
HOLIDAY INN EXPRESS

PHASE II DEVELOPMENT PLANS **LOT 1 INDIAN MEADOWS FILING NO.3**





VICINITY MAP

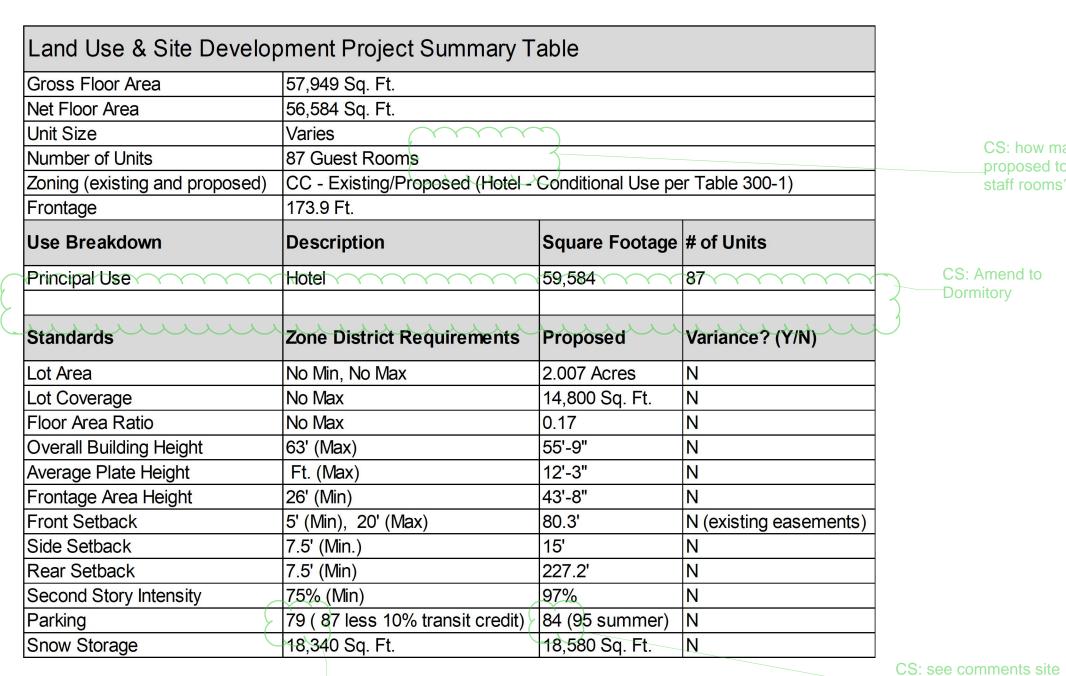

CS: how many people _proposed to occupy the staff rooms?

CS: Amend to Dormitory

DESIGN TEAM:

CIVIL ENGINEER (APPLICANT): LANDSCAPE DESIGNER: FOUR POINTS SURVEYING AND ENGINEERING HICKORY FLATS LANDSCAPE DESIGN ATTN: ANDY BENJAMIN ATTN: JOE WIEDEMEIER, P.E. PO BOX 775966 STEAMBOAT SPRINGS, CO 80477 970-871-6772

ARCHITECT: DESIGN 2 FUNCTION, LLC ATTN: NICHOLAS PIRKL, AIA P.O. BOX 93368

JOEW@FOURPOINTSSE.COM

505-823-6481

OWNER: GRAY STONE, LLC ATTN: BOB AMIN 83 E. 120 AVE THORNTON, CO 80233 ALBUQUERQUE, NM 87199 303-895-4594 BOBAMIN@LIVE.COM NICK@DESIGN2FUNCTIONLLC.COM

OAK CREEK, CO 80467

HICKORYFLATSLDS@GMAIL.COM

970-846-0117

DRAWING INDEX:

=	1. 2. 3. 4. 5. 6. 7. 8. 9.	CS C1 C2 C3.1 C3.2 C4.1 C4.2 C4.3 C5 C6	COVER SHEET CIVIL COVER PAGE & NOTES EXISTING CONDITIONS PLAN OVERALL SITE PLAN FUTURE CROSS ACCESS TO INGLES LANE GRADING AND DRAINAGE PLAN - PHASE 1 GRADING AND DRAINAGE PLAN - PHASE 2 STORMWATER PROFILES UTILITY PLAN PLASING PLAN
	11. 12. 13. 14. 15. 16. 17. 18. 19. 20. 21.	C7 L1 L2 AS1.1 AS1.2 AS1.3 A1.1 A1.2 A1.3 A1.4 A1.5 A2.1	SNOW STORAGE PLAN FOR HOLIDAY INN EXPRESS LANDSCAPE PLAN LANDSCAPE AREA DELINEATION PLAN SITE SHADOW PLAN SITE LIGHTING PLAN SITE LIGHTING CUT SHEETS 1ST FLOOR PLAN 2ND FLOOR PLAN 3RD FLOOR PLAN 4TH FLOOR PLAN ROOF PLAN SOUTH AND EAST EXTERIOR ELEVATIONS
	23. 24.	A2.2 A2.3	NORTH AND WEST EXTERIOR ELEVATIONS RENDERINGS

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PROJECT MANAGER: NICK PIRKL

DRAWN BY:


SHEET TITLE: DEVELOPMENT COVER SHEET

> CS SHEET: 01 OF

0 20 50 100 200

CS: what is 90 based



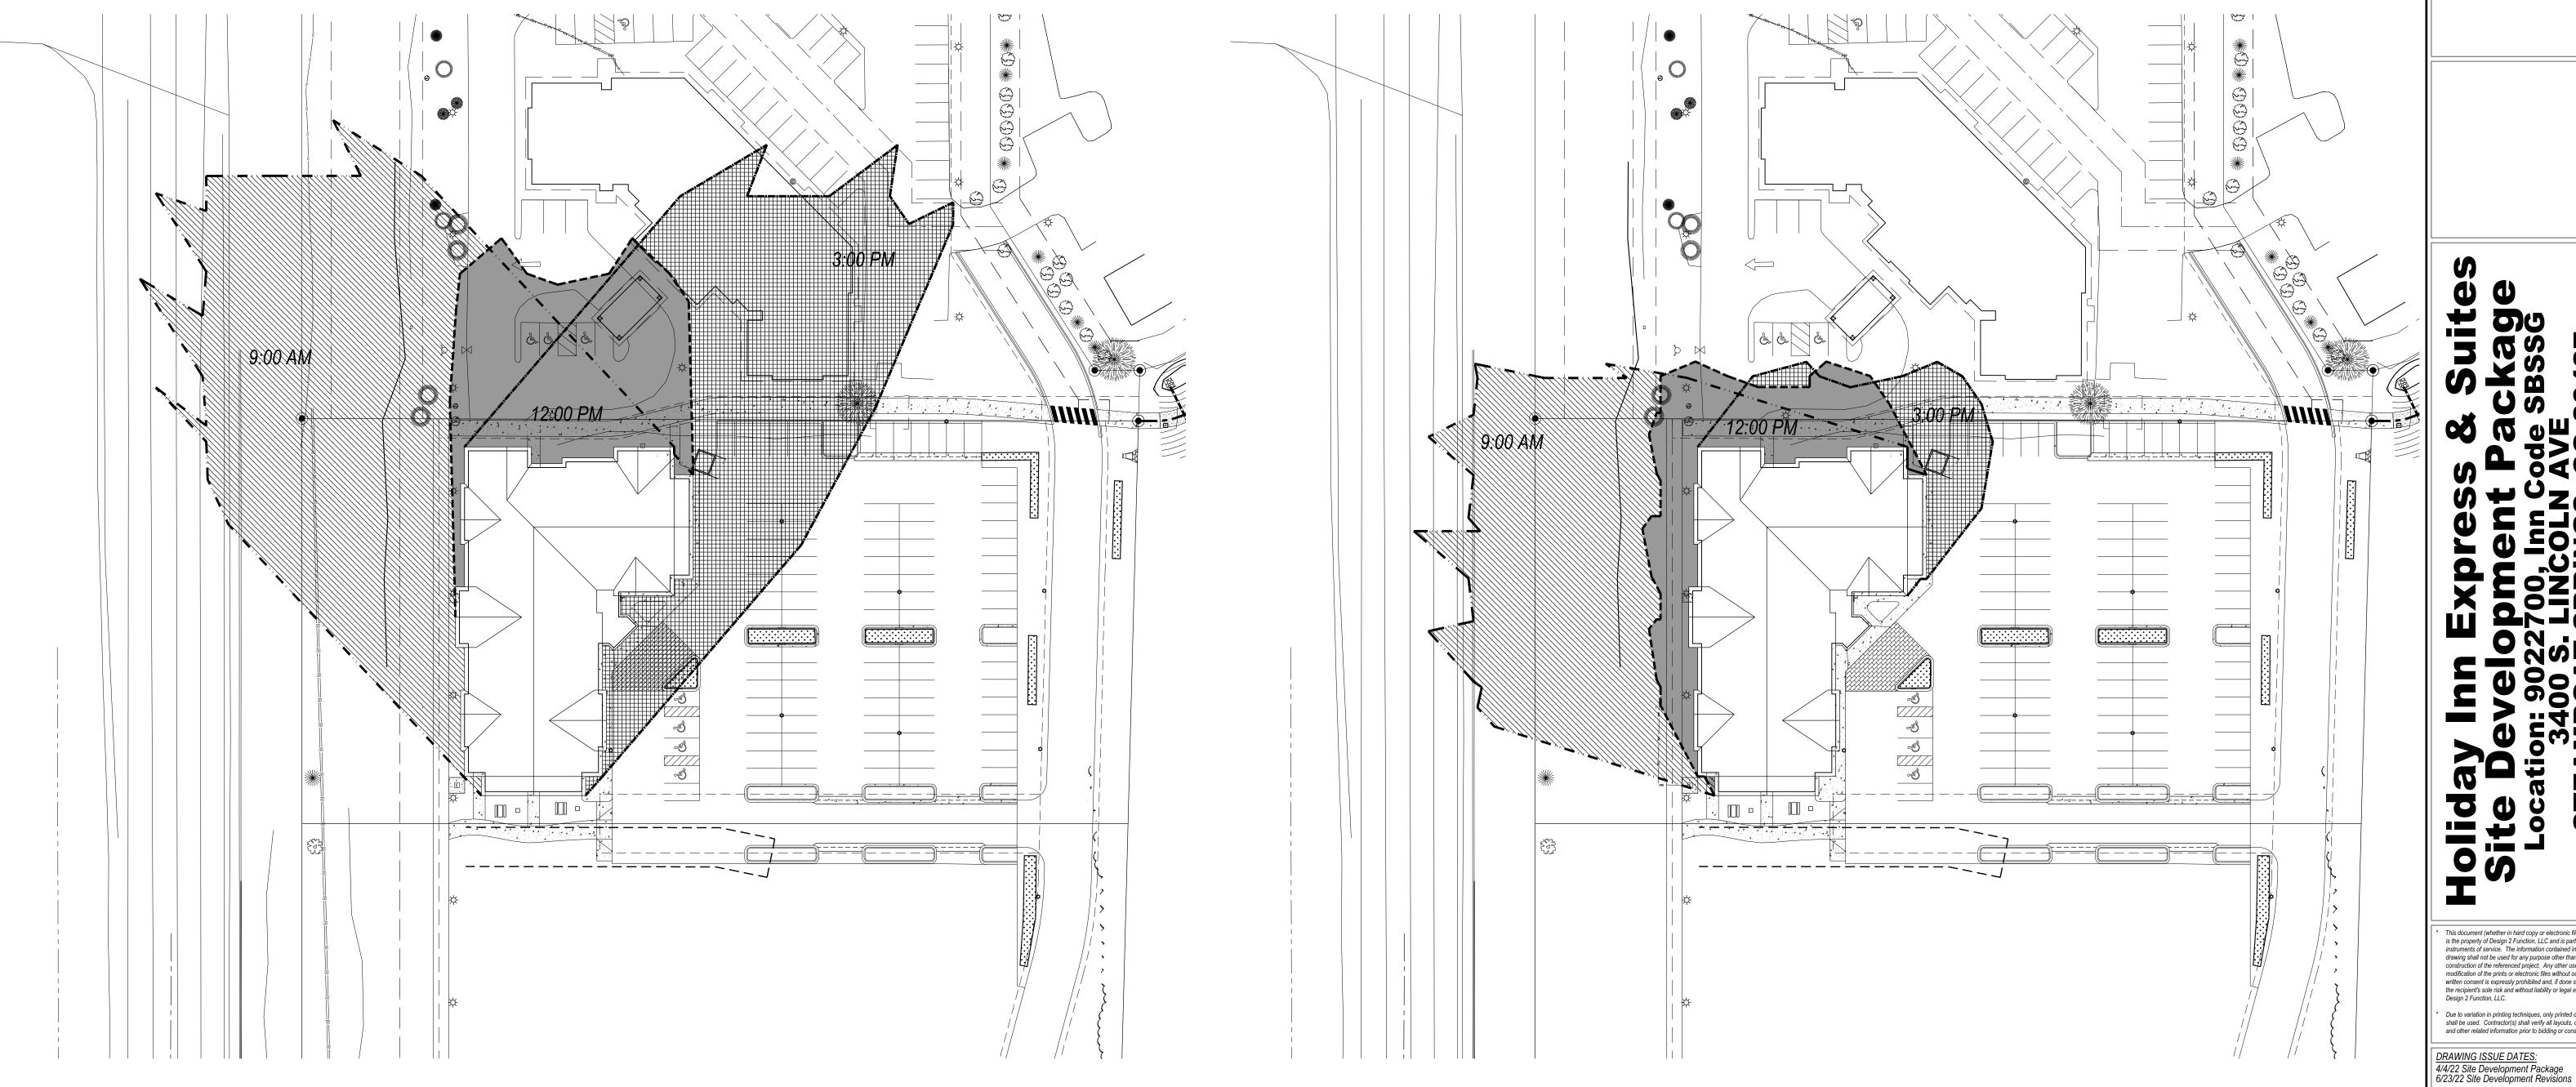

SHADOW PLAN - DECEMBER

SCALE: 1"=40'-0"

MOUNTAIN STANDARD TIMES (9:00, 12:00, 3:00)

0 8 20 40 80

SHADOW LEGEND:

SHADOW PLAN - MARCH

SCALE: 1"=40'-0"

MOUNTAIN DAYLIGHT TIMES (9:00, 12:00, 3:00)

0 8 20 40 80

DIAGONAL HATCH = 9:00 AM BOTH PLANS SOLID HATCH = 12:00 PM BOTH PLANS HORIZONTAL/VERTICAL HATCH = 3:00 PM BOTH PLANS DRAWING REVISION DATES:

te Develor-ocation: 90227 3400 S. I STEAMBOAT S

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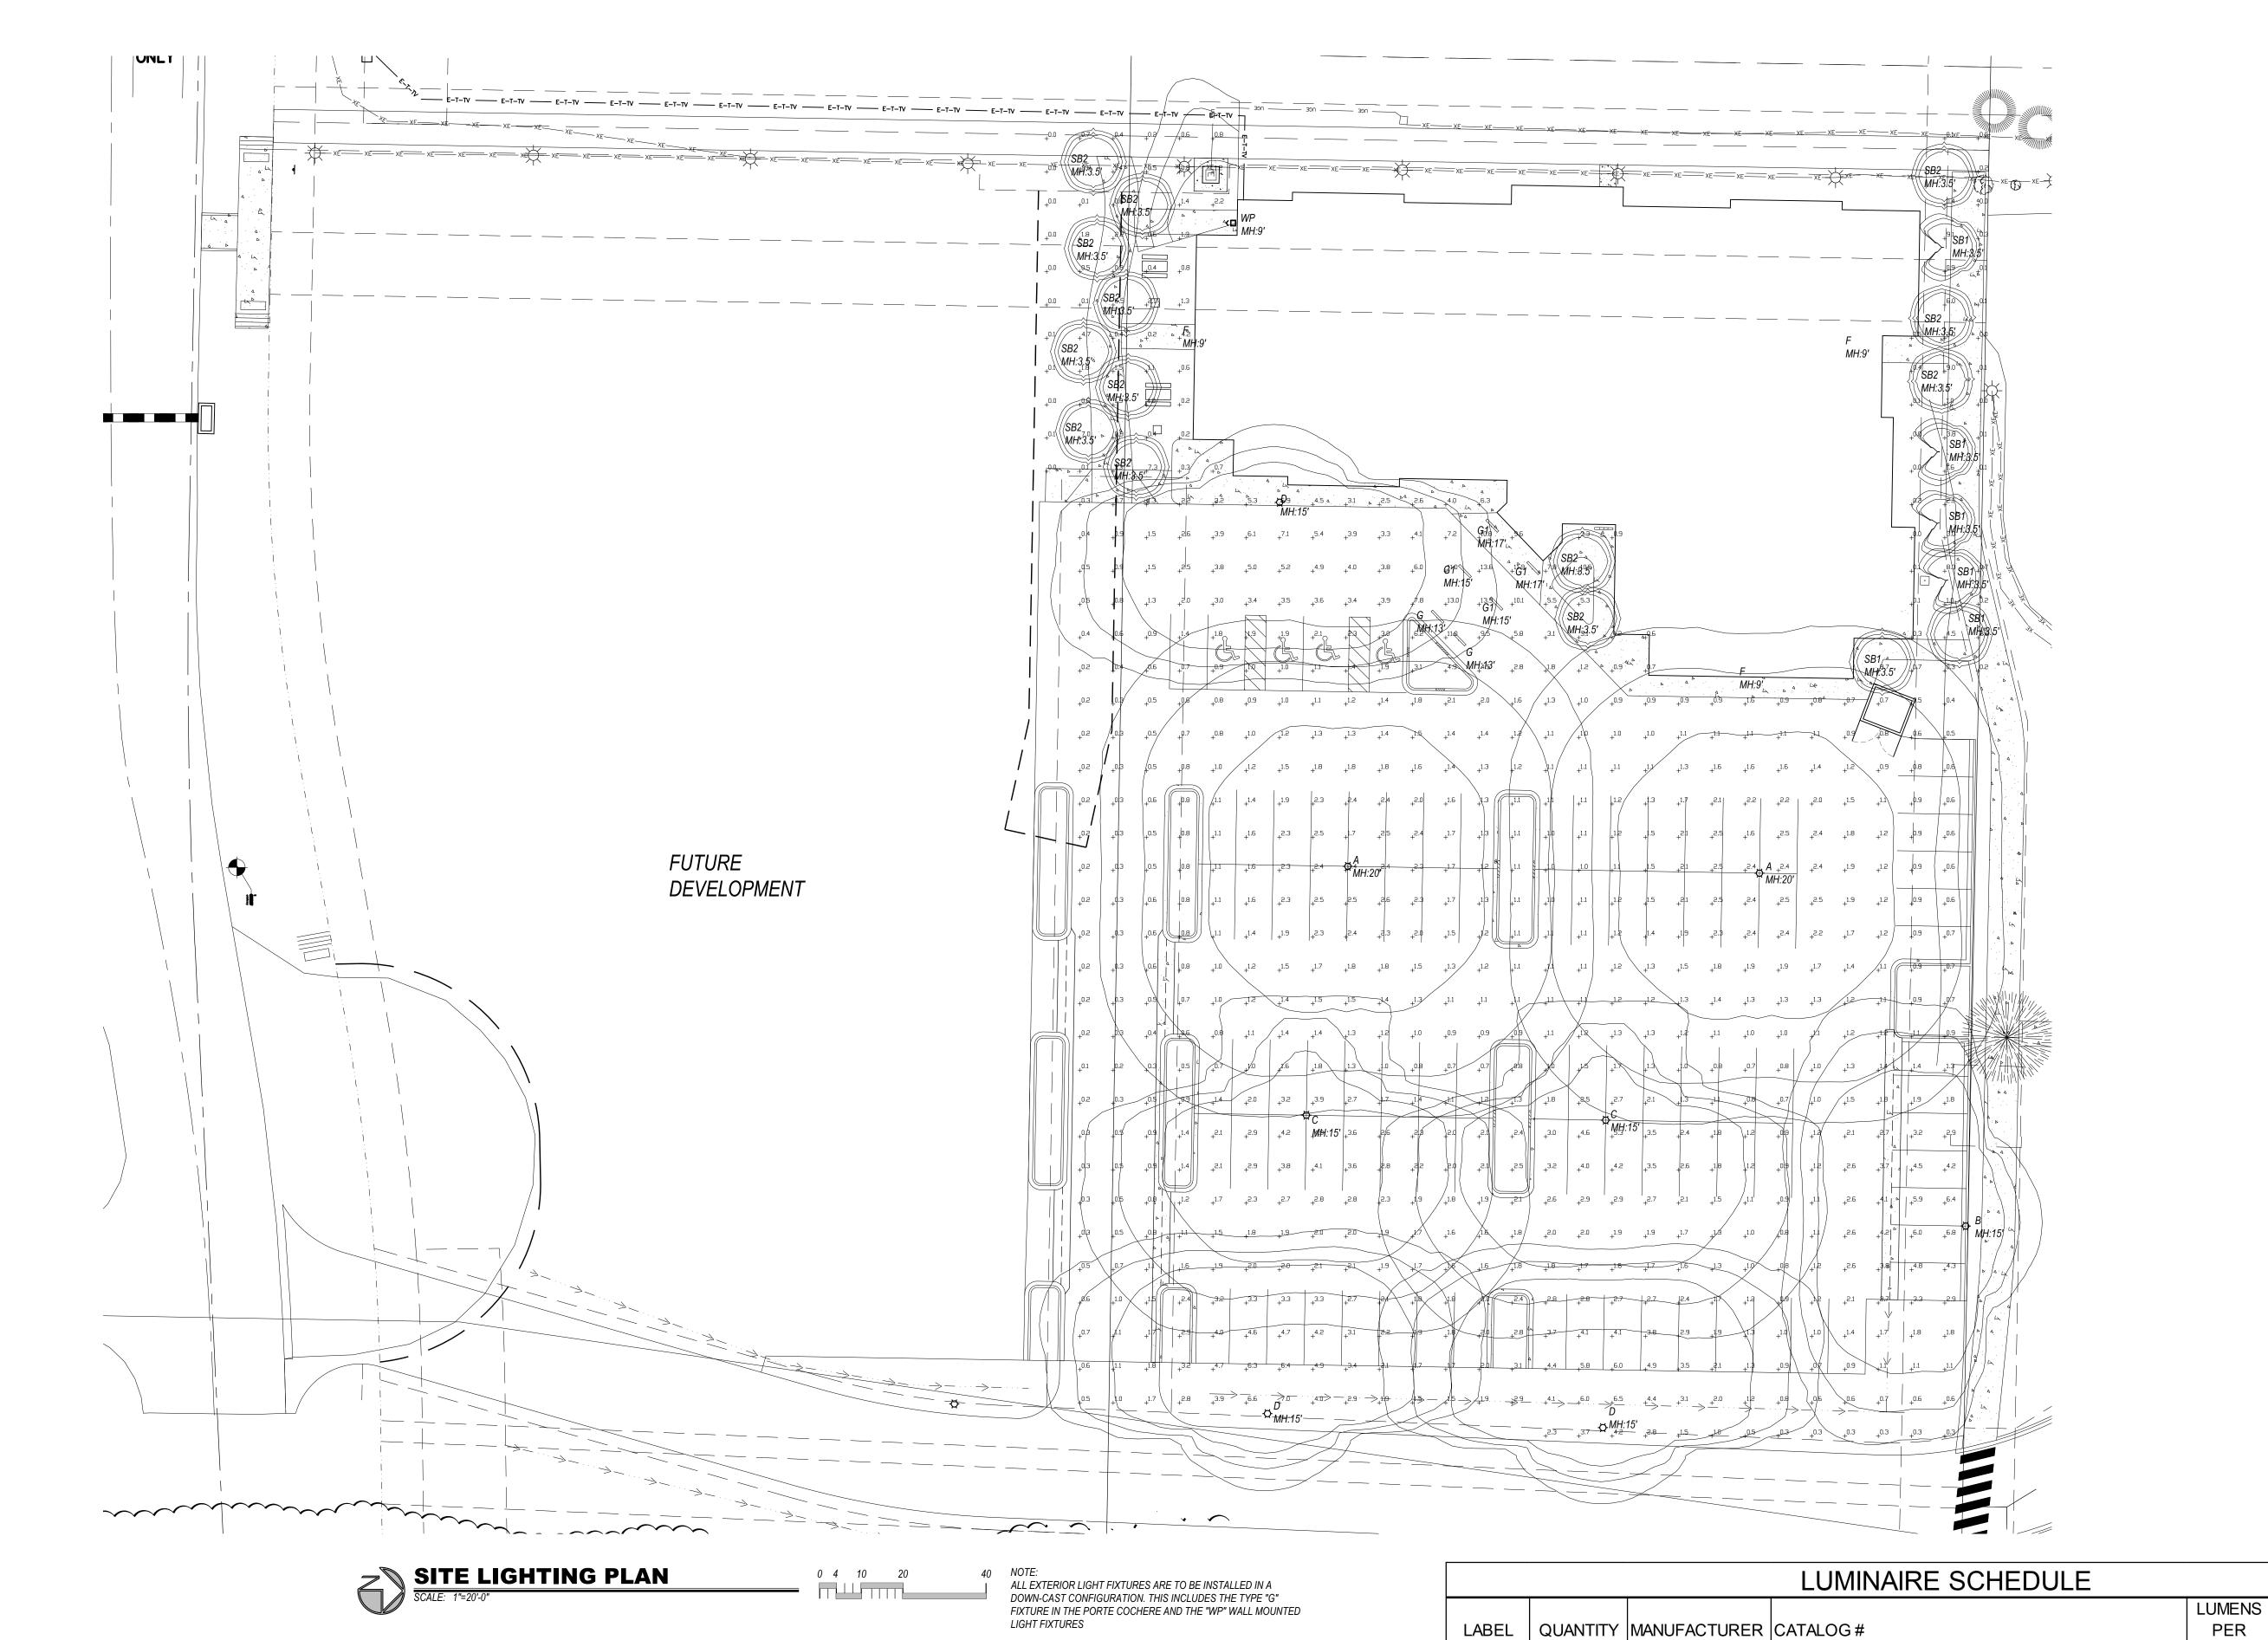
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PROJECT MANAGER: NICK PIRKL

DRAWN BY: SITE SHADOW PLAN

AS1.1

SHEET: 14 OF



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Due to variation in printing techniques, only printed dimension shall be used. Contractor(s) shall verify all layouts, dimensions and other related information prior to bidding or construction.

DRAWING ISSUE DATES: 4/4/22 Site Development Package 6/23/22 Site Development Revisions

DRAWING REVISION DATES: TOTAL WATTS

FIXTURE

WATTS

102

102

70

102

70

10.44

22.42

40.98

8

8

19.56

204

102

140

306

32

120

19.56

1163.64

PER

LAMP

13055

9552

8707

9552

8895

952

1949

3226

559

617

2244

DSX1 LED P3 40K T5M MVOLT

DSX1 LED P2 40K T4M MVOLT

DSX1 LED P2 40K TFTM MVOLT

RADB LED P2 40K ASY DBLXD

RADB LED P2 40K SYM DBLXD

WSQ LED P1 SR3 40K MVOLT

LDN6 40/10 LO6AR LSS (recessed can)

ML5IP65-D-MO-K40-4'-W-LOH-FXXX-EF-UNIV

ML5IP65-D-HO-K40-4'-W-LOH-FXXX-EF-UNIV

DSX1 LED P3 40K T4M MVOLT HS (houseside shield)

DSX1 LED P3 40K T4M MVOLT HS (houseside shield)

Lithonia

Lithonia

Lithonia

Lithonia

Lithonia

Lithonia

Precision

Precision

Lithonia

Lithonia

Lithonia

2

0

2

4

4

15

37

G


SB2

WP

TOTALS

31.32 SITE LIGHTING 44.84 PLAN 163.92

> **AS1.2** SHEET: 15 OF

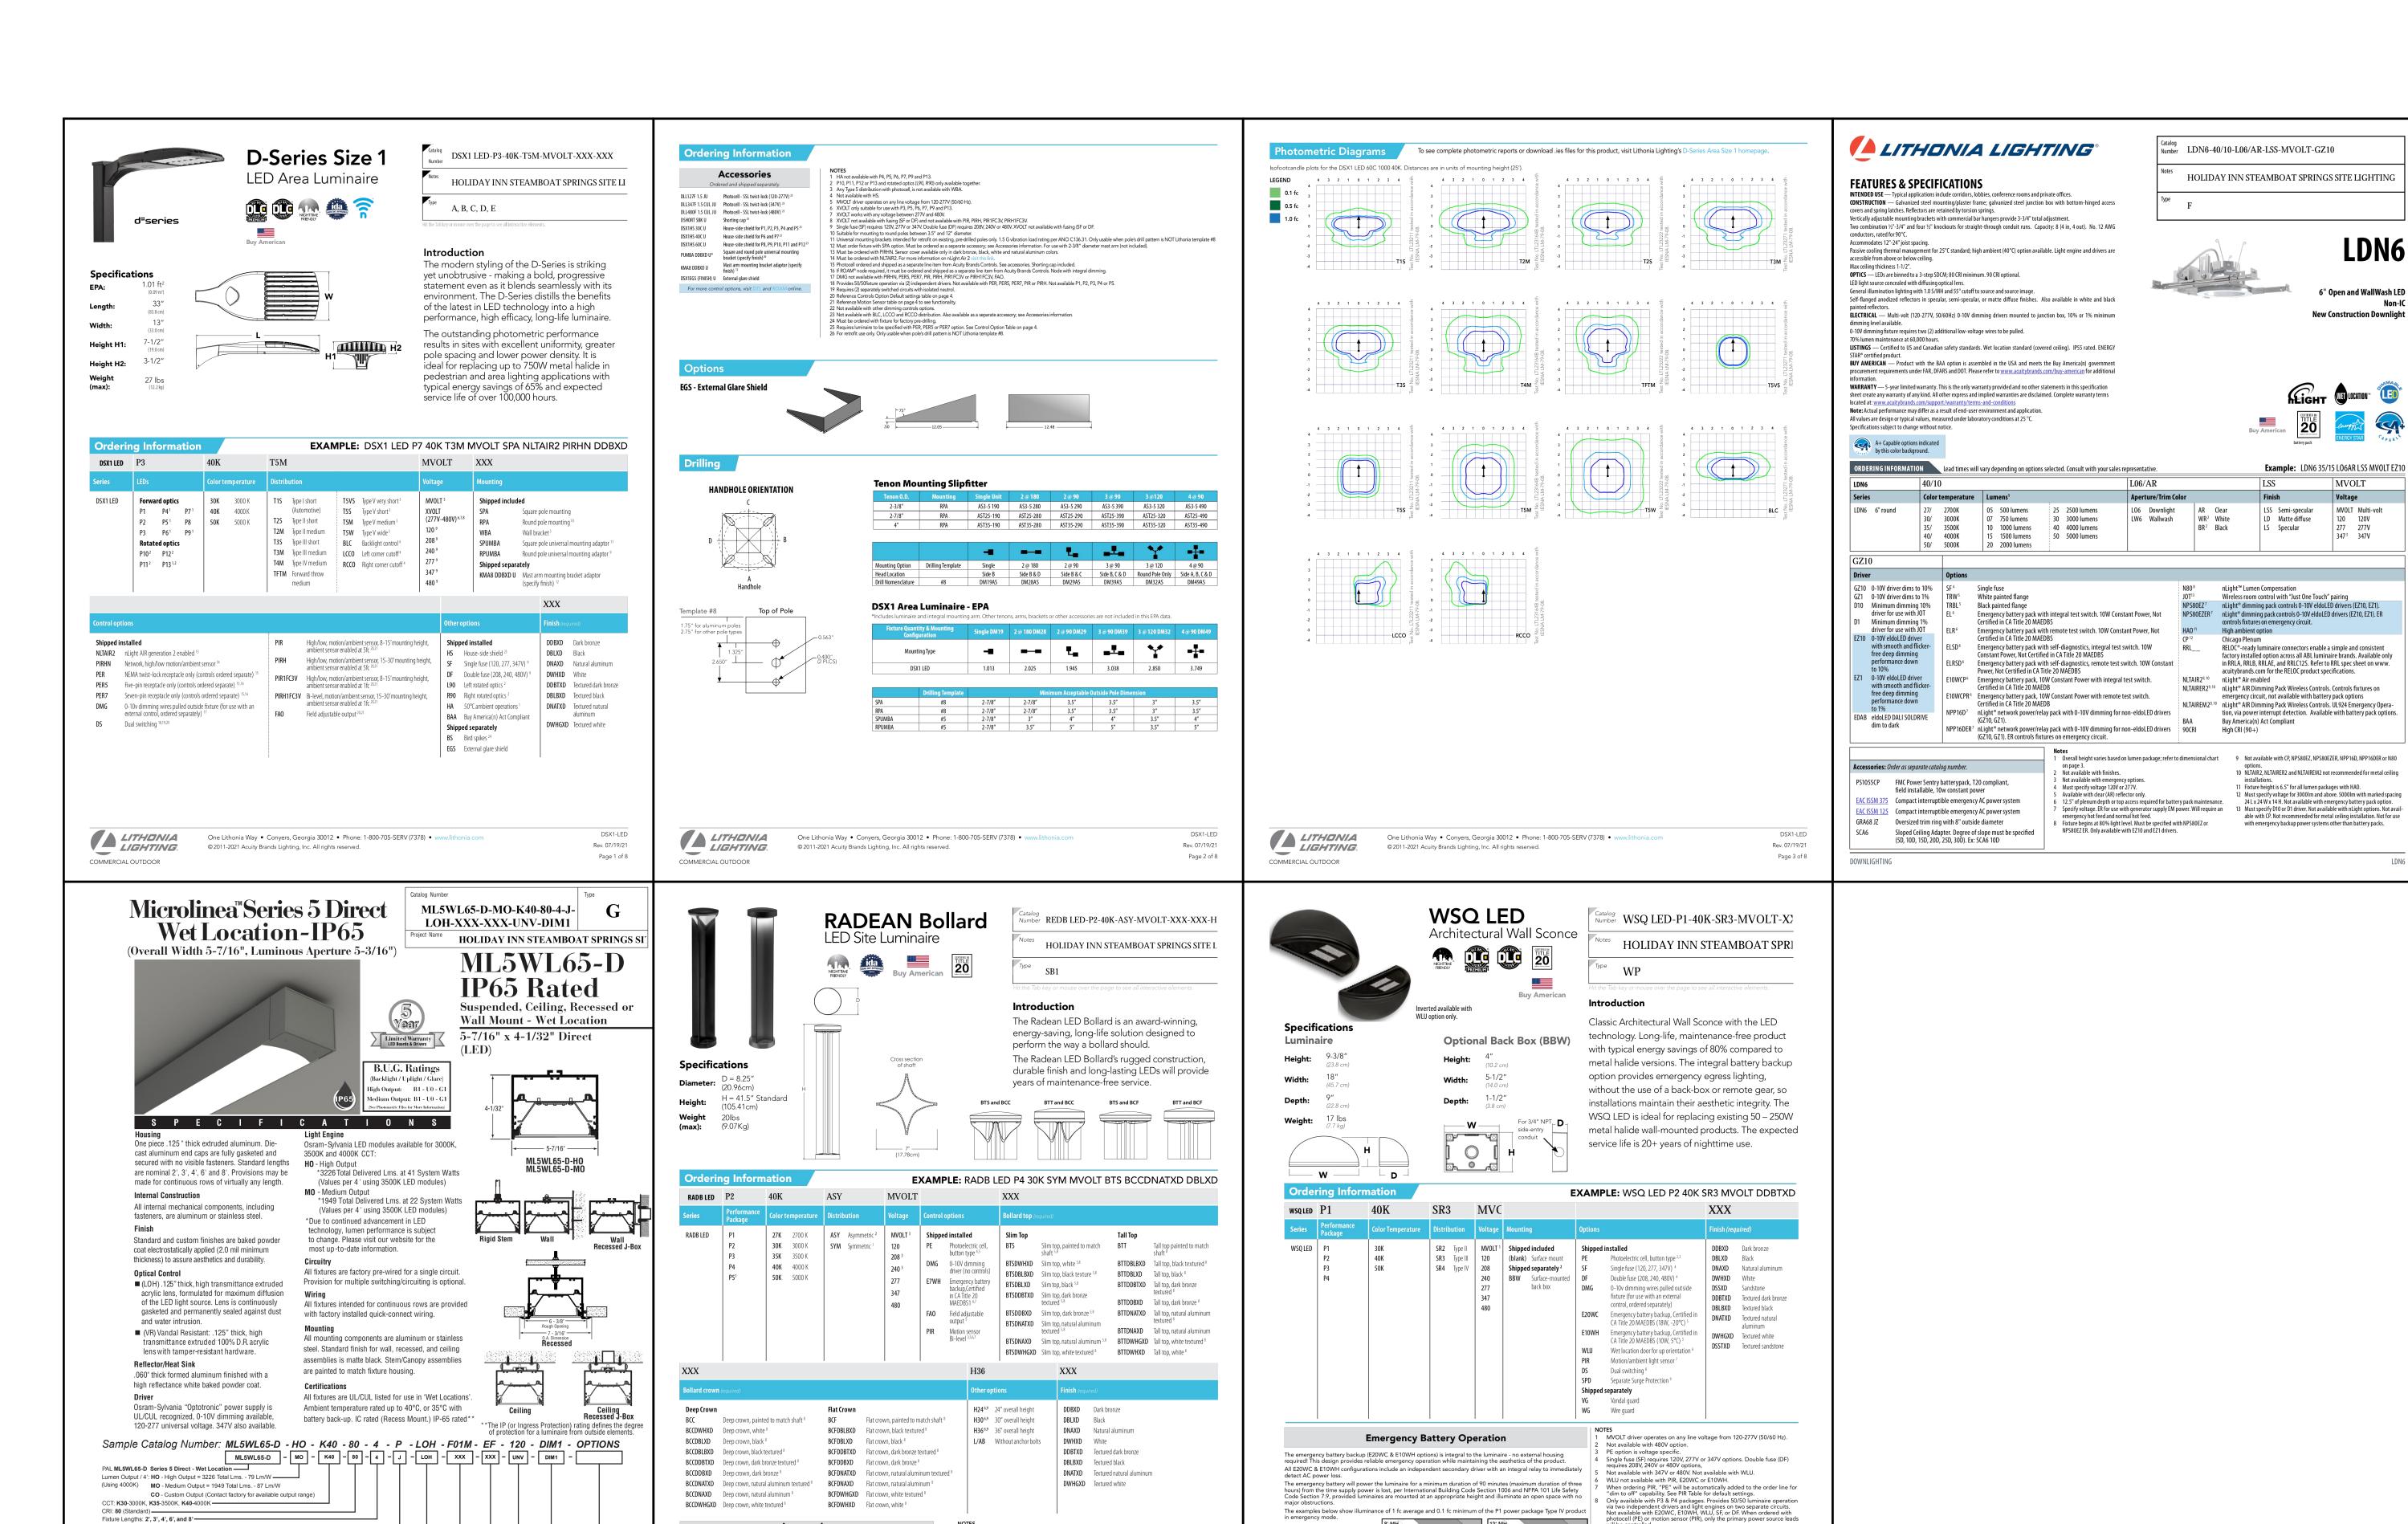

E7WH and PIR only available in full height. Not available with H24, H30 or H36.
 PIR not available with E7WH.

(additional leadtimes and cost may apply) 42" Height is standard. H24, H30 and H36 have longer leadtimes.

8 Architectural and custom colors available

WSR P1 LED 40K SR4 MVOLT E20W

8' and 12' Mounting Height

LITHONIA LIGHTING.

10' x 10' Gridlines

P5 only available in SYM distribution.

3 PIR not available with 208V or 240V.

4 PE only available with ASY.
5 PE, PIR and FAO not available with BTS.

Anchor bolts (4)

(specify finish) (4)

RADBABC DDBXD U Replacement anchor bolt covers RK1RADB EMTESTMAG U Emergency test stylus

RK1RADB BCKIT (FINISH) U Base cover with bolt caps

COMMERCIAL OUTDOOR

One Lithonia Way • Conyers, Georgia 30012 • Phone: 1-800-705-SERV (7378) • www.lithonia.com
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See electrical section on page 2 for more details.

Rev. 03/08/22

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Mounting: **P** = Rigid Stem (Up to 24" Std.) **W** = Wall Mount **R** = Recessed Mount **J** = Ceiling Mount

Standard Finish: F01M Matte White F10 Bronzed F11T Textured Black F12 Ultrasonic Clear FCC Custom Color ——

CWD = Cold Weather Driver, -40 Deg C Ambient Temp. Rating (High Output Only - 3' or Longer Fixtures) (N/A for 1% Dimming Option)

el 713.946.4343 Fax 713.946.4441 www.pal-lighting.com

Options: EMCKT = Emergency Circuit (Separate Hot & Neutral) EBPHST = Self-Testing Emergency Battery Pack (10 Watt) (N/A for 2' Fixtures & N/A for 347V) FS = Fused Drivers

recision Architectural Lighting 4830 Timber Creek Drive Houston, Texas 77017 Made in America

WRJ = Wall Mount w/Recess J-Box WRJ = Wall Mount w/Recess J-Box

Power Feed Location: **EF** = End Feed **TF** = Top Feed (N/A for Recess or Ceiling Mount)

Voltage: 120V, 277V, 347V or UNV (Universal Voltage) ----

VR = 100% D.R. Acrylic Lens with Tamper-Resist Hardware



50 COZE **S**22.⊤

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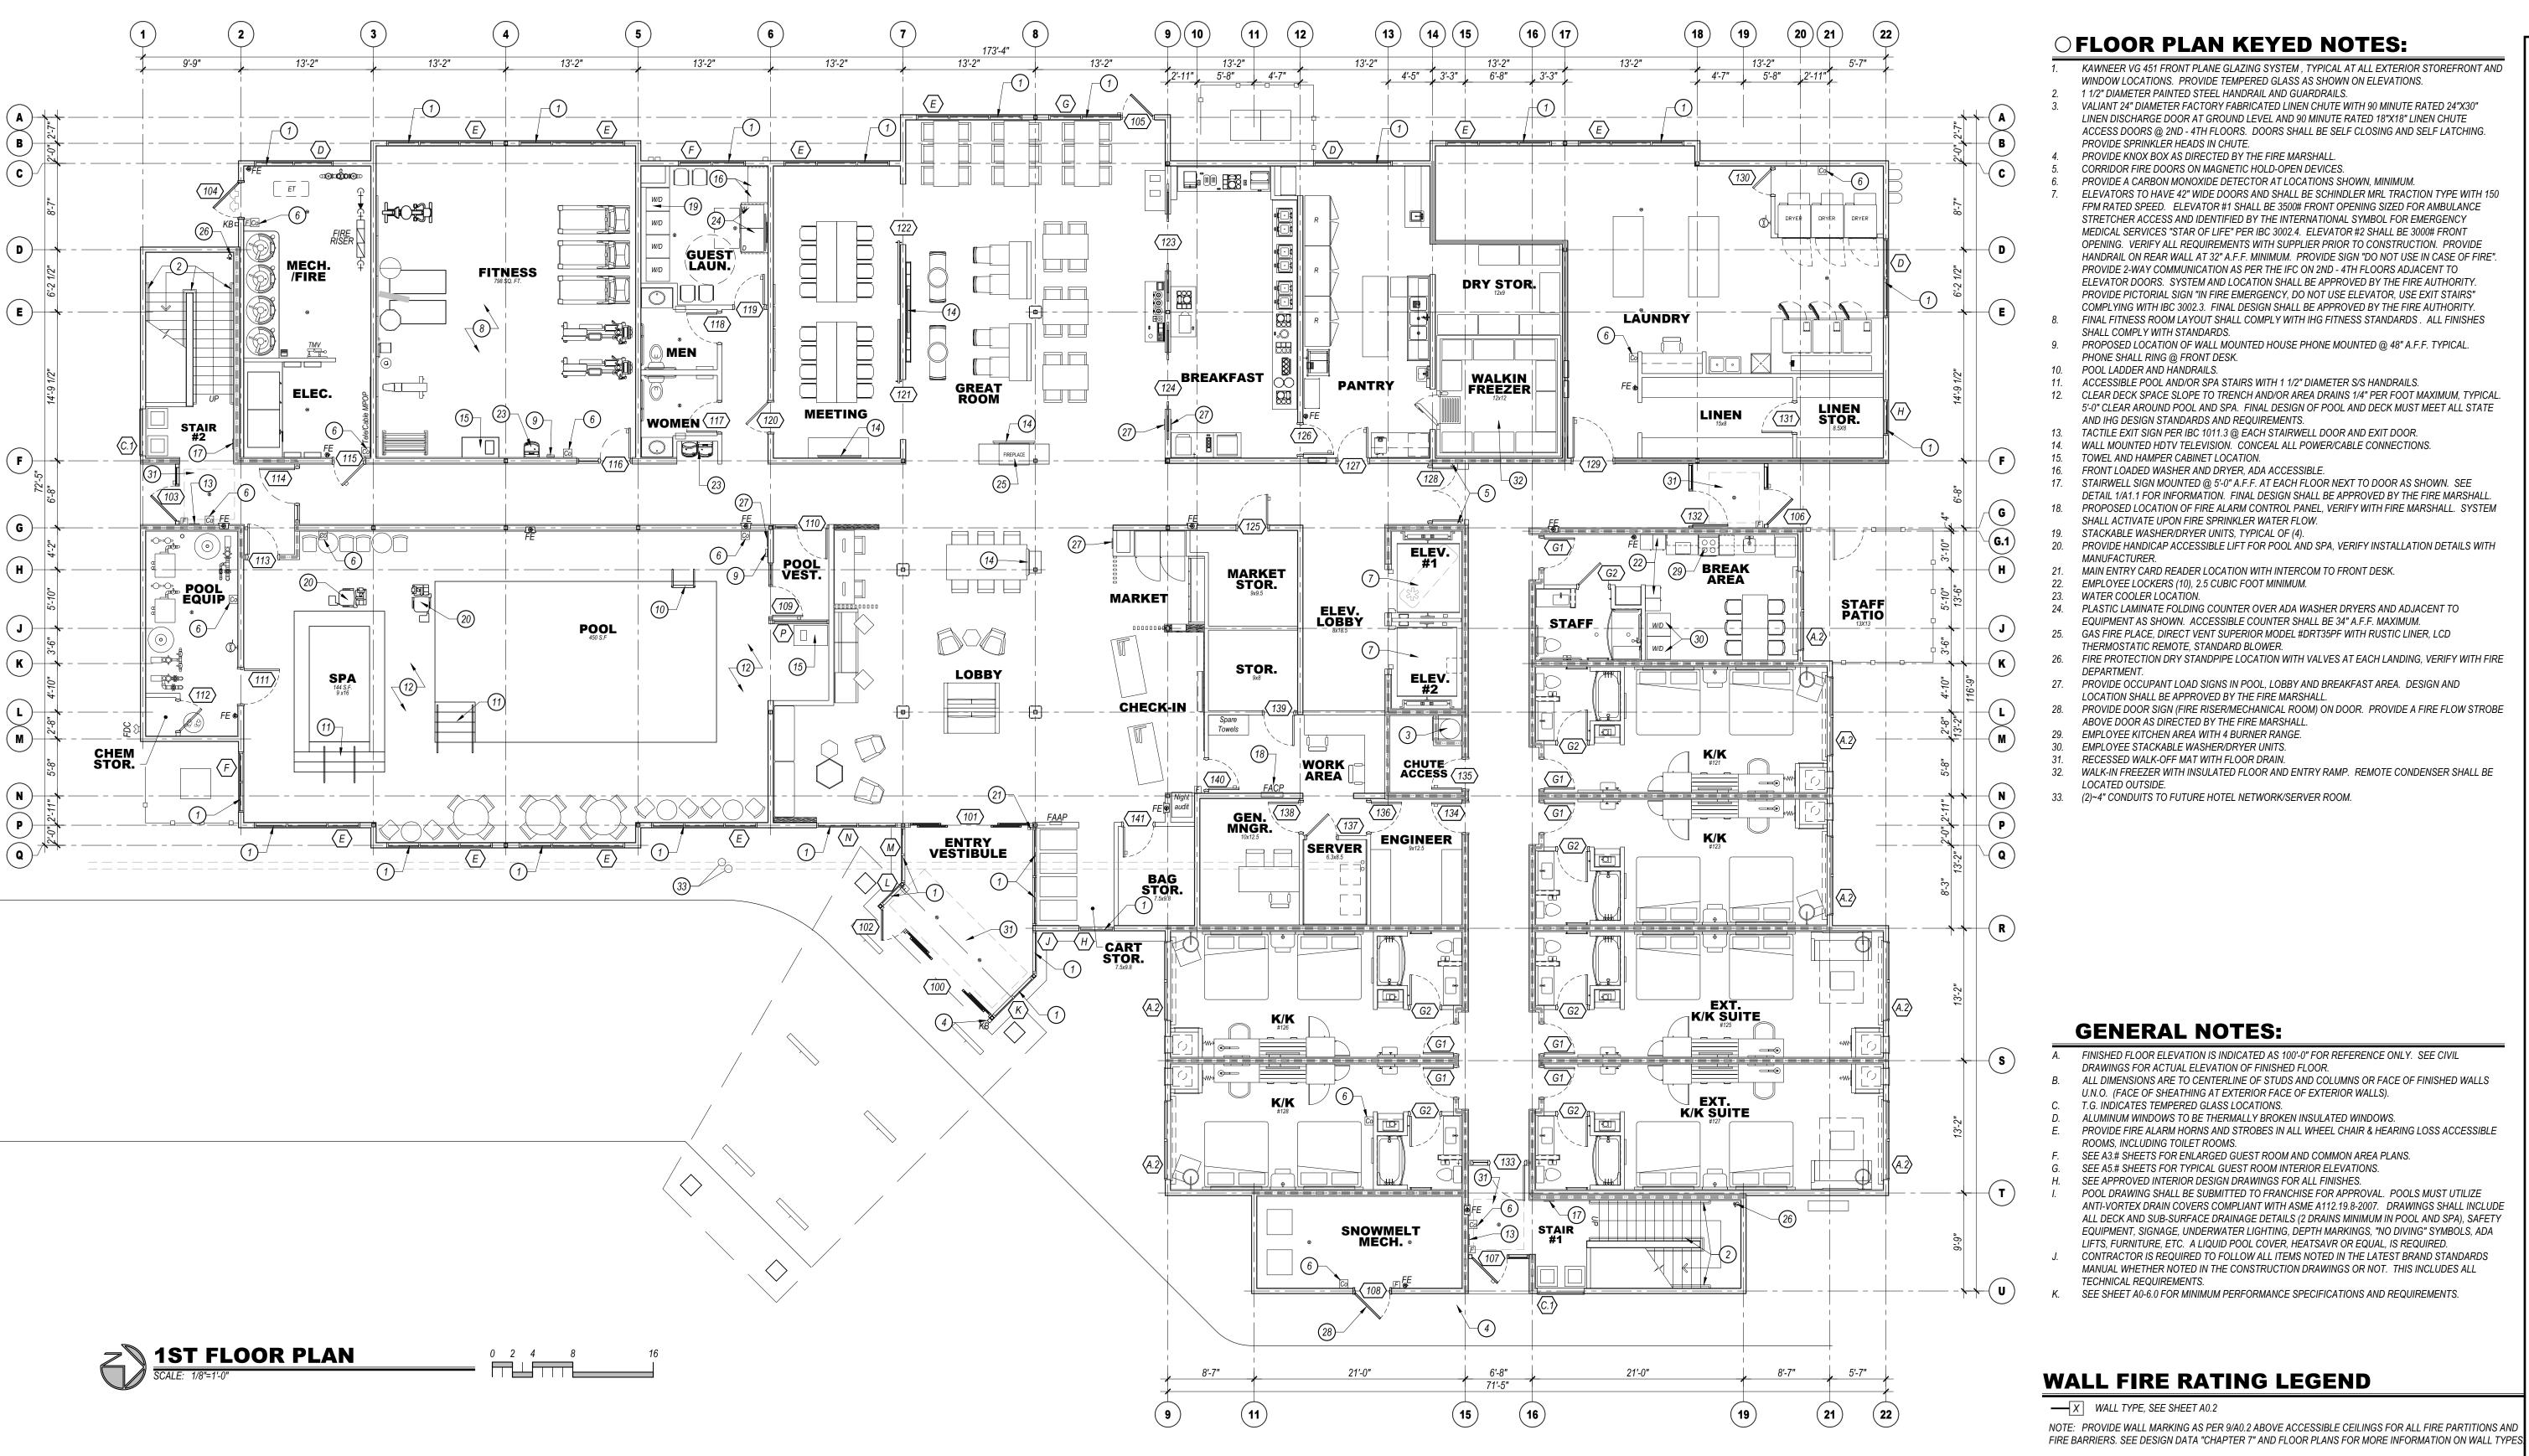
DRAWING ISSUE DATES: 4/4/22 Site Development Package 6/23/22 Site Development Revisions

DRAWING REVISION DATES.

NICK PIRKL DRAWN BY:

PROJECT MANAGER:

EXTERIOR LIGHT FIXTURE CUTSHEETS



- SEE FLOOR PLANS TO CONFIRM ROOF ACCESS AVAILABILITY. **FLOOR** 5" number BRAILLE FLOOR LEVEL INDICATION MUST BE BETWEEN 48" AND 60". braille FLOORS 1 TO 5 DOWN TO FLOOR 1 - SEE FLOOR PLANS FOR TOTAL NUMBER OF FLOORS AND EXIT DISCHARGE LEVEL. TACTILE CHARACTERS L TACTILE CHARACTERS NOTE: ALL CHARACTERS TO BE TACTILE (RAISED) STAIRWELL SIGN SCALE: 1 1/2" = 1'-0" 2 ADA TOILET SIGN SCALE: 1 1/2" = 1'-0"

3	1,250 2,750	Breakfast area, meeting room
	2,750	Labby Market Flay Labby Dool
		Lobby,Market, Elev. Lobby, Pool
	7,930	Offices, Laundry, work room, Fitness, Game Room, etc.
1	2,870	Guest Rooms and residential corridors
	14,800	
1	14,383	Each Floor
ght	63' max	55'-9" Actual Height
ies	4	
а	57,949	Total Building Area
	V-A	Wood construction
	Sec. 903	Building will be fully sprinklered per NFPA 13
	Appendix B105.1(2)	Base fire flow = 4,250 GPM. Reduce to 25% per table B105.2 = 1063 GPM @ 2hr duration required. 1 hydrant required per C102.1.
	8 Int	

PROJECT DATA

OFLOOR PLAN KEYED NOTES:

- KAWNEER VG 451 FRONT PLANE GLAZING SYSTEM, TYPICAL AT ALL EXTERIOR STOREFRONT AND
- 1 1/2" DIAMETER PAINTED STEEL HANDRAIL AND GUARDRAILS. VALIANT 24" DIAMETER FACTORY FABRICATED LINEN CHUTE WITH 90 MINUTE RATED 24"X30"
- LINEN DISCHARGE DOOR AT GROUND LEVEL AND 90 MINUTE RATED 18"X18" LINEN CHUTE PROVIDE SPRINKLER HEADS IN CHUTE.
- PROVIDE KNOX BOX AS DIRECTED BY THE FIRE MARSHALL
- CORRIDOR FIRE DOORS ON MAGNETIC HOLD-OPEN DEVICES.
- PROVIDE A CARBON MONOXIDE DETECTOR AT LOCATIONS SHOWN, MINIMUM ELEVATORS TO HAVE 42" WIDE DOORS AND SHALL BE SCHINDLER MRL TRACTION TYPE WITH 150 FPM RATED SPEED. ELEVATOR #1 SHALL BE 3500# FRONT OPENING SIZED FOR AMBULANCE STRETCHER ACCESS AND IDENTIFIED BY THE INTERNATIONAL SYMBOL FOR EMERGENCY
- PROVIDE 2-WAY COMMUNICATION AS PER THE IFC ON 2ND 4TH FLOORS ADJACENT TO PROVIDE PICTORIAL SIGN "IN FIRE EMERGENCY, DO NOT USE ELEVATOR, USE EXIT STAIRS" COMPLYING WITH IBC 3002.3. FINAL DESIGN SHALL BE APPROVED BY THE FIRE AUTHORITY. FINAL FITNESS ROOM LAYOUT SHALL COMPLY WITH IHG FITNESS STANDARDS. ALL FINISHES SHALL COMPLY WITH STANDARDS.
- PROPOSED LOCATION OF WALL MOUNTED HOUSE PHONE MOUNTED @ 48" A.F.F. TYPICAL. PHONE SHALL RING @ FRONT DESK.
- POOL LADDER AND HANDRAILS. ACCESSIBLE POOL AND/OR SPA STAIRS WITH 1 1/2" DIAMETER S/S HANDRAILS
- CLEAR DECK SPACE SLOPE TO TRENCH AND/OR AREA DRAINS 1/4" PER FOOT MAXIMUM, TYPICAL. 5'-0" CLEAR AROUND POOL AND SPA. FINAL DESIGN OF POOL AND DECK MUST MEET ALL STATE AND IHG DESIGN STANDARDS AND REQUIREMENTS.
- TACTILE EXIT SIGN PER IBC 1011.3 @ EACH STAIRWELL DOOR AND EXIT DOOR. WALL MOUNTED HDTV TELEVISION. CONCEAL ALL POWER/CABLE CONNECTIONS.
- TOWEL AND HAMPER CABINET LOCATION. FRONT LOADED WASHER AND DRYER, ADA ACCESSIBLE.

SHALL ACTIVATE UPON FIRE SPRINKLER WATER FLOW.

- STAIRWELL SIGN MOUNTED @, 5'-0" A.F.F. AT EACH FLOOR NEXT TO DOOR AS SHOWN. SEE DETAIL 1/A1.1 FOR INFORMATION. FINAL DESIGN SHALL BE APPROVED BY THE FIRE MARSHALL. PROPOSED LOCATION OF FIRE ALARM CONTROL PANEL, VERIFY WITH FIRE MARSHALL. SYSTEM
- STACKABLE WASHER/DRYER UNITS, TYPICAL OF (4). PROVIDE HANDICAP ACCESSIBLE LIFT FOR POOL AND SPA, VERIFY INSTALLATION DETAILS WITH
- MAIN ENTRY CARD READER LOCATION WITH INTERCOM TO FRONT DESK.
- EMPLOYEE LOCKERS (10), 2.5 CUBIC FOOT MINIMUM. WATER COOLER LOCATION.
- PLASTIC LAMINATE FOLDING COUNTER OVER ADA WASHER DRYERS AND ADJACENT TO EQUIPMENT AS SHOWN. ACCESSIBLE COUNTER SHALL BE 34" A.F.F. MAXIMUM.
- GAS FIRE PLACE, DIRECT VENT SUPERIOR MODEL #DRT35PF WITH RUSTIC LINER, LCD THERMOSTATIC REMOTE, STANDARD BLOWER. FIRE PROTECTION DRY STANDPIPE LOCATION WITH VALVES AT EACH LANDING, VERIFY WITH FIRE
- PROVIDE OCCUPANT LOAD SIGNS IN POOL, LOBBY AND BREAKFAST AREA. DESIGN AND
- LOCATION SHALL BE APPROVED BY THE FIRE MARSHALL. PROVIDE DOOR SIGN (FIRE RISER/MECHANICAL ROOM) ON DOOR. PROVIDE A FIRE FLOW STROBE
- ABOVE DOOR AS DIRECTED BY THE FIRE MARSHALL.
- EMPLOYEE KITCHEN AREA WITH 4 BURNER RANGE. EMPLOYEE STACKABLE WASHER/DRYER UNITS.
- RECESSED WALK-OFF MAT WITH FLOOR DRAIN.
- WALK-IN FREEZER WITH INSULATED FLOOR AND ENTRY RAMP. REMOTE CONDENSER SHALL BE
- (2)~4" CONDUITS TO FUTURE HOTEL NETWORK/SERVER ROOM.

GENERAL NOTES:

- FINISHED FLOOR ELEVATION IS INDICATED AS 100'-0" FOR REFERENCE ONLY. SEE CIVIL DRAWINGS FOR ACTUAL ELEVATION OF FINISHED FLOOR.
- ALL DIMENSIONS ARE TO CENTERLINE OF STUDS AND COLUMNS OR FACE OF FINISHED WALLS U.N.O. (FACE OF SHEATHING AT EXTERIOR FACE OF EXTERIOR WALLS).
- T.G. INDICATES TEMPERED GLASS LOCATIONS. ALUMINUM WINDOWS TO BE THERMALLY BROKEN INSULATED WINDOWS. PROVIDE FIRE ALARM HORNS AND STROBES IN ALL WHEEL CHAIR & HEARING LOSS ACCESSIBLE
- ROOMS, INCLUDING TOILET ROOMS. SEE A3.# SHEETS FOR ENLARGED GUEST ROOM AND COMMON AREA PLANS.
- SEE A5.# SHEETS FOR TYPICAL GUEST ROOM INTERIOR ELEVATIONS. SEE APPROVED INTERIOR DESIGN DRAWINGS FOR ALL FINISHES. POOL DRAWING SHALL BE SUBMITTED TO FRANCHISE FOR APPROVAL. POOLS MUST UTILIZE
- ANTI-VORTEX DRAIN COVERS COMPLIANT WITH ASME A112.19.8-2007. DRAWINGS SHALL INCLUDE ALL DECK AND SUB-SURFACE DRAINAGE DETAILS (2 DRAINS MINIMUM IN POOL AND SPA), SAFETY EQUIPMENT, SIGNAGE, UNDERWATER LIGHTING, DEPTH MARKINGS, "NO DIVING" SYMBOLS, ADA LIFTS. FURNITURE. ETC. A LIQUID POOL COVER. HEATSAVR OR EQUAL. IS REQUIRED.
- CONTRACTOR IS REQUIRED TO FOLLOW ALL ITEMS NOTED IN THE LATEST BRAND STANDARDS MANUAL WHETHER NOTED IN THE CONSTRUCTION DRAWINGS OR NOT. THIS INCLUDES ALL TECHNICAL REQUIREMENTS. K. SEE SHEET A0-6.0 FOR MINIMUM PERFORMANCE SPECIFICATIONS AND REQUIREMENTS.

WALL FIRE RATING LEGEND

WALL TYPE, SEE SHEET A0.2

NOTE: PROVIDE WALL MARKING AS PER 9/A0.2 ABOVE ACCESSIBLE CEILINGS FOR ALL FIRE PARTITIONS AND

INCIDENTAL USE SEPARATION WALL "SMOKE RESISTANT" PER IBC 509.4.2. (COMMERCIAL LAUNDRY — • — 1 HOUR RATED FIRE PARTITION "RESIDENTIAL CORRIDORS, ELEVATOR LOBBY, GUEST ROOM SEPARATION WALLS".

1 HOUR FIRE BARRIER (LINEN CHUTE ACCESS ROOMS, 3-STORY MECHANICAL SHAFTS). ---- 2 HOUR FIRE BARRIER (STAIRWELLS, ELEVATOR SHAFT, 4-STORY MECHANICAL SHAFTS, LINEN CHUTE, LINEN CHUTE DISCHARGE ROOM).

					,							
ROOM TYPE MATRIX												
FLOOR	KING	KING/ KING	KING SUITE	KING/ KING SUITE	KING ACC. ROLL-IN #214	KING/ KING ADA #225, #325	KING SUITE ADA #303	KING/ KING SUITE ADA #425	FLOOR TOTAL			
1ST		4		2					6			
2ND	3	15	4	3	1	1			27			
3RD	3	16	3	3		1	1		27			
4TH	3	16	4	3				1	27			
TOTAL	9	51	11	11	1	2	1	1	87			

WHEEL CHAIR ACCESSIBLE (MOBILITY FEATURES) 76 TO 100 TOTAL GUEST ROOMS = 5 ROOMS (4 TRANSFER TUBS + 1 ROLL-IN SHOWER REQUIRED).

> HEARING LOSS ACCESSIBLE (COMMUNICATION FEATURES) 76 TO 100 TOTAL GUEST ROOMS = 9 ROOMS REQUIRED (ONLY 1 ROOM THAT IS ALSO A WHEEL CHAIR ACCESSIBLE ROOM MAY COUNT TOWARDS THE TOTAL REQUIRED NUMBER PER 2010 ADAAG SECTION 224.5. 1 KING ROOM (#224), 5 KING/KING ROOMS (#200, 209, 300, 309, 400), 1 KING SUITE (#320) AND 1 KING/KING SUITE (#412) ALONG WITH ALL OF THE MOBILITY ROOMS ARE PROVIDED WITH COMMUNICATION



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<u>0</u>25.⊢

DRAWING REVISION DATES.

1ST FLOOR

PLAN

SHEET: 17 OF



PROJECT DATA									
Chapter 3 - Use and	Туре	Sq. Ft.							
Occupancy Classification	A-2	1,250	Breakfast area, meeting room						
	A-3	2,750	Lobby,Market, Elev. Lobby, Pool						
	В	7,930	Offices, Laundry, work room, Fitness, Game Room, etc.						
	R-1	2,870	Guest Rooms and residential corridors						
1st floor total		14,800							
2nd - 4th floors	R-1	14,383	Each Floor						
Chapter 5 - General Building									
Heights and Areas	Height	63' max	55'-9" Actual Height						
	Stories	4							
	Area	57,949	Total Building Area						
Chapter 6 - Types of		V-A	Wood construction						
Construction		V-A	Wood Constituction						
Chapter 9 - Fire Protection		Sec. 903	Puilding will be fully enrinklored per NEDA 13						
Systems		360.903	Building will be fully sprinklered per NFPA 13						
		Annondiv	Base fire flow = 4,250 GPM. Reduce to 25% per table B105.2						
		Appendix	= 1063 GPM @ 2hr duration required. 1 hydrant required per						
		B105.1(2)	C102.1.						
Information above based on the	e 2018 In	ternational B	uilding Code						

OFLOOR PLAN KEYED NOTES:

- . KAWNEER VG 451 FRONT PLANE GLAZING SYSTEM , TYPICAL AT ALL EXTERIOR STOREFRONT AND WINDOW LOCATIONS. PROVIDE TEMPERED GLASS AS SHOWN ON ELEVATIONS.
- WINDOW LOCATIONS. PROVIDE TEMPERED GLASS AS SHOWN ON ELEVATIONS.
 1 1/2" DIAMETER PAINTED STEEL HANDRAIL AND GUARDRAILS.
 VALIANT 24" DIAMETER FACTORY FABRICATED LINEN CHUTE WITH 90 MINUTE RATED 24"X30" LINEN DISCHARGE DOOR AT GROUND LEVEL AND 90 MINUTE RATED 18"X18" LINEN CHUTE

ACCESS DOORS @ 2ND - 4TH FLOORS. DOORS SHALL BE SELF CLOSING AND SELF LATCHING.

- PROVIDE SPRINKLER HEADS IN CHUTE.

 1. PROVIDE KNOX BOX AS DIRECTED BY THE FIRE MARSHALL.
- PROVIDE KNOX BOX AS DIRECTED BY THE FIRE MARSHALL.
 CORRIDOR FIRE DOORS ON MAGNETIC HOLD-OPEN DEVICES.
- PROVIDE A CARBON MONOXIDE DETECTOR AT LOCATIONS SHOWN, MINIMUM.
 ELEVATORS TO HAVE 42" WIDE DOORS AND SHALL BE SCHINDLER MRL TRACTION TYPE WITH 150 FPM RATED SPEED. ELEVATOR #1 SHALL BE 3500# FRONT OPENING SIZED FOR AMBULANCE STRETCHER ACCESS AND IDENTIFIED BY THE INTERNATIONAL SYMBOL FOR EMERGENCY MEDICAL SERVICES "STAR OF LIFE" PER IBC 3002.4. ELEVATOR #2 SHALL BE 3000# FRONT OPENING. VERIFY ALL REQUIREMENTS WITH SUPPLIER PRIOR TO CONSTRUCTION. PROVIDE HANDRAIL ON REAR WALL AT 32" A.F.F. MINIMUM. PROVIDE SIGN "DO NOT USE IN CASE OF FIRE". PROVIDE 2-WAY COMMUNICATION AS PER THE IFC ON 2ND 4TH FLOORS ADJACENT TO ELEVATOR DOORS. SYSTEM AND LOCATION SHALL BE APPROVED BY THE FIRE AUTHORITY. PROVIDE PICTORIAL SIGN "IN FIRE EMERGENCY, DO NOT USE ELEVATOR, USE EXIT STAIRS" COMPLYING WITH IBC 3002.3. FINAL DESIGN SHALL BE APPROVED BY THE FIRE AUTHORITY.
 - SHALL COMPLY WITH STANDARDS.
 PROPOSED LOCATION OF WALL MOUNTED HOUSE PHONE MOUNTED @ 48" A.F.F. TYPICAL.
 PHONE SHALL RING @ FRONT DESK.

FINAL FITNESS ROOM LAYOUT SHALL COMPLY WITH IHG FITNESS STANDARDS. ALL FINISHES

- PHONE SHALL RING @ FRONT DESK. POOL LADDER AND HANDRAILS.
- ACCESSIBLE POOL AND/OR SPA STAIRS WITH 1 1/2" DIAMETER S/S HANDRAILS.
 CLEAR DECK SPACE SLOPE TO TRENCH AND/OR AREA DRAINS 1/4" PER FOOT MAXIMUM, TYPICAL.
 5'-0" CLEAR AROUND POOL AND SPA. FINAL DESIGN OF POOL AND DECK MUST MEET ALL STATE AND IHG DESIGN STANDARDS AND REQUIREMENTS.
- TACTILE EXIT SIGN PER IBC 1011.3 @ EACH STAIRWELL DOOR AND EXIT DOOR. WALL MOUNTED HDTV TELEVISION. CONCEAL ALL POWER/CABLE CONNECTIONS. TOWEL AND HAMPER CABINET LOCATION.
- FRONT LOADED WASHER AND DRYER, ADA ACCESSIBLE.

SHALL ACTIVATE UPON FIRE SPRINKLER WATER FLOW.

- STAIRWELL SIGN MOUNTED @ 5'-0" A.F.F. AT EACH FLOOR NEXT TO DOOR AS SHOWN. SEE DETAIL 1/A1.1 FOR INFORMATION. FINAL DESIGN SHALL BE APPROVED BY THE FIRE MARSHALL. PROPOSED LOCATION OF FIRE ALARM CONTROL PANEL, VERIFY WITH FIRE MARSHALL. SYSTEM
- STACKABLE WASHER/DRYER UNITS, TYPICAL OF (4).
 PROVIDE HANDICAP ACCESSIBLE LIFT FOR POOL AND SPA, VERIFY INSTALLATION DETAILS WITH MANUFACTURER
- MANUFACTURER.
 21. MAIN ENTRY CARD READER LOCATION WITH INTERCOM TO FRONT DESK.
- EMPLOYEE LOCKERS (10), 2.5 CUBIC FOOT MINIMUM.
- WATER COOLER LOCATION.
- PLASTIC LAMINATE FOLDING COUNTER OVER ADA WASHER DRYERS AND ADJACENT TO EQUIPMENT AS SHOWN. ACCESSIBLE COUNTER SHALL BE 34" A.F.F. MAXIMUM. GAS FIRE PLACE, DIRECT VENT SUPERIOR MODEL #DRT35PF WITH RUSTIC LINER, LCD
- 26. FIRE PROTECTION DRY STANDPIPE LOCATION WITH VALVES AT EACH LANDING, VERIFY WITH FIRE
- DEPARTMENT.

 27. PROVIDE OCCUPANT LOAD SIGNS IN POOL, LOBBY AND BREAKFAST AREA. DESIGN AND
- LOCATION SHALL BE APPROVED BY THE FIRE MARSHALL.

 28. PROVIDE DOOR SIGN (FIRE RISER/MECHANICAL ROOM) ON DOOR. PROVIDE A FIRE FLOW STROBE ABOVE DOOR AS DIRECTED BY THE FIRE MARSHALL.
- DE EMPLOYEE KITCHEN AREA WITH 4 BURNER RANGE.
- EMPLOYEE STACKABLE WASHER/DRYER UNITS. RECESSED WALK-OFF MAT WITH FLOOR DRAIN.

THERMOSTATIC REMOTE, STANDARD BLOWER.

- RECESSED WALK-OFF MAT WITH FLOOR DRAIN.

 WALK-IN FREEZER WITH INSULATED FLOOR AND ENTRY RAMP. REMOTE CONDENSER SHALL BE
- 33. (2)~4" CONDUITS TO FUTURE HOTEL NETWORK/SERVER ROOM.

GENERAL NOTES:

- FINISHED FLOOR ELEVATION IS INDICATED AS 100'-0" FOR REFERENCE ONLY. SEE CIVIL DRAWINGS FOR ACTUAL ELEVATION OF FINISHED FLOOR.
- ALL DIMENSIONS ARE TO CENTERLINE OF STUDS AND COLUMNS OR FACE OF FINISHED WALLS U.N.O. (FACE OF SHEATHING AT EXTERIOR FACE OF EXTERIOR WALLS).

 T.G. INDICATES TEMPERED GLASS LOCATIONS
- T.G. INDICATES TEMPERED GLASS LOCATIONS. ALUMINUM WINDOWS TO BE THERMALLY BROKEN INSULATED WINDOWS. PROVIDE FIRE ALARM HORNS AND STROBES IN ALL WHEEL CHAIR & HEARING LOSS ACCESSIBLE
- PROVIDE FIRE ALARM HORNS AND STROBES IN ALL WHEEL CHAIR & HEARING LOSS ACCESSIBL ROOMS, INCLUDING TOILET ROOMS.
 SEE A3.# SHEETS FOR ENLARGED GUEST ROOM AND COMMON AREA PLANS.
- G. SEE A5.# SHEETS FOR TYPICAL GUEST ROOM INTERIOR ELEVATIONS.
 H. SEE APPROVED INTERIOR DESIGN DRAWINGS FOR ALL FINISHES.
- POOL DRAWING SHALL BE SUBMITTED TO FRANCHISE FOR APPROVAL. POOLS MUST UTILIZE ANTI-VORTEX DRAIN COVERS COMPLIANT WITH ASME A112.19.8-2007. DRAWINGS SHALL INCLUDE ALL DECK AND SUB-SURFACE DRAINAGE DETAILS (2 DRAINS MINIMUM IN POOL AND SPA), SAFETY EQUIPMENT, SIGNAGE, UNDERWATER LIGHTING, DEPTH MARKINGS, "NO DIVING" SYMBOLS, ADA
- LIFTS, FURNITURE, ETC. A LIQUID POOL COVER, HEATSAVR OR EQUAL, IS REQUIRED.
 CONTRACTOR IS REQUIRED TO FOLLOW ALL ITEMS NOTED IN THE LATEST BRAND STANDARDS
 MANUAL WHETHER NOTED IN THE CONSTRUCTION DRAWINGS OR NOT. THIS INCLUDES ALL
 TECHNICAL REQUIREMENTS.
- SEE SHEET A0-6.0 FOR MINIMUM PERFORMANCE SPECIFICATIONS AND REQUIREMENTS.

WALL FIRE RATING LEGEND

X WALL TYPE, SEE SHEET A0.2

NOTE: PROVIDE WALL MARKING AS PER 9/A0.2 ABOVE ACCESSIBLE CEILINGS FOR ALL FIRE PARTITIONS AND

INCIDENTAL USE SEPARATION WALL "SMOKE RESISTANT" PER IBC 509.4.2. (COMMERCIAL LAUNDRY)

1 HOUR RATED FIRE PARTITION "RESIDENTIAL CORRIDORS, ELEVATOR LOBBY, GUEST ROOM

FIRE BARRIERS. SEE DESIGN DATA "CHAPTER 7" AND FLOOR PLANS FOR MORE INFORMATION ON WALL TYPES

SEPARATION WALLS".

1 HOUR FIRE BARRIER (LINEN CHUTE ACCESS ROOMS, 3-STORY MECHANICAL SHAFTS).

2 HOUR FIRE BARRIER (STAIRWELLS, ELEVATOR SHAFT, 4-STORY MECHANICAL SHAFTS, LINEN CHUTE, LINEN CHUTE DISCHARGE ROOM).

	· · · · · · · · · · · · · · · · · · ·												
	ROOM TYPE MATRIX												
FLOOR	KING	KING/ KING	KING SUITE	KING/ KING SUITE	KING ACC. ROLL-IN #214	KING/ KING ADA #225, #325	KING SUITE ADA #303	KING/ KING SUITE ADA #425	FLC TO				
1ST		4		2					(
2ND	3	15	4	3	1	1			2				
3RD	3	16	3	3		1	1		2				
4TH	3	16	4	3				1	2				
TOTAL	9	51	11	11	1	2	1	1	8				

= 5

WHEEL CHAIR ACCESSIBLE (MOBILITY FEATURES) 76 TO 100 TOTAL GUEST ROOMS = 5 ROOMS (4 TRANSFER TUBS + 1 ROLL-IN SHOWER REQUIRED).

HEARING LOSS ACCESSIBLE (COMMUNICATION FEATURES) 76 TO 100 TOTAL GUEST ROOMS = 9 ROOMS REQUIRED (ONLY 1 ROOM THAT IS ALSO A WHEEL CHAIR ACCESSIBLE ROOM MAY COUNT TOWARDS THE TOTAL REQUIRED NUMBER PER 2010 ADAAG SECTION 224.5. 1 KING ROOM (#224), 5 KING/KING ROOMS (#200, 209, 300, 309, 400), 1 KING SUITE (#320) AND 1 KING/KING SUITE (#412) ALONG WITH ALL OF THE MOBILITY ROOMS ARE PROVIDED WITH COMMUNICATION



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Holiday Inn Express & Suites Site Development Package Location: 9022700, Inn Code SBSSG 3400 S. LINCOLN AVE STEAMBOAT SPRINGS. CO 80487

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DRAWING ISSUE DATES: 4/4/22 Site Development Package 6/23/22 Site Development Revisions

<u>DRAWING REVISION DATES:</u>

PROJECT MANAGER:
NICK PIRKL
DRAWN BY:

27 SHEET TITLE: 2ND FLOOR

A1.2

SHEET: 18 OF



		PROJ	IECT DATA			
Chapter 3 - Use and	Туре	Sq. Ft.				
Occupancy Classification	A-2	1,250	Breakfast area, meeting room			
	A-3	2,750	Lobby,Market, Elev. Lobby, Pool			
	В	7,930	Offices, Laundry, work room, Fitness, Game Room, etc.			
	R-1	2,870	Guest Rooms and residential corridors			
1st floor total		14,800				
2nd - 4th floors	R-1	14,383	Each Floor			
Chapter 5 - General Building						
Heights and Areas	Height	63' max	55'-9" Actual Height			
	Stories	4				
	Area	57,949	Total Building Area			
Chapter 6 - Types of		V-A	Wood construction			
Construction		V-A	Wood Construction			
Chapter 9 - Fire Protection		Sec. 903	Puilding will be fully enriptlered per NEDA 13			
Systems		3 8 6, 303	Building will be fully sprinklered per NFPA 13			
		Appendix	Base fire flow = 4,250 GPM. Reduce to 25% per table B105.2			
			= 1063 GPM @ 2hr duration required. 1 hydrant required per			
		B105.1(2)	C102.1.			

Information above based on the 2018 International Building Code

OFLOOR PLAN KEYED NOTES:

- KAWNEER VG 451 FRONT PLANE GLAZING SYSTEM, TYPICAL AT ALL EXTERIOR STOREFRONT AND WINDOW LOCATIONS. PROVIDE TEMPERED GLASS AS SHOWN ON ELEVATIONS.
- 1 1/2" DIAMETER PAINTED STEEL HANDRAIL AND GUARDRAILS.
- VALIANT 24" DIAMETER FACTORY FABRICATED LINEN CHUTE WITH 90 MINUTE RATED 24"X30" LINEN DISCHARGE DOOR AT GROUND LEVEL AND 90 MINUTE RATED 18"X18" LINEN CHUTE ACCESS DOORS @ 2ND - 4TH FLOORS. DOORS SHALL BE SELF CLOSING AND SELF LATCHING. PROVIDE SPRINKLER HEADS IN CHUTE.
- PROVIDE KNOX BOX AS DIRECTED BY THE FIRE MARSHALL
- CORRIDOR FIRE DOORS ON MAGNETIC HOLD-OPEN DEVICES. PROVIDE A CARBON MONOXIDE DETECTOR AT LOCATIONS SHOWN, MINIMUM
- ELEVATORS TO HAVE 42" WIDE DOORS AND SHALL BE SCHINDLER MRL TRACTION TYPE WITH 150 FPM RATED SPEED. ELEVATOR #1 SHALL BE 3500# FRONT OPENING SIZED FOR AMBULANCE STRETCHER ACCESS AND IDENTIFIED BY THE INTERNATIONAL SYMBOL FOR EMERGENCY MEDICAL SERVICES "STAR OF LIFE" PER IBC 3002.4. ELEVATOR #2 SHALL BE 3000# FRONT OPENING. VERIFY ALL REQUIREMENTS WITH SUPPLIER PRIOR TO CONSTRUCTION. PROVIDE HANDRAIL ON REAR WALL AT 32" A.F.F. MINIMUM. PROVIDE SIGN "DO NOT USE IN CASE OF FIRE". PROVIDE 2-WAY COMMUNICATION AS PER THE IFC ON 2ND - 4TH FLOORS ADJACENT TO ELEVATOR DOORS. SYSTEM AND LOCATION SHALL BE APPROVED BY THE FIRE AUTHORITY. PROVIDE PICTORIAL SIGN "IN FIRE EMERGENCY, DO NOT USE ELEVATOR, USE EXIT STAIRS" COMPLYING WITH IBC 3002.3. FINAL DESIGN SHALL BE APPROVED BY THE FIRE AUTHORITY.
 - FINAL FITNESS ROOM LAYOUT SHALL COMPLY WITH IHG FITNESS STANDARDS . ALL FINISHES SHALL COMPLY WITH STANDARDS. PROPOSED LOCATION OF WALL MOUNTED HOUSE PHONE MOUNTED @ 48" A.F.F. TYPICAL. PHONE SHALL RING @ FRONT DESK.
- POOL LADDER AND HANDRAILS. ACCESSIBLE POOL AND/OR SPA STAIRS WITH 1 1/2" DIAMETER S/S HANDRAILS. CLEAR DECK SPACE SLOPE TO TRENCH AND/OR AREA DRAINS 1/4" PER FOOT MAXIMUM, TYPICAL. 5'-0" CLEAR AROUND POOL AND SPA. FINAL DESIGN OF POOL AND DECK MUST MEET ALL STATE
- AND IHG DESIGN STANDARDS AND REQUIREMENTS. TACTILE EXIT SIGN PER IBC 1011.3 @ EACH STAIRWELL DOOR AND EXIT DOOR. WALL MOUNTED HDTV TELEVISION. CONCEAL ALL POWER/CABLE CONNECTIONS.
- TOWEL AND HAMPER CABINET LOCATION. FRONT LOADED WASHER AND DRYER, ADA ACCESSIBLE.

SHALL ACTIVATE UPON FIRE SPRINKLER WATER FLOW.

- STAIRWELL SIGN MOUNTED @ 5'-0" A.F.F. AT EACH FLOOR NEXT TO DOOR AS SHOWN. SEE DETAIL 1/A1.1 FOR INFORMATION. FINAL DESIGN SHALL BE APPROVED BY THE FIRE MARSHALL. PROPOSED LOCATION OF FIRE ALARM CONTROL PANEL, VERIFY WITH FIRE MARSHALL. SYSTEM
- STACKABLE WASHER/DRYER UNITS, TYPICAL OF (4). PROVIDE HANDICAP ACCESSIBLE LIFT FOR POOL AND SPA, VERIFY INSTALLATION DETAILS WITH
- MAIN ENTRY CARD READER LOCATION WITH INTERCOM TO FRONT DESK.
- EMPLOYEE LOCKERS (10), 2.5 CUBIC FOOT MINIMUM.
- WATER COOLER LOCATION.

LOCATION SHALL BE APPROVED BY THE FIRE MARSHALL.

- PLASTIC LAMINATE FOLDING COUNTER OVER ADA WASHER DRYERS AND ADJACENT TO EQUIPMENT AS SHOWN. ACCESSIBLE COUNTER SHALL BE 34" A.F.F. MAXIMUM. GAS FIRE PLACE, DIRECT VENT SUPERIOR MODEL #DRT35PF WITH RUSTIC LINER, LCD THERMOSTATIC REMOTE, STANDARD BLOWER.
- FIRE PROTECTION DRY STANDPIPE LOCATION WITH VALVES AT EACH LANDING, VERIFY WITH FIRE
- PROVIDE OCCUPANT LOAD SIGNS IN POOL, LOBBY AND BREAKFAST AREA. DESIGN AND
- PROVIDE DOOR SIGN (FIRE RISER/MECHANICAL ROOM) ON DOOR. PROVIDE A FIRE FLOW STROBE ABOVE DOOR AS DIRECTED BY THE FIRE MARSHALL.
- EMPLOYEE KITCHEN AREA WITH 4 BURNER RANGE. EMPLOYEE STACKABLE WASHER/DRYER UNITS.
- RECESSED WALK-OFF MAT WITH FLOOR DRAIN.
- WALK-IN FREEZER WITH INSULATED FLOOR AND ENTRY RAMP. REMOTE CONDENSER SHALL BE
- 33. (2)~4" CONDUITS TO FUTURE HOTEL NETWORK/SERVER ROOM.

GENERAL NOTES:

- FINISHED FLOOR ELEVATION IS INDICATED AS 100'-0" FOR REFERENCE ONLY. SEE CIVIL DRAWINGS FOR ACTUAL ELEVATION OF FINISHED FLOOR.
- ALL DIMENSIONS ARE TO CENTERLINE OF STUDS AND COLUMNS OR FACE OF FINISHED WALLS U.N.O. (FACE OF SHEATHING AT EXTERIOR FACE OF EXTERIOR WALLS). T.G. INDICATES TEMPERED GLASS LOCATIONS.
- ALUMINUM WINDOWS TO BE THERMALLY BROKEN INSULATED WINDOWS. PROVIDE FIRE ALARM HORNS AND STROBES IN ALL WHEEL CHAIR & HEARING LOSS ACCESSIBLE
- ROOMS, INCLUDING TOILET ROOMS.
- SEE A3.# SHEETS FOR ENLARGED GUEST ROOM AND COMMON AREA PLANS. SEE A5.# SHEETS FOR TYPICAL GUEST ROOM INTERIOR ELEVATIONS. SEE APPROVED INTERIOR DESIGN DRAWINGS FOR ALL FINISHES.
- POOL DRAWING SHALL BE SUBMITTED TO FRANCHISE FOR APPROVAL. POOLS MUST UTILIZE ANTI-VORTEX DRAIN COVERS COMPLIANT WITH ASME A112.19.8-2007. DRAWINGS SHALL INCLUDE ALL DECK AND SUB-SURFACE DRAINAGE DETAILS (2 DRAINS MINIMUM IN POOL AND SPA), SAFETY EQUIPMENT, SIGNAGE, UNDERWATER LIGHTING, DEPTH MARKINGS, "NO DIVING" SYMBOLS, ADA
- LIFTS, FURNITURE, ETC. A LIQUID POOL COVER, HEATSAVR OR EQUAL, IS REQUIRED. CONTRACTOR IS REQUIRED TO FOLLOW ALL ITEMS NOTED IN THE LATEST BRAND STANDARDS MANUAL WHETHER NOTED IN THE CONSTRUCTION DRAWINGS OR NOT. THIS INCLUDES ALL TECHNICAL REQUIREMENTS.
- K. SEE SHEET A0-6.0 FOR MINIMUM PERFORMANCE SPECIFICATIONS AND REQUIREMENTS.

WALL FIRE RATING LEGEND

WALL TYPE, SEE SHEET A0.2

NOTE: PROVIDE WALL MARKING AS PER 9/A0.2 ABOVE ACCESSIBLE CEILINGS FOR ALL FIRE PARTITIONS AND

- FIRE BARRIERS. SEE DESIGN DATA "CHAPTER 7" AND FLOOR PLANS FOR MORE INFORMATION ON WALL TYPES INCIDENTAL USE SEPARATION WALL "SMOKE RESISTANT" PER IBC 509.4.2. (COMMERCIAL LAUNDRY — • — 1 HOUR RATED FIRE PARTITION "RESIDENTIAL CORRIDORS, ELEVATOR LOBBY, GUEST ROOM
- SEPARATION WALLS". 1 HOUR FIRE BARRIER (LINEN CHUTE ACCESS ROOMS, 3-STORY MECHANICAL SHAFTS). 2 HOUR FIRE BARRIER (STAIRWELLS, ELEVATOR SHAFT, 4-STORY MECHANICAL SHAFTS, LINEN CHUTE, LINEN CHUTE DISCHARGE ROOM).

	ONOTE, ENERGINATE BIOGRANGE ROOMS.													
	ROOM TYPE MATRIX													
FLOOR	KING	KING/ KING	KING SUITE	KING/ KING SUITE	KING ACC. ROLL-IN #214	KING/ KING ADA #225, #325	KING SUITE ADA #303	KING/ KING SUITE ADA #425	FLOOR TOTAL					
1ST		4		2					6					
2ND	3	15	4	3	1	1			27					
3RD	3	16	3	3		1	1		27					
4TH	3	16	4	3				1	27					
TOTAL	9	51	11	11	1	2	1	1	87					

WHEEL CHAIR ACCESSIBLE (MOBILITY FEATURES) 76 TO 100 TOTAL GUEST ROOMS = 5 ROOMS (4 TRANSFER TUBS + 1 ROLL-IN SHOWER REQUIRED).

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DRAWING ISSUE DATES: 4/4/22 Site Development Package 6/23/22 Site Development Revisions

DRAWING REVISION DATES:

PROJECT MANAGER: NICK PIRKL

3RD FLOOR

SHEET: 19 OF



PROJECT DATA									
Chapter 3 - Use and	Туре	Sq. Ft.							
Occupancy Classification	A-2	1,250	Breakfast area, meeting room						
	A-3	2,750	Lobby,Market, Elev. Lobby, Pool						
	В	7,930	Offices, Laundry, work room, Fitness, Game Room, etc.						
	R-1	2,870	Guest Rooms and residential corridors						
1st floor total		14,800							
2nd - 4th floors	R-1	14,383	Each Floor						
Chapter 5 - General Building									
Heights and Areas	Height	63' max	55'-9" Actual Height						
!	Stories	4							
	Area	57,949	Total Building Area						
Chapter 6 - Types of		V-A	Wood construction						
Construction	!	V-77	Wood Construction						
Chapter 9 - Fire Protection		Sec. 903	Building will be fully sprinklered per NFPA 13						
Systems		360. 900	Building will be fully spilliniered per Ni 1 A 10						
!		Appendix	Base fire flow = 4,250 GPM. Reduce to 25% per table B105.2						
!			= 1063 GPM @ 2hr duration required. 1 hydrant required per						
	!	B105.1(2)	C102.1.						

Information above based on the 2018 International Building Code

OFLOOR PLAN KEYED NOTES:

- KAWNEER VG 451 FRONT PLANE GLAZING SYSTEM, TYPICAL AT ALL EXTERIOR STOREFRONT AND WINDOW LOCATIONS. PROVIDE TEMPERED GLASS AS SHOWN ON ELEVATIONS.
- 1 1/2" DIAMETER PAINTED STEEL HANDRAIL AND GUARDRAILS. VALIANT 24" DIAMETER FACTORY FABRICATED LINEN CHUTE WITH 90 MINUTE RATED 24"X30"
- LINEN DISCHARGE DOOR AT GROUND LEVEL AND 90 MINUTE RATED 18"X18" LINEN CHUTE ACCESS DOORS @ 2ND - 4TH FLOORS. DOORS SHALL BE SELF CLOSING AND SELF LATCHING. PROVIDE SPRINKLER HEADS IN CHUTE.
- PROVIDE KNOX BOX AS DIRECTED BY THE FIRE MARSHALL
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- PHONE SHALL RING @ FRONT DESK. POOL LADDER AND HANDRAILS.
- ACCESSIBLE POOL AND/OR SPA STAIRS WITH 1 1/2" DIAMETER S/S HANDRAILS. CLEAR DECK SPACE SLOPE TO TRENCH AND/OR AREA DRAINS 1/4" PER FOOT MAXIMUM, TYPICAL. 5'-0" CLEAR AROUND POOL AND SPA. FINAL DESIGN OF POOL AND DECK MUST MEET ALL STATE AND IHG DESIGN STANDARDS AND REQUIREMENTS.
- TACTILE EXIT SIGN PER IBC 1011.3 @ EACH STAIRWELL DOOR AND EXIT DOOR. WALL MOUNTED HDTV TELEVISION. CONCEAL ALL POWER/CABLE CONNECTIONS. TOWEL AND HAMPER CABINET LOCATION.
- FRONT LOADED WASHER AND DRYER, ADA ACCESSIBLE.

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- U.N.O. (FACE OF SHEATHING AT EXTERIOR FACE OF EXTERIOR WALLS). T.G. INDICATES TEMPERED GLASS LOCATIONS.
- ALUMINUM WINDOWS TO BE THERMALLY BROKEN INSULATED WINDOWS. PROVIDE FIRE ALARM HORNS AND STROBES IN ALL WHEEL CHAIR & HEARING LOSS ACCESSIBLE
- ROOMS, INCLUDING TOILET ROOMS. SEE A3.# SHEETS FOR ENLARGED GUEST ROOM AND COMMON AREA PLANS.
- SEE A5.# SHEETS FOR TYPICAL GUEST ROOM INTERIOR ELEVATIONS. SEE APPROVED INTERIOR DESIGN DRAWINGS FOR ALL FINISHES. POOL DRAWING SHALL BE SUBMITTED TO FRANCHISE FOR APPROVAL. POOLS MUST UTILIZE
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- MANUAL WHETHER NOTED IN THE CONSTRUCTION DRAWINGS OR NOT. THIS INCLUDES ALL TECHNICAL REQUIREMENTS. SEE SHEET A0-6.0 FOR MINIMUM PERFORMANCE SPECIFICATIONS AND REQUIREMENTS.

WALL FIRE RATING LEGEND

WALL TYPE, SEE SHEET A0.2

NOTE: PROVIDE WALL MARKING AS PER 9/A0.2 ABOVE ACCESSIBLE CEILINGS FOR ALL FIRE PARTITIONS AND

INCIDENTAL USE SEPARATION WALL "SMOKE RESISTANT" PER IBC 509.4.2. (COMMERCIAL LAUNDRY — • — 1 HOUR RATED FIRE PARTITION "RESIDENTIAL CORRIDORS, ELEVATOR LOBBY, GUEST ROOM

FIRE BARRIERS. SEE DESIGN DATA "CHAPTER 7" AND FLOOR PLANS FOR MORE INFORMATION ON WALL TYPES

SEPARATION WALLS". 1 HOUR FIRE BARRIER (LINEN CHUTE ACCESS ROOMS, 3-STORY MECHANICAL SHAFTS). 2 HOUR FIRE BARRIER (STAIRWELLS, ELEVATOR SHAFT, 4-STORY MECHANICAL SHAFTS, LINEN CHUTE, LINEN CHUTE DISCHARGE ROOM).

					•							
ROOM TYPE MATRIX												
FLOOR	KING	KING/ KING	KING SUITE	KING/ KING SUITE	KING ACC. ROLL-IN #214	KING/ KING ADA #225, #325	KING SUITE ADA #303	KING/ KING SUITE ADA #425	FLOOR TOTAL			
1ST		4		2					6			
2ND	3	15	4	3	1	1			27			
3RD	3	16	3	3		1	1		27			
4TH	3	16	4	3				1	27			
TOTAL	9	51	11	11	1	2	1	1	87			

WHEEL CHAIR ACCESSIBLE (MOBILITY FEATURES) 76 TO 100 TOTAL GUEST ROOMS = 5 ROOMS (4 TRANSFER TUBS + 1 ROLL-IN SHOWER REQUIRED).

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515 <u>0</u>25.⊢

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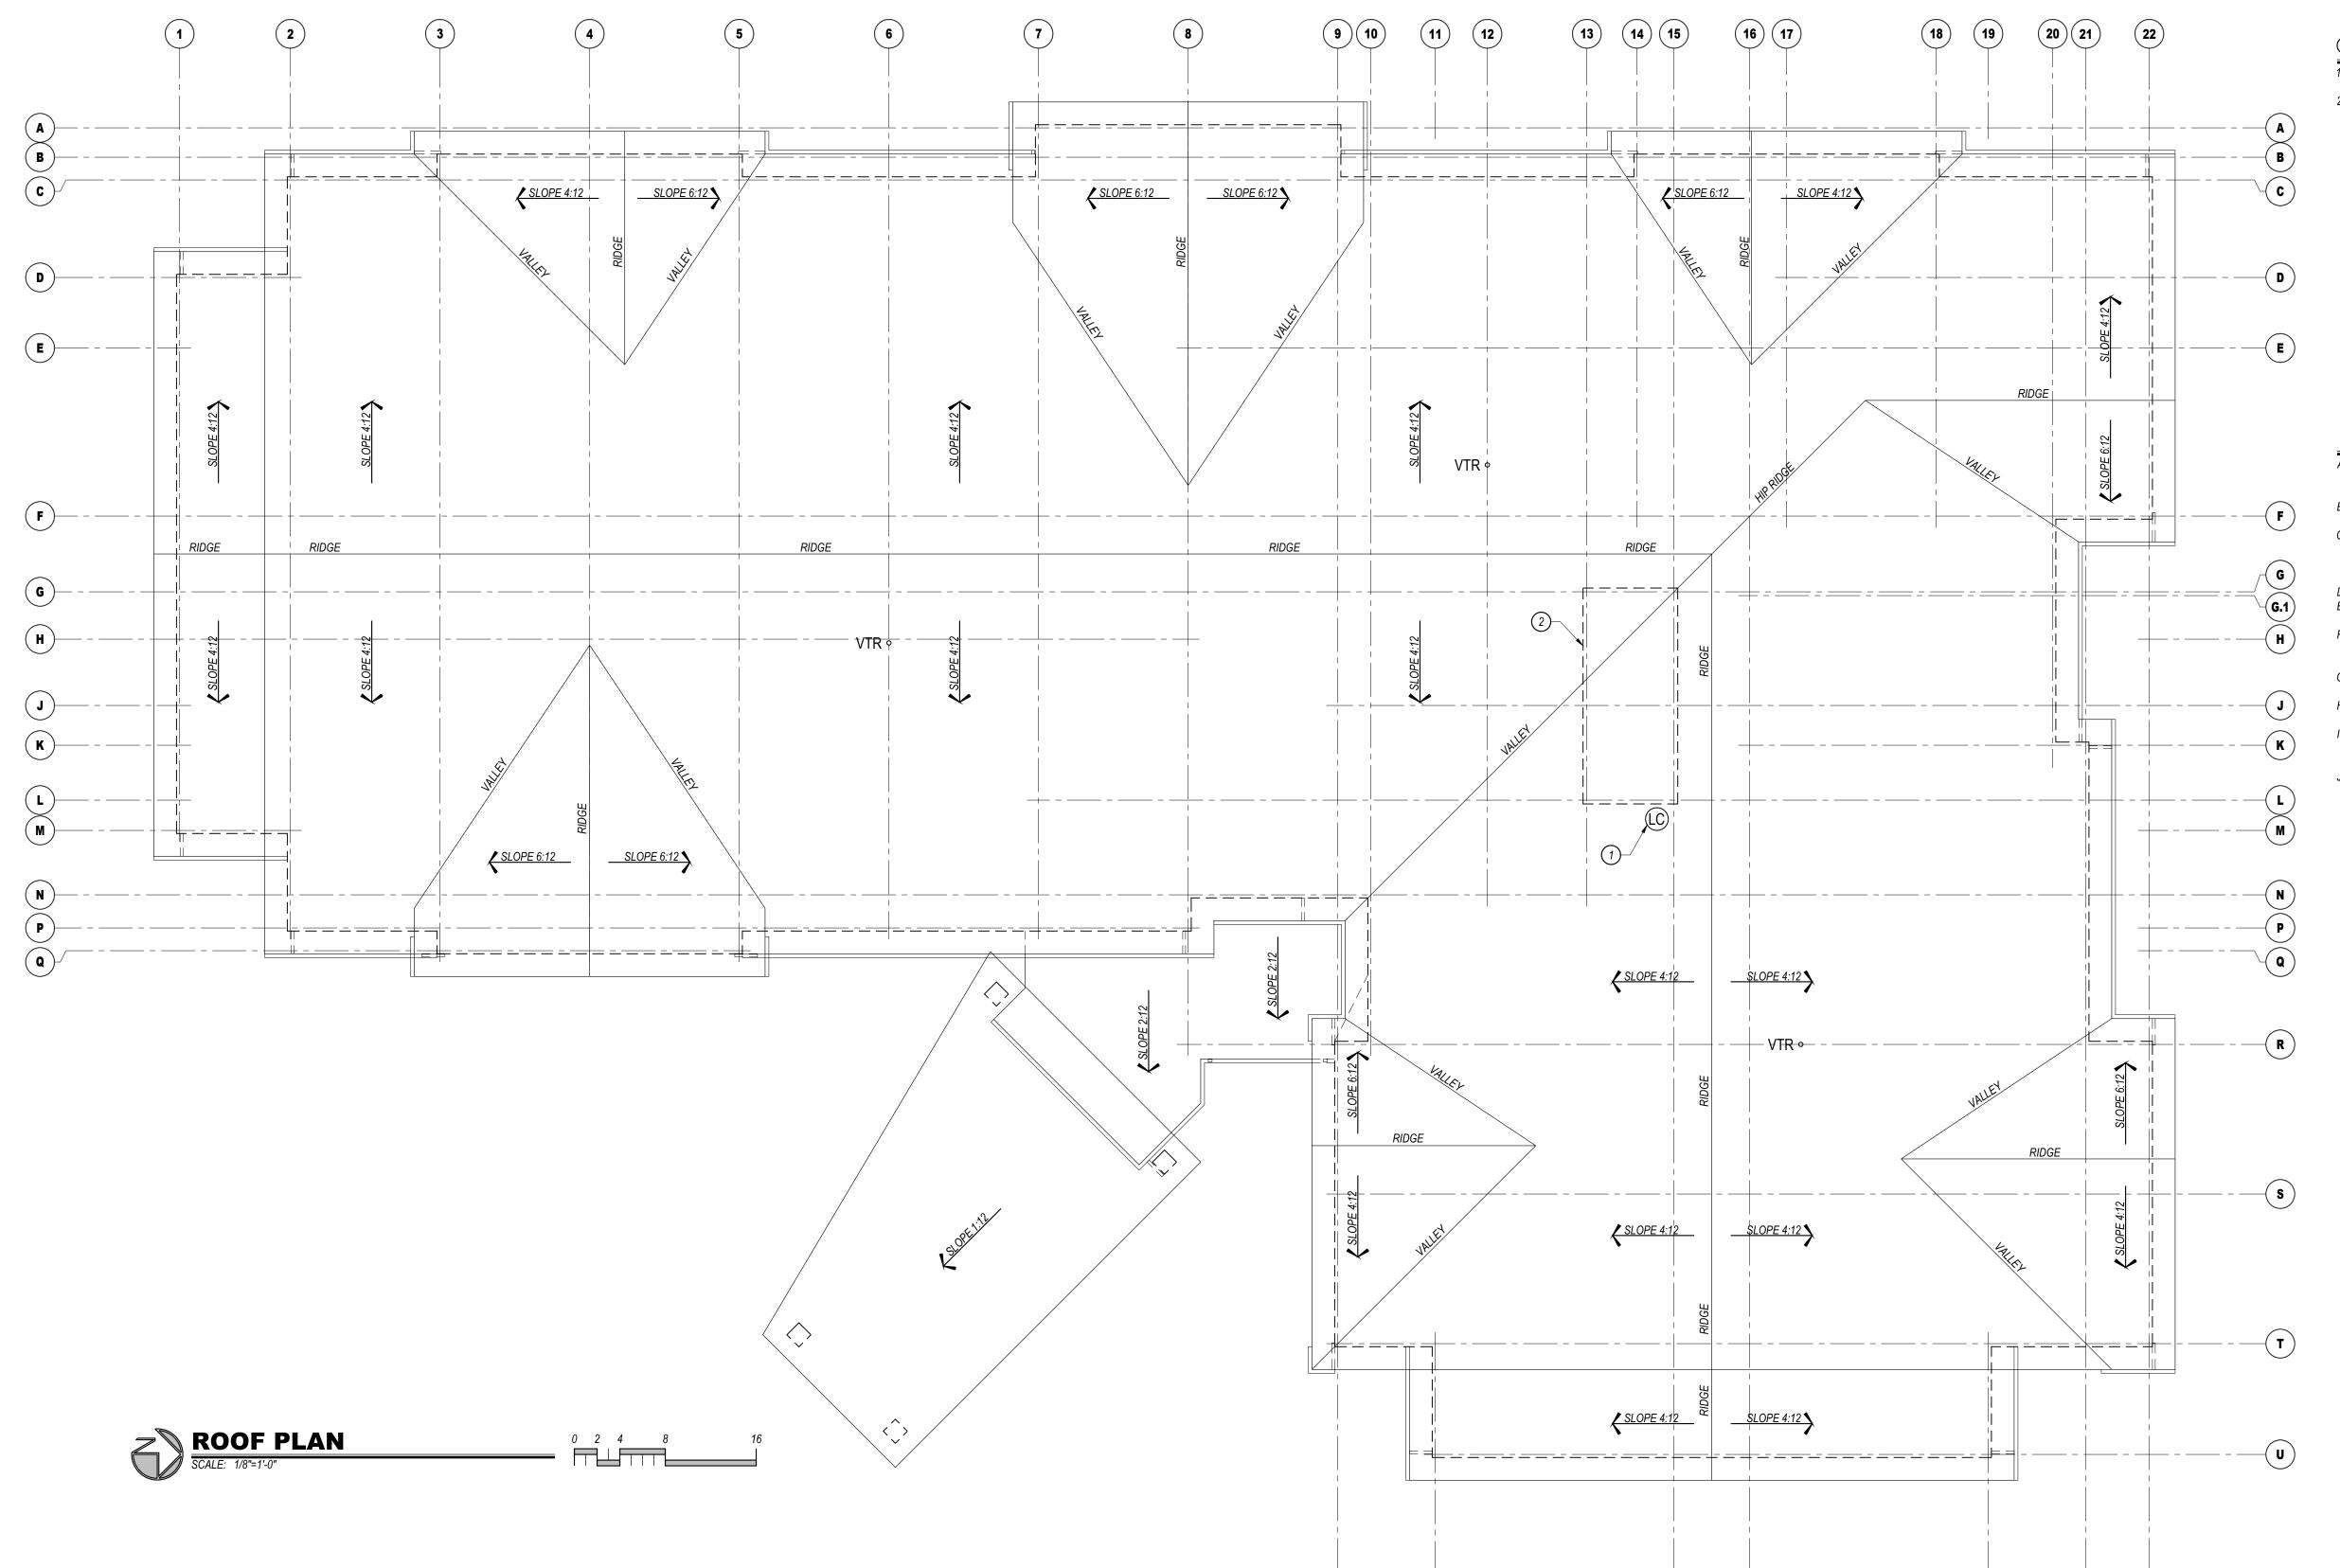
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DRAWING ISSUE DATES: 4/4/22 Site Development Package 6/23/22 Site Development Revisions

DRAWING REVISION DATES:

NICK PIRKL

SHEET: 20 OF



9

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16

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22

19

O ROOF PLAN KEYED NOTES:

- LINEN CHUTE VENT LOCATION, PROVIDE WITH FACTORY RAIN CAP. CHUTE MUST EXTEND 36" MINIMUM ABOVE ROOF SURFACE. ROOF TRUSSES OVER ELEVATOR SHAFTS SHALL BE DESIGNED TO ACCOMMODATE THE HEIGHT OF THE SHAFT.



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GENERAL NOTES:

- PITCHED ROOFING SHALL BE GAF TIMBERLINE HDZ ARCHITECTURAL ASPHALT SHINGLE AND SHALL INCLUDE STARTER STRIP SHINGLES AND RIDGE CAP SHINGLES. SEE ELEVATIONS FOR
- PROVIDE ICE PROTECTION, GAF STORMGUARD OR EQUAL, ACROSS ENTIRE ROOF SURFACE INCLUDING ALL VALLEYS, RIDGES, HIPS, ETC.
- PROVIDE GAF COBRA SNOWCOUNTRY RIDGE ATTIC VENTING (240 L.F. MINIMUM). EQUALLY DISPERSE VENTS BETWEEN EAVE VENTS (30 S.F. NET FREE AREA REQUIRED) AND RIDGE VENTS MINIMUM SPACE BETWEEN UNDERSIDE OF ROOF SHEATHING AND INSULATION.
- PORTE COCHERE ROOFING SHALL BE METAL STANDING SEAM RATED FOR 1:12 SLOPE. INSTALLATION OF ALL ROOFING MATERIALS AND COMPONENTS SHALL BE AS PER EACH INDIVIDUAL MANUFACTURER'S RECOMMENDATIONS.
- PROVIDE PERIMETER SNOW MELT SYSTEM ALL ALL ROOF EAVES AND ALONG ENTIRE PORTE COCHERE AND ENTRY ROOFS AT 2:12 SLOPE OR LESS. SNOW MELT SHALL EXTEND INTO GUTTERS AND DOWNSPOUTS AS PER MANUFACTURER'S RECOMMENDATIONS.
- COORDINATE SIZE AND LOCATION AND INSTALLATION REQUIREMENT OF SATELLITE DISH PROVIDED BY AV CONTRACTOR.
- ATTIC INSULATION SHALL BE INSTALLED SO AS NOT TO INTERRUPT AIR FLOW THROUGH ROOF PROVIDE PRE-FINISHED GUTTERS AND DOWNSPOUTS AROUND THE ENTIRE ROOF PERIMETER, INCLUDING PORTE COCHERE AND ENTRANCE CANOPIES. DOWNSPOUTS SHALL DRAIN AWAY
- PAINT ALL ROOF PENETRATING ITEMS TO MATCH ROOF COLOR (PLUMBING VENTS, LINEN CHUTE

uit te Develor ocation: 90227 3400 S. I STEAMBOAT S

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DRAWING ISSUE DATES: 4/4/22 Site Development Package 6/23/22 Site Development Revisions

DRAWING REVISION DATES:

PROJECT MANAGER: NICK PIRKL


SHEET TITLE: ROOF PLAN

DRAWN BY:

SHEET: 21 OF



COLOR LEGEND

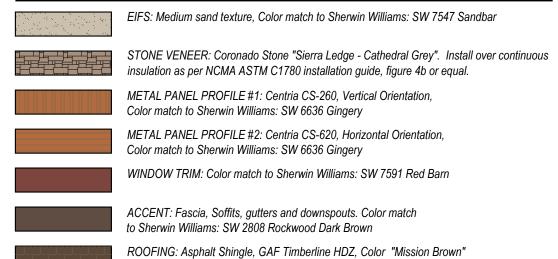

GENERAL NOTES:

signage prior to closing up the walls.

- A. See door and window schedules for door and window types. Doors, windows and louvers to be prefinished.

 All windows to be bronze aluminum with thermally broken frames.
- All windows to be bronze aluminum with thermally broken frames.

 B. Provide blocking and power for all exterior signage. All signage shall be as per hotel standards (size, color, ontinuous etc.). Signage shall be aluminum channels, internally lit (L.E.D.), with colored acrylic faces. Final sign package shall be submitted under separate sign permit for approval. Coordinate installation of exterior
 - C. Stucco system to be EIFS typical. Provide "V" joints as shown. Install as per manufacturers' requirements and details. Colors shall match paint colors noted.
 - and details. Colors shall match paint colors noted.

 Moisture resistant barrier (MRB) shall be liquid applied, typical throughout. Install as per manufacturers' requirements based on the finishes to be used. Utilize sheathing tape, flashing membrane, drain edge tape,
 - and other accessories as necessary for a complete single source system.

 E. Install stone as per manufacturers' recommendations. Provide a 30# felt slip barrier between stone base coat
 - and MRB if required by MRB manufacturer.
 Metal gutters and downspouts shall be pre-finished and shall match fascia color, typical. Pitch outlets away
 - from building foundation.

 G. Building lighting is primarily via wall mounted surface L.E.D. lights.

TRANSPARENCY CALCULATIONS

NOTE: STORY HEIGHT MEASUREMENTS TAKEN FROM FINISH FLOOR TO BOTTOM OF FLOOR/CEILING OR ROOF CEILING ASSEMBLY ABOVE.

GROUND FLOOR FRONT FACADE (US 40) = 40% REQUIRED


TOTAL SURFACE AREA = 173.9' X 12.17' (STORY HEIGHT) = 2,116 SQ. FT. TOTAL TRANSPARENT AREA PROVIDED = 847 SQ. FT. (40.0 %)

GROUND FLOOR OTHER FACADES = 30% REQUIRED


TOTAL SURFACE AREA = 408.5' X 12.17' (STORY HEIGHT) = 4,971 SQ. FT.


TOTAL TRANSPARENT AREA PROVIDED = 1,565 SQ. FT. (31.5 %)

UPPER FLOOR FACADES (ALL SIDES, 2ND STORY CALCULATIONS) = 25% REQUIRED TOTAL SURFACE AREA = 582.4' x 9' (STORY HEIGHT) = 5,242 SQ. FT. TOTAL TRANSPARENT AREA PROVIDED = 1,446 SQ. FT. (27.6 %)

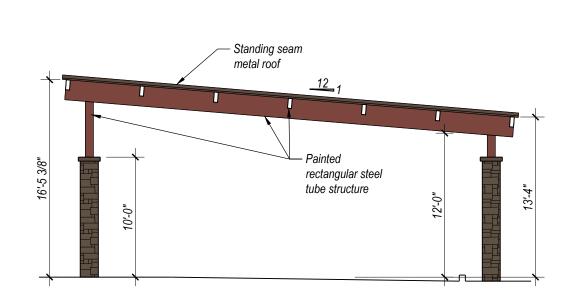



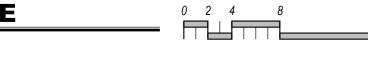

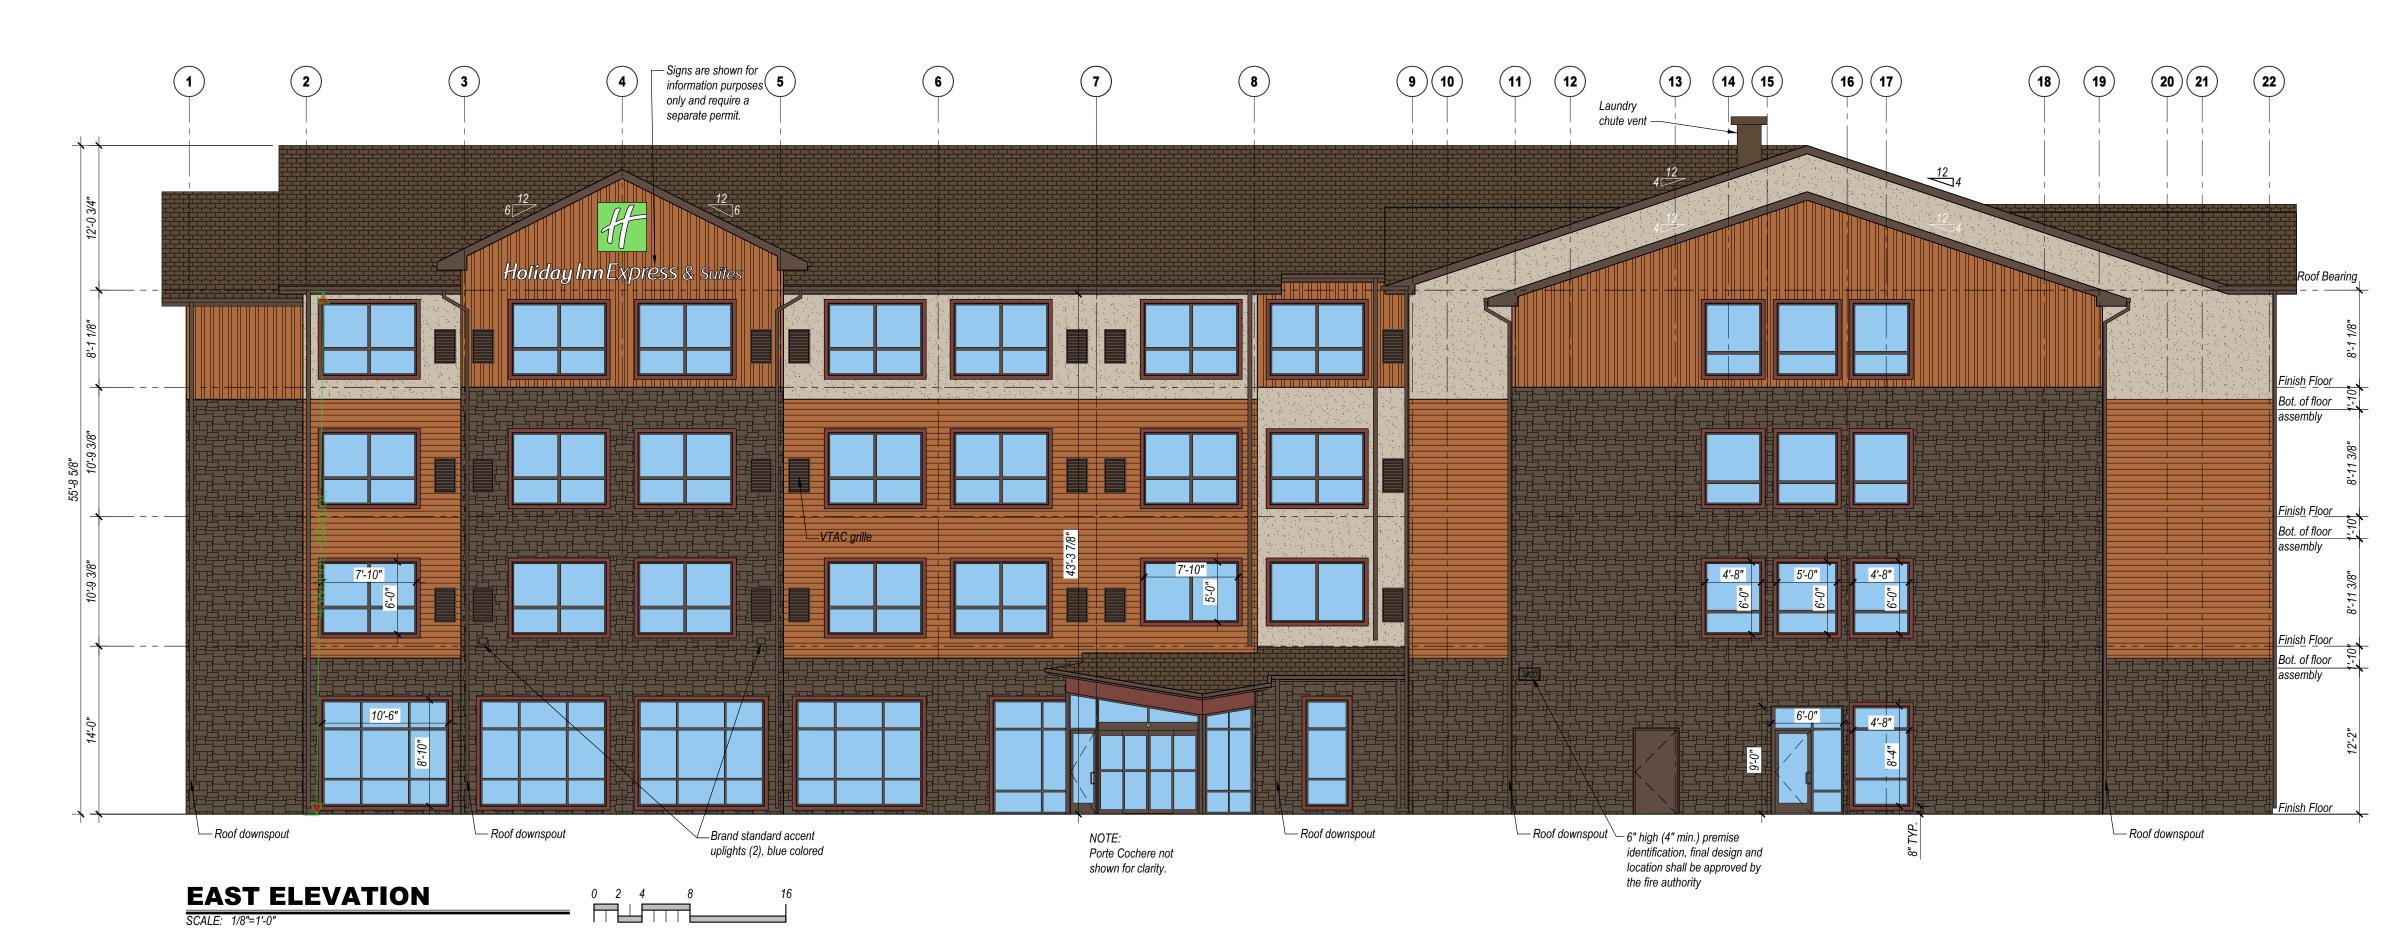



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Holiday Inn Express & Suites Site Development Package Location: 9022700, Inn Code SBSSG 3400 S. LINCOLN AVE STEAMBOAT SPRINGS, CO 80487

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DRAWING REVISION DATES:

PROJECT MANAGER: NICK PIRKL

DRAWN BY:

SOUTH AND EAST ELEVATIONS

A2.1

SHEET: 22 OF



COLOR LEGEND

EIFS: Medium sand texture, Color match to Sherwin Williams: SW 7547 Sandbar STONE VENEER: Coronado Stone "Sierra Ledge - Cathedral Grey". Install over continuous insulation as per NCMA ASTM C1780 installation guide, figure 4b or equal. METAL PANEL PROFILE #1: Centria CS-260, Vertical Orientation, Color match to Sherwin Williams: SW 6636 Gingery METAL PANEL PROFILE #2: Centria CS-620, Horizontal Orientation,

Color match to Sherwin Williams: SW 6636 Gingery WINDOW TRIM: Color match to Sherwin Williams: SW 7591 Red Barn

ACCENT: Fascia, Soffits, gutters and downspouts. Color match to Sherwin Williams: SW 2808 Rockwood Dark Brown ROOFING: Asphalt Shingle, GAF Timberline HDZ, Color "Mission Brown"

A2.2: Signage is not approved with this development plan, a separate sign permit will need to be applied for and reviewed for

GENERAL NOTES:

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 - and MRB if required by MRB manufacturer. Metal gutters and downspouts shall be pre-finished and shall match fascia color, typical. Pitch outlets away
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TRANSPARENCY CALCULATIONS


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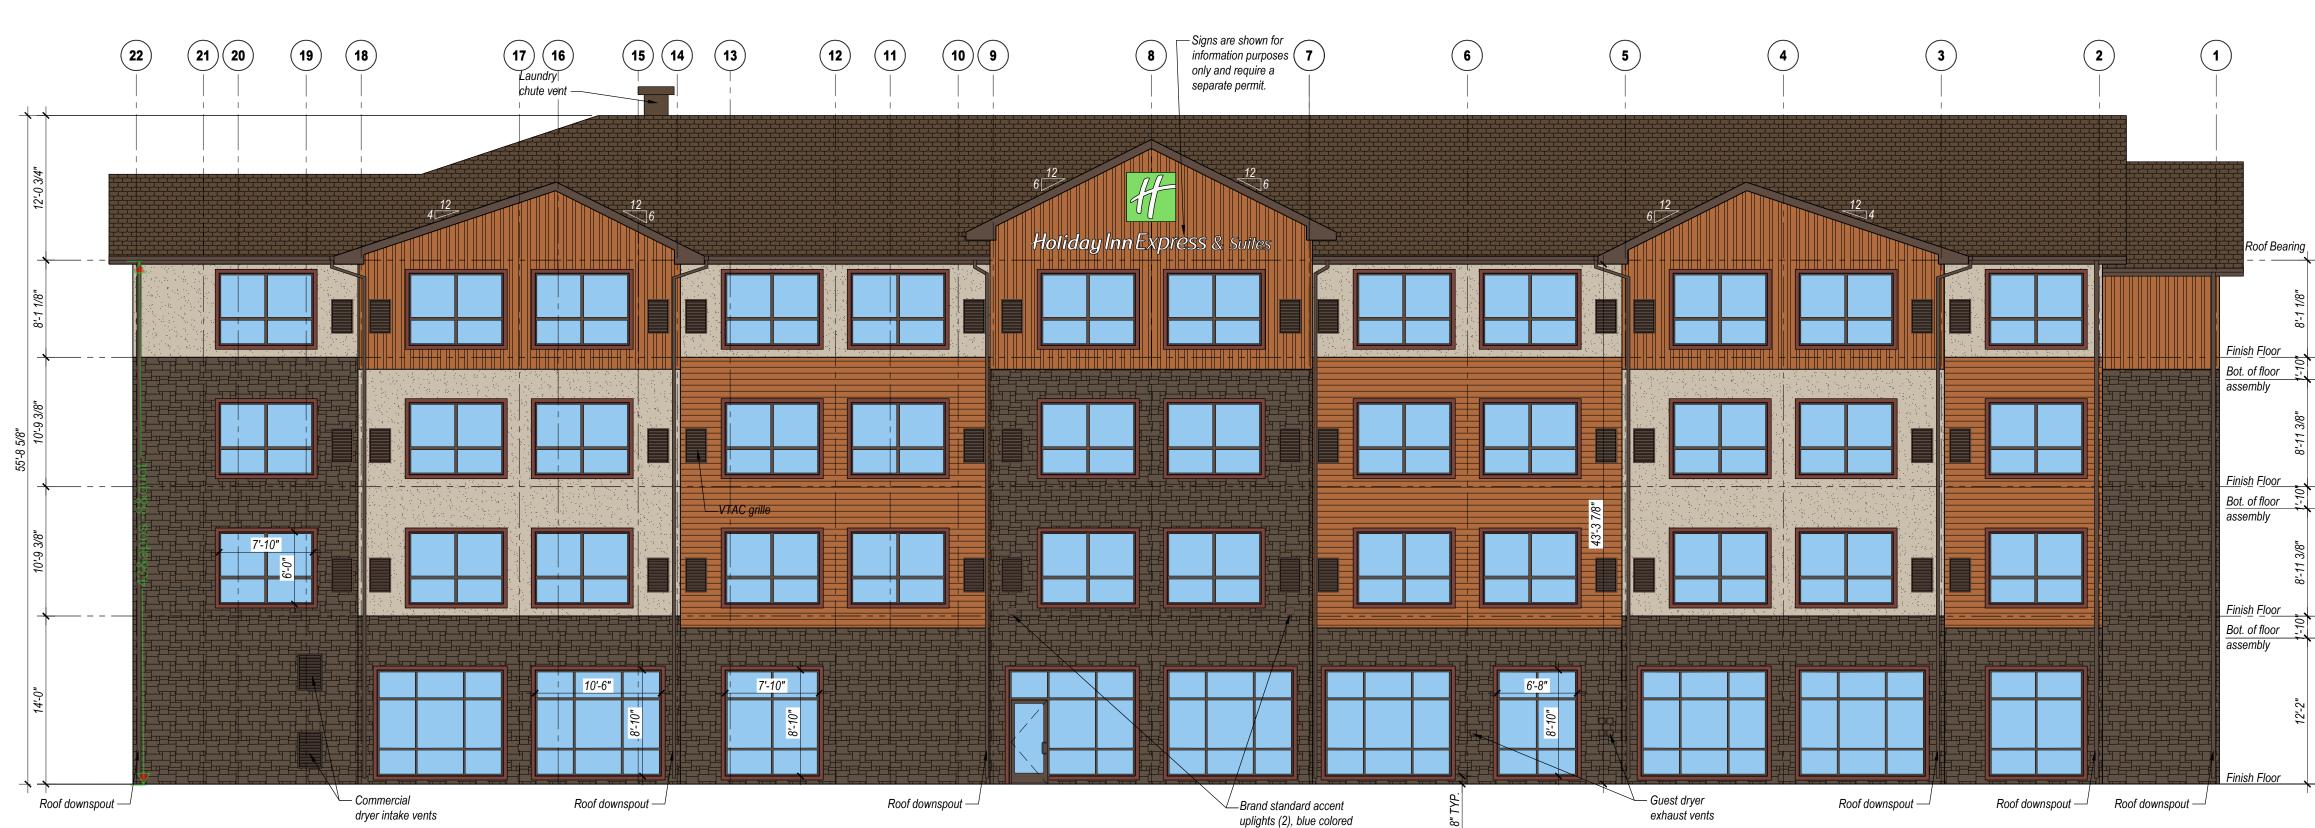
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REFUSE ENCLOSURE

PLAN, SECTION, AND ELEVATION



WEST ELEVATION

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DRAWING REVISION DATES.

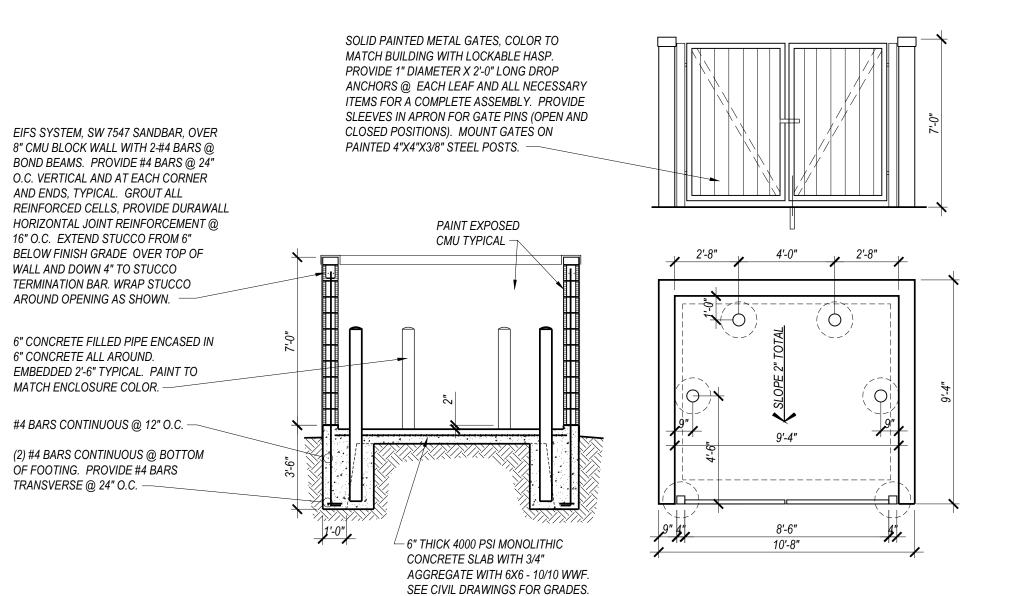PROJECT MANAGER: NICK PIRKL

DRAWN BY:

NORTH AND WEST ELEVATIONS

A2.2

SHEET: 23 OF



AERIAL VIEW

SCALE: NOT TO SCALE



STREET VIEW

SCALE: NOT TO SCALE



Holiday Inn Express & Suite: Site Development Package Location: 9022700, Inn Code SBSSG 3400 S. LINCOLN AVE STEAMBOAT SPRINGS, CO 80487

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PROJECT MANAGER: NICK PIRKL

DRAWN BY:

SHEET TITLE: RENDERINGS

A2.3SHEET: 24 OF