These drawings are instruments of service provided by Landmark Consultants, Inc. and are not to be used for any type of construction or contracting unless signed and sealed by a Professional Engineer in the employ of Landmark C on sult ants, Inc.




CT: 2633-003

7/25/2025

CT: Erik Griepentrog
erikg@landmark-co.com

ı Drawings

SHEET C.410

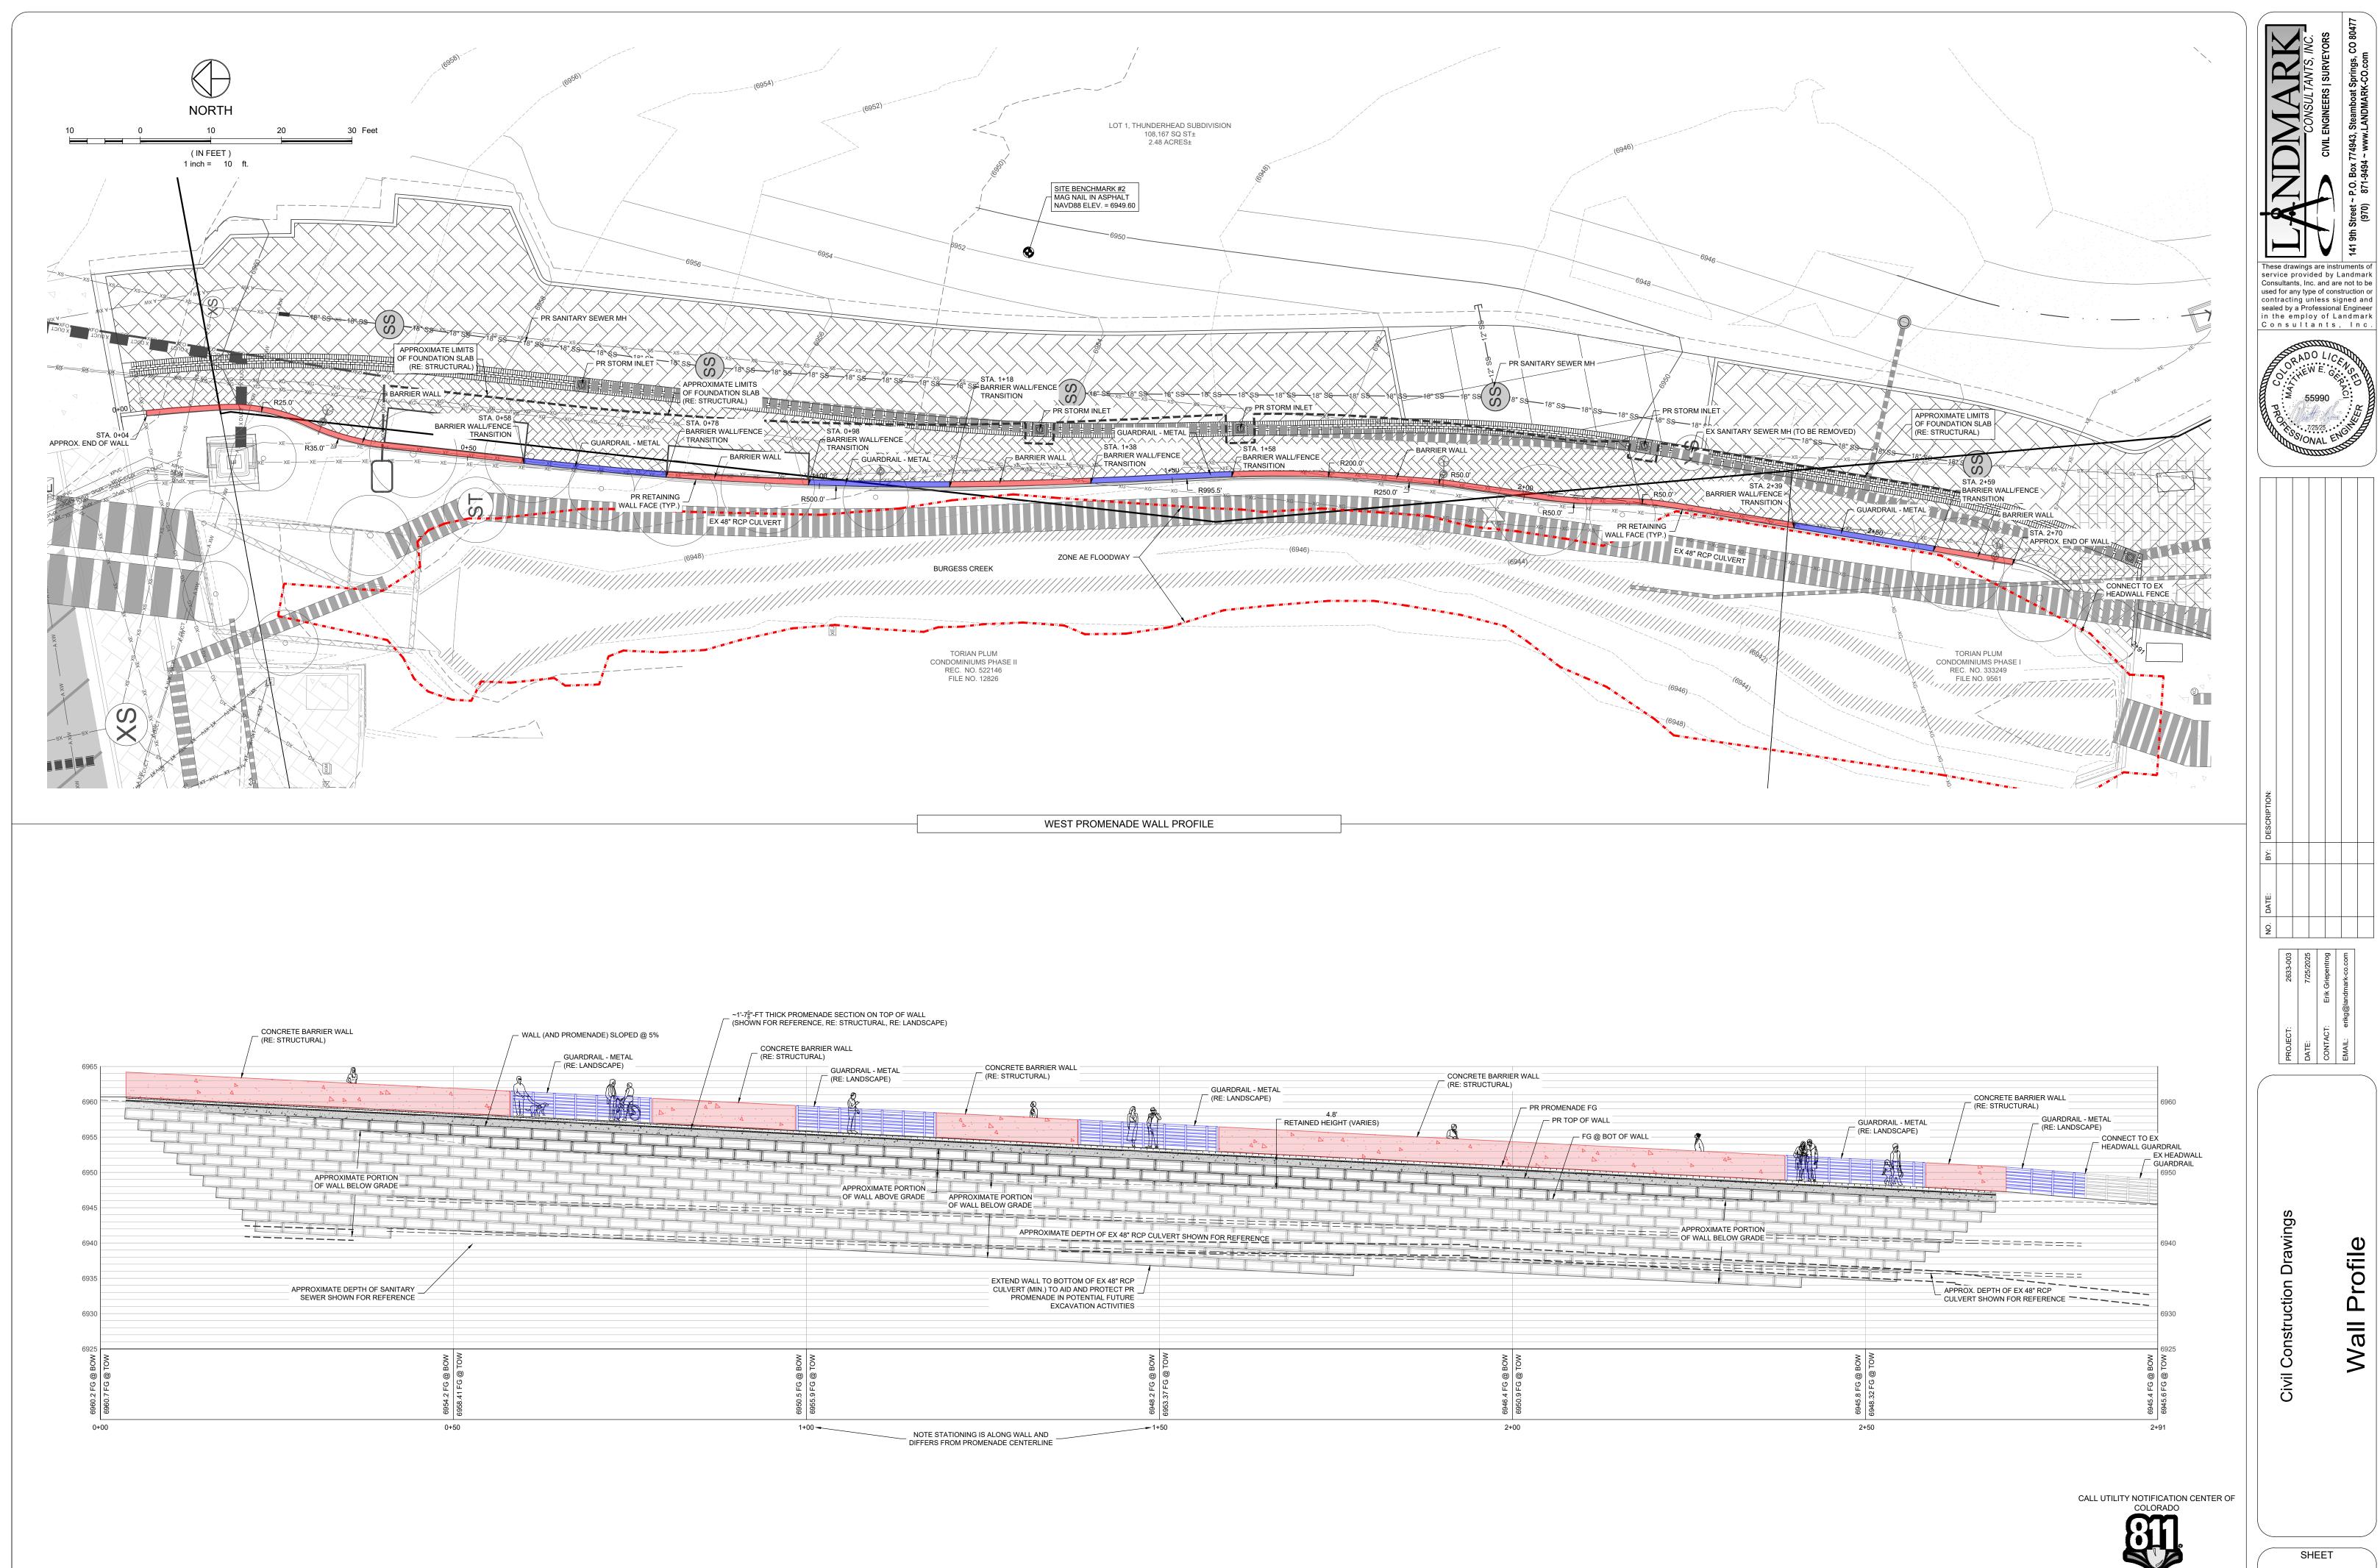


SHEET


Know what's below.

Call before you dig. CALL 2 BUSINESS DAYS IN ADVANCE BEFORE YOU DIG, GRADE, OR EXCAVATE FOR THE MARKING OF UNDERGROUND MEMBER UTILITIES. C.420

- 2. UPON EXCAVATION, WHERE UNSUITABLE SOILS ARE FOUND, SUBCUT AS REQUIRED BY THE ONSITE GEOTECHNICAL ENGINEER AND REPLACE WITH SUITABLE COMPACTED STRUCTURAL FILL TO ACHIEVE THE REQUIRED BEARING CAPACITY. THE STRUCTURAL FILL SHALL BE COMPACTED TO A MINIMUM 95% MODIFIED PROCTOR DENSITY.
- 3. APPROXIMATE LIMITS OF EXCAVATION VARIES WHERE SUBCUT IS REQUIRED. ACTUAL LIMITS AND SIDE SLOPES SHALL BE DETERMINED BY OSHA REGULATIONS AND MATCH FIELD CONDITIONS AS DETERMINED BY THE CONTRACTOR.
- 4. THE WALL IS DESIGNED AS A GRAVITY WALL AND SHALL BE CONSTRUCTED WITH REDI-ROCK: 28", 41", 60", AND 72" UNITS USING THE NEAR VERTICAL 1.0° BATTER.
- 5. 6" CORRUGATED PERFORATED DRAINPIPE INSTALLED AS LOW AS POSSIBLE WITH POSITIVE DRAINAGE. OUTLET INTO ONSITE DRAINAGE NEAR LOW END OF WALL.

- 6. THIRD PARTY INSPECTOR TO INSPECT EXCAVATION SLOPES FOR ACTIVE SEEPAGE AND RECOMMEND PLACEMENT OF ADDITIONAL DRAINS WHERE SEEPAGE OCCURS.
- 7. 1/2" EXPANSION MATERIAL SHALL BE PLACED BETWEEN THE MODULAR BLOCK RETAINING WALL UNITS AND ANY CONCRETE PLACED AFTER CONSTRUCTION OF THE MODULAR BLOCK RETAINING WALL.
- DO NOT BRING HEAVY COMPACTION OR PAVING EQUIPMENT WITHIN 3' OF THE BACK OF THE REDI-ROCK RETAINING WALL.
- 9. SEE MANUFACTURER'S INFORMATION FOR ADDITIONAL DETAILS ON THE REDI-ROCK RETAINING WALL SYSTEM.

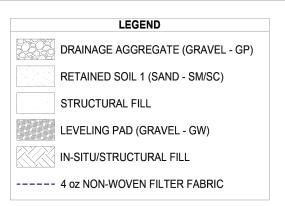

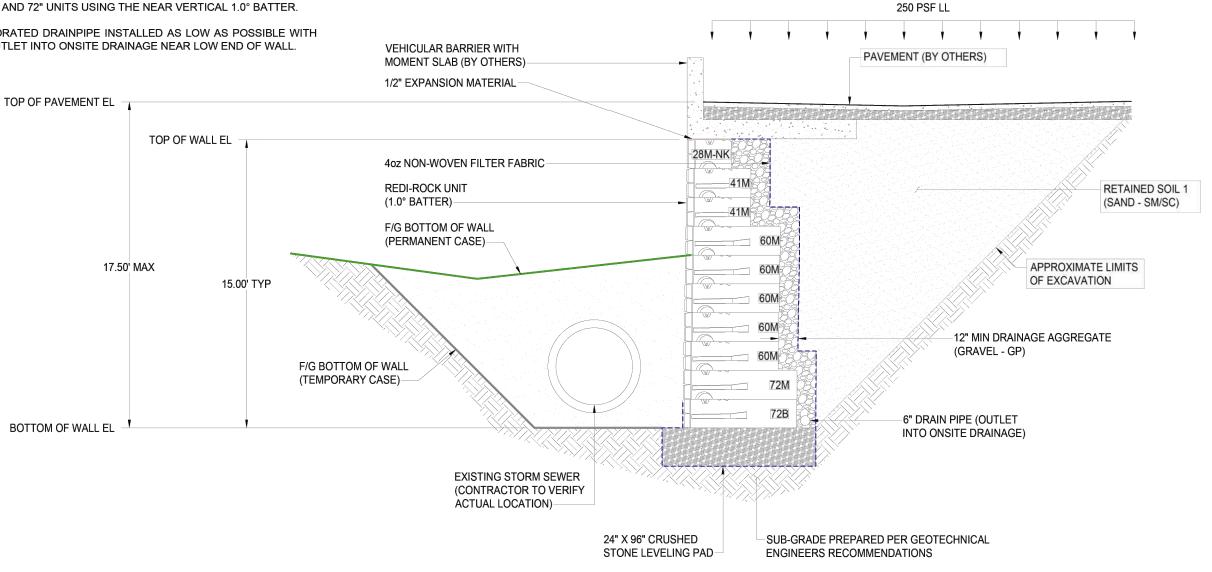

## TYPICAL WALL SECTION

(SECTION CUT AT MAX HEIGHT)



10065 KINGS CANYON DR., PEYTON, COLORADO 80831

(303) 956-8967 • INFO@SOILSTRUCTURES.COM • WWW.SOILSTRUCTURES.COM

(970) 351-0270

211 30th St., Greeley, CO 80631 Eric Boehner (970) 888-1020 eboehner@signaturestone.com

No.	Date	Revision	E	Ву	roject:	INDEDUCAD DE AOU	Ì	
0	19 FEB 2025	FOR REVIEW AND COORDINATION ONLY	В	TD	THUNDERHEAD BEACH			
1					STEAMBOAT SPRINGS, CO			
2								
3	9				itle:			
4	1 A			2				
5	7			i i	TYPICAL WALL SECTION			
6				-				
7	. !			,	roject No: Date:	Scale:	Sheet No:	
8					25SSL015 19 FE	B 2025 1"=5'	RW-5.00	
9					2555L015 19 FE	B 2025	KW-5.00	