

STEAMBOAT BASECAMP - DEVELOPMENT PLAN SUBMISSION

1901 CURVE PLAZA STEAMBOAT SPRINGS, COLORADO 80487

PROJECT TEAM

OWNER

MAY RIEGLER PROPERTIES 2201 WISCONSIN AVENUE NW SUITE 200 WASHINGTON, DC 20007

PO BOX 881330 STEAMBOAT SPRINGS, CO 80488

ARCHITECT

3318 N. COLUMBUS ST. ARLINGTON, VA 22207

CIVIL ENGINEER

LANDMARK ENGINEERS & SURVEYORS 141 9TH STREET PO BOX 774943 STEAMBOAT SPRINGS, CO 80477

PROJECT SUMMARY TABLE

GROSS FLOOR AREA: 64,073 GSF **NET FLOOR AREA:** 52,142 NSF **UNIT SIZE:** 616 SF AVERAGE NUMBER OF UNITS:

ZONING:

FRONTAGE: CURVE CT: 263' / SHIELD DR: 350' / ELK RIVER RD: 380' / HWY 40: 377'

USE BREAKDOWN DESCRIPTION SQUARE FOOTAGE # OF UNITS PRINCIPAL USE RESIDENTIAL 55,934 SF

ACCESSORY USES COMMERCIAL 8,139 SF

STANDARDS	ZONE DISTRICT REQMTS	PROPOSED	VARIANCE? (Y/N
LOT AREA	NO MAX/NO MIN	2.64 ACRES	N
LOT COVERAGE	NO MAX/NO MIN	19.7%	N
OPEN SPACE	15% MIN	52.67%	N
FLOOR AREA RATIO	NO MAX	0.58 FAR	N
OVERALL BLDG HT	63' MAX	53'-3"	N
AVERAGE PLATE HT	N/A		
FRONTAGE AREA HT	26' MIN	27'-7" (EXIST) / 51'-9" (NI	EW) N
FRONT SETBACK	5 FT MIN	COMPLIES	N
SIDE SETBACK	7.5 FT MIN	COMPLIES	N
UPPER STORY SETBACK	OVER 45' OR 3 STORIES	VARIES	Υ
REAR SETBACK	7.5 FT MIN	COMPLIES	N
SECOND STORY INTENSITY	50% MINIMUM	NEW CONST: 100%	N
PARKING	128 SPACES (SEE NARRATIVE)	128 SPACES	N
SNOW STORAGE	29,301 SF	32,478 SF	N
	•	•	

DRAWING LIST G 1.0 COVER SHEET C.003 EXISTING CONDITIONS & SITE REMOVAL EXHIBIT C.100 SITE PLAN C.200 UTILITY PLAN C.210 WATER MAIN PLAN - OVERALL C.211 WATER MAIN PLAN & PROFILE C.212 WATER MAIN PLAN & PROFILE C.213 WATER MAIN PLAN & PROFILE C.214 WATER MAIN PLAN & PROFILE C.221 SANITARY SEWER PLAN & PROFILE C.301 DETAILED GRADING PLAN - OFFSITE C.302 DETAILED GRADING PLAN - ONSITE

C.311 STORM SEWER PLAN & PROFILE C.400 MATERIALS, SIGNAGE, & STRIPING PLAN C.401 MATERIALS, SIGNAGE, & STRIPING PLAN

C.410 ROADWAY PLAN & PROFILE

C.310 STORM SEWER PLAN - OVERALL

C.700 EASEMENT EXHIBIT

A 1.1 EXISTING GROUND LEVEL PLAN A 1.2 EXISTING ROOF PLAN

A 1.3 DEMOLITION PLAN A 2.1 GROUND LEVEL PLAN A 2.2 TYPICAL FLOOR PLAN

A 2.3 FIFTH FLOOR PLAN A 2.4 ROOF PLAN

A 2.5 ENLARGED UNIT PLANS

A 3.01 EXISTING SOUTH AND WEST ELEVATIONS

A 3.02 EXISTING NORTH AND EAST ELEVATIONS A 3.11 PROPOSED SOUTH AND WEST ELEVATIONS

A 3.12 PROPOSED NORTH AND EAST ELEVATIONS

A 3.2 BUILDING SECTIONS

A 4.1 PROPOSED PROJECT PERSPECTIVE RENDERING

A 4.2 PROPOSED PROJECT PERSPECTIVE RENDERING

A 4.3 PROPOSED PROJECT PERSPECTIVE RENDERING A 4.4 PROPOSED PROJECT PERSPECTIVE RENDERING

A 4.5 PROPOSED PROJECT PERSPECTIVE RENDERING

A 5.1 LIGHTING SPECIFICATIONS

LANDSCAPE PLAN

MEP 1 PHOTOMETRIC SITE PLAN

MEP 2 PHOTOMETRIC SCHEDULES AND DETAILS

APPROVAL STAMPS: K. Plan Set 5 6/17/2021 Development Plan Submittal #5 4 4/19/2021 Development Plan Submittal #4 3 10/14/2020 Development Plan Submittal #3 7/8/2020 Development Plan Submittal #2 1 3/27/2020 Development Plan Submittal SUBMISSIONS & REVISIONS May Riegler Properties 2201 Wisconsin Avenue NW Suite 200 Washington, DC 20007 PO Box 881330 Steamboat Springs, CO 80488 **KEVIN & ASAKO SPERRY ARCHITECTURE** 3318 N. Columbus Street Arlington, VA 22207 T.312.636.3248 / 312.636.4252 www.kasa-arch.com STRUCTURAL ENGINEER M.E.P. & F.P. ENGINEERS CIVIL ENGINEER LANDMARK CONSULTANTS, INC. PO Box 774943 Steamboat Springs, Colorado 80477 T.970.871.9494 LANDSCAPE ARCHITECT MGC DESIGN, INC. PO Box 773522 Steamboat Springs, Colorado 80477 T.970.879.7740

GENERAL CONTRACTOR

PROJECT LOCATION

Steamboat Basecamp

Steamboat Springs, CO DRAWING TITLE

COVER SHEET


> 03/27/20 DRAWN BY: CHECKED BY

DRAWING NO:


G 1.0

VICINITY MAP

PROJECT NO:

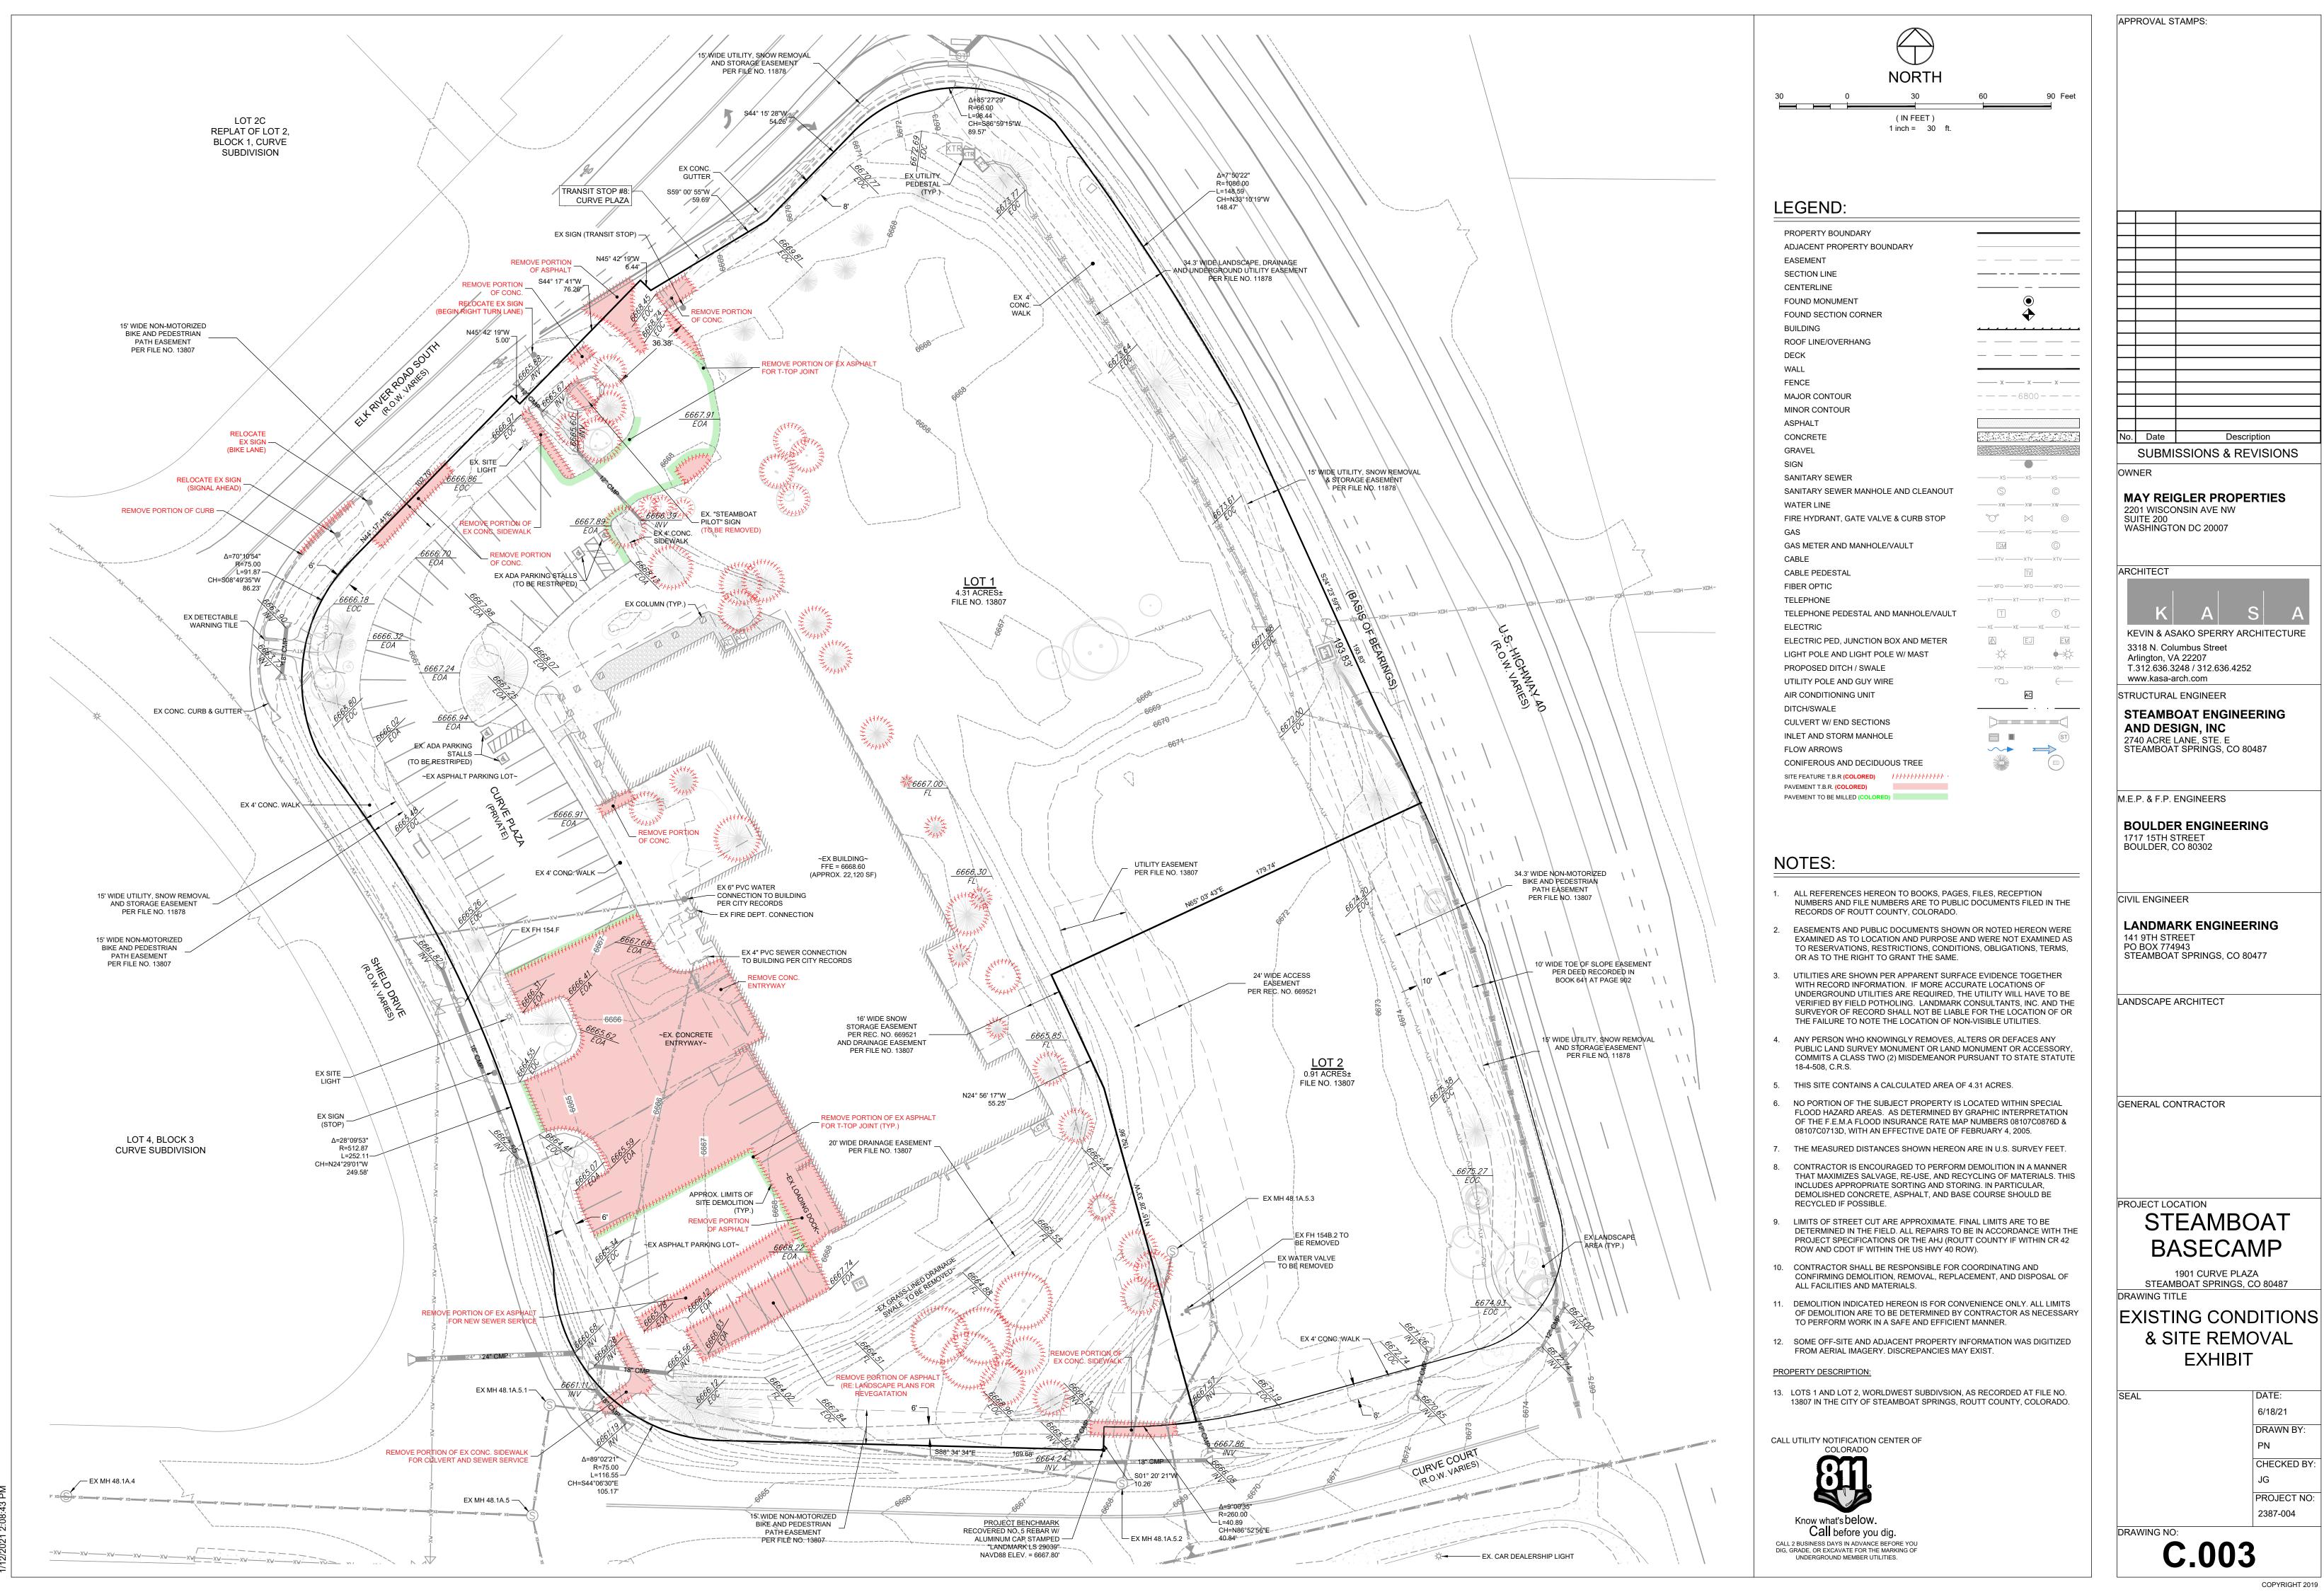

6/18/21 DRAWN BY:

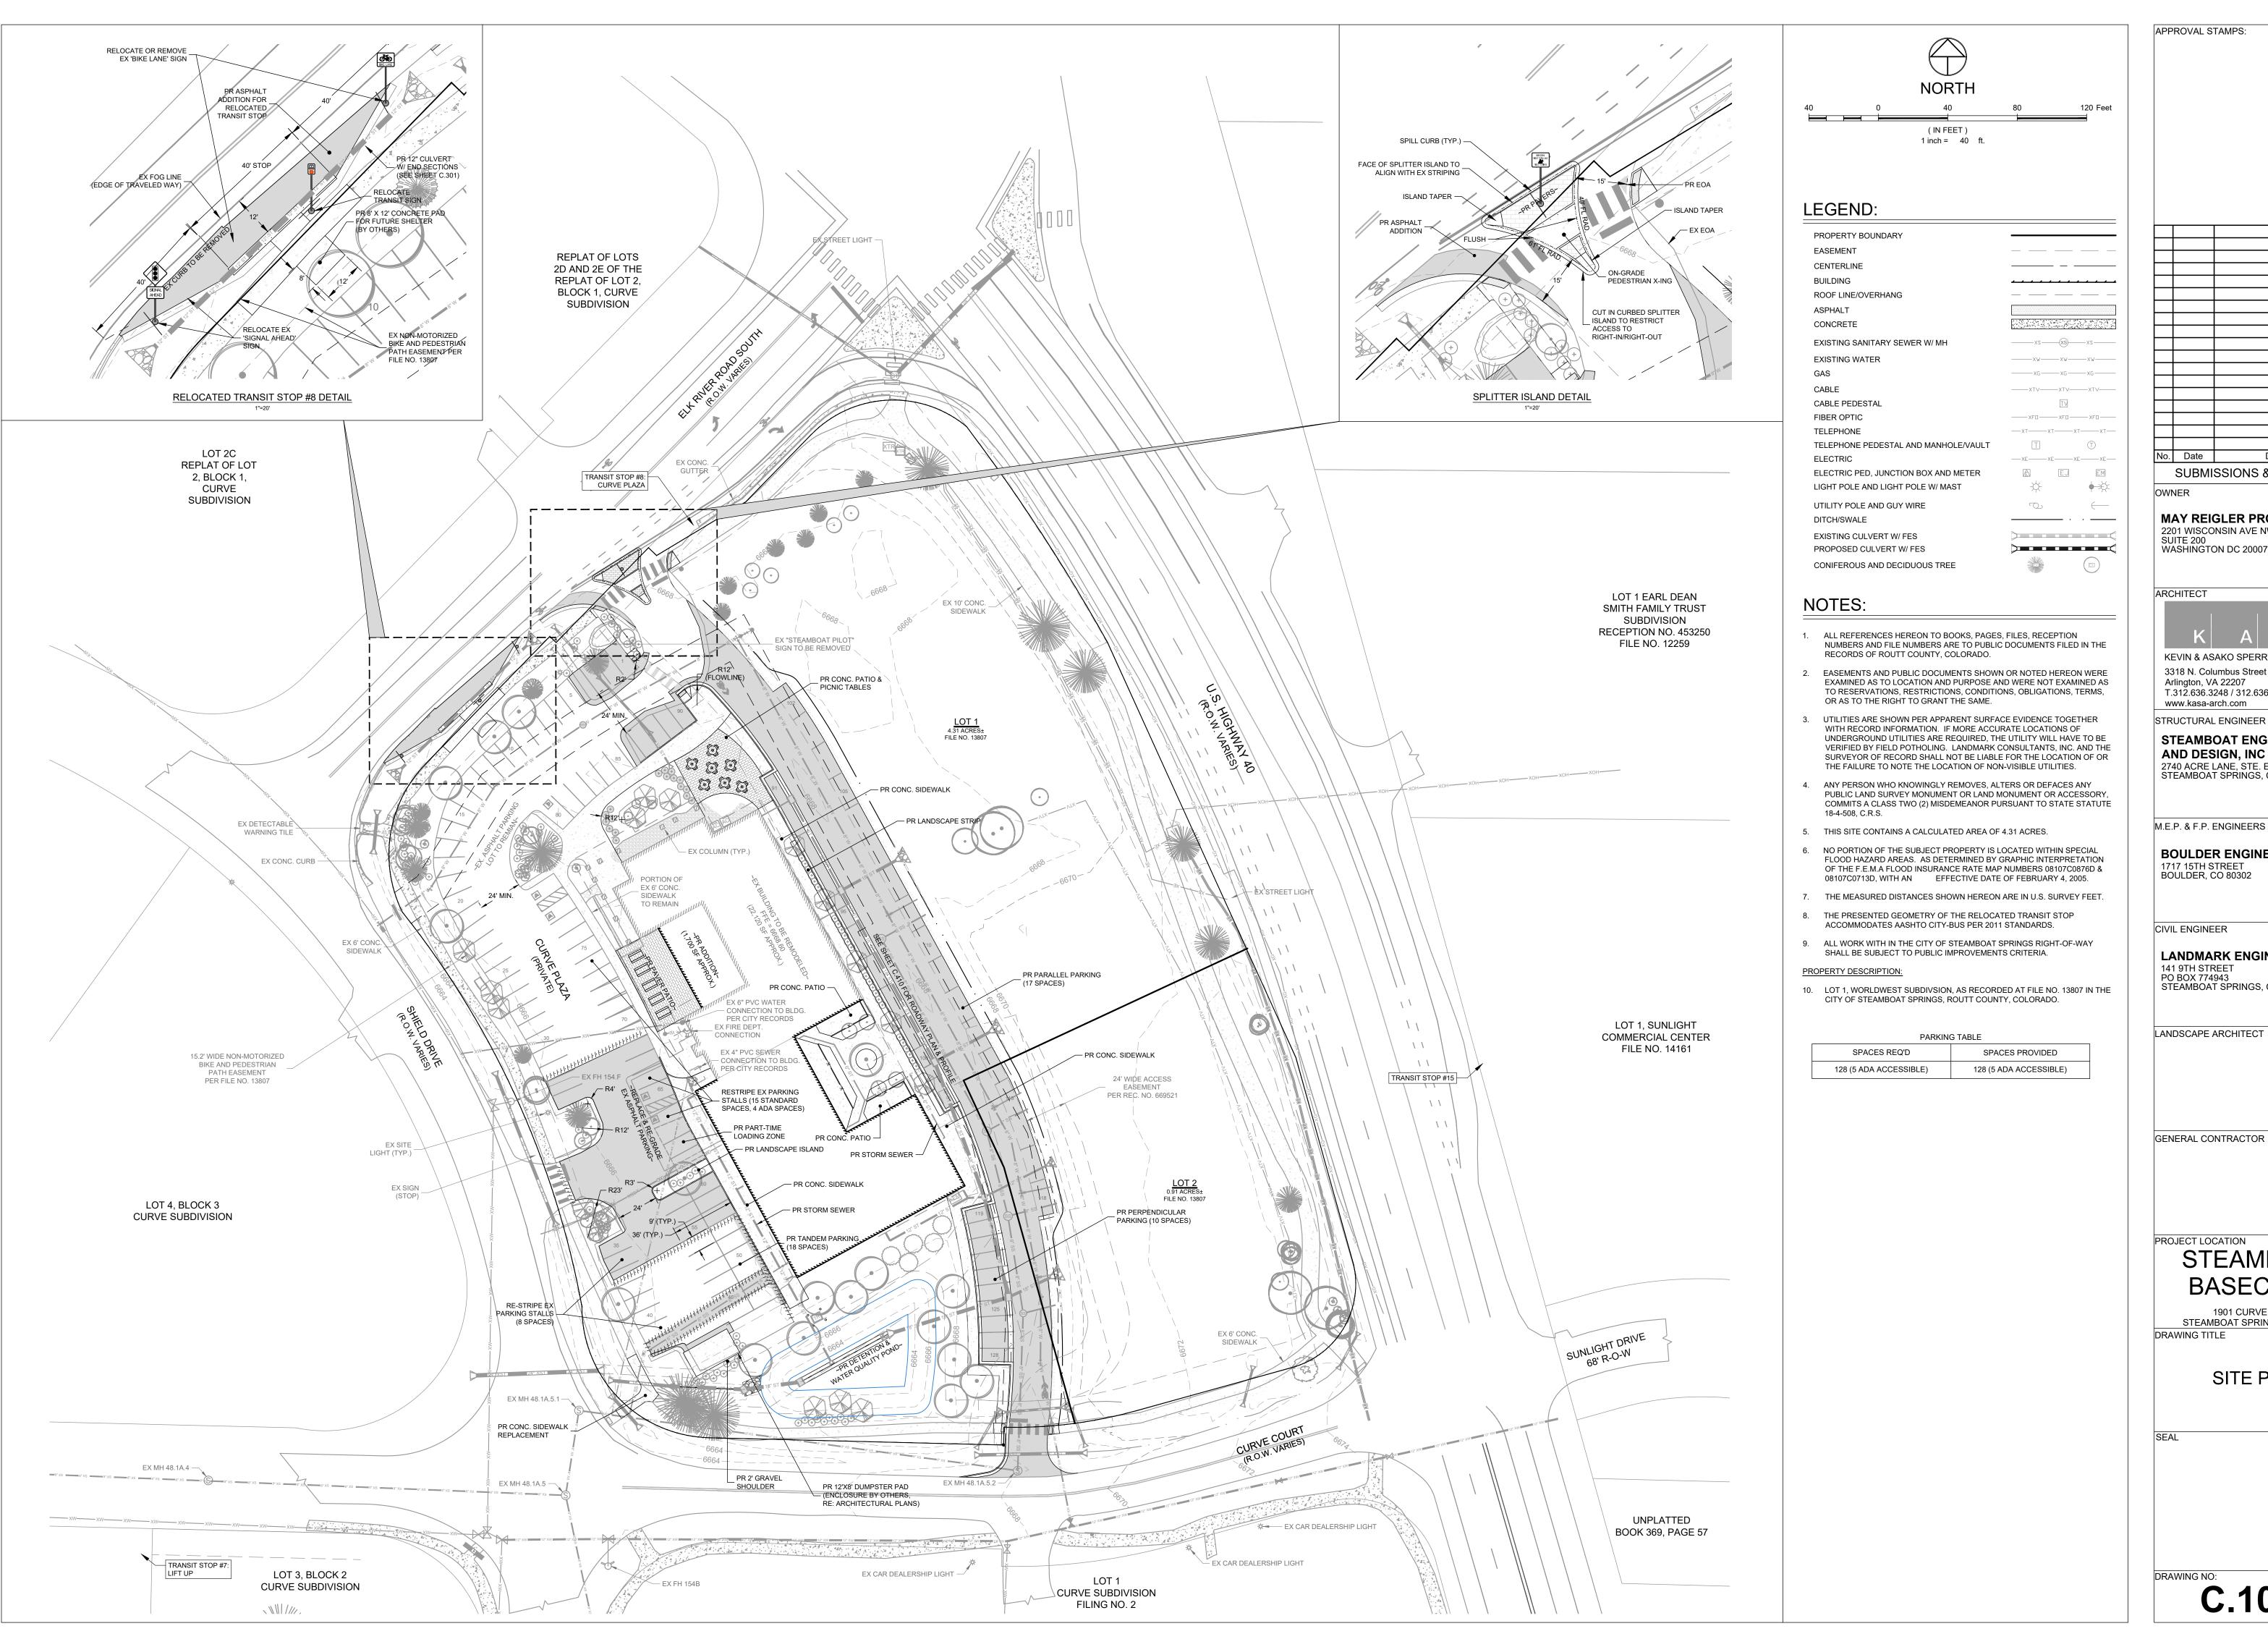

APPROVAL STAMPS: No. Date Description MAY REIGLER PROPERTIES 2201 WISCONSIN AVE NW SUITE 200 WASHINGTON DC 20007 ARCHITECT

SUBMISSIONS & REVISIONS

KEVIN & ASAKO SPERRY ARCHITECTURE 3318 N. Columbus Street Arlington, VA 22207 T.312.636.3248 / 312.636.4252

STRUCTURAL ENGINEER

STEAMBOAT ENGINEERING **AND DESIGN, INC** 2740 ACRE LANE, STE. E STEAMBOAT SPRINGS, CO 80487

BOULDER ENGINEERING 1717 15TH STREET BOULDER, CO 80302

CIVIL ENGINEER

LANDMARK ENGINEERING 141 9TH STREET

PO BOX 774943 STEAMBOAT SPRINGS, CO 80477

LANDSCAPE ARCHITECT

GENERAL CONTRACTOR

PROJECT LOCATION


STEAMBOAT **BASECAMP**

1901 CURVE PLAZA STEAMBOAT SPRINGS, CO 80487 DRAWING TITLE

SITE PLAN

6/18/21 DRAWN BY: CHECKED BY: EG PROJECT NO: 2387-004

C.100

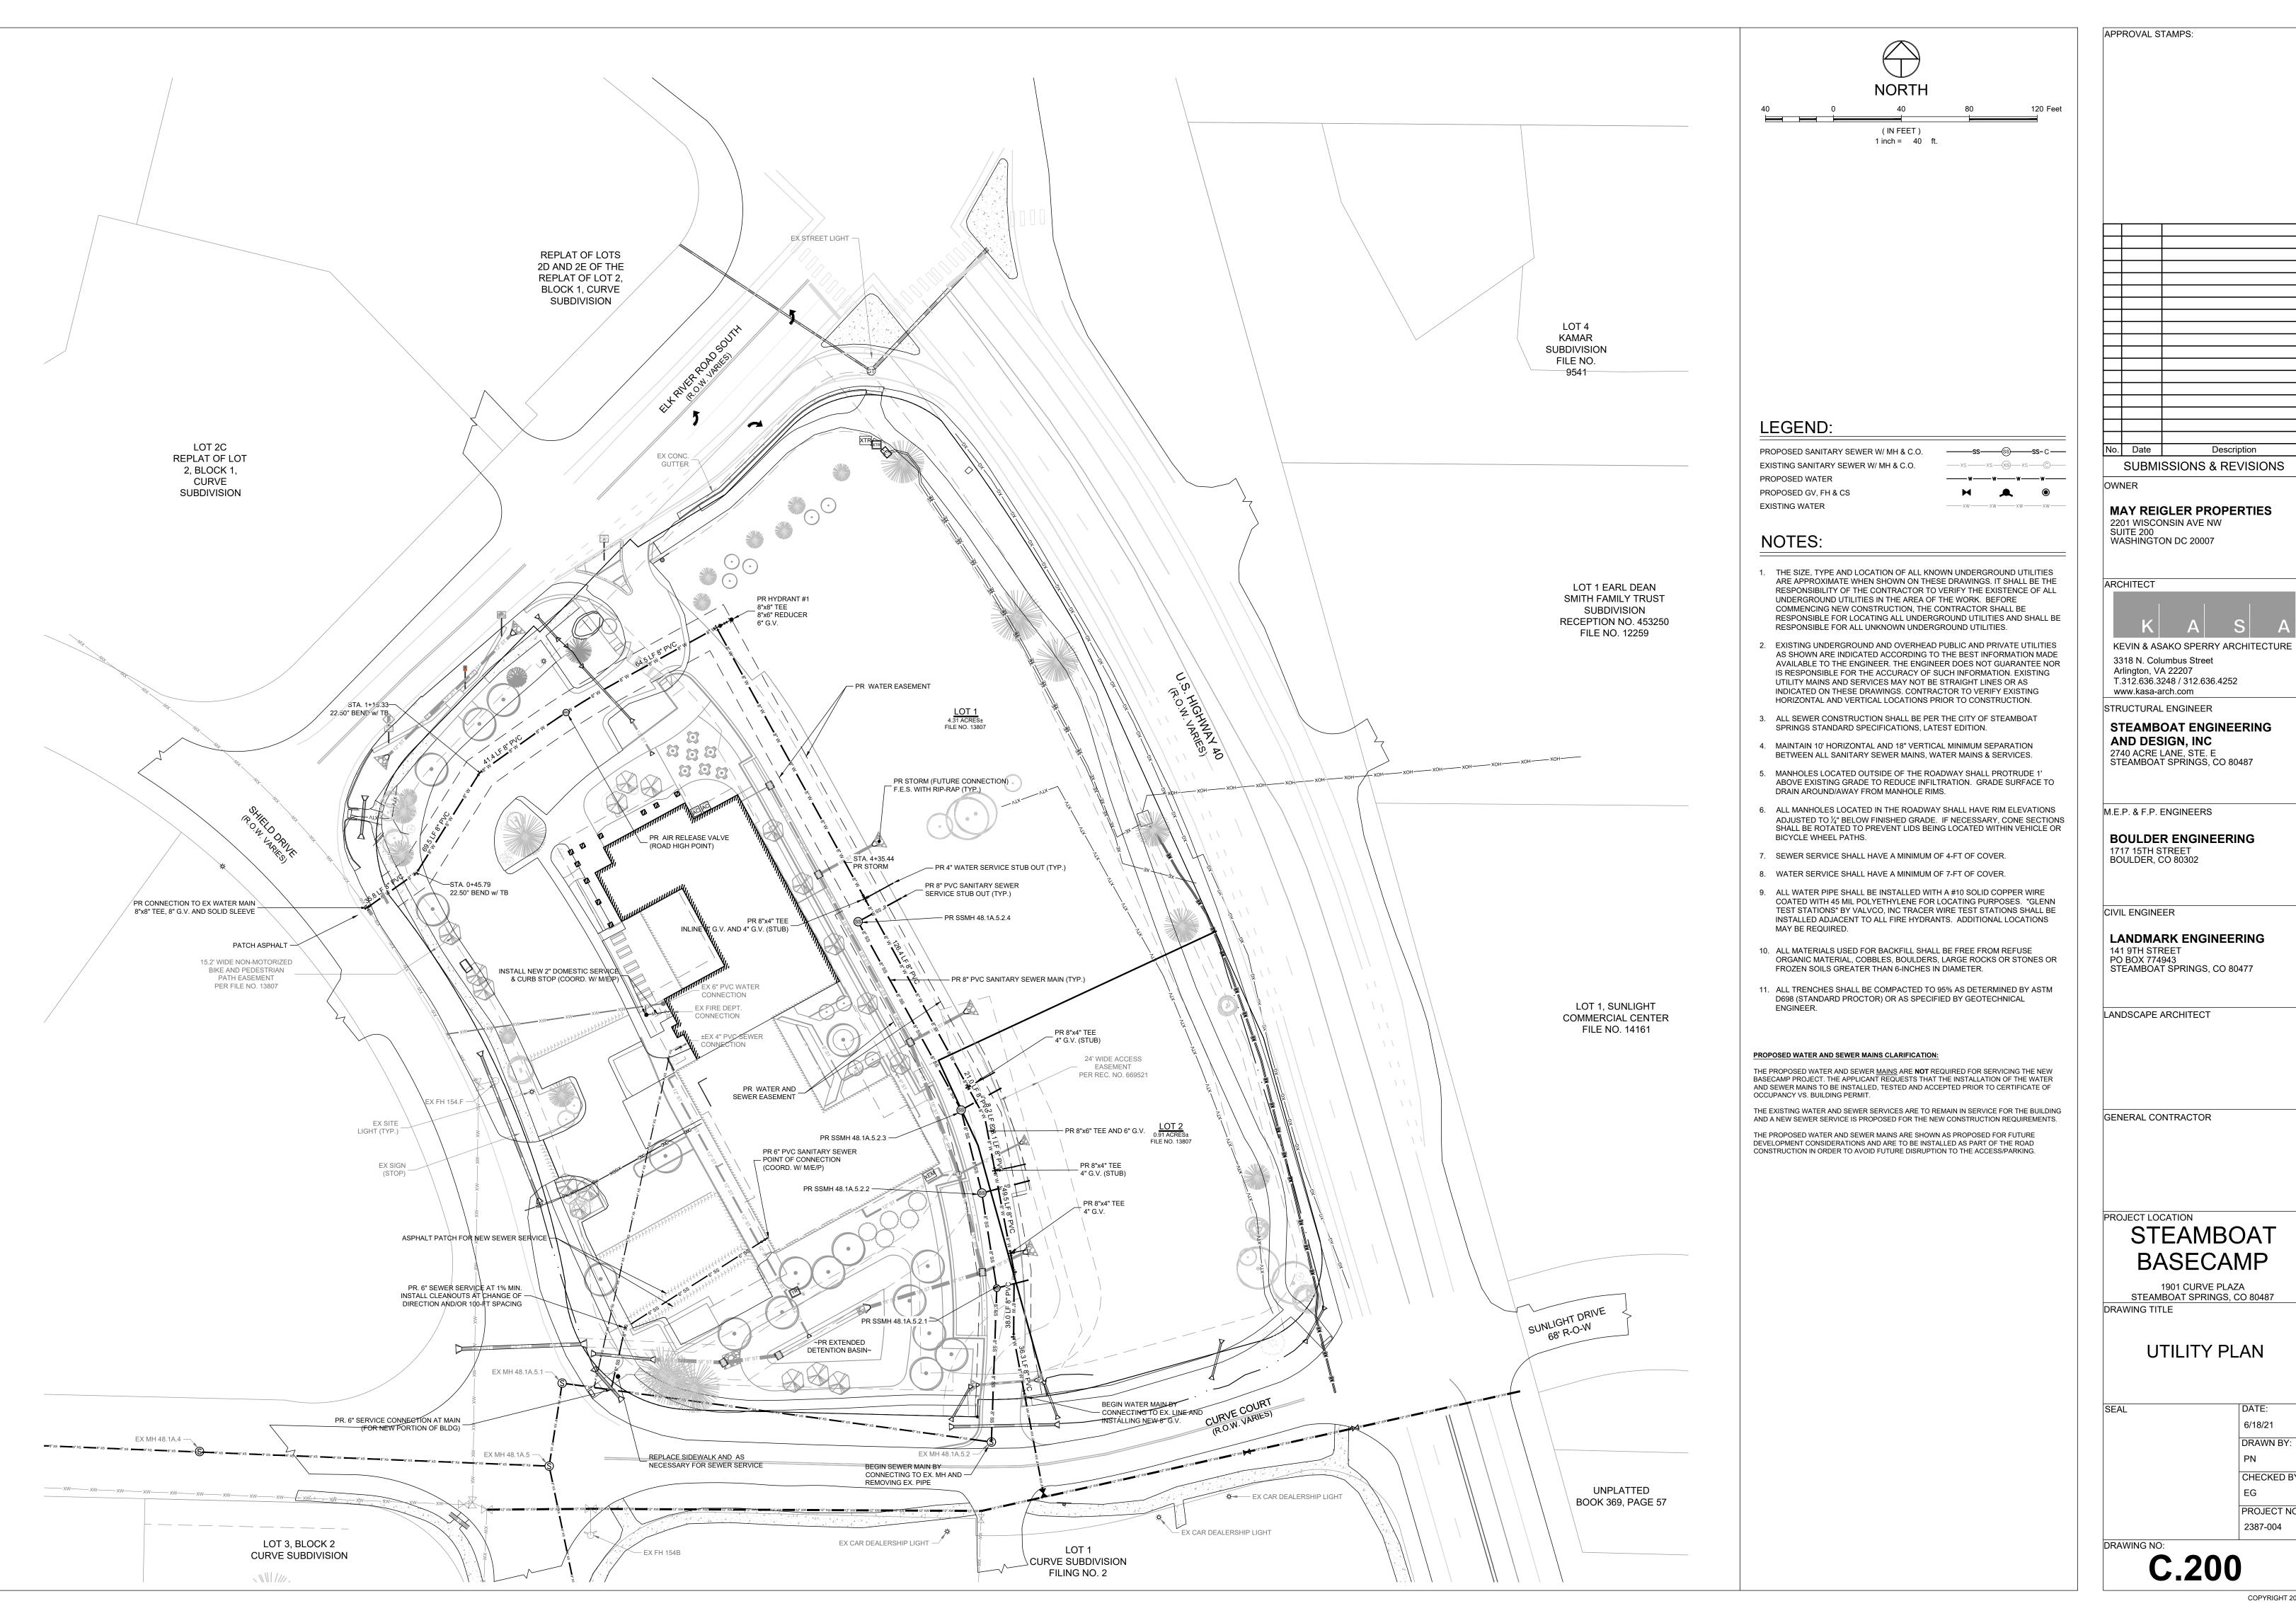

APPROVAL STAMPS: No. Date Description SUBMISSIONS & REVISIONS OWNER MAY REIGLER PROPERTIES 2201 WISCONSIN AVE NW SUITE 200 WASHINGTON DC 20007

CIVIL ENGINEER

LANDMARK ENGINEERING 141 9TH STREET PO BOX 774943 STEAMBOAT SPRINGS, CO 80477

LANDSCAPE ARCHITECT


GENERAL CONTRACTOR

STEAMBOAT **BASECAMP**

1901 CURVE PLAZA STEAMBOAT SPRINGS, CO 80487 DRAWING TITLE

UTILITY PLAN

6/18/21 DRAWN BY: CHECKED BY: PROJECT NO: 2387-004

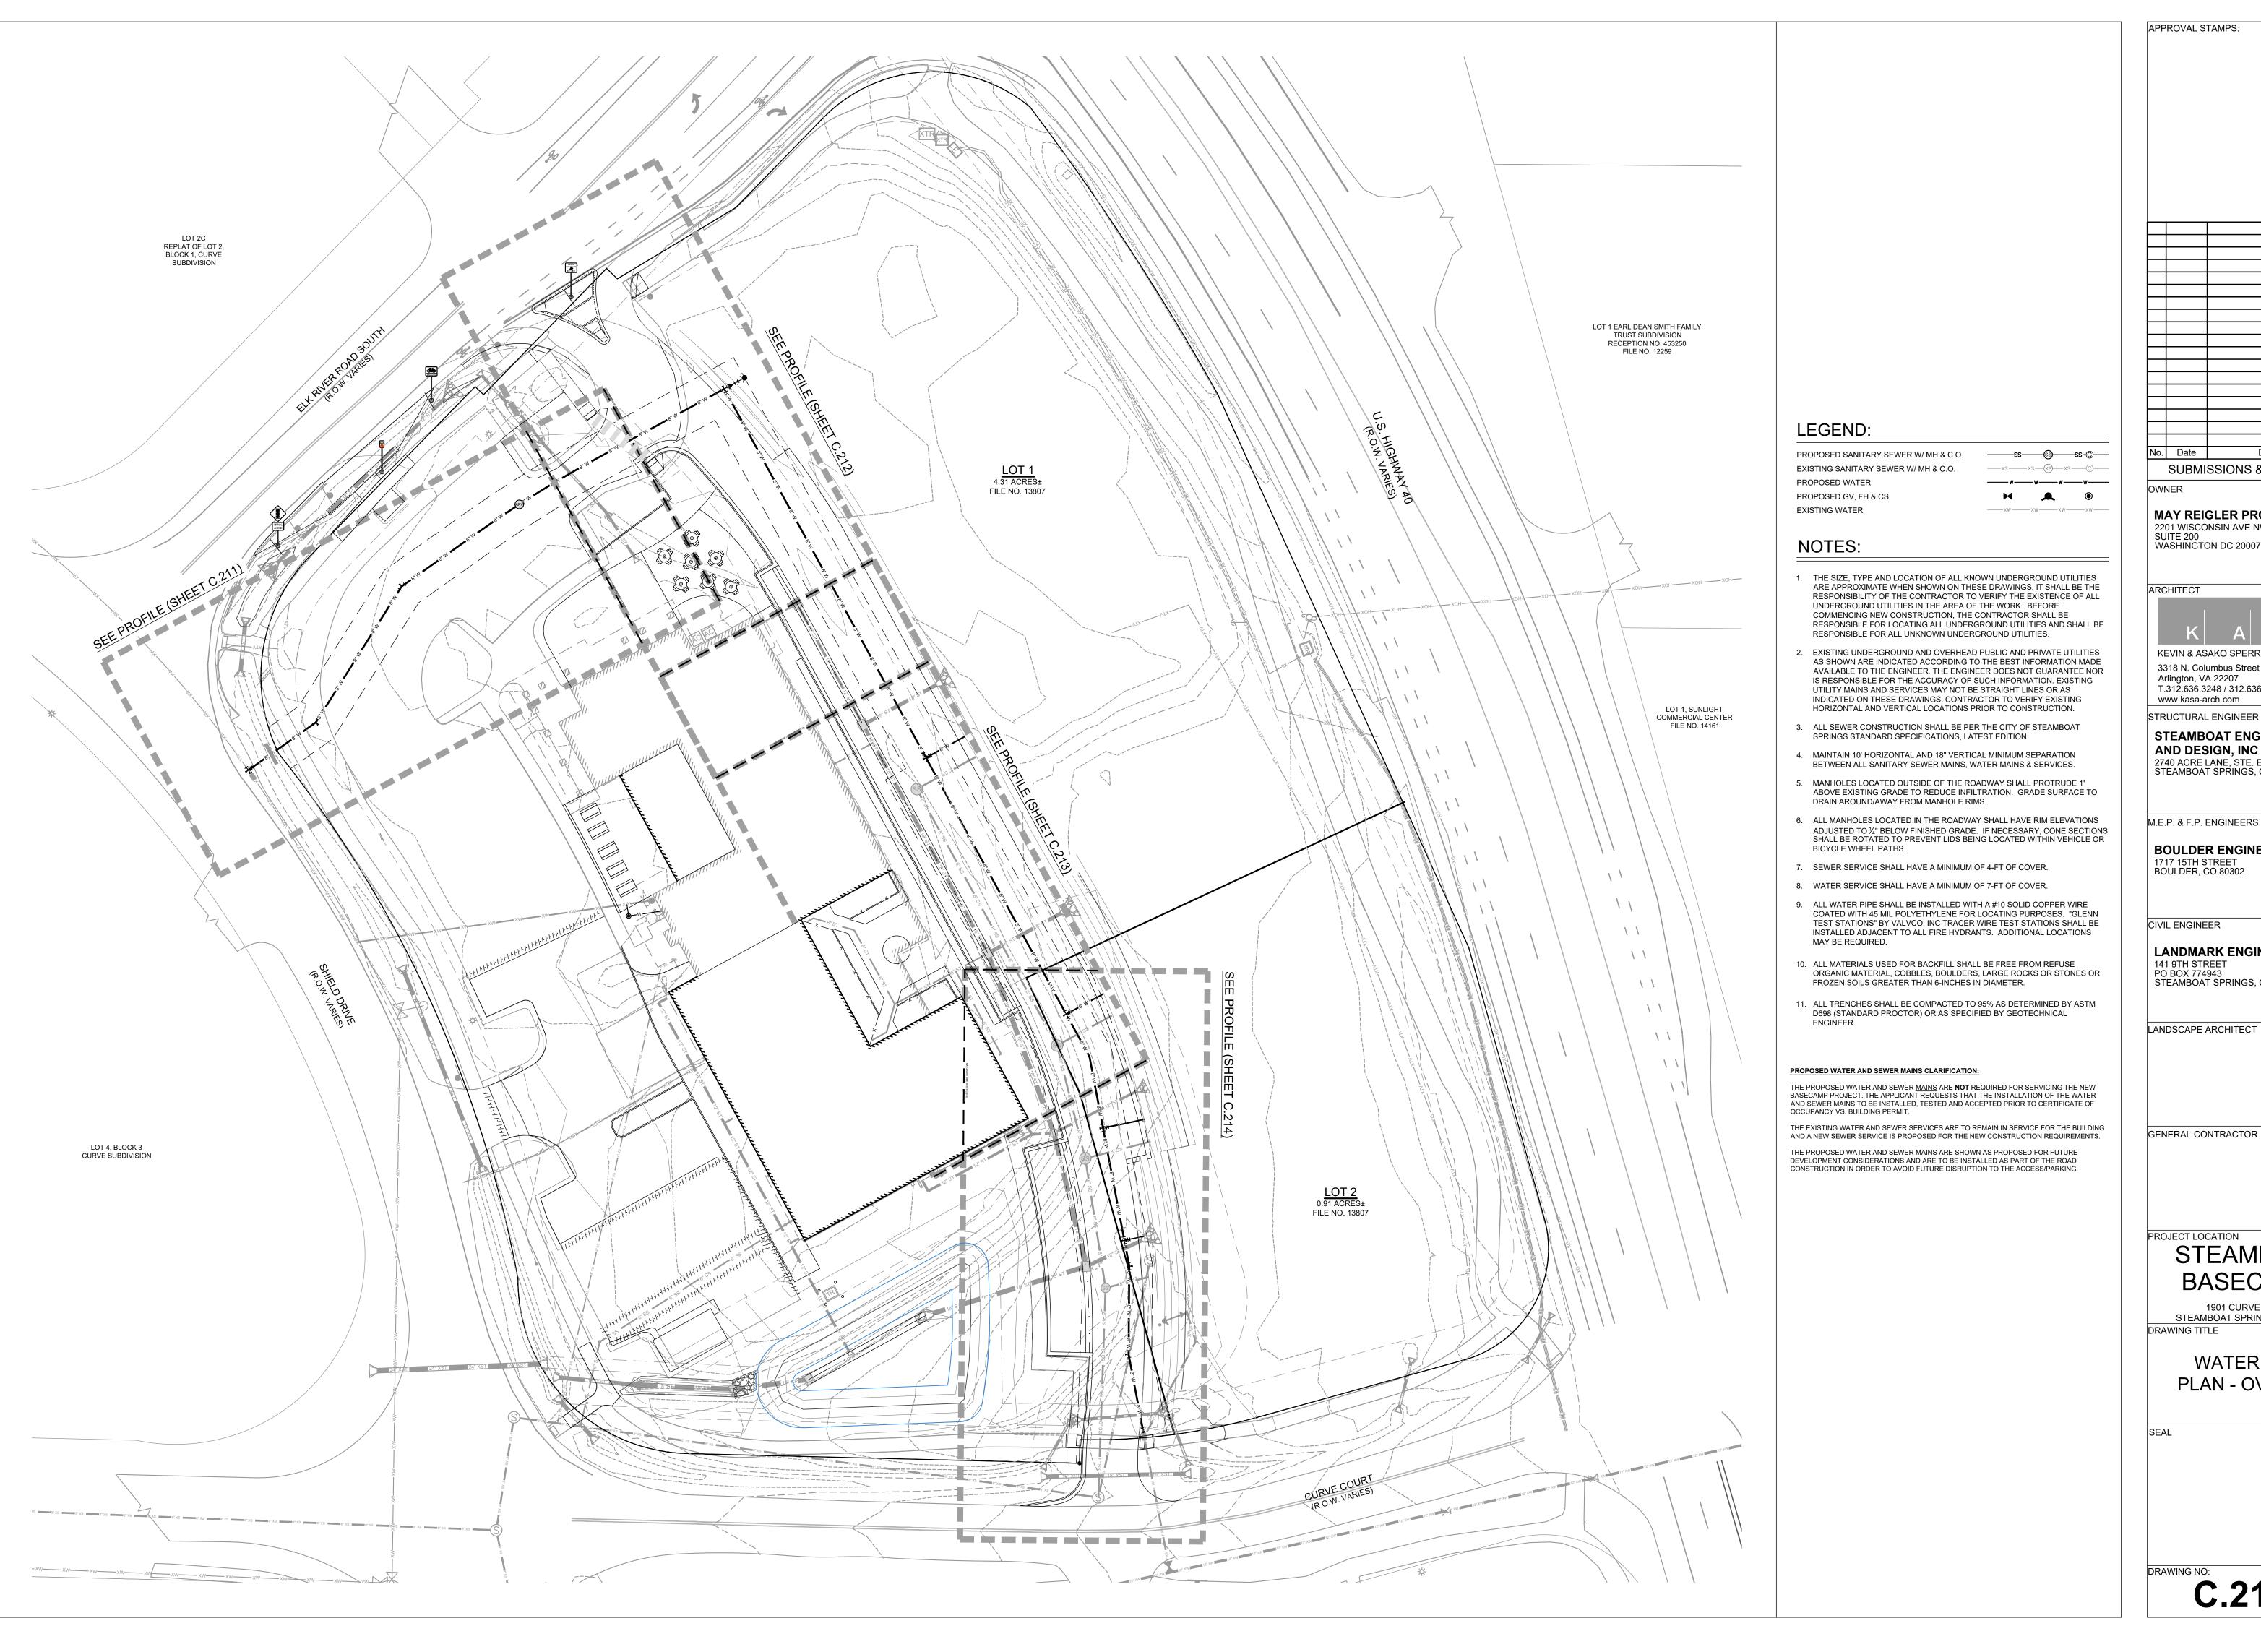

SUBMISSIONS & REVISIONS

Description

MAY REIGLER PROPERTIES
2201 WISCONSIN AVE NW

SUITE 200 WASHINGTON DC 20007



KEVIN & ASAKO SPERRY ARCHITECTURE 3318 N. Columbus Street Arlington, VA 22207 T.312.636.3248 / 312.636.4252

STRUCTURAL ENGINEER

STEAMBOAT ENGINEERING AND DESIGN, INC 2740 ACRE LANE, STE. E STEAMBOAT SPRINGS, CO 80487

M.E.P. & F.P. ENGINEERS

BOULDER ENGINEERING 1717 15TH STREET BOULDER, CO 80302

CIVIL ENGINEER

LANDMARK ENGINEERING

141 9TH STREET

PO BOX 774943 STEAMBOAT SPRINGS, CO 80477

LANDSCAPE ARCHITECT


PROJECT LOCATION

STEAMBOAT BASECAMP

1901 CURVE PLAZA STEAMBOAT SPRINGS, CO 80487 DRAWING TITLE

> **WATER MAIN** PLAN - OVERALL

6/18/21 DRAWN BY: CHECKED BY: PROJECT NO: 2387-004

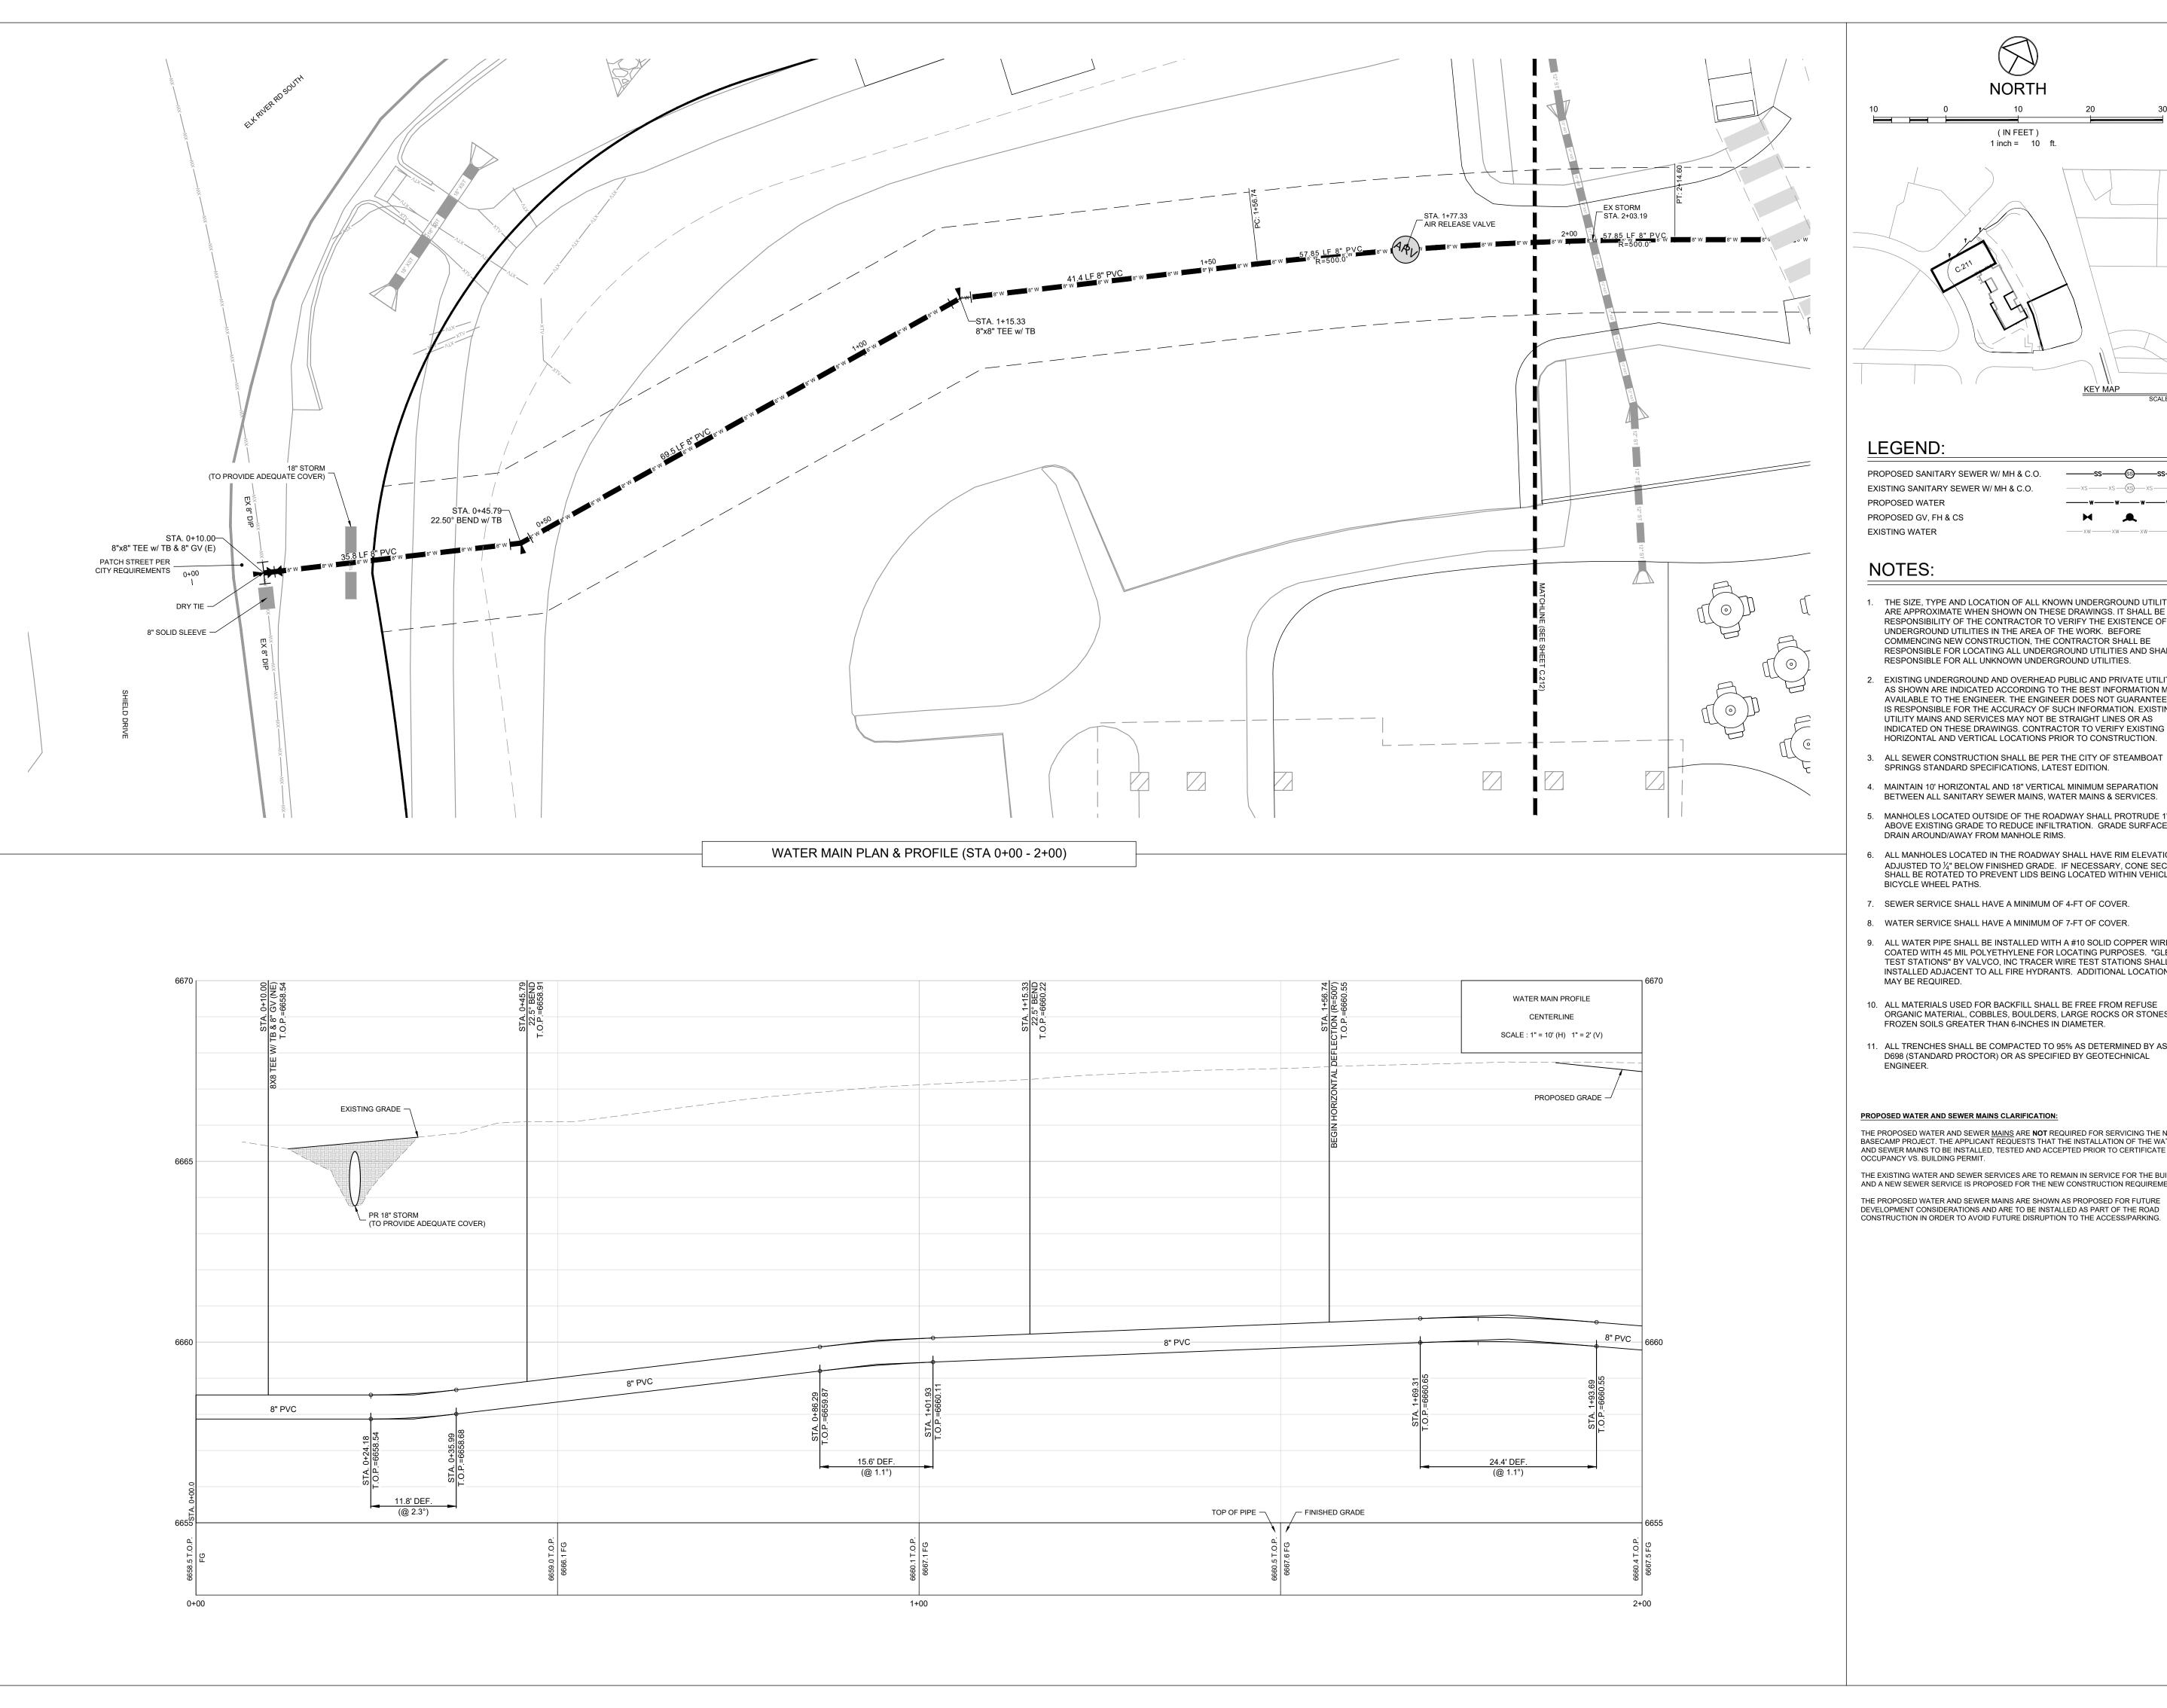

30 Feet 1 inch = 10 ft. KEY MAP SCALE = 1" : 300'

———ss——ss-©—— ____w__w___w____

- 1. THE SIZE, TYPE AND LOCATION OF ALL KNOWN UNDERGROUND UTILITIES ARE APPROXIMATE WHEN SHOWN ON THESE DRAWINGS. IT SHALL BE THE RESPONSIBILITY OF THE CONTRACTOR TO VERIFY THE EXISTENCE OF ALL UNDERGROUND UTILITIES IN THE AREA OF THE WORK. BEFORE COMMENCING NEW CONSTRUCTION, THE CONTRACTOR SHALL BE RESPONSIBLE FOR LOCATING ALL UNDERGROUND UTILITIES AND SHALL BE RESPONSIBLE FOR ALL UNKNOWN UNDERGROUND UTILITIES.
- EXISTING UNDERGROUND AND OVERHEAD PUBLIC AND PRIVATE UTILITIES AS SHOWN ARE INDICATED ACCORDING TO THE BEST INFORMATION MADE AVAILABLE TO THE ENGINEER. THE ENGINEER DOES NOT GUARANTEE NOR IS RESPONSIBLE FOR THE ACCURACY OF SUCH INFORMATION. EXISTING UTILITY MAINS AND SERVICES MAY NOT BE STRAIGHT LINES OR AS INDICATED ON THESE DRAWINGS. CONTRACTOR TO VERIFY EXISTING
- 3. ALL SEWER CONSTRUCTION SHALL BE PER THE CITY OF STEAMBOAT SPRINGS STANDARD SPECIFICATIONS, LATEST EDITION.
- 4. MAINTAIN 10' HORIZONTAL AND 18" VERTICAL MINIMUM SEPARATION
- 5. MANHOLES LOCATED OUTSIDE OF THE ROADWAY SHALL PROTRUDE 1' ABOVE EXISTING GRADE TO REDUCE INFILTRATION. GRADE SURFACE TO
- ALL MANHOLES LOCATED IN THE ROADWAY SHALL HAVE RIM ELEVATIONS ADJUSTED TO $\frac{1}{4}$ " BELOW FINISHED GRADE. IF NECESSARY, CONE SECTIONS SHALL BE ROTATED TO PREVENT LIDS BEING LOCATED WITHIN VEHICLE OR
- 7. SEWER SERVICE SHALL HAVE A MINIMUM OF 4-FT OF COVER.
- 8. WATER SERVICE SHALL HAVE A MINIMUM OF 7-FT OF COVER.
- 9. ALL WATER PIPE SHALL BE INSTALLED WITH A #10 SOLID COPPER WIRE COATED WITH 45 MIL POLYETHYLENE FOR LOCATION PURPOSES. "GLENN TEST STATIONS" BY VALVCO, INC TRACER WIRE TEST STATIONS SHALL BE INSTALLED ADJACENT TO ALL FIRE HYDRANTS. ADDITIONAL LOCATIONS
- 10. ALL MATERIALS USED FOR BACKFILL SHALL BE FREE FROM REFUSE ORGANIC MATERIAL, COBBLES, BOULDERS, LARGE ROCKS OR STONES OR FROZEN SOILS GREATER THAN 6-INCHES IN DIAMETER.
- 11. ALL TRENCHES SHALL BE COMPACTED TO 95% AS DETERMINED BY ASTM D698 (STANDARD PROCTOR) OR AS SPECIFIED BY GEOTECHNICAL

THE PROPOSED WATER AND SEWER $\underline{\text{MAINS}}$ ARE $\underline{\text{NOT}}$ REQUIRED FOR SERVICING THE NEW BASECAMP PROJECT. THE APPLICANT REQUESTS THAT THE INSTALLATION OF THE WATER AND SEWER MAINS TO BE INSTALLED, TESTED AND ACCEPTED PRIOR TO CERTIFICATE OF

THE EXISTING WATER AND SEWER SERVICES ARE TO REMAIN IN SERVICE FOR THE BUILDING AND A NEW SEWER SERVICE IS PROPOSED FOR THE NEW CONSTRUCTION REQUIREMENTS. THE PROPOSED WATER AND SEWER MAINS ARE SHOWN AS PROPOSED FOR FUTURE

APPROVAL STAMPS:

SUBMISSIONS & REVISIONS

Description

OWNER

MAY REIGLER PROPERTIES 2201 WISCONSIN AVE NW SUITE 200 WASHINGTON DC 20007

ARCHITECT

No. Date



3318 N. Columbus Street Arlington, VA 22207 T.312.636.3248 / 312.636.4252 www.kasa-arch.com

STRUCTURAL ENGINEER

STEAMBOAT ENGINEERING AND DESIGN, INC 2740 ACRE LANE, STE. E STEAMBOAT SPRINGS, CO 80487

M.E.P. & F.P. ENGINEERS

BOULDER ENGINEERING 1717 15TH STREET BOULDER, CO 80302

CIVIL ENGINEER

LANDMARK ENGINEERING 141 9TH STREET

PO BOX 774943 STEAMBOAT SPRINGS, CO 80477

LANDSCAPE ARCHITECT

GENERAL CONTRACTOR

PROJECT LOCATION

STEAMBOAT


1901 CURVE PLAZA STEAMBOAT SPRINGS, CO 80487 DRAWING TITLE


> **WATER MAIN** PLAN & PROFILE

6/18/21 DRAWN BY: CHECKED BY: PROJECT NO:

DRAWING NO:

COPYRIGHT 2019

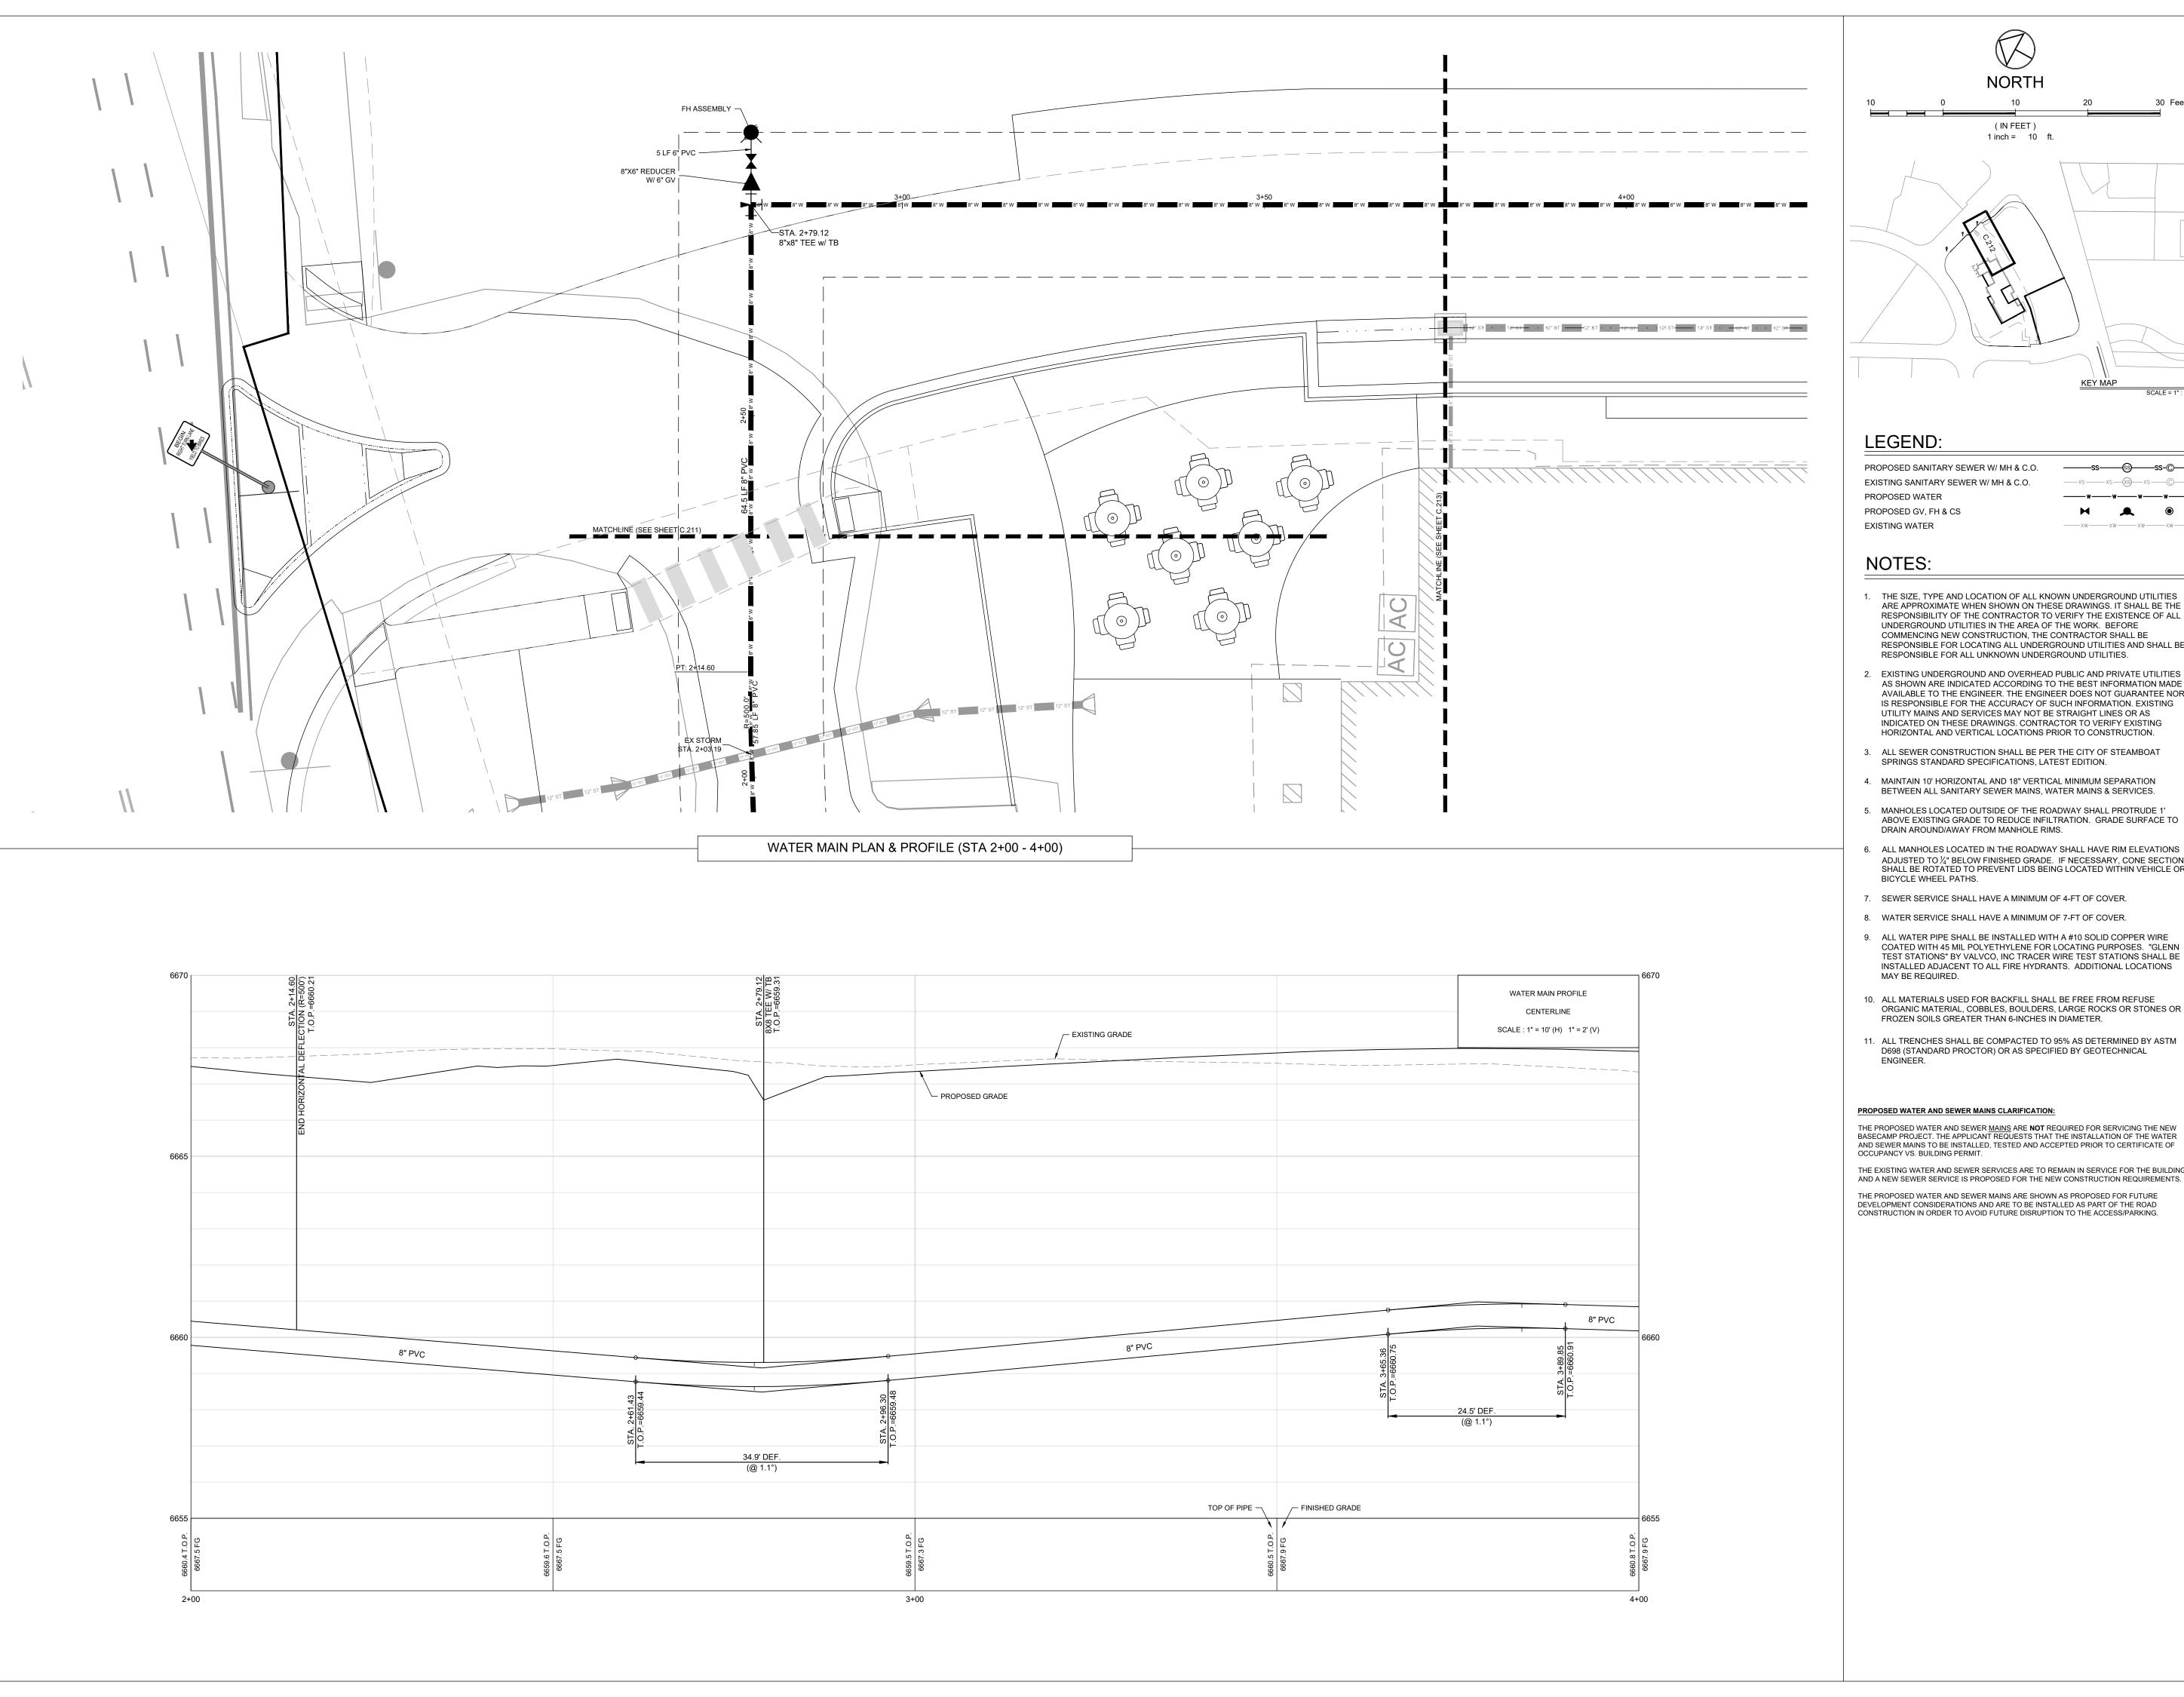

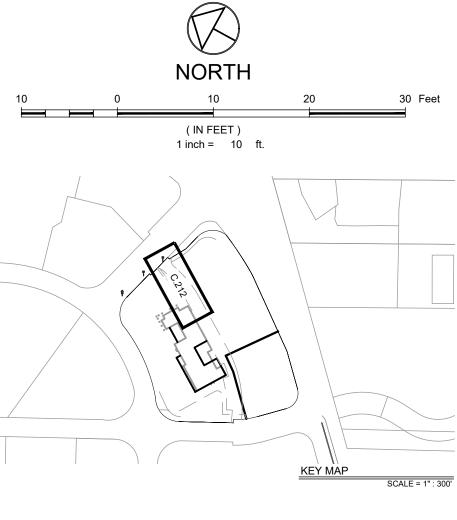

———ss——<u>\$</u>\$——ss-©— ____w__w___w____

- 1. THE SIZE, TYPE AND LOCATION OF ALL KNOWN UNDERGROUND UTILITIES ARE APPROXIMATE WHEN SHOWN ON THESE DRAWINGS. IT SHALL BE THE RESPONSIBILITY OF THE CONTRACTOR TO VERIFY THE EXISTENCE OF ALL UNDERGROUND UTILITIES IN THE AREA OF THE WORK. BEFORE COMMENCING NEW CONSTRUCTION, THE CONTRACTOR SHALL BE RESPONSIBLE FOR LOCATING ALL UNDERGROUND UTILITIES AND SHALL BE
- AS SHOWN ARE INDICATED ACCORDING TO THE BEST INFORMATION MADE AVAILABLE TO THE ENGINEER. THE ENGINEER DOES NOT GUARANTEE NOR IS RESPONSIBLE FOR THE ACCURACY OF SUCH INFORMATION. EXISTING UTILITY MAINS AND SERVICES MAY NOT BE STRAIGHT LINES OR AS INDICATED ON THESE DRAWINGS. CONTRACTOR TO VERIFY EXISTING
- 4. MAINTAIN 10' HORIZONTAL AND 18" VERTICAL MINIMUM SEPARATION
- 5. MANHOLES LOCATED OUTSIDE OF THE ROADWAY SHALL PROTRUDE 1' ABOVE EXISTING GRADE TO REDUCE INFILTRATION. GRADE SURFACE TO
- ALL MANHOLES LOCATED IN THE ROADWAY SHALL HAVE RIM ELEVATIONS ADJUSTED TO 1/4" BELOW FINISHED GRADE. IF NECESSARY, CONE SECTIONS SHALL BE ROTATED TO PREVENT LIDS BEING LOCATED WITHIN VEHICLE OR
- 7. SEWER SERVICE SHALL HAVE A MINIMUM OF 4-FT OF COVER.
- 8. WATER SERVICE SHALL HAVE A MINIMUM OF 7-FT OF COVER.
- 9. ALL WATER PIPE SHALL BE INSTALLED WITH A #10 SOLID COPPER WIRE COATED WITH 45 MIL POLYETHYLENE FOR LOCATING PURPOSES. "GLENN TEST STATIONS" BY VALVCO, INC TRACER WIRE TEST STATIONS SHALL BE INSTALLED ADJACENT TO ALL FIRE HYDRANTS. ADDITIONAL LOCATIONS
- 10. ALL MATERIALS USED FOR BACKFILL SHALL BE FREE FROM REFUSE ORGANIC MATERIAL, COBBLES, BOULDERS, LARGE ROCKS OR STONES OR
- D698 (STANDARD PROCTOR) OR AS SPECIFIED BY GEOTECHNICAL

THE PROPOSED WATER AND SEWER <u>MAINS</u> ARE **NOT** REQUIRED FOR SERVICING THE NEW BASECAMP PROJECT. THE APPLICANT REQUESTS THAT THE INSTALLATION OF THE WATER AND SEWER MAINS TO BE INSTALLED, TESTED AND ACCEPTED PRIOR TO CERTIFICATE OF

THE EXISTING WATER AND SEWER SERVICES ARE TO REMAIN IN SERVICE FOR THE BUILDING AND A NEW SEWER SERVICE IS PROPOSED FOR THE NEW CONSTRUCTION REQUIREMENTS. THE PROPOSED WATER AND SEWER MAINS ARE SHOWN AS PROPOSED FOR FUTURE

No. Date Description

APPROVAL STAMPS:

OWNER

SUBMISSIONS & REVISIONS

MAY REIGLER PROPERTIES 2201 WISCONSIN AVE NW SUITE 200 WASHINGTON DC 20007

ARCHITECT



3318 N. Columbus Street Arlington, VA 22207 T.312.636.3248 / 312.636.4252 www.kasa-arch.com

STRUCTURAL ENGINEER

STEAMBOAT ENGINEERING AND DESIGN, INC 2740 ACRE LANE, STE. E STEAMBOAT SPRINGS, CO 80487

M.E.P. & F.P. ENGINEERS

BOULDER ENGINEERING 1717 15TH STREET BOULDER, CO 80302

CIVIL ENGINEER

LANDMARK ENGINEERING

141 9TH STREET PO BOX 774943 STEAMBOAT SPRINGS, CO 80477

LANDSCAPE ARCHITECT

GENERAL CONTRACTOR


PROJECT LOCATION

STEAMBOAT BASECAMP

1901 CURVE PLAZA STEAMBOAT SPRINGS, CO 80487 DRAWING TITLE

> **WATER MAIN** PLAN & PROFILE

6/18/21 DRAWN BY: CHECKED BY: PROJECT NO:

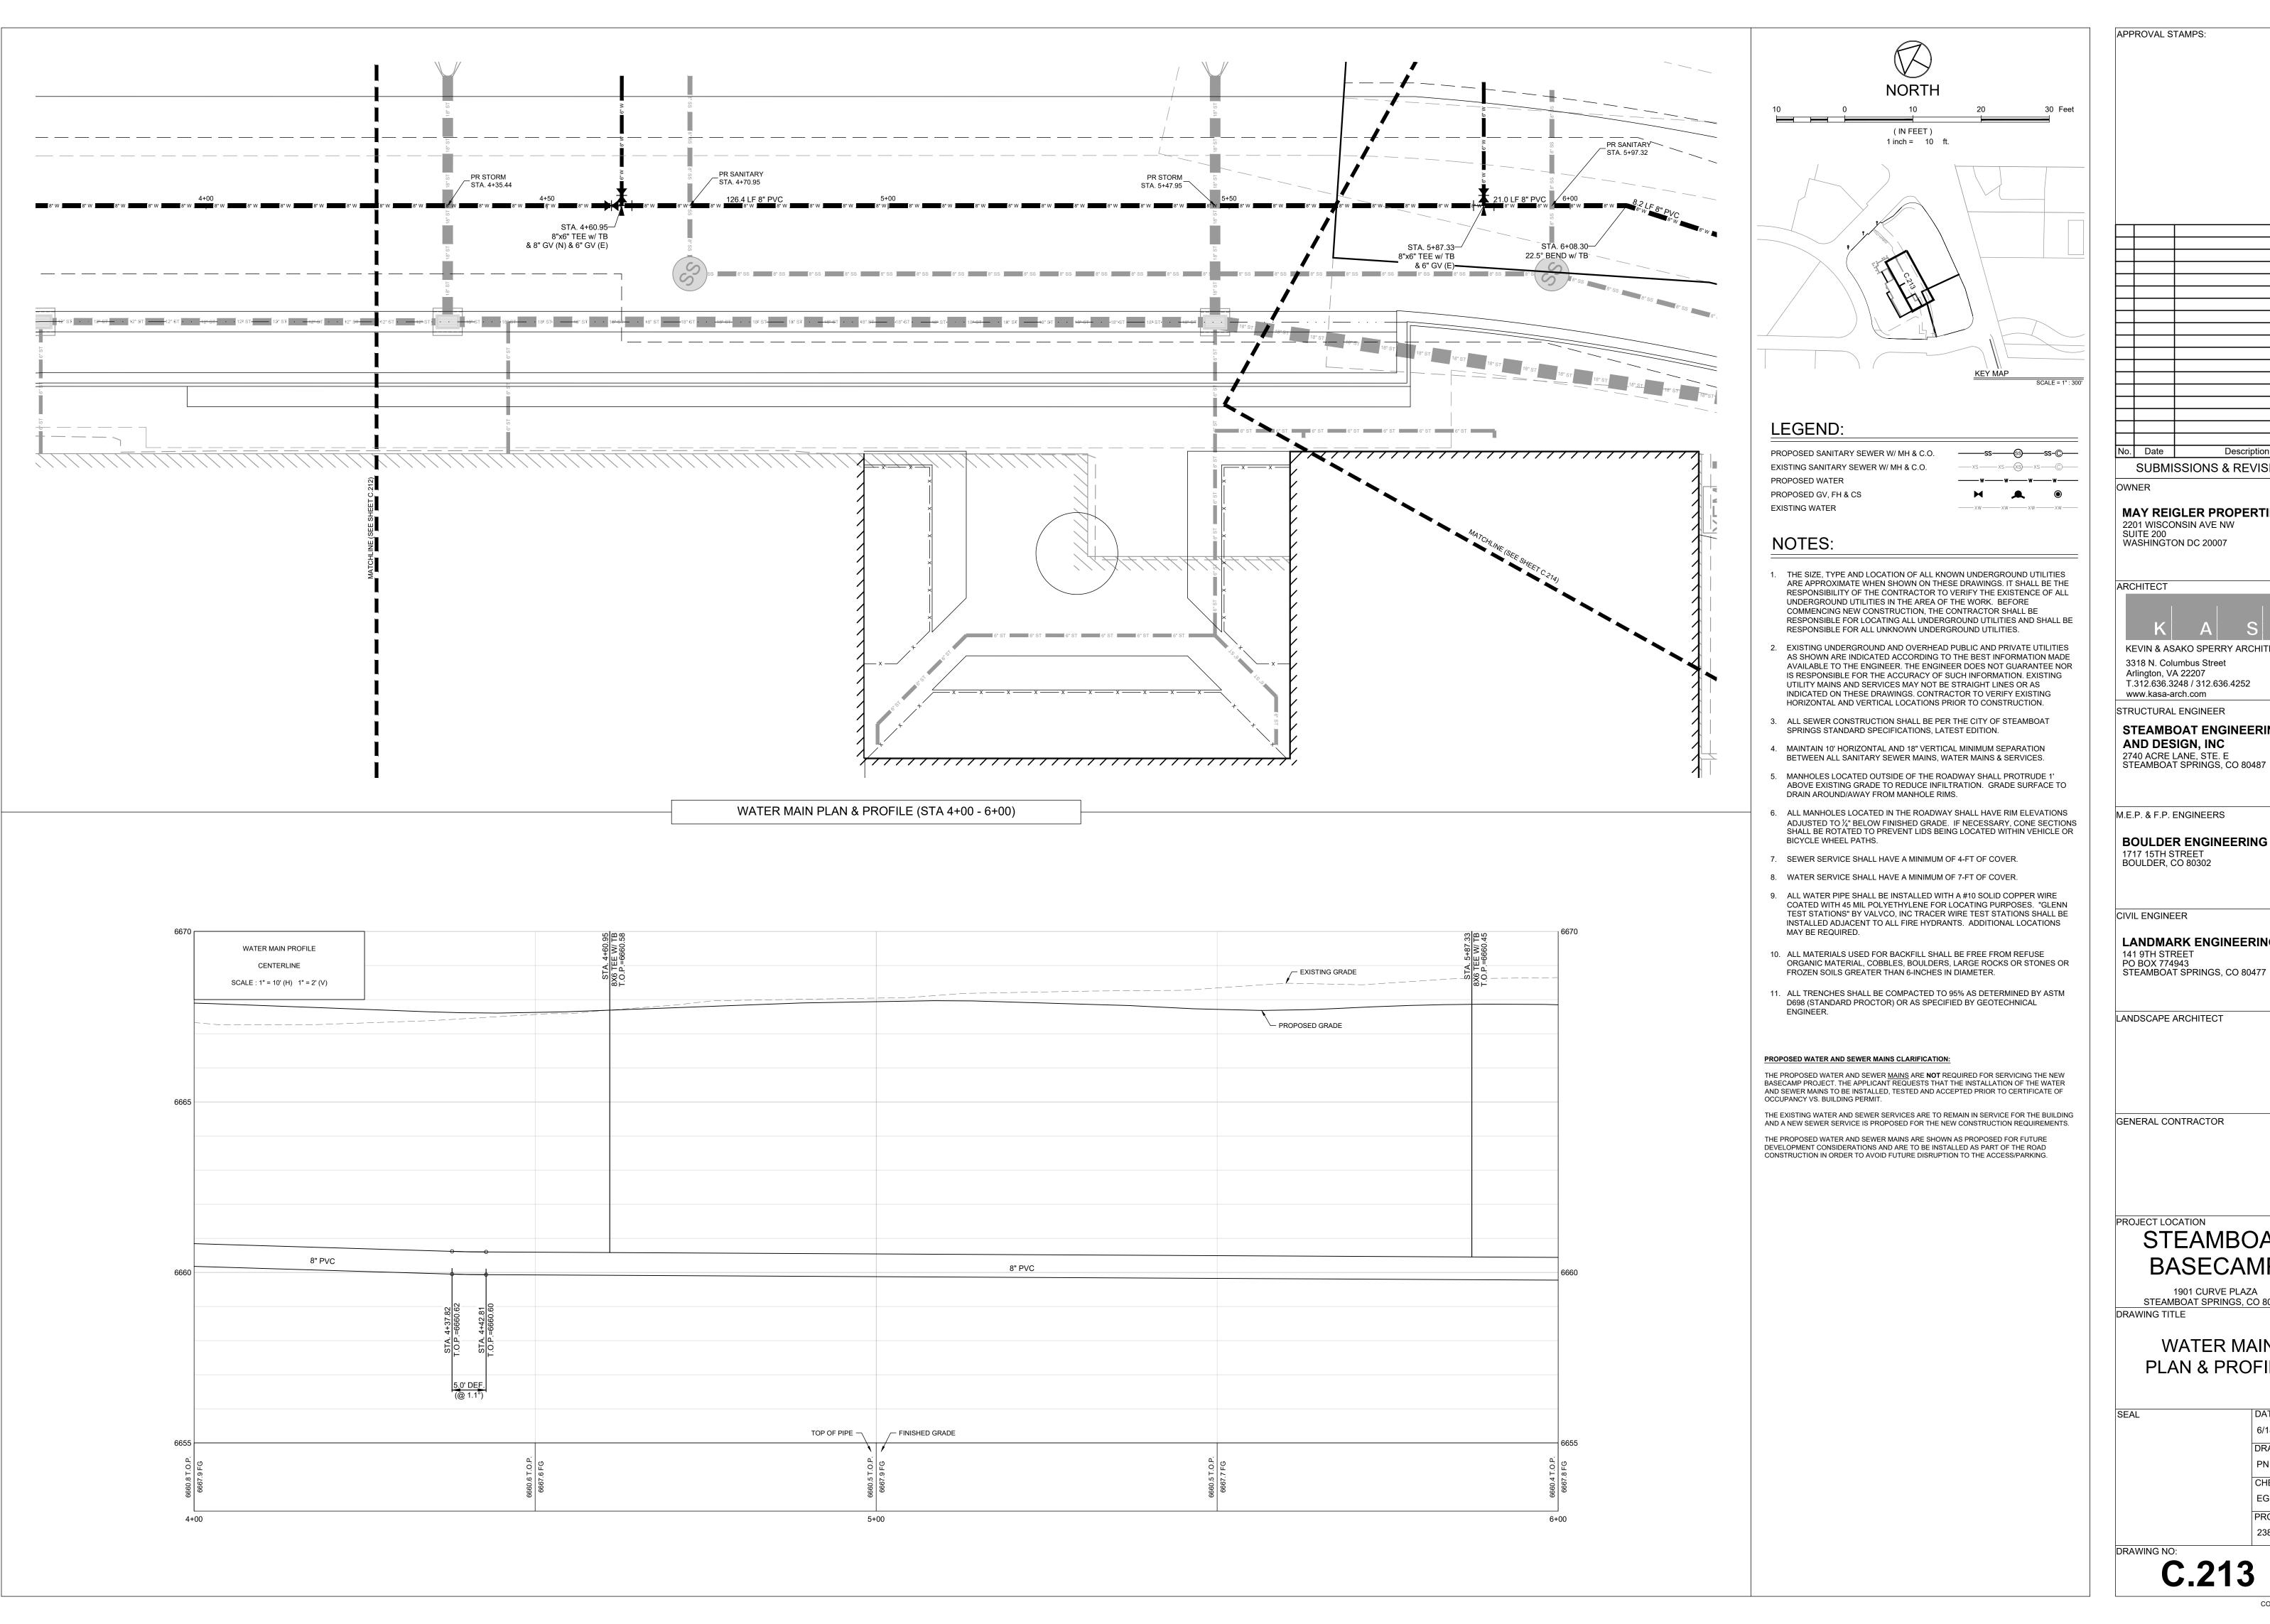

APPROVAL STAMPS:

No. Date Description SUBMISSIONS & REVISIONS

MAY REIGLER PROPERTIES 2201 WISCONSIN AVE NW SUITE 200



KEVIN & ASAKO SPERRY ARCHITECTURE 3318 N. Columbus Street Arlington, VA 22207 T.312.636.3248 / 312.636.4252

STRUCTURAL ENGINEER

STEAMBOAT ENGINEERING AND DESIGN, INC 2740 ACRE LANE, STE. E STEAMBOAT SPRINGS, CO 80487

M.E.P. & F.P. ENGINEERS

BOULDER ENGINEERING 1717 15TH STREET BOULDER, CO 80302

LANDMARK ENGINEERING


STEAMBOAT


1901 CURVE PLAZA STEAMBOAT SPRINGS, CO 80487

WATER MAIN PLAN & PROFILE

> 6/18/21 DRAWN BY: CHECKED BY: PROJECT NO:

COPYRIGHT 2019

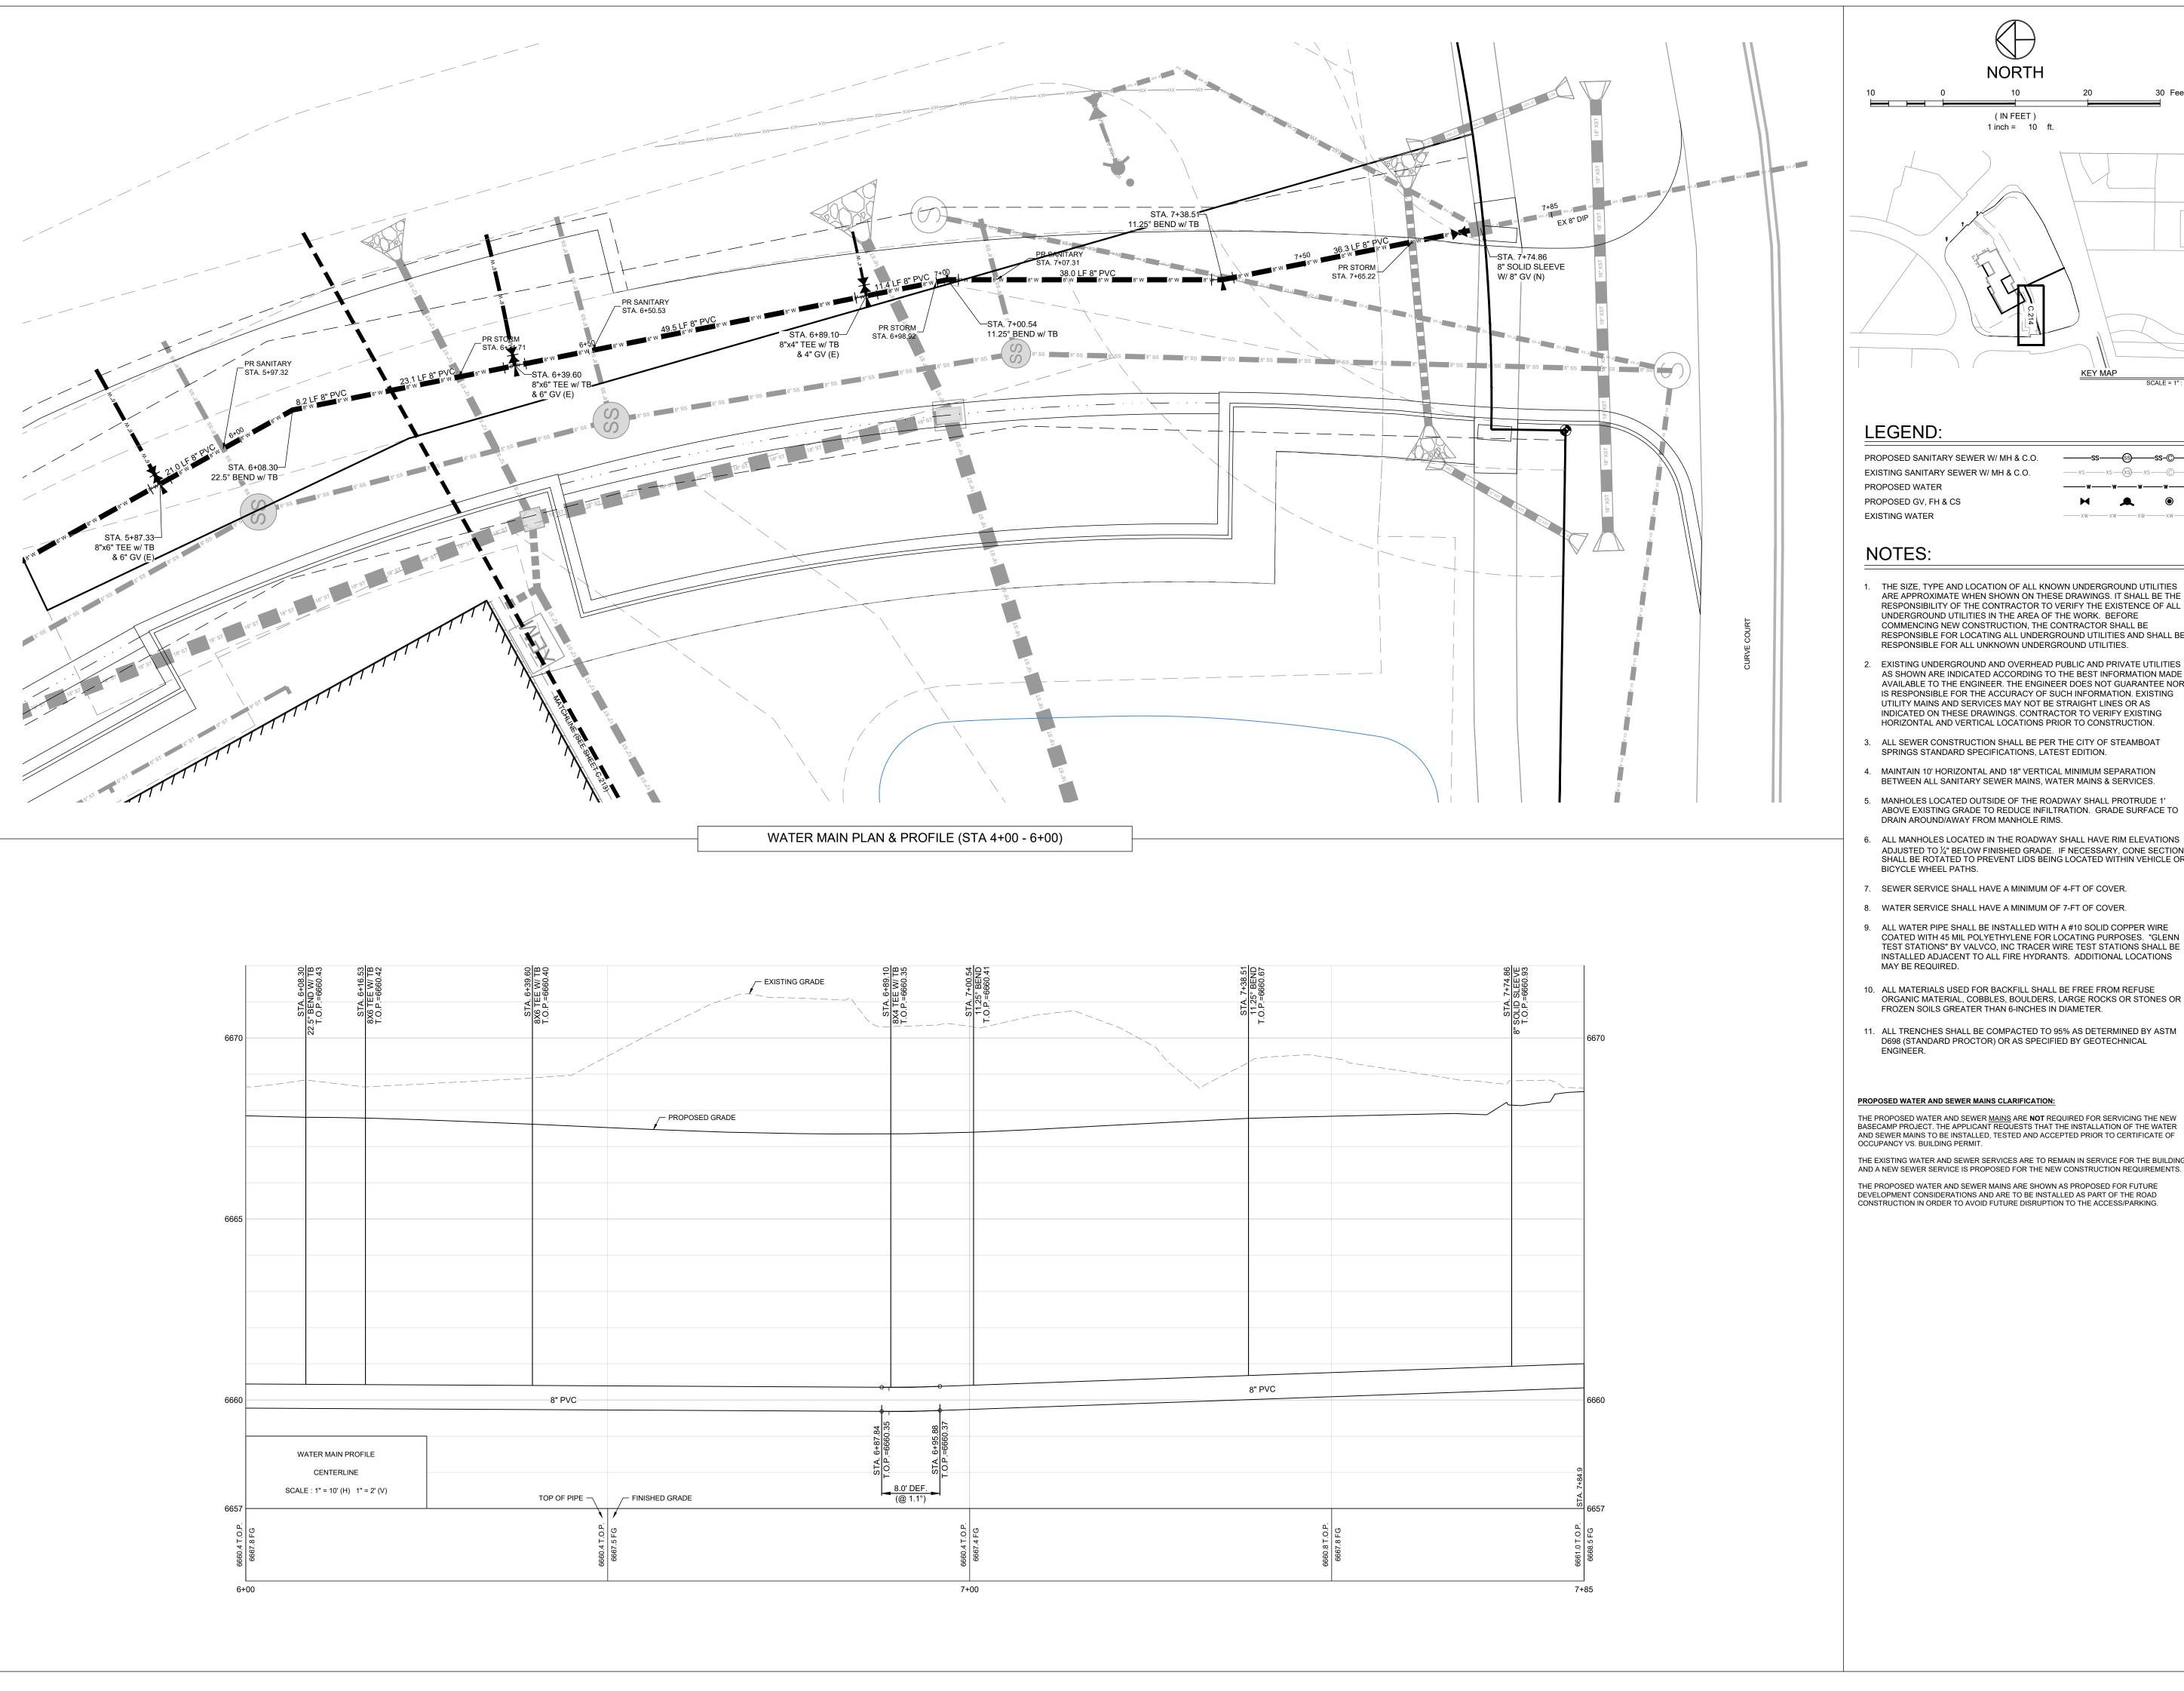

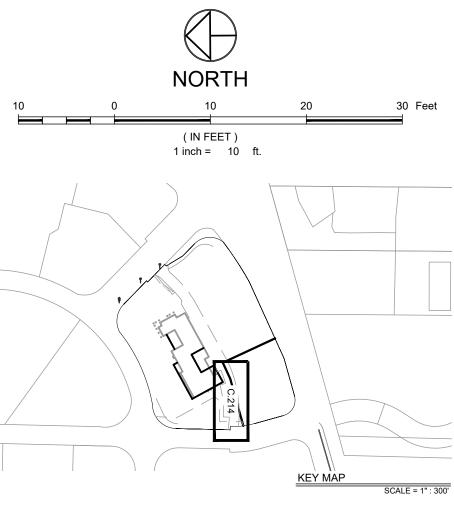

———ss——ss-©—— ____w__w___w____

- 1. THE SIZE, TYPE AND LOCATION OF ALL KNOWN UNDERGROUND UTILITIES ARE APPROXIMATE WHEN SHOWN ON THESE DRAWINGS. IT SHALL BE THE RESPONSIBILITY OF THE CONTRACTOR TO VERIFY THE EXISTENCE OF ALL UNDERGROUND UTILITIES IN THE AREA OF THE WORK. BEFORE COMMENCING NEW CONSTRUCTION, THE CONTRACTOR SHALL BE RESPONSIBLE FOR LOCATING ALL UNDERGROUND UTILITIES AND SHALL BE
- AS SHOWN ARE INDICATED ACCORDING TO THE BEST INFORMATION MADE AVAILABLE TO THE ENGINEER. THE ENGINEER DOES NOT GUARANTEE NOR IS RESPONSIBLE FOR THE ACCURACY OF SUCH INFORMATION. EXISTING UTILITY MAINS AND SERVICES MAY NOT BE STRAIGHT LINES OR AS INDICATED ON THESE DRAWINGS. CONTRACTOR TO VERIFY EXISTING
- 3. ALL SEWER CONSTRUCTION SHALL BE PER THE CITY OF STEAMBOAT
- 4. MAINTAIN 10' HORIZONTAL AND 18" VERTICAL MINIMUM SEPARATION
- 5. MANHOLES LOCATED OUTSIDE OF THE ROADWAY SHALL PROTRUDE 1' ABOVE EXISTING GRADE TO REDUCE INFILTRATION. GRADE SURFACE TO
- ALL MANHOLES LOCATED IN THE ROADWAY SHALL HAVE RIM ELEVATIONS ADJUSTED TO ¼" BELOW FINISHED GRADE. IF NECESSARY, CONE SECTIONS SHALL BE ROTATED TO PREVENT LIDS BEING LOCATED WITHIN VEHICLE OR
- 7. SEWER SERVICE SHALL HAVE A MINIMUM OF 4-FT OF COVER.
- 8. WATER SERVICE SHALL HAVE A MINIMUM OF 7-FT OF COVER.
- ALL WATER PIPE SHALL BE INSTALLED WITH A #10 SOLID COPPER WIRE COATED WITH 45 MIL POLYETHYLENE FOR LOCATING PURPOSES. "GLENN TEST STATIONS" BY VALVCO, INC TRACER WIRE TEST STATIONS SHALL BE INSTALLED ADJACENT TO ALL FIRE HYDRANTS. ADDITIONAL LOCATIONS
- 10. ALL MATERIALS USED FOR BACKFILL SHALL BE FREE FROM REFUSE ORGANIC MATERIAL, COBBLES, BOULDERS, LARGE ROCKS OR STONES OR
- 11. ALL TRENCHES SHALL BE COMPACTED TO 95% AS DETERMINED BY ASTM D698 (STANDARD PROCTOR) OR AS SPECIFIED BY GEOTECHNICAL

THE PROPOSED WATER AND SEWER <u>MAINS</u> ARE **NOT** REQUIRED FOR SERVICING THE NEW BASECAMP PROJECT. THE APPLICANT REQUESTS THAT THE INSTALLATION OF THE WATER AND SEWER MAINS TO BE INSTALLED, TESTED AND ACCEPTED PRIOR TO CERTIFICATE OF

THE EXISTING WATER AND SEWER SERVICES ARE TO REMAIN IN SERVICE FOR THE BUILDING AND A NEW SEWER SERVICE IS PROPOSED FOR THE NEW CONSTRUCTION REQUIREMENTS. THE PROPOSED WATER AND SEWER MAINS ARE SHOWN AS PROPOSED FOR FUTURE

APPROVAL STAMPS:

No. Date Description SUBMISSIONS & REVISIONS

OWNER

MAY REIGLER PROPERTIES 2201 WISCONSIN AVE NW SUITE 200 WASHINGTON DC 20007

ARCHITECT



KEVIN & ASAKO SPERRY ARCHITECTURE 3318 N. Columbus Street Arlington, VA 22207 T.312.636.3248 / 312.636.4252 www.kasa-arch.com

STRUCTURAL ENGINEER

STEAMBOAT ENGINEERING AND DESIGN, INC 2740 ACRE LANE, STE. E STEAMBOAT SPRINGS, CO 80487

M.E.P. & F.P. ENGINEERS

BOULDER ENGINEERING 1717 15TH STREET BOULDER, CO 80302

CIVIL ENGINEER

LANDMARK ENGINEERING

141 9TH STREET PO BOX 774943 STEAMBOAT SPRINGS, CO 80477

LANDSCAPE ARCHITECT

GENERAL CONTRACTOR

PROJECT LOCATION


STEAMBOAT BASECAMP

1901 CURVE PLAZA STEAMBOAT SPRINGS, CO 80487 DRAWING TITLE

> **WATER MAIN** PLAN & PROFILE

6/18/21 DRAWN BY: CHECKED BY:

PROJECT NO: 2387-004

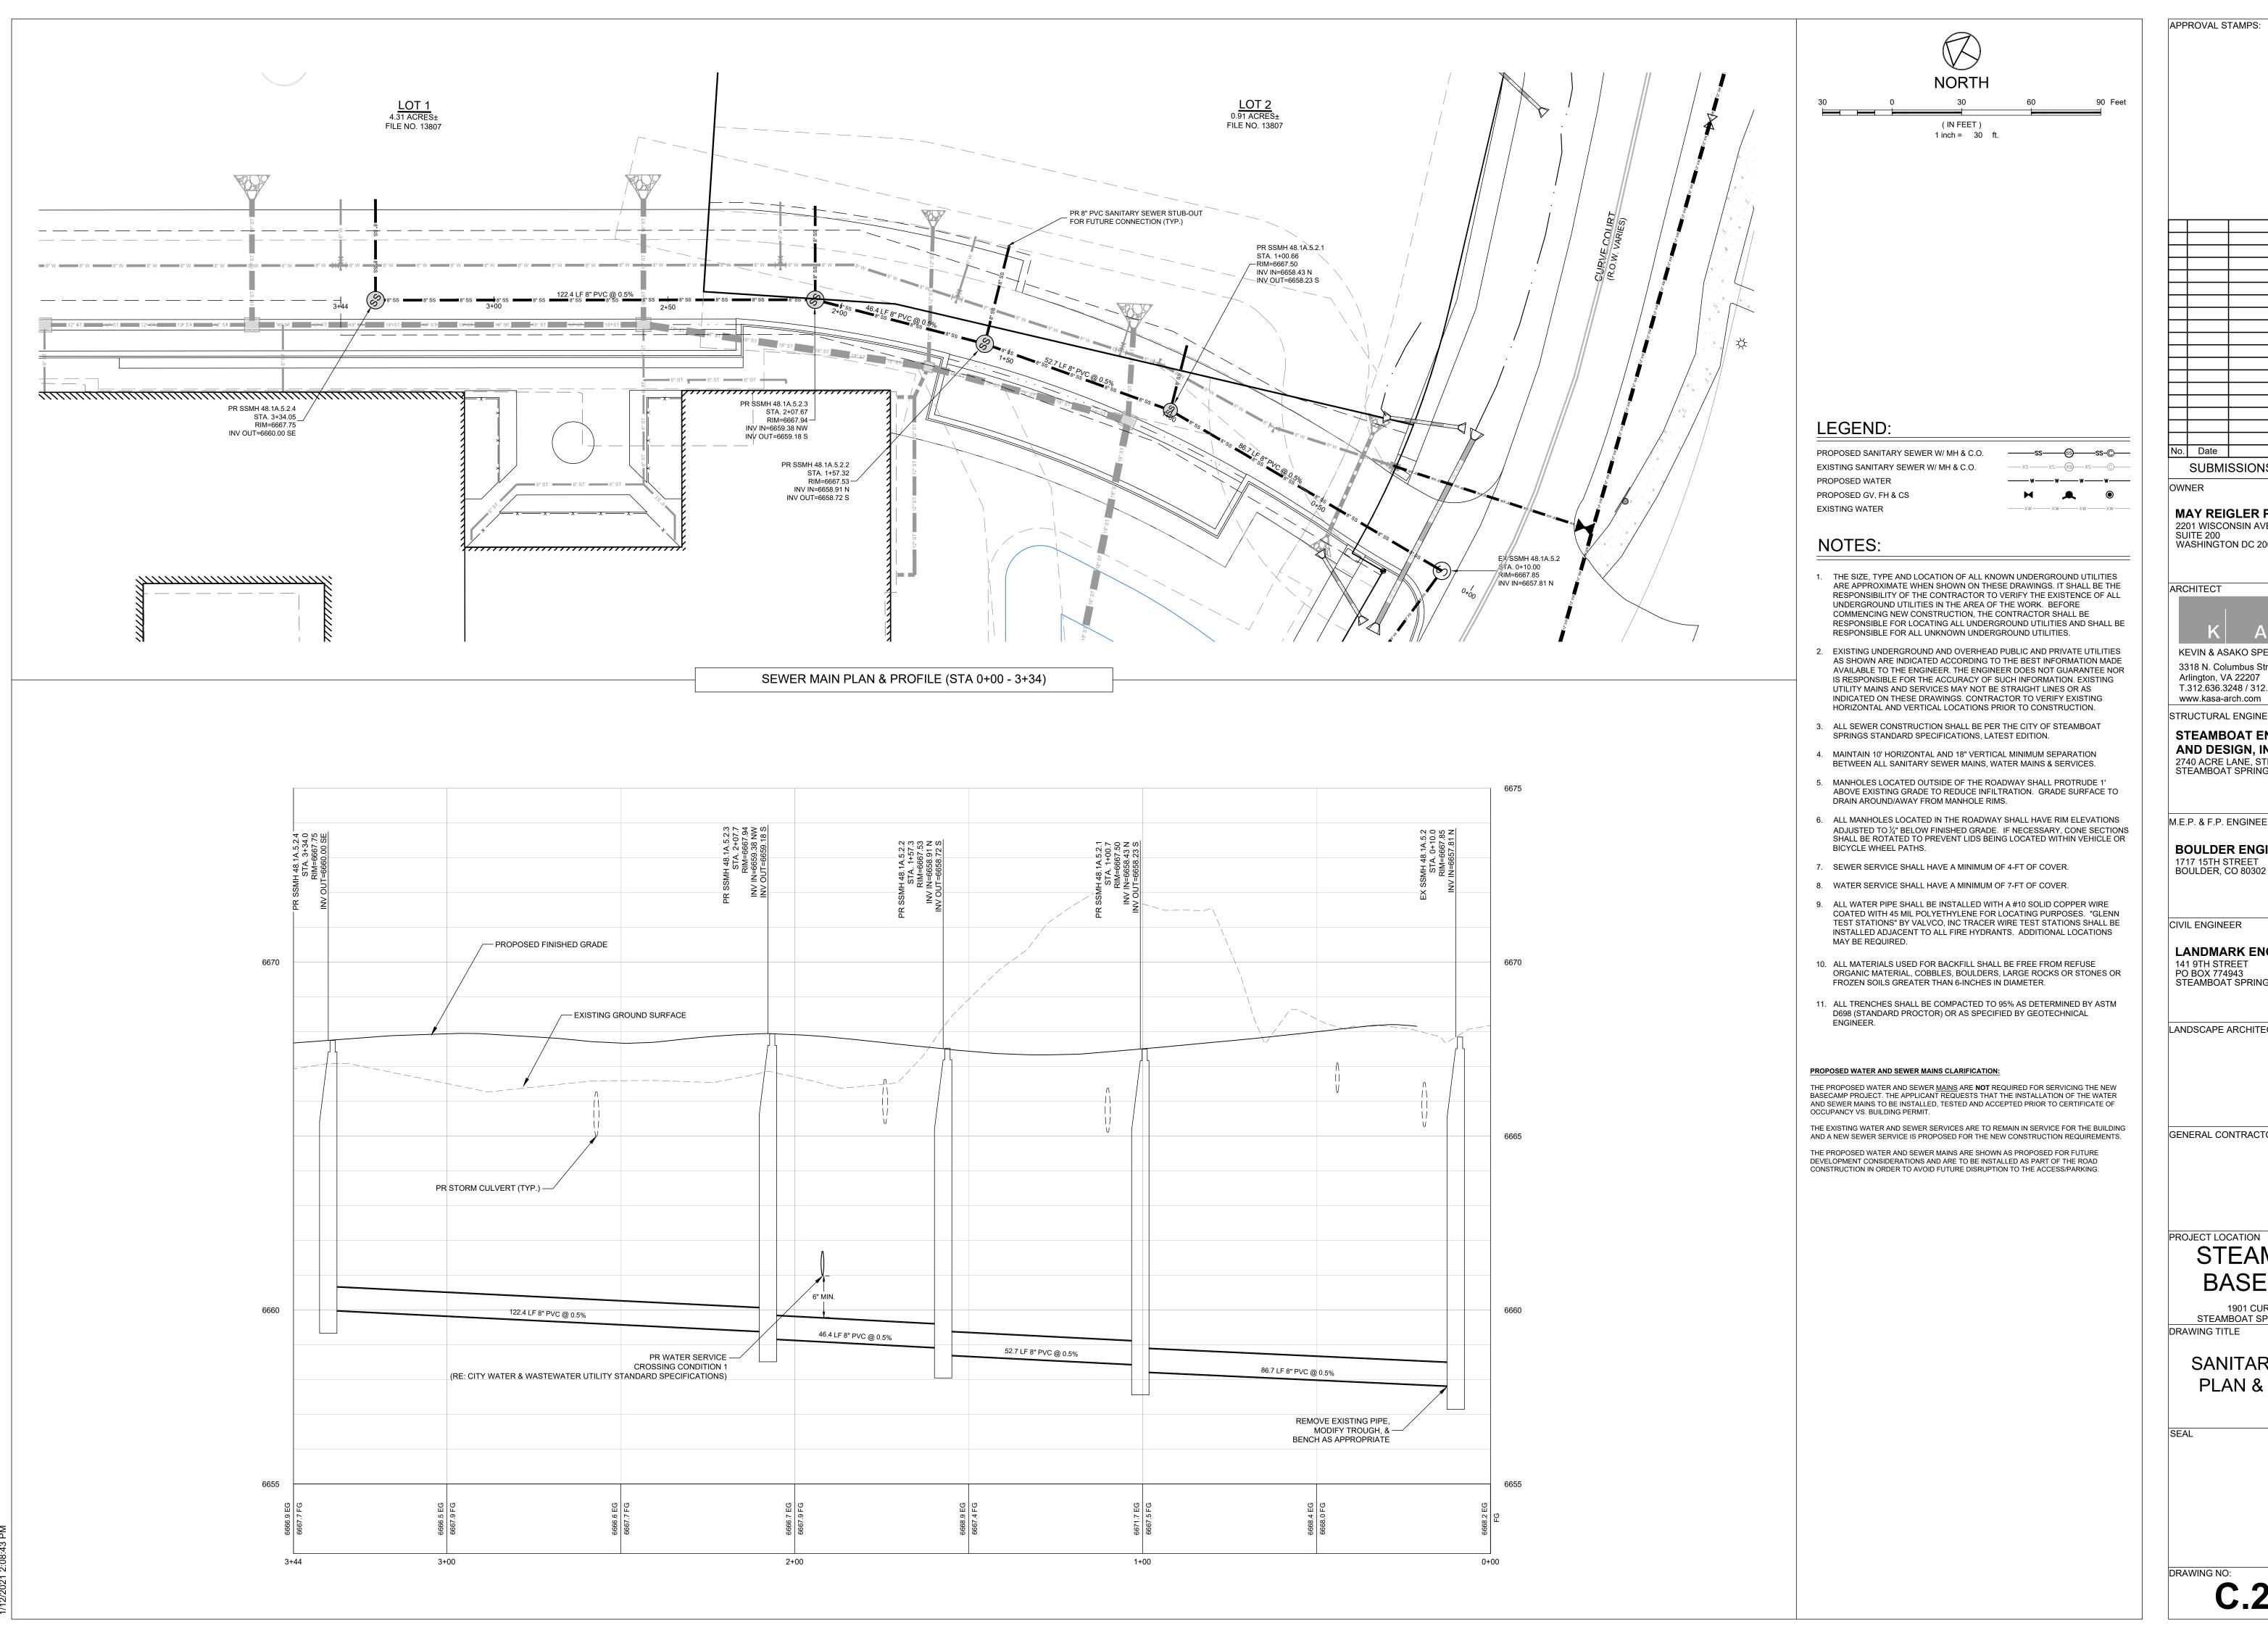

APPROVAL STAMPS: No. Date Description SUBMISSIONS & REVISIONS MAY REIGLER PROPERTIES 2201 WISCONSIN AVE NW SUITE 200 WASHINGTON DC 20007 ARCHITECT



KEVIN & ASAKO SPERRY ARCHITECTURE 3318 N. Columbus Street Arlington, VA 22207 T.312.636.3248 / 312.636.4252

STRUCTURAL ENGINEER

STEAMBOAT ENGINEERING AND DESIGN, INC 2740 ACRE LANE, STE. E STEAMBOAT SPRINGS, CO 80487

M.E.P. & F.P. ENGINEERS

BOULDER ENGINEERING 1717 15TH STREET BOULDER, CO 80302

CIVIL ENGINEER

LANDMARK ENGINEERING

STEAMBOAT SPRINGS, CO 80477

LANDSCAPE ARCHITECT

GENERAL CONTRACTOR


STEAMBOAT BASECAMP

1901 CURVE PLAZA STEAMBOAT SPRINGS, CO 80487

SANITARY SEWER PLAN & PROFILE

6/18/21 DRAWN BY: CHECKED BY: PROJECT NO:

COPYRIGHT 2019

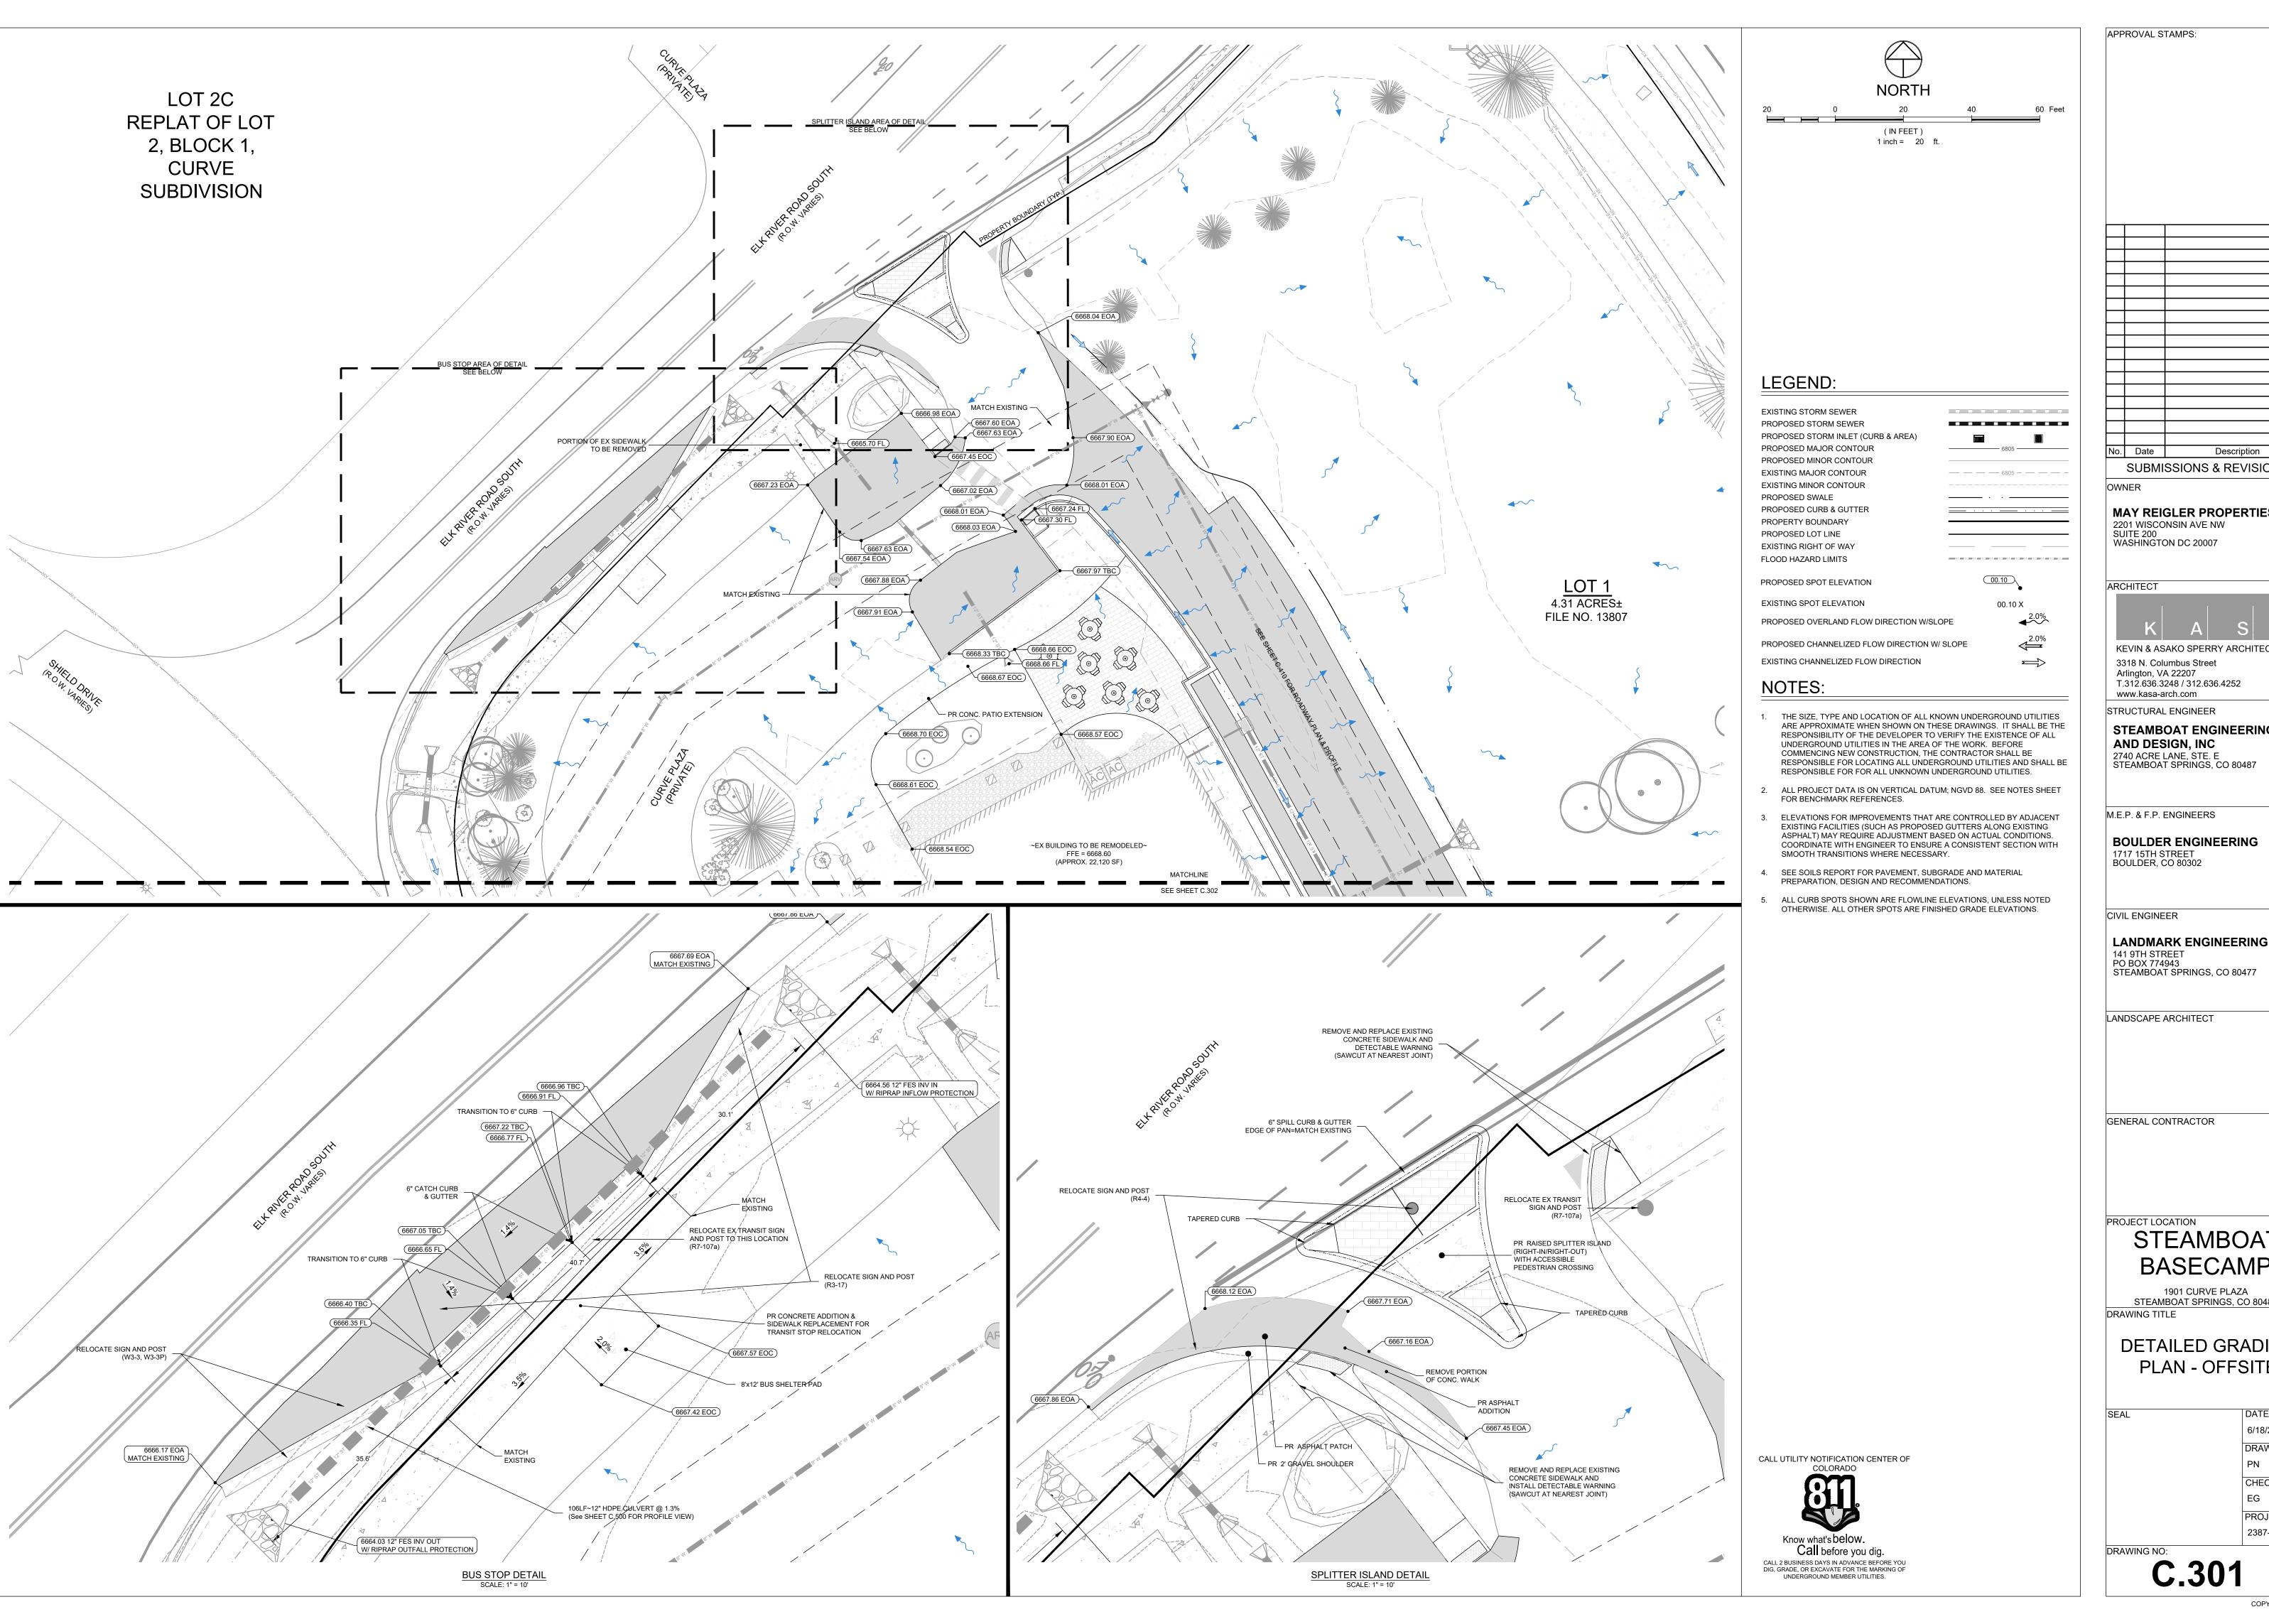

APPROVAL STAMPS: No. Date Description SUBMISSIONS & REVISIONS MAY REIGLER PROPERTIES 2201 WISCONSIN AVE NW SUITE 200 WASHINGTON DC 20007 ARCHITECT KEVIN & ASAKO SPERRY ARCHITECTURE 3318 N. Columbus Street Arlington, VA 22207 T.312.636.3248 / 312.636.4252 www.kasa-arch.com

> PROJECT LOCATION STEAMBOAT


STEAMBOAT ENGINEERING


BASECAMP 1901 CURVE PLAZA STEAMBOAT SPRINGS, CO 80487 DRAWING TITLE

DETAILED GRADING PLAN - OFFSITE

6/18/21 DRAWN BY: CHECKED BY: EG PROJECT NO: 2387-004

DRAWING NO: C.301

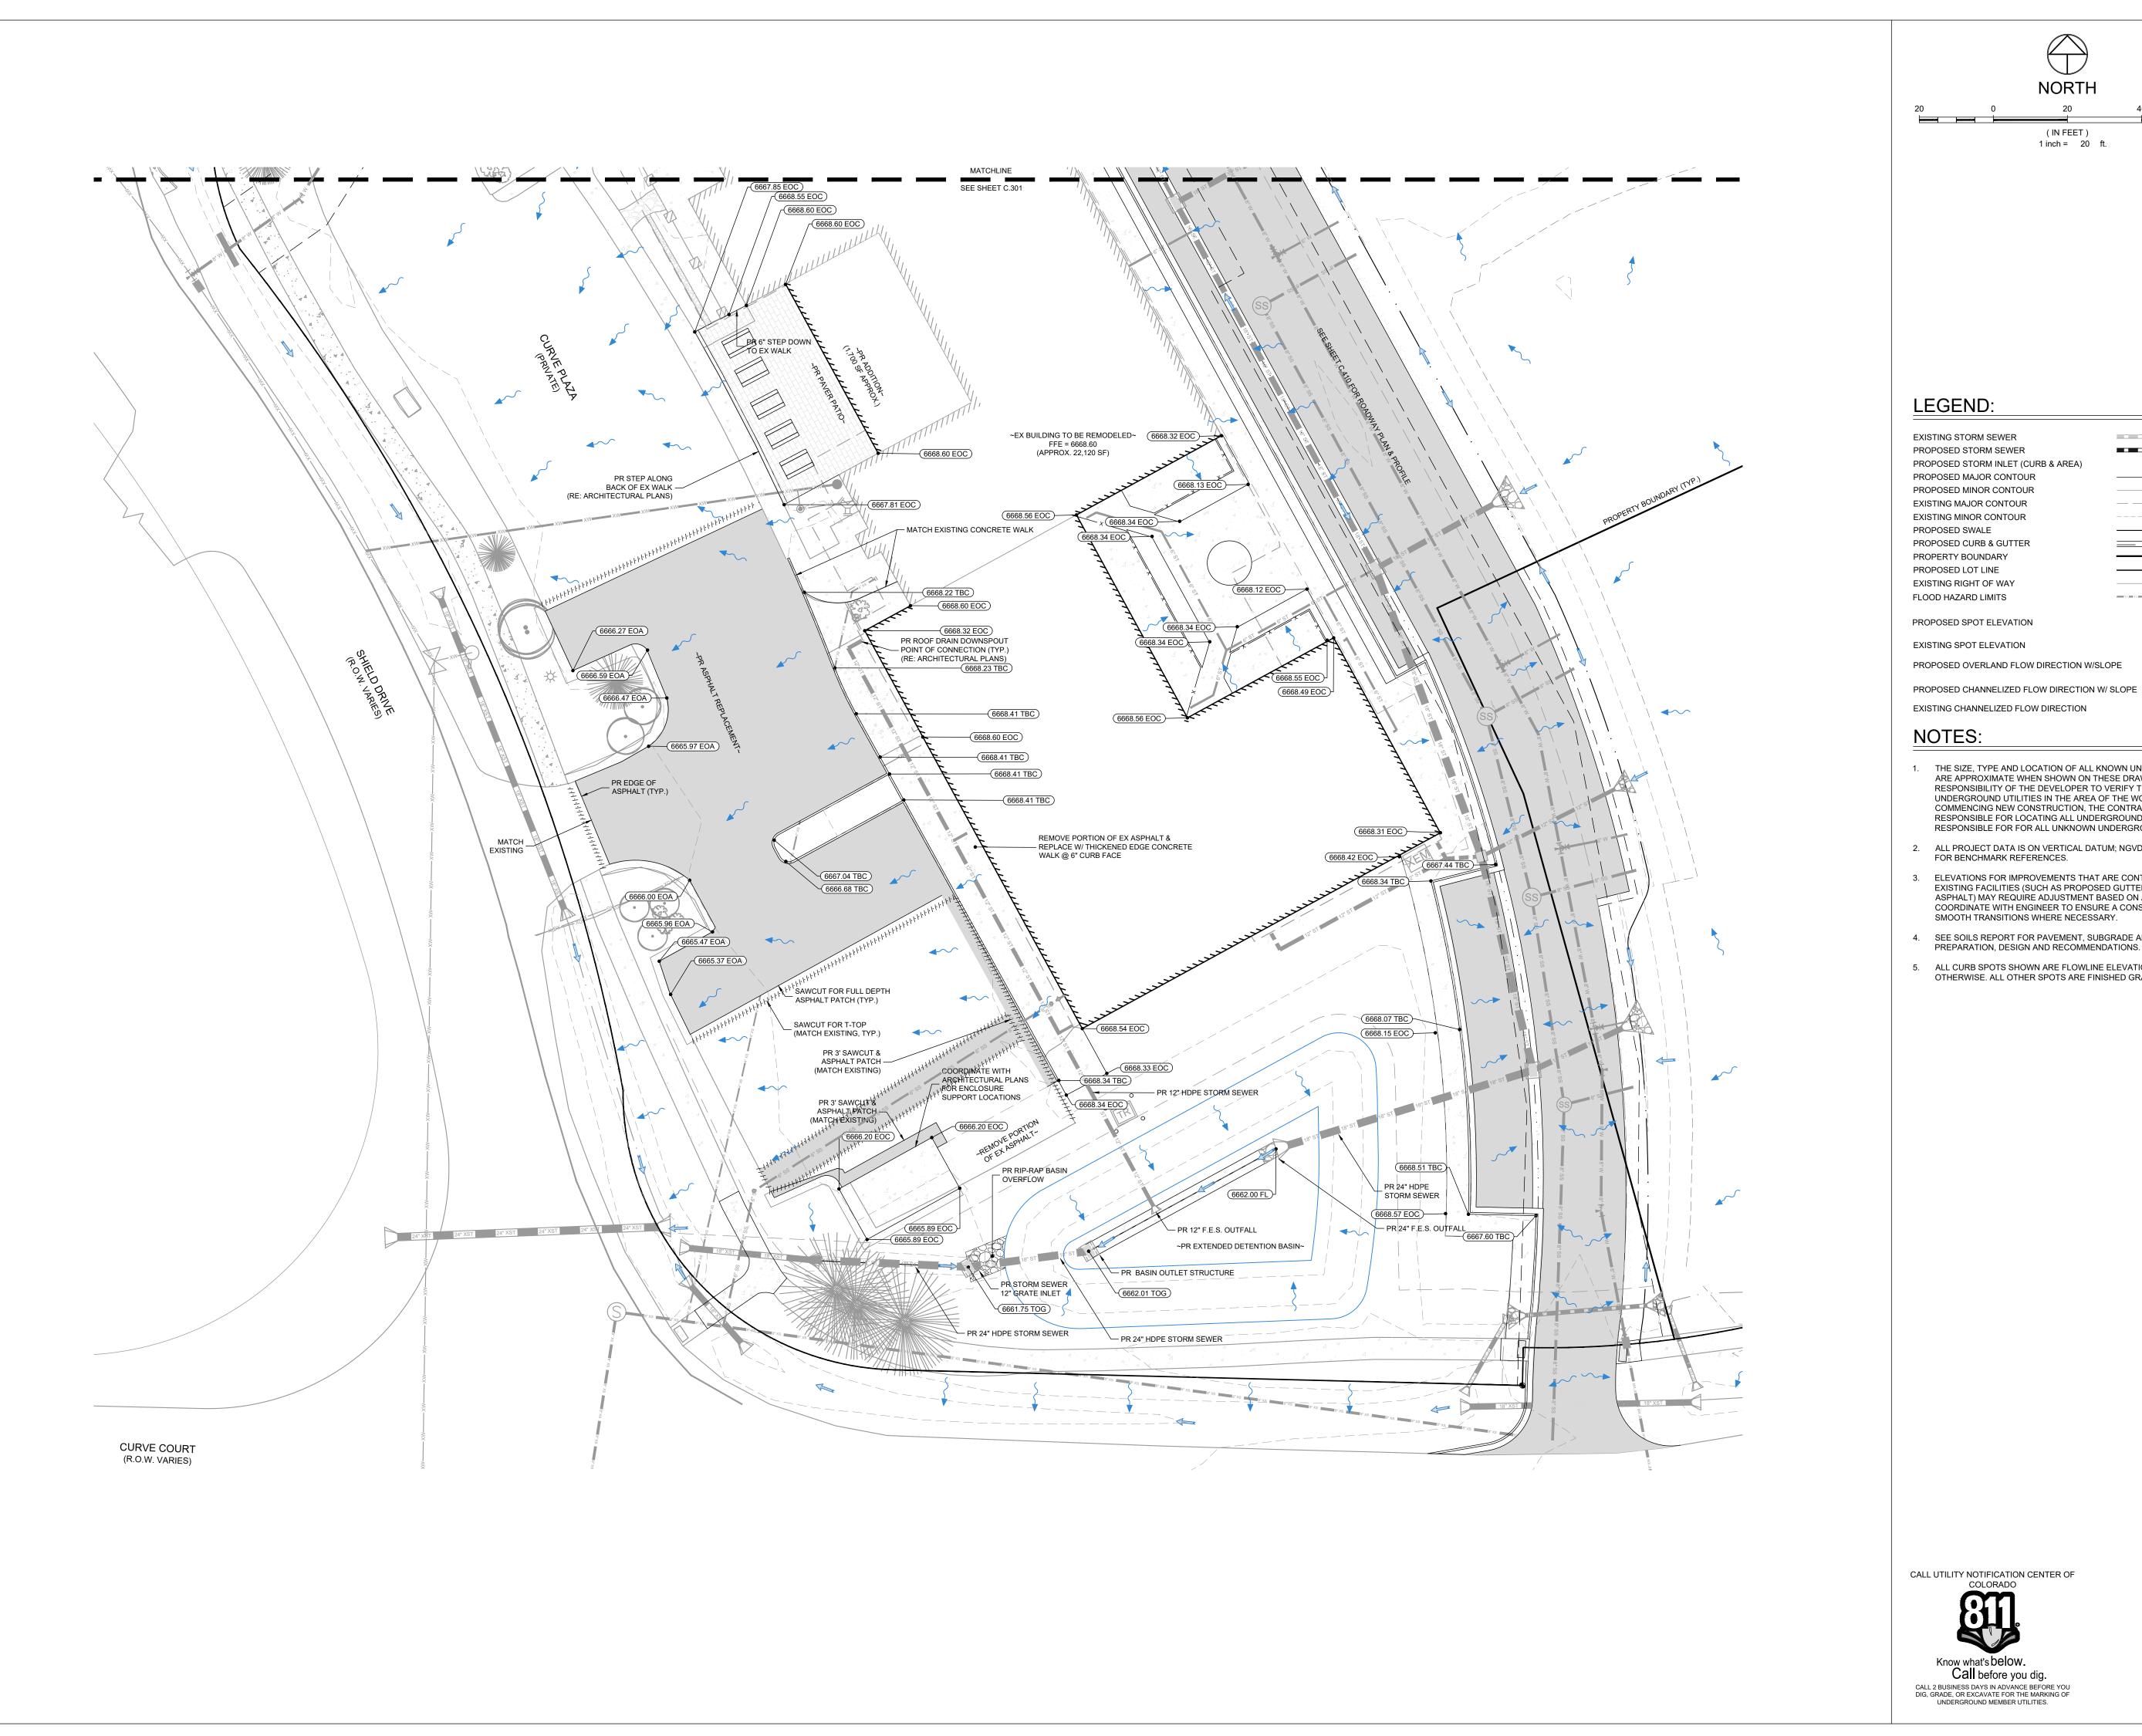

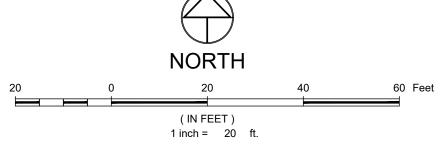

LEGEND:

EXISTING STORM SEWER PROPOSED STORM SEWER PROPOSED STORM INLET (CURB & AREA) PROPOSED MAJOR CONTOUR PROPOSED MINOR CONTOUR EXISTING MAJOR CONTOUR — — — 6805 — — — — EXISTING MINOR CONTOUR PROPOSED SWALE PROPOSED CURB & GUTTER PROPERTY BOUNDARY PROPOSED LOT LINE EXISTING RIGHT OF WAY FLOOD HAZARD LIMITS 00.10 PROPOSED SPOT ELEVATION EXISTING SPOT ELEVATION 00.10 X PROPOSED OVERLAND FLOW DIRECTION W/SLOPE

- 1. THE SIZE, TYPE AND LOCATION OF ALL KNOWN UNDERGROUND UTILITIES ARE APPROXIMATE WHEN SHOWN ON THESE DRAWINGS. IT SHALL BE THE RESPONSIBILITY OF THE DEVELOPER TO VERIFY THE EXISTENCE OF ALL UNDERGROUND UTILITIES IN THE AREA OF THE WORK. BEFORE COMMENCING NEW CONSTRUCTION, THE CONTRACTOR SHALL BE RESPONSIBLE FOR LOCATING ALL UNDERGROUND UTILITIES AND SHALL BE RESPONSIBLE FOR FOR ALL UNKNOWN UNDERGROUND UTILITIES.
- 2. ALL PROJECT DATA IS ON VERTICAL DATUM; NGVD 88. SEE NOTES SHEET FOR BENCHMARK REFERENCES.
- 3. ELEVATIONS FOR IMPROVEMENTS THAT ARE CONTROLLED BY ADJACENT EXISTING FACILITIES (SUCH AS PROPOSED GUTTERS ALONG EXISTING ASPHALT) MAY REQUIRE ADJUSTMENT BASED ON ACTUAL CONDITIONS. COORDINATE WITH ENGINEER TO ENSURE A CONSISTENT SECTION WITH SMOOTH TRANSITIONS WHERE NECESSARY.
- 4. SEE SOILS REPORT FOR PAVEMENT, SUBGRADE AND MATERIAL PREPARATION, DESIGN AND RECOMMENDATIONS.
- 5. ALL CURB SPOTS SHOWN ARE FLOWLINE ELEVATIONS, UNLESS NOTED OTHERWISE. ALL OTHER SPOTS ARE FINISHED GRADE ELEVATIONS.

No. Date Description

APPROVAL STAMPS:

SUBMISSIONS & REVISIONS OWNER

MAY REIGLER PROPERTIES 2201 WISCONSIN AVE NW SUITE 200 WASHINGTON DC 20007

ARCHITECT



KEVIN & ASAKO SPERRY ARCHITECTURE 3318 N. Columbus Street Arlington, VA 22207 T.312.636.3248 / 312.636.4252 www.kasa-arch.com

STRUCTURAL ENGINEER

STEAMBOAT ENGINEERING AND DESIGN, INC 2740 ACRE LANE, STE. E STEAMBOAT SPRINGS, CO 80487

M.E.P. & F.P. ENGINEERS

BOULDER ENGINEERING 1717 15TH STREET BOULDER, CO 80302

CIVIL ENGINEER

LANDMARK ENGINEERING
141 9TH STREET

PO BOX 774943 STEAMBOAT SPRINGS, CO 80477

LANDSCAPE ARCHITECT

GENERAL CONTRACTOR

PROJECT LOCATION


STEAMBOAT BASECAMP

1901 CURVE PLAZA STEAMBOAT SPRINGS, CO 80487 DRAWING TITLE

DETAILED GRADING PLAN - ONSITE

6/18/21 DRAWN BY: CHECKED BY: EG PROJECT NO: 2387-004

DRAWING NO: C.302

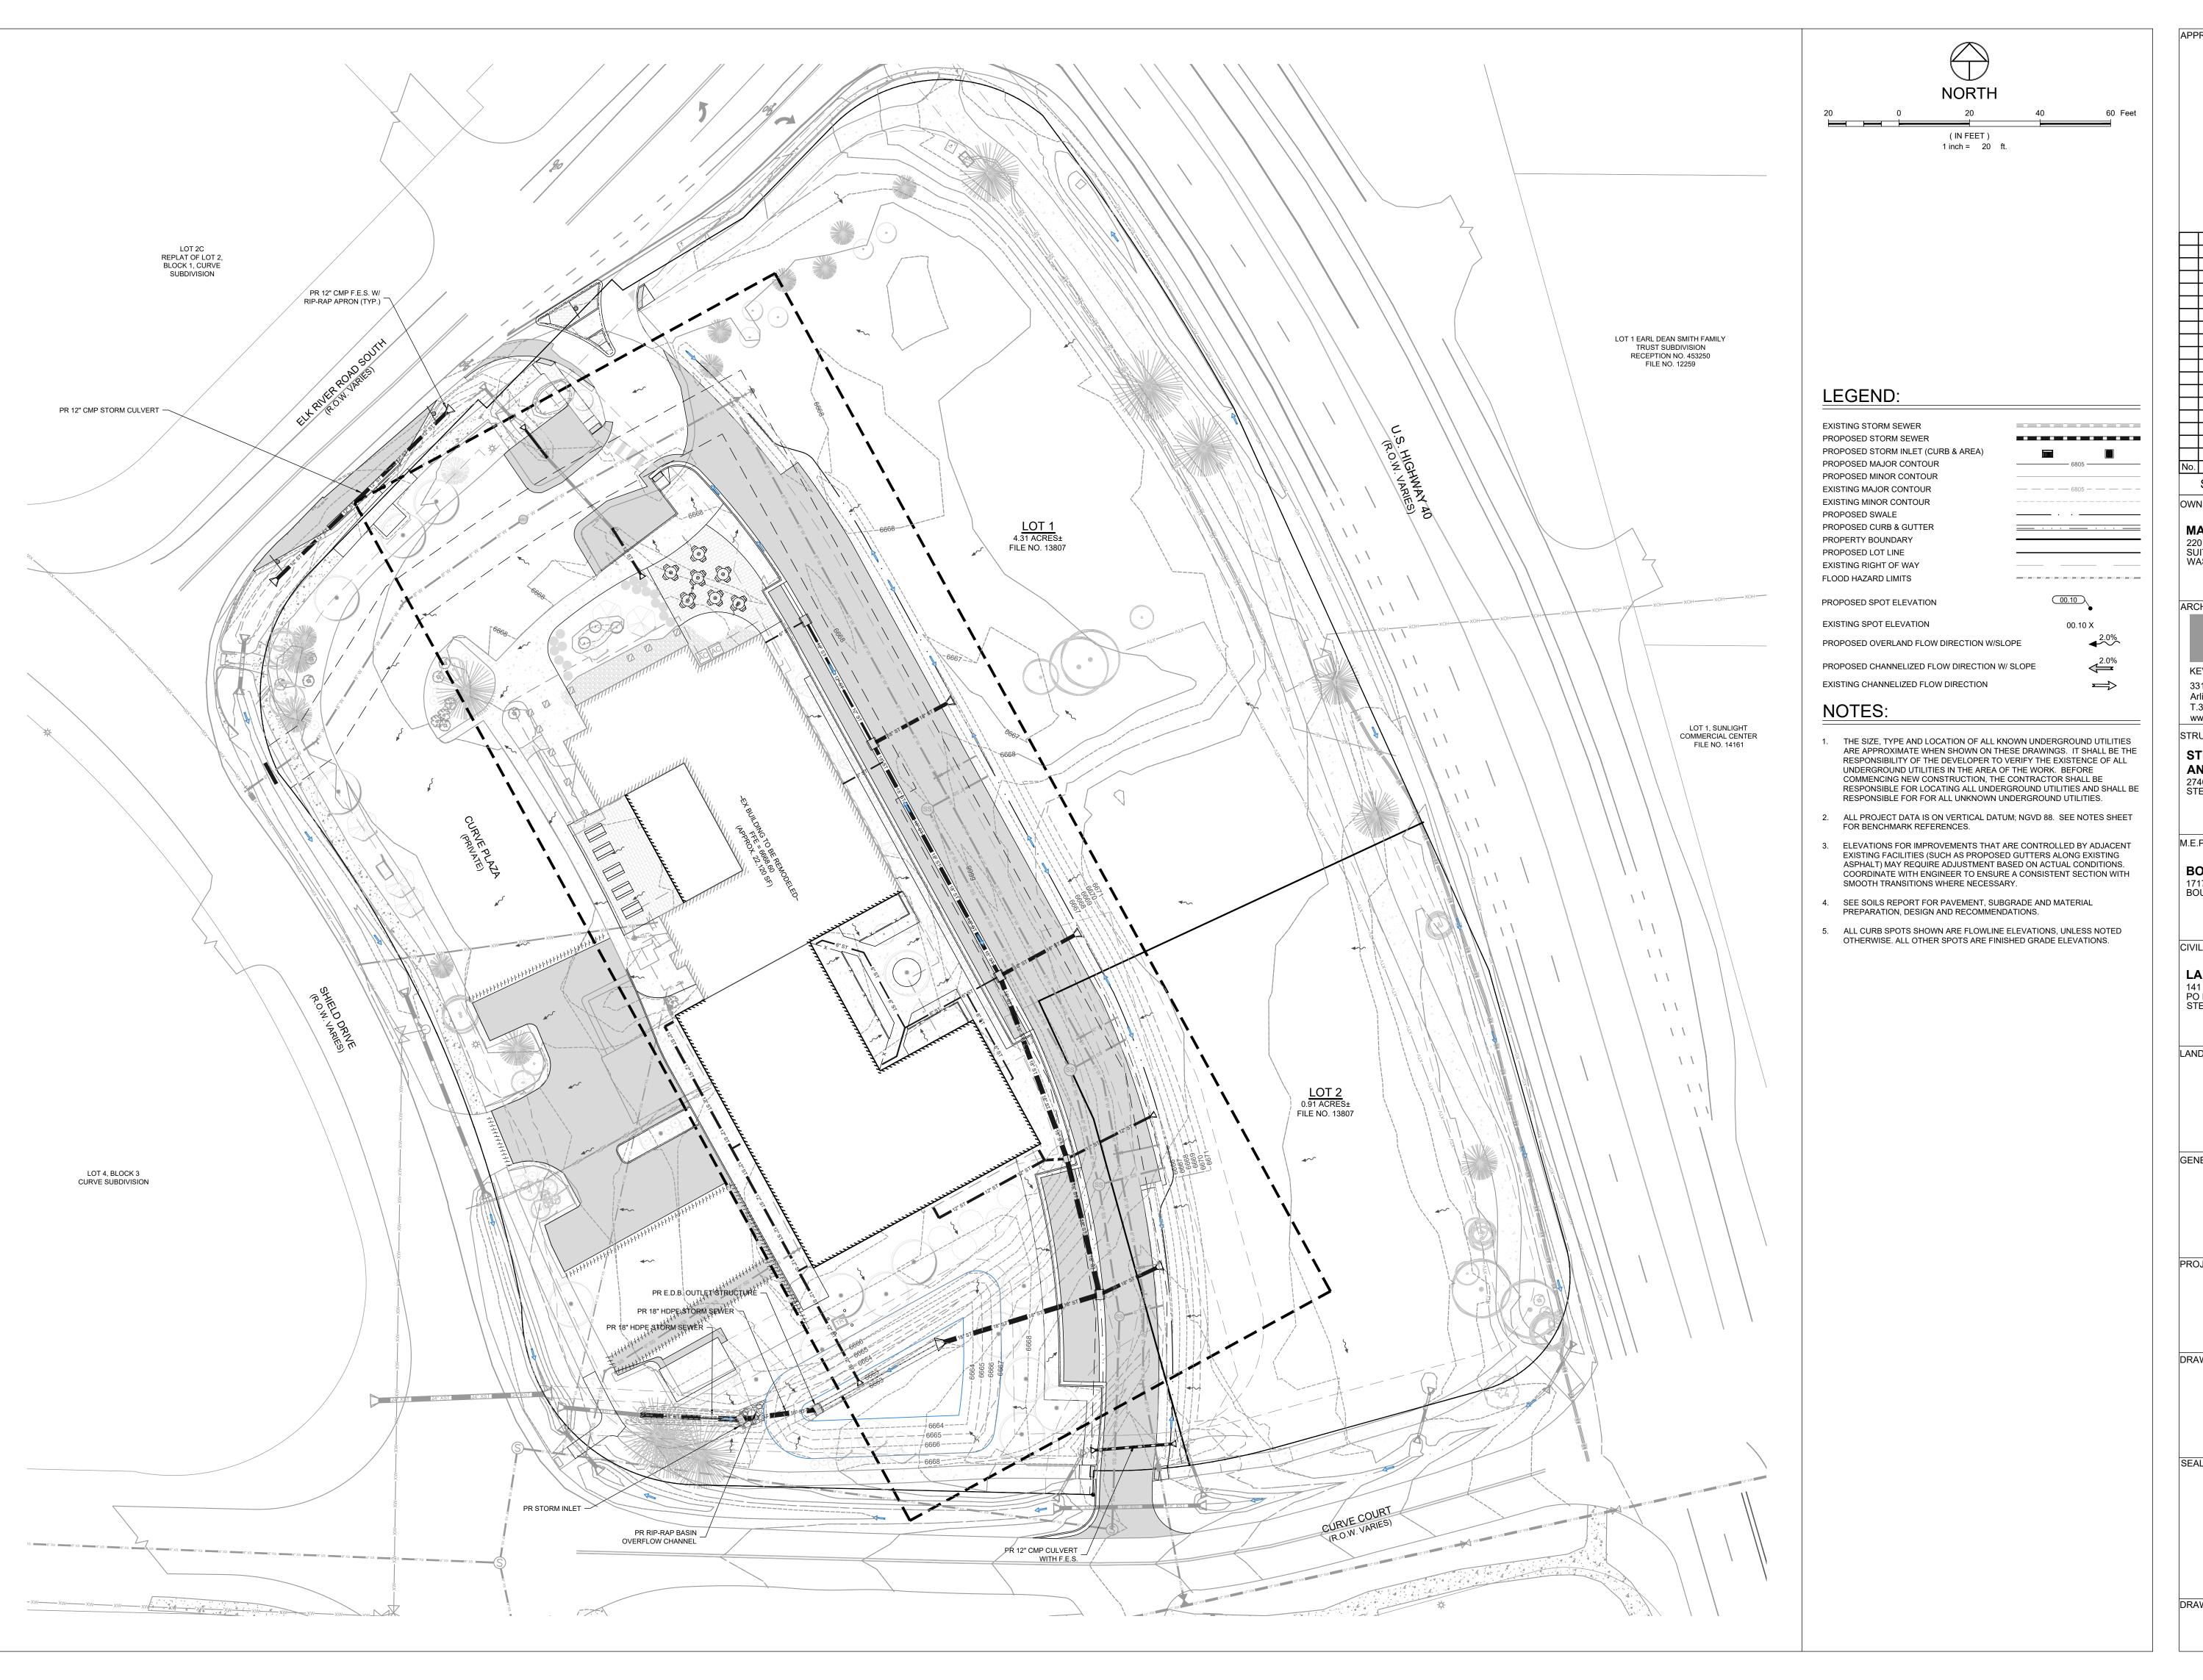

APPROVAL STAMPS: No. Date SUBMISSIONS & REVISIONS OWNER MAY REIGLER PROPERTIES 2201 WISCONSIN AVE NW SUITE 200 WASHINGTON DC 20007 ARCHITECT KEVIN & ASAKO SPERRY ARCHITECTURE 3318 N. Columbus Street Arlington, VA 22207 T.312.636.3248 / 312.636.4252 www.kasa-arch.com STRUCTURAL ENGINEER STEAMBOAT ENGINEERING AND DESIGN, INC 2740 ACRE LANE, STE. E STEAMBOAT SPRINGS, CO 80487 M.E.P. & F.P. ENGINEERS **BOULDER ENGINEERING** 1717 15TH STREET BOULDER, CO 80302

Description

CIVIL ENGINEER

LANDMARK ENGINEERING
141 9TH STREET
PO BOX 774943
STEAMBOAT SPRINGS, CO 80477

LANDSCAPE ARCHITECT

GENERAL CONTRACTOR

PROJECT LOCATION


STEAMBOAT BASECAMP

1901 CURVE PLAZA STEAMBOAT SPRINGS, CO 80487 DRAWING TITLE

> STORM SEWER PLAN - OVERALL

6/18/21 DRAWN BY: CHECKED BY: PROJECT NO: 2387-004

C.310

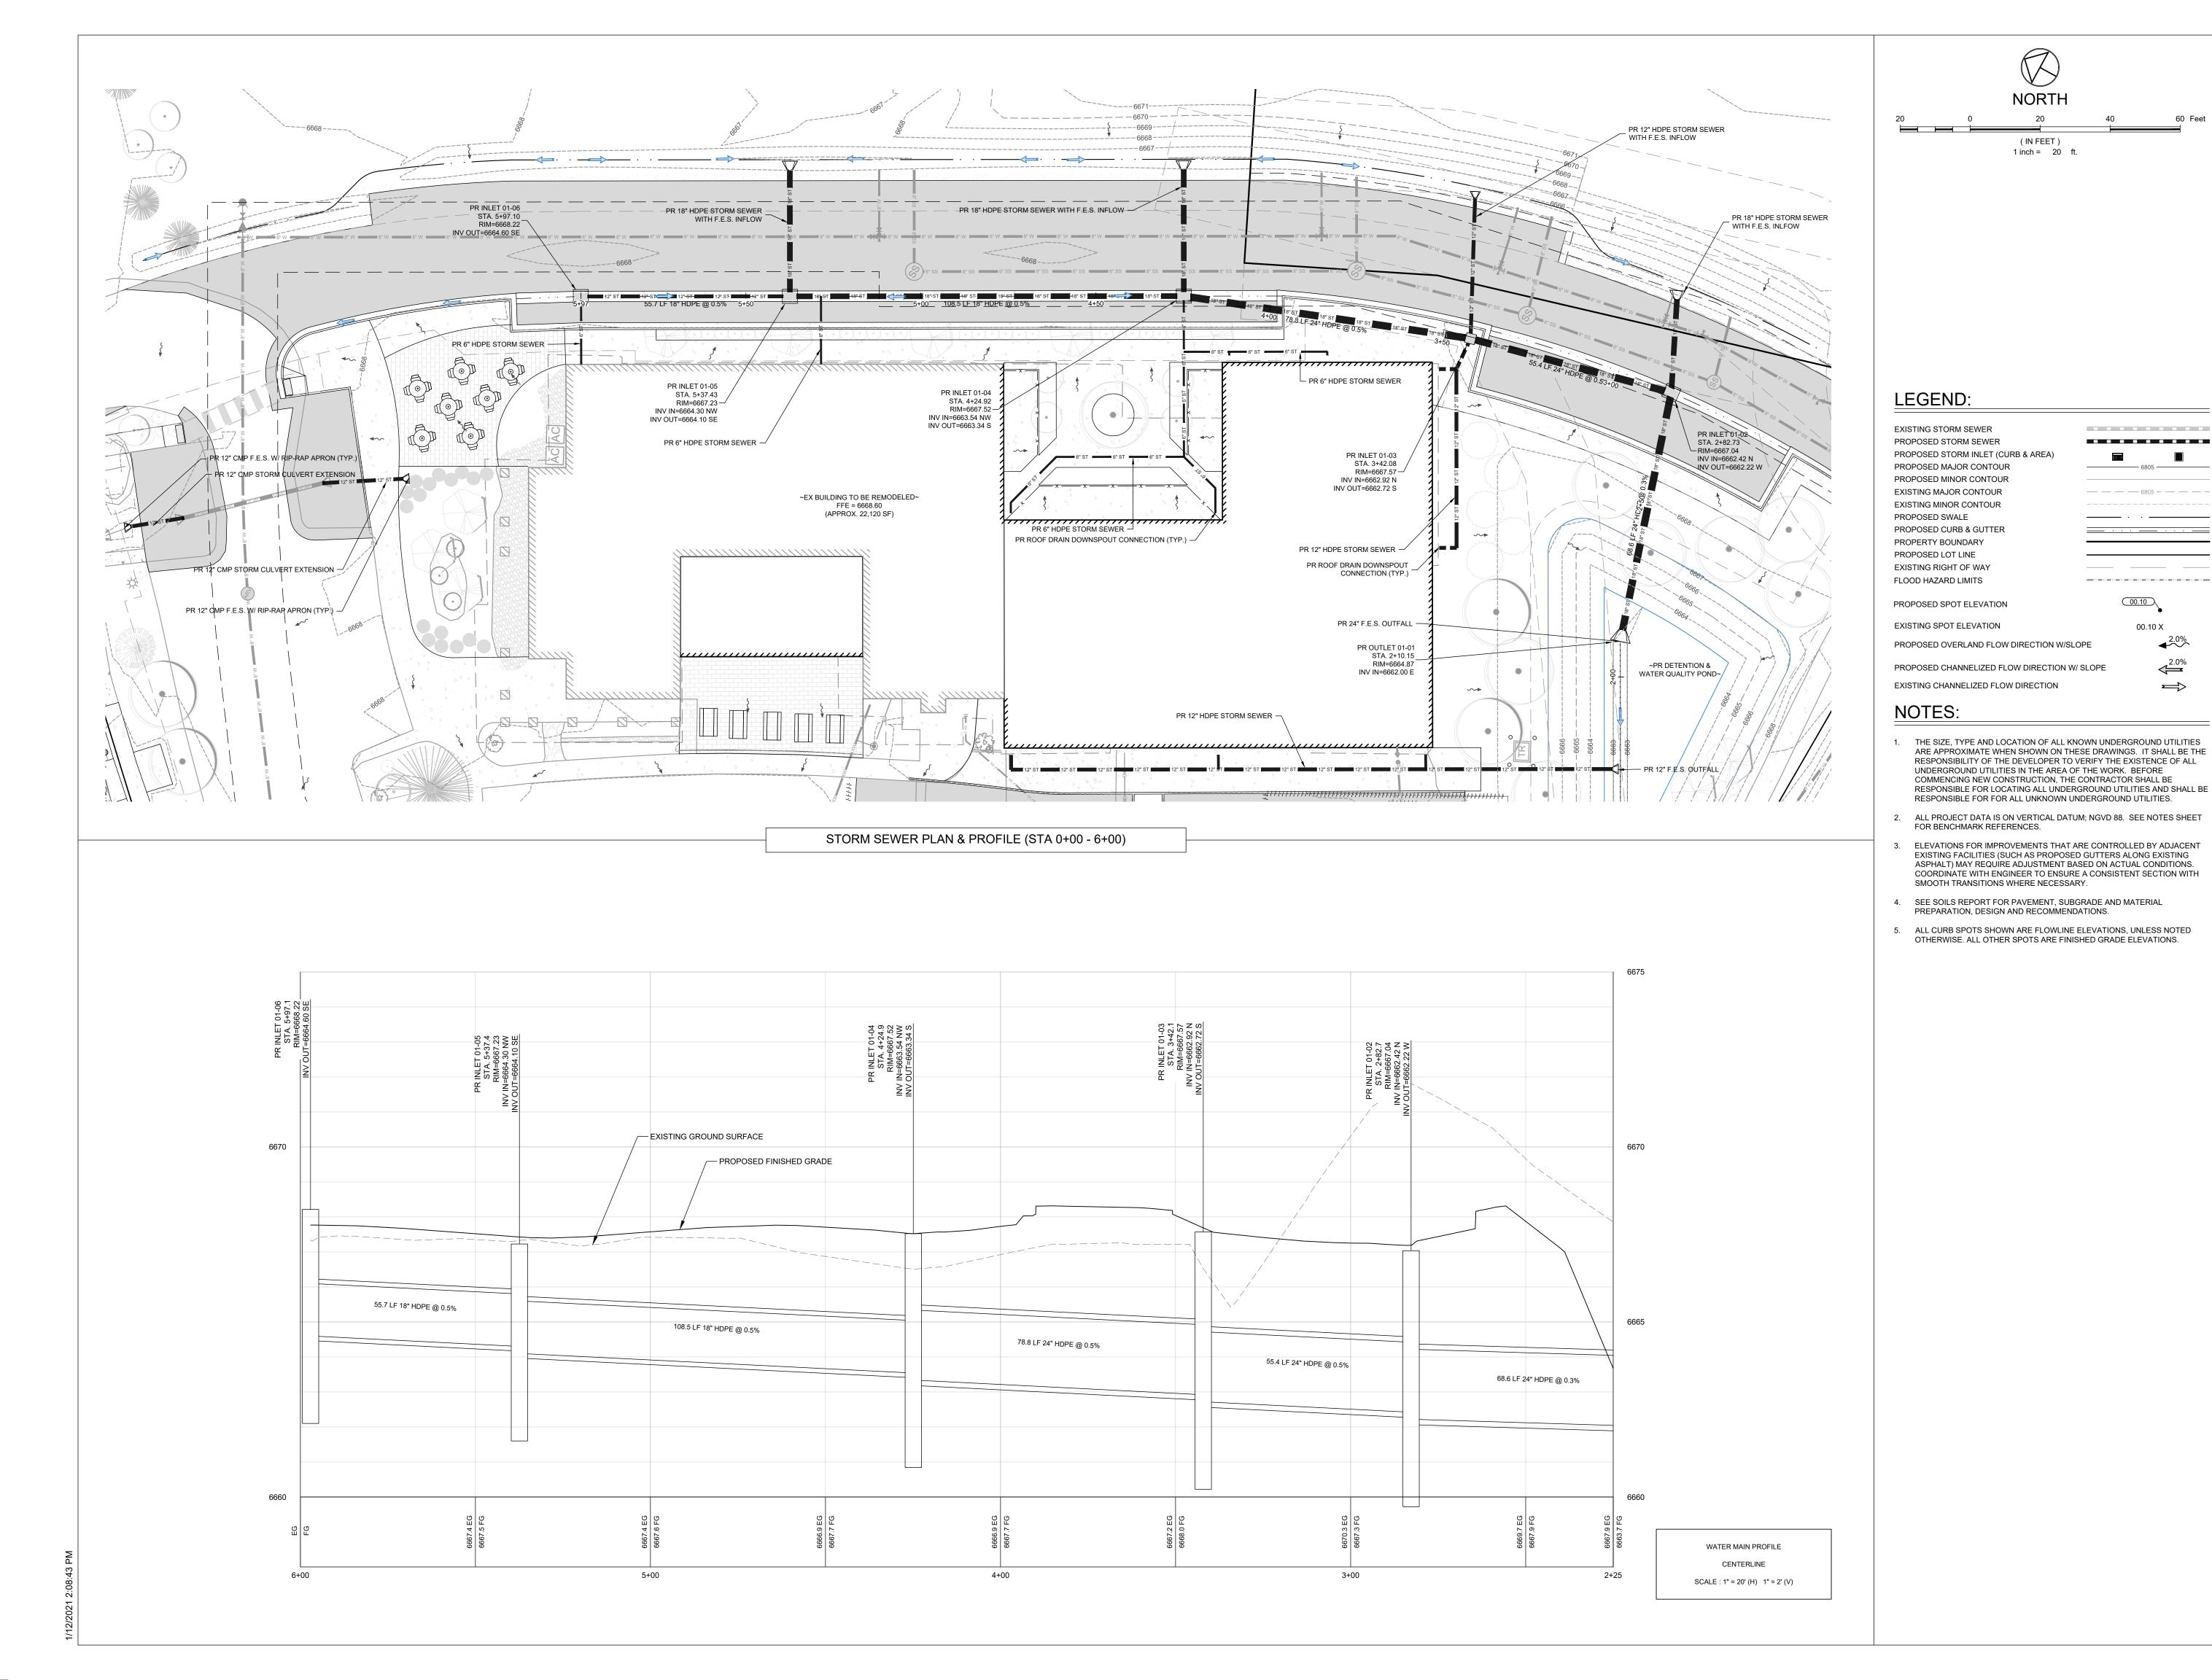

APPROVAL STAMPS: No. Date SUBMISSIONS & REVISIONS OWNER MAY REIGLER PROPERTIES 2201 WISCONSIN AVE NW SUITE 200 WASHINGTON DC 20007 ARCHITECT KEVIN & ASAKO SPERRY ARCHITECTURE 3318 N. Columbus Street Arlington, VA 22207 T.312.636.3248 / 312.636.4252 www.kasa-arch.com STRUCTURAL ENGINEER STEAMBOAT ENGINEERING **AND DESIGN, INC** 2740 ACRE LANE, STE. E STEAMBOAT SPRINGS, CO 80487

Description

M.E.P. & F.P. ENGINEERS

BOULDER ENGINEERING

CIVIL ENGINEER

1717 15TH STREET BOULDER, CO 80302

LANDMARK ENGINEERING
141 9TH STREET PO BOX 774943 STEAMBOAT SPRINGS, CO 80477

LANDSCAPE ARCHITECT

GENERAL CONTRACTOR

PROJECT LOCATION STEAMBOAT


BASECAMP

1901 CURVE PLAZA STEAMBOAT SPRINGS, CO 80487 DRAWING TITLE

> STORM SEWER PLAN & PROFILE

6/18/21 DRAWN BY: CHECKED BY: PROJECT NO: 2387-004

DRAWING NO: C.311

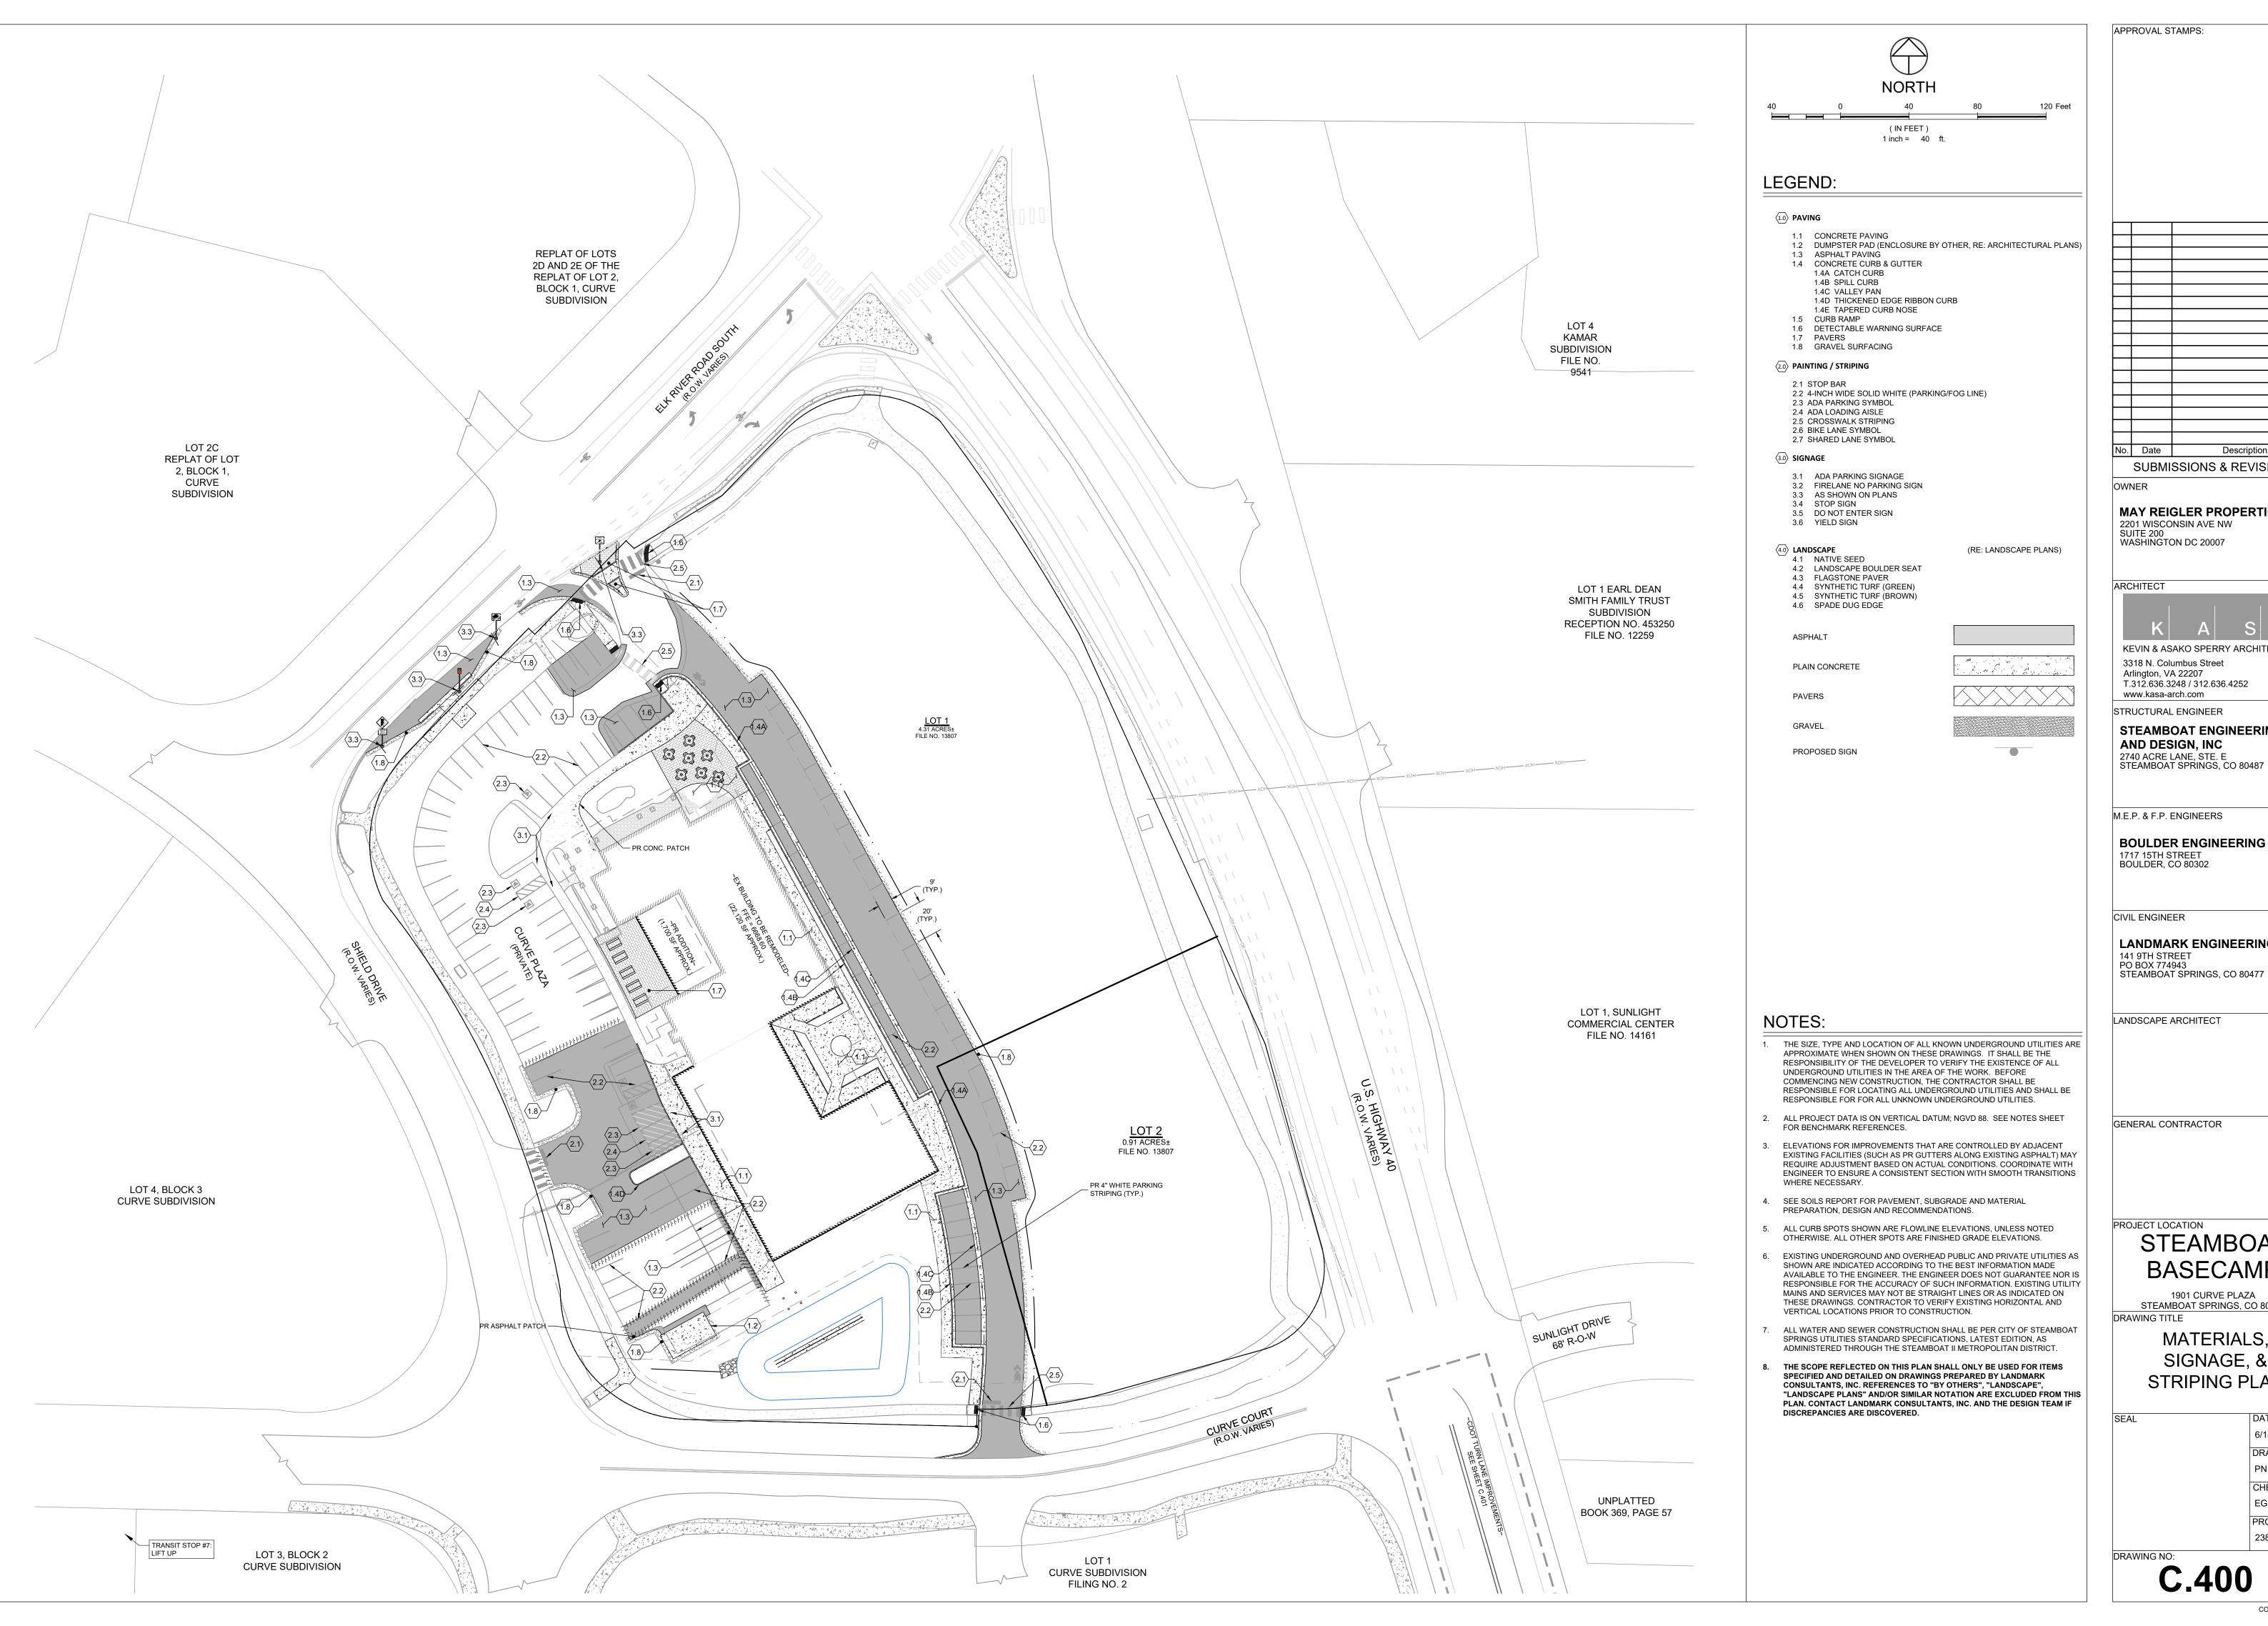

No. Date Description SUBMISSIONS & REVISIONS

MAY REIGLER PROPERTIES

2201 WISCONSIN AVE NW SUITE 200 WASHINGTON DC 20007

KEVIN & ASAKO SPERRY ARCHITECTURE 3318 N. Columbus Street Arlington, VA 22207 T.312.636.3248 / 312.636.4252 www.kasa-arch.com

STRUCTURAL ENGINEER

STEAMBOAT ENGINEERING AND DESIGN, INC 2740 ACRE LANE, STE. E STEAMBOAT SPRINGS, CO 80487

1717 15TH STREET BOULDER, CO 80302

CIVIL ENGINEER

LANDMARK ENGINEERING 141 9TH STREET PO BOX 774943 STEAMBOAT SPRINGS, CO 80477

LANDSCAPE ARCHITECT

GENERAL CONTRACTOR

STEAMBOAT BASECAMP


1901 CURVE PLAZA STEAMBOAT SPRINGS, CO 80487 DRAWING TITLE


MATERIALS,

SIGNAGE, & STRIPING PLAN

6/18/21 DRAWN BY: CHECKED BY: PROJECT NO:

C.400

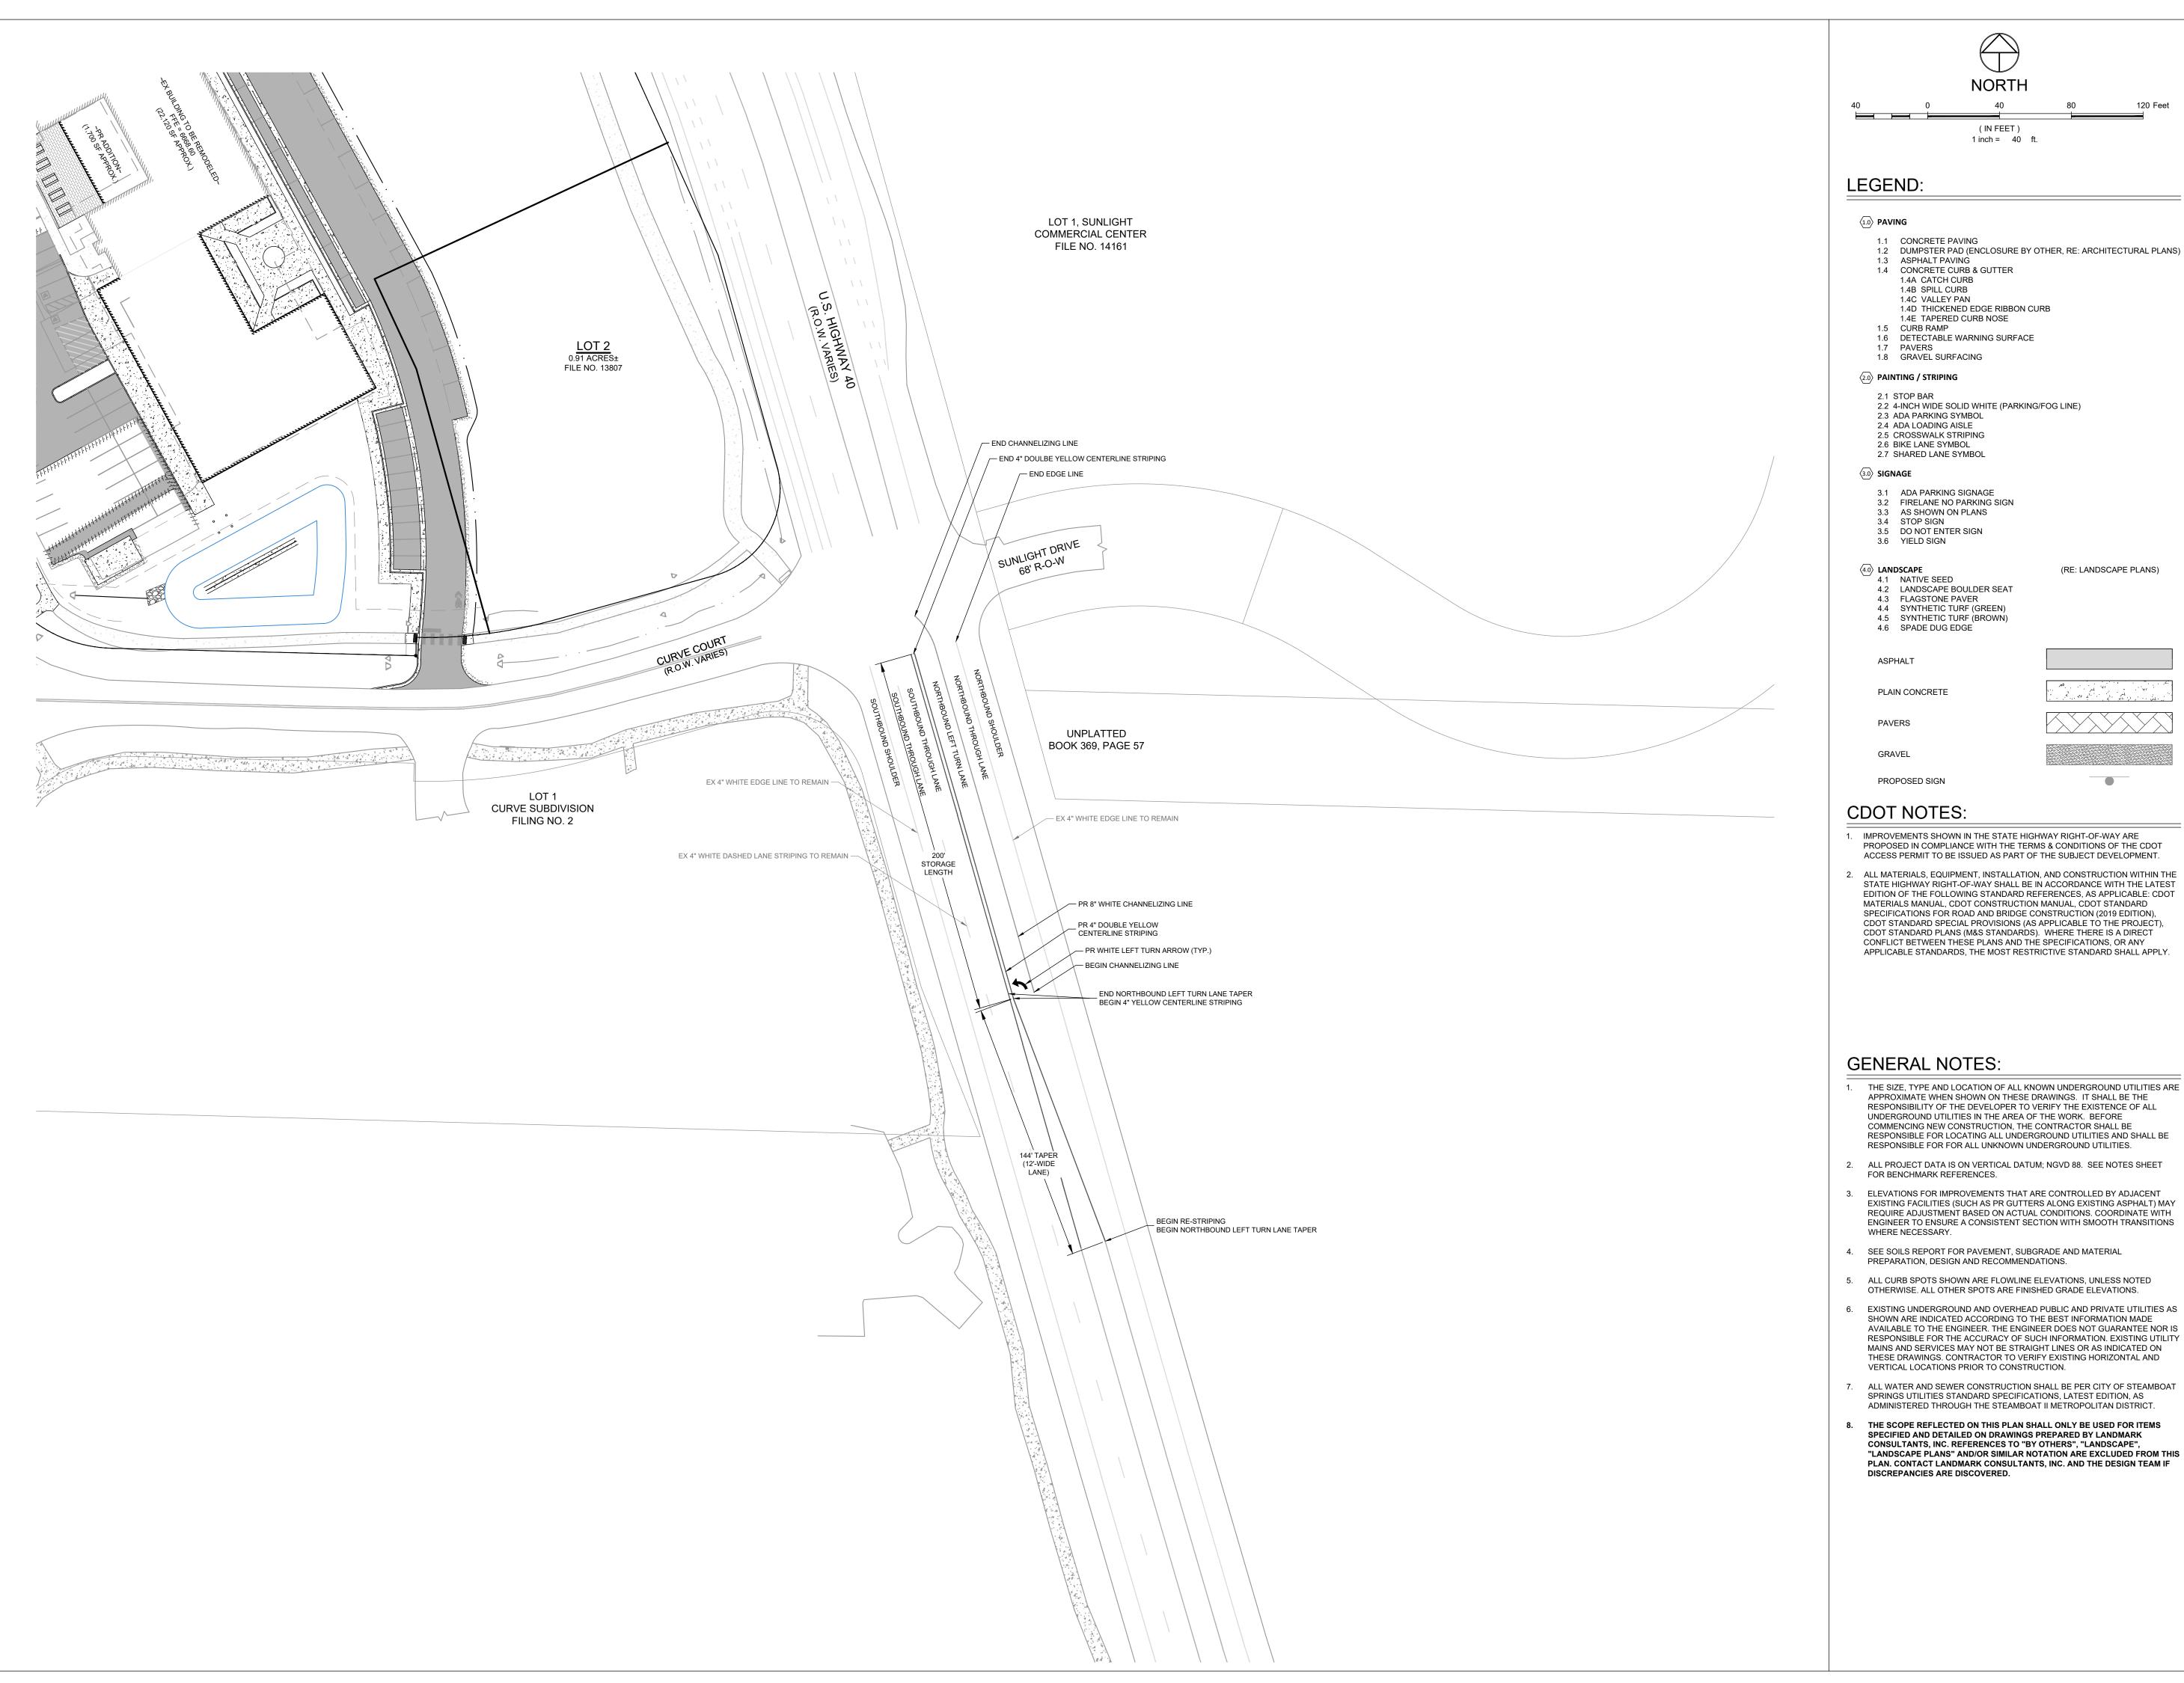

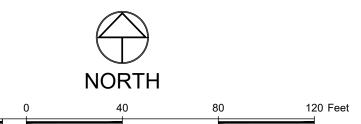

- 1.1 CONCRETE PAVING
- 1.3 ASPHALT PAVING

(IN FEET) 1 inch = 40 ft.

- 1.4 CONCRETE CURB & GUTTER 1.4A CATCH CURB
- 1.4C VALLEY PAN 1.4D THICKENED EDGE RIBBON CURB
- 1.6 DETECTABLE WARNING SURFACE

- 2.2 4-INCH WIDE SOLID WHITE (PARKING/FOG LINE)
- 2.5 CROSSWALK STRIPING
- 3.1 ADA PARKING SIGNAGE
- 3.3 AS SHOWN ON PLANS

- 4.2 LANDSCAPE BOULDER SEAT
- 4.4 SYNTHETIC TURF (GREEN)

- 1. IMPROVEMENTS SHOWN IN THE STATE HIGHWAY RIGHT-OF-WAY ARE PROPOSED IN COMPLIANCE WITH THE TERMS & CONDITIONS OF THE CDOT ACCESS PERMIT TO BE ISSUED AS PART OF THE SUBJECT DEVELOPMENT.
- 2. ALL MATERIALS, EQUIPMENT, INSTALLATION, AND CONSTRUCTION WITHIN THE STATE HIGHWAY RIGHT-OF-WAY SHALL BE IN ACCORDANCE WITH THE LATEST EDITION OF THE FOLLOWING STANDARD REFERENCES, AS APPLICABLE: CDOT MATERIALS MANUAL, CDOT CONSTRUCTION MANUAL, CDOT STANDARD SPECIFICATIONS FOR ROAD AND BRIDGE CONSTRUCTION (2019 EDITION), CDOT STANDARD SPECIAL PROVISIONS (AS APPLICABLE TO THE PROJECT), CDOT STANDARD PLANS (M&S STANDARDS). WHERE THERE IS A DIRECT CONFLICT BETWEEN THESE PLANS AND THE SPECIFICATIONS, OR ANY

GENERAL NOTES:

- 1. THE SIZE, TYPE AND LOCATION OF ALL KNOWN UNDERGROUND UTILITIES ARE APPROXIMATE WHEN SHOWN ON THESE DRAWINGS. IT SHALL BE THE RESPONSIBILITY OF THE DEVELOPER TO VERIFY THE EXISTENCE OF ALL UNDERGROUND UTILITIES IN THE AREA OF THE WORK. BEFORE COMMENCING NEW CONSTRUCTION, THE CONTRACTOR SHALL BE RESPONSIBLE FOR LOCATING ALL UNDERGROUND UTILITIES AND SHALL BE
- 2. ALL PROJECT DATA IS ON VERTICAL DATUM; NGVD 88. SEE NOTES SHEET FOR BENCHMARK REFERENCES.
- 3. ELEVATIONS FOR IMPROVEMENTS THAT ARE CONTROLLED BY ADJACENT EXISTING FACILITIES (SUCH AS PR GUTTERS ALONG EXISTING ASPHALT) MAY REQUIRE ADJUSTMENT BASED ON ACTUAL CONDITIONS. COORDINATE WITH ENGINEER TO ENSURE A CONSISTENT SECTION WITH SMOOTH TRANSITIONS
- 4. SEE SOILS REPORT FOR PAVEMENT, SUBGRADE AND MATERIAL PREPARATION, DESIGN AND RECOMMENDATIONS.
- OTHERWISE. ALL OTHER SPOTS ARE FINISHED GRADE ELEVATIONS.
- 6. EXISTING UNDERGROUND AND OVERHEAD PUBLIC AND PRIVATE UTILITIES AS SHOWN ARE INDICATED ACCORDING TO THE BEST INFORMATION MADE AVAILABLE TO THE ENGINEER. THE ENGINEER DOES NOT GUARANTEE NOR IS RESPONSIBLE FOR THE ACCURACY OF SUCH INFORMATION. EXISTING UTILITY MAINS AND SERVICES MAY NOT BE STRAIGHT LINES OR AS INDICATED ON THESE DRAWINGS. CONTRACTOR TO VERIFY EXISTING HORIZONTAL AND VERTICAL LOCATIONS PRIOR TO CONSTRUCTION.
- 7. ALL WATER AND SEWER CONSTRUCTION SHALL BE PER CITY OF STEAMBOAT SPRINGS UTILITIES STANDARD SPECIFICATIONS, LATEST EDITION, AS ADMINISTERED THROUGH THE STEAMBOAT II METROPOLITAN DISTRICT.
- 8. THE SCOPE REFLECTED ON THIS PLAN SHALL ONLY BE USED FOR ITEMS SPECIFIED AND DETAILED ON DRAWINGS PREPARED BY LANDMARK CONSULTANTS, INC. REFERENCES TO "BY OTHERS", "LANDSCAPE", "LANDSCAPE PLANS" AND/OR SIMILAR NOTATION ARE EXCLUDED FROM THIS PLAN. CONTACT LANDMARK CONSULTANTS, INC. AND THE DESIGN TEAM IF DISCREPANCIES ARE DISCOVERED.

APPROVAL STAMPS:

No. Date Description SUBMISSIONS & REVISIONS

MAY REIGLER PROPERTIES

2201 WISCONSIN AVE NW SUITE 200 WASHINGTON DC 20007

ARCHITECT

OWNER

(RE: LANDSCAPE PLANS)



KEVIN & ASAKO SPERRY ARCHITECTURE 3318 N. Columbus Street Arlington, VA 22207 T.312.636.3248 / 312.636.4252

www.kasa-arch.com STRUCTURAL ENGINEER

STEAMBOAT ENGINEERING AND DESIGN, INC 2740 ACRE LANE, STE. E STEAMBOAT SPRINGS, CO 80487

M.E.P. & F.P. ENGINEERS

BOULDER ENGINEERING 1717 15TH STREET BOULDER, CO 80302

CIVIL ENGINEER

PO BOX 774943

LANDMARK ENGINEERING 141 9TH STREET

STEAMBOAT SPRINGS, CO 80477

LANDSCAPE ARCHITECT

GENERAL CONTRACTOR

PROJECT LOCATION

STEAMBOAT BASECAMP

1901 CURVE PLAZA STEAMBOAT SPRINGS, CO 80487

DRAWING TITLE OFFSITE MATERIALS, SIGNAGE, &


STRIPING PLAN


6/18/21 DRAWN BY: CHECKED BY:

2387-004

COPYRIGHT 2019

PROJECT NO:

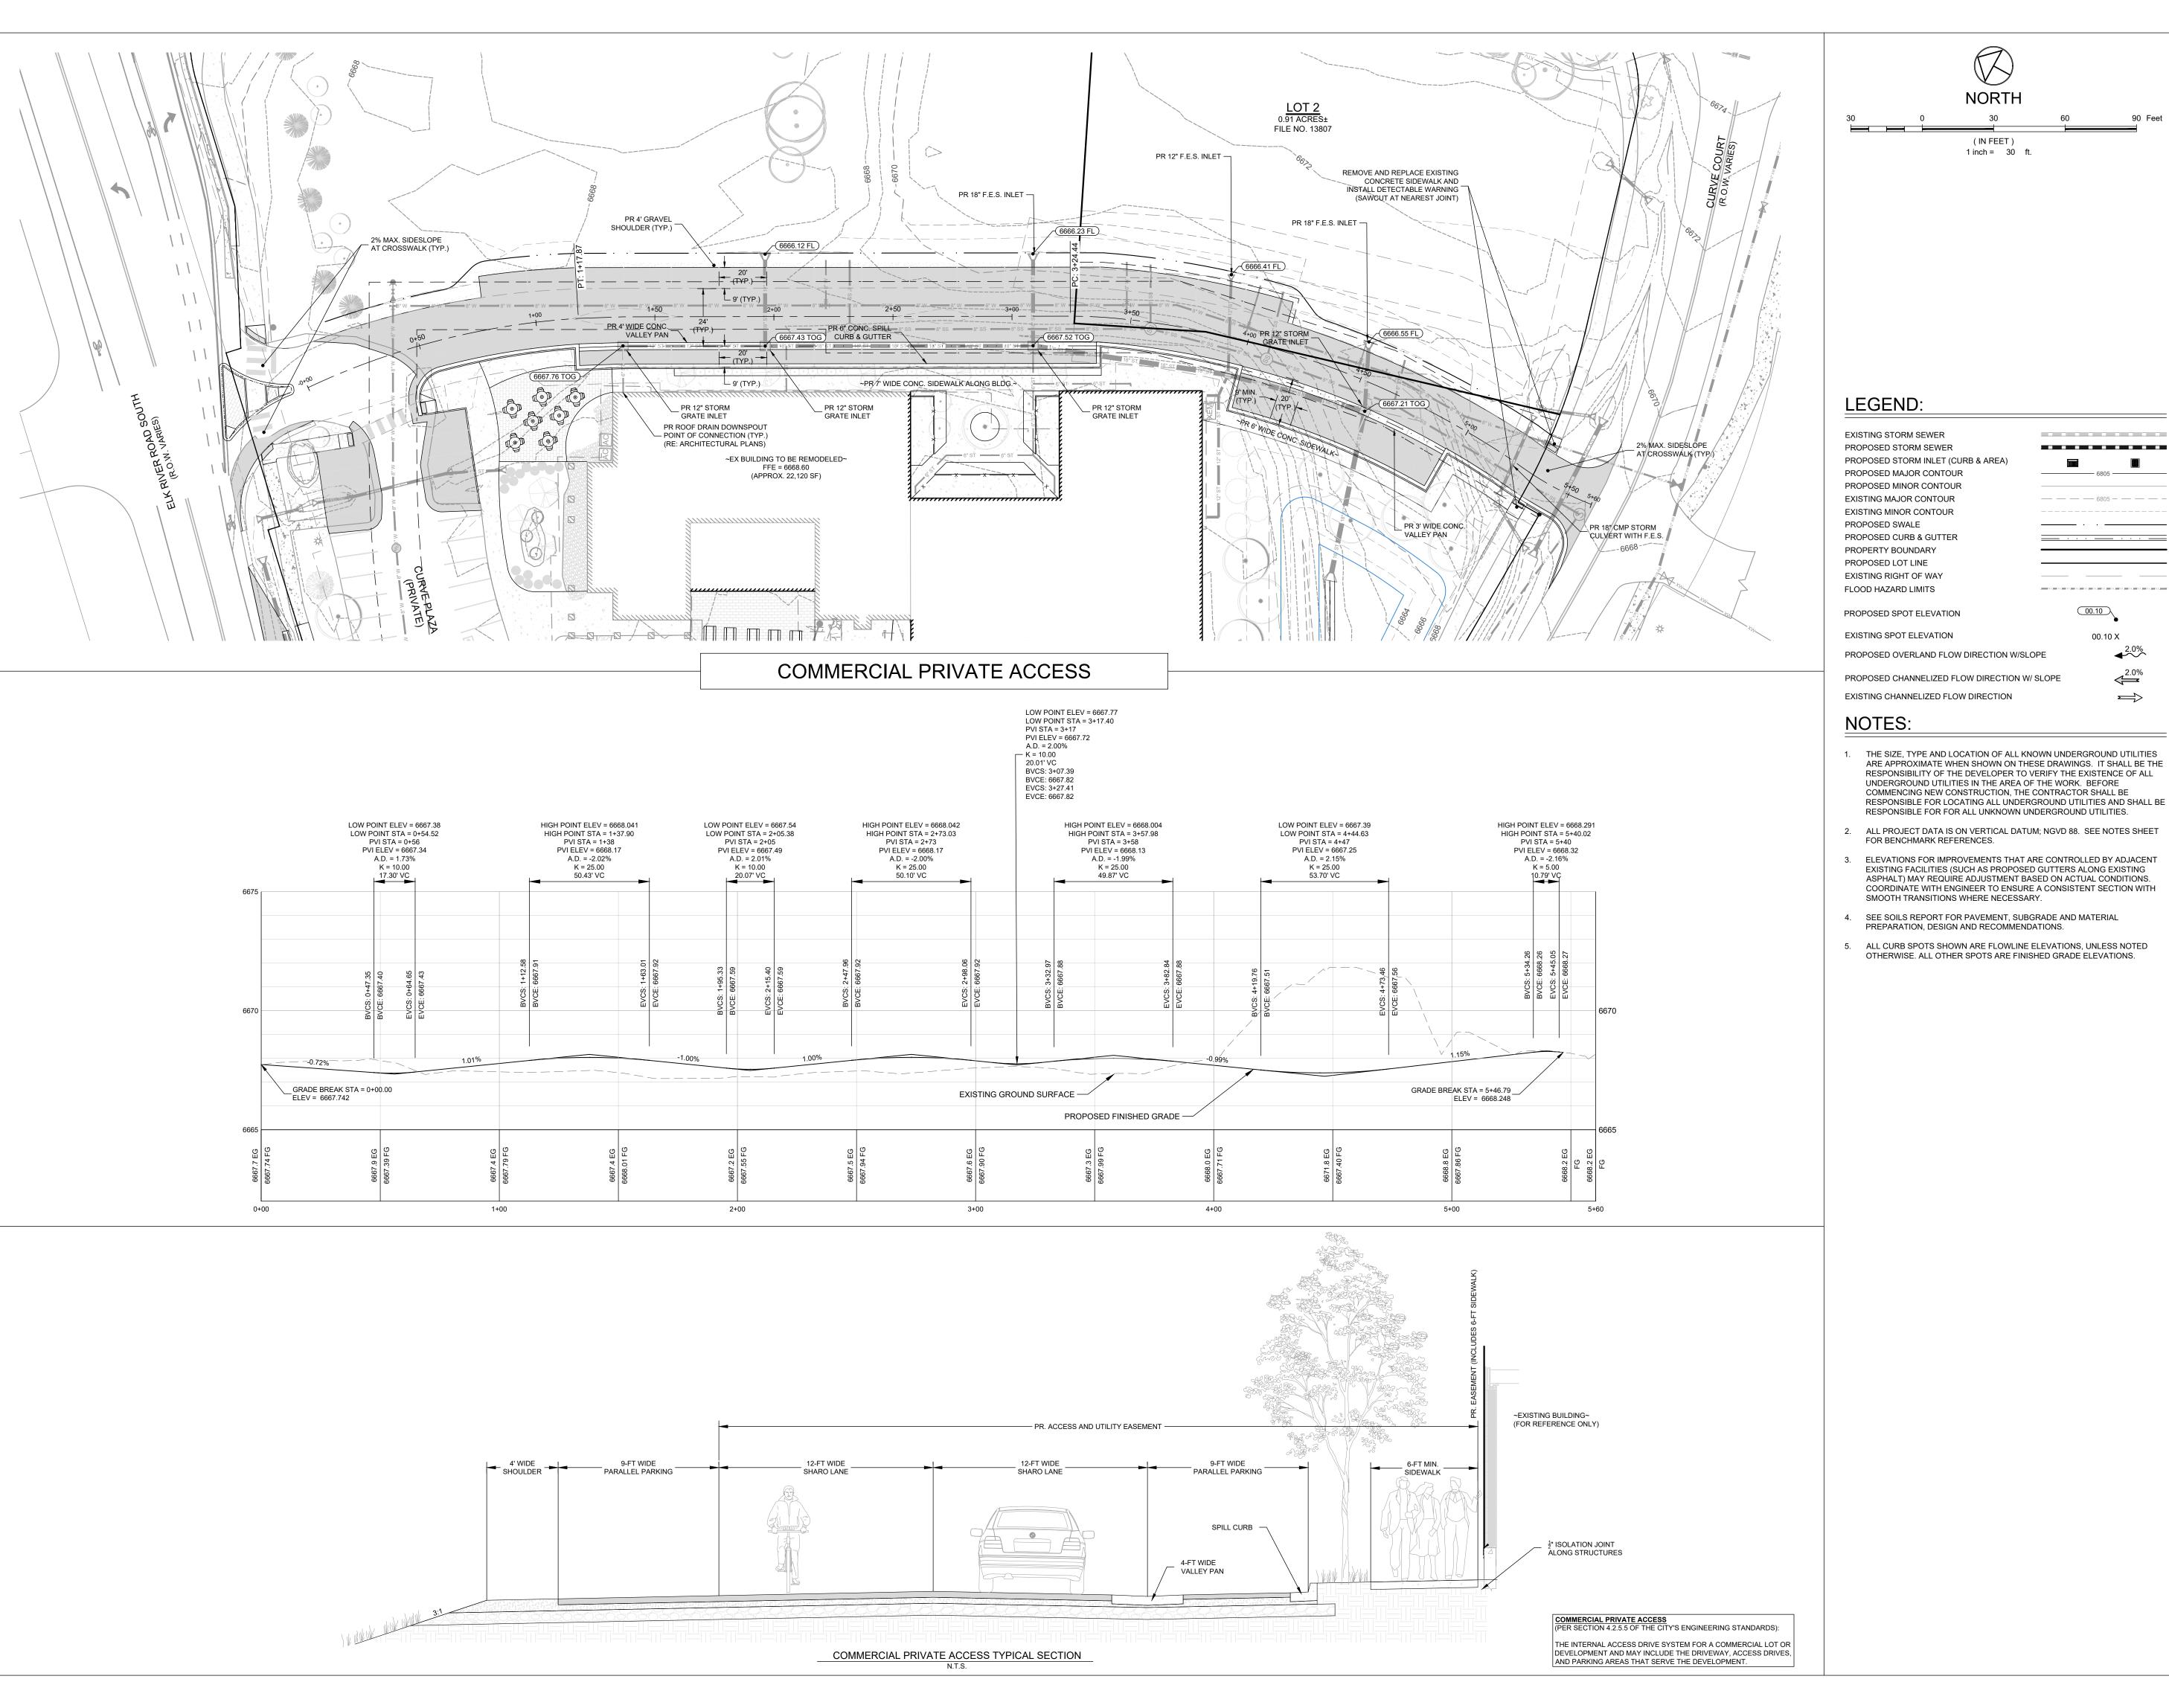

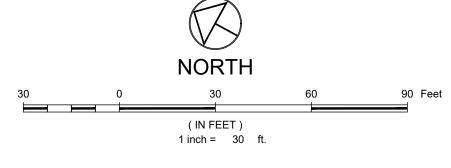

- ARE APPROXIMATE WHEN SHOWN ON THESE DRAWINGS. IT SHALL BE THE RESPONSIBILITY OF THE DEVELOPER TO VERIFY THE EXISTENCE OF ALL UNDERGROUND UTILITIES IN THE AREA OF THE WORK. BEFORE COMMENCING NEW CONSTRUCTION. THE CONTRACTOR SHALL BE RESPONSIBLE FOR LOCATING ALL UNDERGROUND UTILITIES AND SHALL BE RESPONSIBLE FOR FOR ALL UNKNOWN UNDERGROUND UTILITIES.
- 2. ALL PROJECT DATA IS ON VERTICAL DATUM; NGVD 88. SEE NOTES SHEET
- 3. ELEVATIONS FOR IMPROVEMENTS THAT ARE CONTROLLED BY ADJACENT EXISTING FACILITIES (SUCH AS PROPOSED GUTTERS ALONG EXISTING ASPHALT) MAY REQUIRE ADJUSTMENT BASED ON ACTUAL CONDITIONS.
- 5. ALL CURB SPOTS SHOWN ARE FLOWLINE ELEVATIONS, UNLESS NOTED

No. Date Description OWNER

APPROVAL STAMPS:

SUBMISSIONS & REVISIONS

MAY REIGLER PROPERTIES

2201 WISCONSIN AVE NW SUITE 200 WASHINGTON DC 20007

ARCHITECT

<=2.0%



KEVIN & ASAKO SPERRY ARCHITECTURE 3318 N. Columbus Street Arlington, VA 22207 T.312.636.3248 / 312.636.4252 www.kasa-arch.com

STRUCTURAL ENGINEER

STEAMBOAT ENGINEERING AND DESIGN, INC 2740 ACRE LANE, STE. E STEAMBOAT SPRINGS, CO 80487

M.E.P. & F.P. ENGINEERS

BOULDER ENGINEERING 1717 15TH STREET BOULDER, CO 80302

CIVIL ENGINEER

LANDMARK ENGINEERING 141 9TH STREET

PO BOX 774943 STEAMBOAT SPRINGS, CO 80477

LANDSCAPE ARCHITECT

GENERAL CONTRACTOR

PROJECT LOCATION

STEAMBOAT BASECAMP


1901 CURVE PLAZA STEAMBOAT SPRINGS, CO 80487 DRAWING TITLE


> **ROADWAY PLAN** & PROFILE

6/18/21 DRAWN BY: CHECKED BY: EG PROJECT NO:

DRAWING NO: C.410

COPYRIGHT 2019

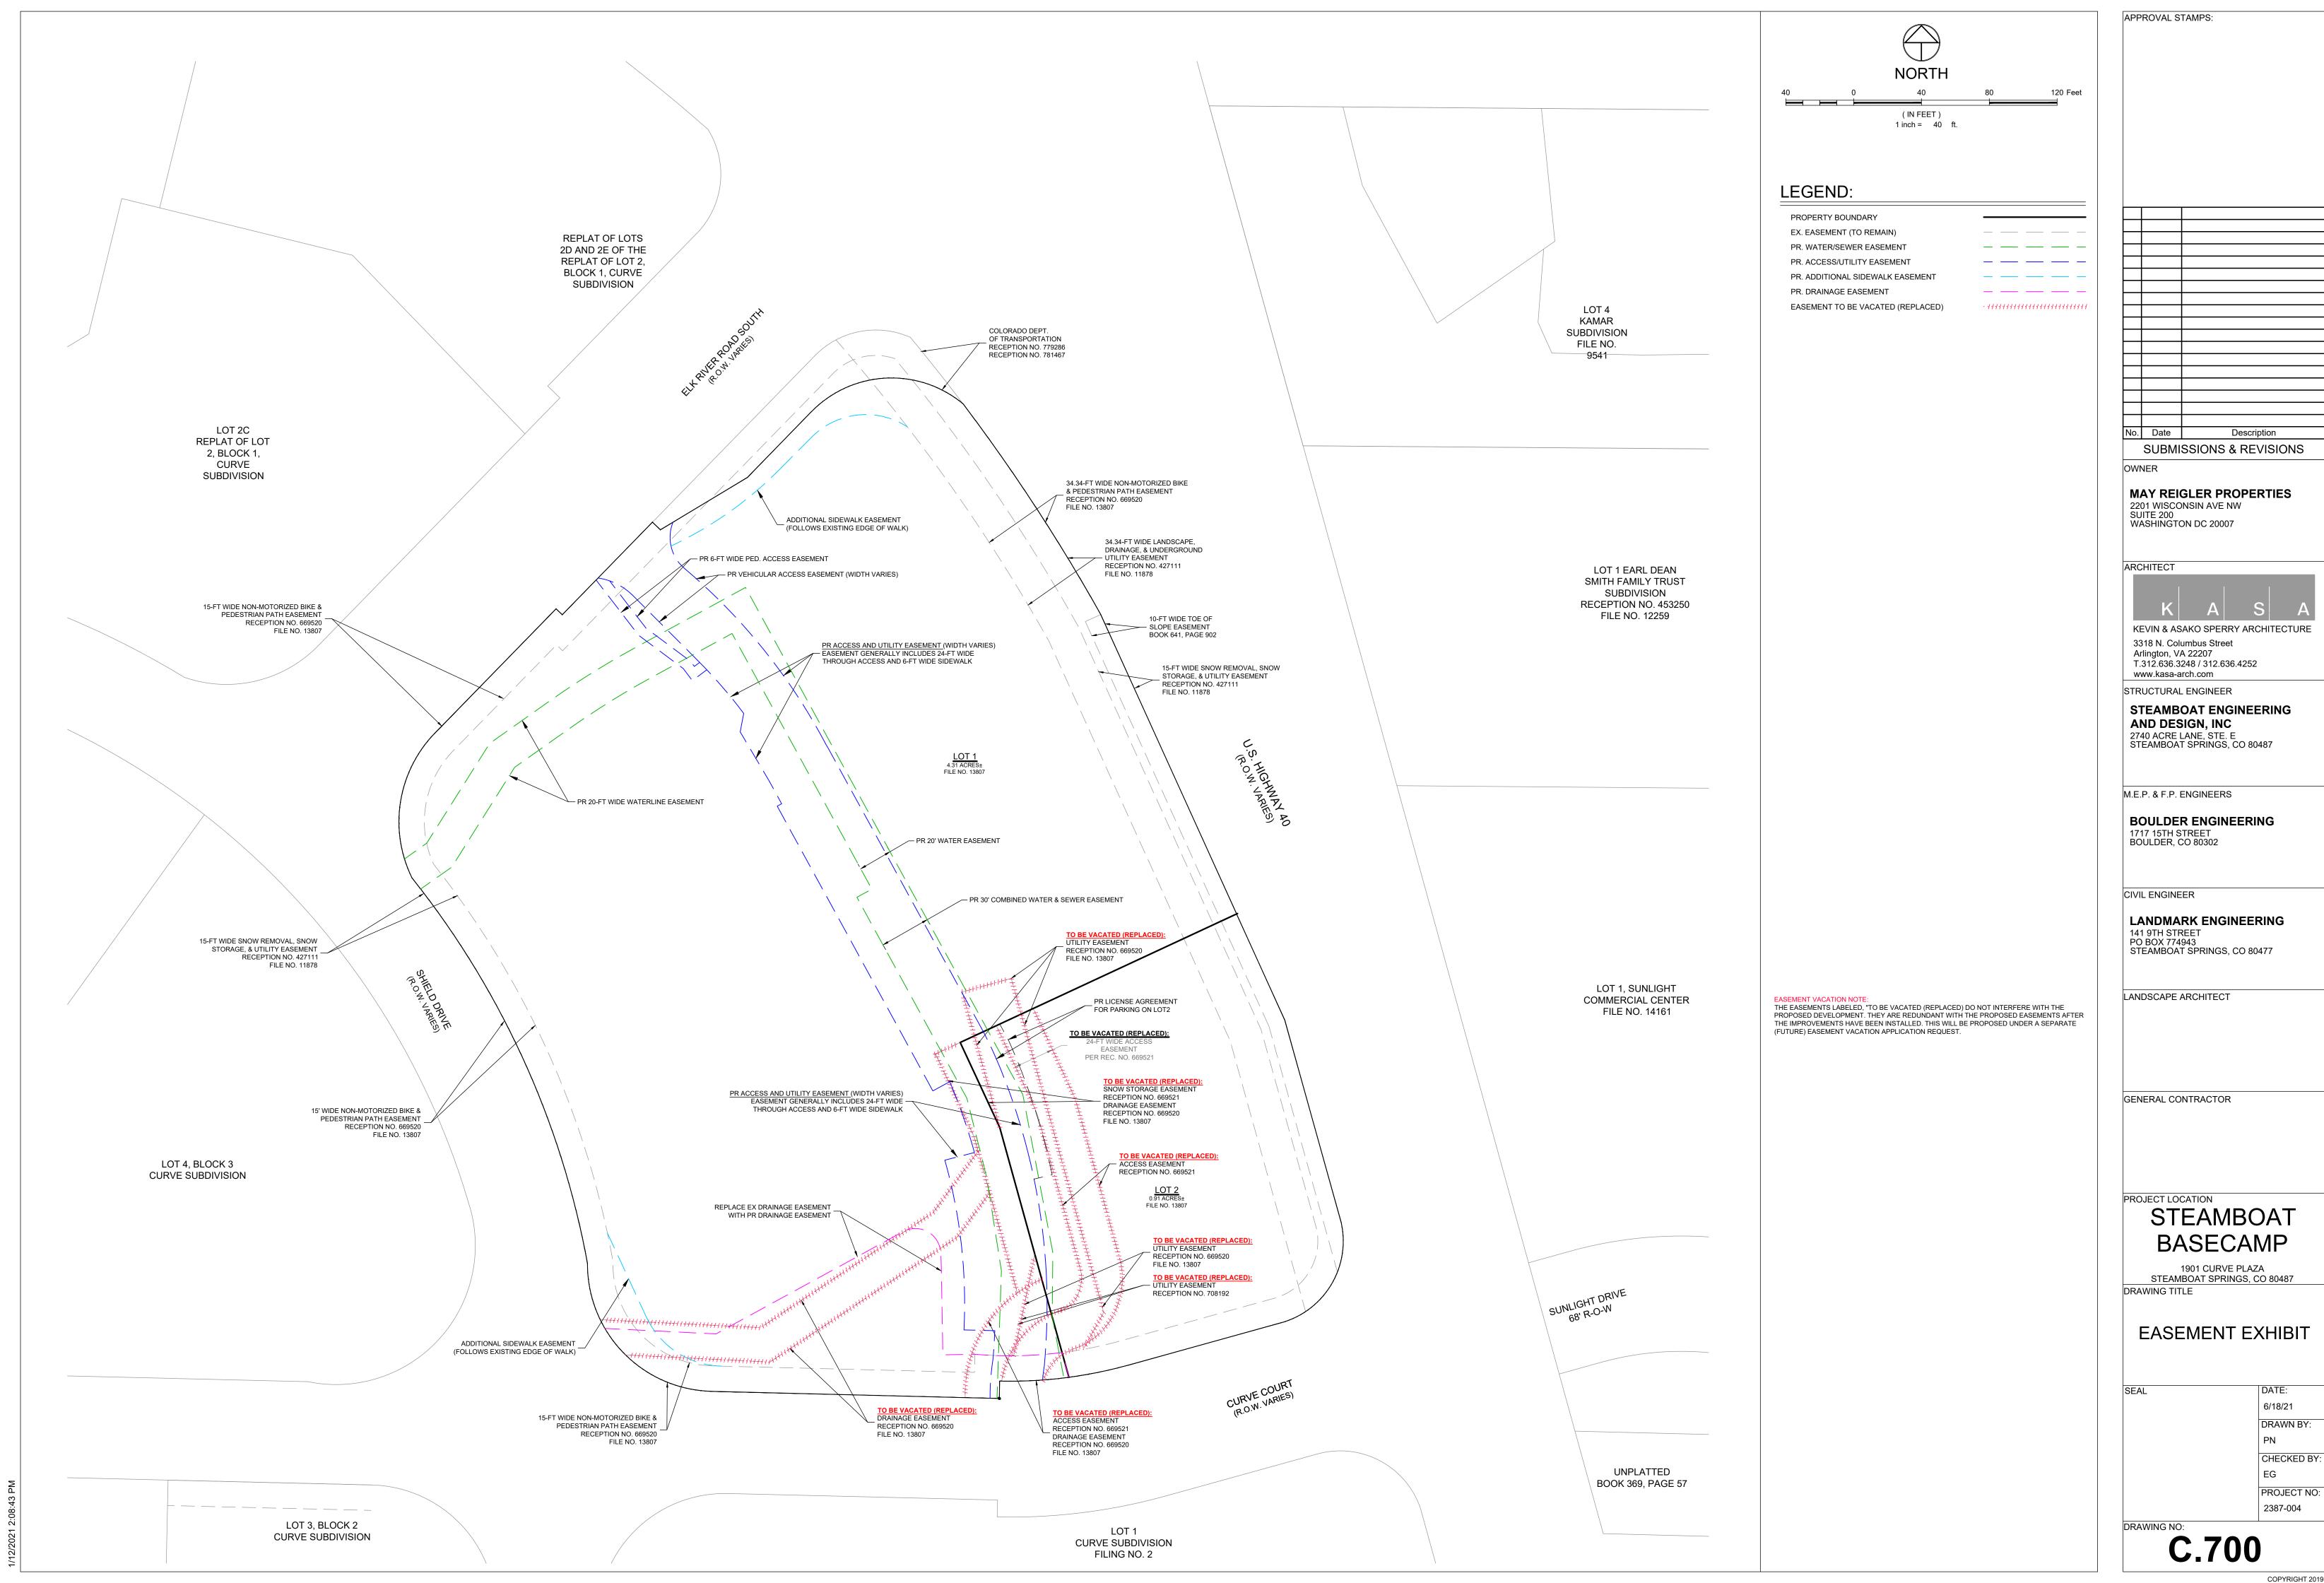

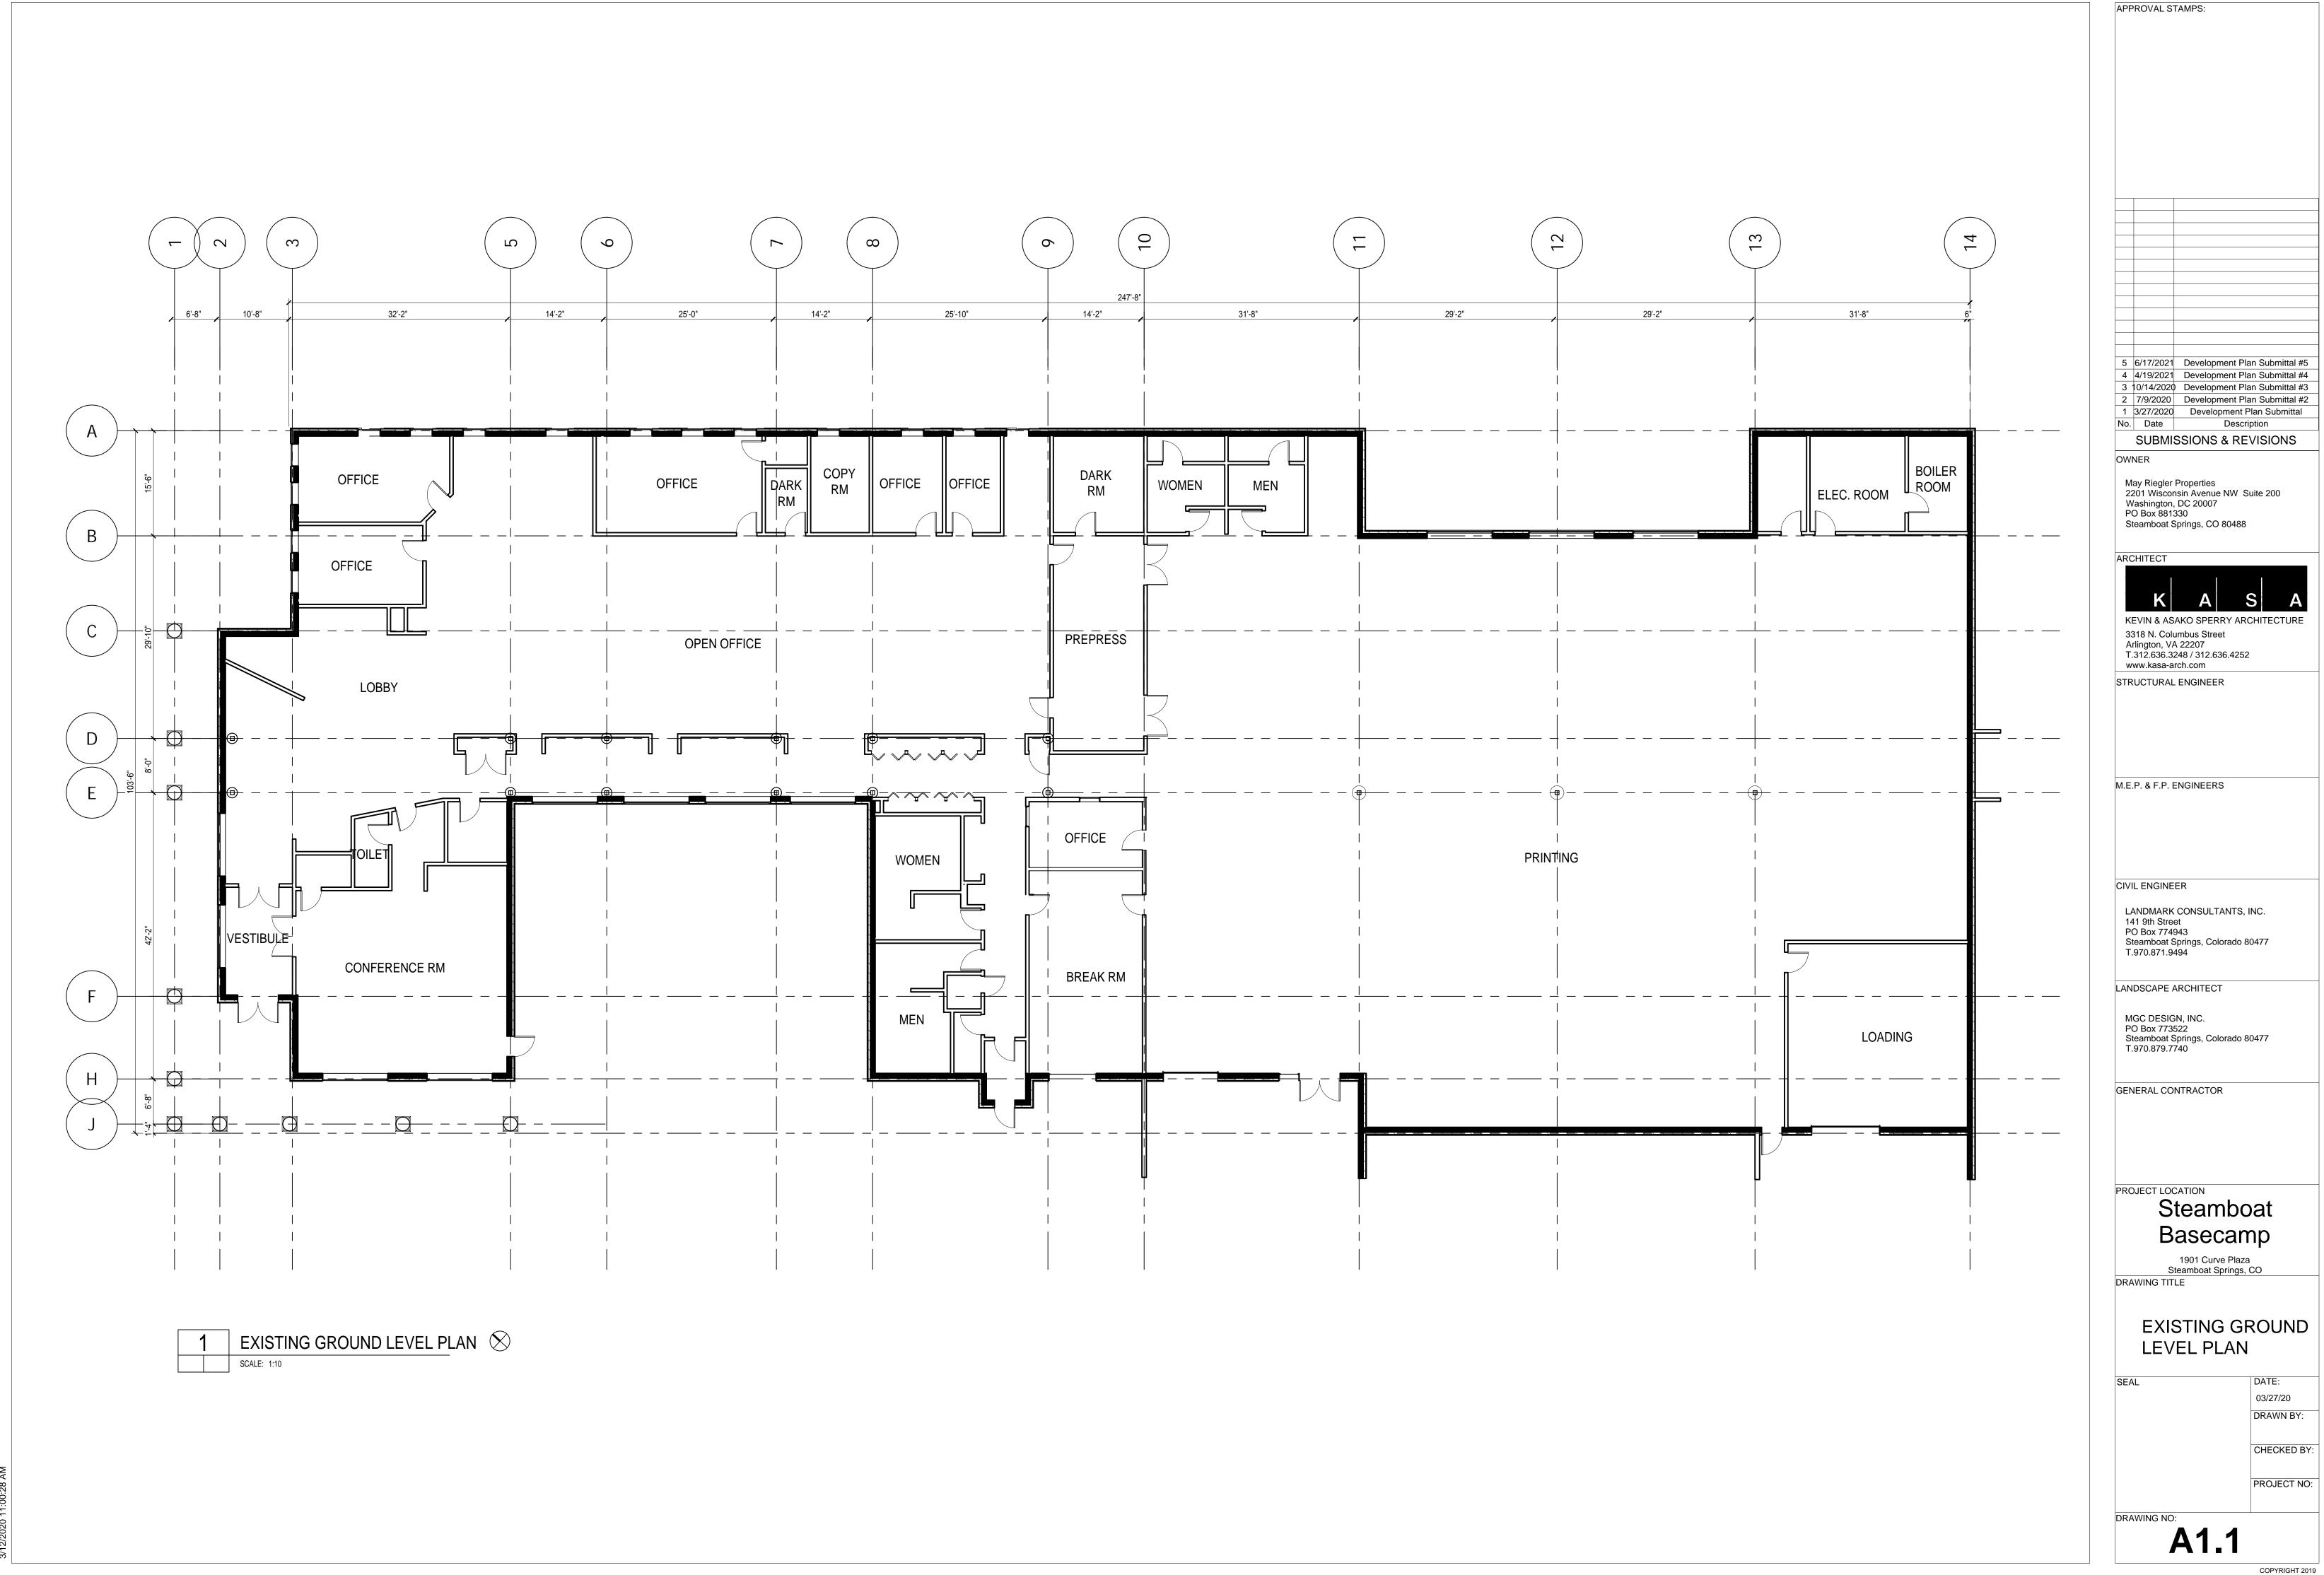


5 6/17/2021 Development Plan Submittal #5 4 4/19/2021 Development Plan Submittal #4 3 10/14/2020 Development Plan Submittal #3 2 7/9/2020 Development Plan Submittal #2



03/27/20 DRAWN BY:

CHECKED BY:

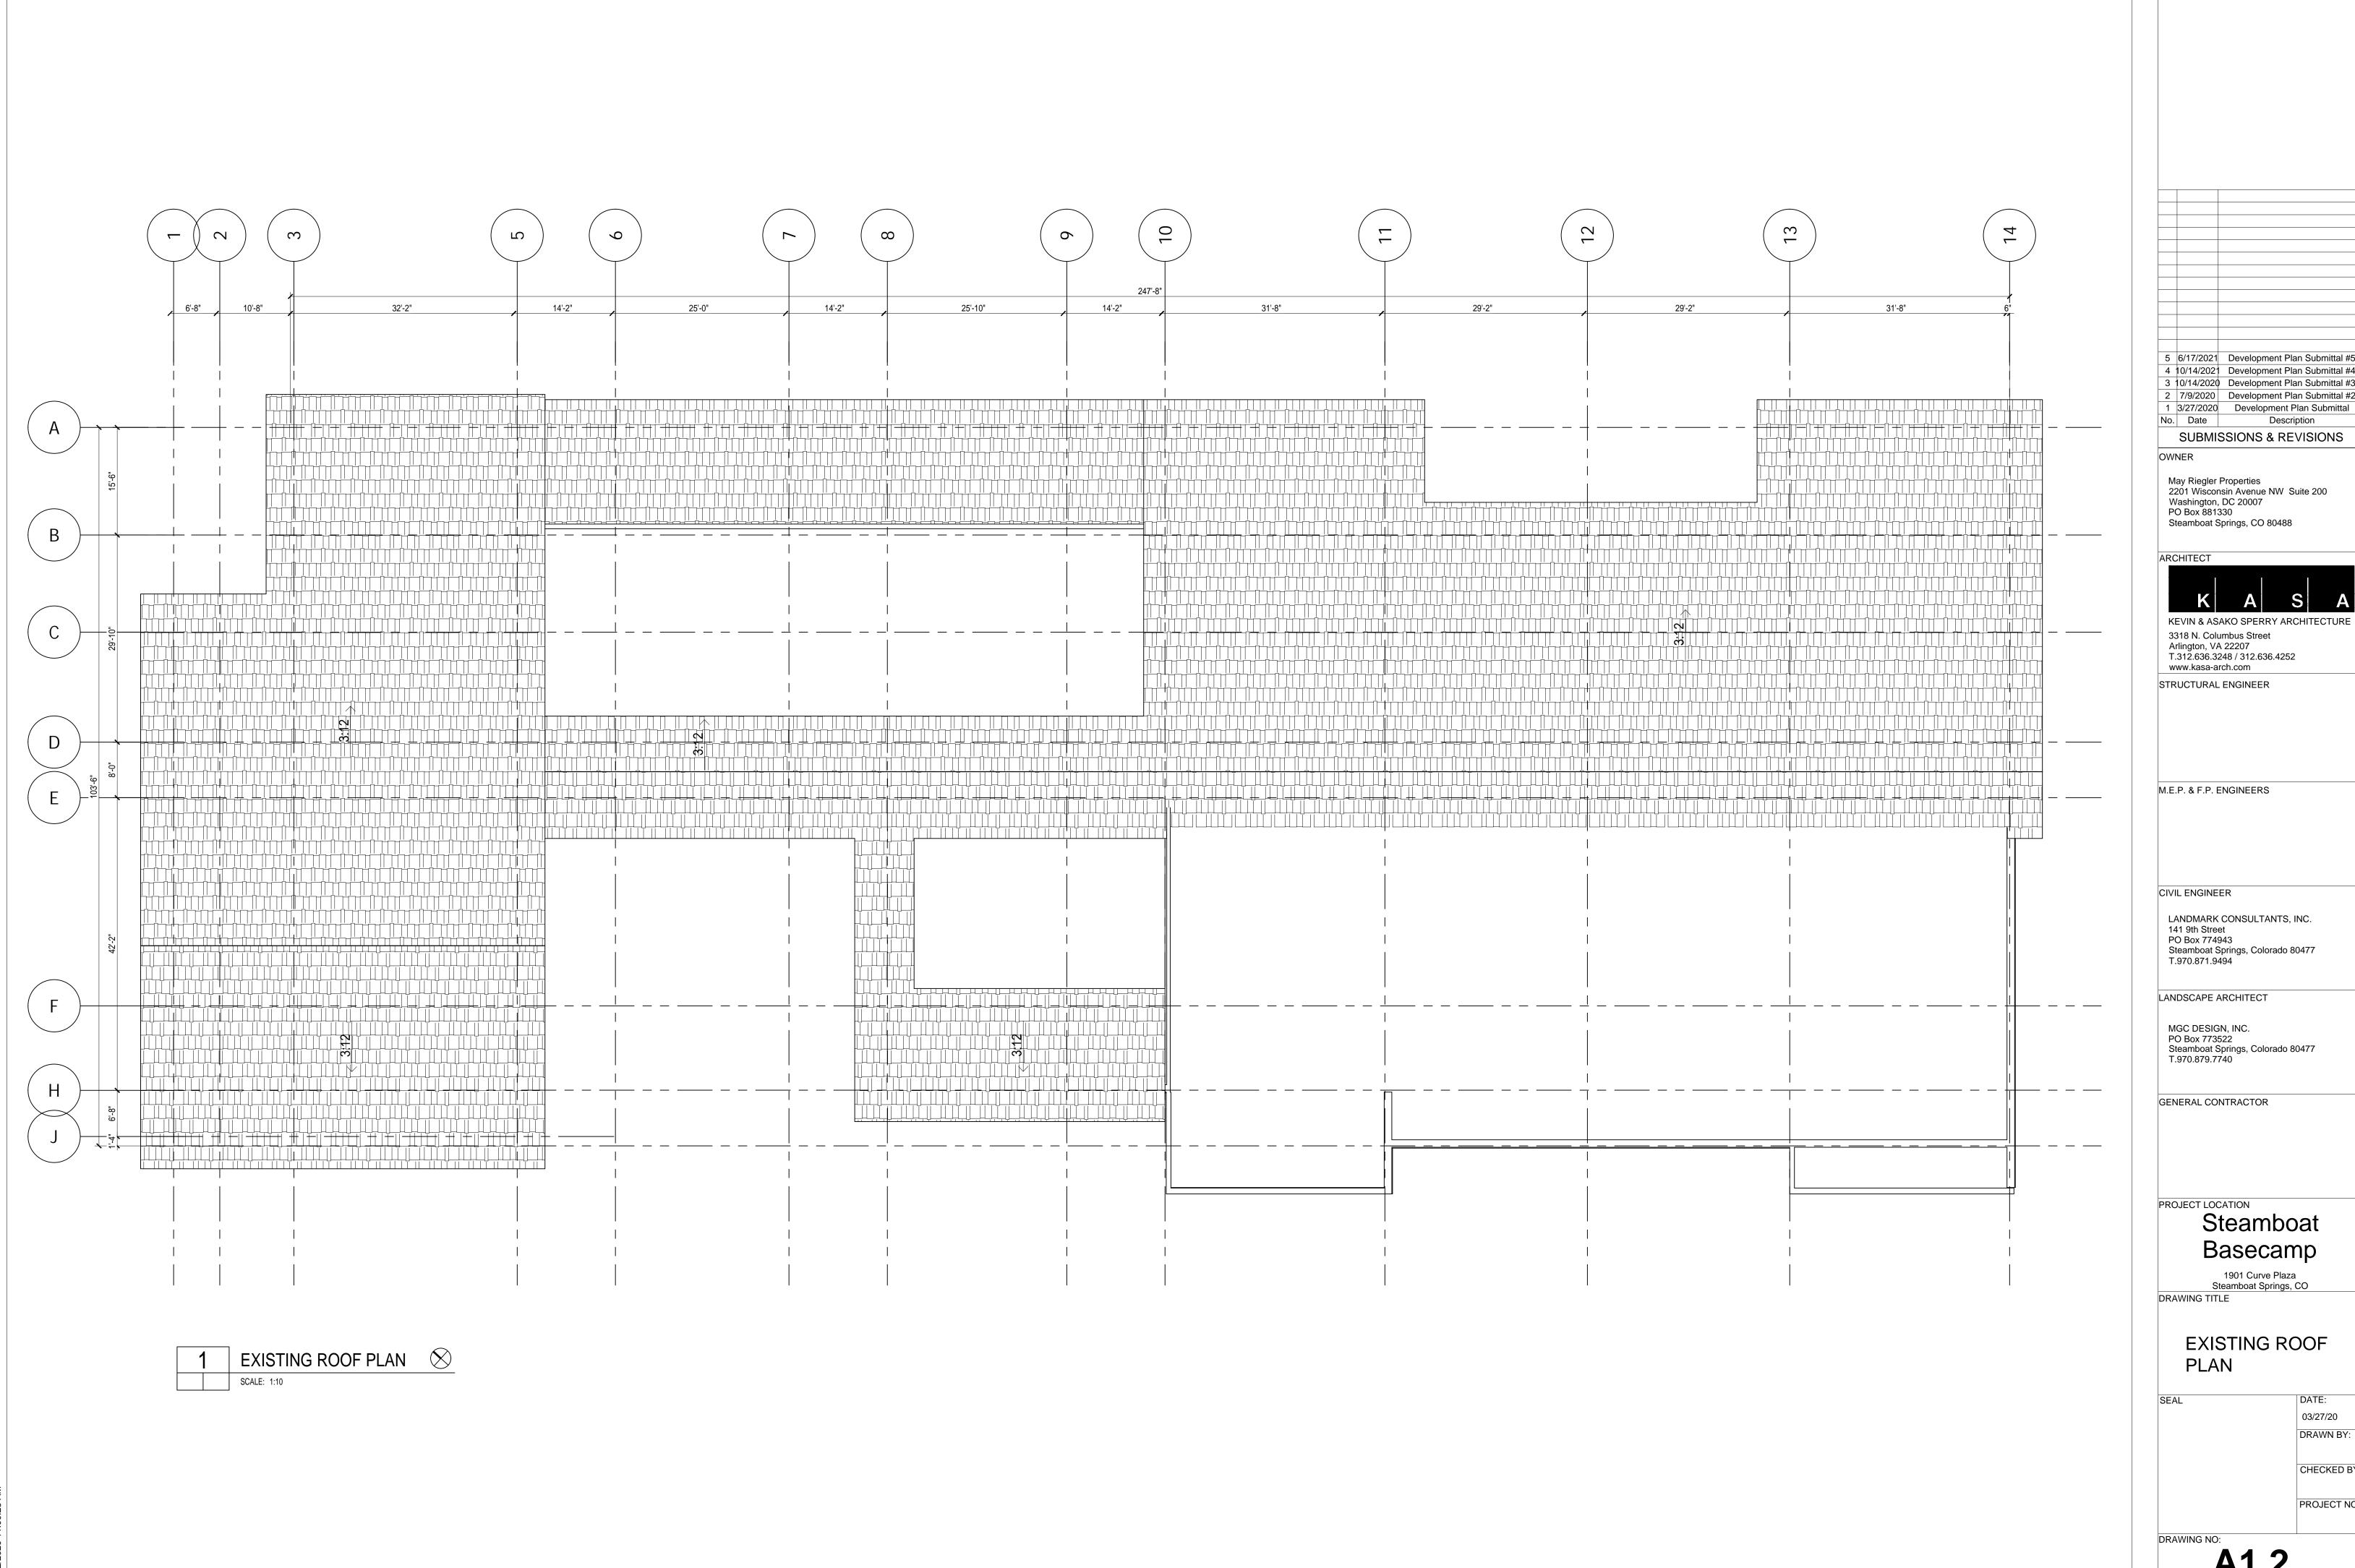

APPROVAL STAMPS:

5 6/17/2021 Development Plan Submittal #5 4 10/14/2021 Development Plan Submittal #4 3 10/14/2020 Development Plan Submittal #3 2 7/9/2020 Development Plan Submittal #2

Description SUBMISSIONS & REVISIONS

May Riegler Properties 2201 Wisconsin Avenue NW Suite 200 Washington, DC 20007 PO Box 881330

KEVIN & ASAKO SPERRY ARCHITECTURE

3318 N. Columbus Street Arlington, VA 22207 T.312.636.3248 / 312.636.4252 www.kasa-arch.com

STRUCTURAL ENGINEER

M.E.P. & F.P. ENGINEERS

LANDMARK CONSULTANTS, INC. 141 9th Street PO Box 774943 Steamboat Springs, Colorado 80477 T.970.871.9494

LANDSCAPE ARCHITECT

MGC DESIGN, INC. PO Box 773522 Steamboat Springs, Colorado 80477 T.970.879.7740

GENERAL CONTRACTOR

PROJECT LOCATION

Steamboat Basecamp

1901 Curve Plaza Steamboat Springs, CO

DRAWING TITLE

EXISTING ROOF


PLAN

03/27/20 DRAWN BY:

PROJECT NO:

CHECKED BY:

A1.2

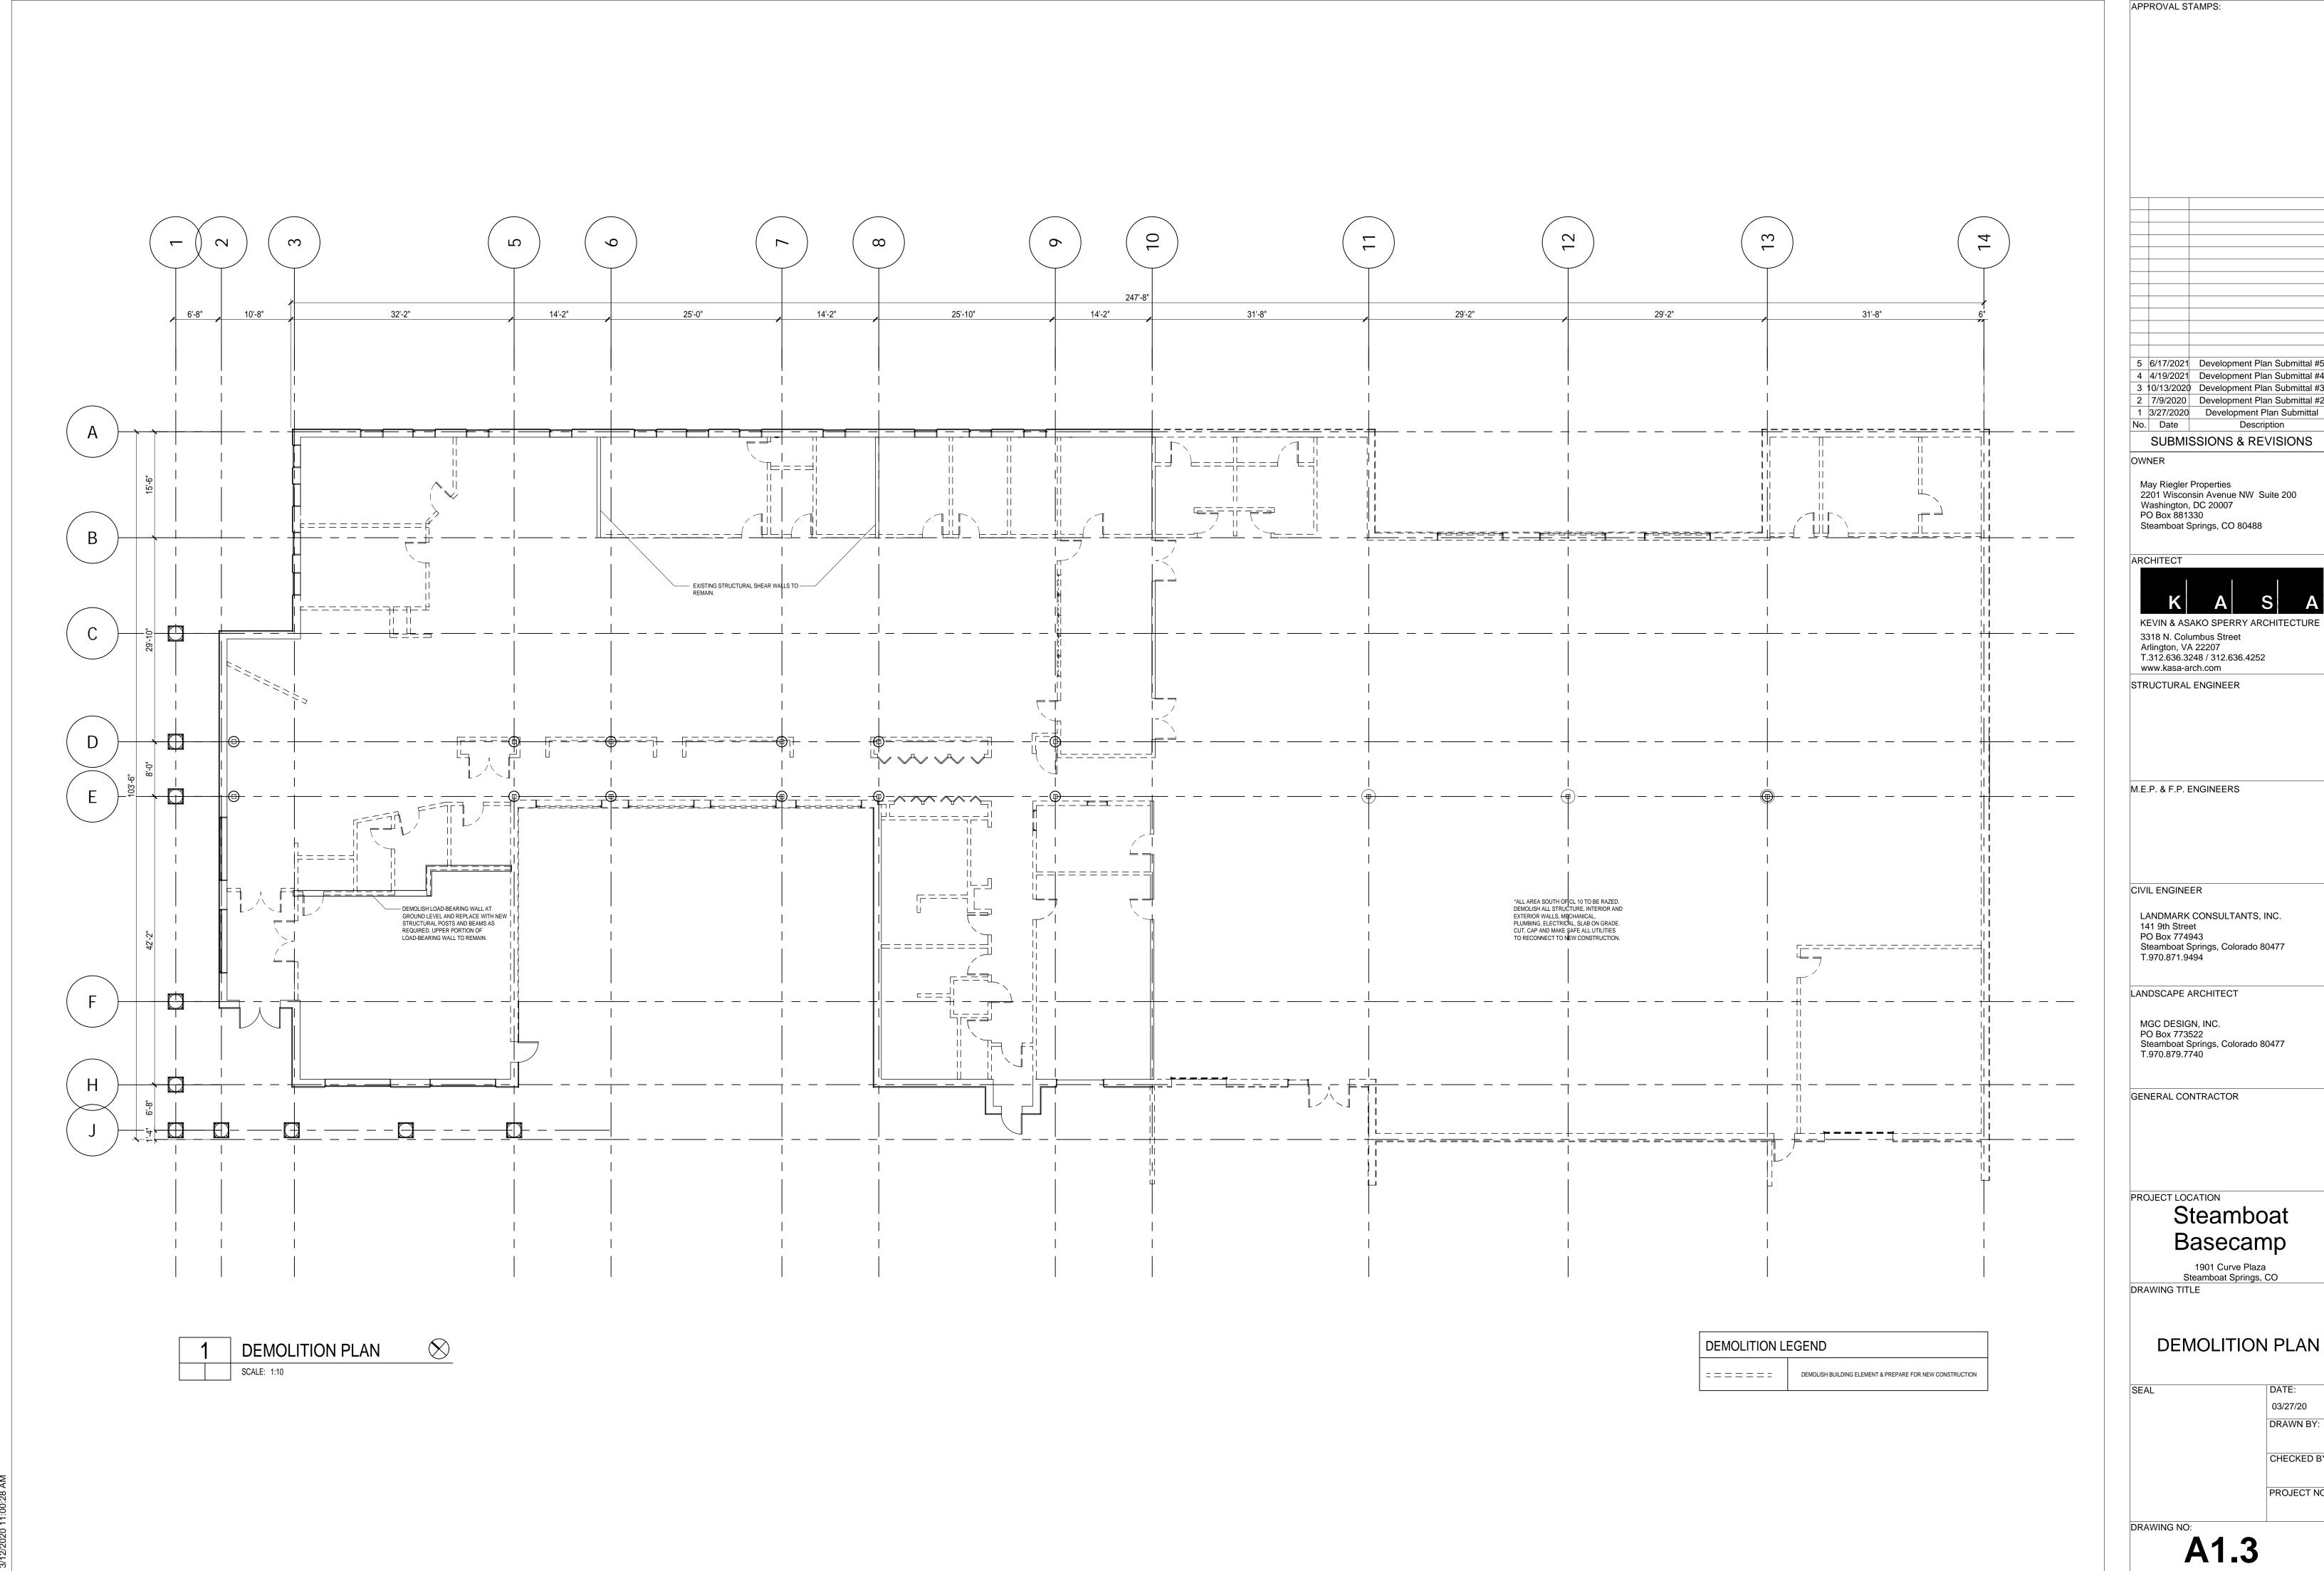



5 6/17/2021 Development Plan Submittal #5 4 4/19/2021 Development Plan Submittal #4 3 10/13/2020 Development Plan Submittal #3 2 7/9/2020 Development Plan Submittal #2




CHECKED BY:


PROJECT NO:

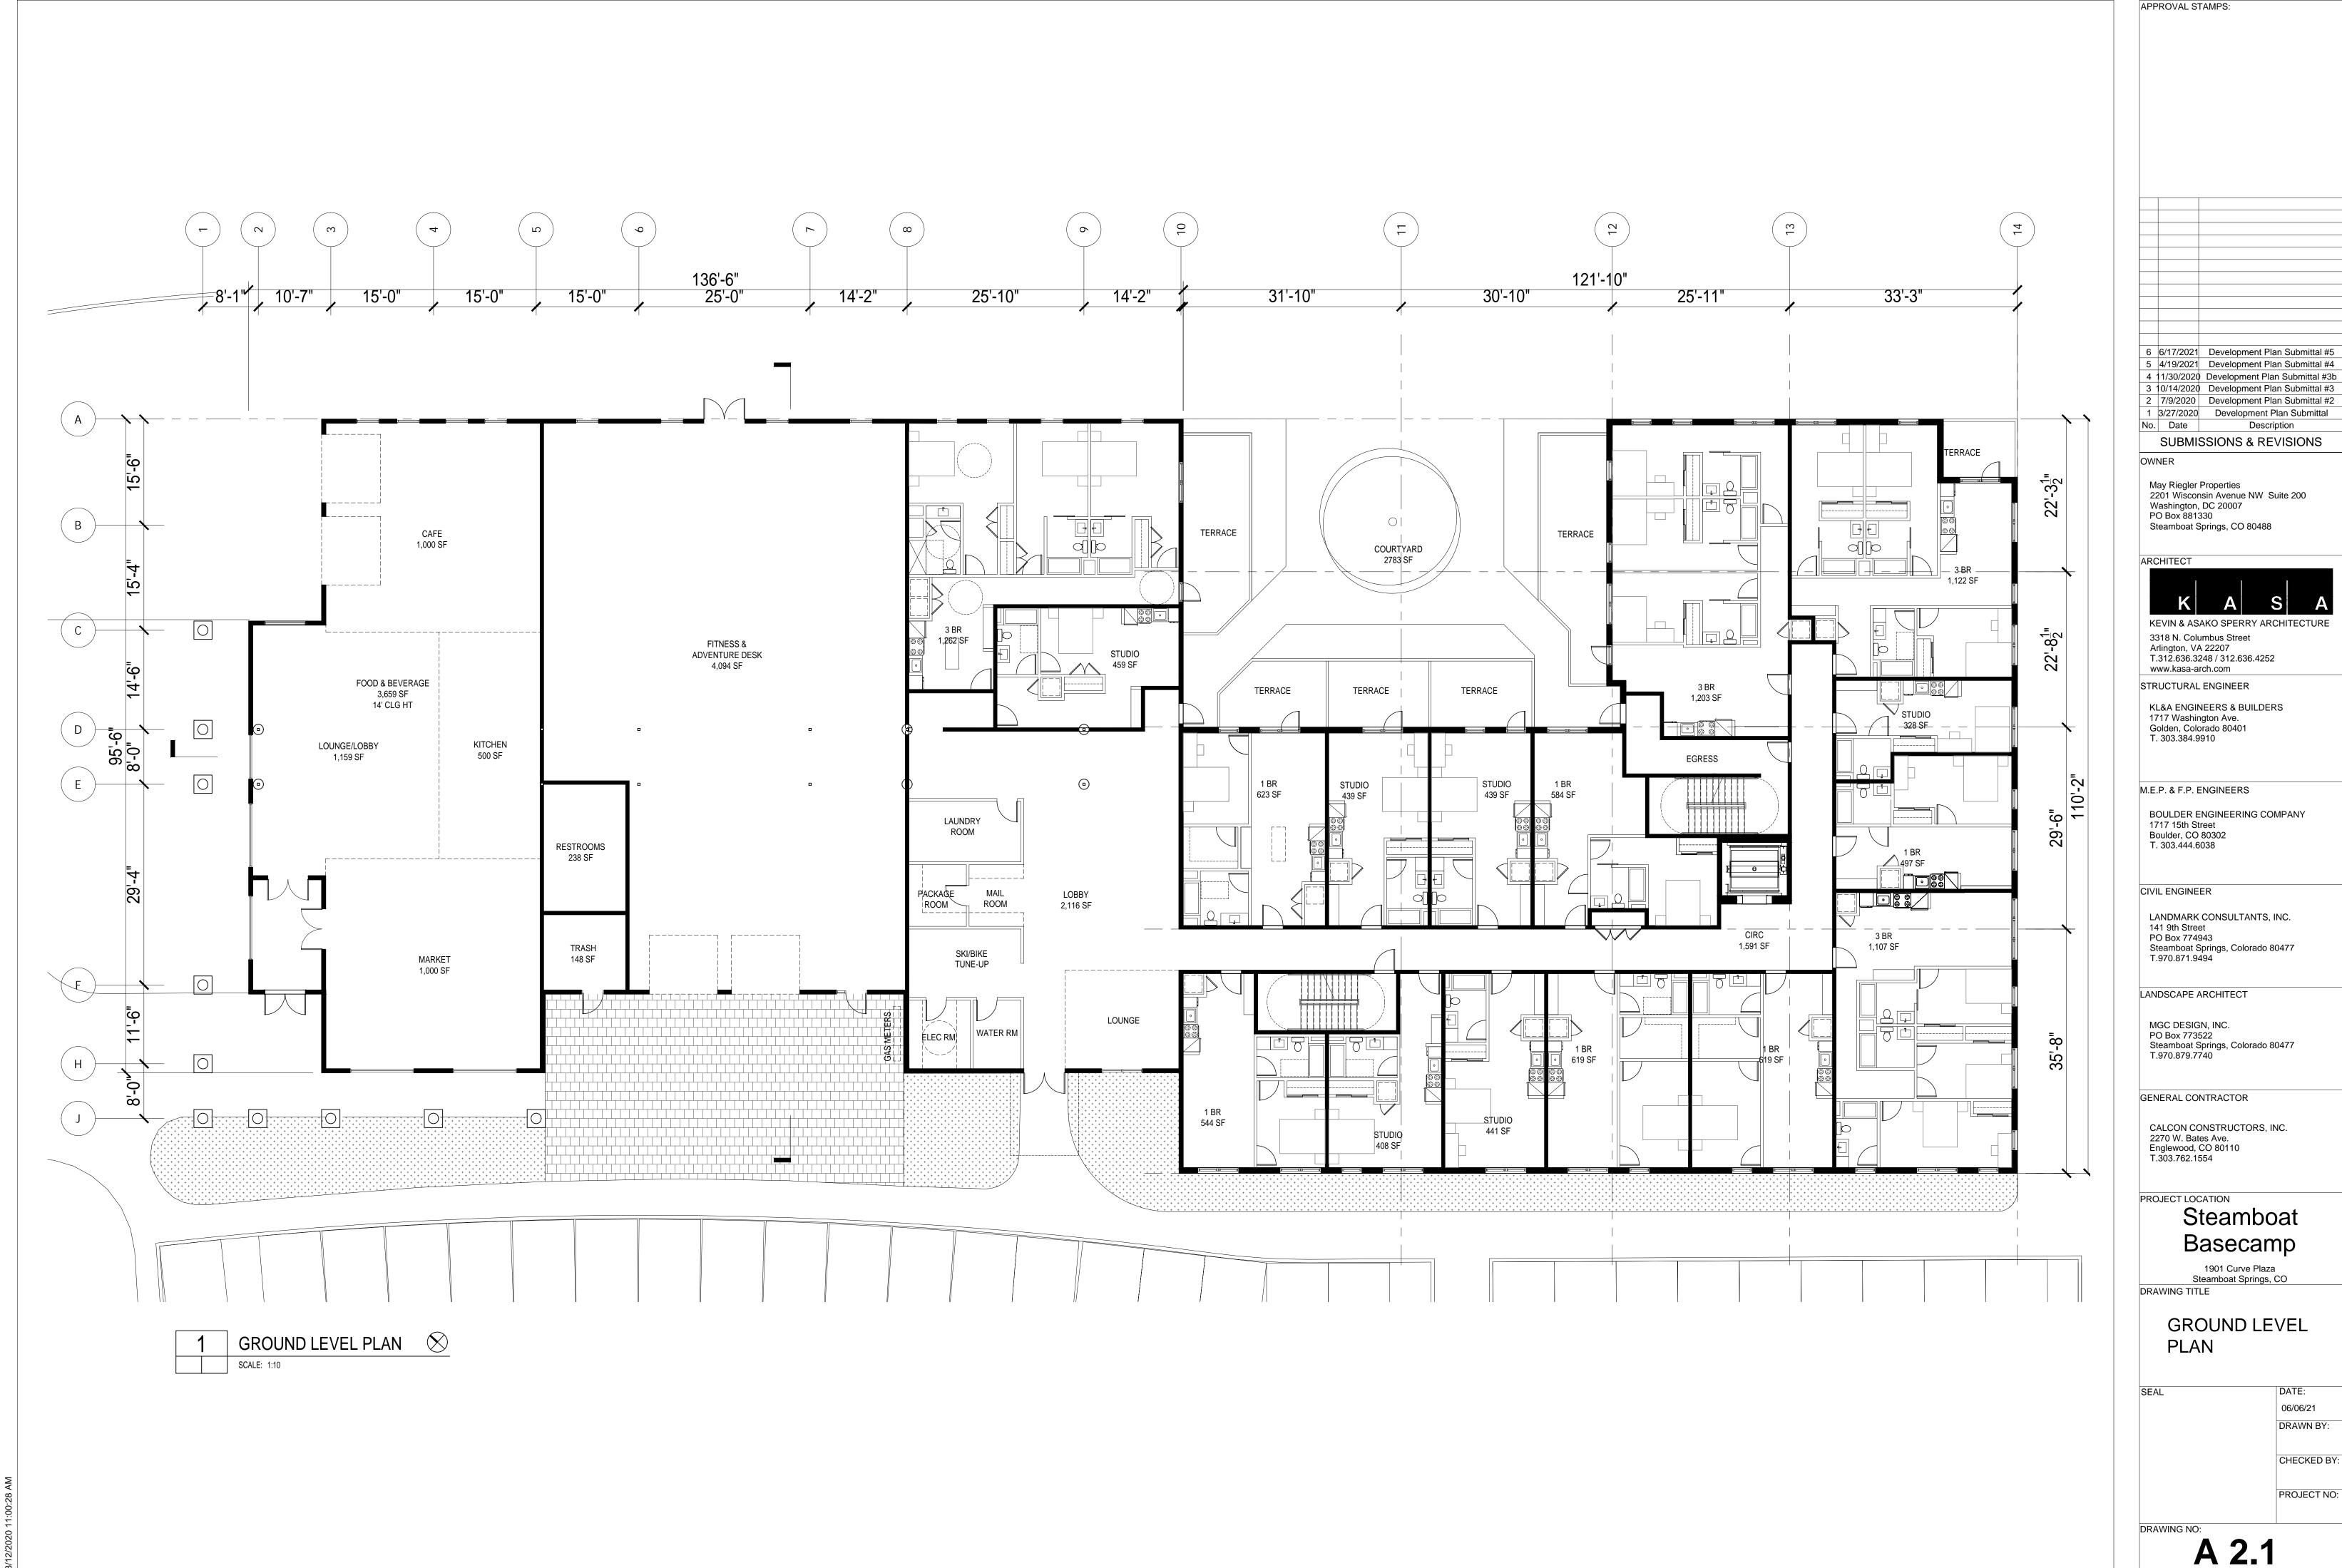


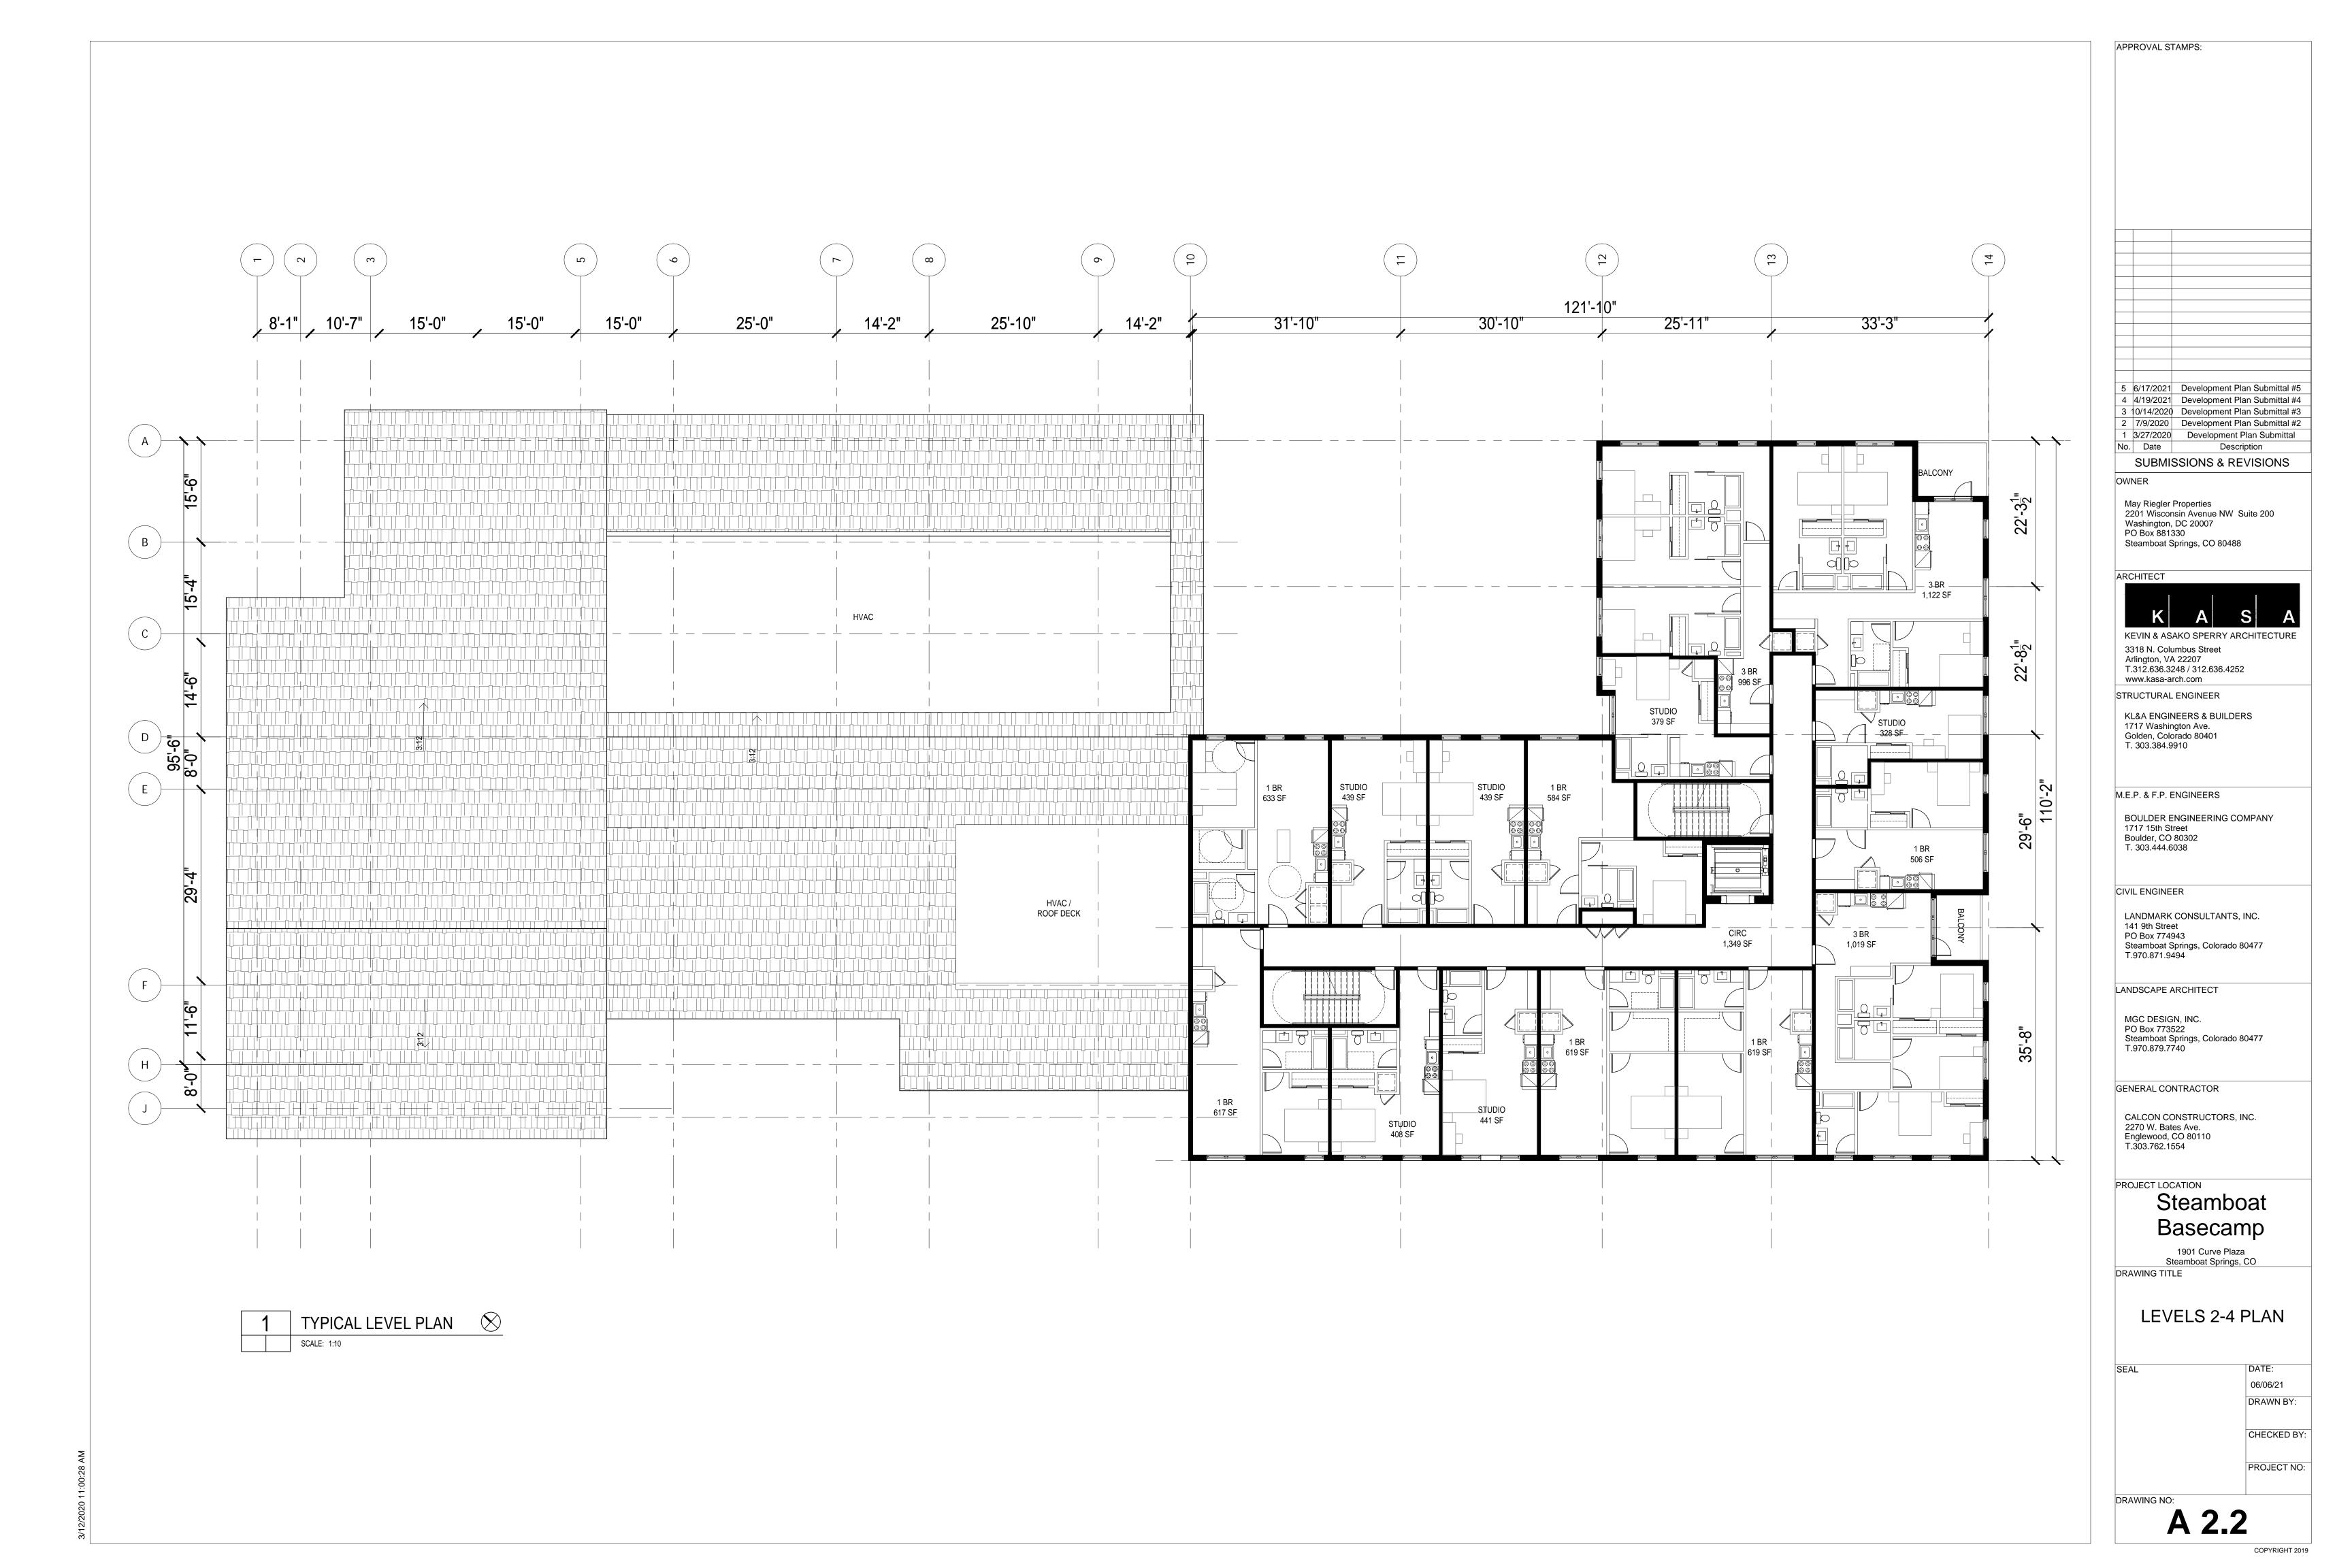


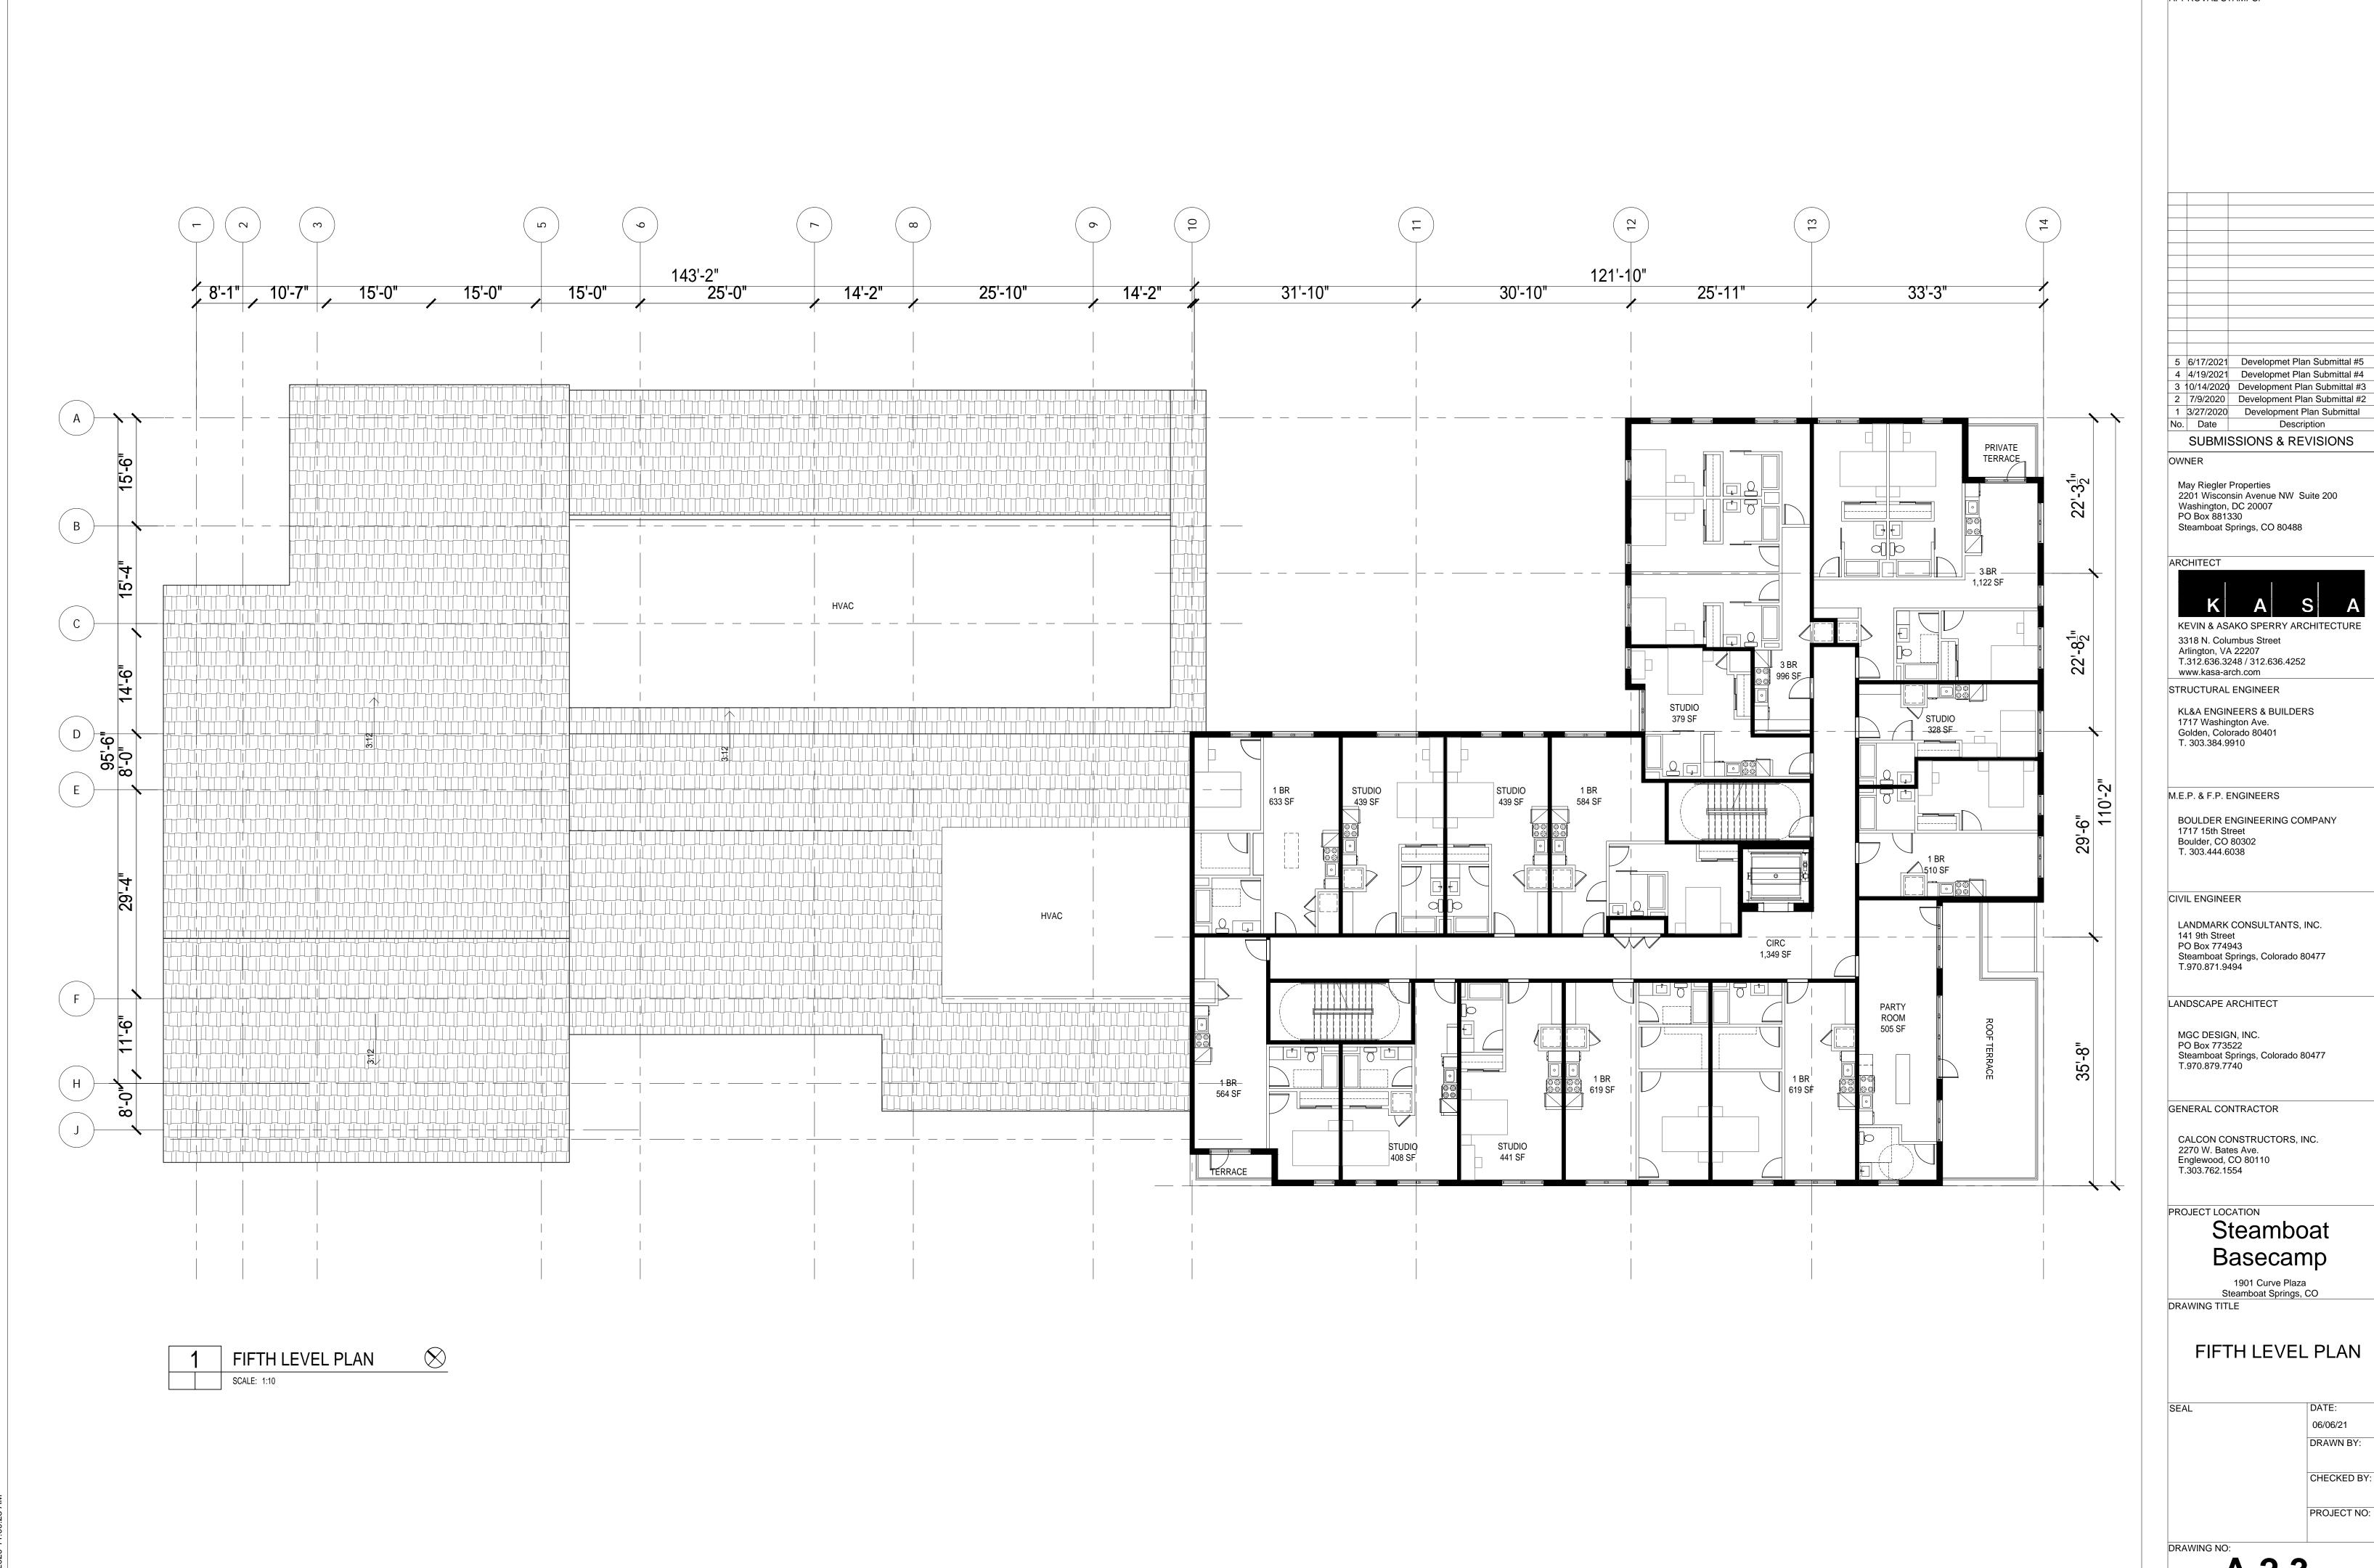



APPROVAL STAMPS:

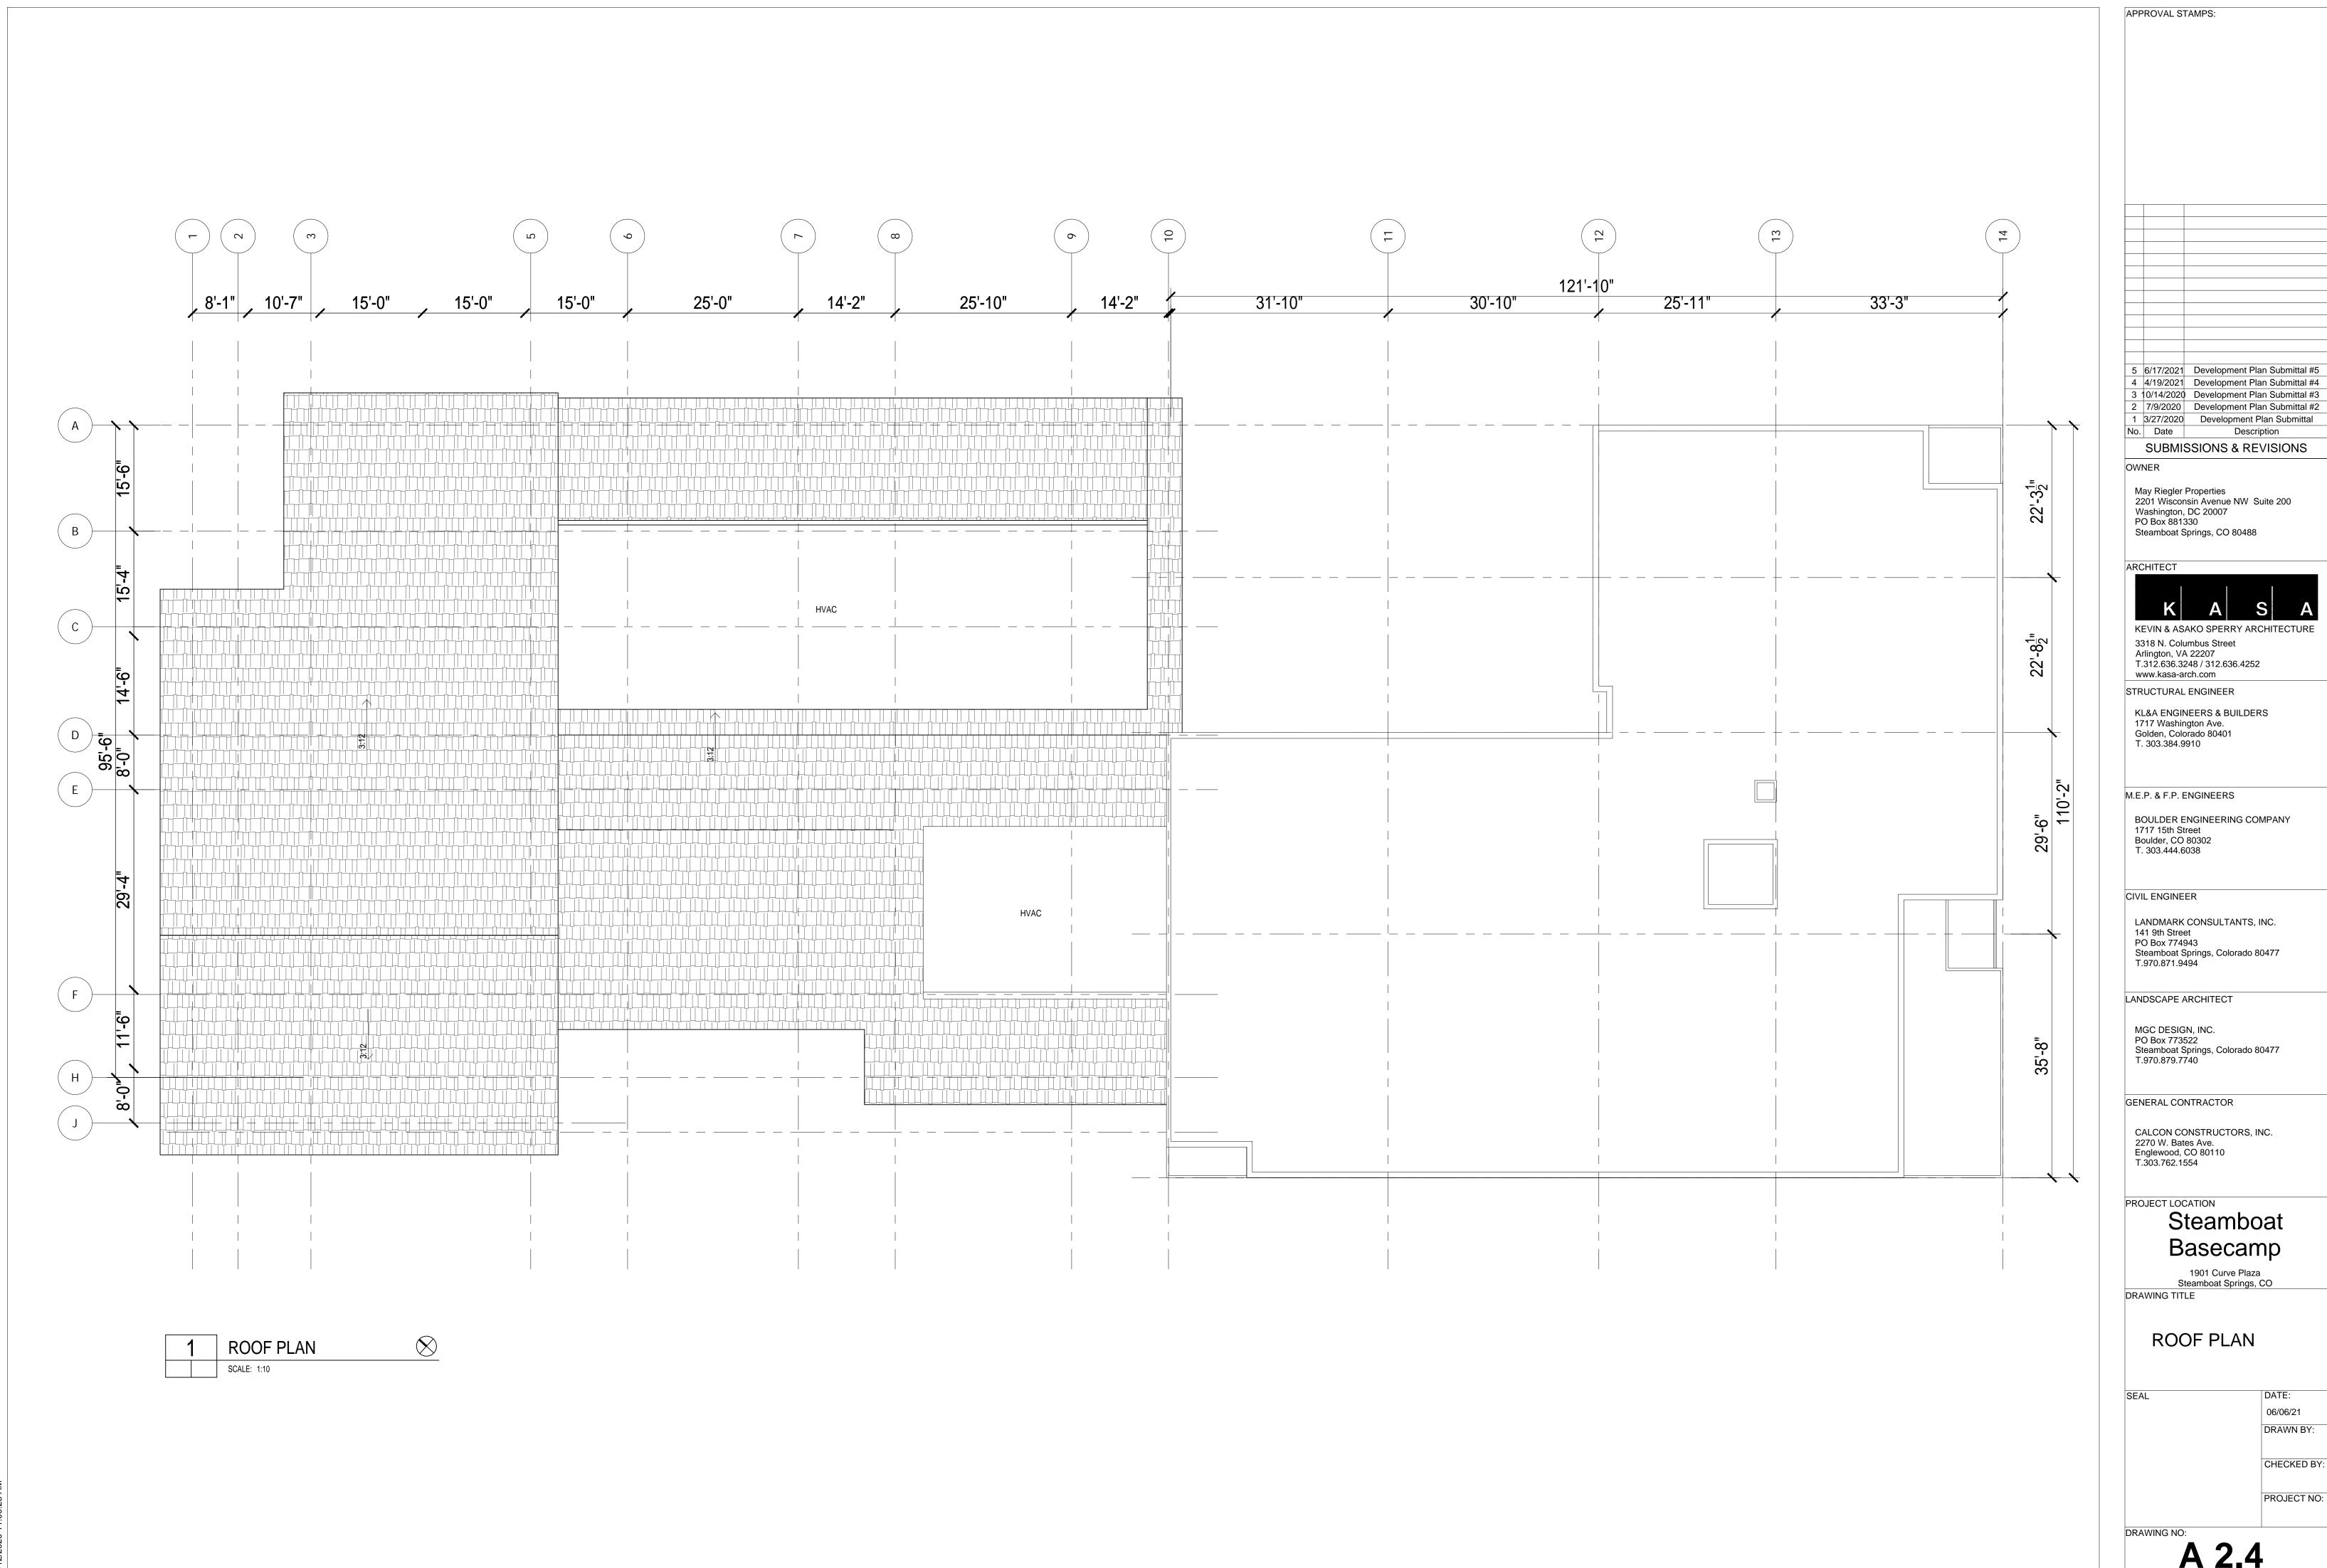

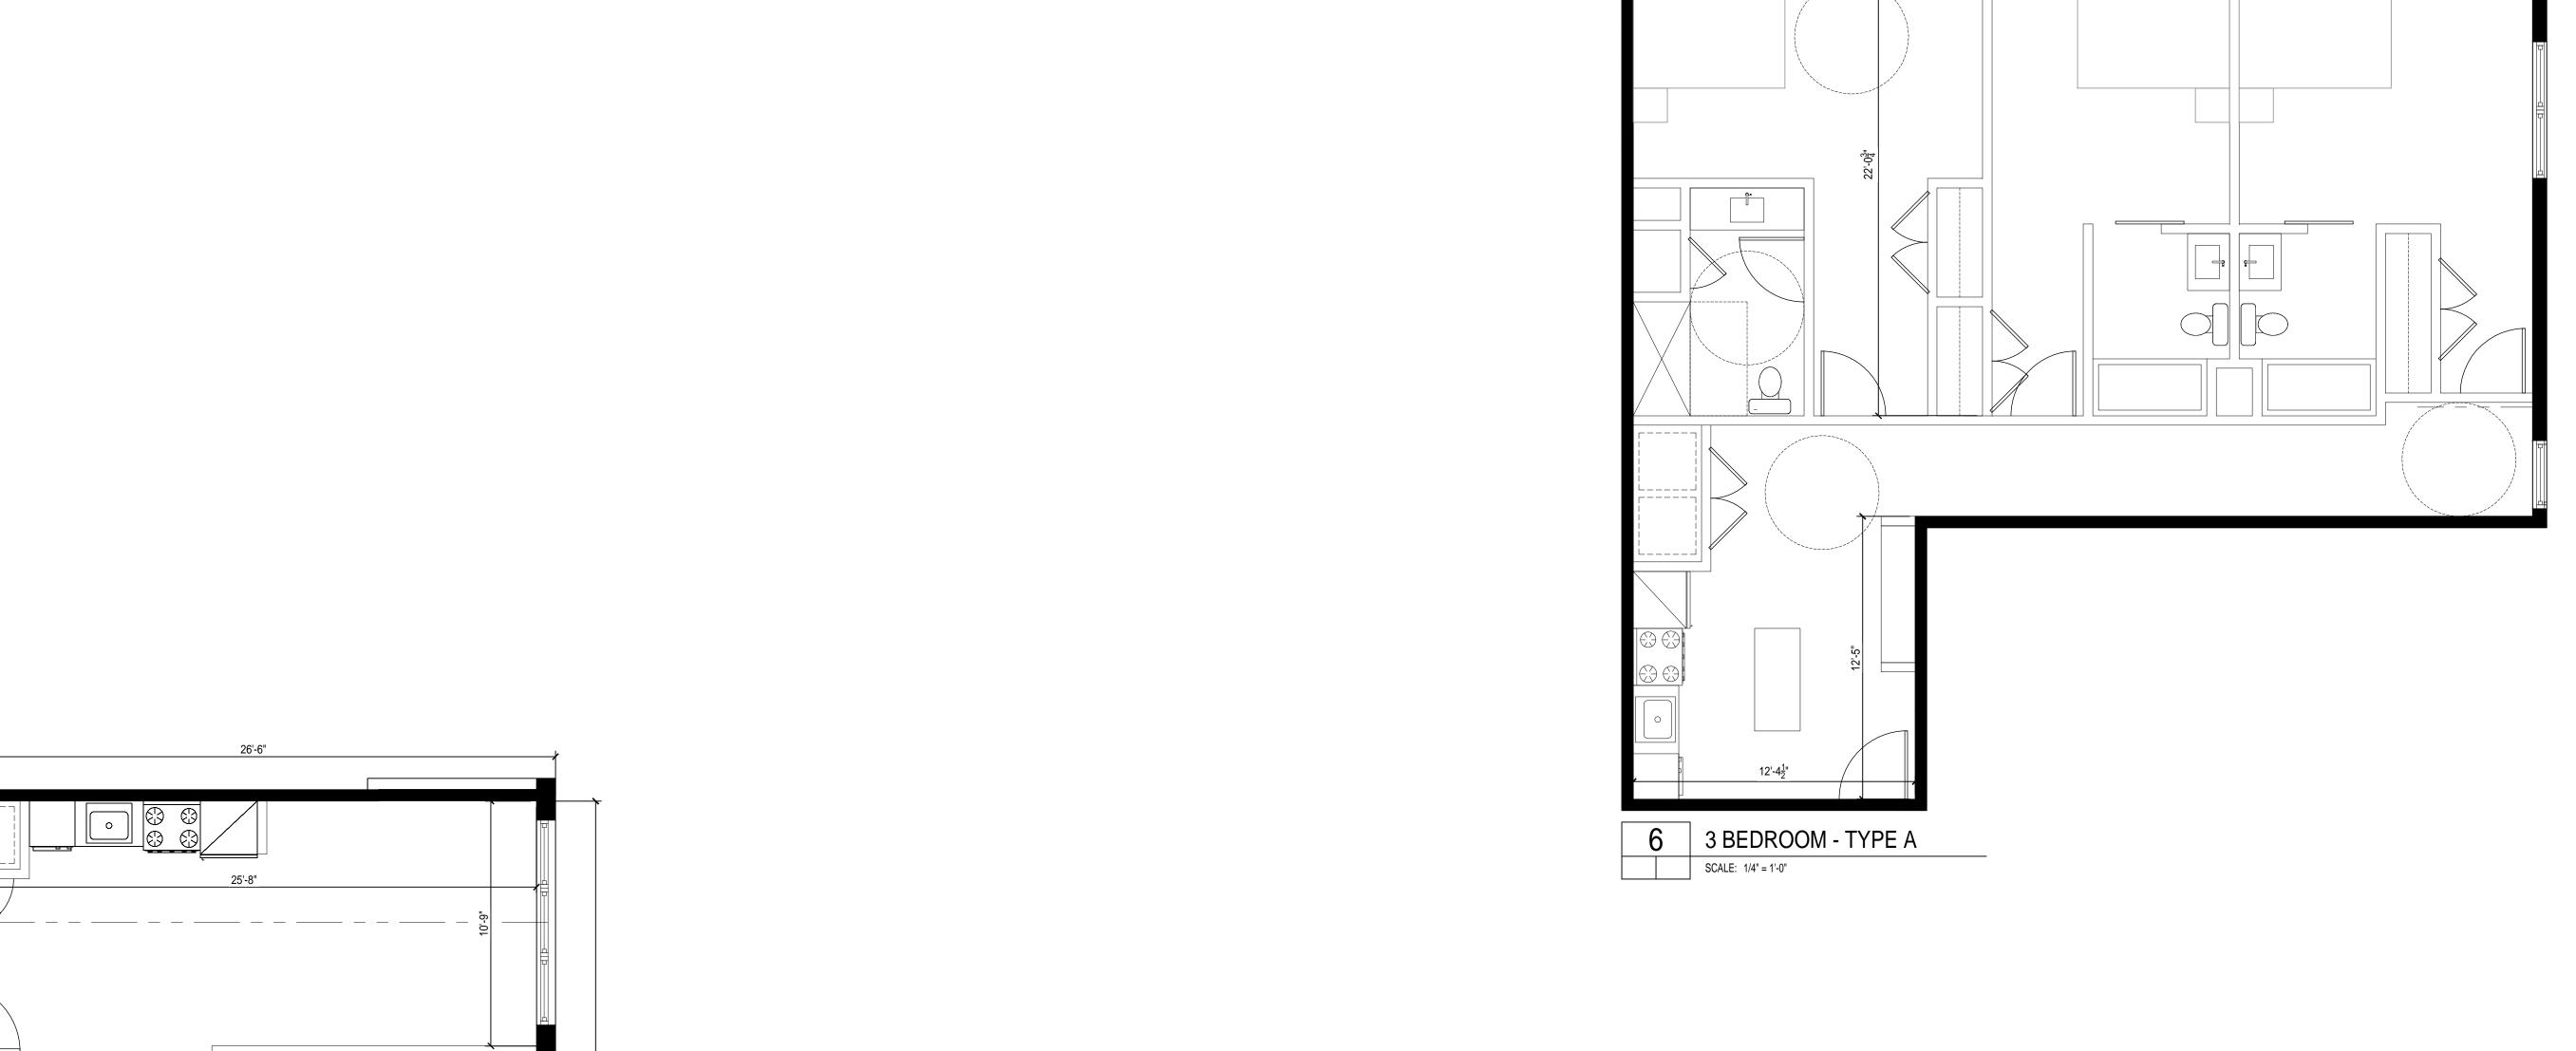


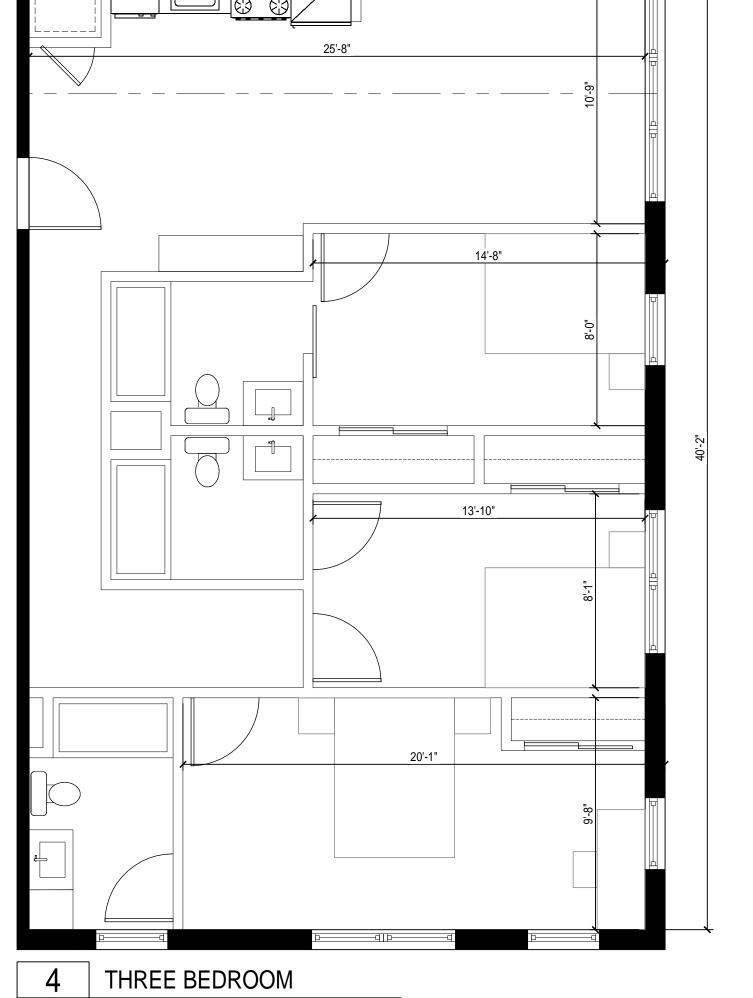

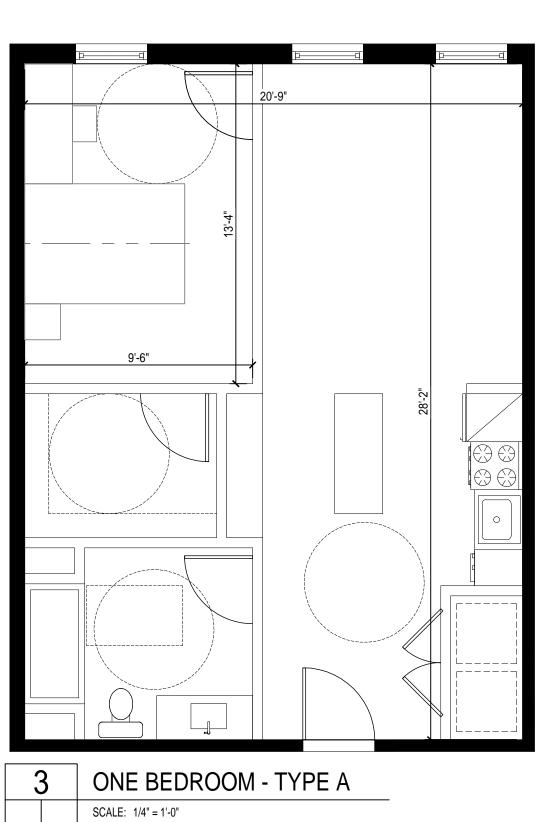

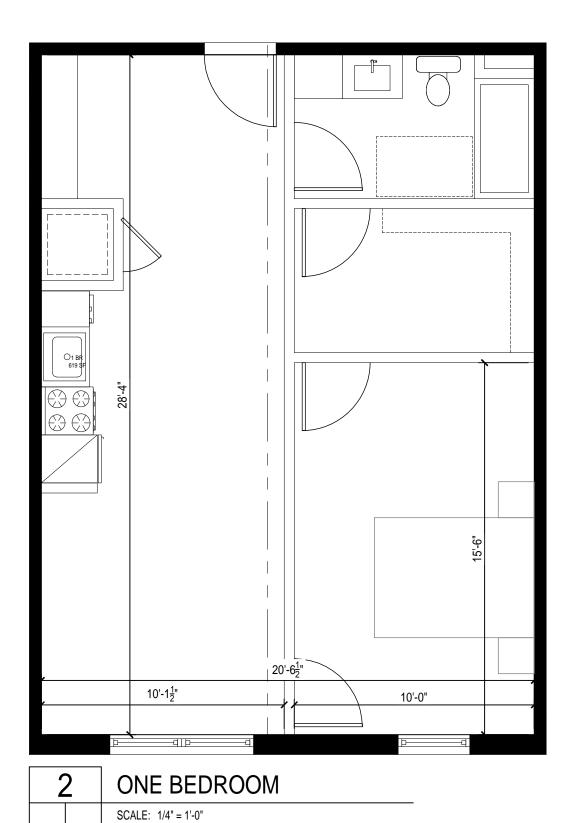


15'-4"

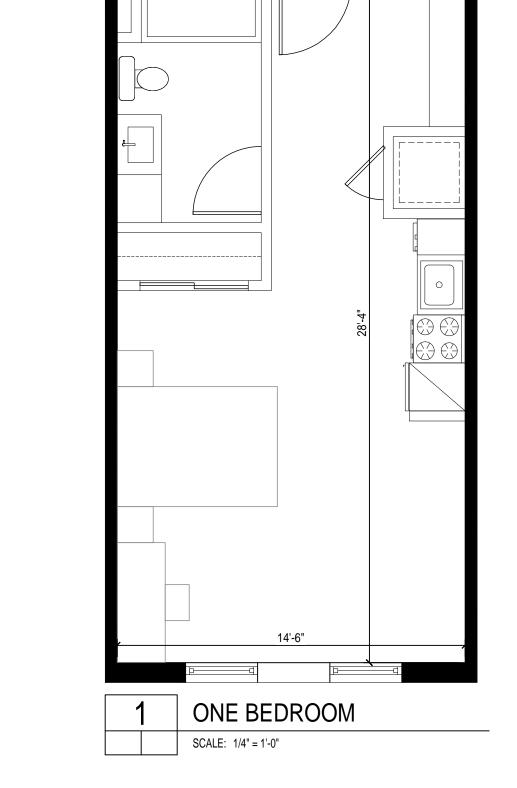


12'-10<u>1</u>"

10'-5"

39'-51"

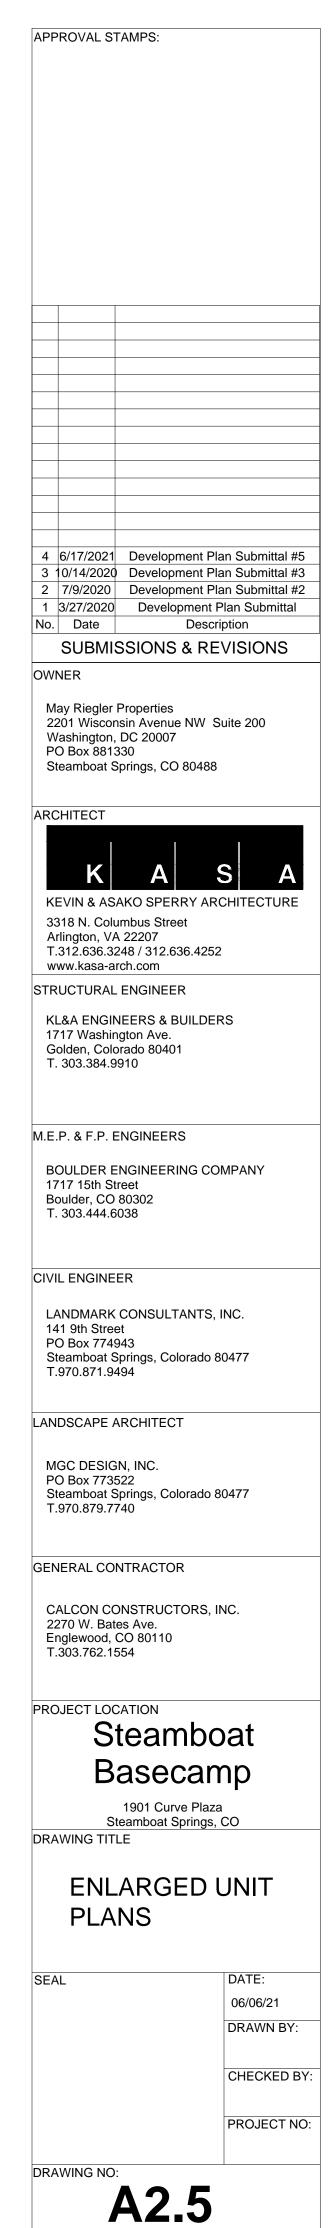

SCALE: 1/4" = 1'-0"

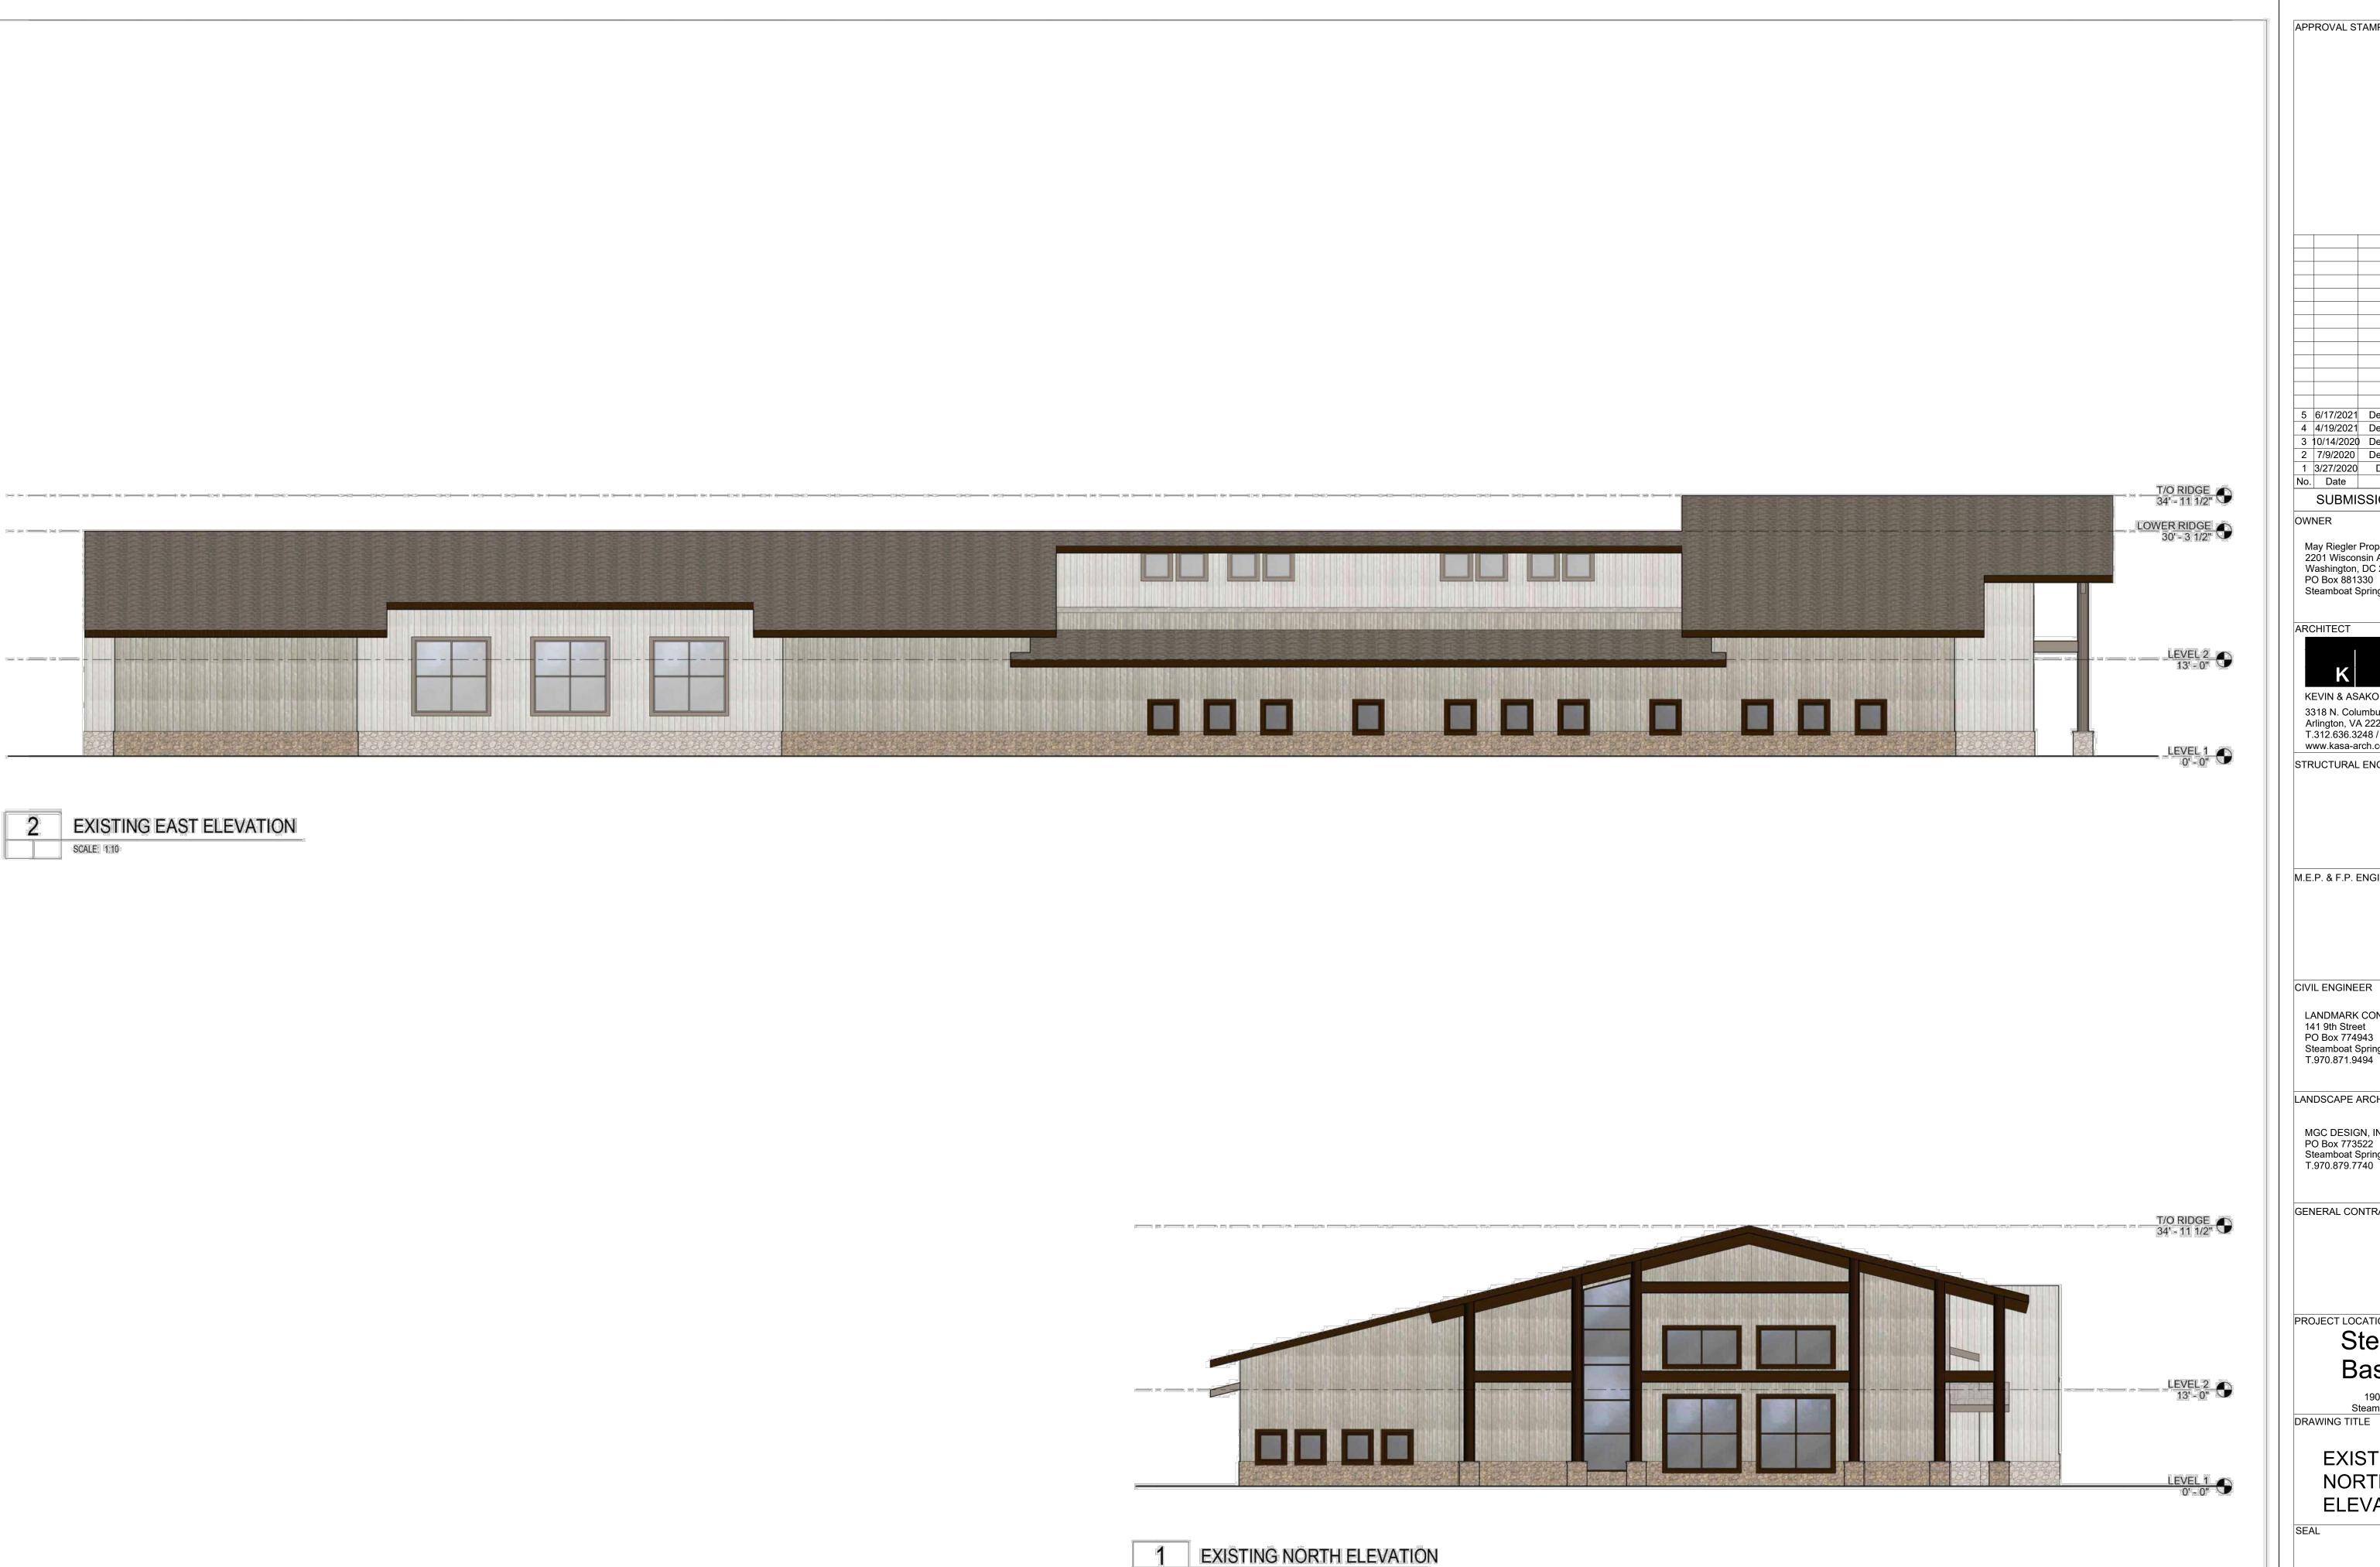

SCALE: 1:10

APPROVAL STAMPS: 5 6/17/2021 Development Plan Submittal #5 4 4/19/2021 Development Plan Submittal #4 3 10/14/2020 Development Plan Submittal #3 2 7/9/2020 Development Plan Submittal #2 1 3/27/2020 Development Plan Submittal No. Date Description SUBMISSIONS & REVISIONS May Riegler Properties
2201 Wisconsin Avenue NW Suite 200
Washington, DC 20007
PO Box 84 Springs CO 20408 Steamboat Springs, CO 80488 ARCHITECT KEVIN & ASAKO SPERRY ARCHITECTURE 3318 N. Columbus Street Arlington, VA 22207 T.312.636.3248 / 312.636.4252 www.kasa-arch.com STRUCTURAL ENGINEER M.E.P. & F.P. ENGINEERS CIVIL ENGINEER

LANDMARK CONSULTANTS, INC. 141 9th Street PO Box 774943 Steamboat Springs, Colorado 80477 T.970.871.9494

LANDSCAPE ARCHITECT

MGC DESIGN, INC. PO Box 773522 Steamboat Springs, Colorado 80477 T.970.879.7740

GENERAL CONTRACTOR

PROJECT LOCATION

Steamboat Basecamp

1901 Curve Plaza Steamboat Springs, CO

EXISTING NORTH & EAST ELEVATIONS

> 03/27/20 DRAWN BY:

CHECKED BY: PROJECT NO:

DRAWING NO:

A3.02



2 EXISTING WEST ELEVATION



1 EXISTING SOUTH ELEVATION
SCALE 1:10

APPROVAL STAMPS:

5 6/17/2021 Development Plan Submittal #5
4 4/19/2021 Development Plan Submittal #4
3 10/14/2020 Development Plan Submittal #3
2 7/9/2020 Development Plan Submittal #2
1 3/27/2020 Development Plan Submittal Mo. Date Description

SUBMISSIONS & REVISIONS

OWNER

May Riegler Properties 2201 Wisconsin Avenue NW Suite 200 Washington, DC 20007 PO Box 881330 Steamboat Springs, CO 80488

ARCHITECT



KEVIN & ASAKO SPERRY ARCHITECTURE 3318 N. Columbus Street Arlington, VA 22207 T.312.636.3248 / 312.636.4252 www.kasa-arch.com

STRUCTURAL ENGINEER

M.E.P. & F.P. ENGINEERS

CIVIL ENGINEER

LANDMARK CONSULTANTS, INC. 141 9th Street PO Box 774943 Steamboat Springs, Colorado 80477 T.970.871.9494

LANDSCAPE ARCHITECT

MGC DESIGN, INC. PO Box 773522 Steamboat Springs, Colorado 80477 T.970.879.7740

GENERAL CONTRACTOR

PROJECT LOCATION

Steamboat Basecamp

1901 Curve Plaza Steamboat Springs, CO

EXISTING

SOUTH & WEST ELEVATIONS

EAL

DATE:
03/27/20
DRAWN BY:
CHECKED BY:

PROJECT NO:

DRAWING NO:

A3.01






TRASH ENCLOSURE ELEVATIONS

SCALE: 1:10

APPROVAL STAMPS: B 6/17/2021 Development Plan Submittal 2 4/19/2021 Development Plan Submittal 1 3/27/2020 Development Plan Submittal Description SUBMISSIONS & REVISIONS May Riegler Properties
2201 Wisconsin Avenue NW Suite 200
Washington, DC 20007
PO Box 881330 Steamboat Springs, CO 80488 ARCHITECT KEVIN & ASAKO SPERRY ARCHITECTURE 3318 N. Columbus Street Arlington, VA 22207 T.312.636.3248 / 312.636.4252 www.kasa-arch.com STRUCTURAL ENGINEER M.E.P. & F.P. ENGINEERS CIVIL ENGINEER LANDMARK CONSULTANTS, INC. 141 9th Street PO Box 774943 Steamboat Springs, Colorado 80477 T.970.871.9494 LANDSCAPE ARCHITECT MGC DESIGN, INC. PO Box 773522 Steamboat Springs, Colorado 80477 T.970.879.7740 GENERAL CONTRACTOR PROJECT LOCATION Steamboat Basecamp 1901 Curve Plaza Steamboat Springs, CO DRAWING TITLE PROPOSED SOUTH & WEST **ELEVATIONS** 04/16/21 DRAWN BY: CHECKED BY: PROJECT NO: DRAWING NO: **A3.11**



EAST ELEVATION SCALE: 1:10

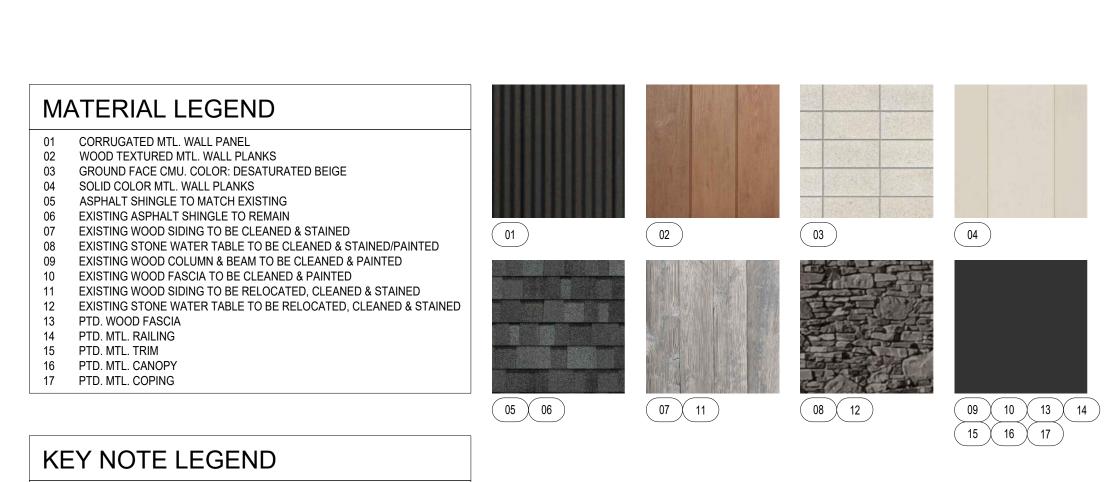

TRANSPARENCY	/ CALCUI	_ATIONS			
PRIMARY STREET FACADES - NEW CO	NSTRUCTION				
FACADE LOCATION	AREA	% REQUIREMENT	TRANSPARENCY REQUIRED	TRANSPARENCY PROVIDED	% PROVIDED
NORTH FACADE / GROUND LEVEL:	2,581 SF	30%	774.3 SF	557.8 SF	21.6%
EAST FACADE / GROUND LEVEL:	3,001 SF	30%	900.3 SF	306.1 SF	10.2%
SOUTH FACADE / GROUND LEVEL:	1,128 SF	30%	270.1 SF	213.3 SF	18.9%
WEST FACADE / GROUND LEVEL:	4,243 SF	30%	1,272.9 SF	1,032.4 SF	24.3%
NORTH FACADE / UPPER LEVELS:	N/A	N/A	N/A	N/A	N/A
EAST FACADE / UPPER LEVELS:	6,230 SF	25%	1,557.5 SF	1,309 SF	21%
SOUTH FACADE / UPPER LEVELS:	4,185 SF	25%	1,046 SF	882.5 SF	21.1%
WEST FACADE / GROUND LEVELS:	5,350 SF	25%	1,337.5 SF	1,195.1 SF	22.3%

A NEW EXTERIOR LIGHT FIXTURES. REFER TO A.XX & A.XX FOR DETAILS

B HATCHED WINDOWS INDICATE EXISTING TO REMAIN

C GARAGE DOOR STOREFRONT

F WALL MURAL

WOOD PRIVACY FENCE



A3.12

APPROVAL STAMPS:

3 6/17/2021 Development Plan Submittal 2 4/19/2021 Development Plan Submittal

SUBMISSIONS & REVISIONS

May Riegler Properties
2201 Wisconsin Avenue NW Suite 200
Washington, DC 20007
PO Box 881330

KEVIN & ASAKO SPERRY ARCHITECTURE

Steamboat Springs, CO 80488

3318 N. Columbus Street Arlington, VA 22207 T.312.636.3248 / 312.636.4252

LANDMARK CONSULTANTS, INC.

Steamboat Springs, Colorado 80477 T.970.871.9494

PO Box 773522 Steamboat Springs, Colorado 80477 T.970.879.7740

Steamboat

Basecamp

1901 Curve Plaza

Steamboat Springs, CO

PROPOSED

NORTH & EAST

ELEVATIONS

DRAWING NO:

141 9th Street PO Box 774943

LANDSCAPE ARCHITECT

MGC DESIGN, INC.

www.kasa-arch.com STRUCTURAL ENGINEER

ARCHITECT

Description


COPYRIGHT 2019

04/16/21

DRAWN BY:

CHECKED BY:

PROJECT NO:

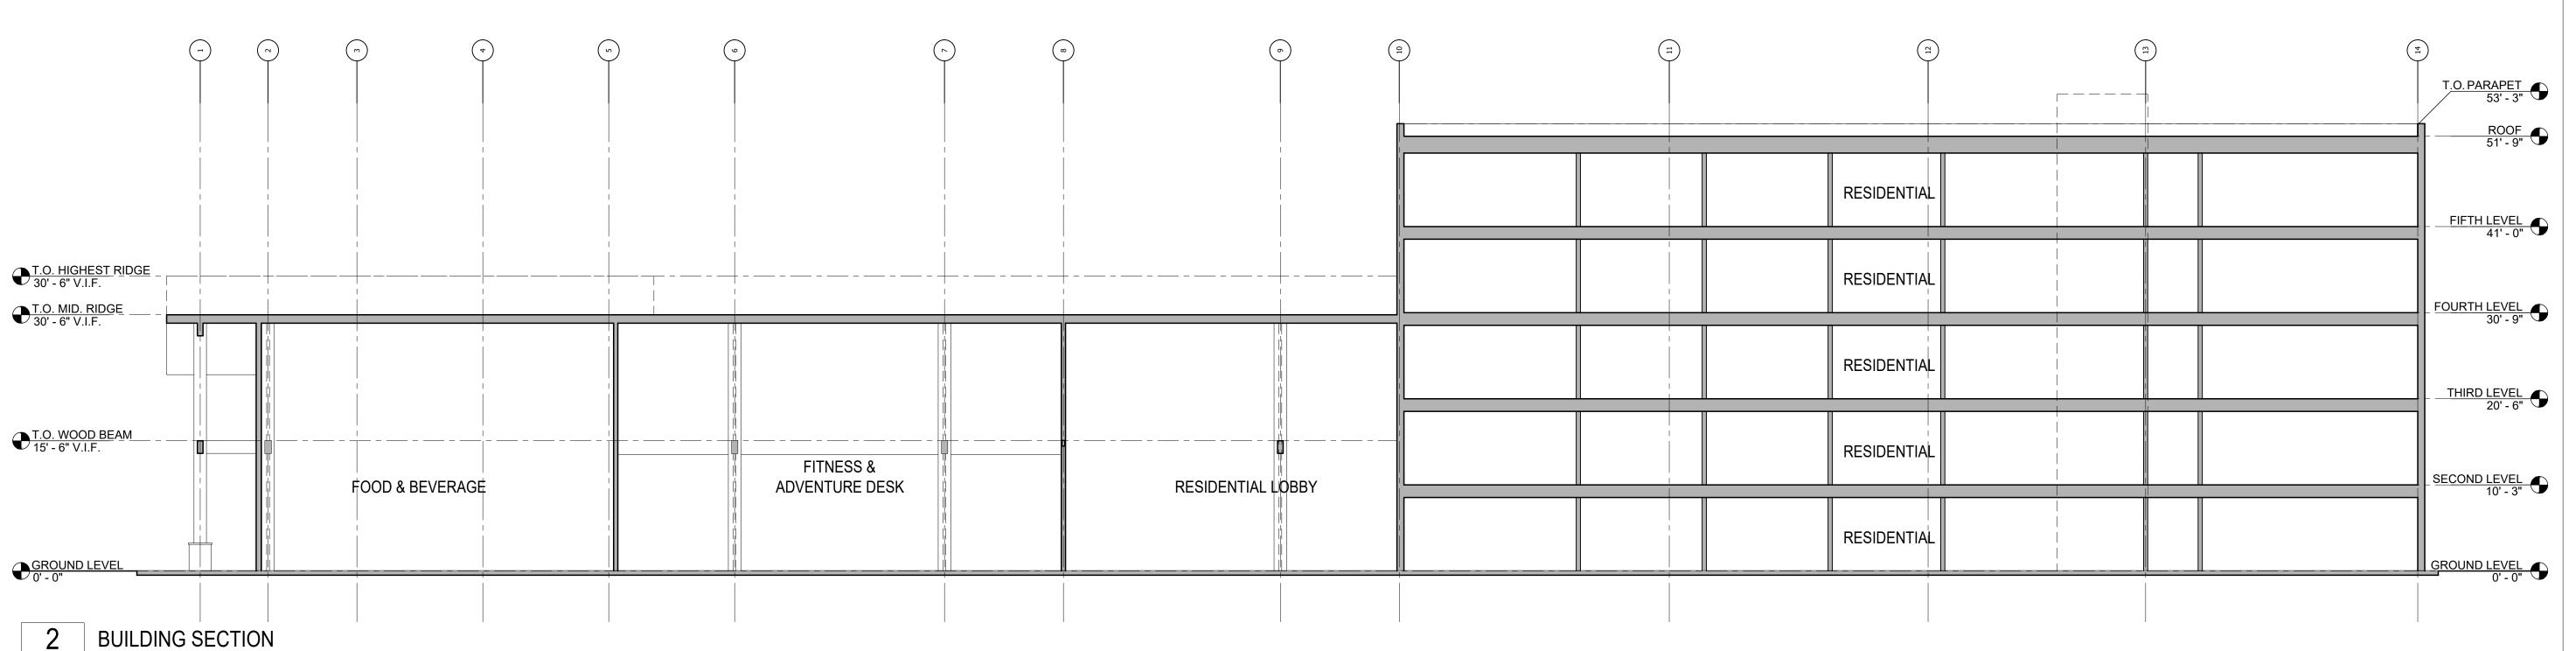

SCALE: 1:10

PEAK OF ROOF 35' - 1" V.I.F. T.O. RIDGE 30' - 6" V.I.F. T.O. STEEL BEAM 14' - 10 1/2" V.I.F. FITNESS & ADVENTURE DESK GROUND LEVEL 0' - 0" **BUILDING SECTION** SCALE: 1:10

3 6/17/2021 Development Plan Submittal 2 4/19/2021 Development Plan Submittal 1 3/27/2020 Development Plan Submittal Description SUBMISSIONS & REVISIONS

APPROVAL STAMPS:

May Riegler Properties 2201 Wisconsin Avenue NW Suite 200 Washington, DC 20007 PO Box 881330 Steamboat Springs, CO 80488

ARCHITECT



www.kasa-arch.com STRUCTURAL ENGINEER

M.E.P. & F.P. ENGINEERS

CIVIL ENGINEER

LANDMARK CONSULTANTS, INC. 141 9th Street PO Box 774943 Steamboat Springs, Colorado 80477 T.970.871.9494

LANDSCAPE ARCHITECT

MGC DESIGN, INC. PO Box 773522 Steamboat Springs, Colorado 80477 T.970.879.7740

GENERAL CONTRACTOR

PROJECT LOCATION Steamboat Basecamp

1901 Curve Plaza Steamboat Springs, CO DRAWING TITLE

> PROPOSED BUILDING

SECTIONS DATE: 04/16/21 DRAWN BY: CHECKED BY: PROJECT NO:

DRAWING NO:

A3.2



PERSPECTIVE RENDERING

SCALE: N.T.S.

APPROVAL STAMPS:

5 6/17/2021 Development Plan Submittal #5 4 4/19/2021 Development Plan Submittal #4 3 10/14/2020 Development Plan Submittal #3 2 7/9/2020 Development Plan Submittal #2 1 3/27/2020 Development Plan Submittal

Description

SUBMISSIONS & REVISIONS

OWNER

No. Date

May Riegler Properties
2201 Wisconsin Avenue NW Suite 200
Washington, DC 20007
PO Box 881330 Steamboat Springs, CO 80488

ARCHITECT



3318 N. Columbus Street Arlington, VA 22207 T.312.636.3248 / 312.636.4252 www.kasa-arch.com

STRUCTURAL ENGINEER

M.E.P. & F.P. ENGINEERS

CIVIL ENGINEER

LANDMARK CONSULTANTS, INC. 141 9th Street PO Box 774943 Steamboat Springs, Colorado 80477 T.970.871.9494

LANDSCAPE ARCHITECT

MGC DESIGN, INC. PO Box 773522 Steamboat Springs, Colorado 80477 T.970.879.7740

GENERAL CONTRACTOR

PROJECT LOCATION

Steamboat Basecamp

1901 Curve Plaza Steamboat Springs, CO DRAWING TITLE

> PROPOSED PERSPECTIVE RENDERING

03/27/20 DRAWN BY:

PROJECT NO:

CHECKED BY:

DRAWING NO:



PERSPECTIVE RENDERING

SCALE: N.T.S.

APPROVAL STAMPS:

5 6/17/2021 Development Plan Submittal #5 4 4/19/2021 Development Plan Submittal #4 3 10/14/2020 Development Plan Submittal #3 2 7/9/2020 Development Plan Submittal #2 1 3/27/2020 Development Plan Submittal

Description

SUBMISSIONS & REVISIONS

OWNER

No. Date

May Riegler Properties
2201 Wisconsin Avenue NW Suite 200
Washington, DC 20007
PO Box 881330 Steamboat Springs, CO 80488



3318 N. Columbus Street Arlington, VA 22207 T.312.636.3248 / 312.636.4252 www.kasa-arch.com

STRUCTURAL ENGINEER

M.E.P. & F.P. ENGINEERS

CIVIL ENGINEER

LANDMARK CONSULTANTS, INC. 141 9th Street PO Box 774943 Steamboat Springs, Colorado 80477 T.970.871.9494

LANDSCAPE ARCHITECT

MGC DESIGN, INC. PO Box 773522 Steamboat Springs, Colorado 80477 T.970.879.7740

GENERAL CONTRACTOR

PROJECT LOCATION

Steamboat Basecamp

1901 Curve Plaza Steamboat Springs, CO

DRAWING TITLE PROPOSED

PERSPECTIVE RENDERING

03/27/20 DRAWN BY:

> CHECKED BY: PROJECT NO:

DRAWING NO:



PERSPECTIVE RENDERING

SCALE: N.T.S.

APPROVAL STAMPS:

5 6/17/2021 Development Plan Submittal #5 4 4/19/2021 Development Plan Submittal #4 3 10/14/2020 Development Plan Submittal #3 2 7/9/2020 Development Plan Submittal #2 1 3/27/2020 Development Plan Submittal

SUBMISSIONS & REVISIONS

Description

OWNER

No. Date

May Riegler Properties
2201 Wisconsin Avenue NW Suite 200
Washington, DC 20007
PO Box 881330 Steamboat Springs, CO 80488



3318 N. Columbus Street Arlington, VA 22207 T.312.636.3248 / 312.636.4252 www.kasa-arch.com

STRUCTURAL ENGINEER

M.E.P. & F.P. ENGINEERS

CIVIL ENGINEER

LANDMARK CONSULTANTS, INC. 141 9th Street PO Box 774943 Steamboat Springs, Colorado 80477 T.970.871.9494

LANDSCAPE ARCHITECT

MGC DESIGN, INC. PO Box 773522 Steamboat Springs, Colorado 80477 T.970.879.7740

GENERAL CONTRACTOR

PROJECT LOCATION

Steamboat Basecamp

1901 Curve Plaza Steamboat Springs, CO DRAWING TITLE

PROPOSED PERSPECTIVE RENDERING

03/27/20 DRAWN BY:

CHECKED BY:

PROJECT NO:

DRAWING NO:



PERSPECTIVE RENDERING SCALE: N.T.S.

APPROVAL STAMPS:

5 6/17/2021 Development Plan Submittal #5 4 4/19/2021 Development Plan Submittal #4

2 7/9/2020 Development Plan Submittal #2 1 3/27/2020 Development Plan Submittal No. Date Description

SUBMISSIONS & REVISIONS

3 10/14/2020 Development Plan Submittal #3

OWNER

May Riegler Properties 2201 Wisconsin Avenue NW Suite 200 Washington, DC 20007 PO Box 881330 Steamboat Springs, CO 80488

ARCHITECT

KEVIN & ASAKO SPERRY ARCHITECTURE 3318 N. Columbus Street Arlington, VA 22207 T.312.636.3248 / 312.636.4252 www.kasa-arch.com

STRUCTURAL ENGINEER

M.E.P. & F.P. ENGINEERS

CIVIL ENGINEER

LANDMARK CONSULTANTS, INC. 141 9th Street PO Box 774943 Steamboat Springs, Colorado 80477 T.970.871.9494

LANDSCAPE ARCHITECT

MGC DESIGN, INC. PO Box 773522 Steamboat Springs, Colorado 80477 T.970.879.7740

GENERAL CONTRACTOR

PROJECT LOCATION

Steamboat Basecamp

1901 Curve Plaza Steamboat Springs, CO DRAWING TITLE

> PROPOSED PERSPECTIVE RENDERING

03/27/20 DRAWN BY:

> CHECKED BY: PROJECT NO:

DRAWING NO:



PERSPECTIVE RENDERING SCALE: N.T.S.

5 6/17/2021 Development Plan Submittal #5 4 4/19/2021 Development Plan Submittal #4 3 10/14/2020 Development Plan Submittal #3 2 7/9/2020 Development Plan Submittal #2 1 3/27/2020 Development Plan Submittal No. Date SUBMISSIONS & REVISIONS OWNER May Riegler Properties
2201 Wisconsin Avenue NW Suite 200
Washington, DC 20007
PO Box 881330 Steamboat Springs, CO 80488 ARCHITECT KEVIN & ASAKO SPERRY ARCHITECTURE 3318 N. Columbus Street Arlington, VA 22207 T.312.636.3248 / 312.636.4252 www.kasa-arch.com STRUCTURAL ENGINEER M.E.P. & F.P. ENGINEERS CIVIL ENGINEER

Description

APPROVAL STAMPS:

LANDMARK CONSULTANTS, INC. 141 9th Street PO Box 774943 Steamboat Springs, Colorado 80477 T.970.871.9494

LANDSCAPE ARCHITECT

MGC DESIGN, INC. PO Box 773522 Steamboat Springs, Colorado 80477 T.970.879.7740

GENERAL CONTRACTOR

PROJECT LOCATION Steamboat

Basecamp

1901 Curve Plaza Steamboat Springs, CO DRAWING TITLE


PROPOSED PERSPECTIVE RENDERING

03/27/20 DRAWN BY:

> CHECKED BY: PROJECT NO:

> > COPYRIGHT 2019

DRAWING NO:

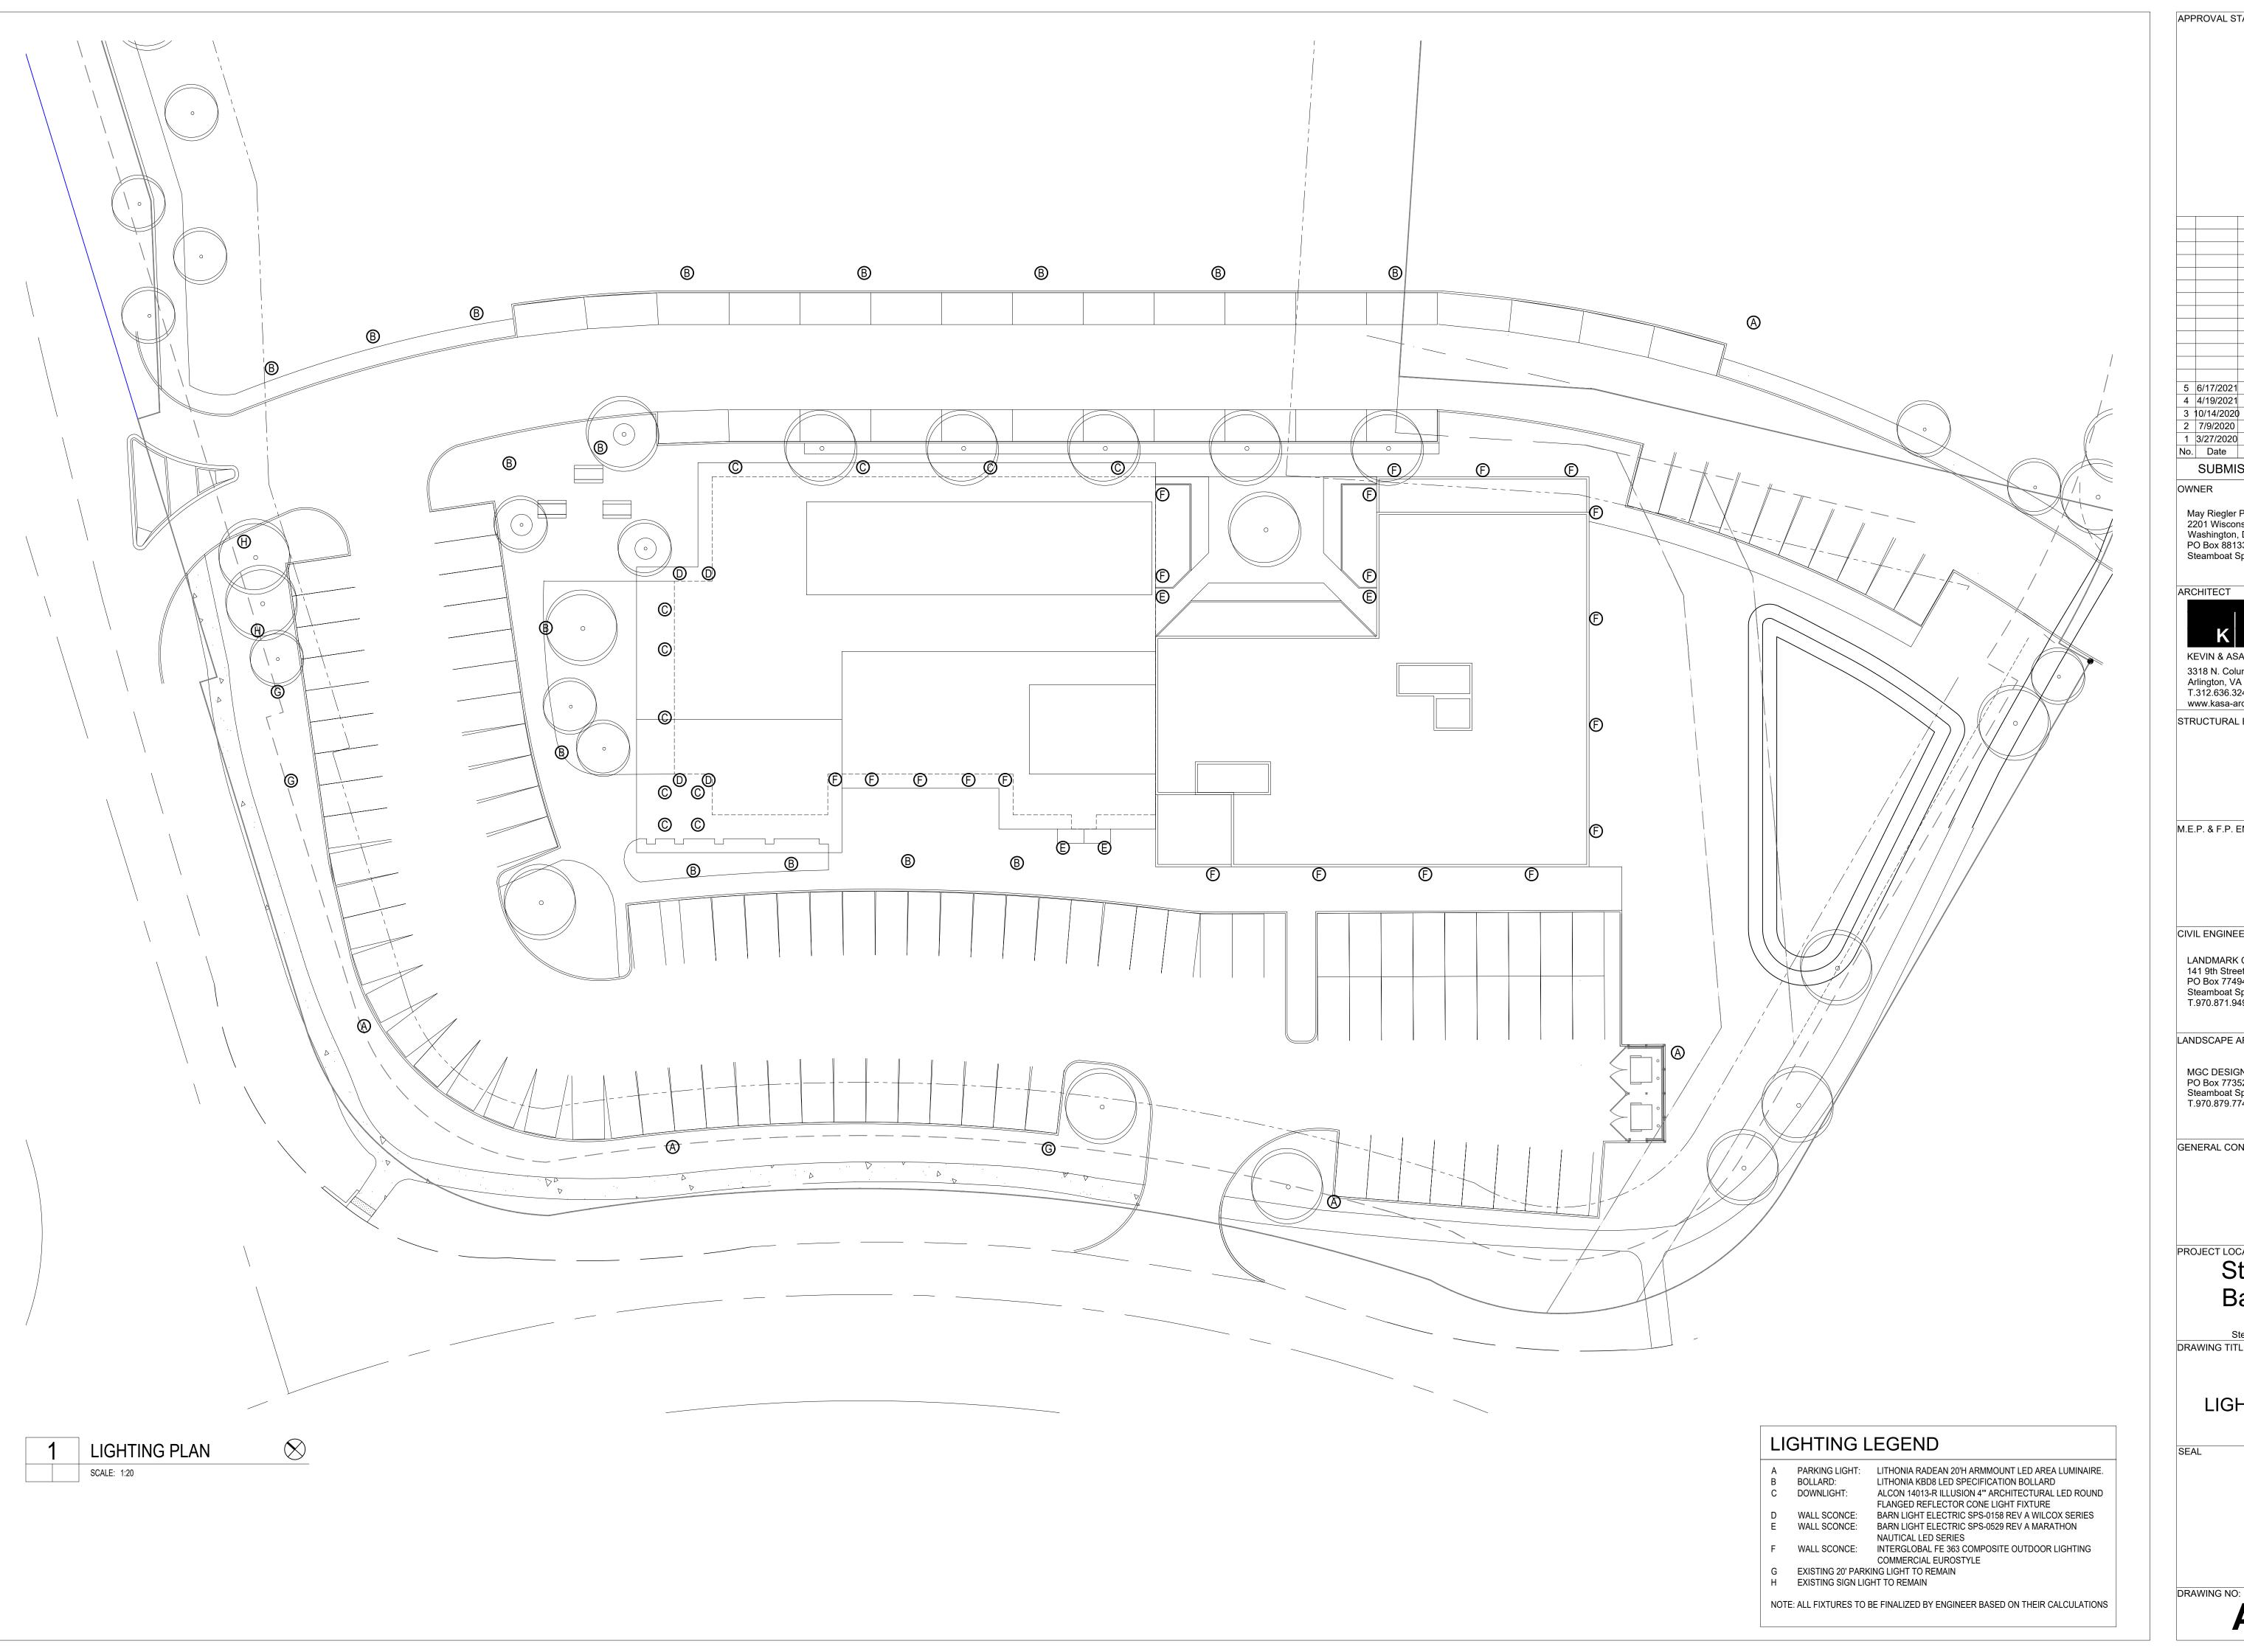


APPROVAL STAMPS: 5 6/17/2021 Development Plan Submittal #5 4 4/19/2021 Development Plan Submittal #4 3 10/14/2020 Development Plan Submittal #3 2 7/9/2020 Development Plan Submittal #2 1 3/27/2020 Development Plan Submittal No. Date Description SUBMISSIONS & REVISIONS OWNER May Riegler Properties 2201 Wisconsin Avenue NW Suite 200 Washington, DC 20007 PO Box 881330 Steamboat Springs, CO 80488 ARCHITECT KEVIN & ASAKO SPERRY ARCHITECTURE 3318 N. Columbus Street Arlington, VA 22207 T.312.636.3248 / 312.636.4252 www.kasa-arch.com STRUCTURAL ENGINEER M.E.P. & F.P. ENGINEERS CIVIL ENGINEER LANDMARK CONSULTANTS, INC. 141 9th Street PO Box 774943 Steamboat Springs, Colorado 80477 T.970.871.9494 LANDSCAPE ARCHITECT MGC DESIGN, INC. PO Box 773522 Steamboat Springs, Colorado 80477 T.970.879.7740 GENERAL CONTRACTOR PROJECT LOCATION Steamboat Basecamp 1901 Curve Plaza Steamboat Springs, CO DRAWING TITLE LIGHTING PLAN

DATE:
03/27/20
DRAWN BY:


CHECKED BY:


PROJECT NO:


A5.0

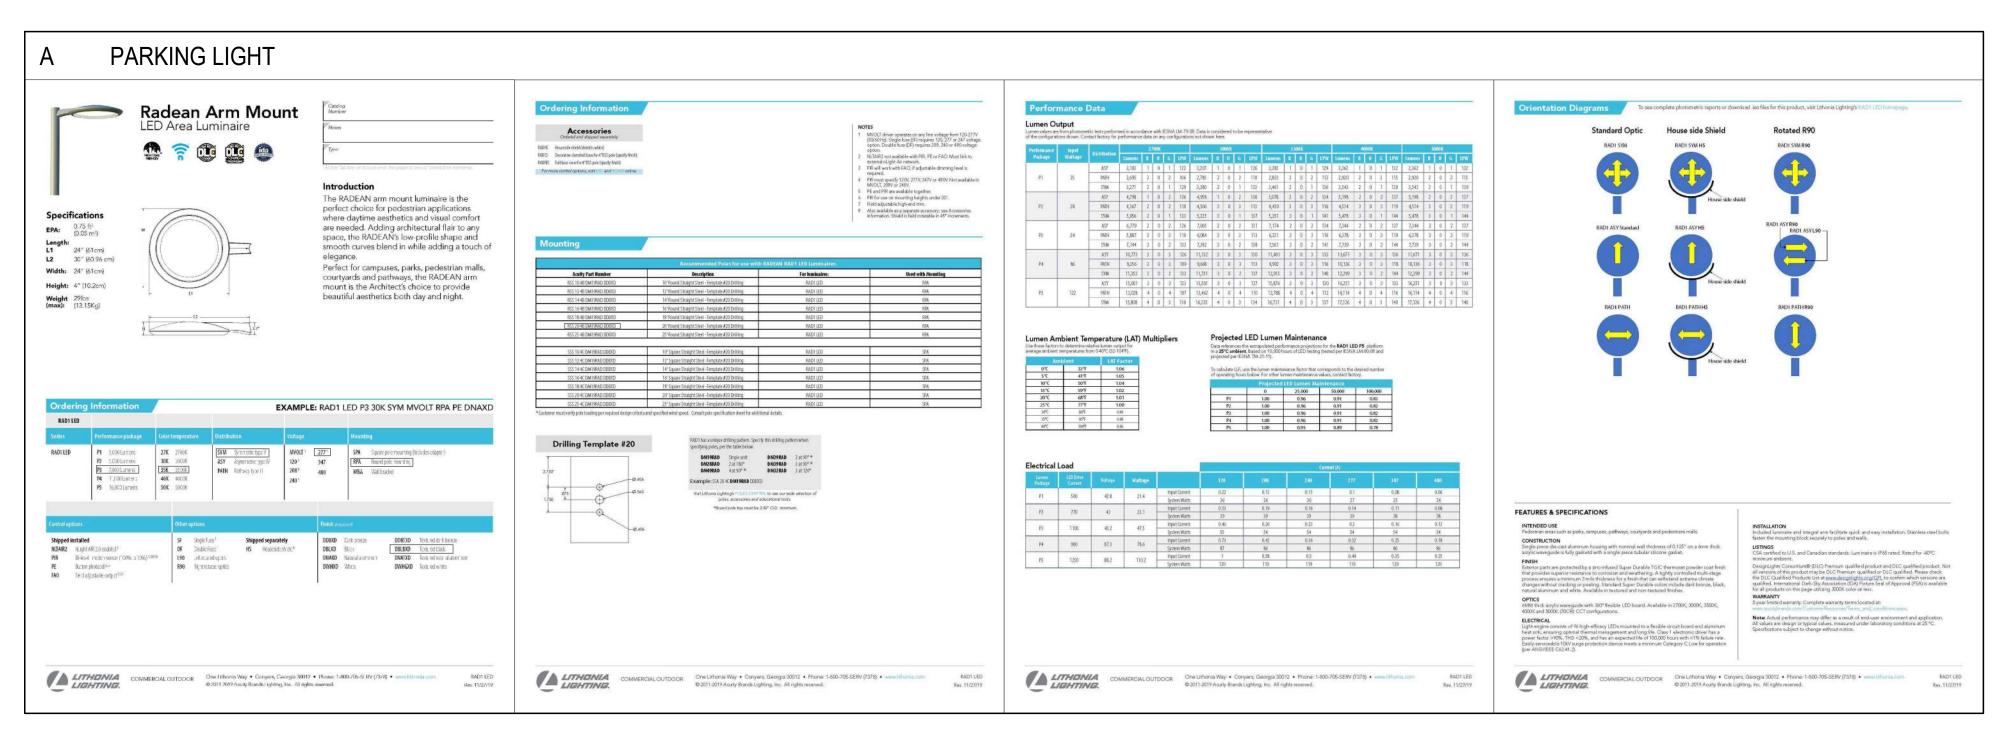




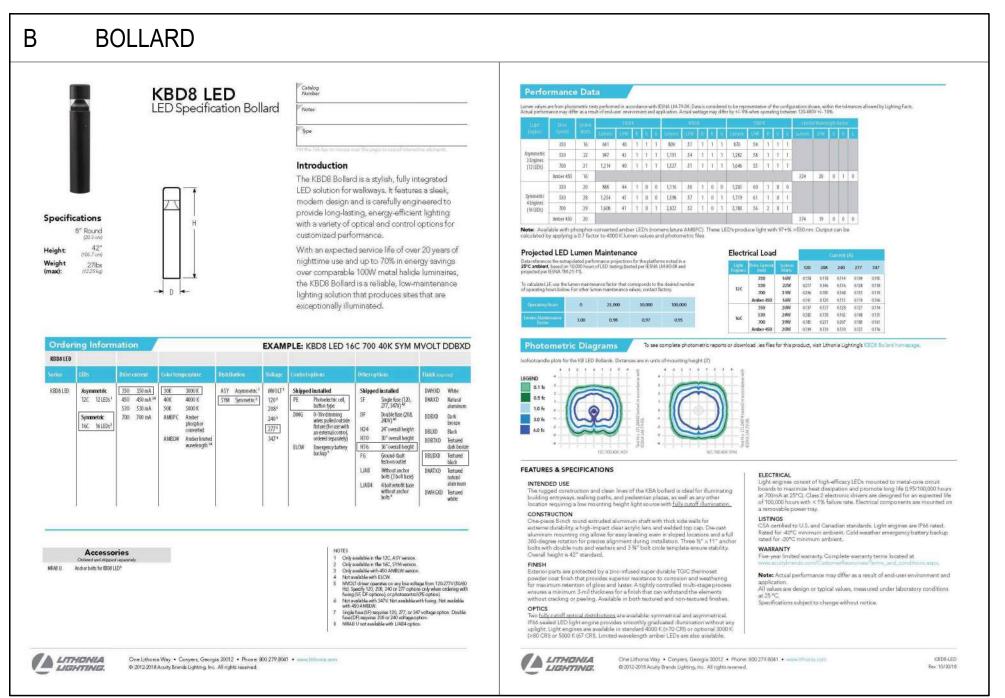

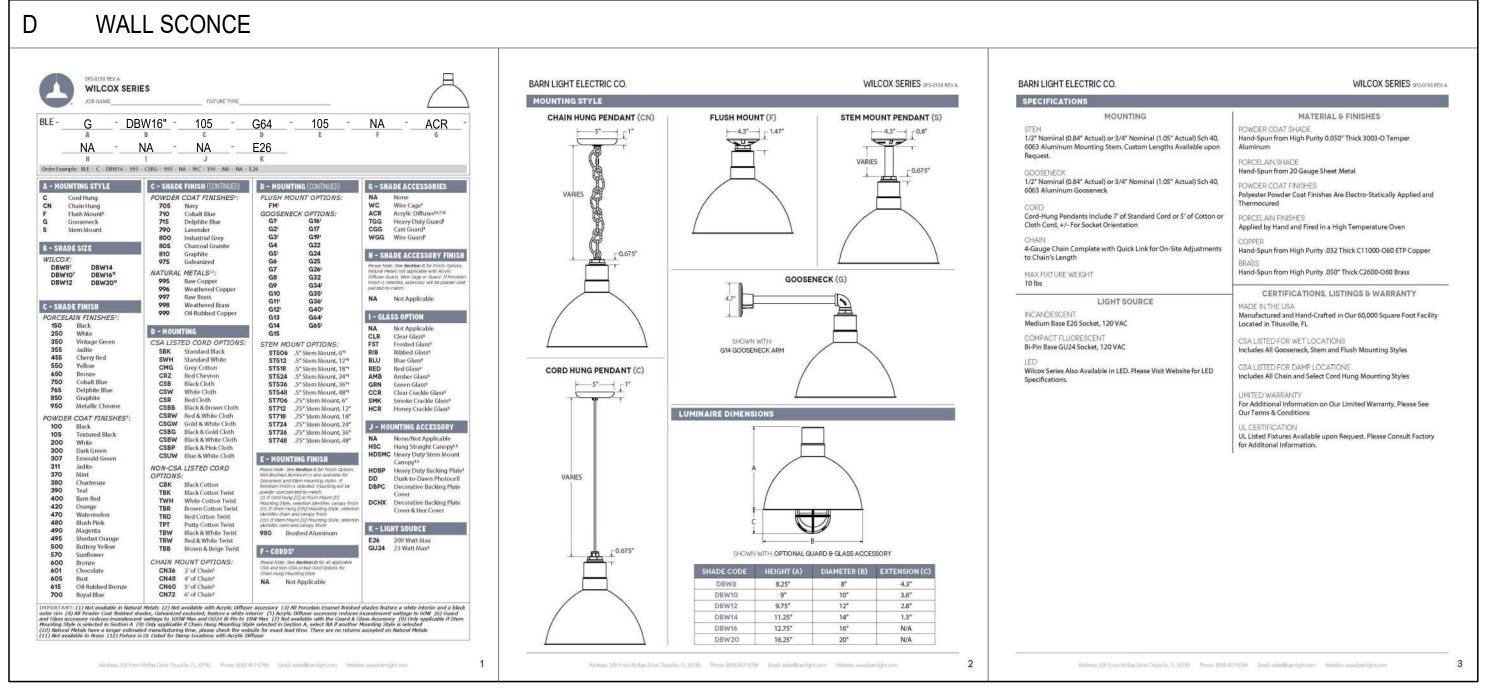

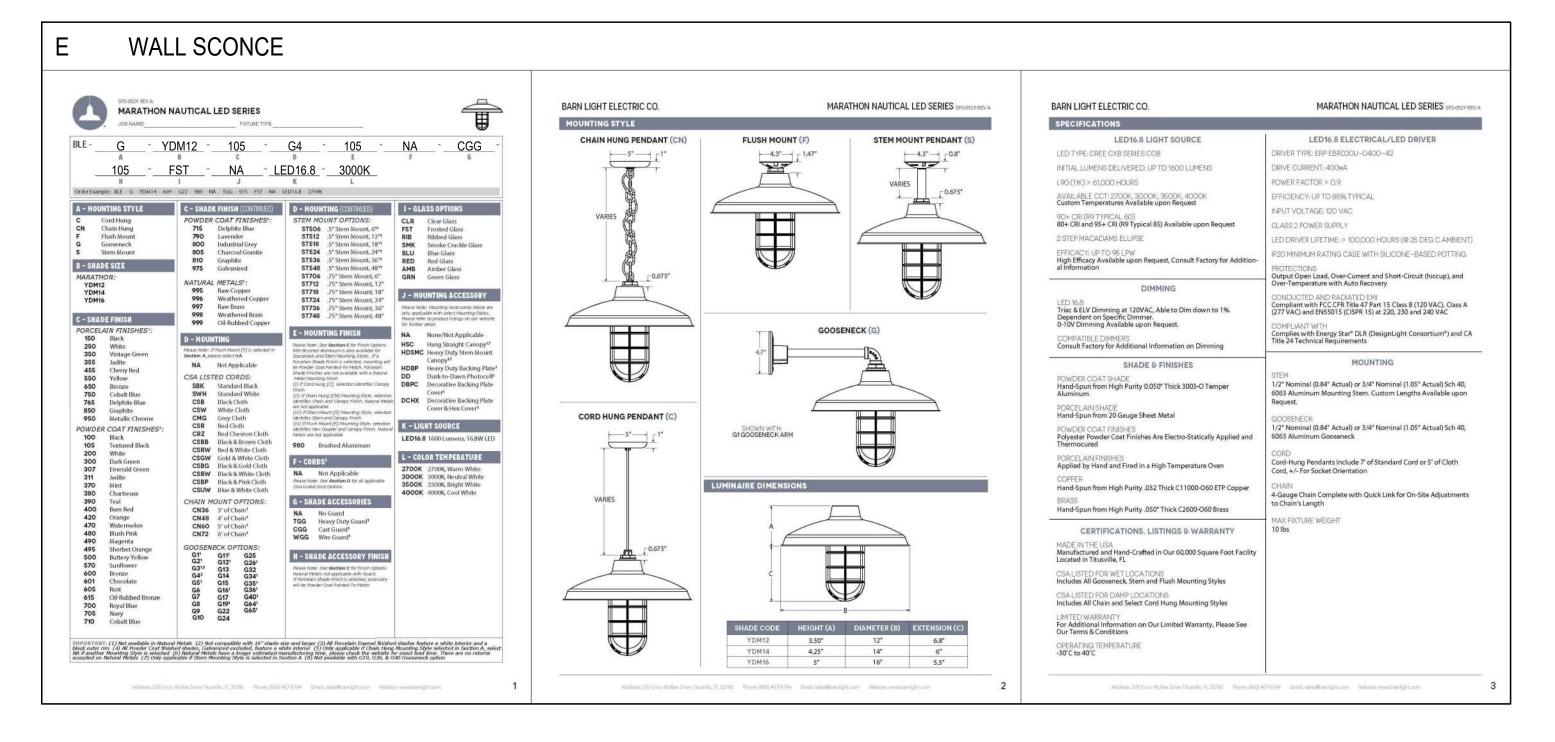

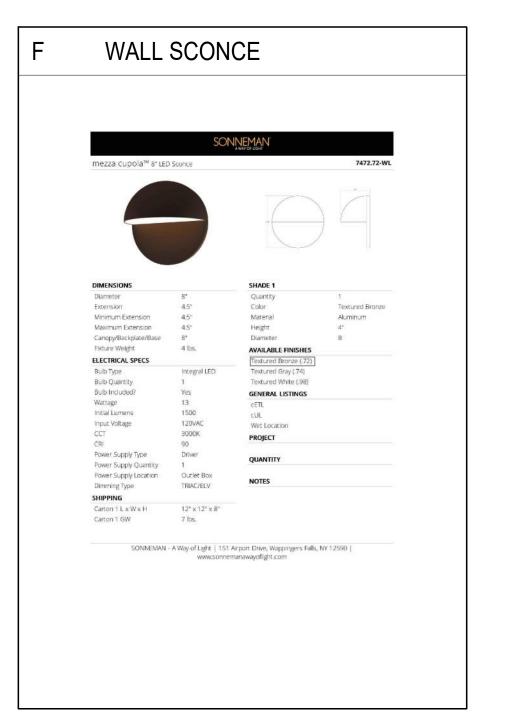

NOTE: ALL FIXTURES TO BE FINALIZED BY ENGINEER BASED ON THEIR CALCULATIONS

5 6/17/2021 Development Plan Submittal #5
4 4/19/2021 Development Plan Submittal #4
3 10/14/2020 Development Plan Submittal #3
2 7/9/2020 Development Plan Submittal #2
1 3/27/2020 Development Plan Submittal #2
No. Date Description
SUBMISSIONS & REVISIONS
OWNER

APPROVAL STAMPS:

:R

May Riegler Properties
2201 Wisconsin Avenue NW Suite 200
Washington, DC 20007
PO Box 881330
Steamboat Springs, CO 80488

ARCHITECT



3318 N. Columbus Street
Arlington, VA 22207
T.312.636.3248 / 312.636.4252
www.kasa-arch.com

STRUCTURAL ENGINEER

M.E.P. & F.P. ENGINEERS

CIVIL ENGINEER

LANDMARK CONSULTANTS, INC. 141 9th Street PO Box 774943 Steamboat Springs, Colorado 80477 T.970.871.9494

LANDSCAPE ARCHITECT

MGC DESIGN, INC. PO Box 773522 Steamboat Springs, Colorado 80477 T.970.879.7740

GENERAL CONTRACTOR

PROJECT LOCATION


Steamboat Basecamp

1901 Curve Plaza Steamboat Springs, CO DRAWING TITLE

> LIGHTING SPECIFICATIONS


> > DATE:
> > 03/27/20
> >
> > DRAWN BY:
> >
> > CHECKED BY:
> >
> > PROJECT NO:


DRAWING NO:
A5.1

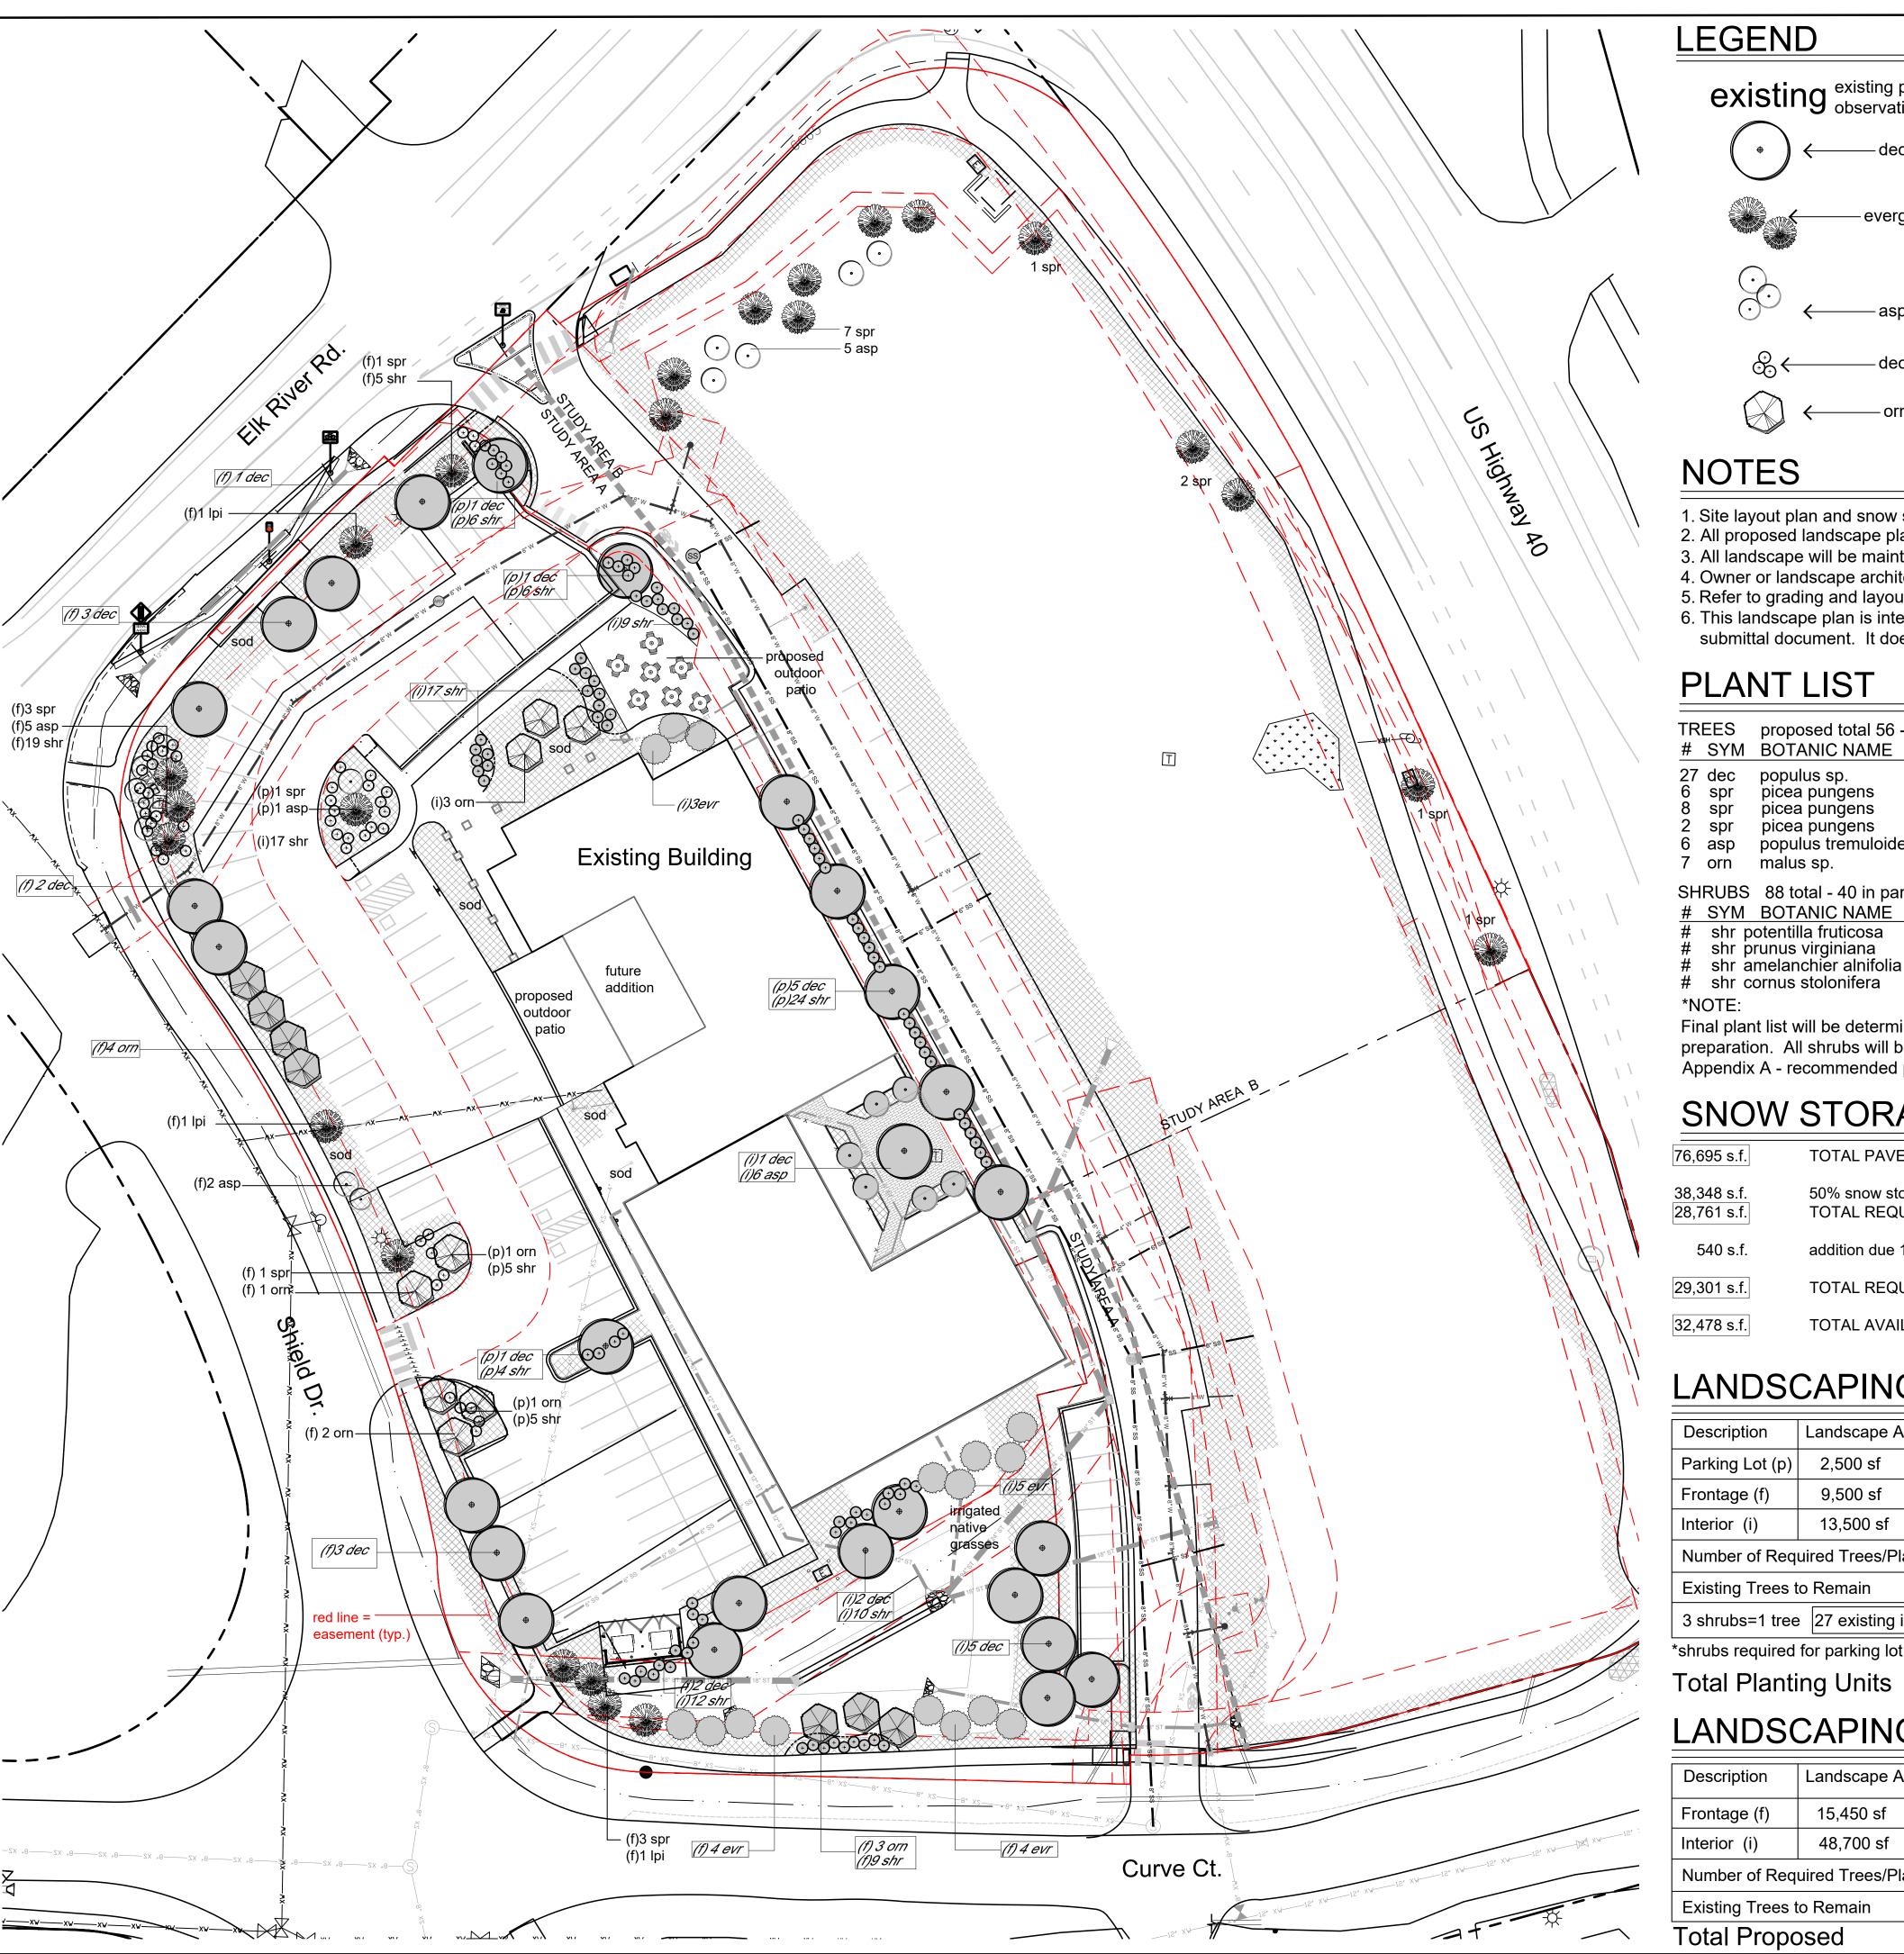

LEGEND

existing existing plants are per field observation - not survey

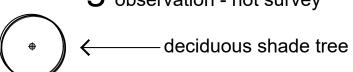

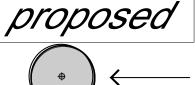












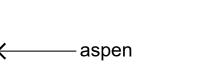

ornamental tree



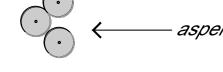

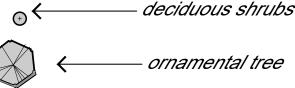

NOTES

- 1. Site layout plan and snow storage calculations provided by Landmark Consultants Inc.
- 2. All proposed landscape plantings will be under an automatic irrigation system.
- 3. All landscape will be maintained in a professional manner to industry standard.
- 4. Owner or landscape architect to approve layout of all proposed work prior to installation.
- 5. Refer to grading and layout and materials plans for additional information on all proposed work.
- 6. This landscape plan is intended only as a City of Steamboat Springs planning submittal document. It does not contain the necessary information for construction.

PLANT LIST

TREES proposed total 56 - 27 large	e deciduous, 16 evergreen,13 asp	en/ornamenta
# SYM BOTANIC NAME	COMMON NAME	SIZE
27 dec populus sp. 6 spr picea pungens 8 spr picea pungens 2 spr picea pungens 6 asp populus tremuloides 7 orn malus sp.	cottonwood colorado spruce colorado spruce colorado spruce quaking aspen ornamental crabtree	2.5" cal. 6'-7' ht. 8'-9' ht. 10' ht 2" cal. 2" cal.
SHRUBS 88 total - 40 in parking lot,	48 shrub for tree substitution	
# SYM BOTANIC NAME	COMMON NAME	SIZE
# chr notontilla fruticaca	nativo vallow natantilla	<u> </u>

shr potentilla fruticosa# shr prunus virginiana# shr amelanchier alnifolia native yellow potentilla native chokecherry saskatoon serviceberry # shr cornus stolonifera colorado dogwood

Final plant list will be determined at time of construction document

preparation. All shrubs will be low water usage plants and be within Appendix A - recommended plant list - in the Community Development Code.

SNOW STORAGE CALCULATIONS

TOTAL PAVED AREA

38,348 s.f.

50% snow storage requirement TOTAL REQUIRED (after 25% reduction for elevation) 28,761 s.f.

addition due 18 evergreen trees in storage areas

TOTAL AVAILABLE

TOTAL REQUIRED 29,301 s.f.

LANDSCAPING STANDARDS TABLE - STUDY AREA A

Description	Landscape Area	CS Zone district Requirements	Required	Existing	Proposed	Evr Tree		Dec Tree		Orn Tree	
Parking Lot (p)	2,500 sf	1 tree/200sf + 4 shrubs/200sf	12/50*	4/10	8/40*	1	0	0	8	3	0
Frontage (f)	9,500 sf	Category EC - 1tree/200sf	48	21	24/3	11	8	0	8	10	7
Interior (i)	13,500 sf	Category EC3 - 1tree/500sf	27	3	24	0	8	0	11	3	6
Number of Required Trees/Planting Units		87				•					
Existing Trees to Remain				28							
3 shrubs=1 tree 27 existing in frontage=0 trees 48 proposed= int. 16 trees				0	16						
*shrubs required for parking lot landscape not a part of shrub for tree substitution		on	28	59							

LANDSCAPING STANDARDS TABLE - STUDY AREA B

Description	Landscape Area	CS Zone district Requirements	Required	Existing	Proposed	Evr Tree		Dec Tree			Tree
Frontage (f)	15,450 sf	Category EC - 1tree/200sf	77	17	0	12		0	0	0	5
Interior (i)	48,700 sf	Category EC3 - 1tree/500sf	97	0	0	7	0	0	0	6	0
Number of Req	uired Trees/Planting Units		174								
Existing Trees	to Remain			17							
Total Prond	need				Ω					•	

date 4-9-2020 city submittal rev. 7-14-2020 city submittal rev. 4-20-21

city submittal

city submittal


rev. 6-18-21

rev. 6-23-21 city submittal

> plan landscap

Steamboat Steamboat



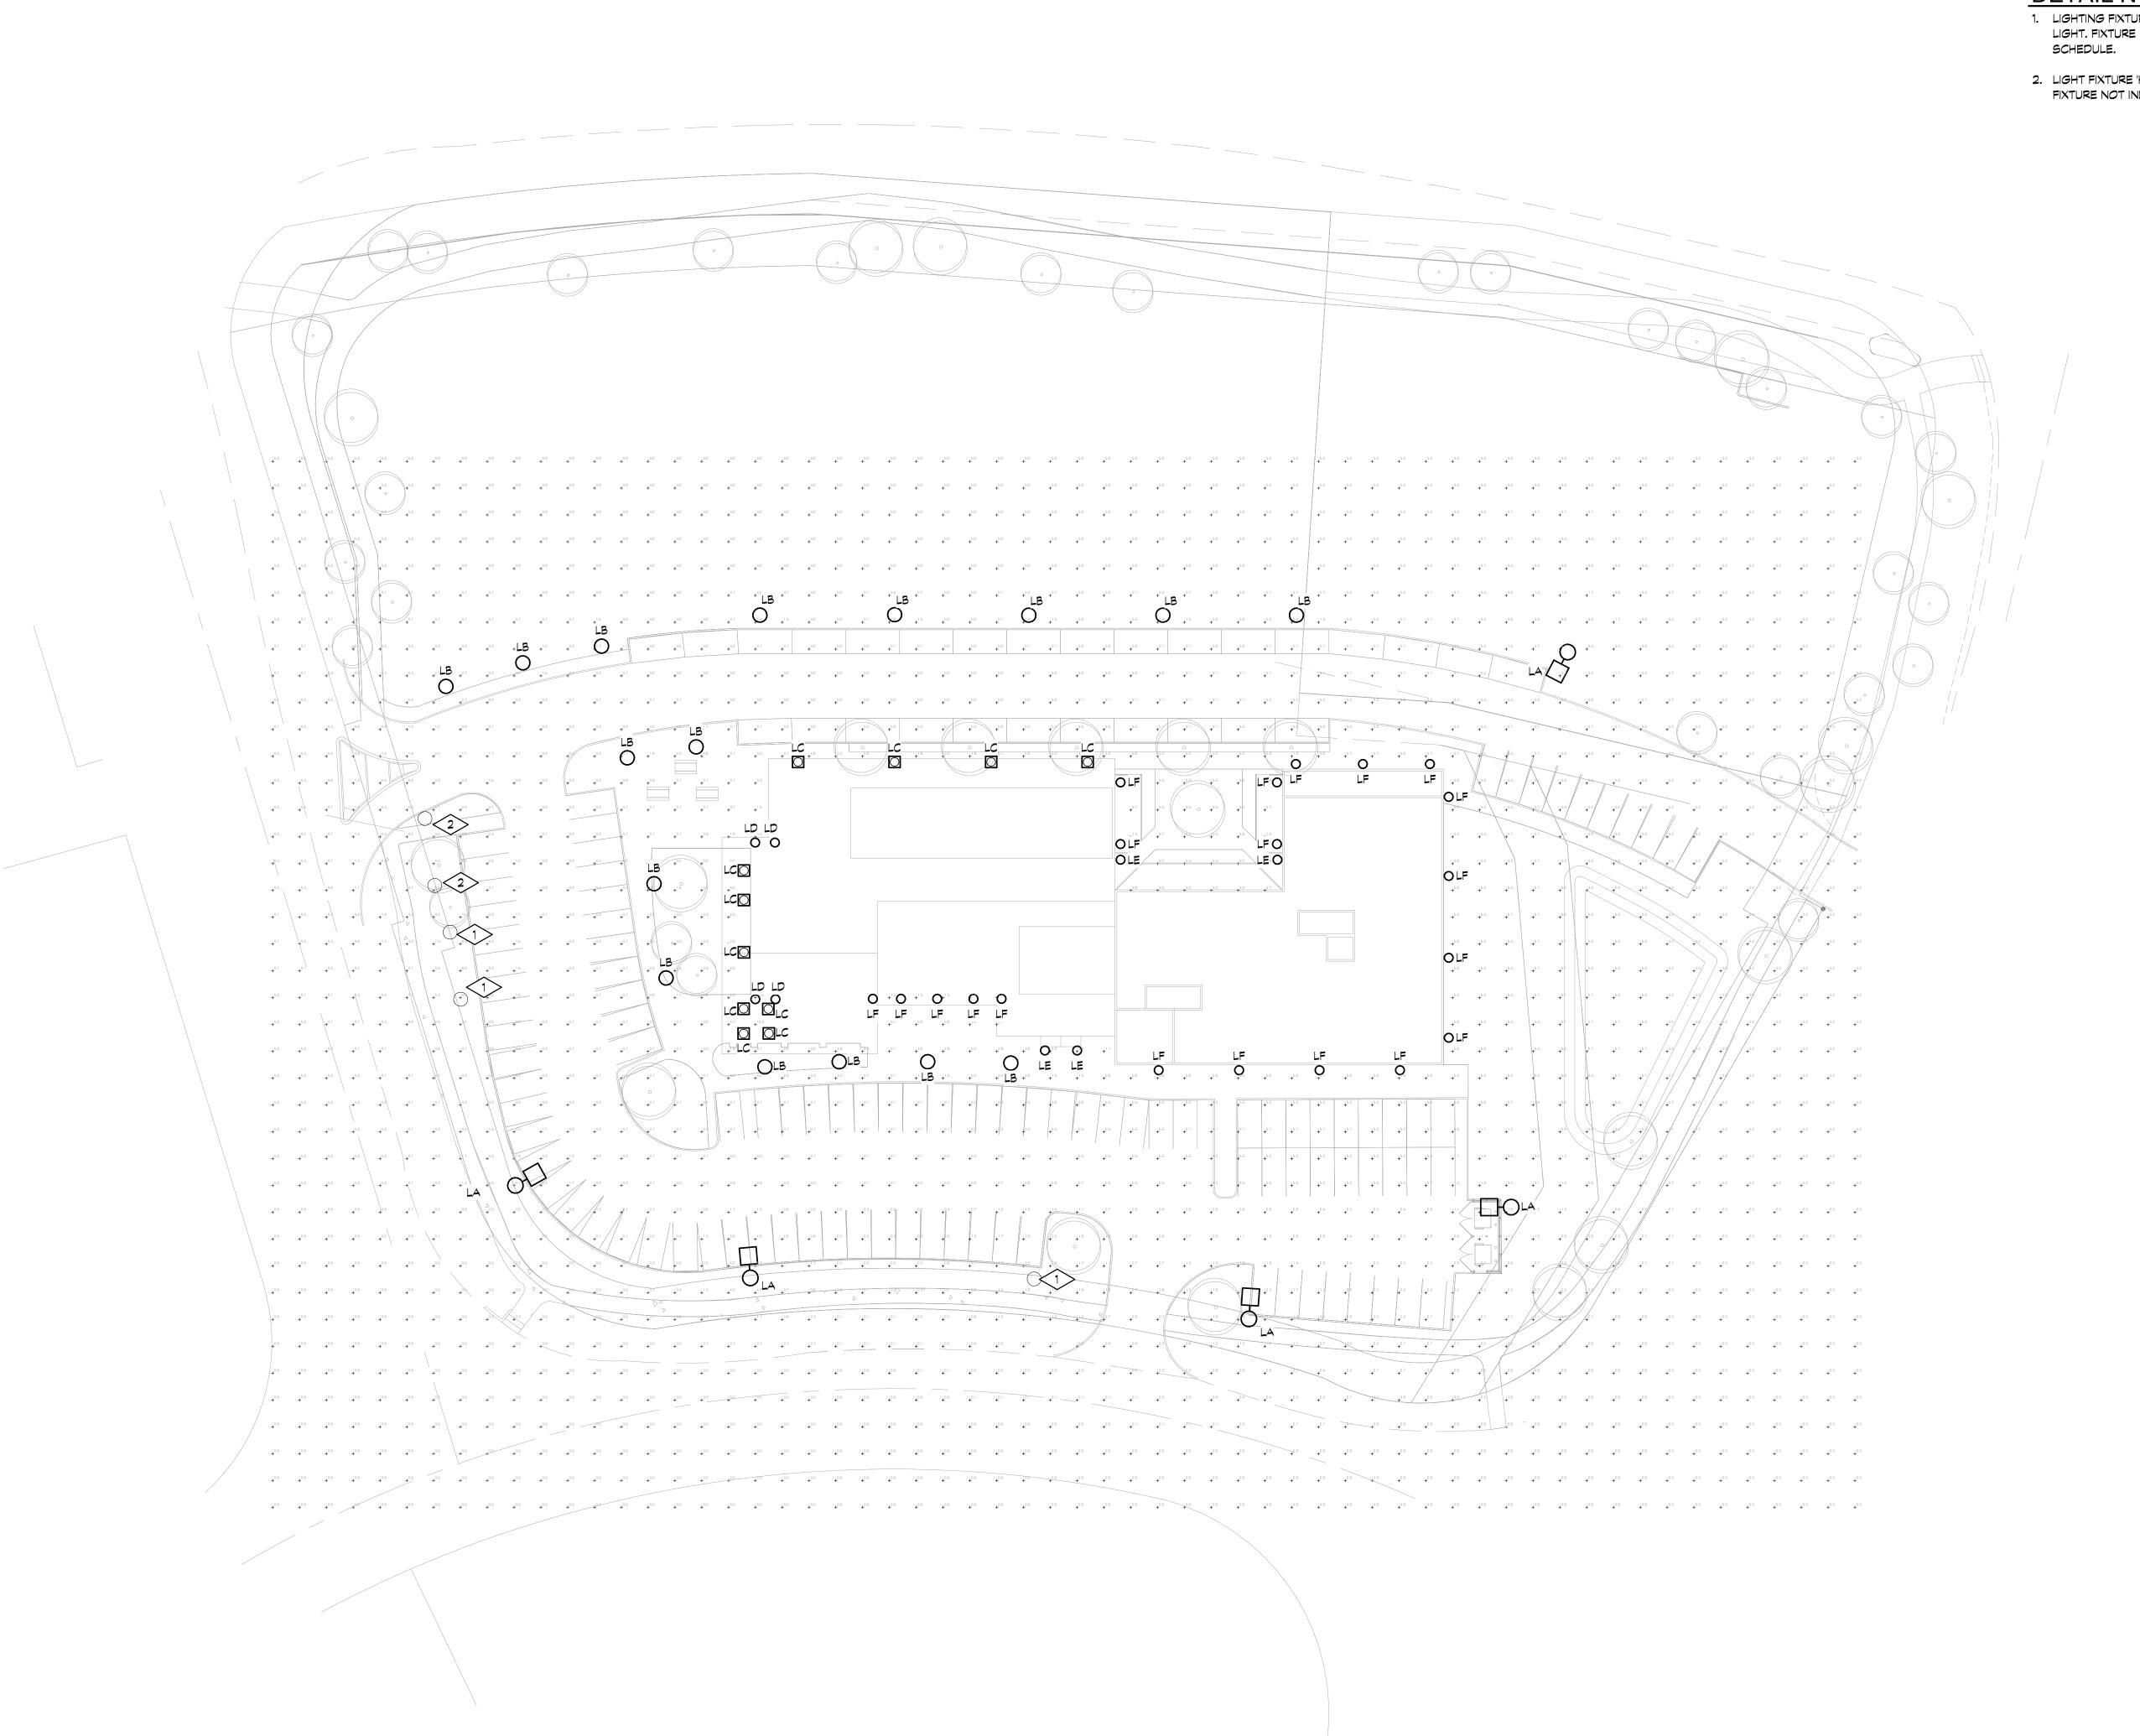

PHOTOMETRIC SITE PLAN

DETAIL NOTES THIS SHEET

 LIGHTING FIXTURE 'G' IS EXISTING TO REMAIN PARKING LIGHT. FIXTURE NOT INDCLUDED IN LIGHTING FIXTURE SCHEDULE.

2. LIGHT FIXTURE 'H' IS EXISTING TO REMAIN SIGN LIGHT. FIXTURE NOT INDCLUDED IN LIGHTING FIXTURE SCHEDULE.




and electrical 1717 15th Street Boulder, CO 80302

303.444.6038 phone 303.442.1172 fax staff@boulderengineering.com

METRIC

No.DescriptionDate1Revision 1Date 1

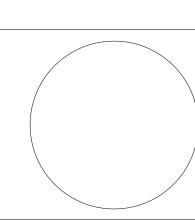



Issue PERMIT SET
Date 06.18.2021
Project Number 20061
Drawn by MOD
Checked by EM
Sheet
Title:
PHOTOMETRIC

SITE PLAN

Sheet Number

MEP 1

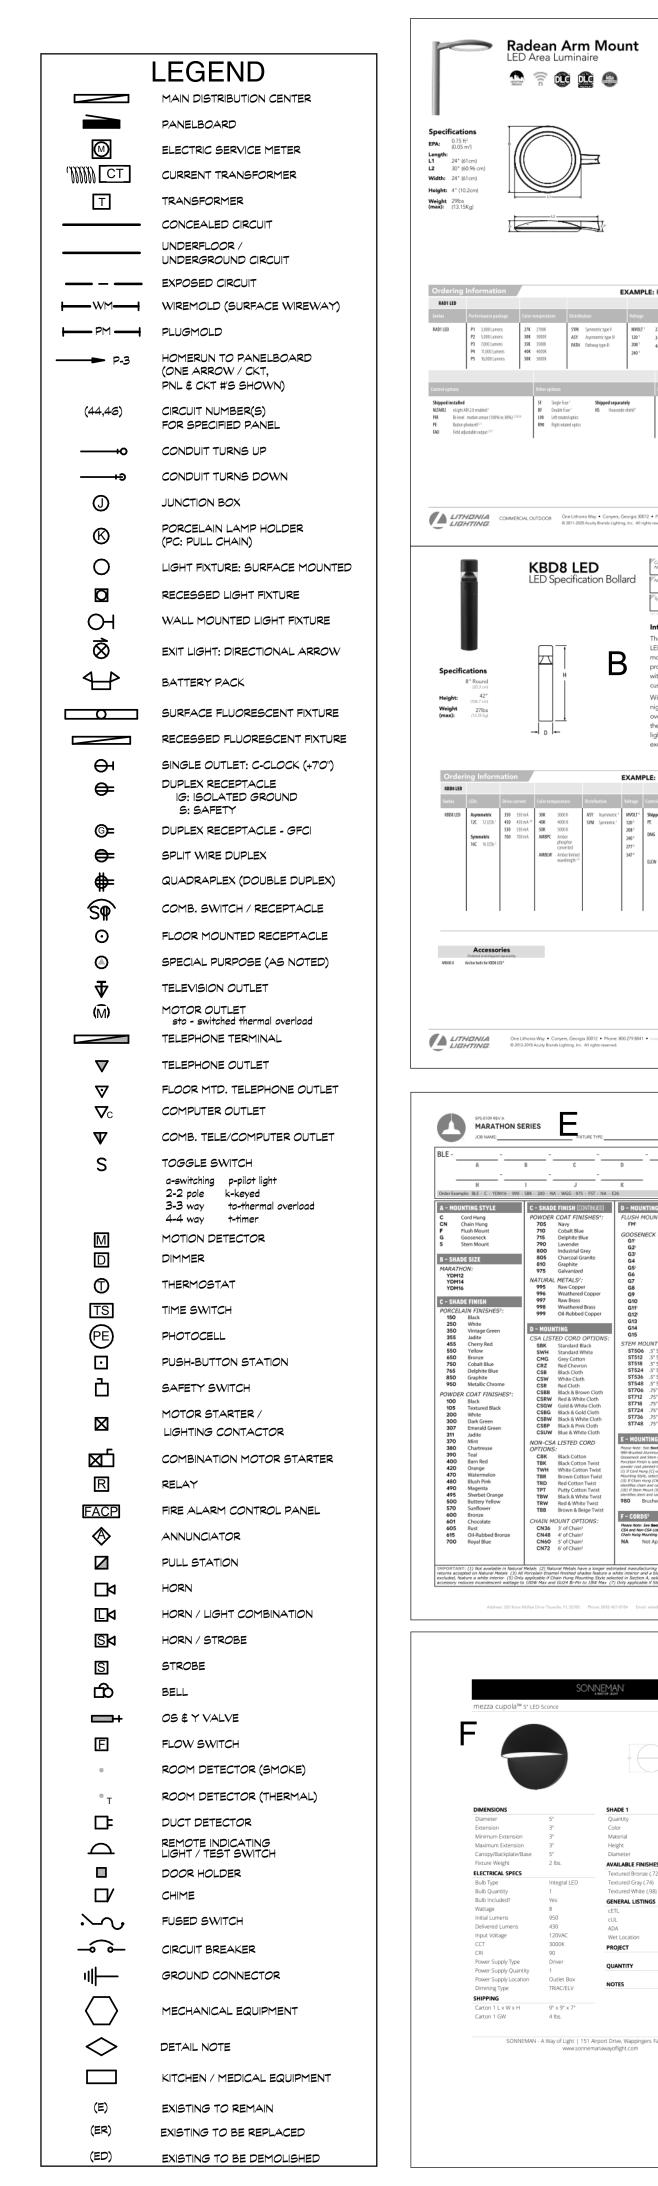

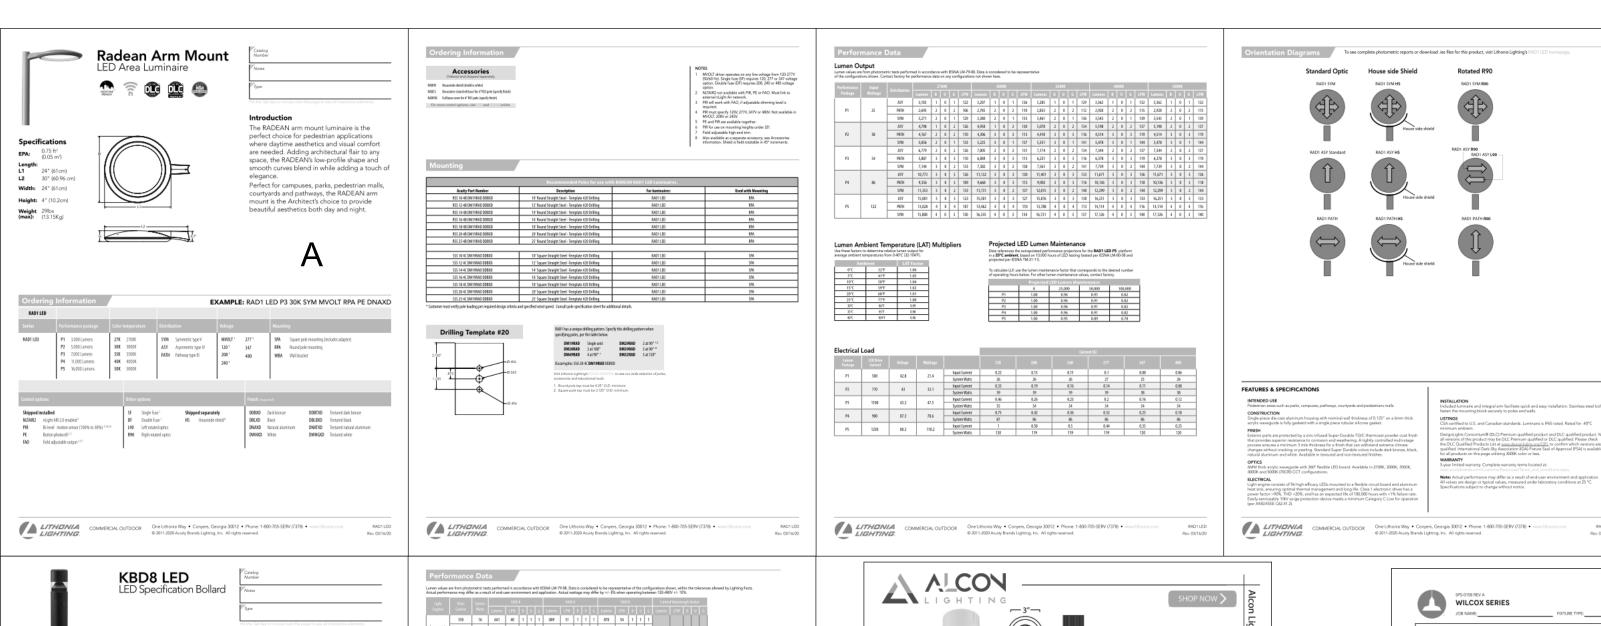

All values are design or typical values, measured under laboratory conditions

SHOWN WITH: OPTIONAL GUARD & GLASS ACCESSORY

SHADE CODE HEIGHT (A) DIAMETER (B) EXTENSION (C)

1/2" Nominal (0.84" Actual) or 3/4" Nominal (1.65" Actual) Sch 40, do603 Aluminum Mounting Stem. Custom Lengths Available upon Request.

Address: 320 Knox McRae Drive Titueville, FL 32780 Phone: (800) 407-8784 Email: sales@bamlight.com Website: www.bemlight.com

and-Spun from High Purity .050" Thick C2600-O60 Brass

ludes All Gooseneck, Stem and Flush Mounting Style

ludes All Chain and Select Cord Hung Mounting Style

anufactured and Hand-ocated in Titusville, FL

/2" Nominal (0.84" Actual) or 3/4" Nominal (1.05" Actual) Sch 40,

4-Gauge Chain Complete with Quick Link for On-Site Adjustments to Chain's Length

Medium Base E26 Socket, 120 VAC

LED solution for walkways. It features a sleek,

orovide long-lasting, energy-efficient lighting

with a variety of optical and control options f With an expected service life of over 20 years of

nighttime use and up to 70% in energy savings

over comparable 100W metal halide luminaire the KBD8 Bollard is a reliable, low-maintenan-lighting solution that produces sites that are

EXAMPLE: KBD8 LED 16C 700 40K SYM MVOLT DDBXI

Chija wallable in the 13C, ASY warsion.
Chija wallable in the 15C, SYM warsion.
Chija wallable with 15C, SYM warrion.
Chija wallable with ELC.W.
MNCCLI driven operation on any line sinchage from 133-277V (SIAMO Hol.) Speech (120, 25E, 284 or 277 options only when certaining stiff in options on any line sinchage from 133-277V (SIAMO Hol.) Speech (120, 25E, 284 or 277 options only when certaining stiff in options of photocontrol for potatol.
Nat revailable with 33TV. Not available with fautra, Nat available with 450 AMSILW.

Single fuse (SF) requires 120, 277, or 347 voltage option. Double fuse (DF) requires 206 or 240 voltage option.

MRAB U not available with L/AB4 option.

NA Not Applicable I - GLASS OPTION

Acciso K - LIGHT SOURCE

exceptionally illuminated.

Projected LED Lumen Maintenance

FEATURES & SPECIFICATIONS

BARN LIGHT ELECTRIC CO.

CORD HUNG PENDANT (C)

17

Data references the extrapolated performance projections for the platforms noted in a 25°C archivest, based on 10,000 hours of LED testing (tested per IESNA LM-80-06 and projected per IESNA TM-21-11).

To calculate LLE, use the lumen maintenance factor that corresponds to the desired number of consisting four hallow. For other house maintenance values, contact factors

Operating Notes 0 25,000 50,000 100,000

Lanser Maintenance 1.00 0.98 0.97 0.95

modern design and is carefully engineered

Specifications

Weight 27lbs (max): (12.25 kg)

Accessories

Ordered and displayed Imparately.

MERE U Archar belts for WEEG LED.*

SPS-0109 REV A
MARATHON SERIES
JOB NAME

B - SHADE SIZE

 370
 Mint

 380
 Chartreuse

 390
 Teal

 400
 Bam Red

 420
 Orange

 470
 Watermelon

 480
 Blush Pink

 490
 Magenta

 495
 Sherbet Orange

 500
 Buttery Yellow

 570
 Sunflower

 601
 Chocolate

 605
 Rust

 615
 Oil-Rubbed Bronze

 700
 Royal Blue

ELECTRICAL SPECS

Bulb Type Bulb Quantity Bulb Included? Wattage Initial Lumens Delivered Lumens Input Voltage

Power Supply Type Power Supply Quantity Power Supply Location Dimming Type

SHIPPING

Carton 1 L x W x H


Carton 1 GW


Example: BLE - C - YDM16 - 999 - SBK - 200 - NA - WGG - 975 - FST - NA - E26


NON-CSA LISTED CORD
OPTIONS:
CBK Black Cotton
TBK Black Cotton Twist
TWH White Cotton Twist


AVAILABLE FINISHES


GENERAL LISTINGS

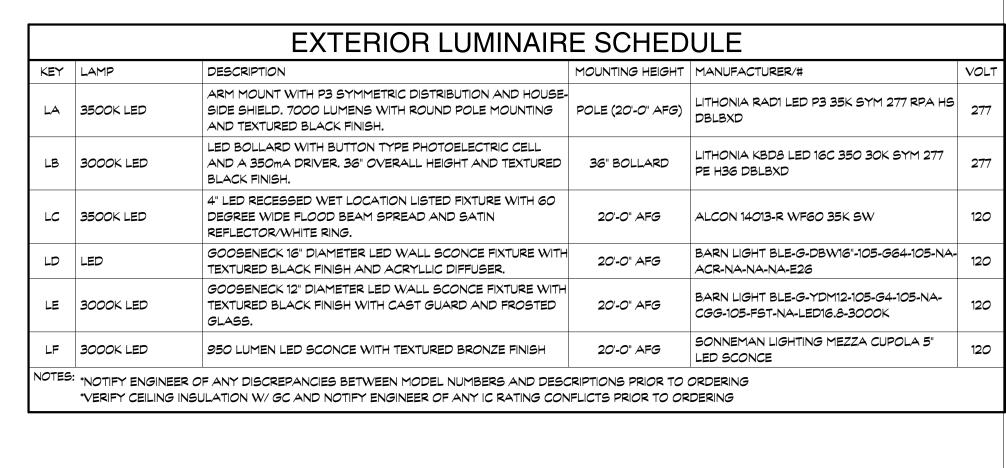


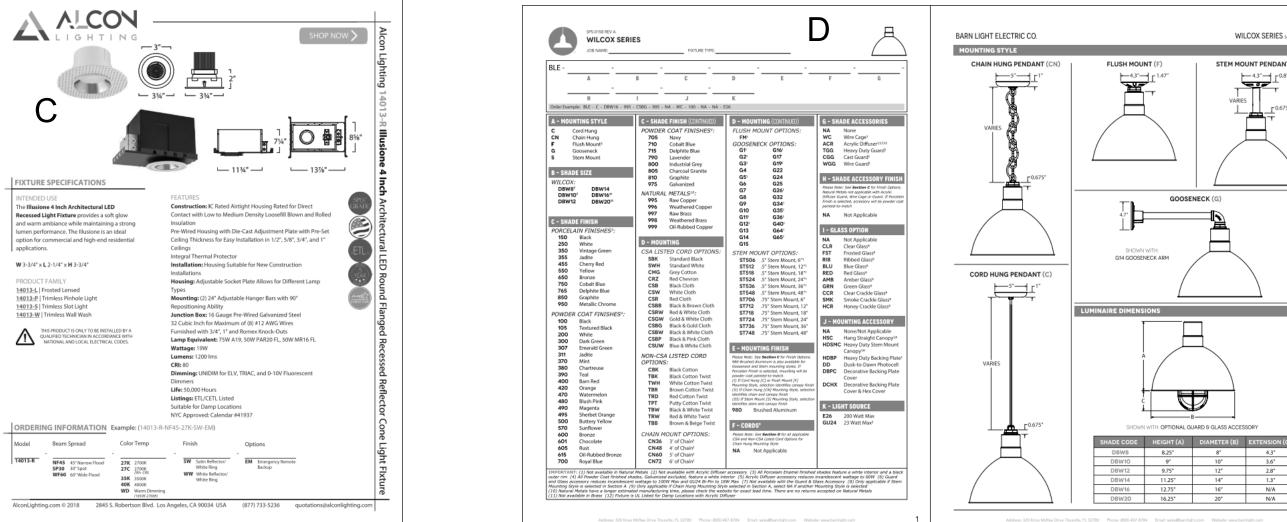


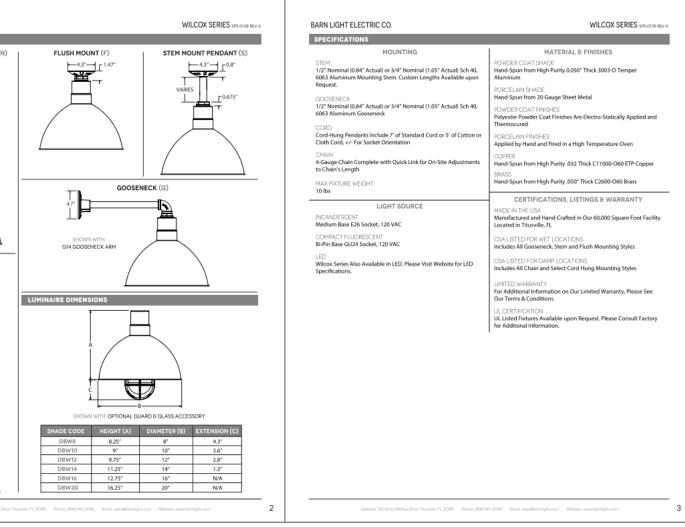

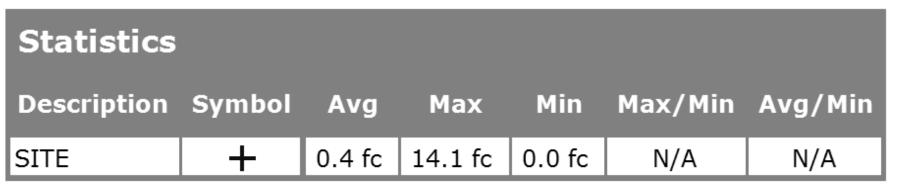

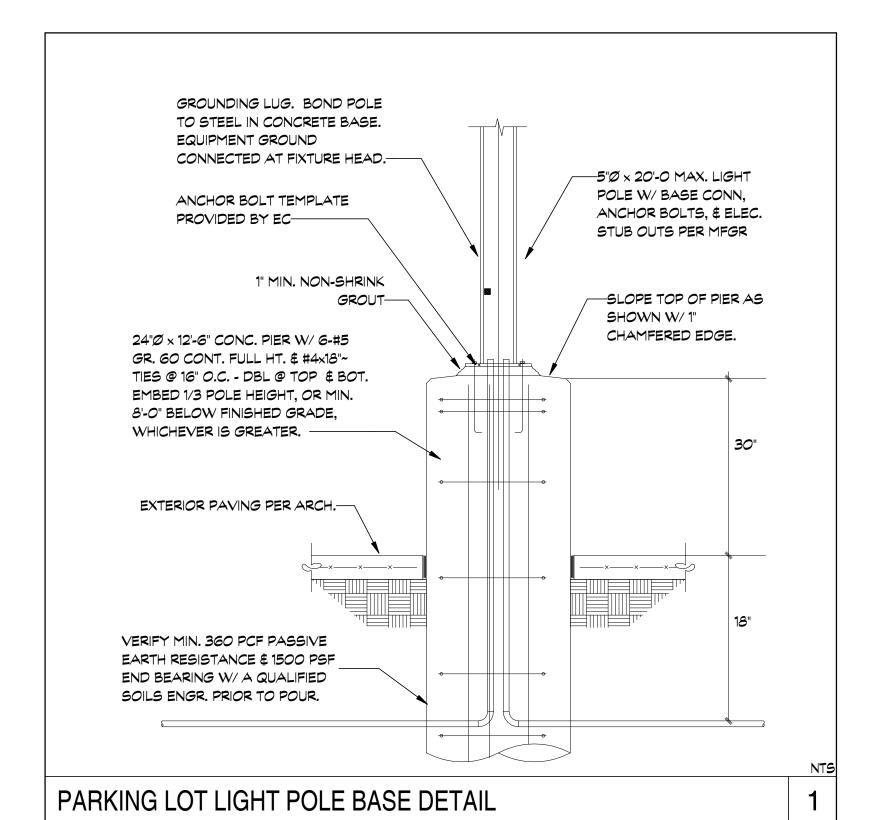

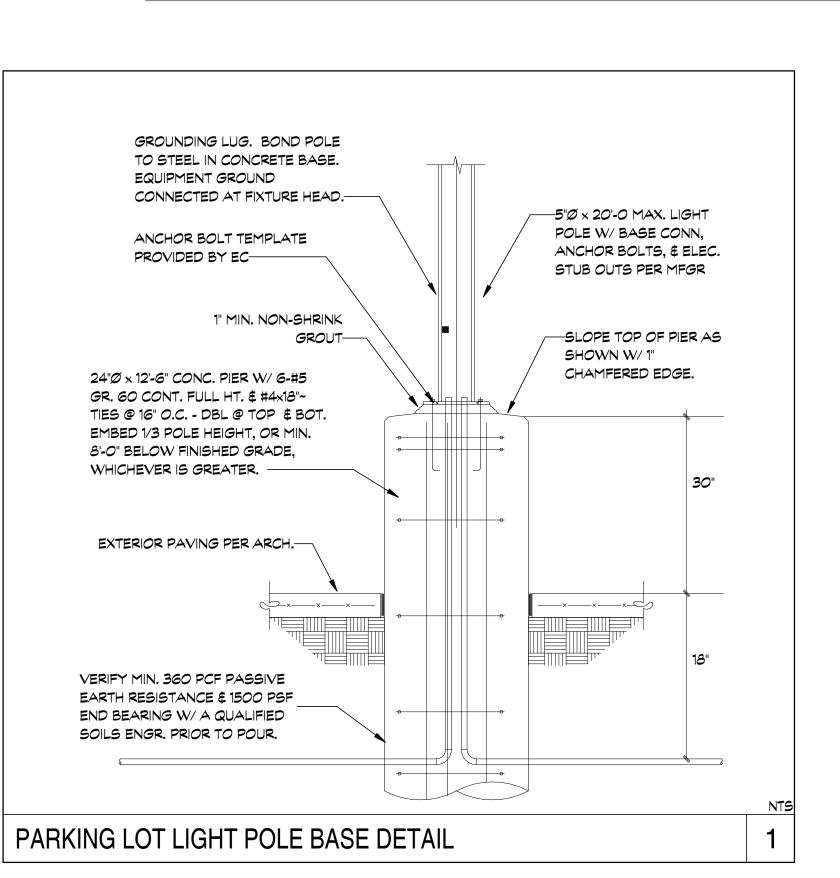

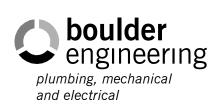

1717 15th Street Boulder, CO 80302

303.444.6038 phone 303.442.1172 fax staff@boulderengineering.com

)20 ARAPAHOE , BOULDER, CO 8

<

No. Description Date

Issue

PERMIT SET 06.18.2021 Date 20061 Project Number Drawn by MOD Checked by Sheet Title: **PHOTOMETRIC**

DETAILS Sheet Number

SCHEDULES AND