

# STEAMBOAT BASECAMP - DEVELOPMENT PLAN SUBMISSION

1901 CURVE PLAZA STEAMBOAT SPRINGS, COLORADO 80487

PROJECT TEAM

**OWNER** 

MAY RIEGLER PROPERTIES 2201 WISCONSIN AVENUE NW SUITE 200 WASHINGTON, DC 20007

PO BOX 881330 STEAMBOAT SPRINGS, CO 80488

**ARCHITECT** 

3318 N. COLUMBUS ST. ARLINGTON, VA 22207

CIVIL ENGINEER

LANDMARK ENGINEERS & SURVEYORS 141 9TH STREET PO BOX 774943 STEAMBOAT SPRINGS, CO 80477

PROJECT SUMMARY TABLE

**GROSS FLOOR AREA:** 64,073 GSF **NET FLOOR AREA:** 52,142 NSF **UNIT SIZE:** 616 SF AVERAGE NUMBER OF UNITS:

**ZONING:** 

FRONTAGE: CURVE CT: 263' / SHIELD DR: 350' / ELK RIVER RD: 380' / HWY 40: 377'

**USE BREAKDOWN DESCRIPTION** SQUARE FOOTAGE # OF UNITS PRINCIPAL USE RESIDENTIAL 55,934 SF

**ACCESSORY USES** COMMERCIAL 8,139 SF

STANDARDS	ZONE DISTRICT REQMTS	PROPOSED	VARIANCE? (Y/N
LOT AREA	NO MAX/NO MIN	2.64 ACRES	N
LOT COVERAGE	NO MAX/NO MIN	19.7%	N
OPEN SPACE	15% MIN	52.67%	N
FLOOR AREA RATIO	NO MAX	0.58 FAR	N
OVERALL BLDG HT	63' MAX	53'-3"	N
AVERAGE PLATE HT	N/A		
FRONTAGE AREA HT	26' MIN	27'-7" (EXIST) / 51'-9" (NI	EW) N
FRONT SETBACK	5 FT MIN	COMPLIES	N
SIDE SETBACK	7.5 FT MIN	COMPLIES	N
UPPER STORY SETBACK	OVER 45' OR 3 STORIES	VARIES	Υ
REAR SETBACK	7.5 FT MIN	COMPLIES	N
SECOND STORY INTENSITY	50% MINIMUM	NEW CONST: 100%	N
PARKING	128 SPACES (SEE NARRATIVE)	128 SPACES	N
SNOW STORAGE	29,301 SF	32,478 SF	N
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**DRAWING LIST** G 1.0 COVER SHEET C.003 EXISTING CONDITIONS & SITE REMOVAL EXHIBIT C.100 SITE PLAN C.200 UTILITY PLAN C.210 WATER MAIN PLAN - OVERALL C.211 WATER MAIN PLAN & PROFILE C.212 WATER MAIN PLAN & PROFILE C.213 WATER MAIN PLAN & PROFILE C.214 WATER MAIN PLAN & PROFILE C.221 SANITARY SEWER PLAN & PROFILE C.301 DETAILED GRADING PLAN - OFFSITE C.302 DETAILED GRADING PLAN - ONSITE

C.311 STORM SEWER PLAN & PROFILE C.400 MATERIALS, SIGNAGE, & STRIPING PLAN C.401 MATERIALS, SIGNAGE, & STRIPING PLAN

C.410 ROADWAY PLAN & PROFILE

C.310 STORM SEWER PLAN - OVERALL

C.700 EASEMENT EXHIBIT

A 1.1 EXISTING GROUND LEVEL PLAN A 1.2 EXISTING ROOF PLAN

A 1.3 DEMOLITION PLAN A 2.1 GROUND LEVEL PLAN A 2.2 TYPICAL FLOOR PLAN

A 2.3 FIFTH FLOOR PLAN A 2.4 ROOF PLAN

A 2.5 ENLARGED UNIT PLANS

A 3.01 EXISTING SOUTH AND WEST ELEVATIONS

A 3.02 EXISTING NORTH AND EAST ELEVATIONS A 3.11 PROPOSED SOUTH AND WEST ELEVATIONS

A 3.12 PROPOSED NORTH AND EAST ELEVATIONS

A 3.2 BUILDING SECTIONS

A 4.1 PROPOSED PROJECT PERSPECTIVE RENDERING

A 4.2 PROPOSED PROJECT PERSPECTIVE RENDERING

A 4.3 PROPOSED PROJECT PERSPECTIVE RENDERING A 4.4 PROPOSED PROJECT PERSPECTIVE RENDERING

A 4.5 PROPOSED PROJECT PERSPECTIVE RENDERING

A 5.1 LIGHTING SPECIFICATIONS

LANDSCAPE PLAN

MEP 1 PHOTOMETRIC SITE PLAN

MEP 2 PHOTOMETRIC SCHEDULES AND DETAILS

APPROVAL STAMPS: K. Plan Set 5 6/17/2021 Development Plan Submittal #5 4 4/19/2021 Development Plan Submittal #4 3 10/14/2020 Development Plan Submittal #3 7/8/2020 Development Plan Submittal #2 1 3/27/2020 Development Plan Submittal SUBMISSIONS & REVISIONS May Riegler Properties 2201 Wisconsin Avenue NW Suite 200 Washington, DC 20007 PO Box 881330 Steamboat Springs, CO 80488 **KEVIN & ASAKO SPERRY ARCHITECTURE** 3318 N. Columbus Street Arlington, VA 22207 T.312.636.3248 / 312.636.4252 www.kasa-arch.com STRUCTURAL ENGINEER M.E.P. & F.P. ENGINEERS CIVIL ENGINEER LANDMARK CONSULTANTS, INC. PO Box 774943 Steamboat Springs, Colorado 80477 T.970.871.9494 LANDSCAPE ARCHITECT MGC DESIGN, INC. PO Box 773522 Steamboat Springs, Colorado 80477 T.970.879.7740

GENERAL CONTRACTOR

PROJECT LOCATION

Steamboat Basecamp

Steamboat Springs, CO DRAWING TITLE

COVER SHEET


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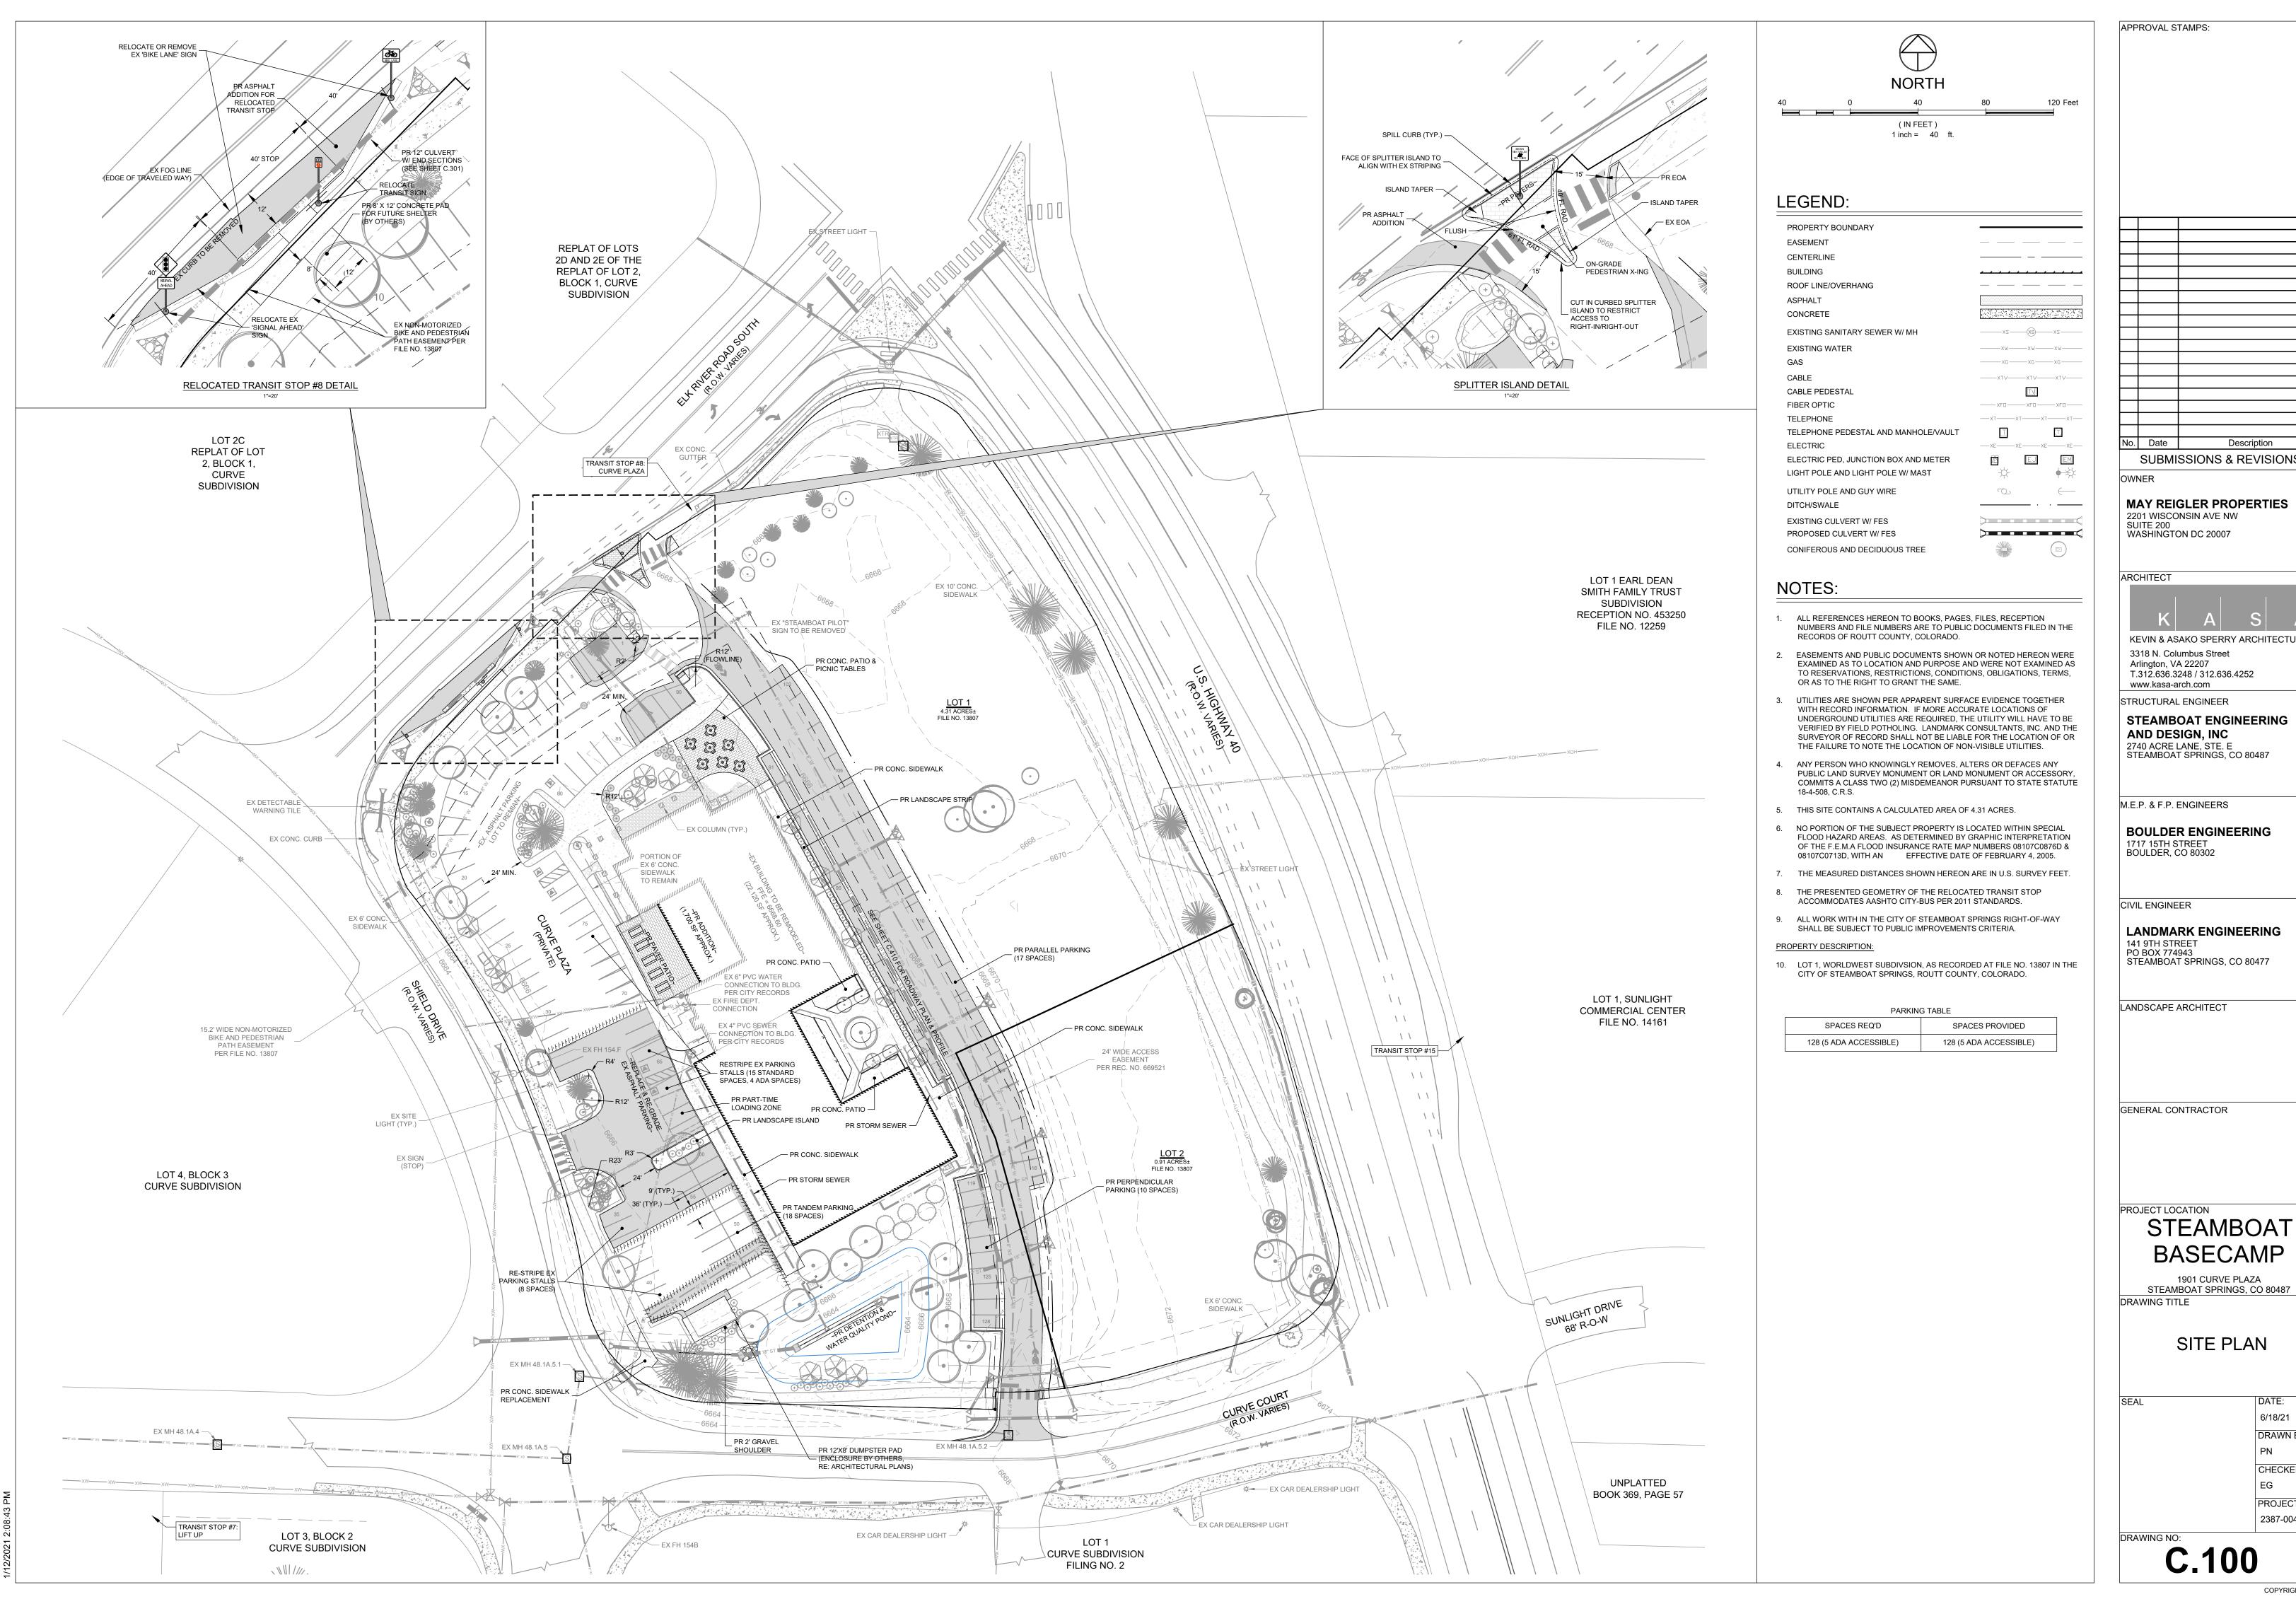
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**VICINITY MAP** 

PROJECT NO:





Description **SUBMISSIONS & REVISIONS MAY REIGLER PROPERTIES** 2201 WISCONSIN AVE NW SUITE 200 WASHINGTON DC 20007 KEVIN & ASAKO SPERRY ARCHITECTURE 3318 N. Columbus Street Arlington, VA 22207 T.312.636.3248 / 312.636.4252 www.kasa-arch.com STRUCTURAL ENGINEER STEAMBOAT ENGINEERING **AND DESIGN, INC** 2740 ACRE LANE, STE. E STEAMBOAT SPRINGS, CO 80487 M.E.P. & F.P. ENGINEERS **BOULDER ENGINEERING** 1717 15TH STREET BOULDER, CO 80302

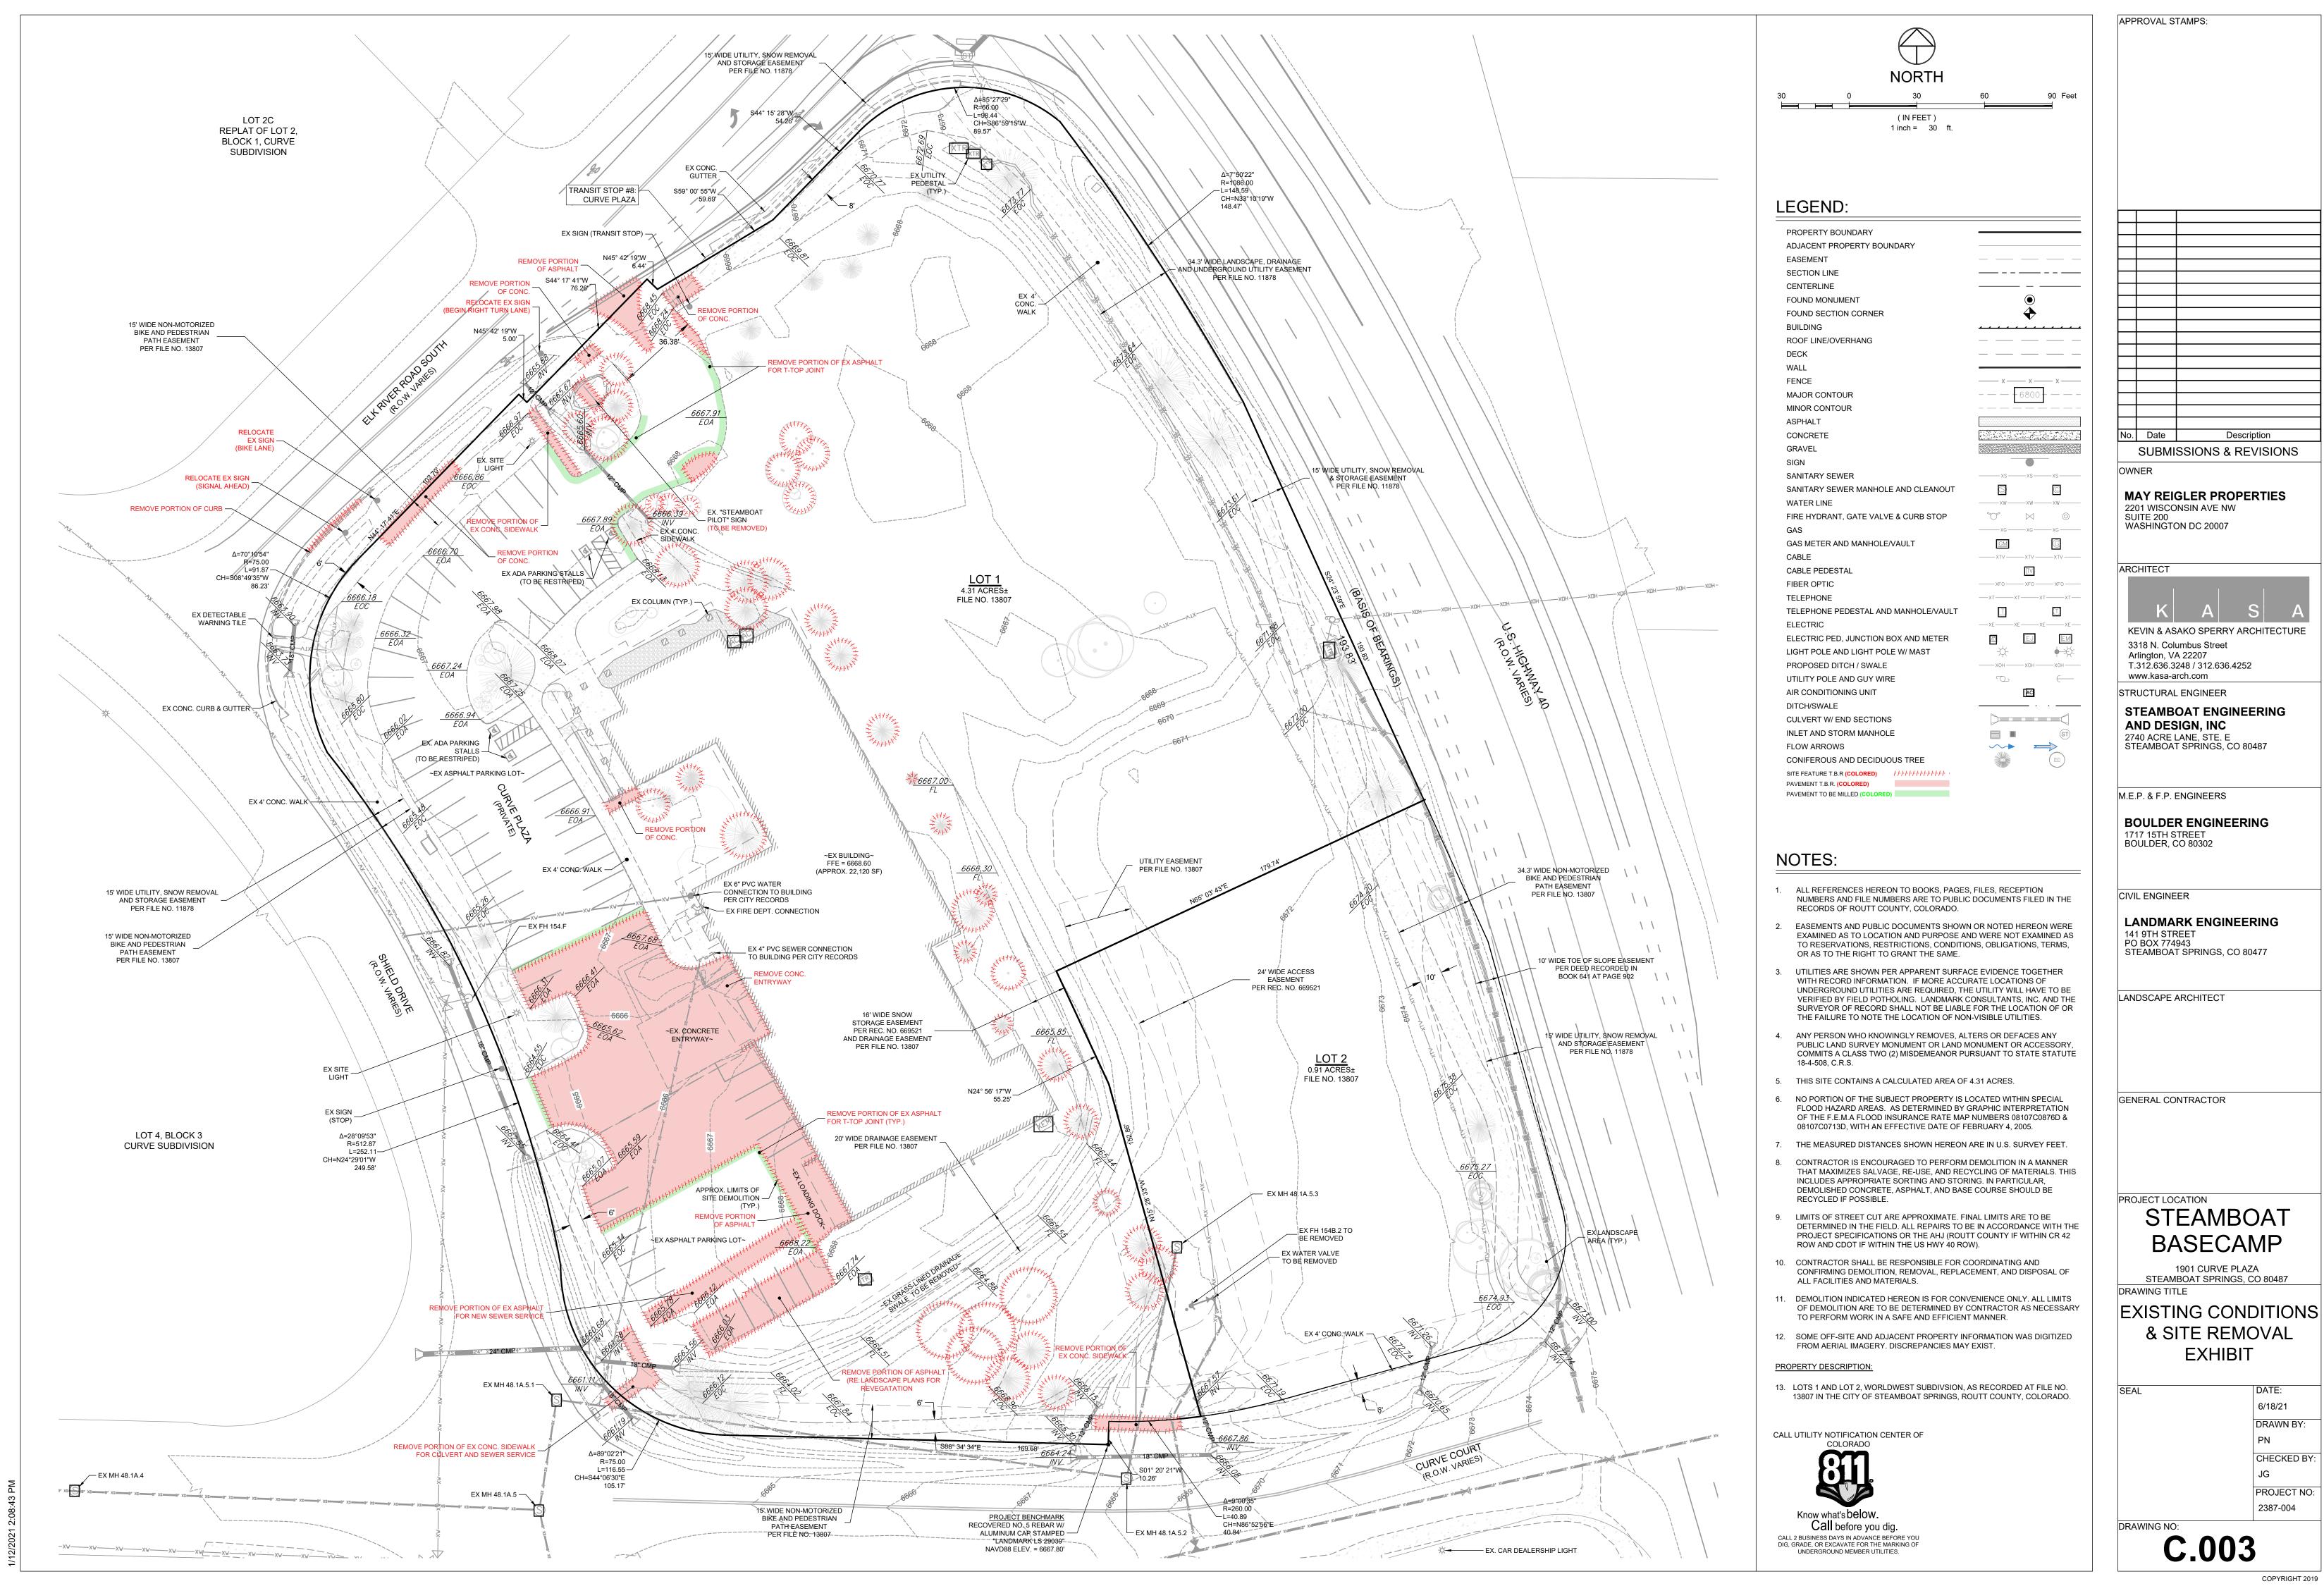LANDMARK ENGINEERING

GENERAL CONTRACTOR


## **BASECAMP**

1901 CURVE PLAZA STEAMBOAT SPRINGS, CO 80487

SITE PLAN

6/18/21 DRAWN BY: CHECKED BY: EG PROJECT NO: 2387-004

C.100

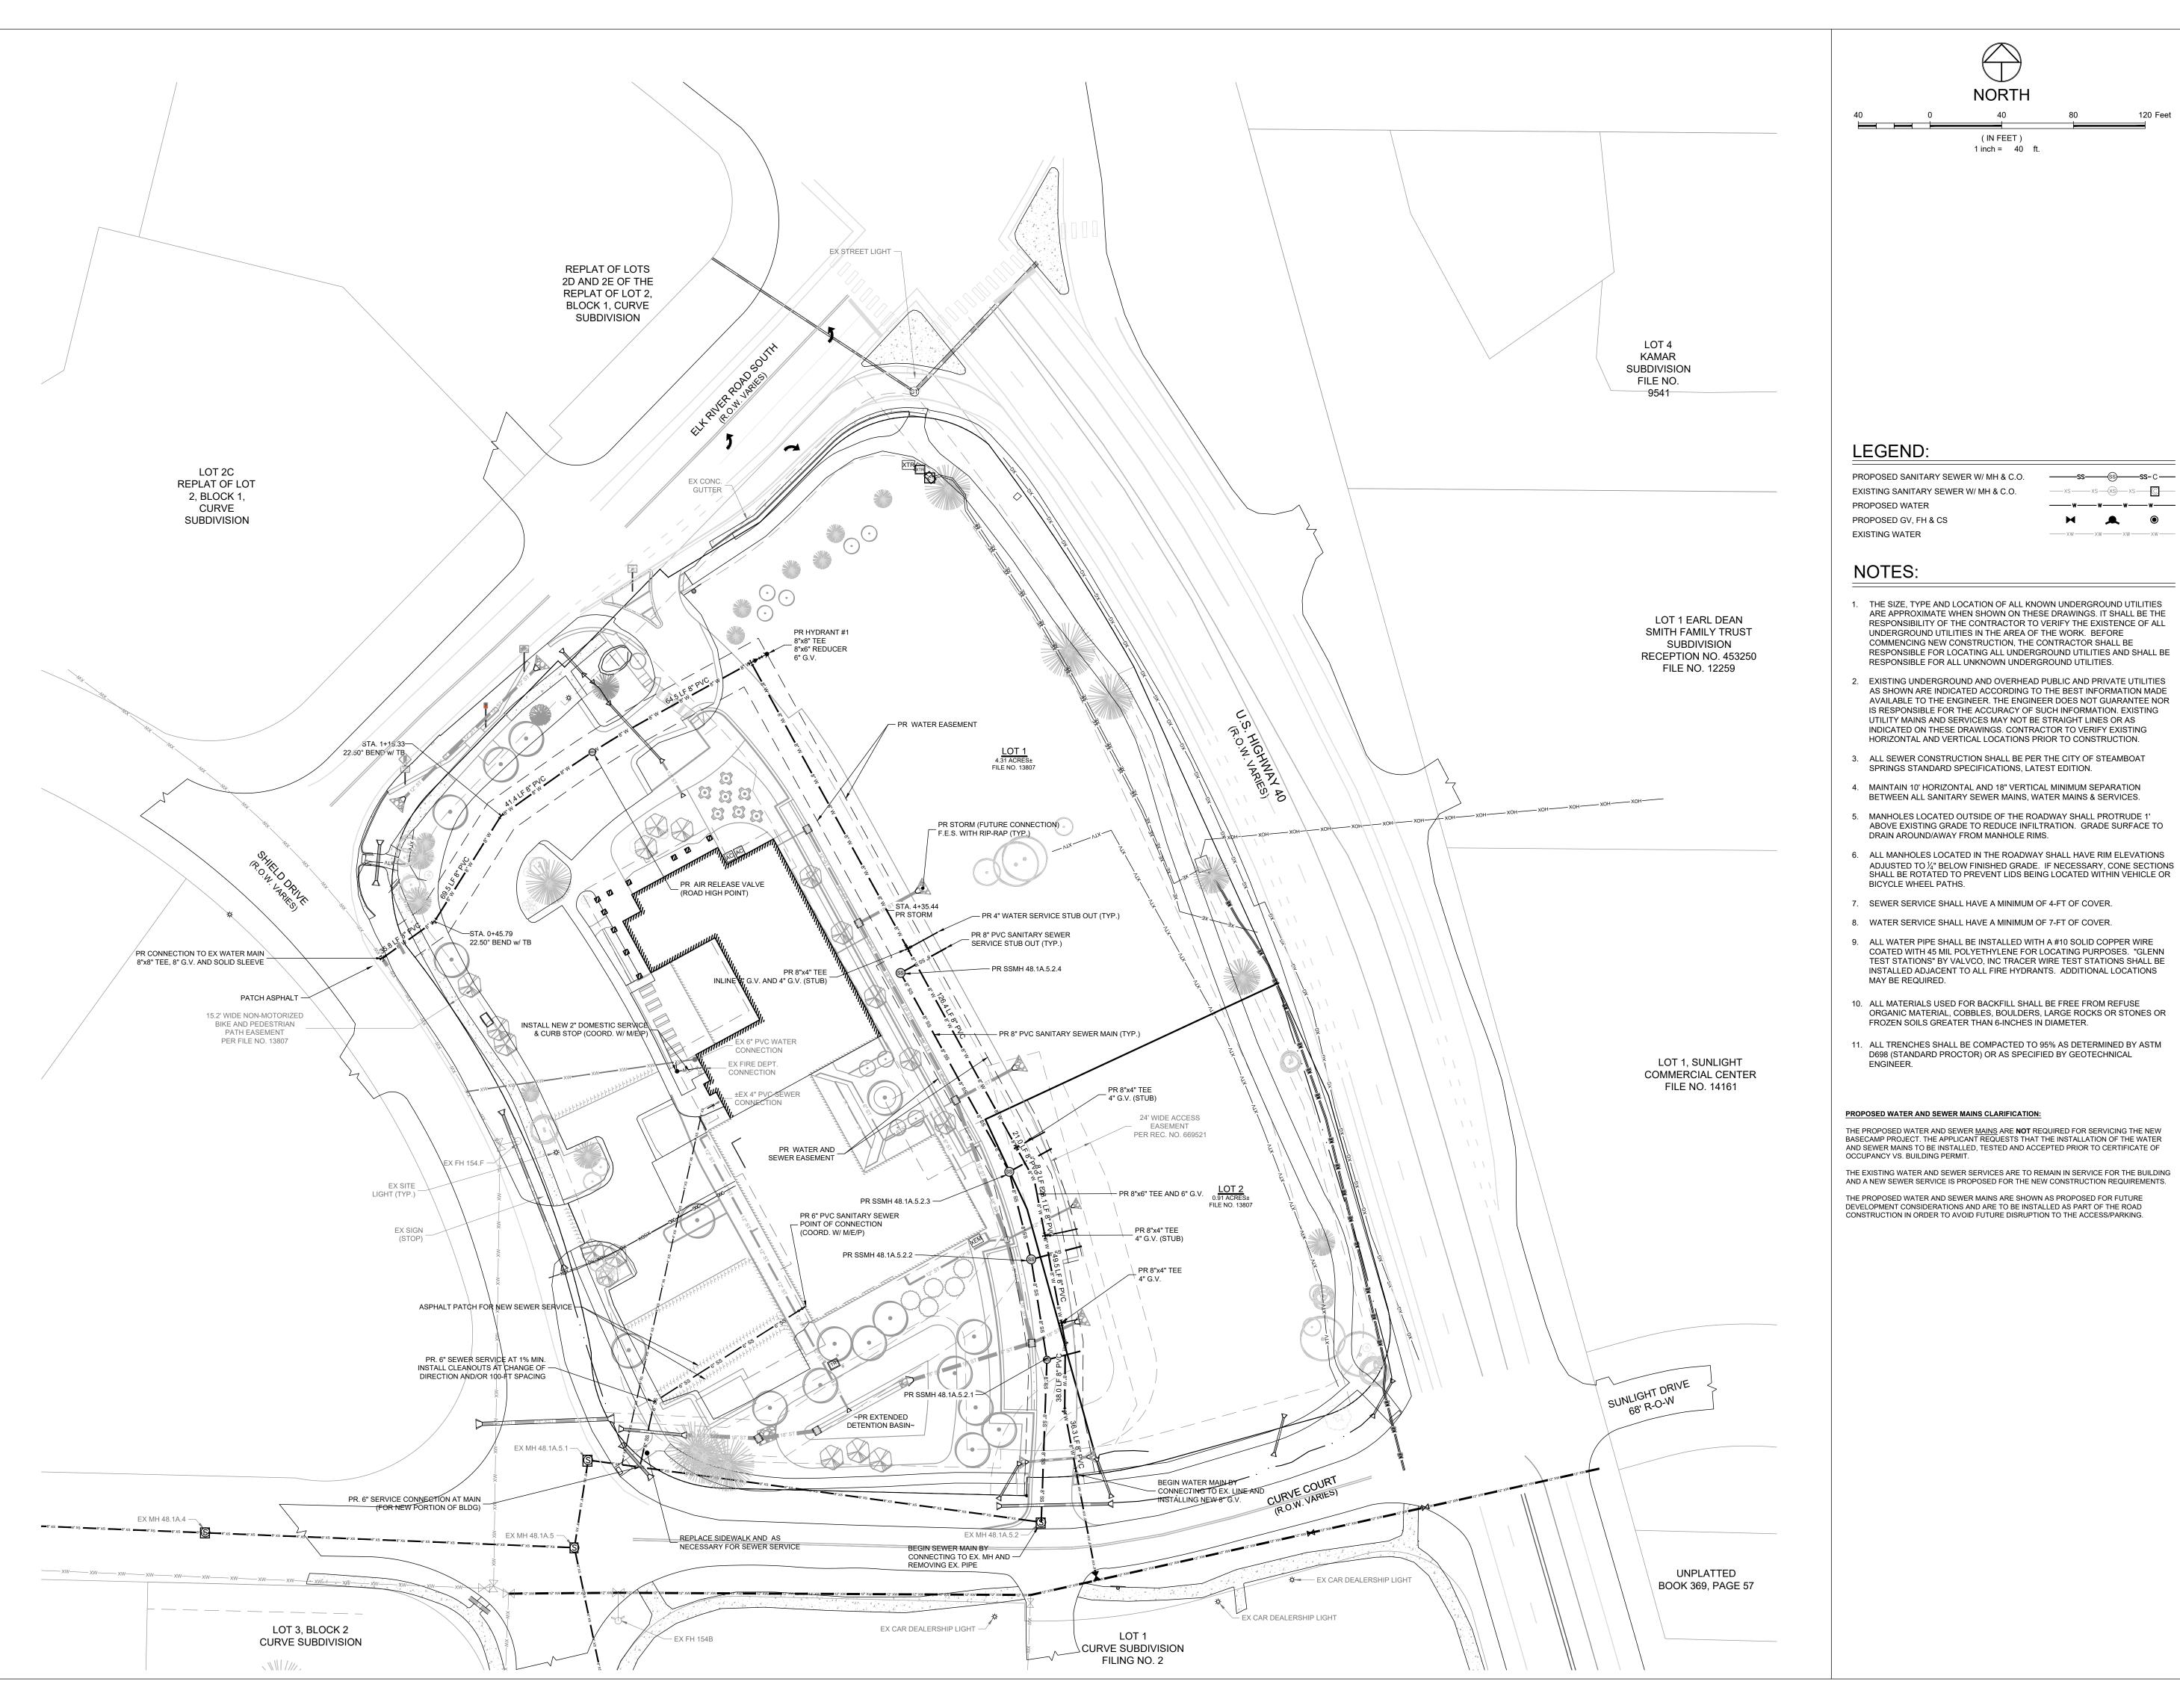

APPROVAL STAMPS:

SUBMISSIONS & REVISIONS

Description

OWNER

No. Date

MAY REIGLER PROPERTIES 2201 WISCONSIN AVE NW

SUITE 200 WASHINGTON DC 20007

ARCHITECT



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LANDMARK ENGINEERING

141 9TH STREET PO BOX 774943 STEAMBOAT SPRINGS, CO 80477

LANDSCAPE ARCHITECT

GENERAL CONTRACTOR


PROJECT LOCATION

#### STEAMBOAT **BASECAMP**

1901 CURVE PLAZA STEAMBOAT SPRINGS, CO 80487 DRAWING TITLE

UTILITY PLAN

6/18/21 DRAWN BY: CHECKED BY: PROJECT NO: 2387-004

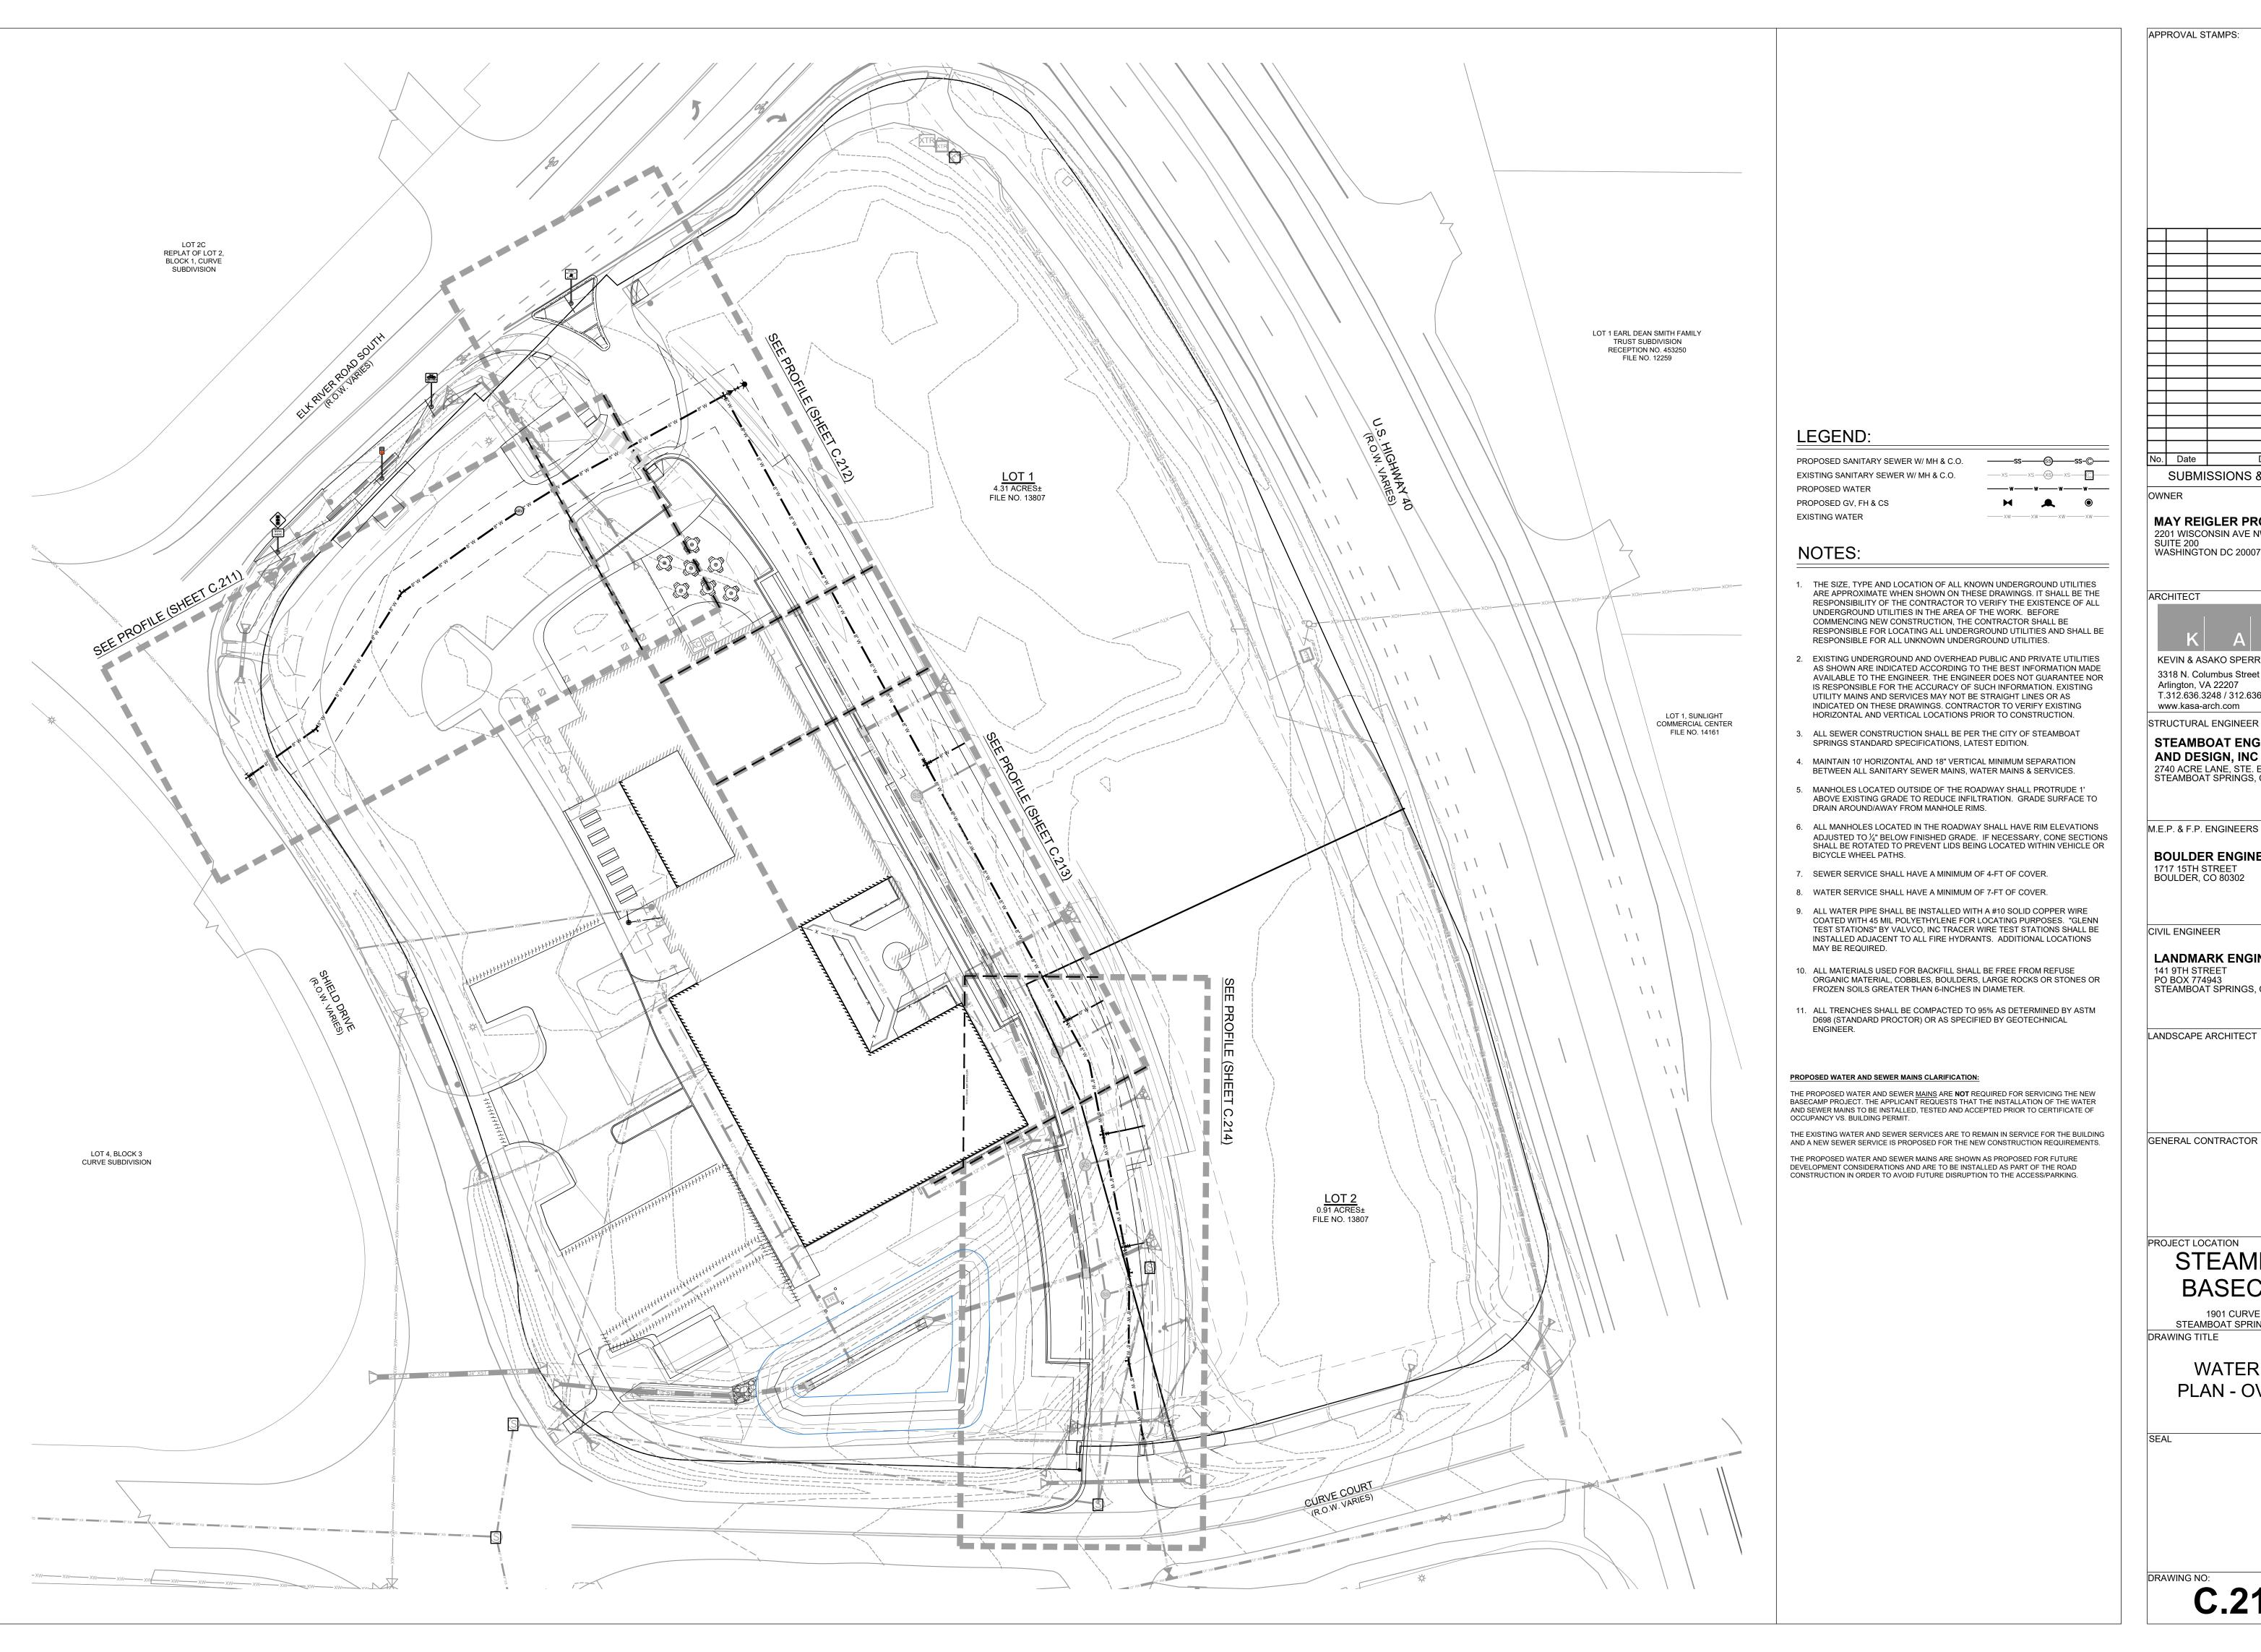

No. Date Description OWNER MAY REIGLER PROPERTIES
2201 WISCONSIN AVE NW SUITE 200 WASHINGTON DC 20007 ARCHITECT KEVIN & ASAKO SPERRY ARCHITECTURE

SUBMISSIONS & REVISIONS

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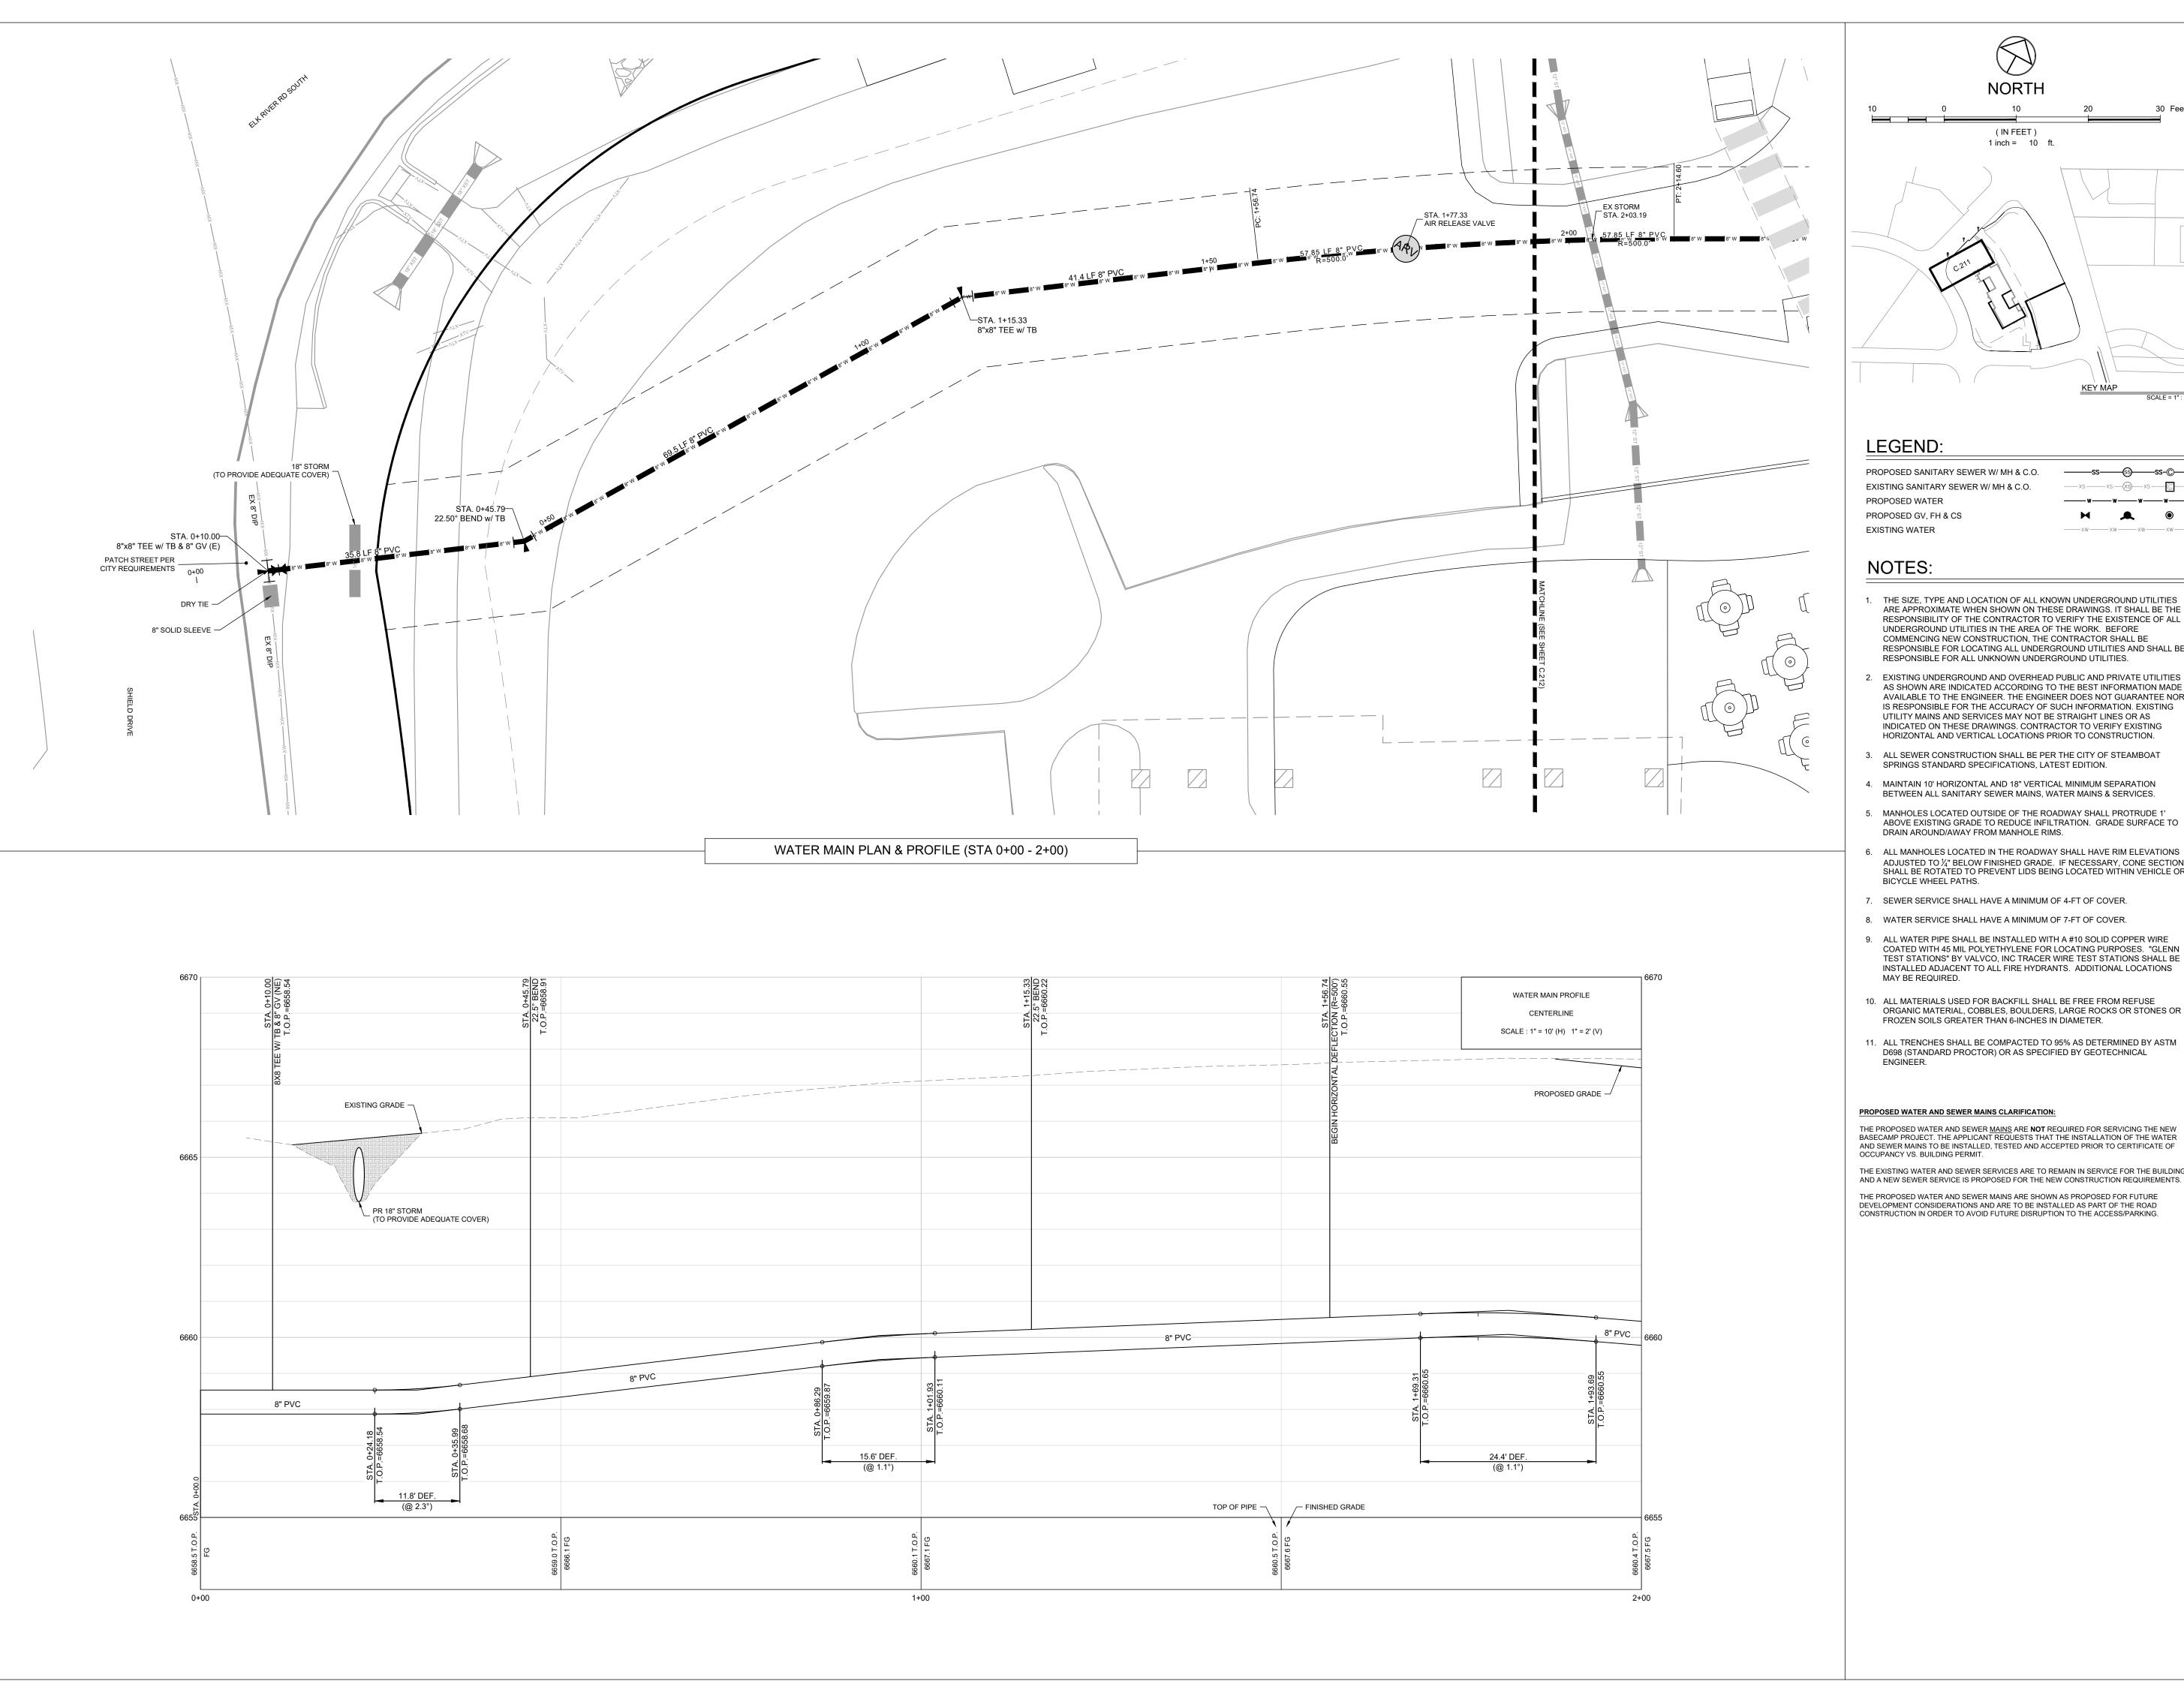
PROJECT LOCATION STEAMBOAT BASECAMP


1901 CURVE PLAZA STEAMBOAT SPRINGS, CO 80487 DRAWING TITLE

> **WATER MAIN** PLAN - OVERALL

6/18/21 DRAWN BY: CHECKED BY:

PROJECT NO: 2387-004



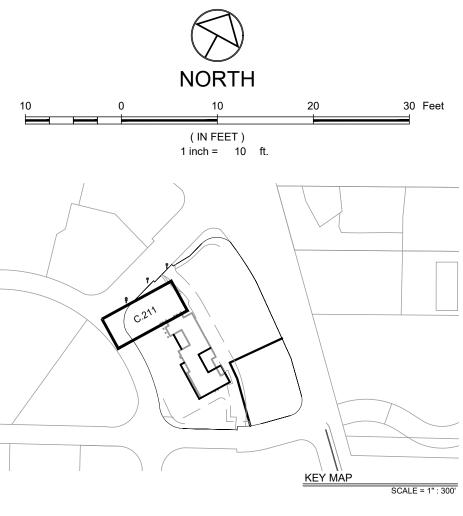

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- 1. THE SIZE, TYPE AND LOCATION OF ALL KNOWN UNDERGROUND UTILITIES ARE APPROXIMATE WHEN SHOWN ON THESE DRAWINGS. IT SHALL BE THE RESPONSIBILITY OF THE CONTRACTOR TO VERIFY THE EXISTENCE OF ALL UNDERGROUND UTILITIES IN THE AREA OF THE WORK. BEFORE COMMENCING NEW CONSTRUCTION, THE CONTRACTOR SHALL BE RESPONSIBLE FOR LOCATING ALL UNDERGROUND UTILITIES AND SHALL BE RESPONSIBLE FOR ALL UNKNOWN UNDERGROUND UTILITIES.
- AS SHOWN ARE INDICATED ACCORDING TO THE BEST INFORMATION MADE AVAILABLE TO THE ENGINEER. THE ENGINEER DOES NOT GUARANTEE NOR IS RESPONSIBLE FOR THE ACCURACY OF SUCH INFORMATION. EXISTING UTILITY MAINS AND SERVICES MAY NOT BE STRAIGHT LINES OR AS INDICATED ON THESE DRAWINGS. CONTRACTOR TO VERIFY EXISTING
- 3. ALL SEWER CONSTRUCTION SHALL BE PER THE CITY OF STEAMBOAT SPRINGS STANDARD SPECIFICATIONS, LATEST EDITION.
- 4. MAINTAIN 10' HORIZONTAL AND 18" VERTICAL MINIMUM SEPARATION
- 5. MANHOLES LOCATED OUTSIDE OF THE ROADWAY SHALL PROTRUDE 1' ABOVE EXISTING GRADE TO REDUCE INFILTRATION. GRADE SURFACE TO
- ALL MANHOLES LOCATED IN THE ROADWAY SHALL HAVE RIM ELEVATIONS ADJUSTED TO  $\frac{1}{4}$ " BELOW FINISHED GRADE. IF NECESSARY, CONE SECTIONS SHALL BE ROTATED TO PREVENT LIDS BEING LOCATED WITHIN VEHICLE OR
- 7. SEWER SERVICE SHALL HAVE A MINIMUM OF 4-FT OF COVER.
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- 9. ALL WATER PIPE SHALL BE INSTALLED WITH A #10 SOLID COPPER WIRE COATED WITH 45 MIL POLYETHYLENE FOR LOCATION PURPOSES. "GLENN TEST STATIONS" BY VALVCO, INC TRACER WIRE TEST STATIONS SHALL BE INSTALLED ADJACENT TO ALL FIRE HYDRANTS. ADDITIONAL LOCATIONS
- 10. ALL MATERIALS USED FOR BACKFILL SHALL BE FREE FROM REFUSE ORGANIC MATERIAL, COBBLES, BOULDERS, LARGE ROCKS OR STONES OR
- 11. ALL TRENCHES SHALL BE COMPACTED TO 95% AS DETERMINED BY ASTM D698 (STANDARD PROCTOR) OR AS SPECIFIED BY GEOTECHNICAL

THE PROPOSED WATER AND SEWER  $\underline{\text{MAINS}}$  ARE  $\underline{\text{NOT}}$  REQUIRED FOR SERVICING THE NEW BASECAMP PROJECT. THE APPLICANT REQUESTS THAT THE INSTALLATION OF THE WATER AND SEWER MAINS TO BE INSTALLED, TESTED AND ACCEPTED PRIOR TO CERTIFICATE OF

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APPROVAL STAMPS:

SUBMISSIONS & REVISIONS

Description

OWNER

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ARCHITECT

No. Date



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CIVIL ENGINEER

LANDMARK ENGINEERING 141 9TH STREET

PO BOX 774943 STEAMBOAT SPRINGS, CO 80477

LANDSCAPE ARCHITECT

GENERAL CONTRACTOR

PROJECT LOCATION

# STEAMBOAT


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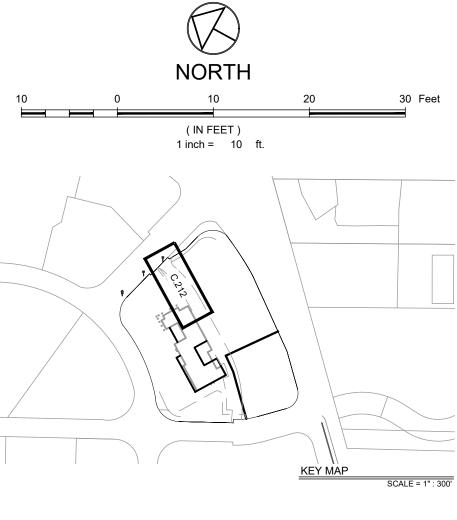
> **WATER MAIN** PLAN & PROFILE

6/18/21 DRAWN BY: CHECKED BY: PROJECT NO:

DRAWING NO:

2387-004



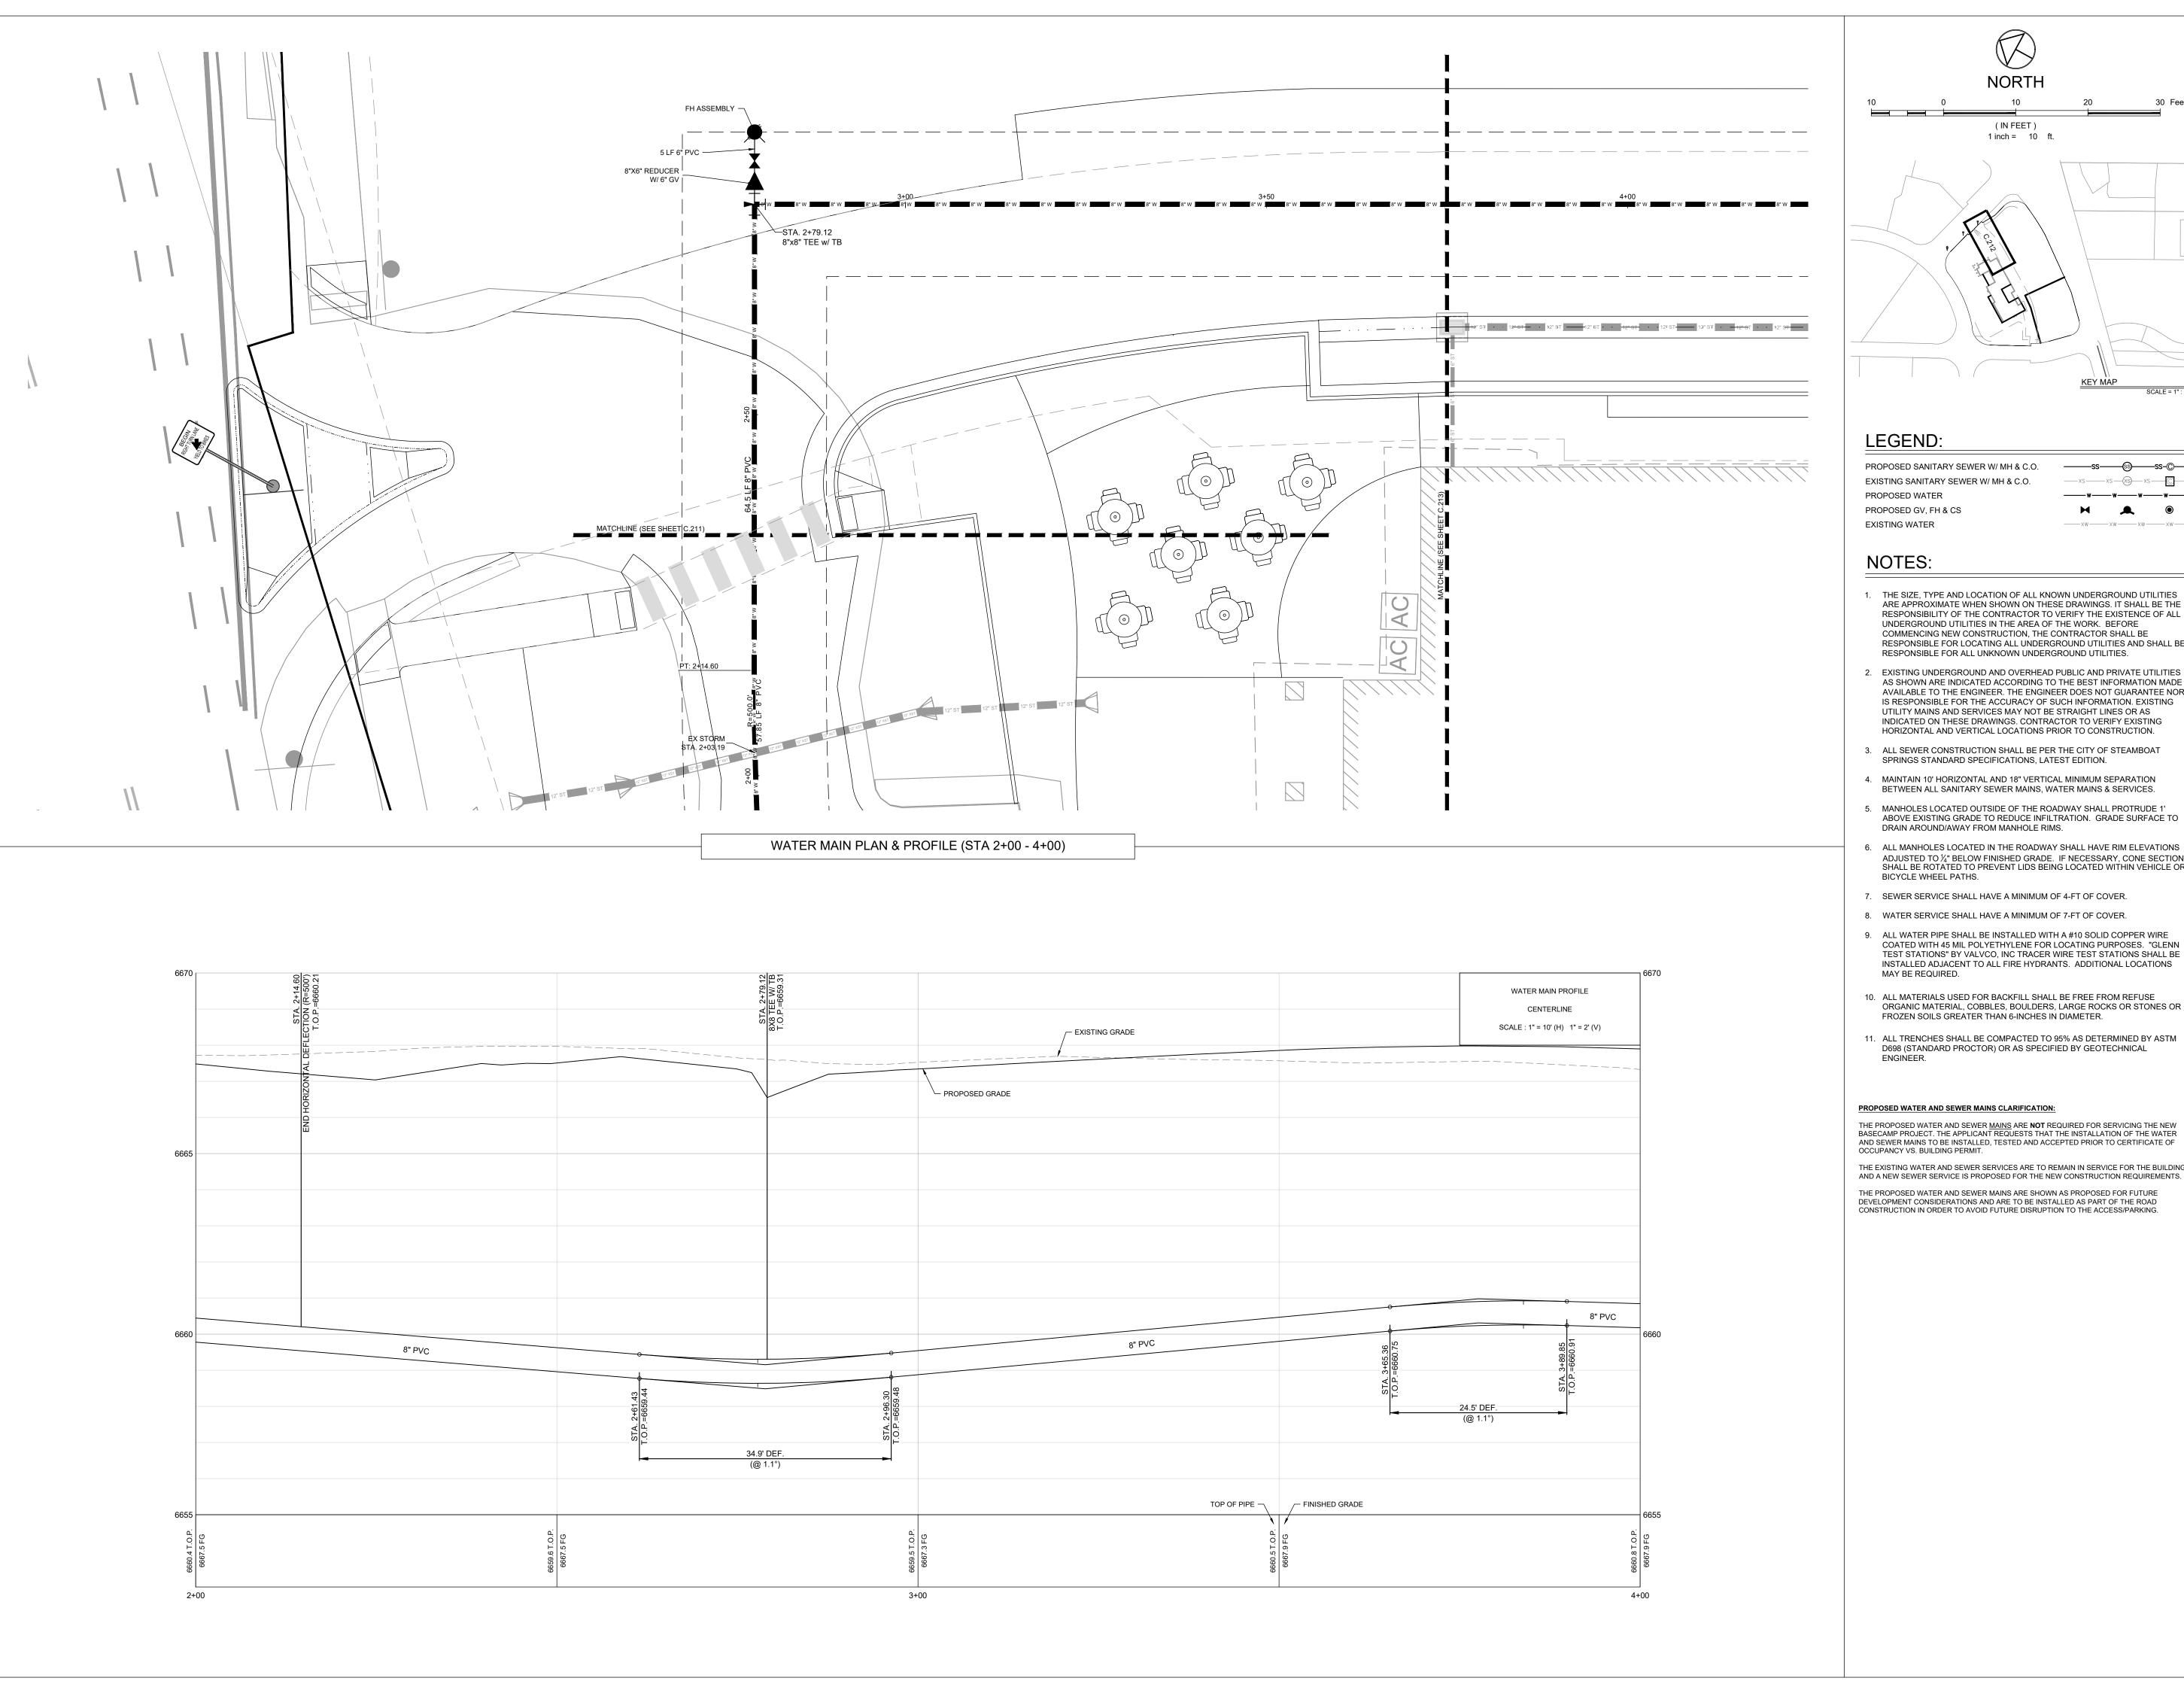

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LANDSCAPE ARCHITECT

GENERAL CONTRACTOR

PROJECT LOCATION


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1901 CURVE PLAZA STEAMBOAT SPRINGS, CO 80487 DRAWING TITLE

> **WATER MAIN** PLAN & PROFILE

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STEAMBOAT 1901 CURVE PLAZA STEAMBOAT SPRINGS, CO 80487 **WATER MAIN** 


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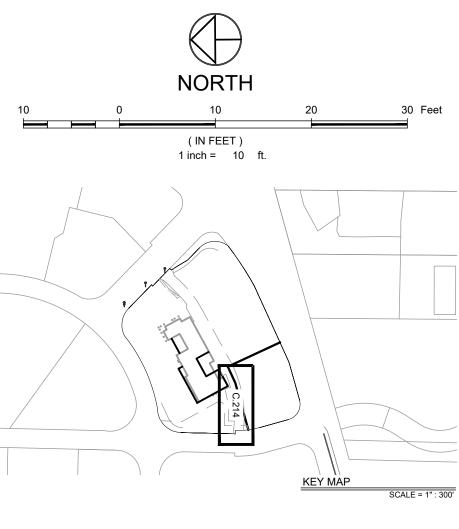
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LANDSCAPE ARCHITECT

GENERAL CONTRACTOR

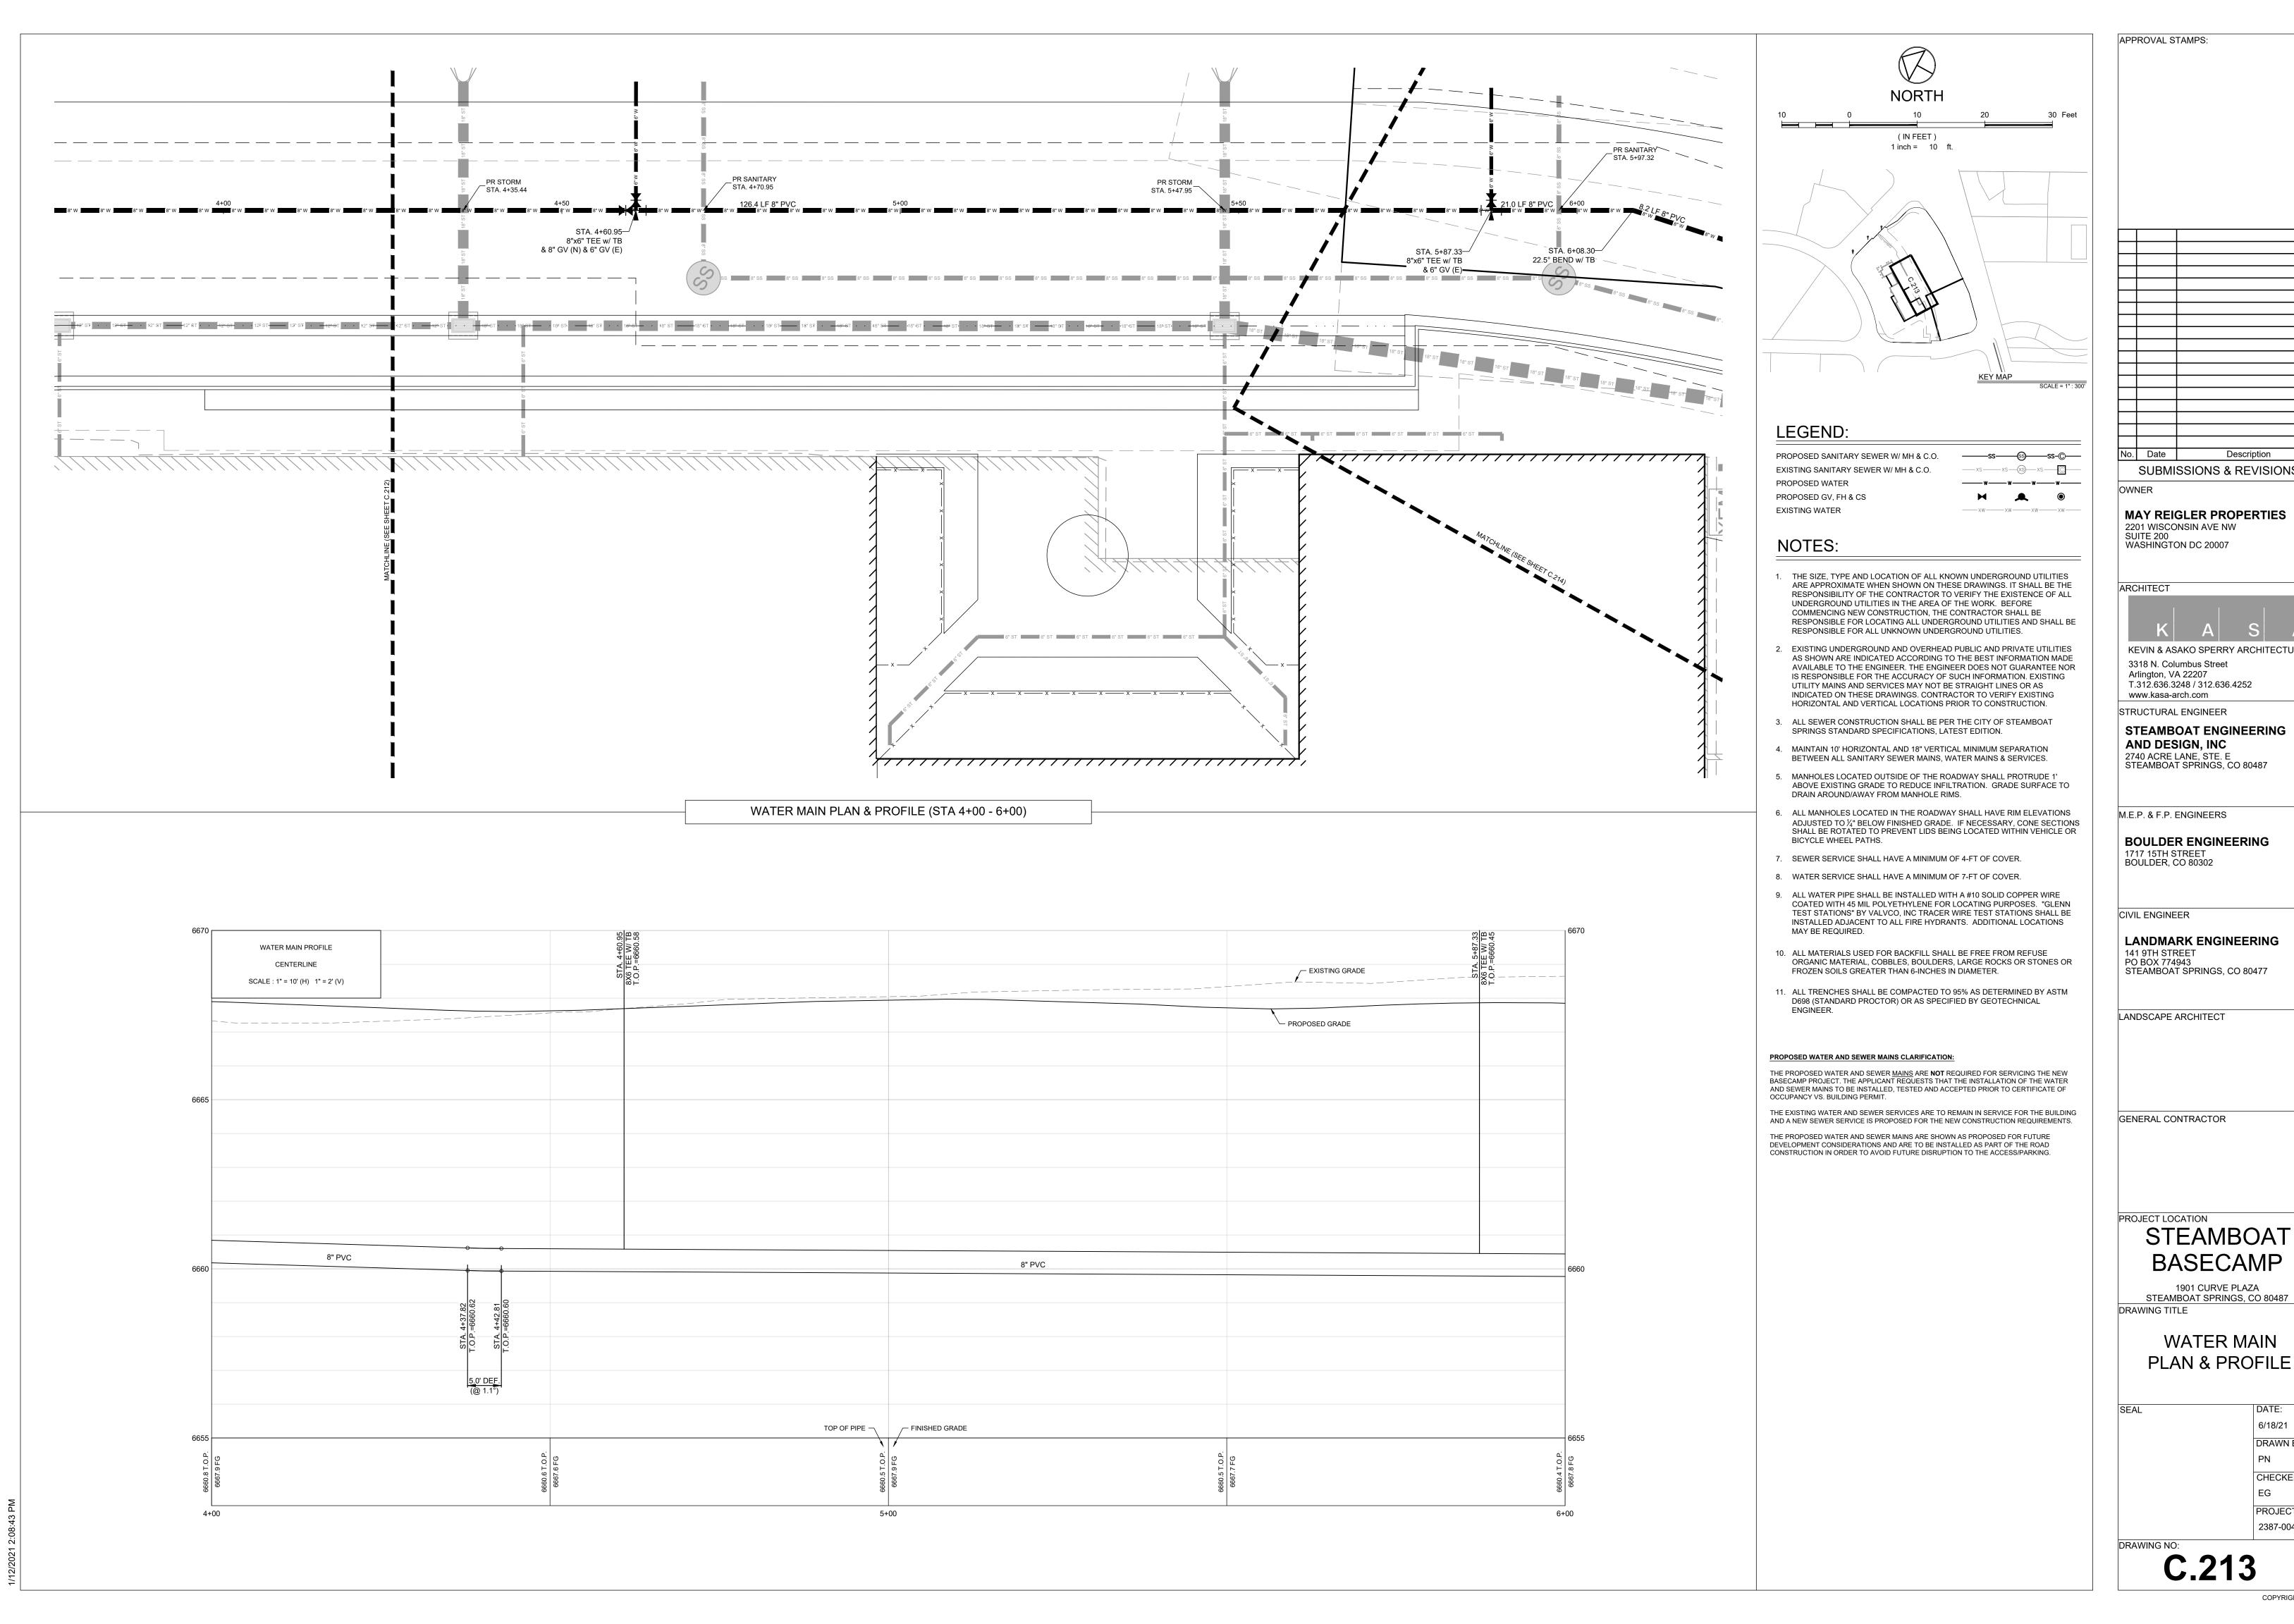PROJECT LOCATION


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> **WATER MAIN** PLAN & PROFILE

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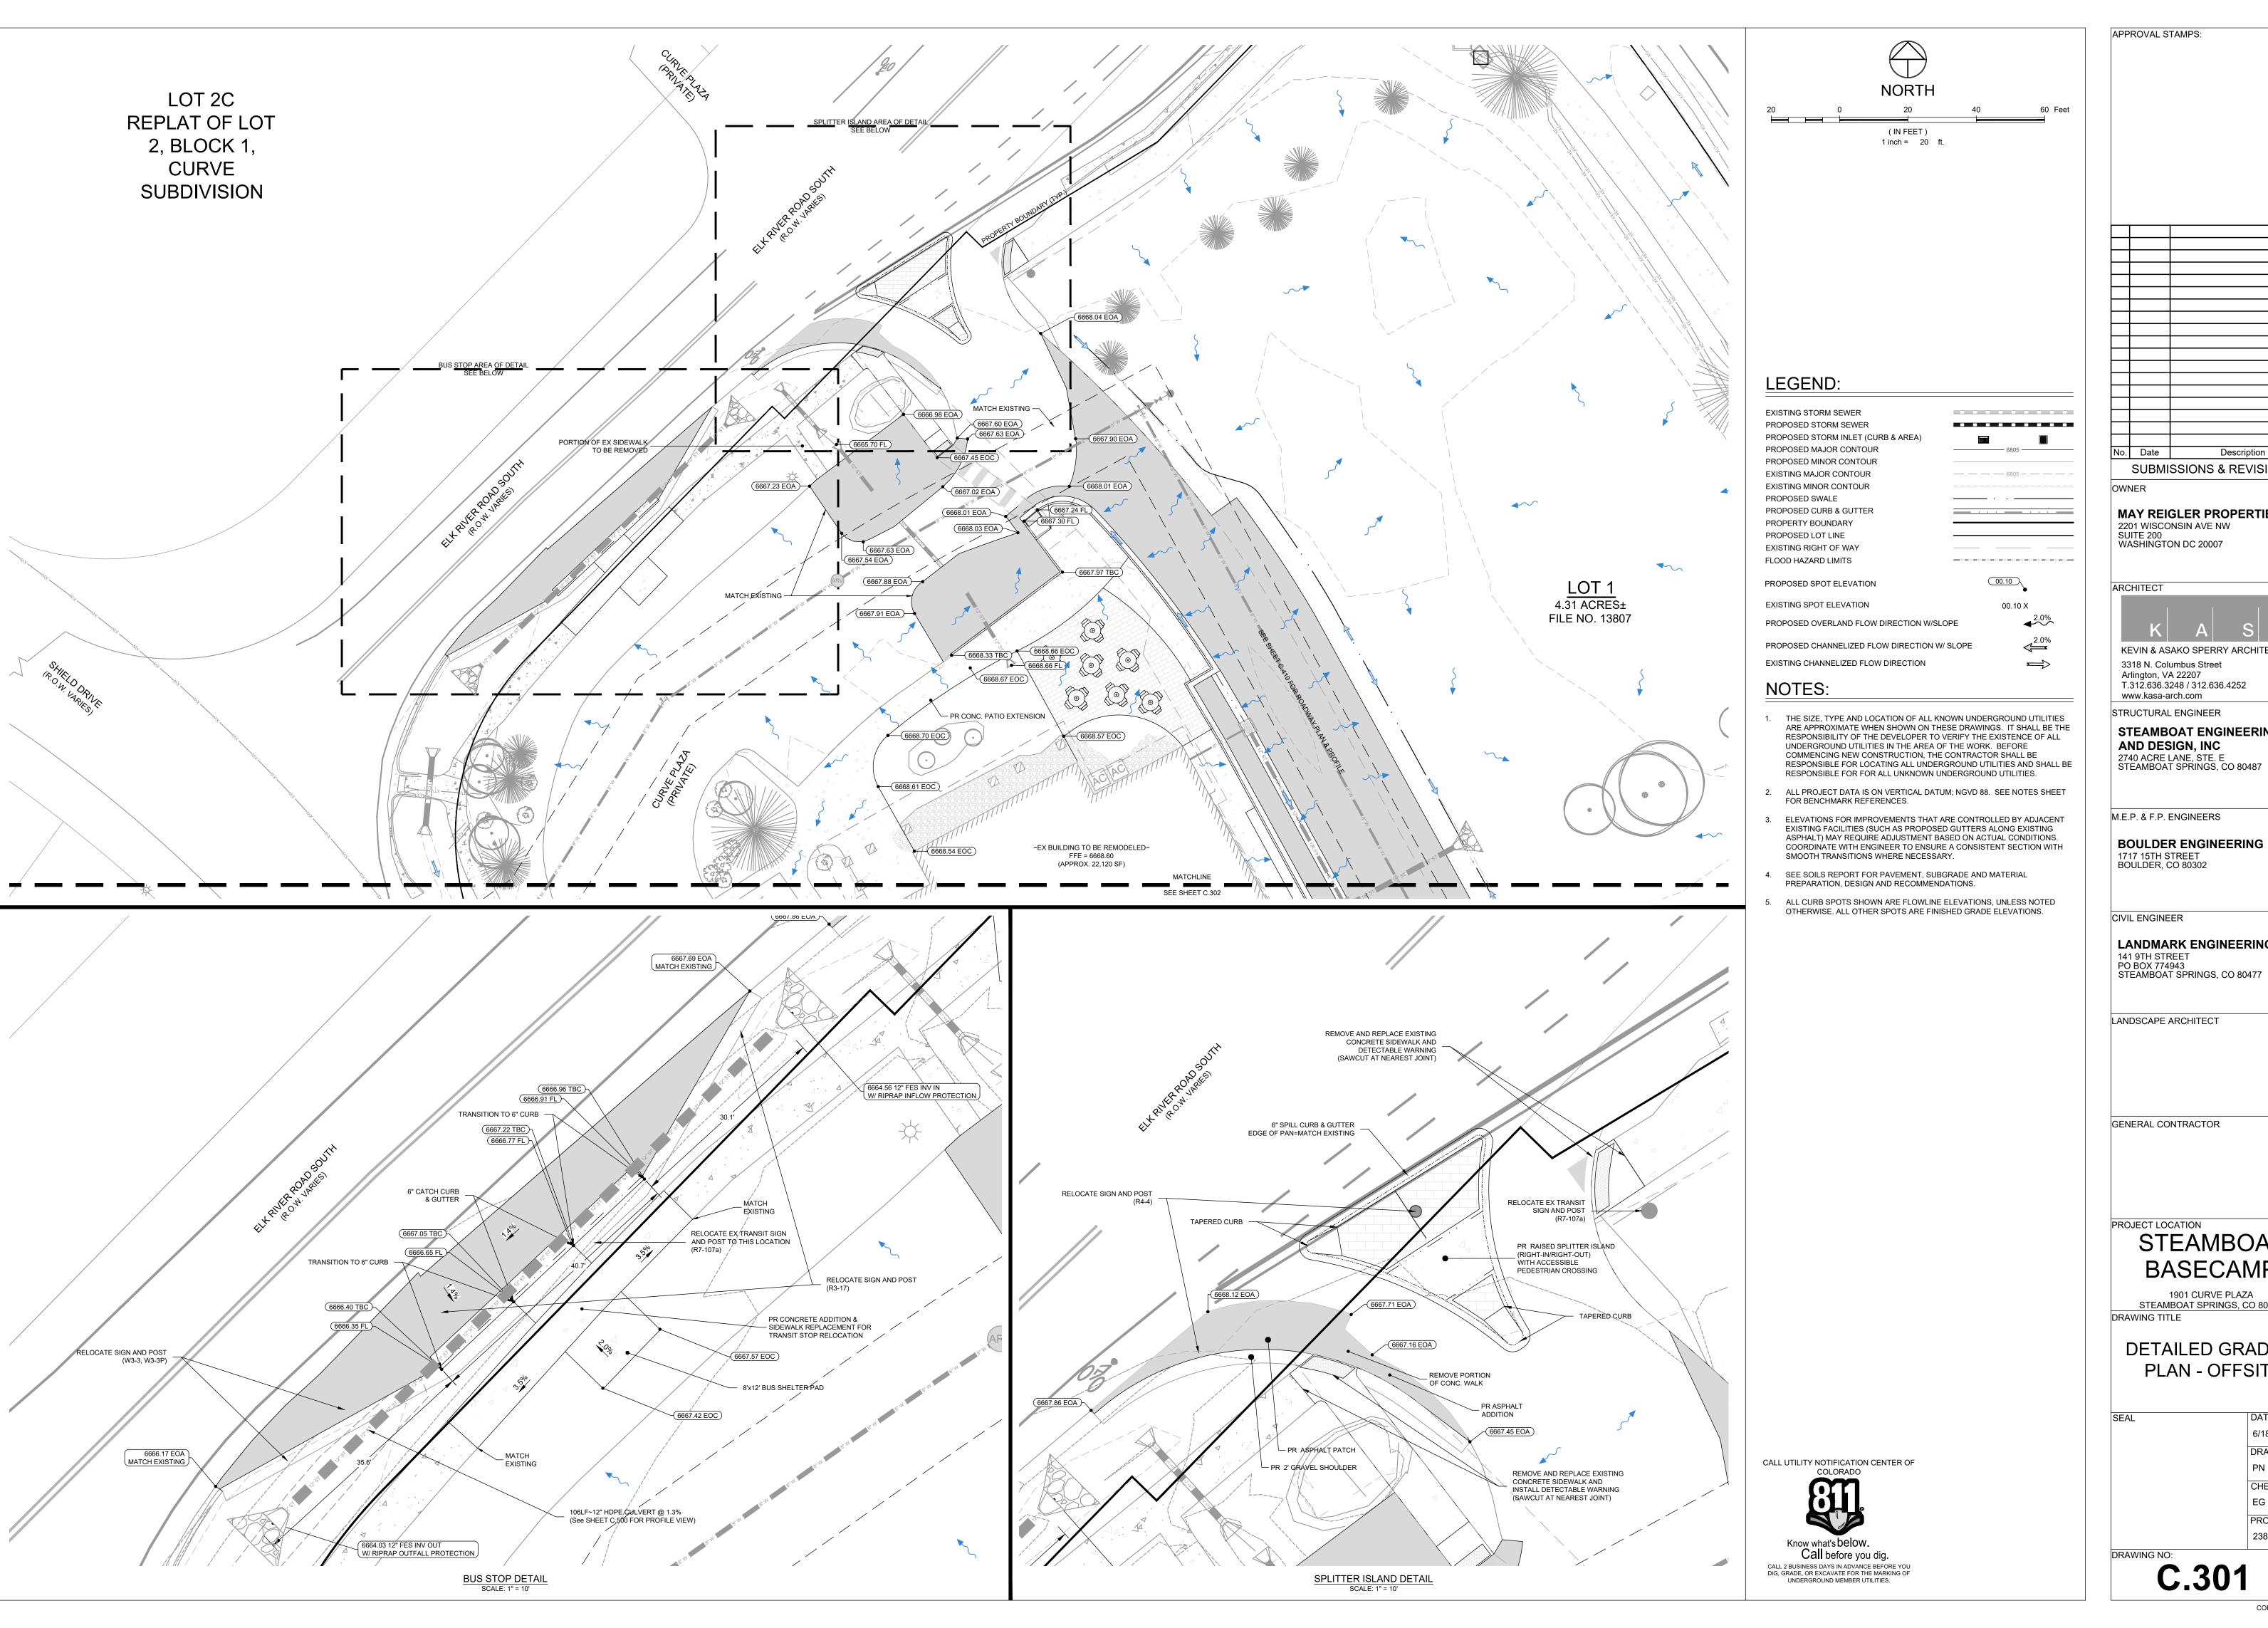
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SANITARY SEWER PLAN & PROFILE
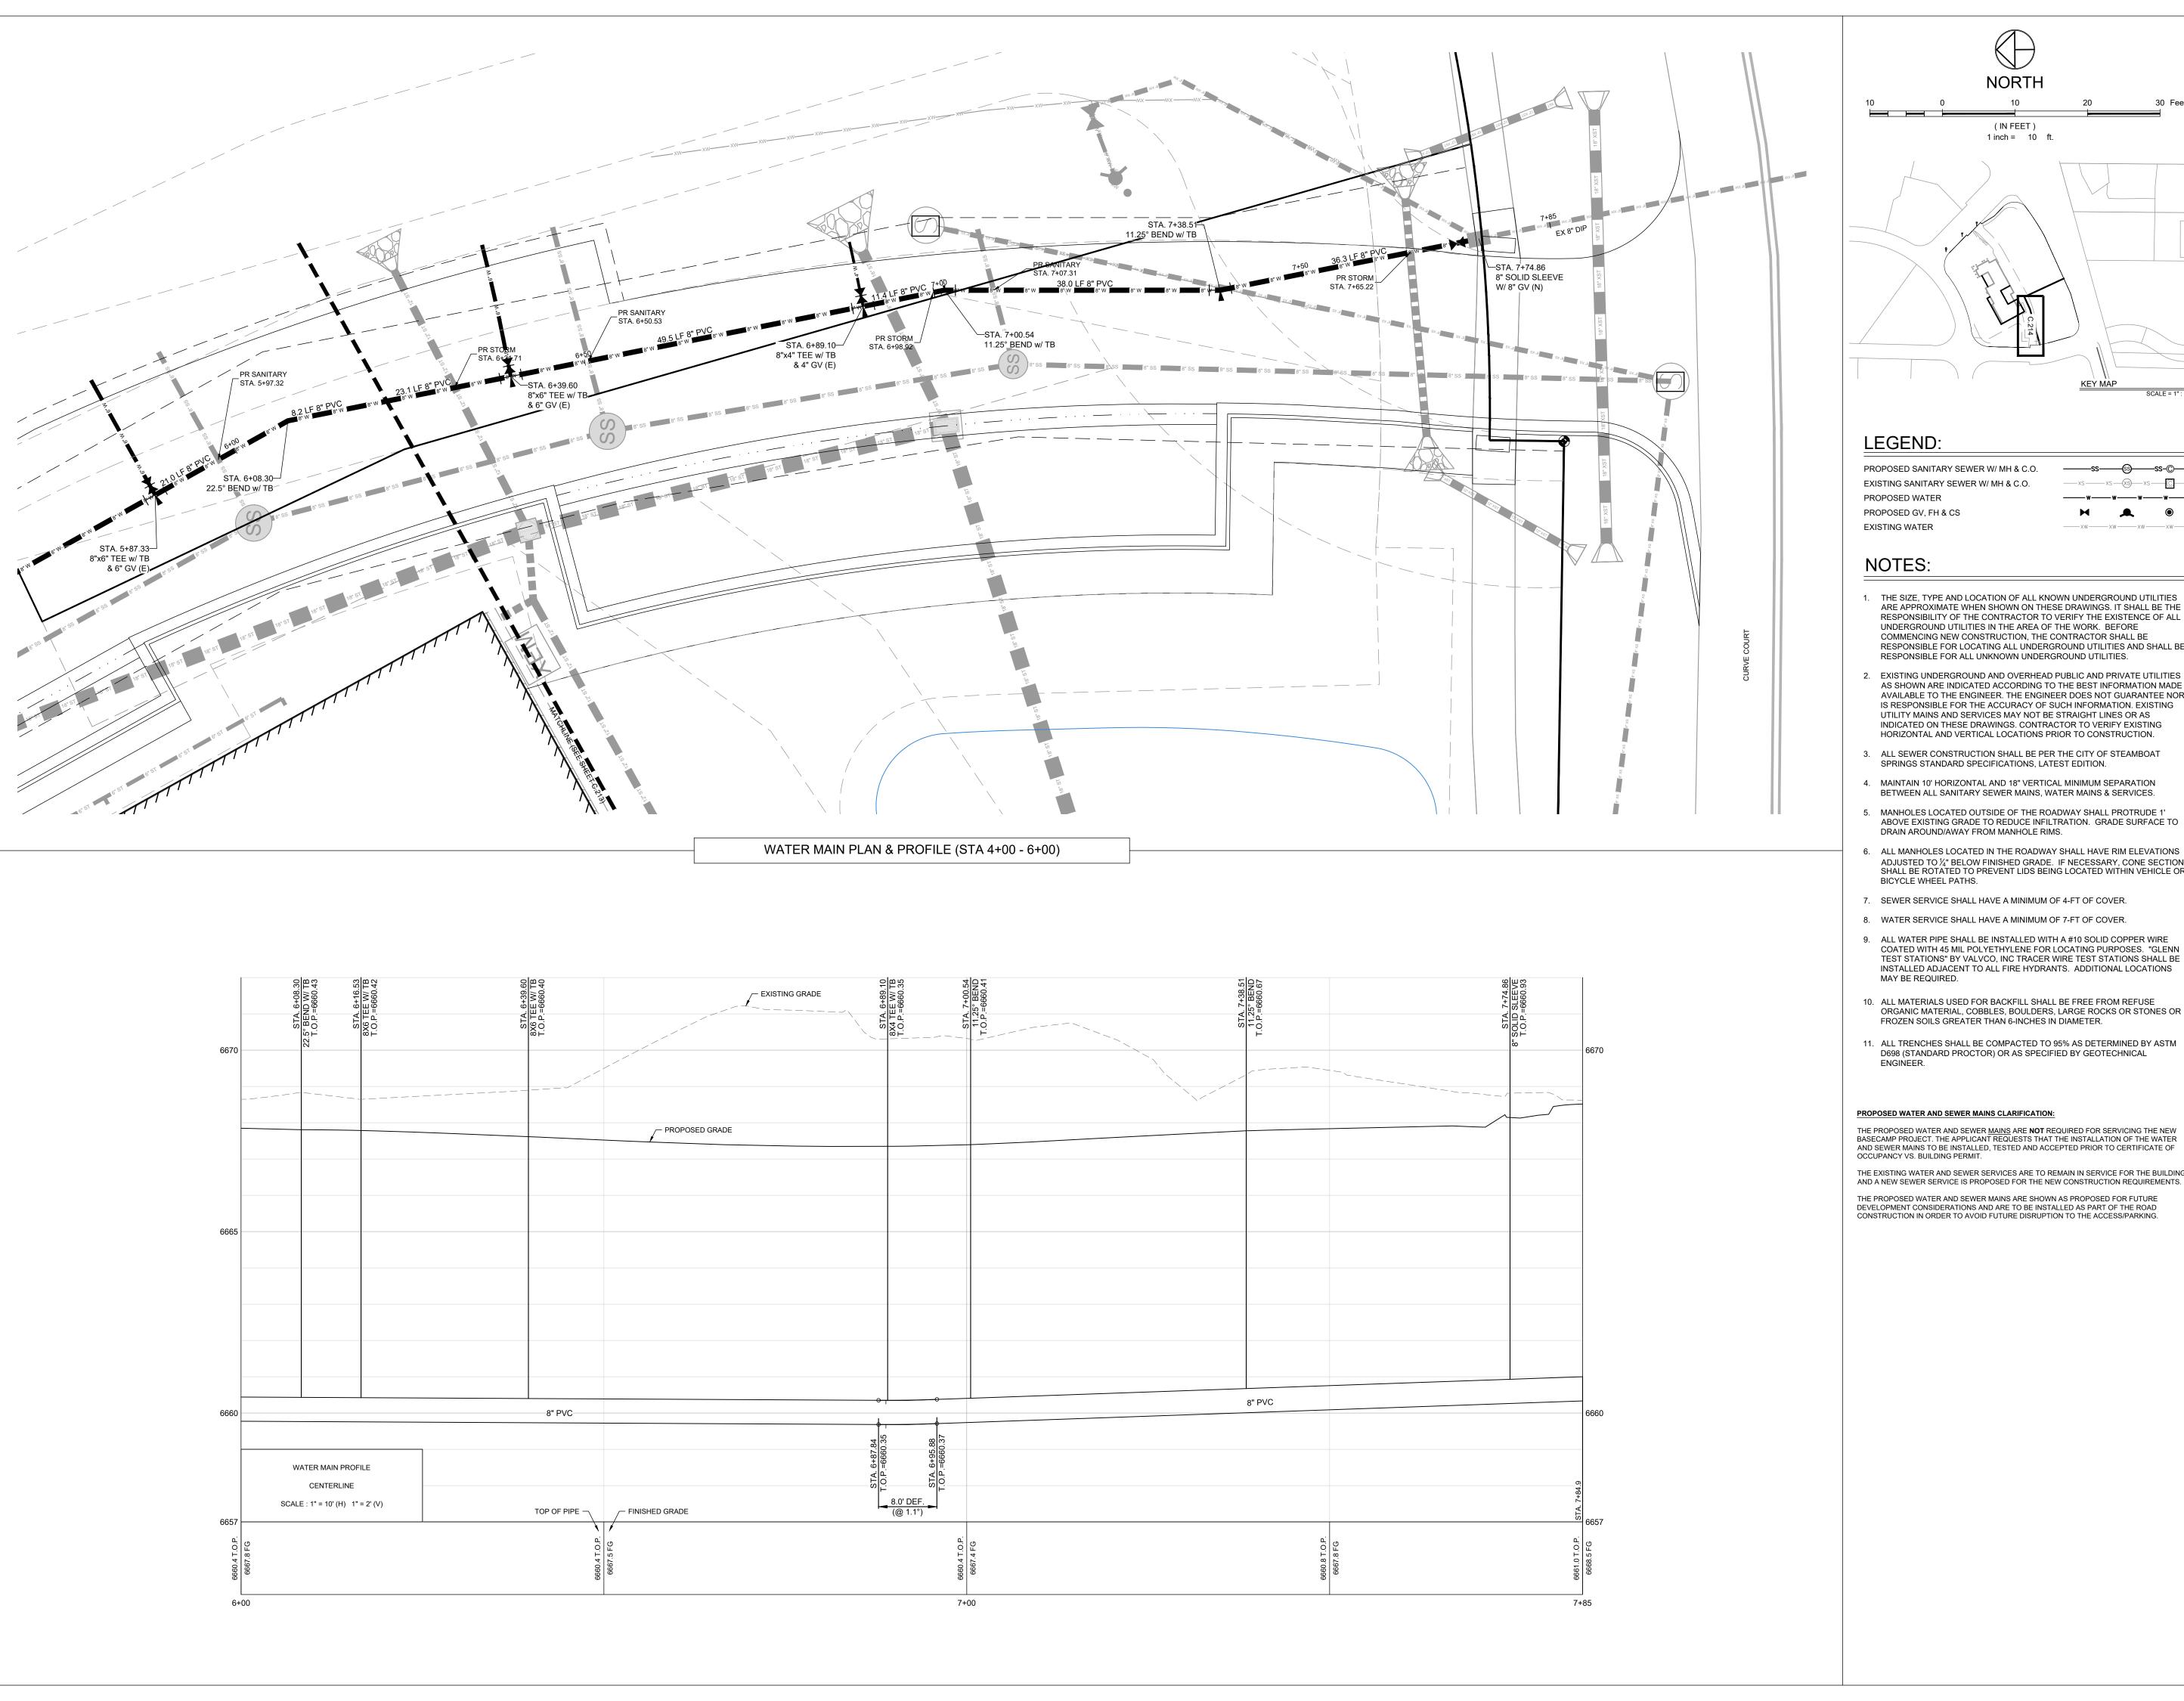
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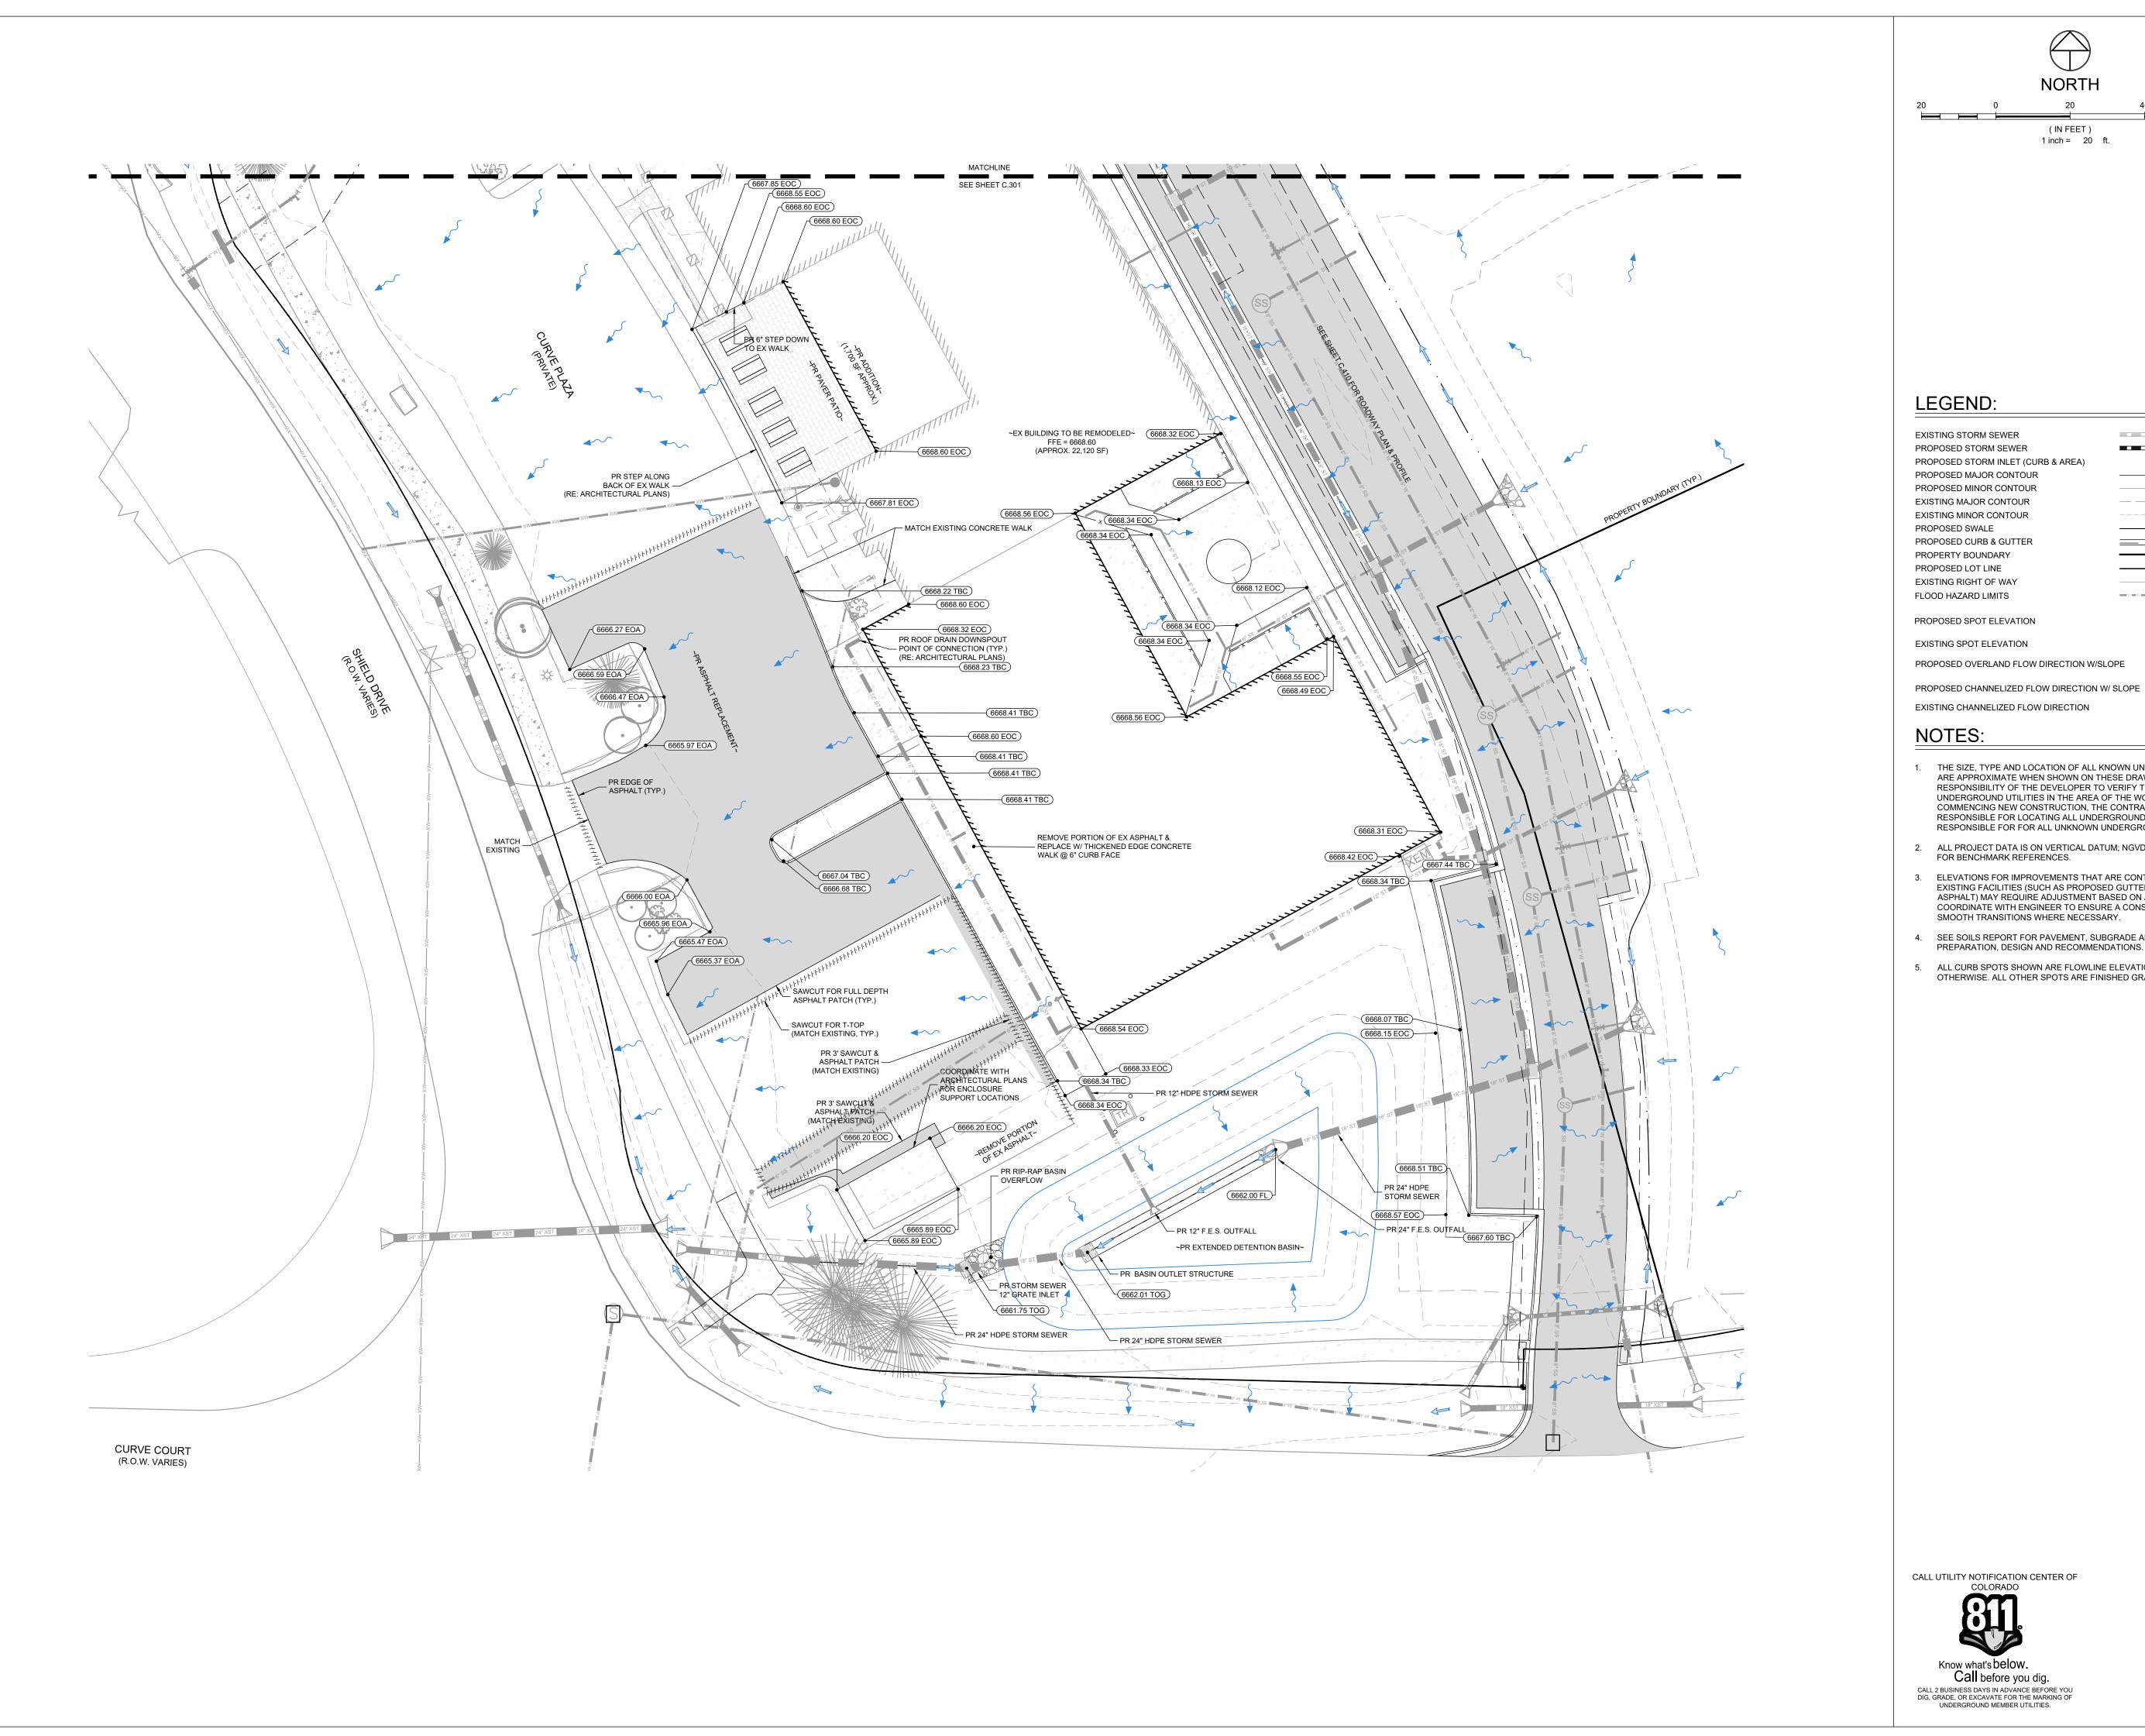
DETAILED GRADING PLAN - OFFSITE


6/18/21 DRAWN BY: CHECKED BY: EG

2387-004 DRAWING NO: C.301
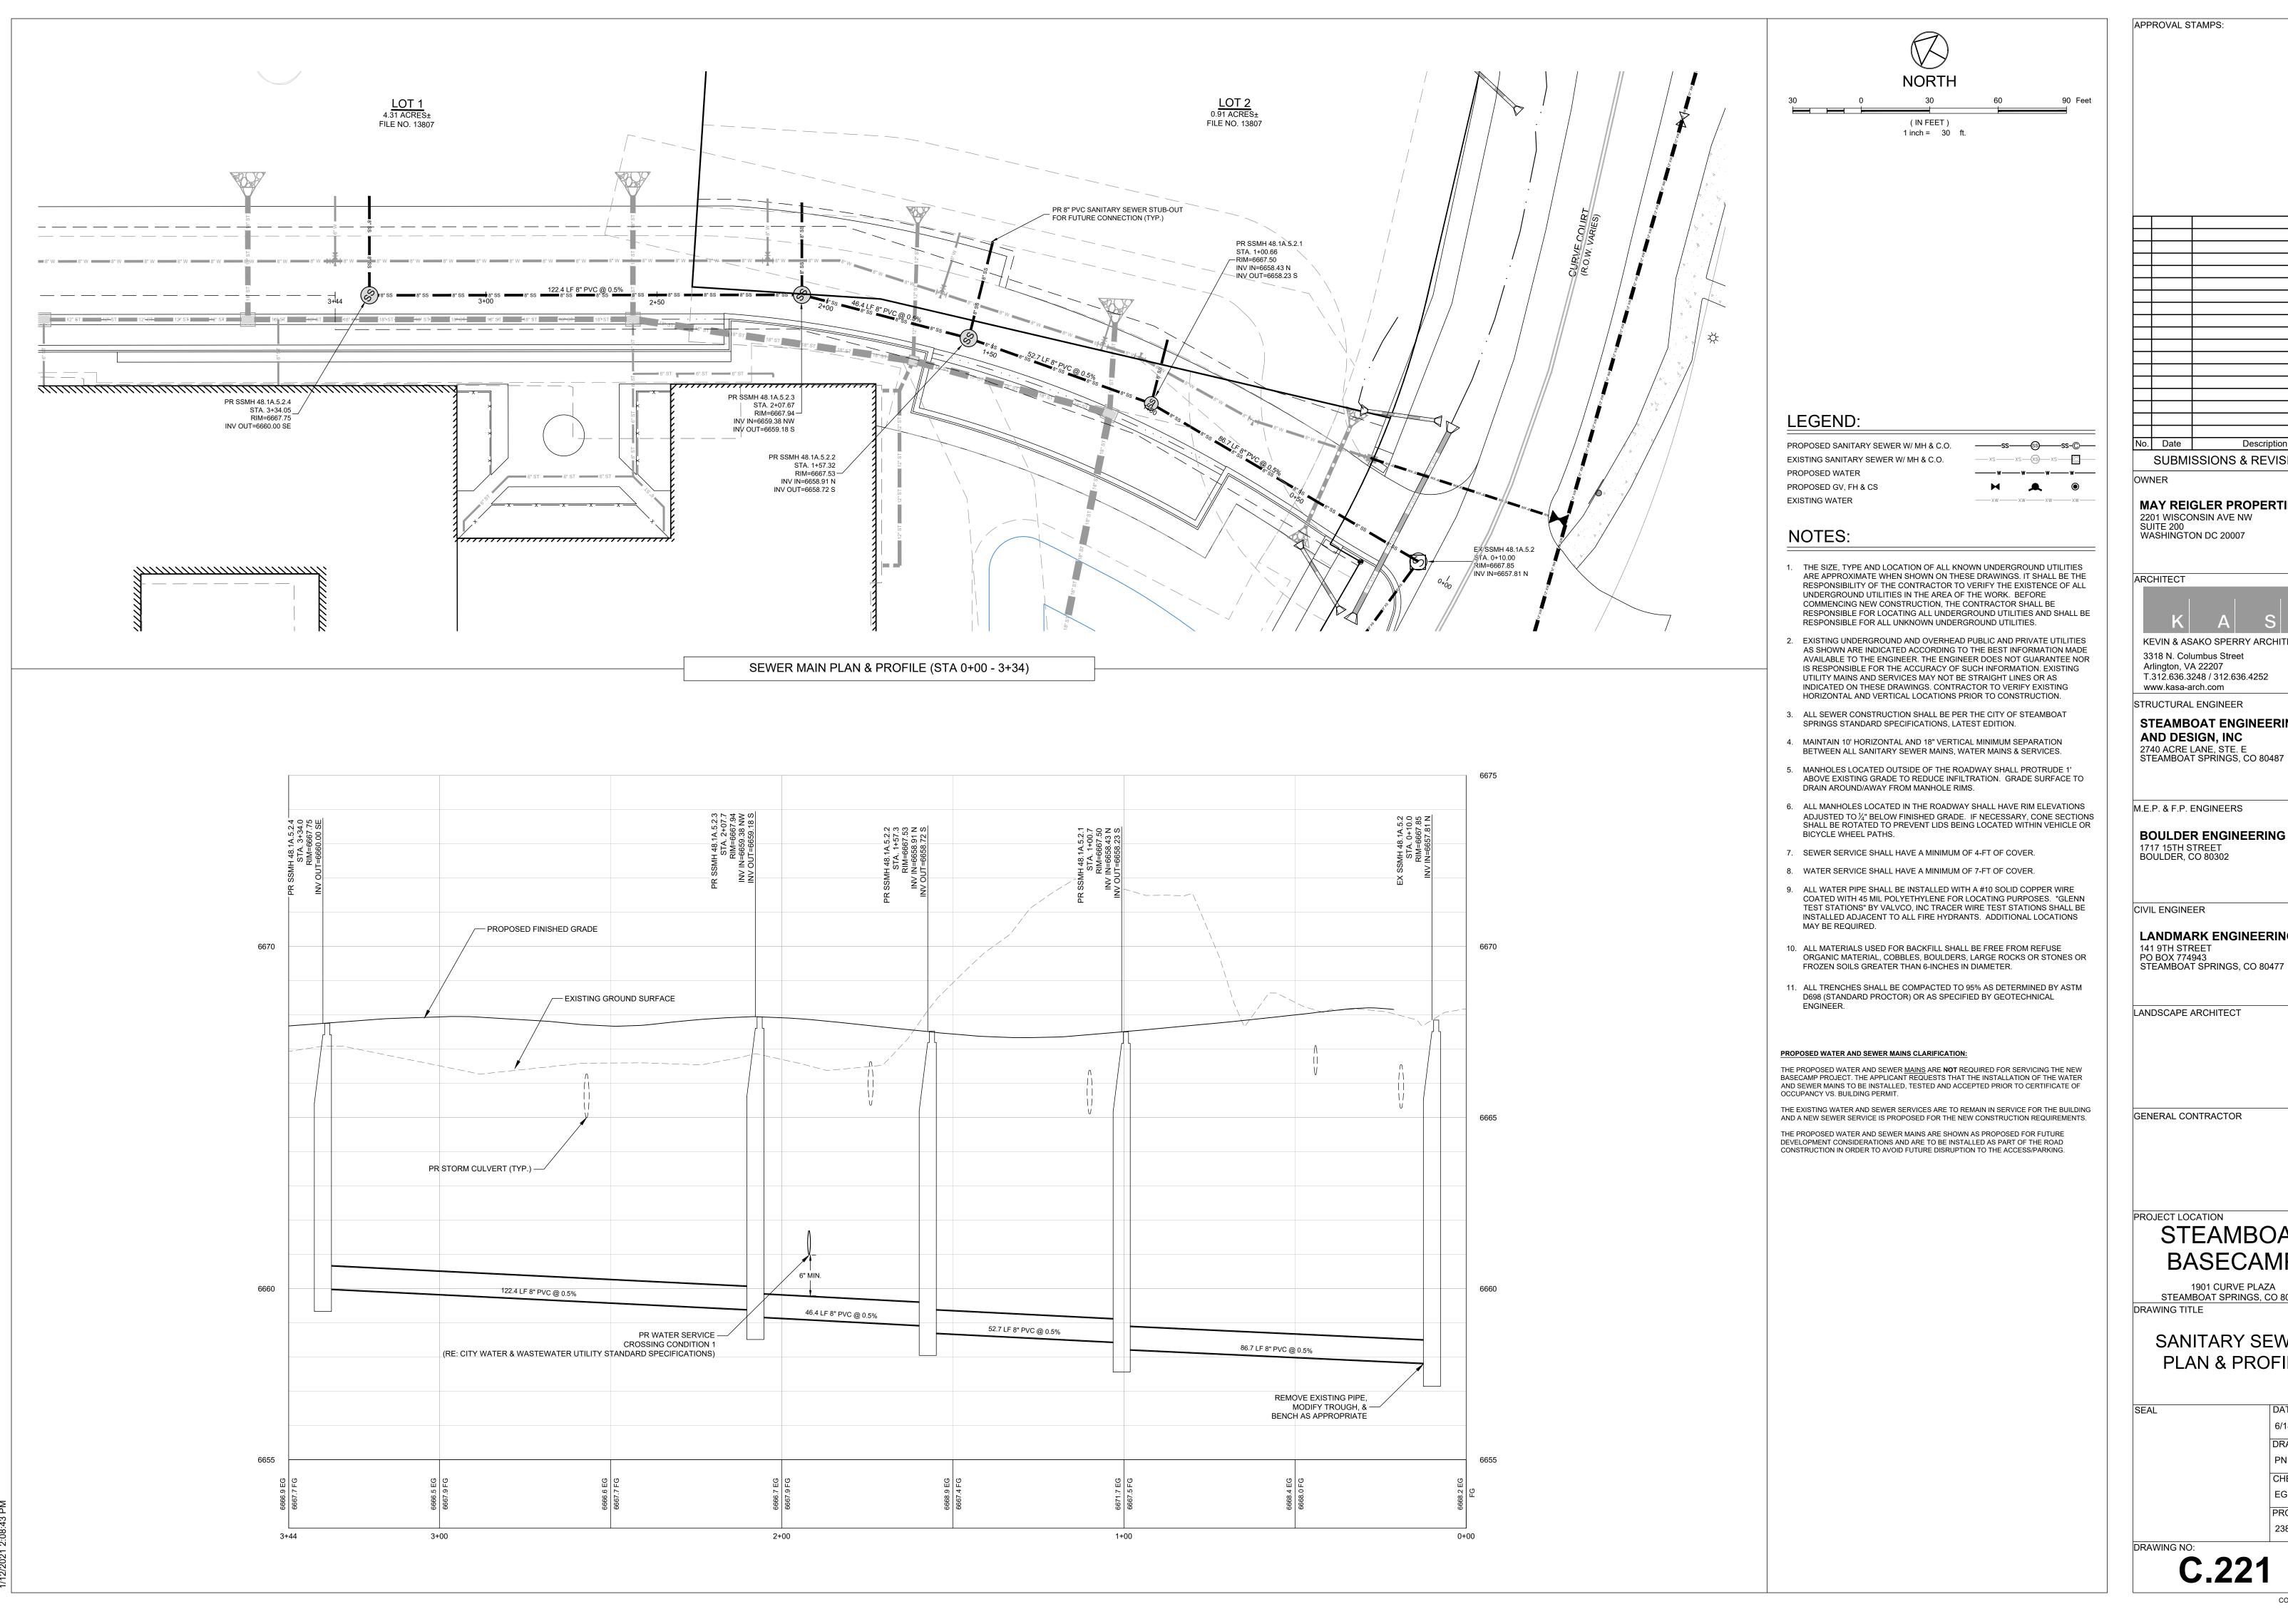
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PROJECT NO:



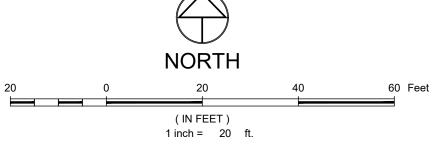

#### LEGEND:

EXISTING STORM SEWER PROPOSED STORM SEWER . . . . . . . . . . PROPOSED STORM INLET (CURB & AREA) PROPOSED MAJOR CONTOUR PROPOSED MINOR CONTOUR EXISTING MAJOR CONTOUR — — — 6805 — — — — EXISTING MINOR CONTOUR PROPOSED SWALE PROPOSED CURB & GUTTER PROPERTY BOUNDARY PROPOSED LOT LINE EXISTING RIGHT OF WAY FLOOD HAZARD LIMITS 00.10 PROPOSED SPOT ELEVATION EXISTING SPOT ELEVATION 00.10 X PROPOSED OVERLAND FLOW DIRECTION W/SLOPE

#### NOTES:

- 1. THE SIZE, TYPE AND LOCATION OF ALL KNOWN UNDERGROUND UTILITIES ARE APPROXIMATE WHEN SHOWN ON THESE DRAWINGS. IT SHALL BE THE RESPONSIBILITY OF THE DEVELOPER TO VERIFY THE EXISTENCE OF ALL UNDERGROUND UTILITIES IN THE AREA OF THE WORK. BEFORE COMMENCING NEW CONSTRUCTION, THE CONTRACTOR SHALL BE RESPONSIBLE FOR LOCATING ALL UNDERGROUND UTILITIES AND SHALL BE RESPONSIBLE FOR FOR ALL UNKNOWN UNDERGROUND UTILITIES.
- 2. ALL PROJECT DATA IS ON VERTICAL DATUM; NGVD 88. SEE NOTES SHEET FOR BENCHMARK REFERENCES.
- 3. ELEVATIONS FOR IMPROVEMENTS THAT ARE CONTROLLED BY ADJACENT EXISTING FACILITIES (SUCH AS PROPOSED GUTTERS ALONG EXISTING ASPHALT) MAY REQUIRE ADJUSTMENT BASED ON ACTUAL CONDITIONS. COORDINATE WITH ENGINEER TO ENSURE A CONSISTENT SECTION WITH SMOOTH TRANSITIONS WHERE NECESSARY.
- 4. SEE SOILS REPORT FOR PAVEMENT, SUBGRADE AND MATERIAL PREPARATION, DESIGN AND RECOMMENDATIONS.
- 5. ALL CURB SPOTS SHOWN ARE FLOWLINE ELEVATIONS, UNLESS NOTED OTHERWISE. ALL OTHER SPOTS ARE FINISHED GRADE ELEVATIONS.

No. Date Description SUBMISSIONS & REVISIONS

APPROVAL STAMPS:

OWNER

MAY REIGLER PROPERTIES 2201 WISCONSIN AVE NW SUITE 200 WASHINGTON DC 20007

ARCHITECT



KEVIN & ASAKO SPERRY ARCHITECTURE 3318 N. Columbus Street Arlington, VA 22207 T.312.636.3248 / 312.636.4252

STRUCTURAL ENGINEER

www.kasa-arch.com

STEAMBOAT ENGINEERING AND DESIGN, INC 2740 ACRE LANE, STE. E STEAMBOAT SPRINGS, CO 80487

M.E.P. & F.P. ENGINEERS

**BOULDER ENGINEERING** 1717 15TH STREET BOULDER, CO 80302

CIVIL ENGINEER

LANDMARK ENGINEERING
141 9TH STREET

PO BOX 774943 STEAMBOAT SPRINGS, CO 80477

LANDSCAPE ARCHITECT

GENERAL CONTRACTOR

PROJECT LOCATION

STEAMBOAT BASECAMP

1901 CURVE PLAZA STEAMBOAT SPRINGS, CO 80487 DRAWING TITLE


DETAILED GRADING PLAN - ONSITE

6/18/21 DRAWN BY: CHECKED BY: EG

2387-004 DRAWING NO:

C.302

PROJECT NO:

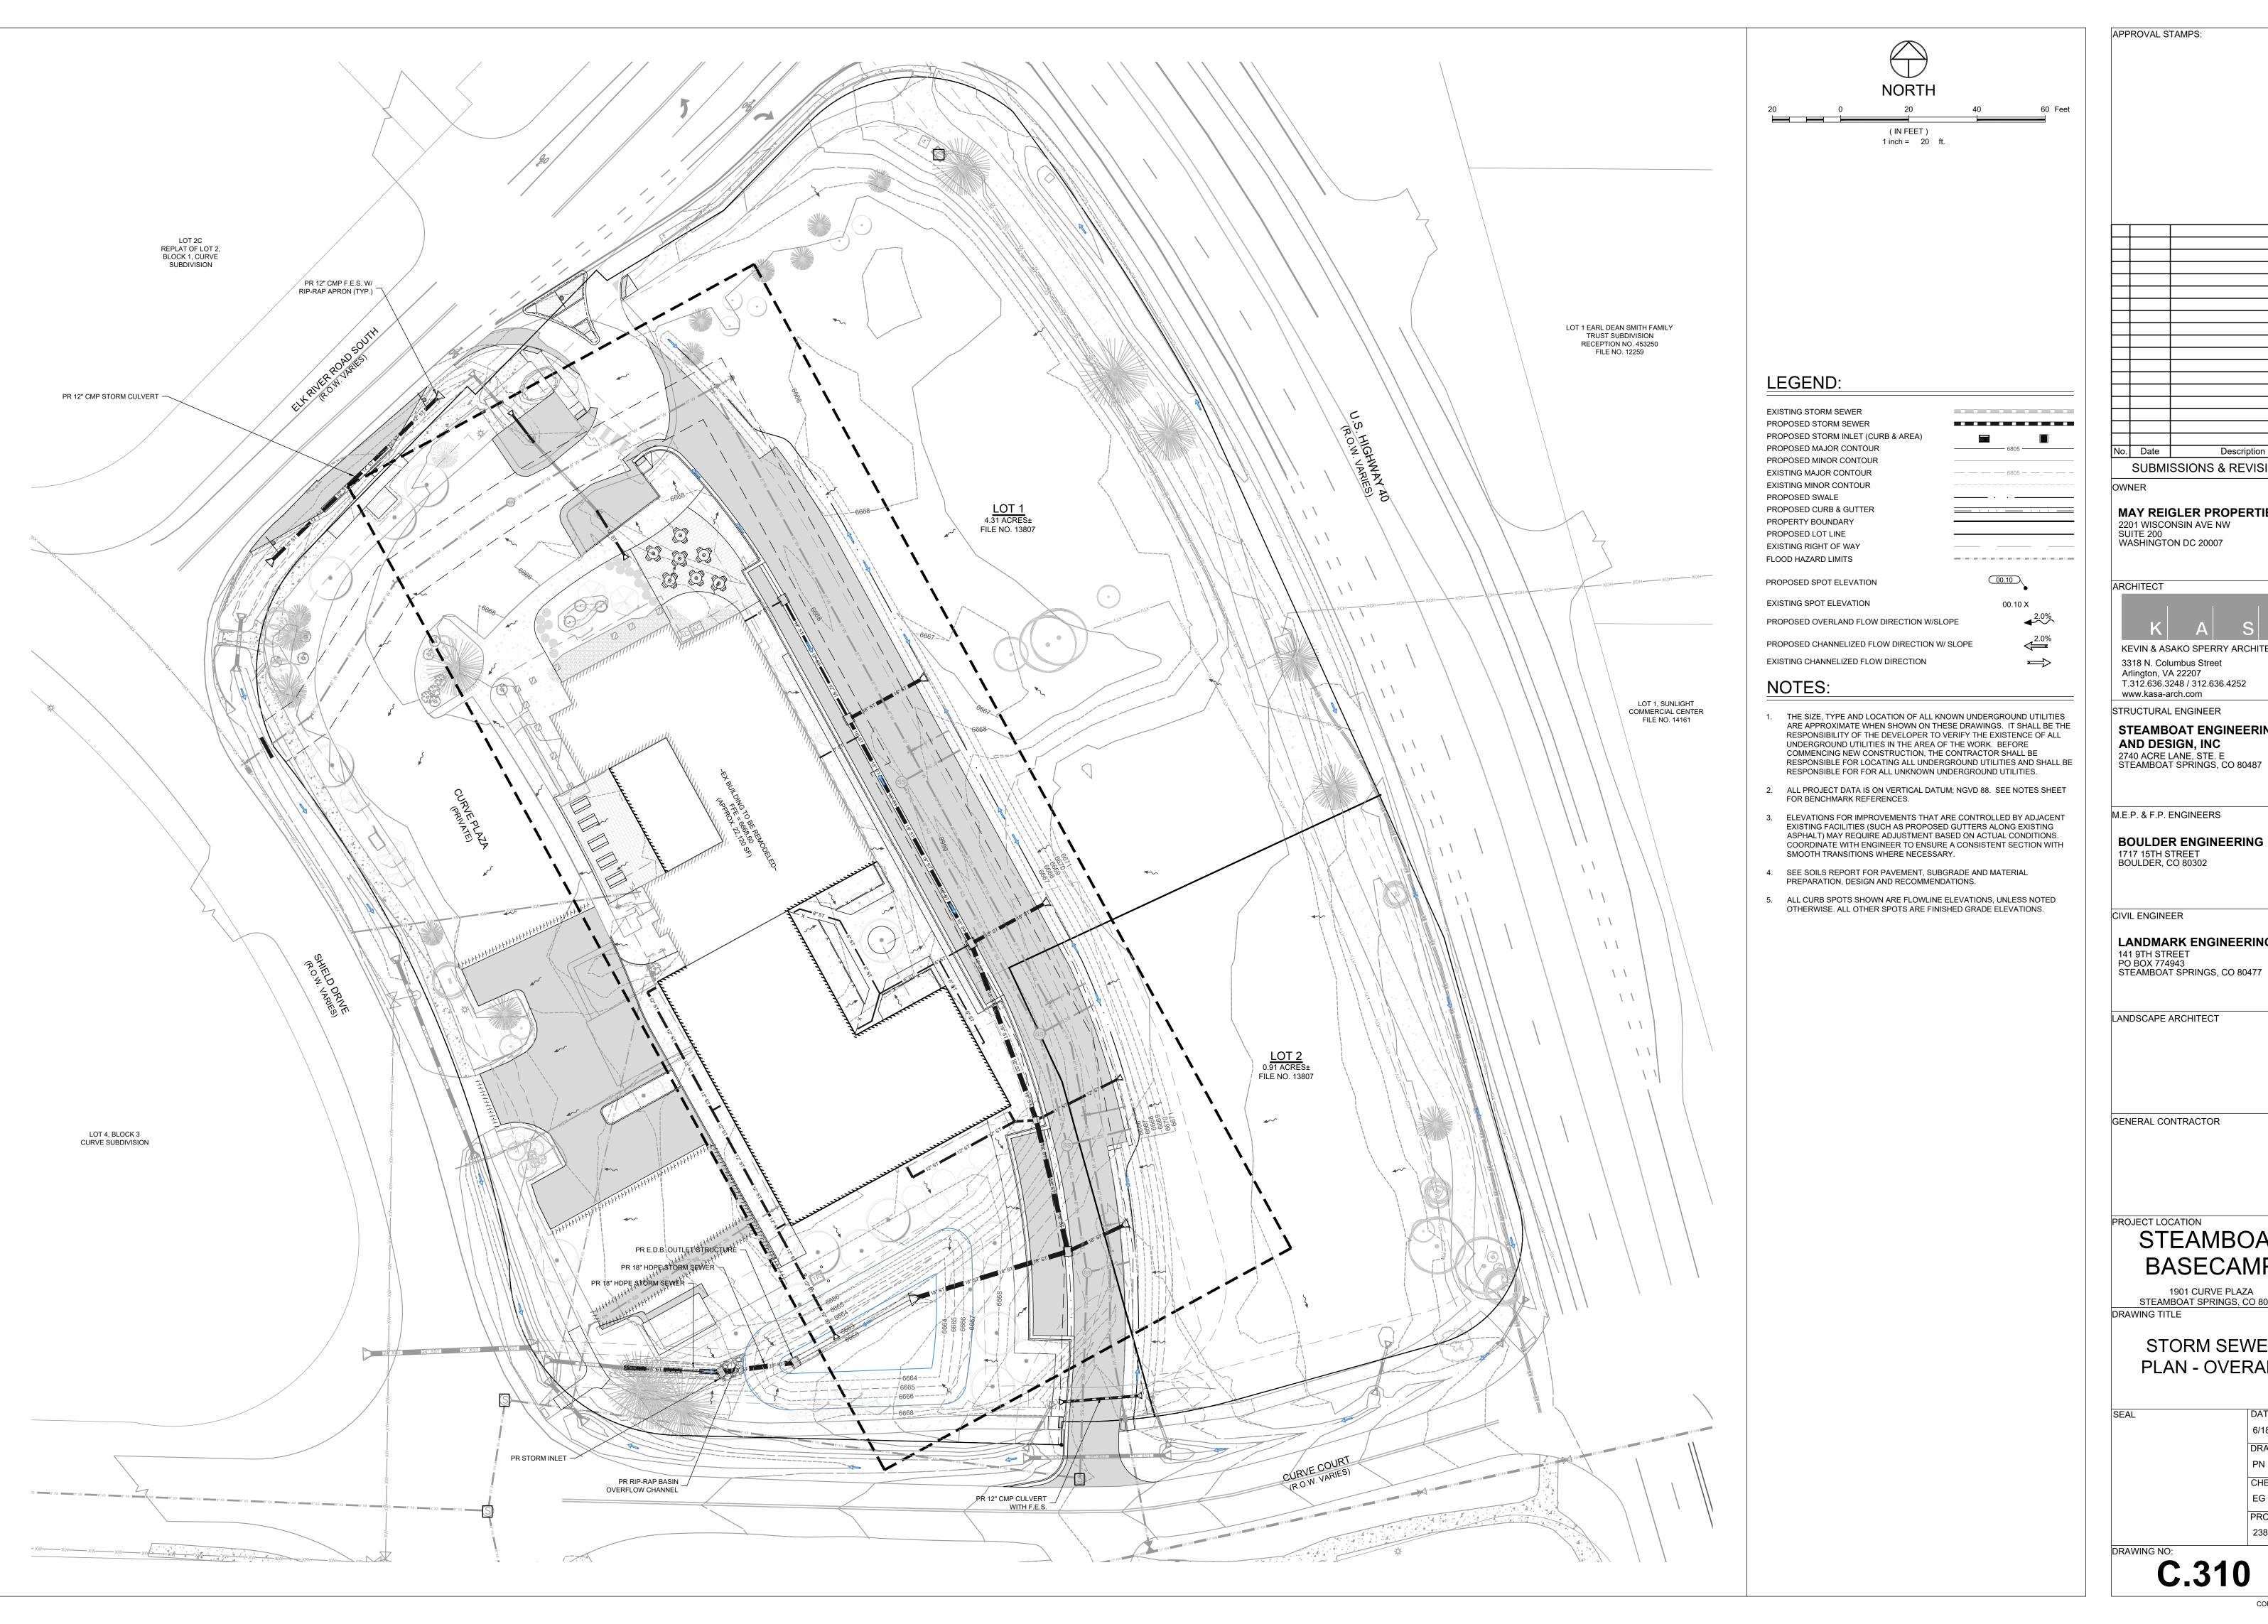

APPROVAL STAMPS: No. Date Description SUBMISSIONS & REVISIONS OWNER MAY REIGLER PROPERTIES 2201 WISCONSIN AVE NW SUITE 200 WASHINGTON DC 20007 ARCHITECT KEVIN & ASAKO SPERRY ARCHITECTURE 3318 N. Columbus Street Arlington, VA 22207 T.312.636.3248 / 312.636.4252 www.kasa-arch.com STRUCTURAL ENGINEER STEAMBOAT ENGINEERING AND DESIGN, INC 2740 ACRE LANE, STE. E STEAMBOAT SPRINGS, CO 80487 M.E.P. & F.P. ENGINEERS

1717 15TH STREET BOULDER, CO 80302

CIVIL ENGINEER

LANDMARK ENGINEERING
141 9TH STREET
PO BOX 774943
STEAMBOAT SPRINGS, CO 80477

LANDSCAPE ARCHITECT

GENERAL CONTRACTOR

PROJECT LOCATION


STEAMBOAT BASECAMP

1901 CURVE PLAZA STEAMBOAT SPRINGS, CO 80487 DRAWING TITLE

> STORM SEWER PLAN - OVERALL

6/18/21 DRAWN BY: CHECKED BY: PROJECT NO: 2387-004

C.310

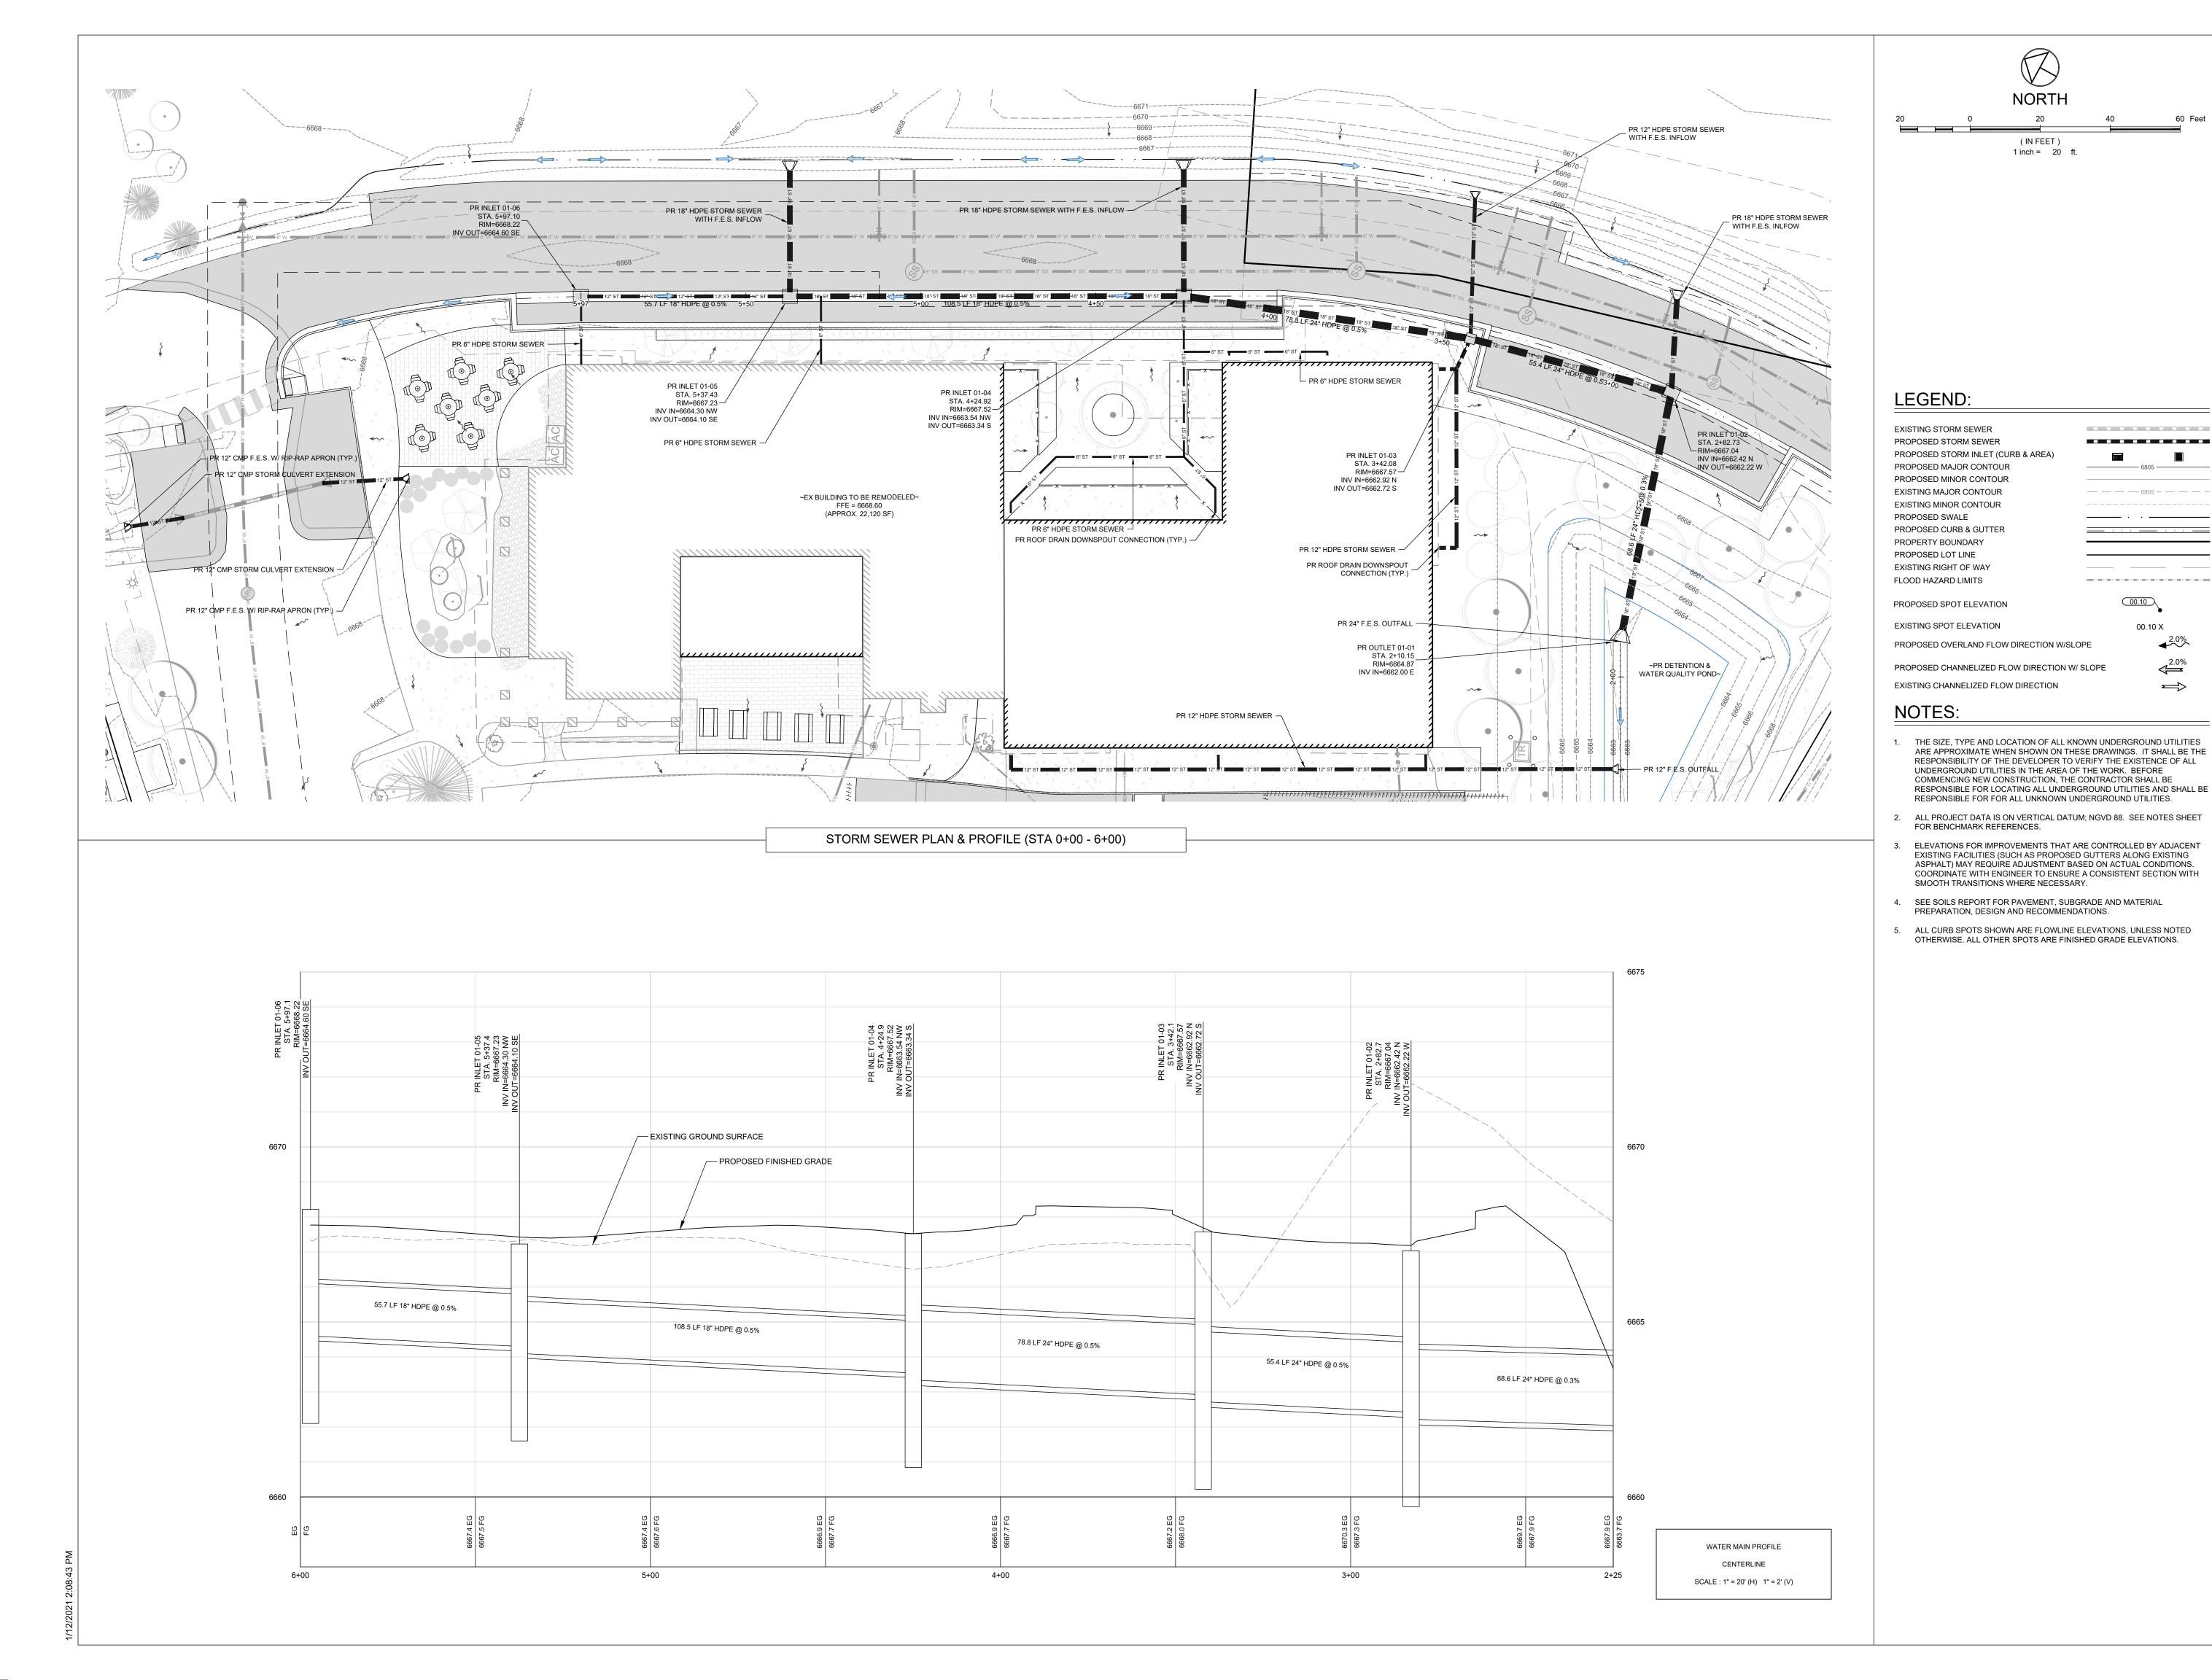

APPROVAL STAMPS: No. Date SUBMISSIONS & REVISIONS OWNER MAY REIGLER PROPERTIES 2201 WISCONSIN AVE NW SUITE 200 WASHINGTON DC 20007 ARCHITECT KEVIN & ASAKO SPERRY ARCHITECTURE 3318 N. Columbus Street Arlington, VA 22207 T.312.636.3248 / 312.636.4252 www.kasa-arch.com STRUCTURAL ENGINEER STEAMBOAT ENGINEERING **AND DESIGN, INC** 2740 ACRE LANE, STE. E STEAMBOAT SPRINGS, CO 80487

Description

M.E.P. & F.P. ENGINEERS

**BOULDER ENGINEERING** 

CIVIL ENGINEER

1717 15TH STREET BOULDER, CO 80302

LANDMARK ENGINEERING
141 9TH STREET PO BOX 774943 STEAMBOAT SPRINGS, CO 80477

LANDSCAPE ARCHITECT

GENERAL CONTRACTOR

PROJECT LOCATION STEAMBOAT


BASECAMP

1901 CURVE PLAZA STEAMBOAT SPRINGS, CO 80487 DRAWING TITLE

> STORM SEWER PLAN & PROFILE

6/18/21 DRAWN BY: CHECKED BY: PROJECT NO: 2387-004

DRAWING NO: C.311

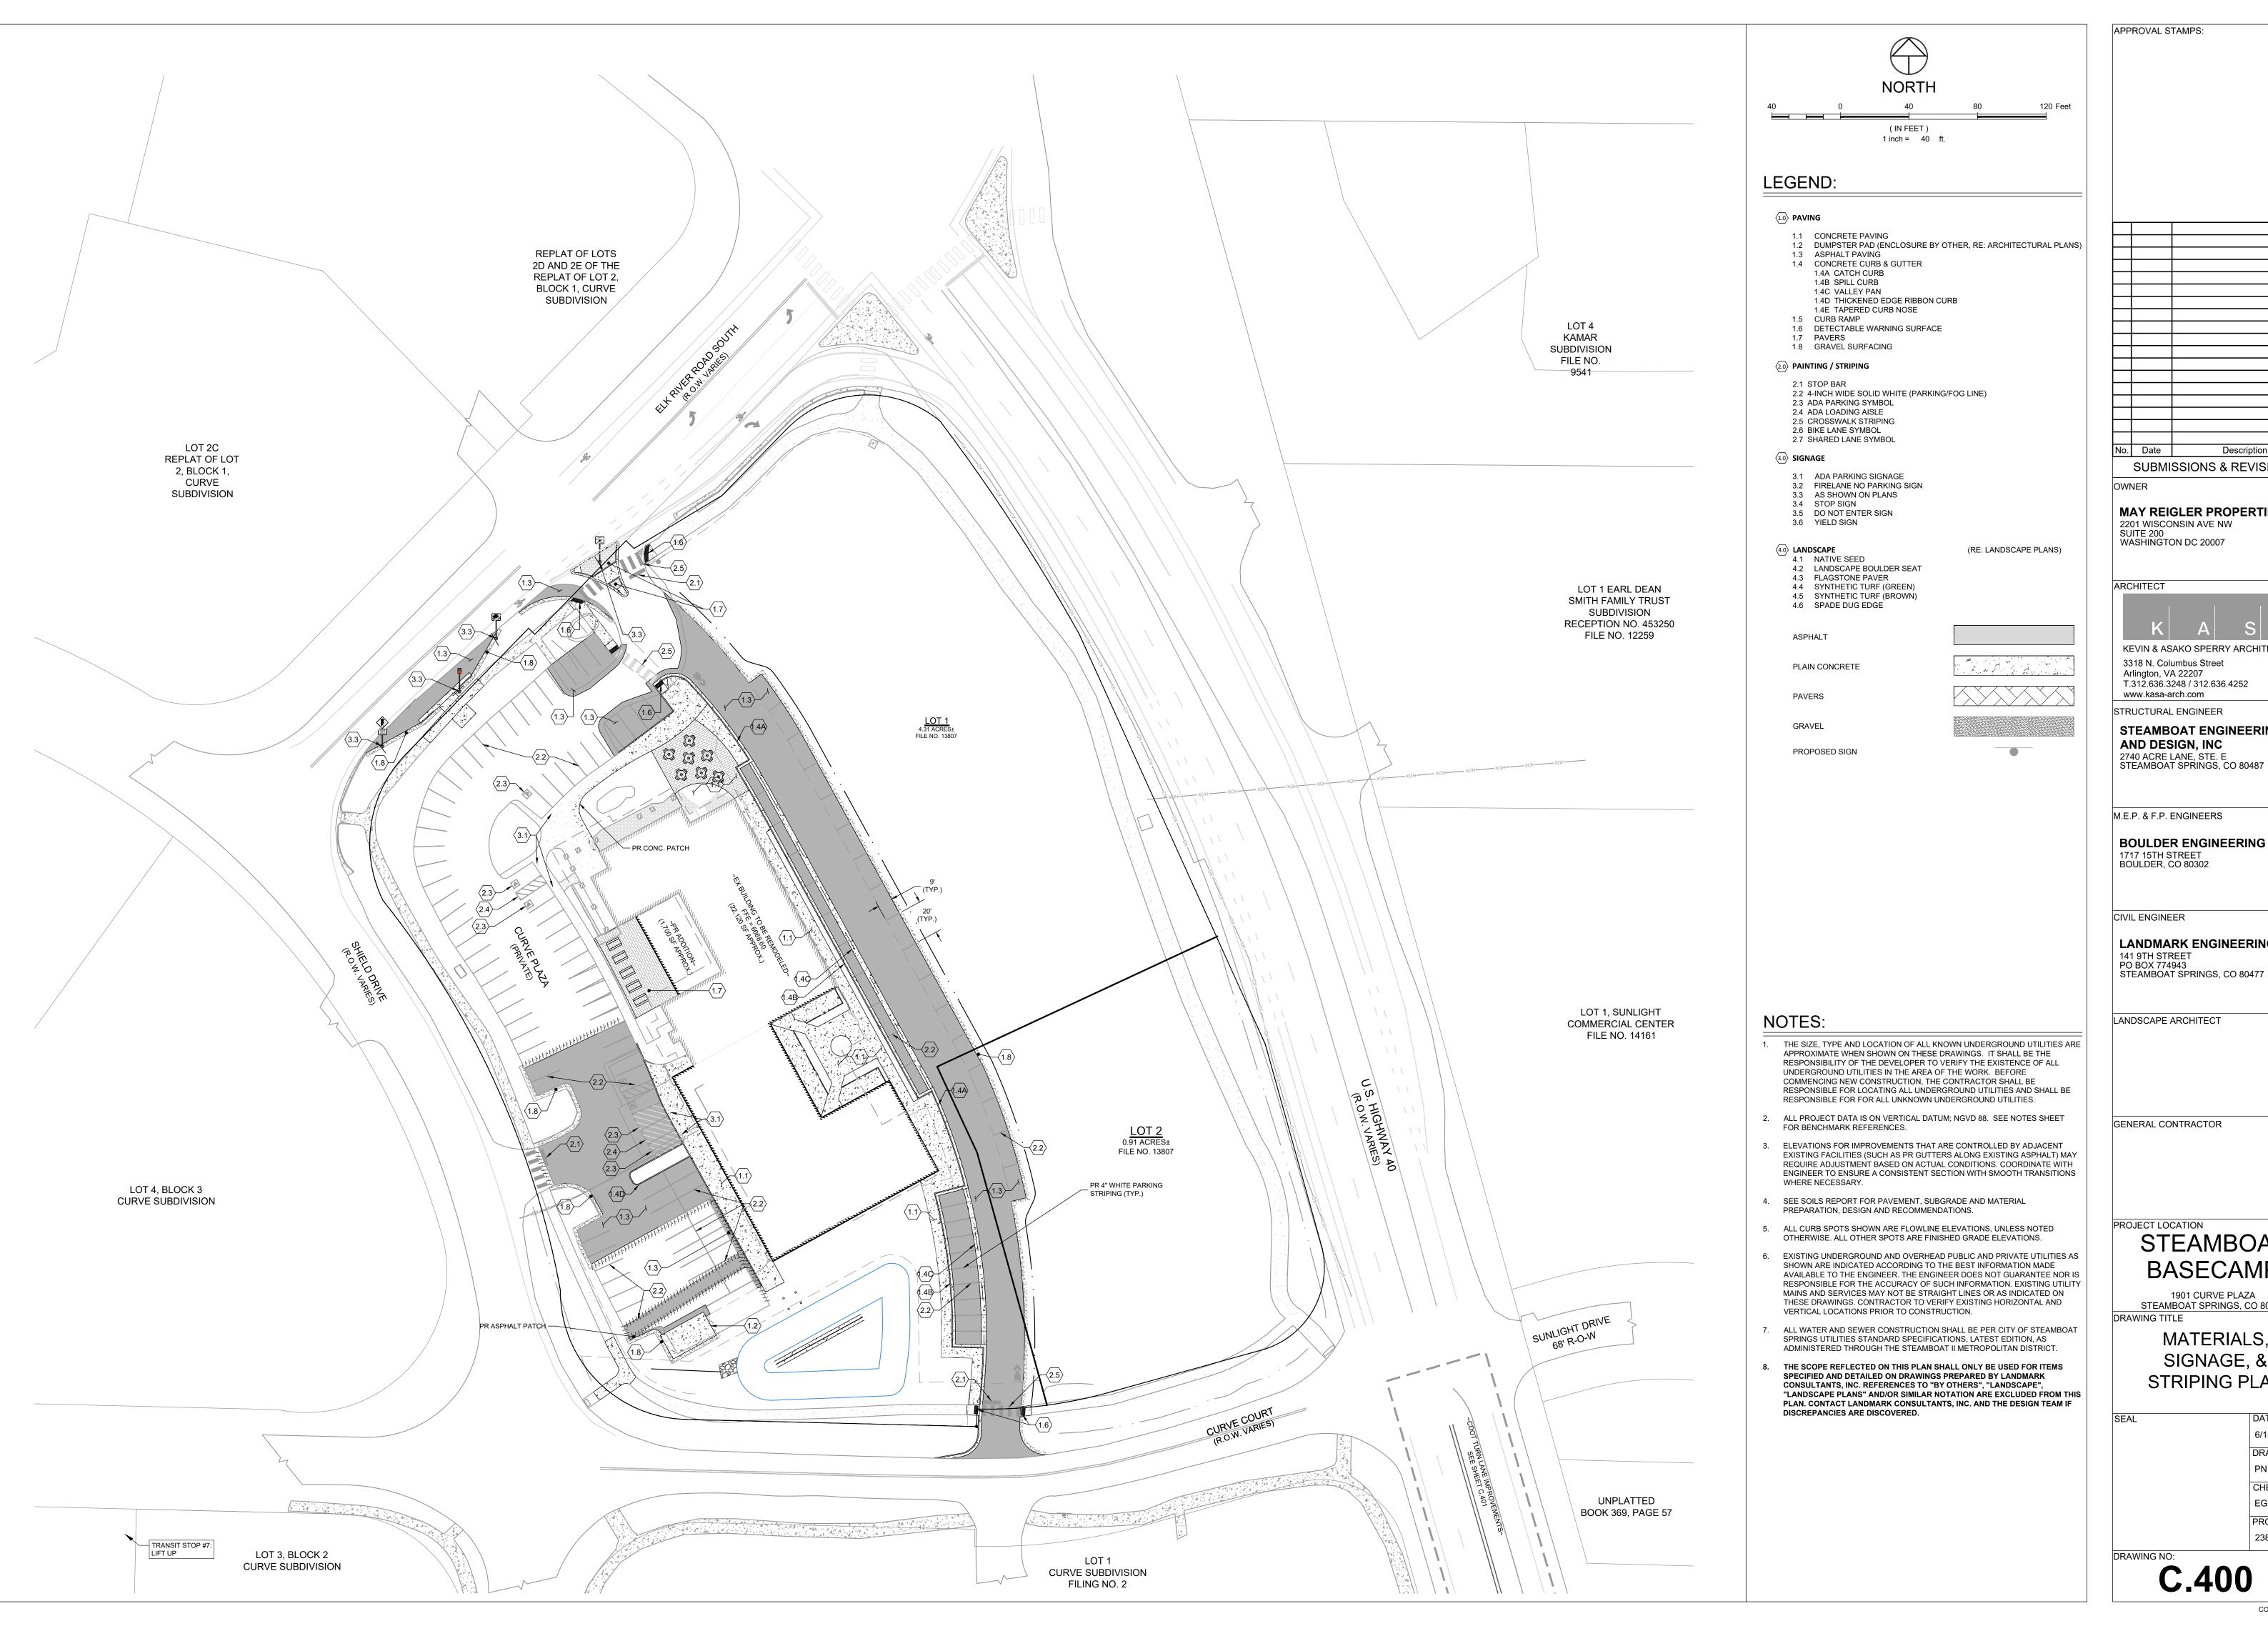

No. Date Description SUBMISSIONS & REVISIONS

MAY REIGLER PROPERTIES

2201 WISCONSIN AVE NW SUITE 200 WASHINGTON DC 20007

KEVIN & ASAKO SPERRY ARCHITECTURE 3318 N. Columbus Street Arlington, VA 22207 T.312.636.3248 / 312.636.4252 www.kasa-arch.com

STRUCTURAL ENGINEER

STEAMBOAT ENGINEERING AND DESIGN, INC 2740 ACRE LANE, STE. E STEAMBOAT SPRINGS, CO 80487

1717 15TH STREET BOULDER, CO 80302

CIVIL ENGINEER

LANDMARK ENGINEERING 141 9TH STREET PO BOX 774943 STEAMBOAT SPRINGS, CO 80477

LANDSCAPE ARCHITECT

GENERAL CONTRACTOR

### STEAMBOAT BASECAMP

1901 CURVE PLAZA STEAMBOAT SPRINGS, CO 80487 DRAWING TITLE


MATERIALS,


SIGNAGE, & STRIPING PLAN

6/18/21 DRAWN BY: CHECKED BY: PROJECT NO:

C.400

2387-004

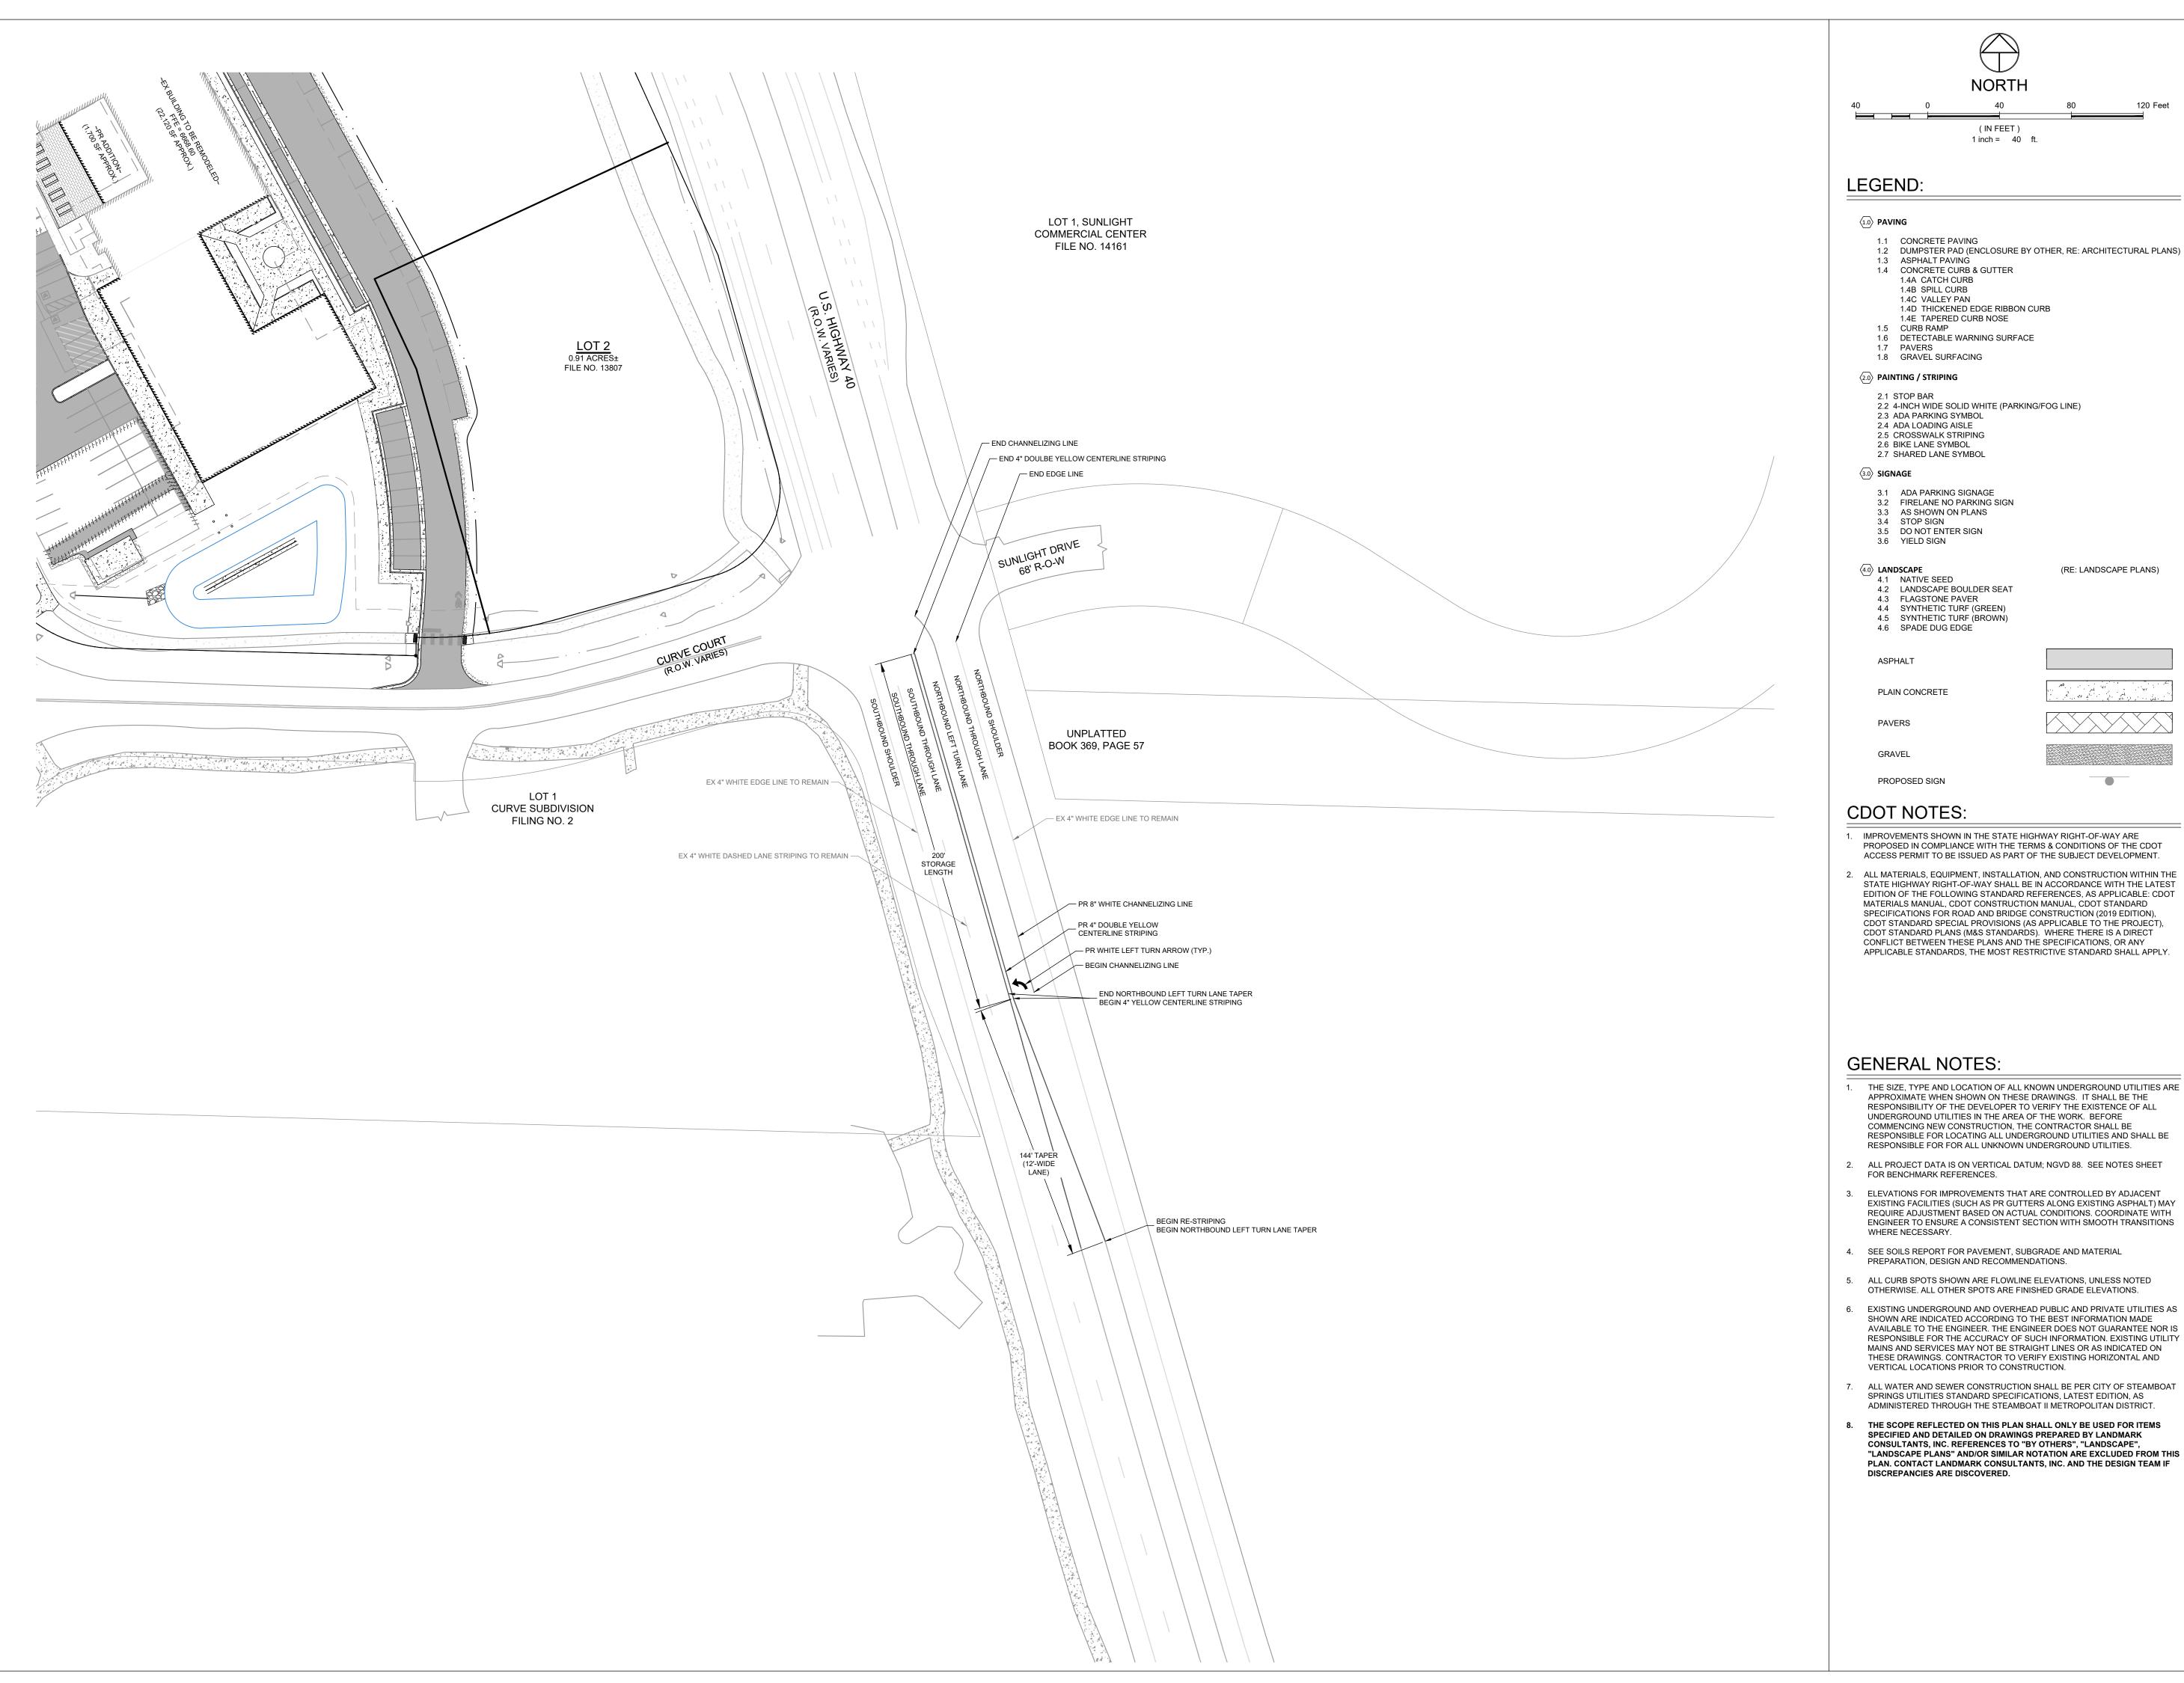

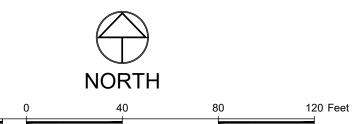

- 1.1 CONCRETE PAVING
- 1.3 ASPHALT PAVING

(IN FEET) 1 inch = 40 ft.

- 1.4 CONCRETE CURB & GUTTER 1.4A CATCH CURB
- 1.4C VALLEY PAN 1.4D THICKENED EDGE RIBBON CURB
- 1.6 DETECTABLE WARNING SURFACE

- 2.2 4-INCH WIDE SOLID WHITE (PARKING/FOG LINE)
- 2.5 CROSSWALK STRIPING
- 3.1 ADA PARKING SIGNAGE
- 3.3 AS SHOWN ON PLANS

- 4.2 LANDSCAPE BOULDER SEAT
- 4.4 SYNTHETIC TURF (GREEN)

- 1. IMPROVEMENTS SHOWN IN THE STATE HIGHWAY RIGHT-OF-WAY ARE PROPOSED IN COMPLIANCE WITH THE TERMS & CONDITIONS OF THE CDOT ACCESS PERMIT TO BE ISSUED AS PART OF THE SUBJECT DEVELOPMENT.
- 2. ALL MATERIALS, EQUIPMENT, INSTALLATION, AND CONSTRUCTION WITHIN THE STATE HIGHWAY RIGHT-OF-WAY SHALL BE IN ACCORDANCE WITH THE LATEST EDITION OF THE FOLLOWING STANDARD REFERENCES, AS APPLICABLE: CDOT MATERIALS MANUAL, CDOT CONSTRUCTION MANUAL, CDOT STANDARD SPECIFICATIONS FOR ROAD AND BRIDGE CONSTRUCTION (2019 EDITION), CDOT STANDARD SPECIAL PROVISIONS (AS APPLICABLE TO THE PROJECT), CDOT STANDARD PLANS (M&S STANDARDS). WHERE THERE IS A DIRECT CONFLICT BETWEEN THESE PLANS AND THE SPECIFICATIONS, OR ANY

#### **GENERAL NOTES:**

- 1. THE SIZE, TYPE AND LOCATION OF ALL KNOWN UNDERGROUND UTILITIES ARE APPROXIMATE WHEN SHOWN ON THESE DRAWINGS. IT SHALL BE THE RESPONSIBILITY OF THE DEVELOPER TO VERIFY THE EXISTENCE OF ALL UNDERGROUND UTILITIES IN THE AREA OF THE WORK. BEFORE COMMENCING NEW CONSTRUCTION, THE CONTRACTOR SHALL BE RESPONSIBLE FOR LOCATING ALL UNDERGROUND UTILITIES AND SHALL BE
- 2. ALL PROJECT DATA IS ON VERTICAL DATUM; NGVD 88. SEE NOTES SHEET FOR BENCHMARK REFERENCES.
- 3. ELEVATIONS FOR IMPROVEMENTS THAT ARE CONTROLLED BY ADJACENT EXISTING FACILITIES (SUCH AS PR GUTTERS ALONG EXISTING ASPHALT) MAY REQUIRE ADJUSTMENT BASED ON ACTUAL CONDITIONS. COORDINATE WITH ENGINEER TO ENSURE A CONSISTENT SECTION WITH SMOOTH TRANSITIONS
- 4. SEE SOILS REPORT FOR PAVEMENT, SUBGRADE AND MATERIAL PREPARATION, DESIGN AND RECOMMENDATIONS.
- OTHERWISE. ALL OTHER SPOTS ARE FINISHED GRADE ELEVATIONS.
- 6. EXISTING UNDERGROUND AND OVERHEAD PUBLIC AND PRIVATE UTILITIES AS SHOWN ARE INDICATED ACCORDING TO THE BEST INFORMATION MADE AVAILABLE TO THE ENGINEER. THE ENGINEER DOES NOT GUARANTEE NOR IS RESPONSIBLE FOR THE ACCURACY OF SUCH INFORMATION. EXISTING UTILITY MAINS AND SERVICES MAY NOT BE STRAIGHT LINES OR AS INDICATED ON THESE DRAWINGS. CONTRACTOR TO VERIFY EXISTING HORIZONTAL AND VERTICAL LOCATIONS PRIOR TO CONSTRUCTION.
- 7. ALL WATER AND SEWER CONSTRUCTION SHALL BE PER CITY OF STEAMBOAT SPRINGS UTILITIES STANDARD SPECIFICATIONS, LATEST EDITION, AS ADMINISTERED THROUGH THE STEAMBOAT II METROPOLITAN DISTRICT.
- 8. THE SCOPE REFLECTED ON THIS PLAN SHALL ONLY BE USED FOR ITEMS SPECIFIED AND DETAILED ON DRAWINGS PREPARED BY LANDMARK CONSULTANTS, INC. REFERENCES TO "BY OTHERS", "LANDSCAPE", "LANDSCAPE PLANS" AND/OR SIMILAR NOTATION ARE EXCLUDED FROM THIS PLAN. CONTACT LANDMARK CONSULTANTS, INC. AND THE DESIGN TEAM IF DISCREPANCIES ARE DISCOVERED.

APPROVAL STAMPS:

No. Date Description SUBMISSIONS & REVISIONS

MAY REIGLER PROPERTIES

2201 WISCONSIN AVE NW SUITE 200 WASHINGTON DC 20007

ARCHITECT

OWNER

(RE: LANDSCAPE PLANS)



KEVIN & ASAKO SPERRY ARCHITECTURE 3318 N. Columbus Street Arlington, VA 22207 T.312.636.3248 / 312.636.4252

www.kasa-arch.com STRUCTURAL ENGINEER

STEAMBOAT ENGINEERING AND DESIGN, INC 2740 ACRE LANE, STE. E STEAMBOAT SPRINGS, CO 80487

M.E.P. & F.P. ENGINEERS

**BOULDER ENGINEERING** 1717 15TH STREET BOULDER, CO 80302

CIVIL ENGINEER

PO BOX 774943

LANDMARK ENGINEERING 141 9TH STREET

STEAMBOAT SPRINGS, CO 80477

LANDSCAPE ARCHITECT

GENERAL CONTRACTOR

PROJECT LOCATION

STEAMBOAT BASECAMP

1901 CURVE PLAZA STEAMBOAT SPRINGS, CO 80487

DRAWING TITLE OFFSITE MATERIALS, SIGNAGE, &


STRIPING PLAN


6/18/21 DRAWN BY: CHECKED BY:

2387-004

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PROJECT NO:



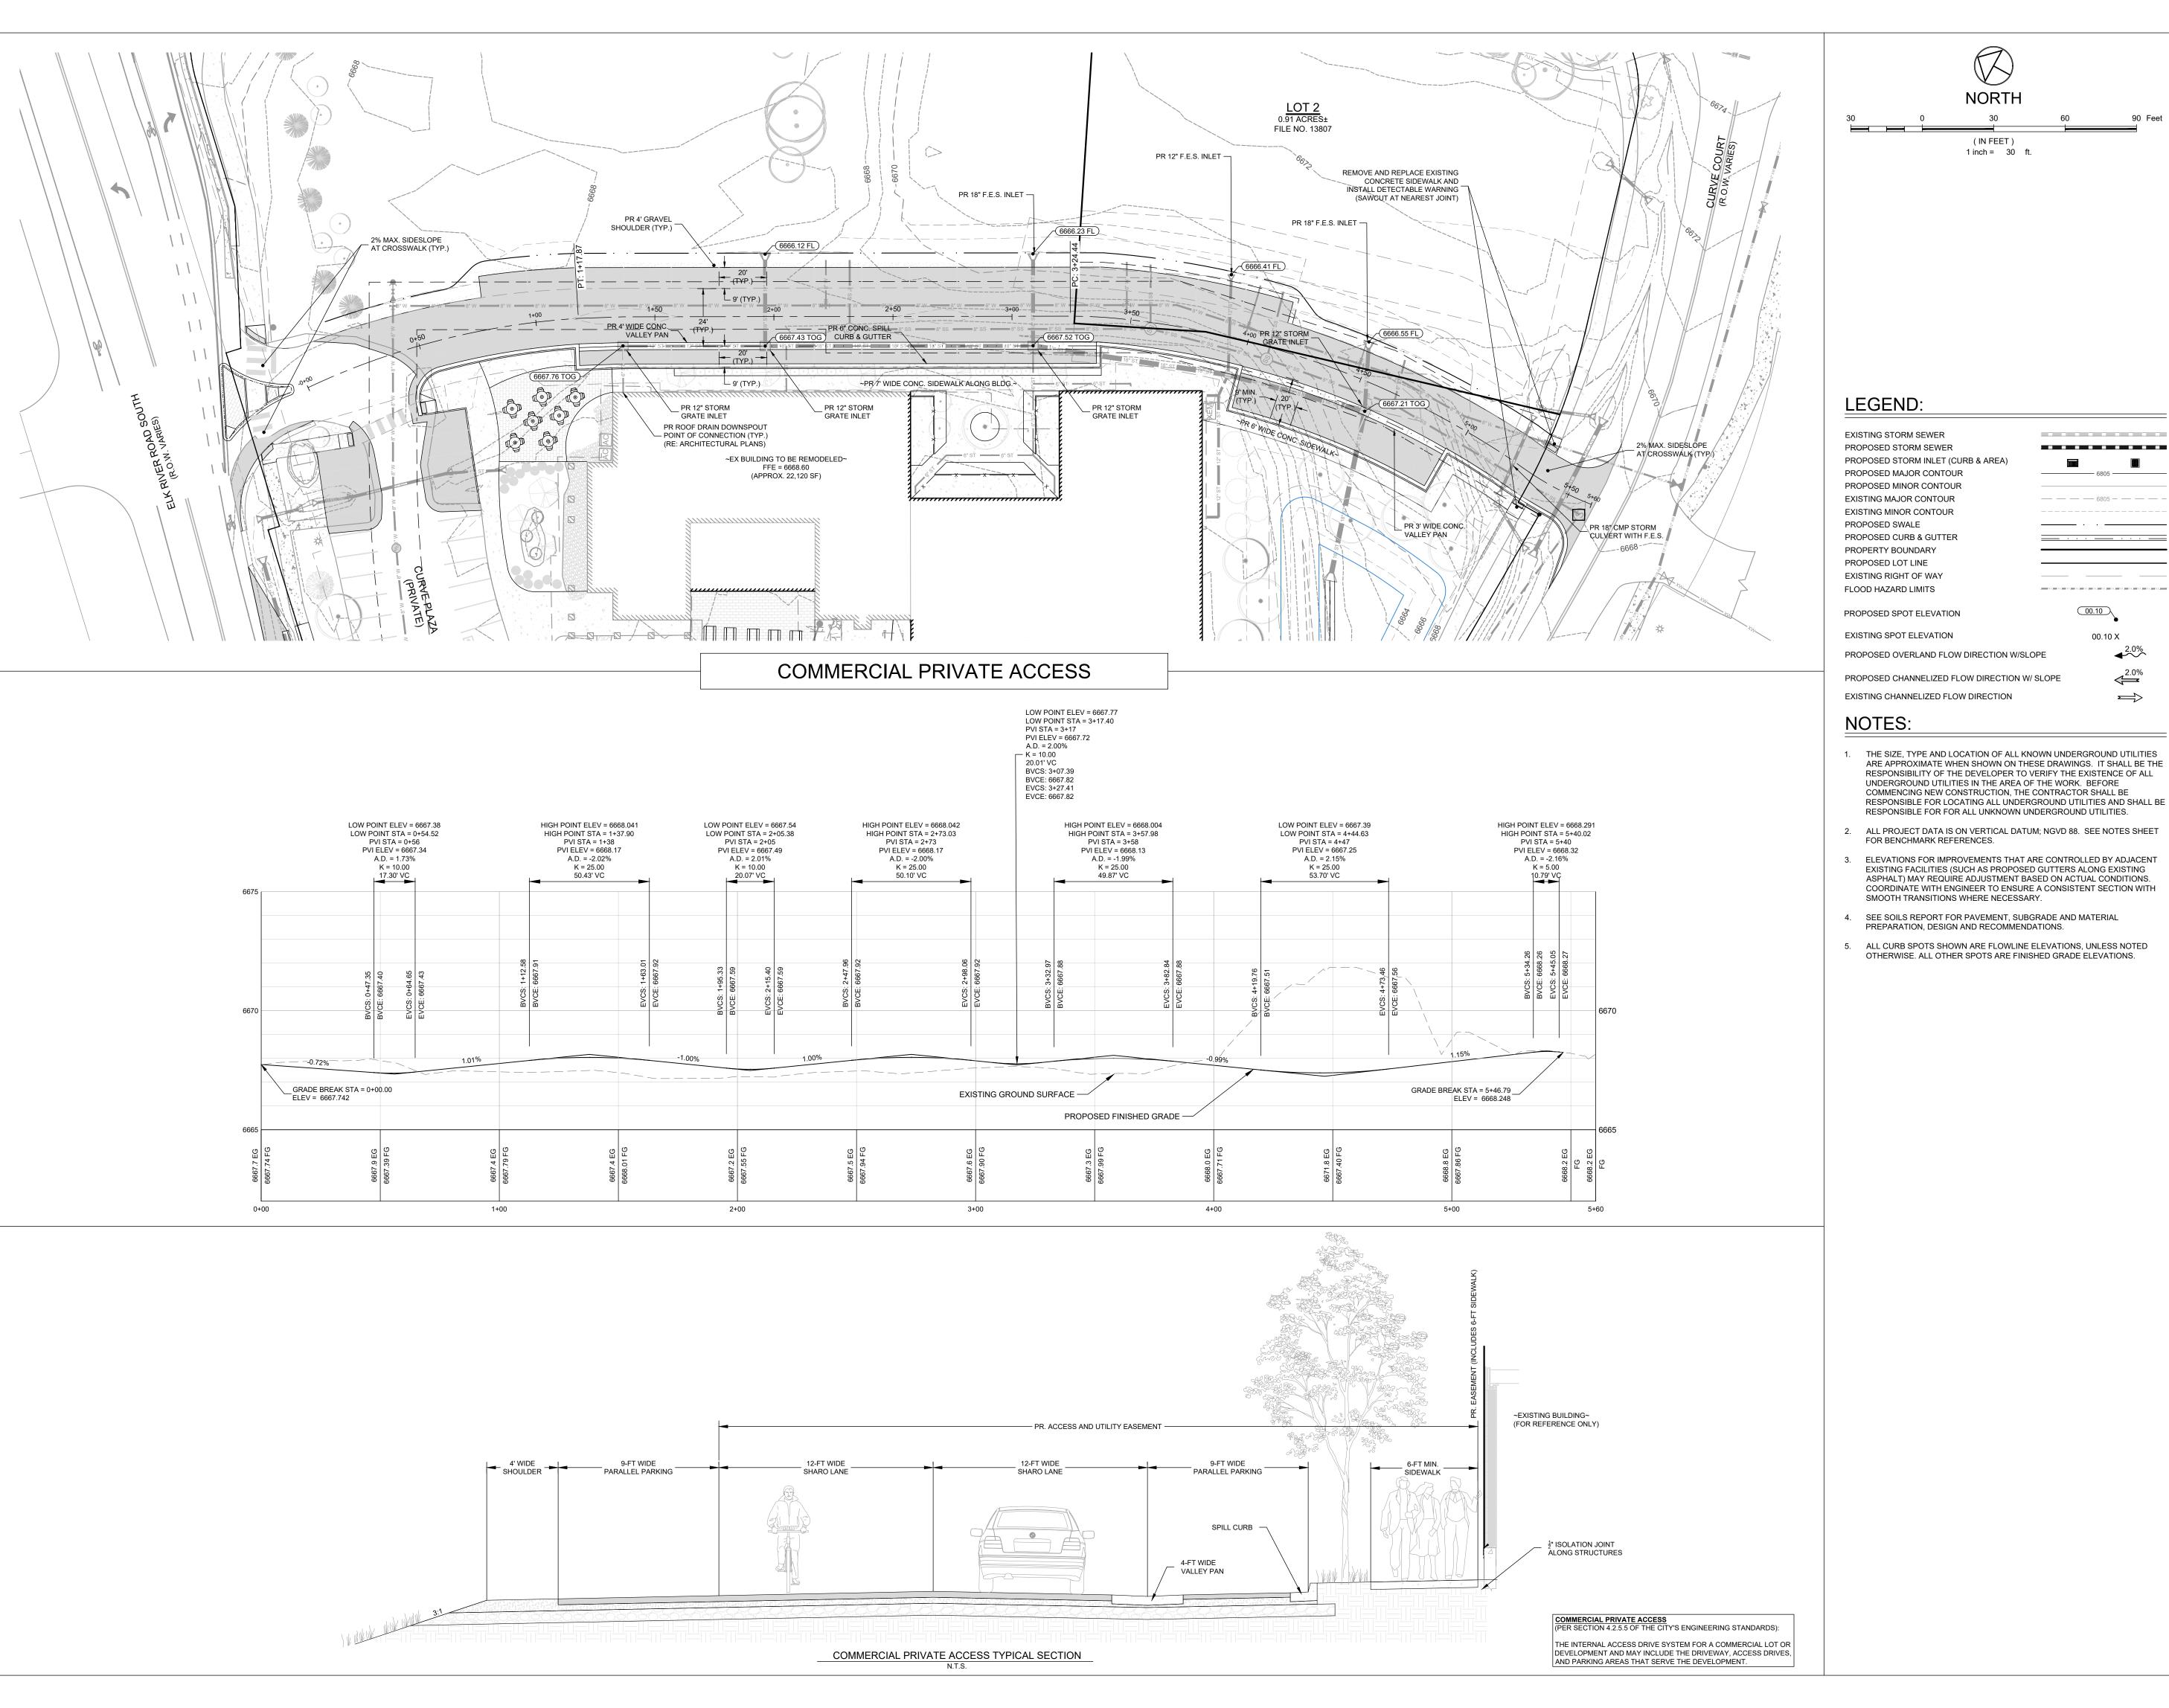

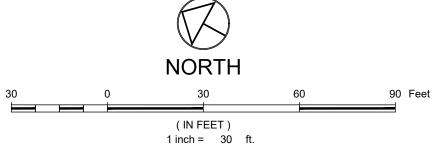- ARE APPROXIMATE WHEN SHOWN ON THESE DRAWINGS. IT SHALL BE THE RESPONSIBILITY OF THE DEVELOPER TO VERIFY THE EXISTENCE OF ALL UNDERGROUND UTILITIES IN THE AREA OF THE WORK. BEFORE COMMENCING NEW CONSTRUCTION. THE CONTRACTOR SHALL BE RESPONSIBLE FOR LOCATING ALL UNDERGROUND UTILITIES AND SHALL BE RESPONSIBLE FOR FOR ALL UNKNOWN UNDERGROUND UTILITIES.
- 2. ALL PROJECT DATA IS ON VERTICAL DATUM; NGVD 88. SEE NOTES SHEET
- 3. ELEVATIONS FOR IMPROVEMENTS THAT ARE CONTROLLED BY ADJACENT EXISTING FACILITIES (SUCH AS PROPOSED GUTTERS ALONG EXISTING ASPHALT) MAY REQUIRE ADJUSTMENT BASED ON ACTUAL CONDITIONS.
- 5. ALL CURB SPOTS SHOWN ARE FLOWLINE ELEVATIONS, UNLESS NOTED

No. Date Description OWNER

APPROVAL STAMPS:

SUBMISSIONS & REVISIONS

MAY REIGLER PROPERTIES 2201 WISCONSIN AVE NW SUITE 200

WASHINGTON DC 20007

**ARCHITECT** 

<=2.0%



KEVIN & ASAKO SPERRY ARCHITECTURE 3318 N. Columbus Street Arlington, VA 22207 T.312.636.3248 / 312.636.4252 www.kasa-arch.com

STRUCTURAL ENGINEER

STEAMBOAT ENGINEERING AND DESIGN, INC 2740 ACRE LANE, STE. E STEAMBOAT SPRINGS, CO 80487

**BOULDER ENGINEERING** 

M.E.P. & F.P. ENGINEERS

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CIVIL ENGINEER

LANDMARK ENGINEERING

141 9TH STREET PO BOX 774943 STEAMBOAT SPRINGS, CO 80477

LANDSCAPE ARCHITECT

GENERAL CONTRACTOR

PROJECT LOCATION

#### **STEAMBOAT** BASECAMP

1901 CURVE PLAZA STEAMBOAT SPRINGS, CO 80487 DRAWING TITLE


> **ROADWAY PLAN** & PROFILE


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2387-004 DRAWING NO:

C.410

PROJECT NO:



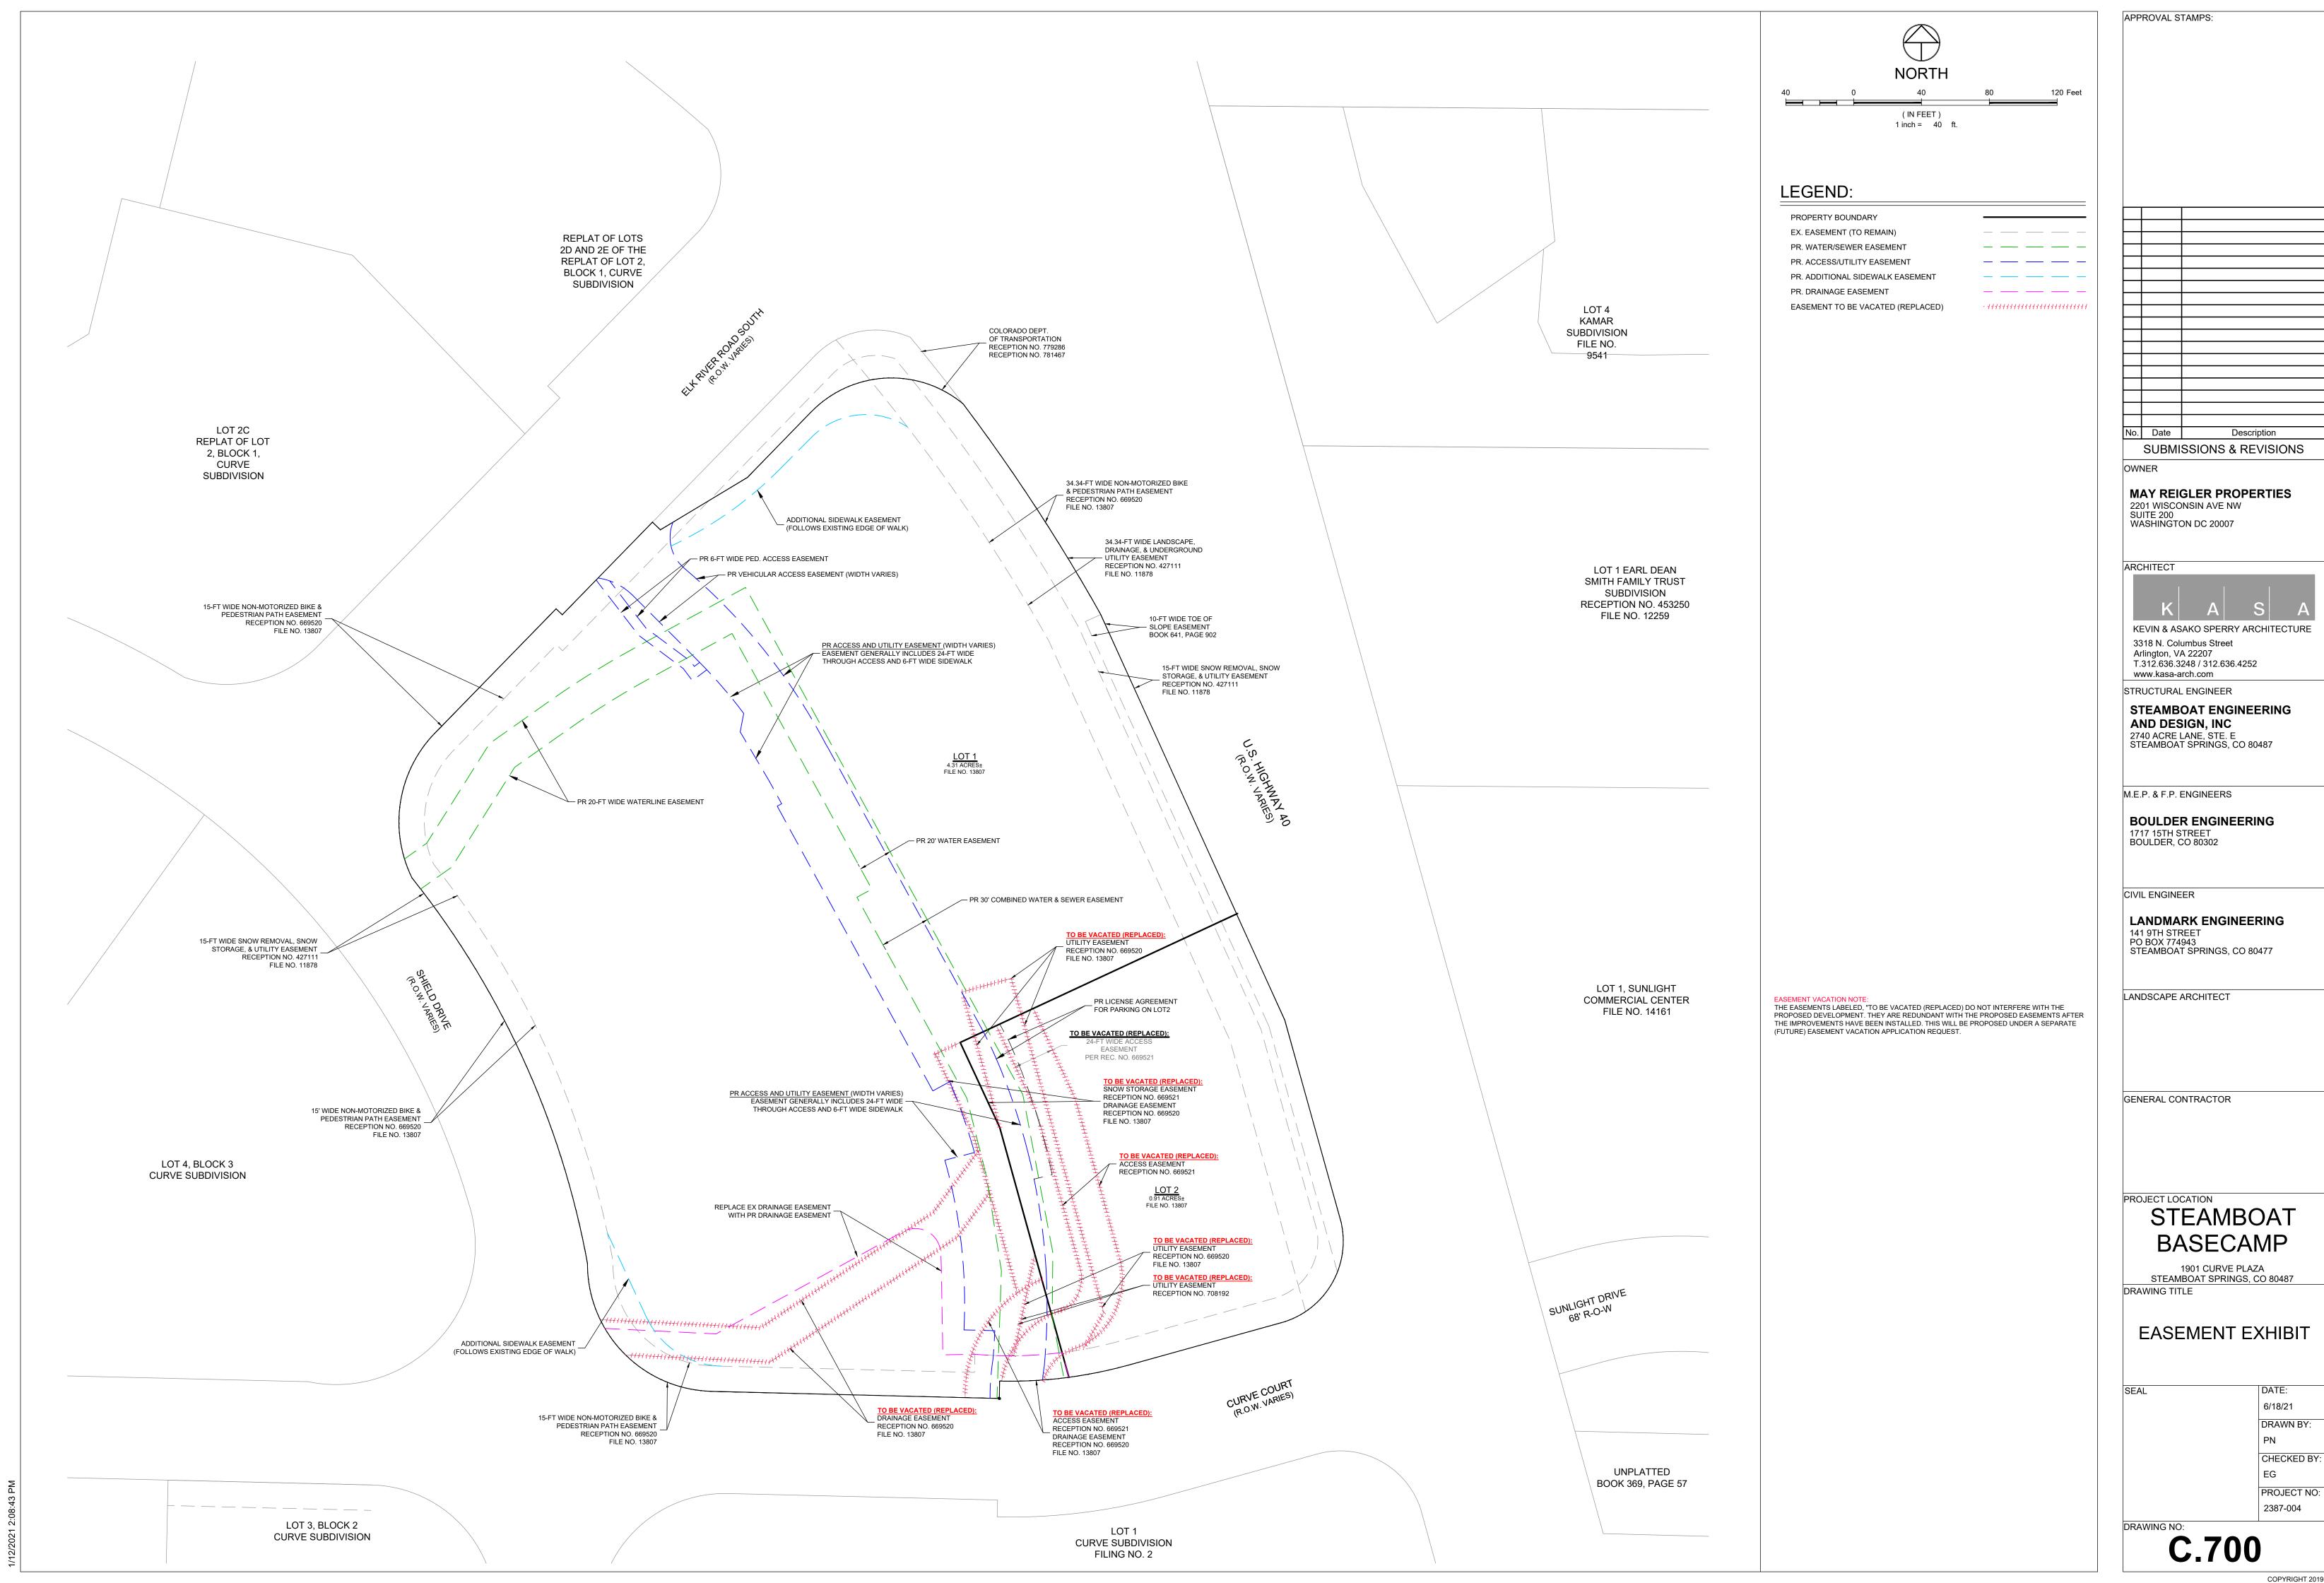


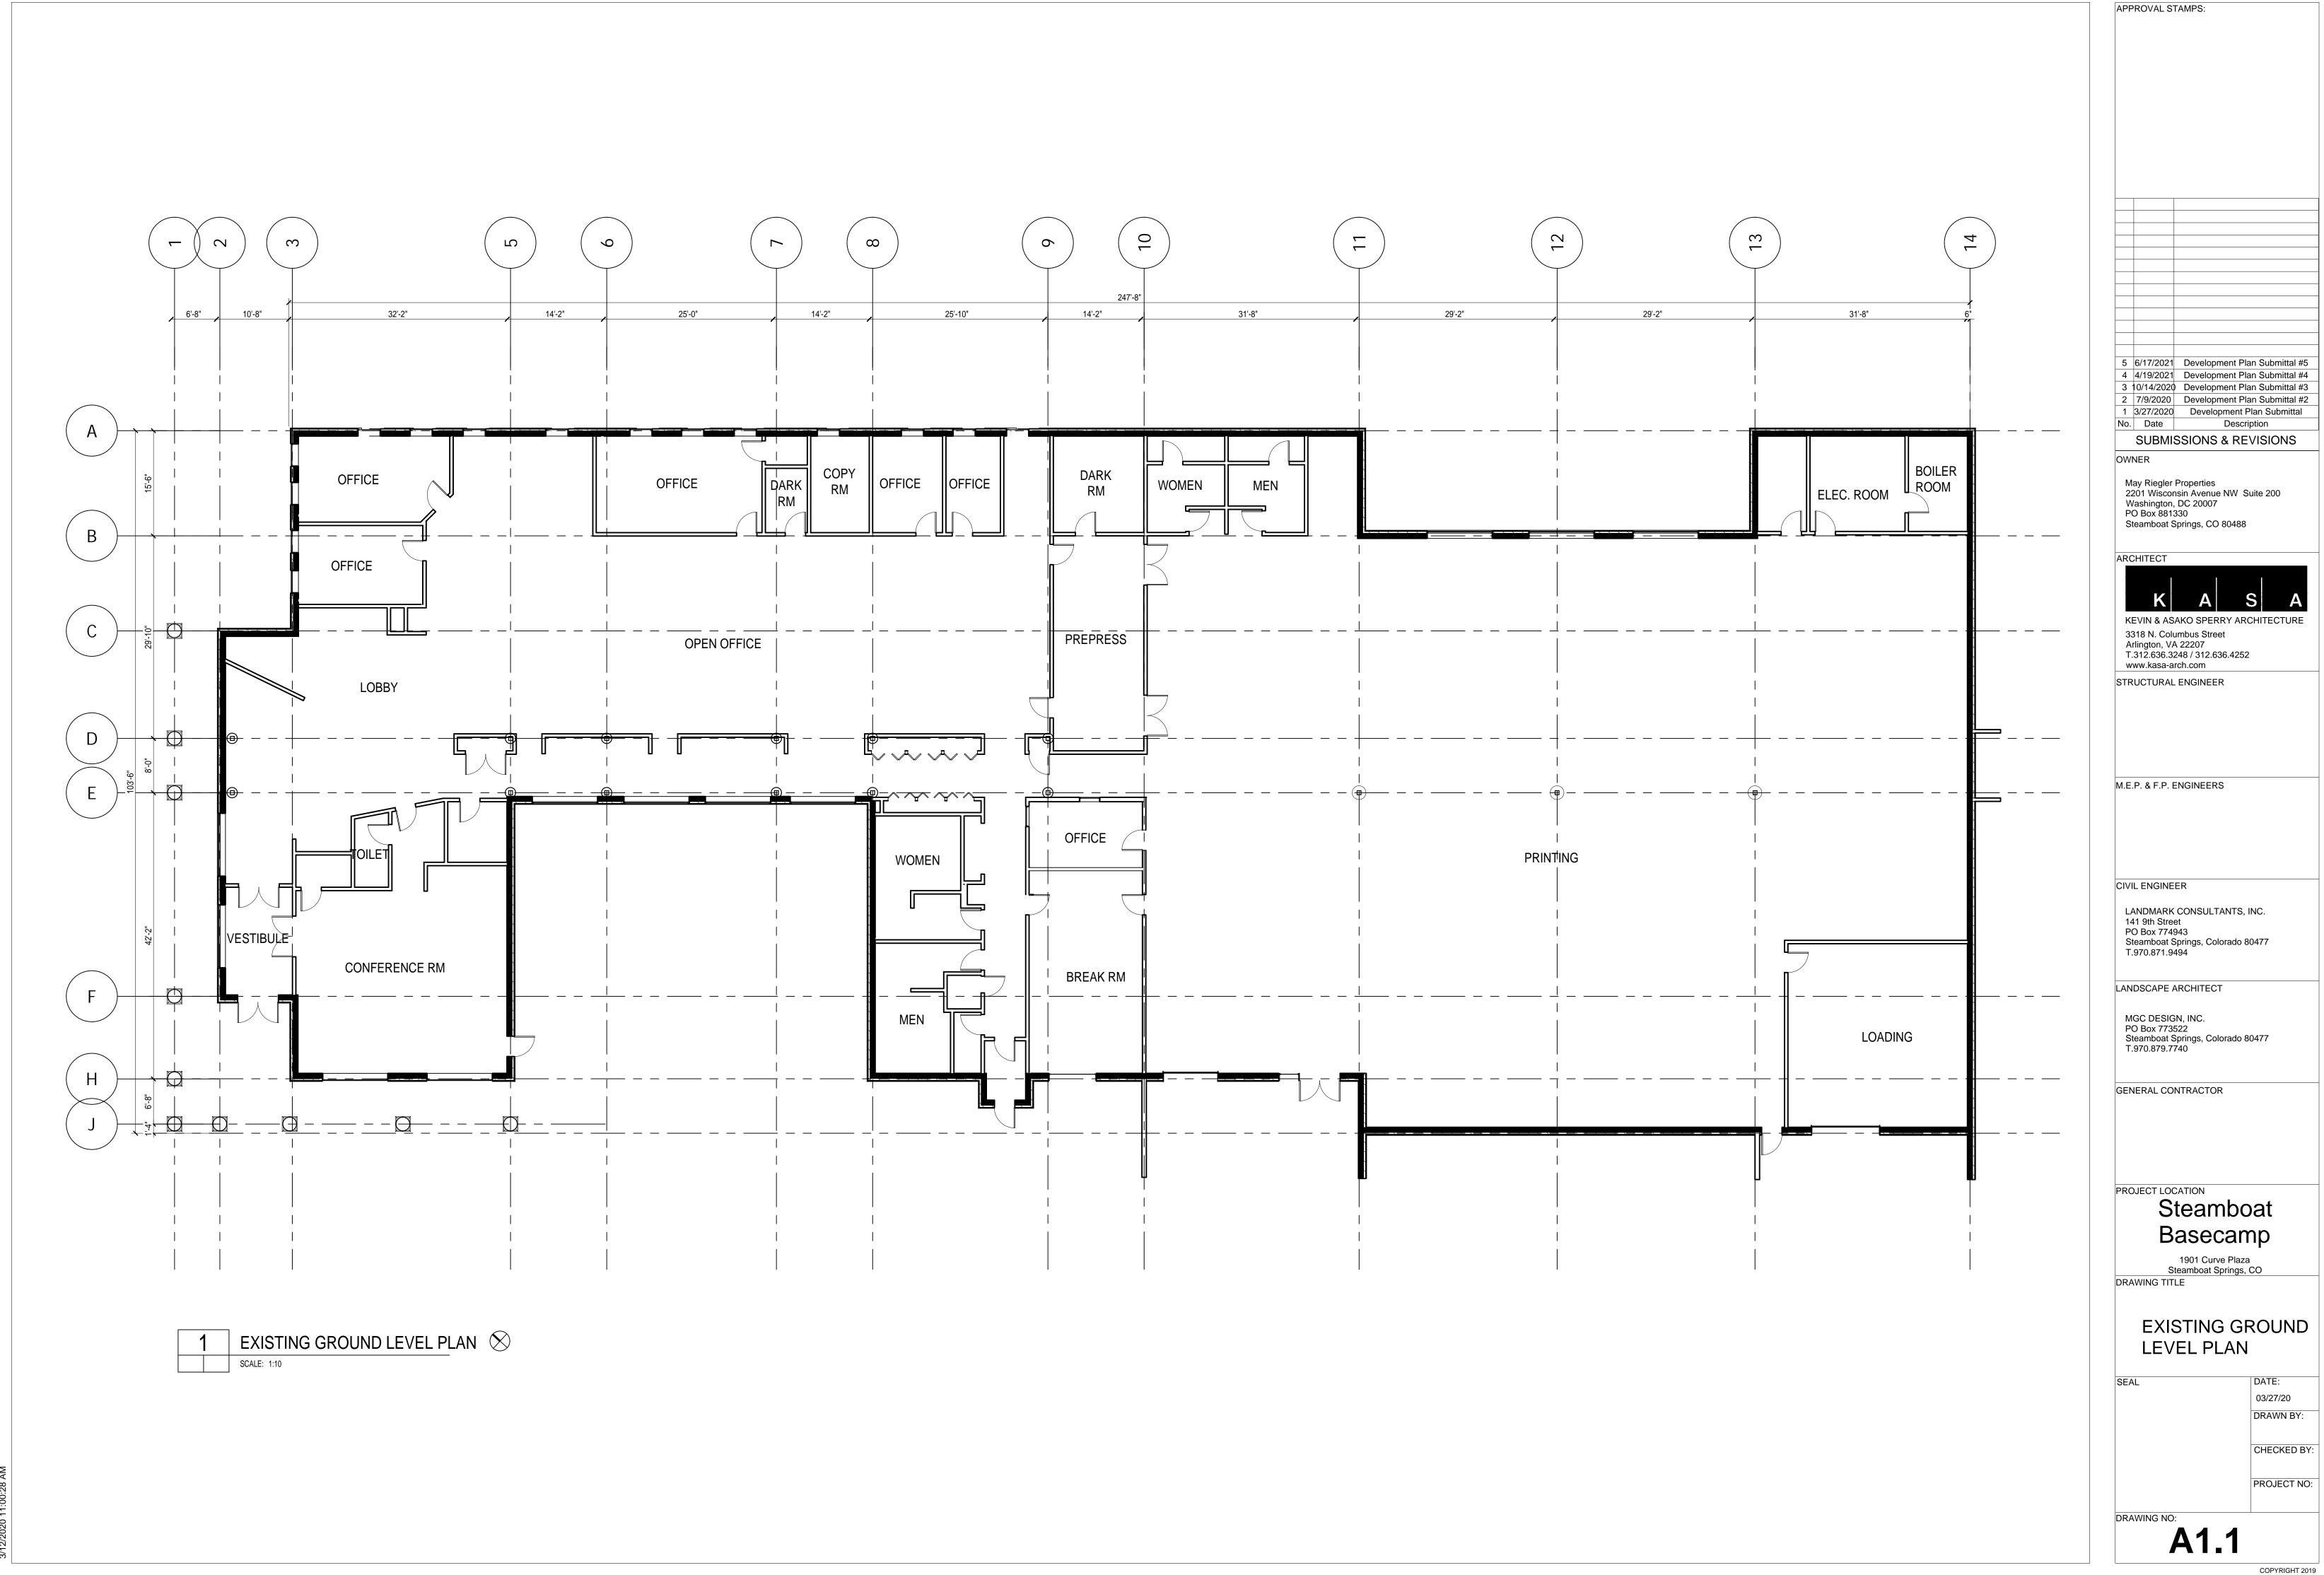5 6/17/2021 Development Plan Submittal #5 4 4/19/2021 Development Plan Submittal #4 3 10/14/2020 Development Plan Submittal #3 2 7/9/2020 Development Plan Submittal #2



03/27/20 DRAWN BY:

CHECKED BY:

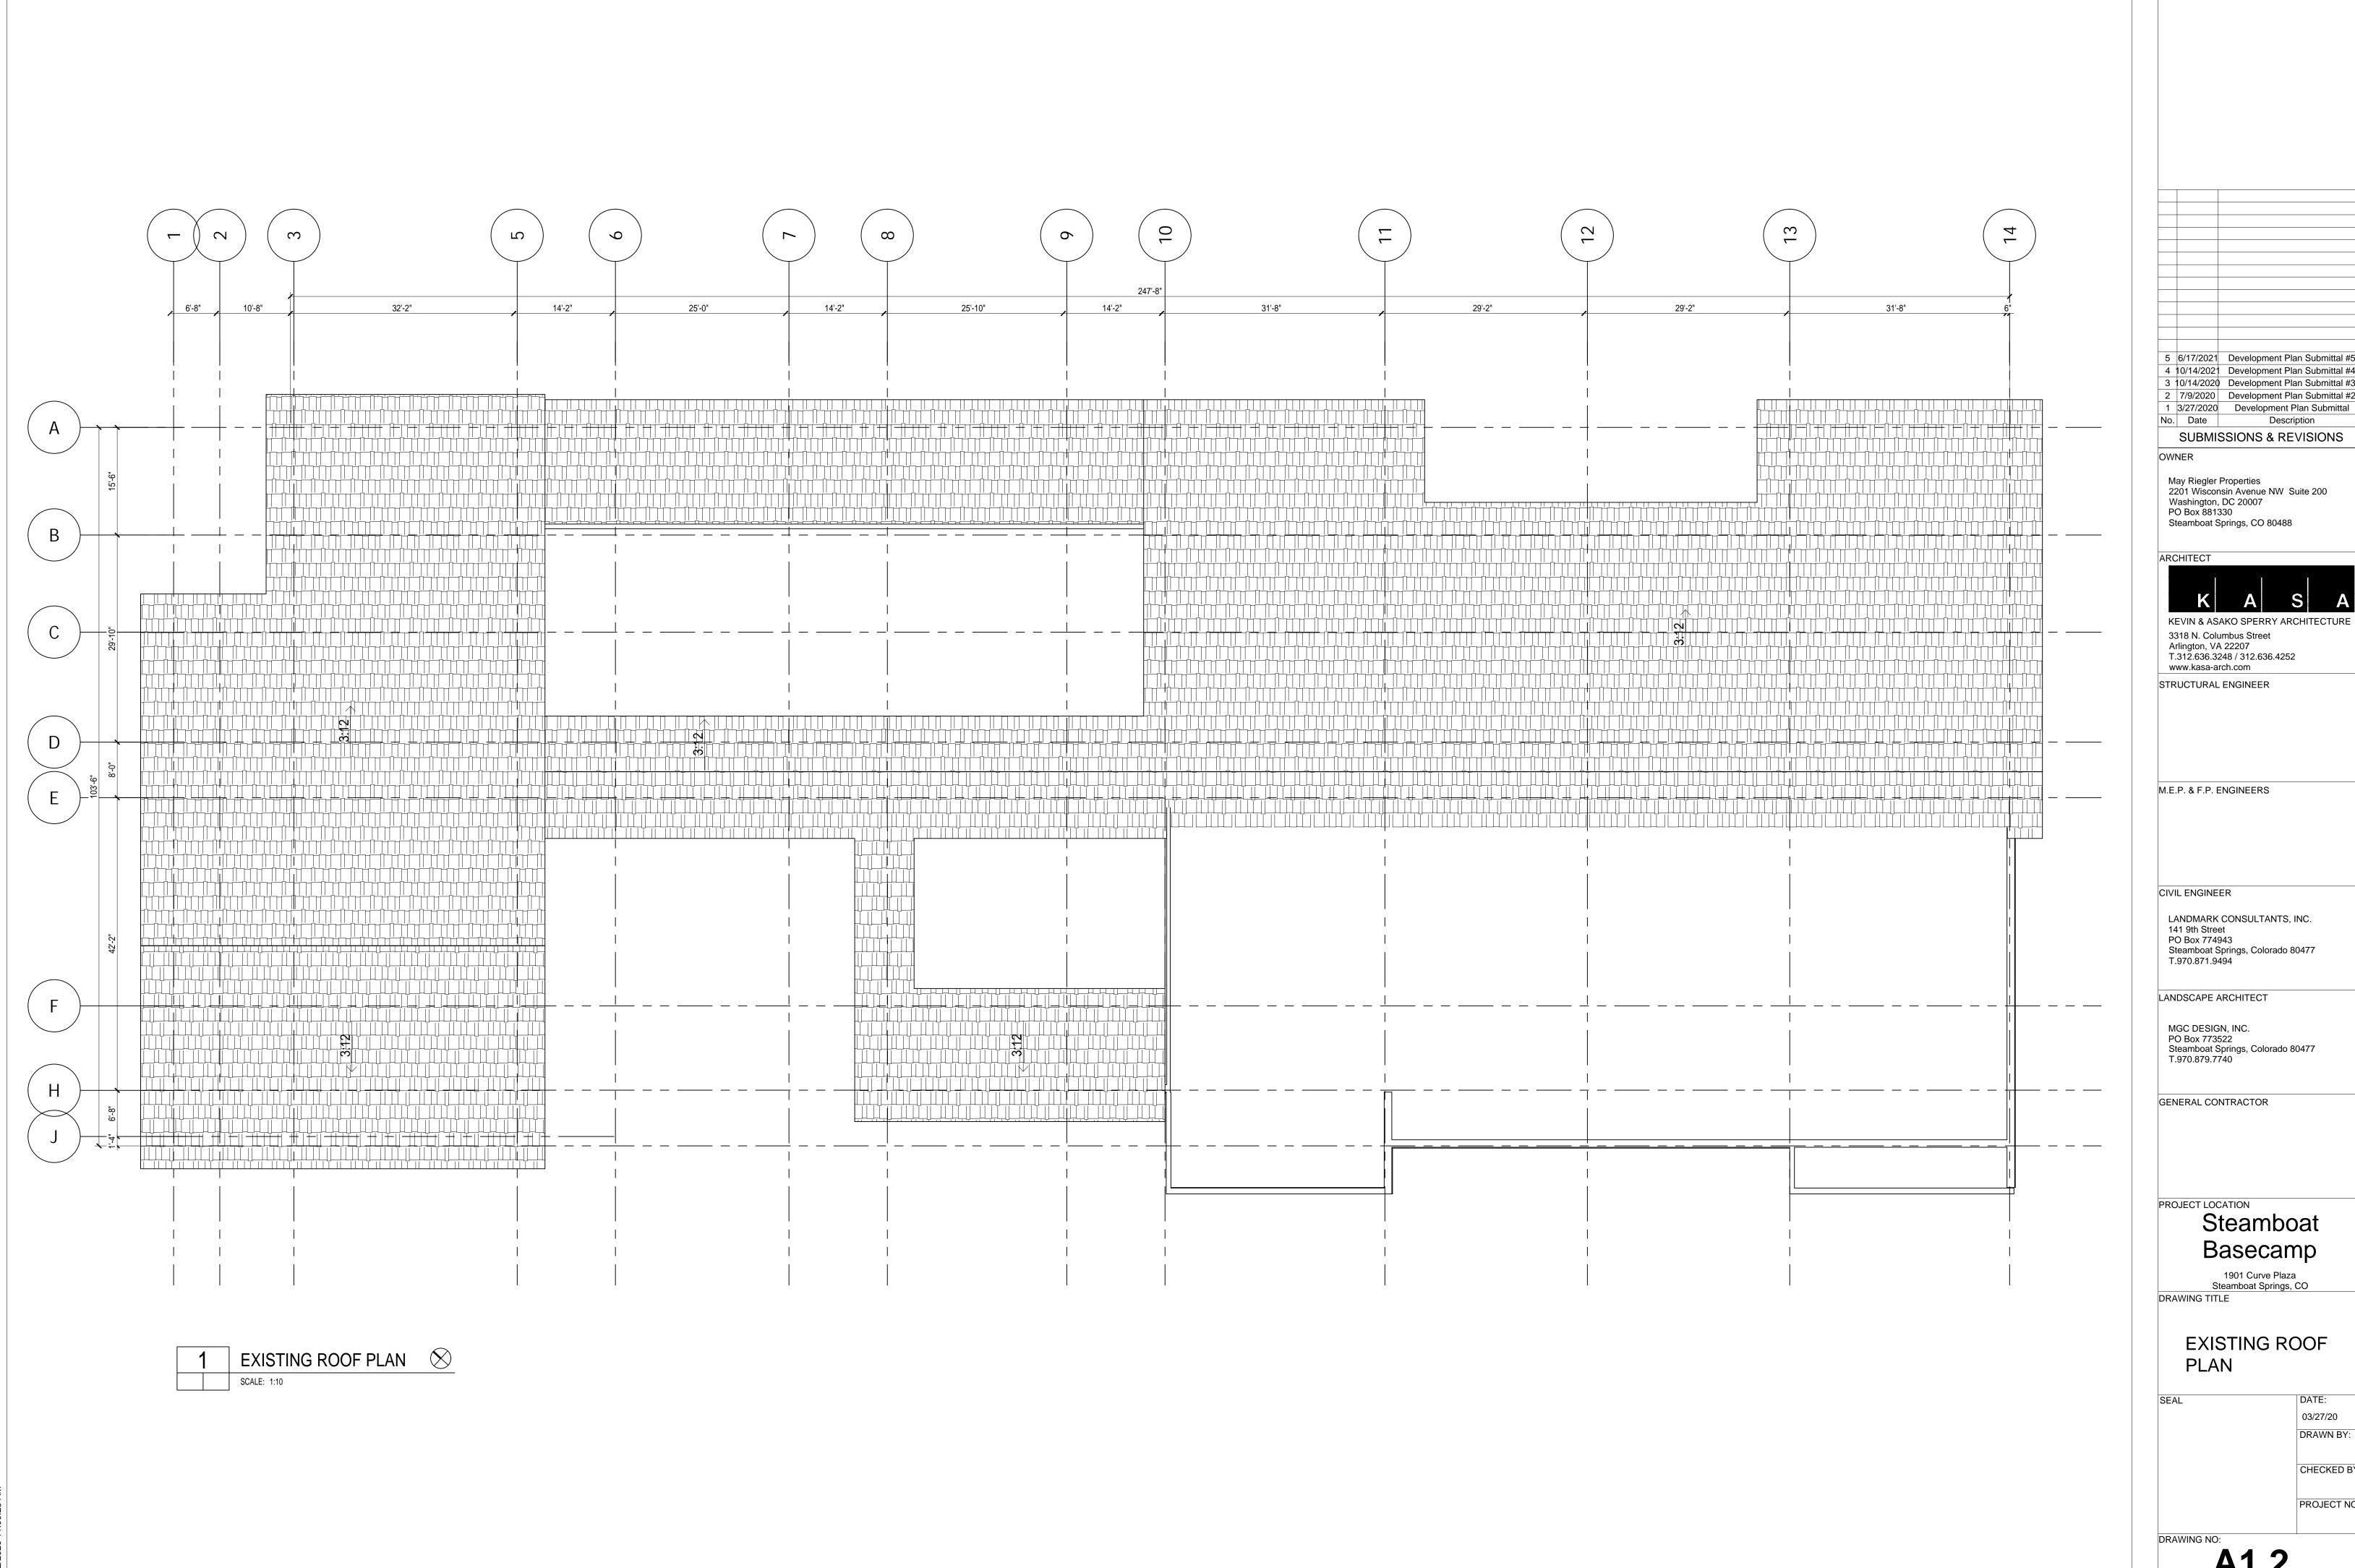

APPROVAL STAMPS:

5 6/17/2021 Development Plan Submittal #5 4 10/14/2021 Development Plan Submittal #4 3 10/14/2020 Development Plan Submittal #3 2 7/9/2020 Development Plan Submittal #2

Description SUBMISSIONS & REVISIONS

May Riegler Properties 2201 Wisconsin Avenue NW Suite 200 Washington, DC 20007 PO Box 881330

KEVIN & ASAKO SPERRY ARCHITECTURE

3318 N. Columbus Street Arlington, VA 22207 T.312.636.3248 / 312.636.4252 www.kasa-arch.com

STRUCTURAL ENGINEER

M.E.P. & F.P. ENGINEERS

LANDMARK CONSULTANTS, INC. 141 9th Street PO Box 774943 Steamboat Springs, Colorado 80477 T.970.871.9494

LANDSCAPE ARCHITECT

MGC DESIGN, INC. PO Box 773522 Steamboat Springs, Colorado 80477 T.970.879.7740

GENERAL CONTRACTOR

PROJECT LOCATION

Steamboat Basecamp

1901 Curve Plaza Steamboat Springs, CO

DRAWING TITLE

**EXISTING ROOF** 


PLAN

03/27/20 DRAWN BY:

PROJECT NO:

CHECKED BY:

**A1.2** 

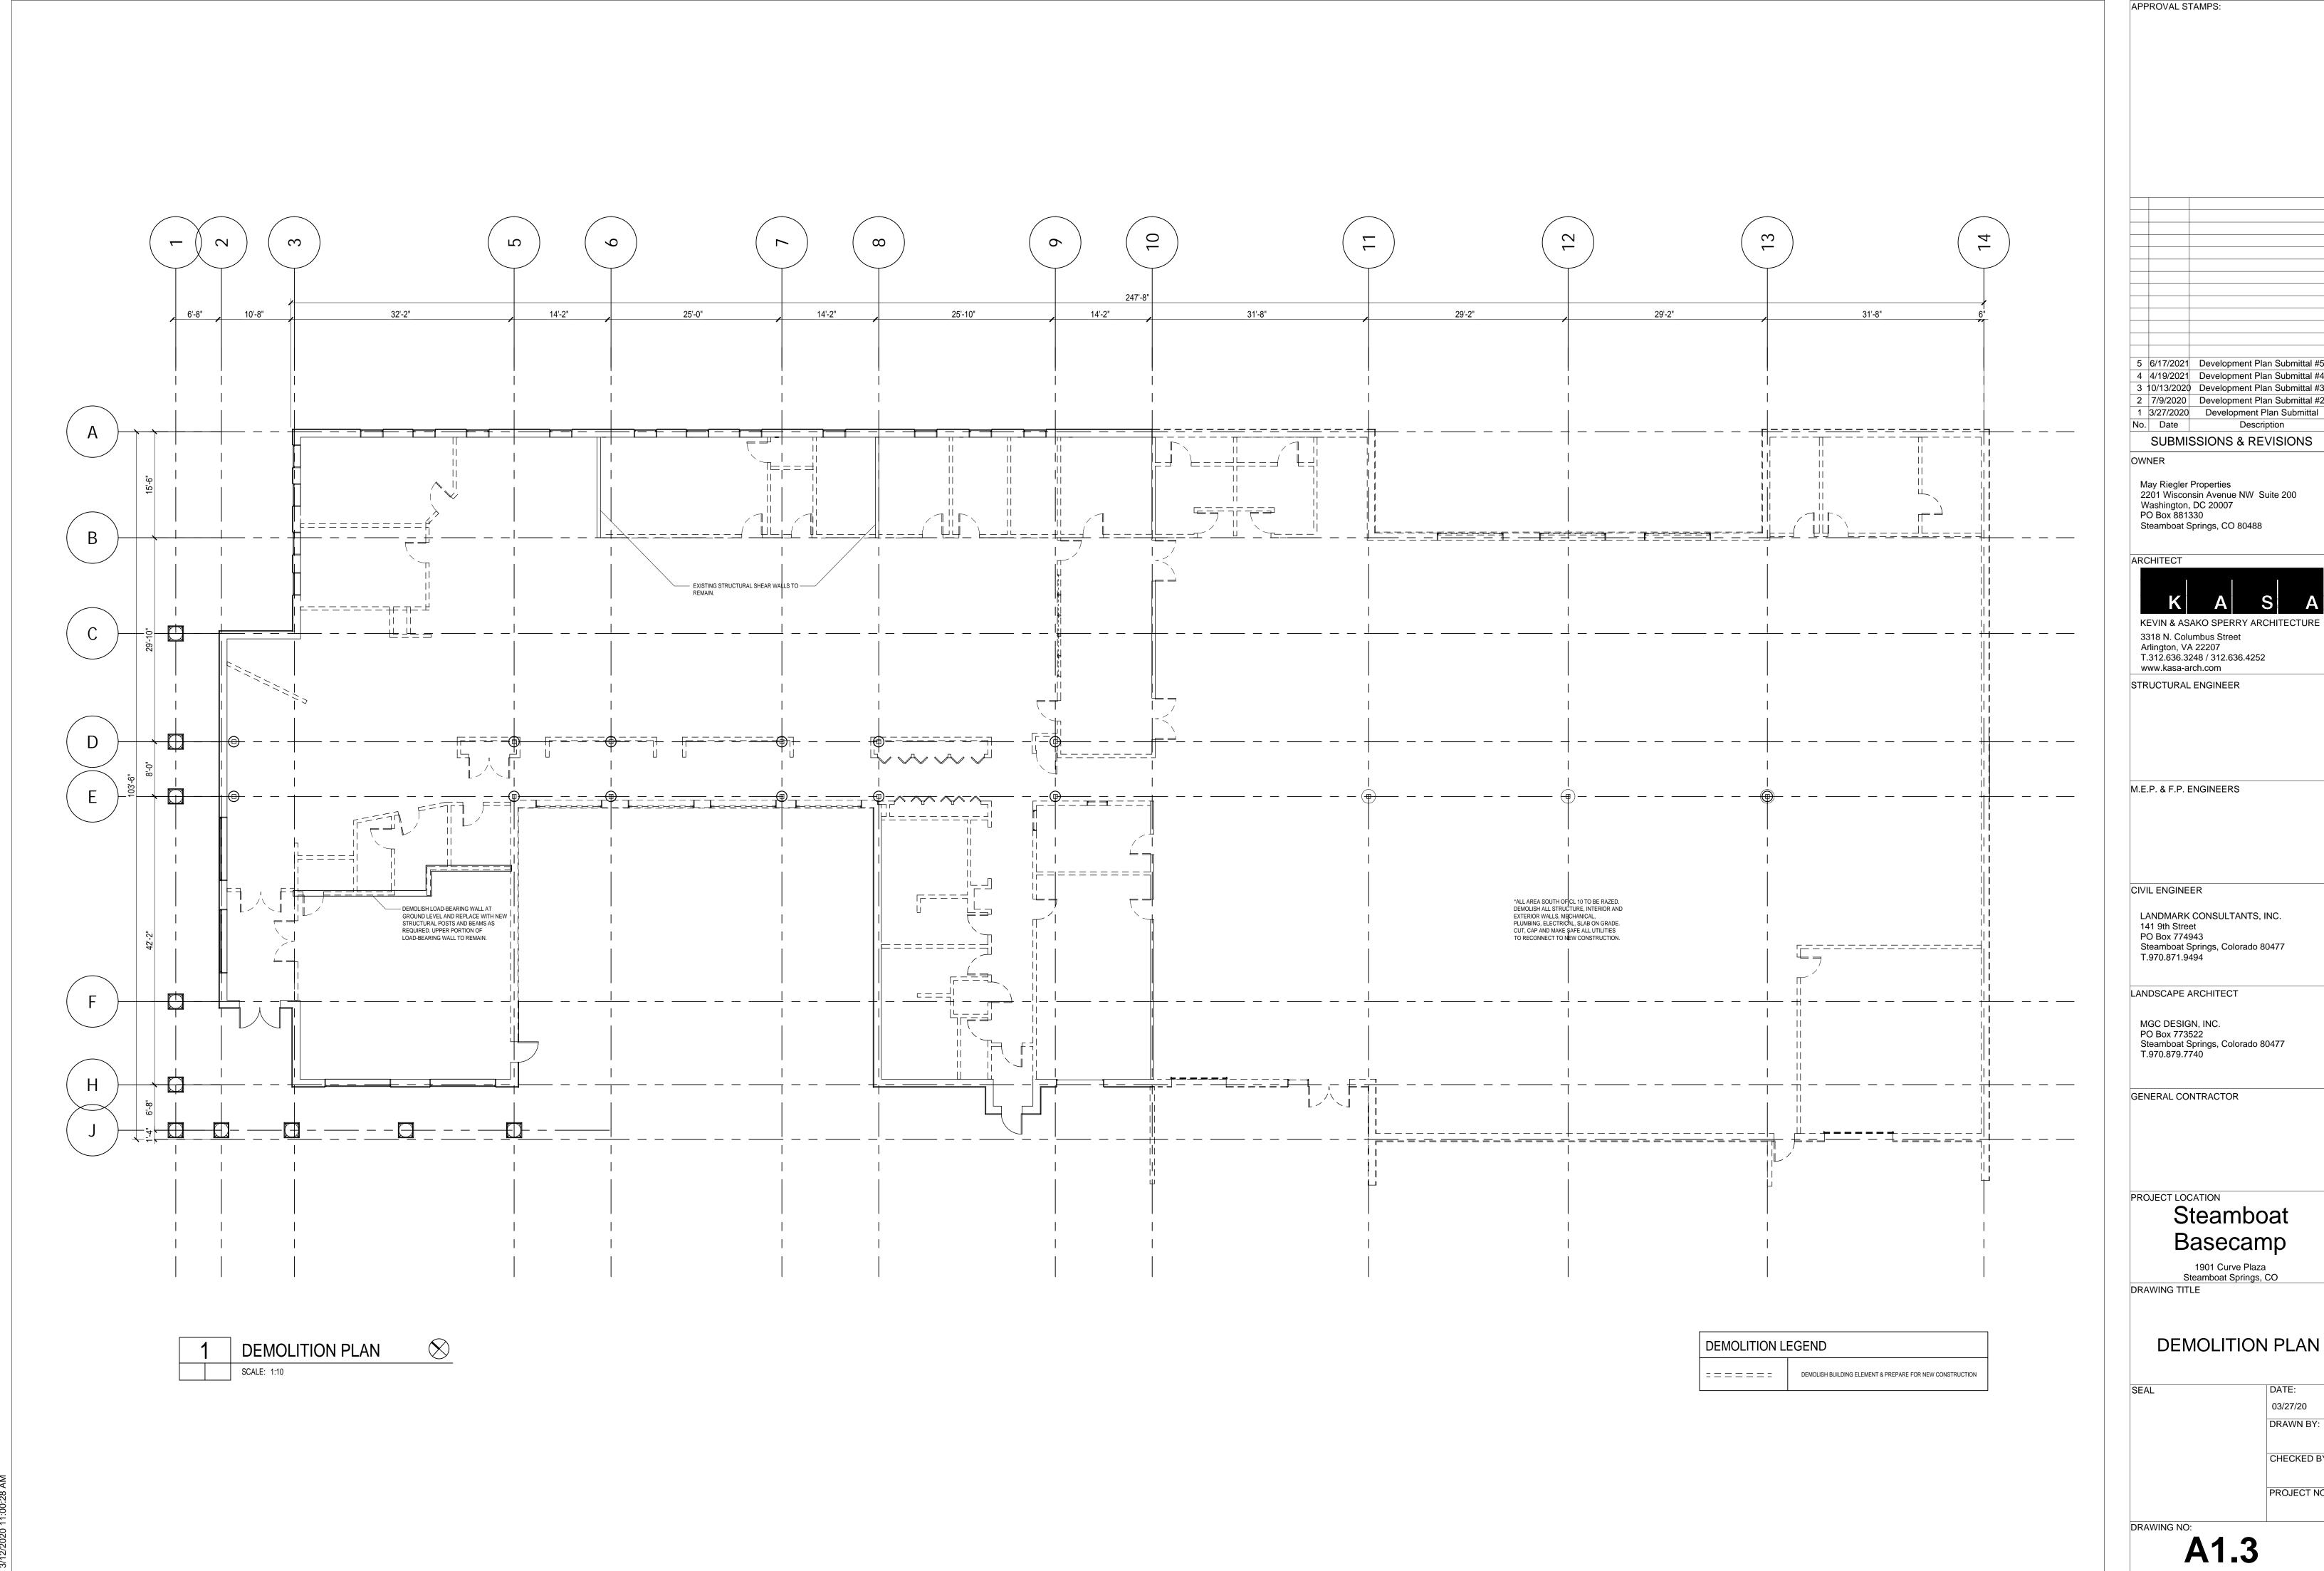



5 6/17/2021 Development Plan Submittal #5 4 4/19/2021 Development Plan Submittal #4 3 10/13/2020 Development Plan Submittal #3 2 7/9/2020 Development Plan Submittal #2




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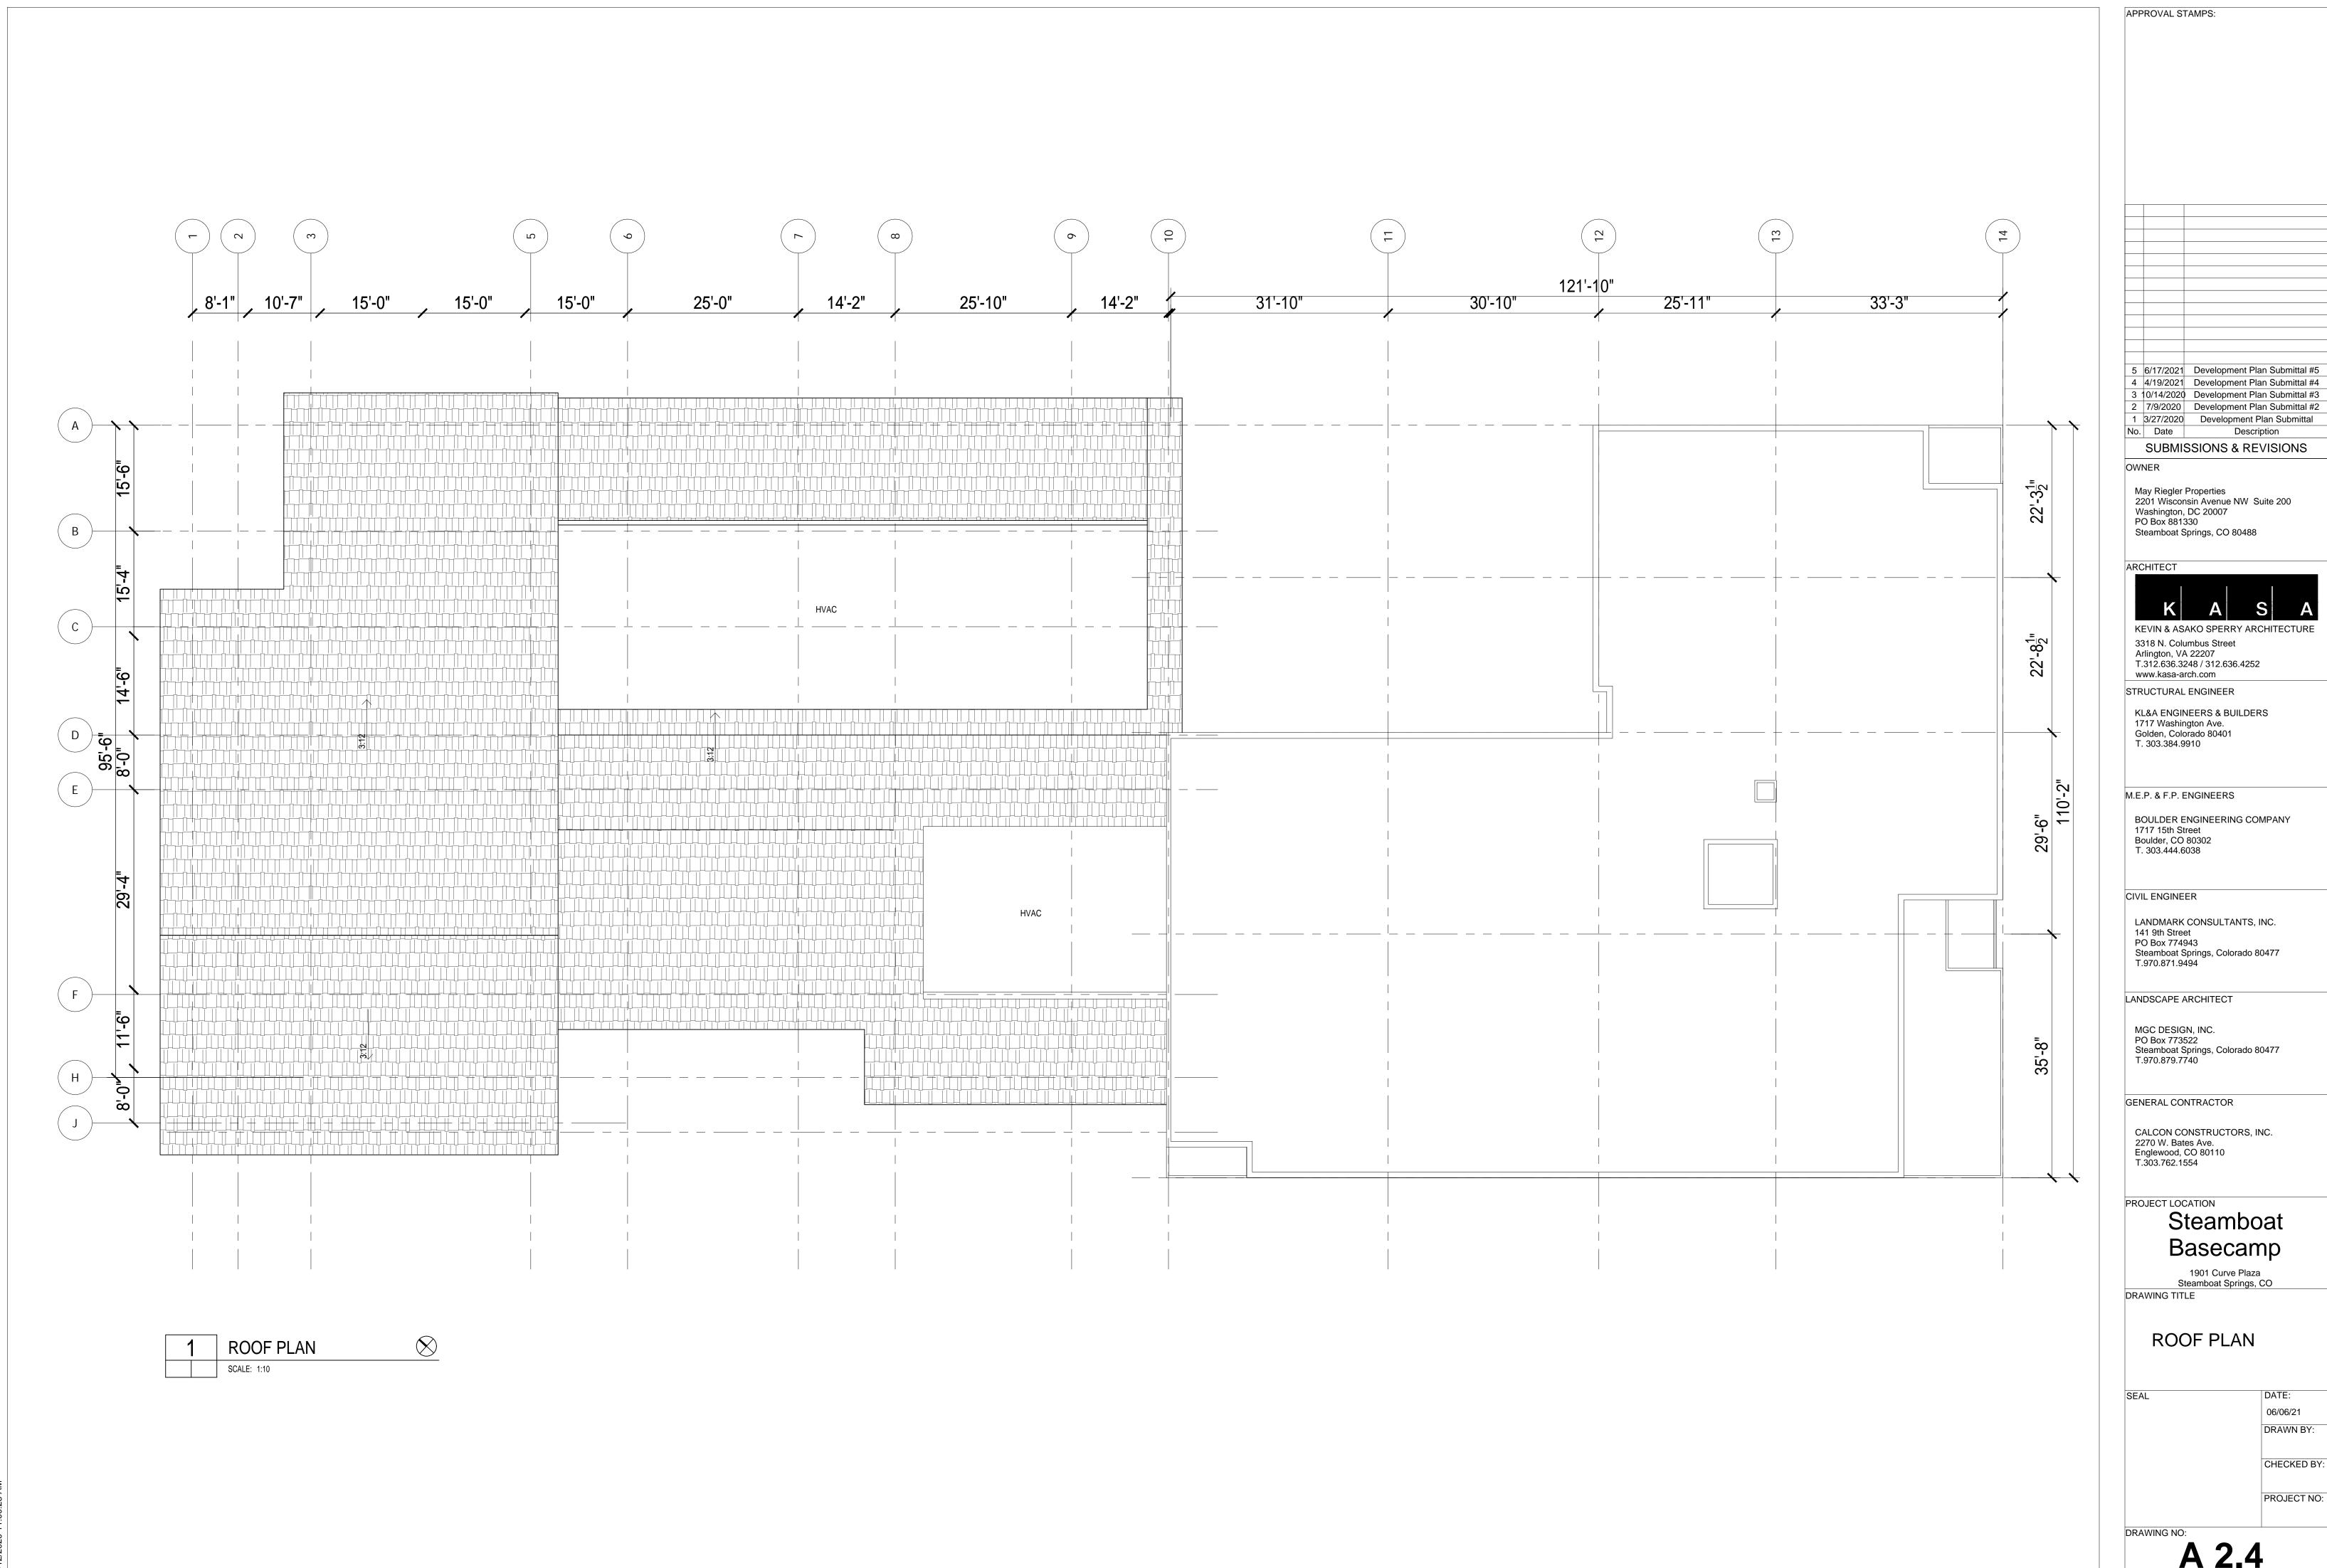
PROJECT NO:




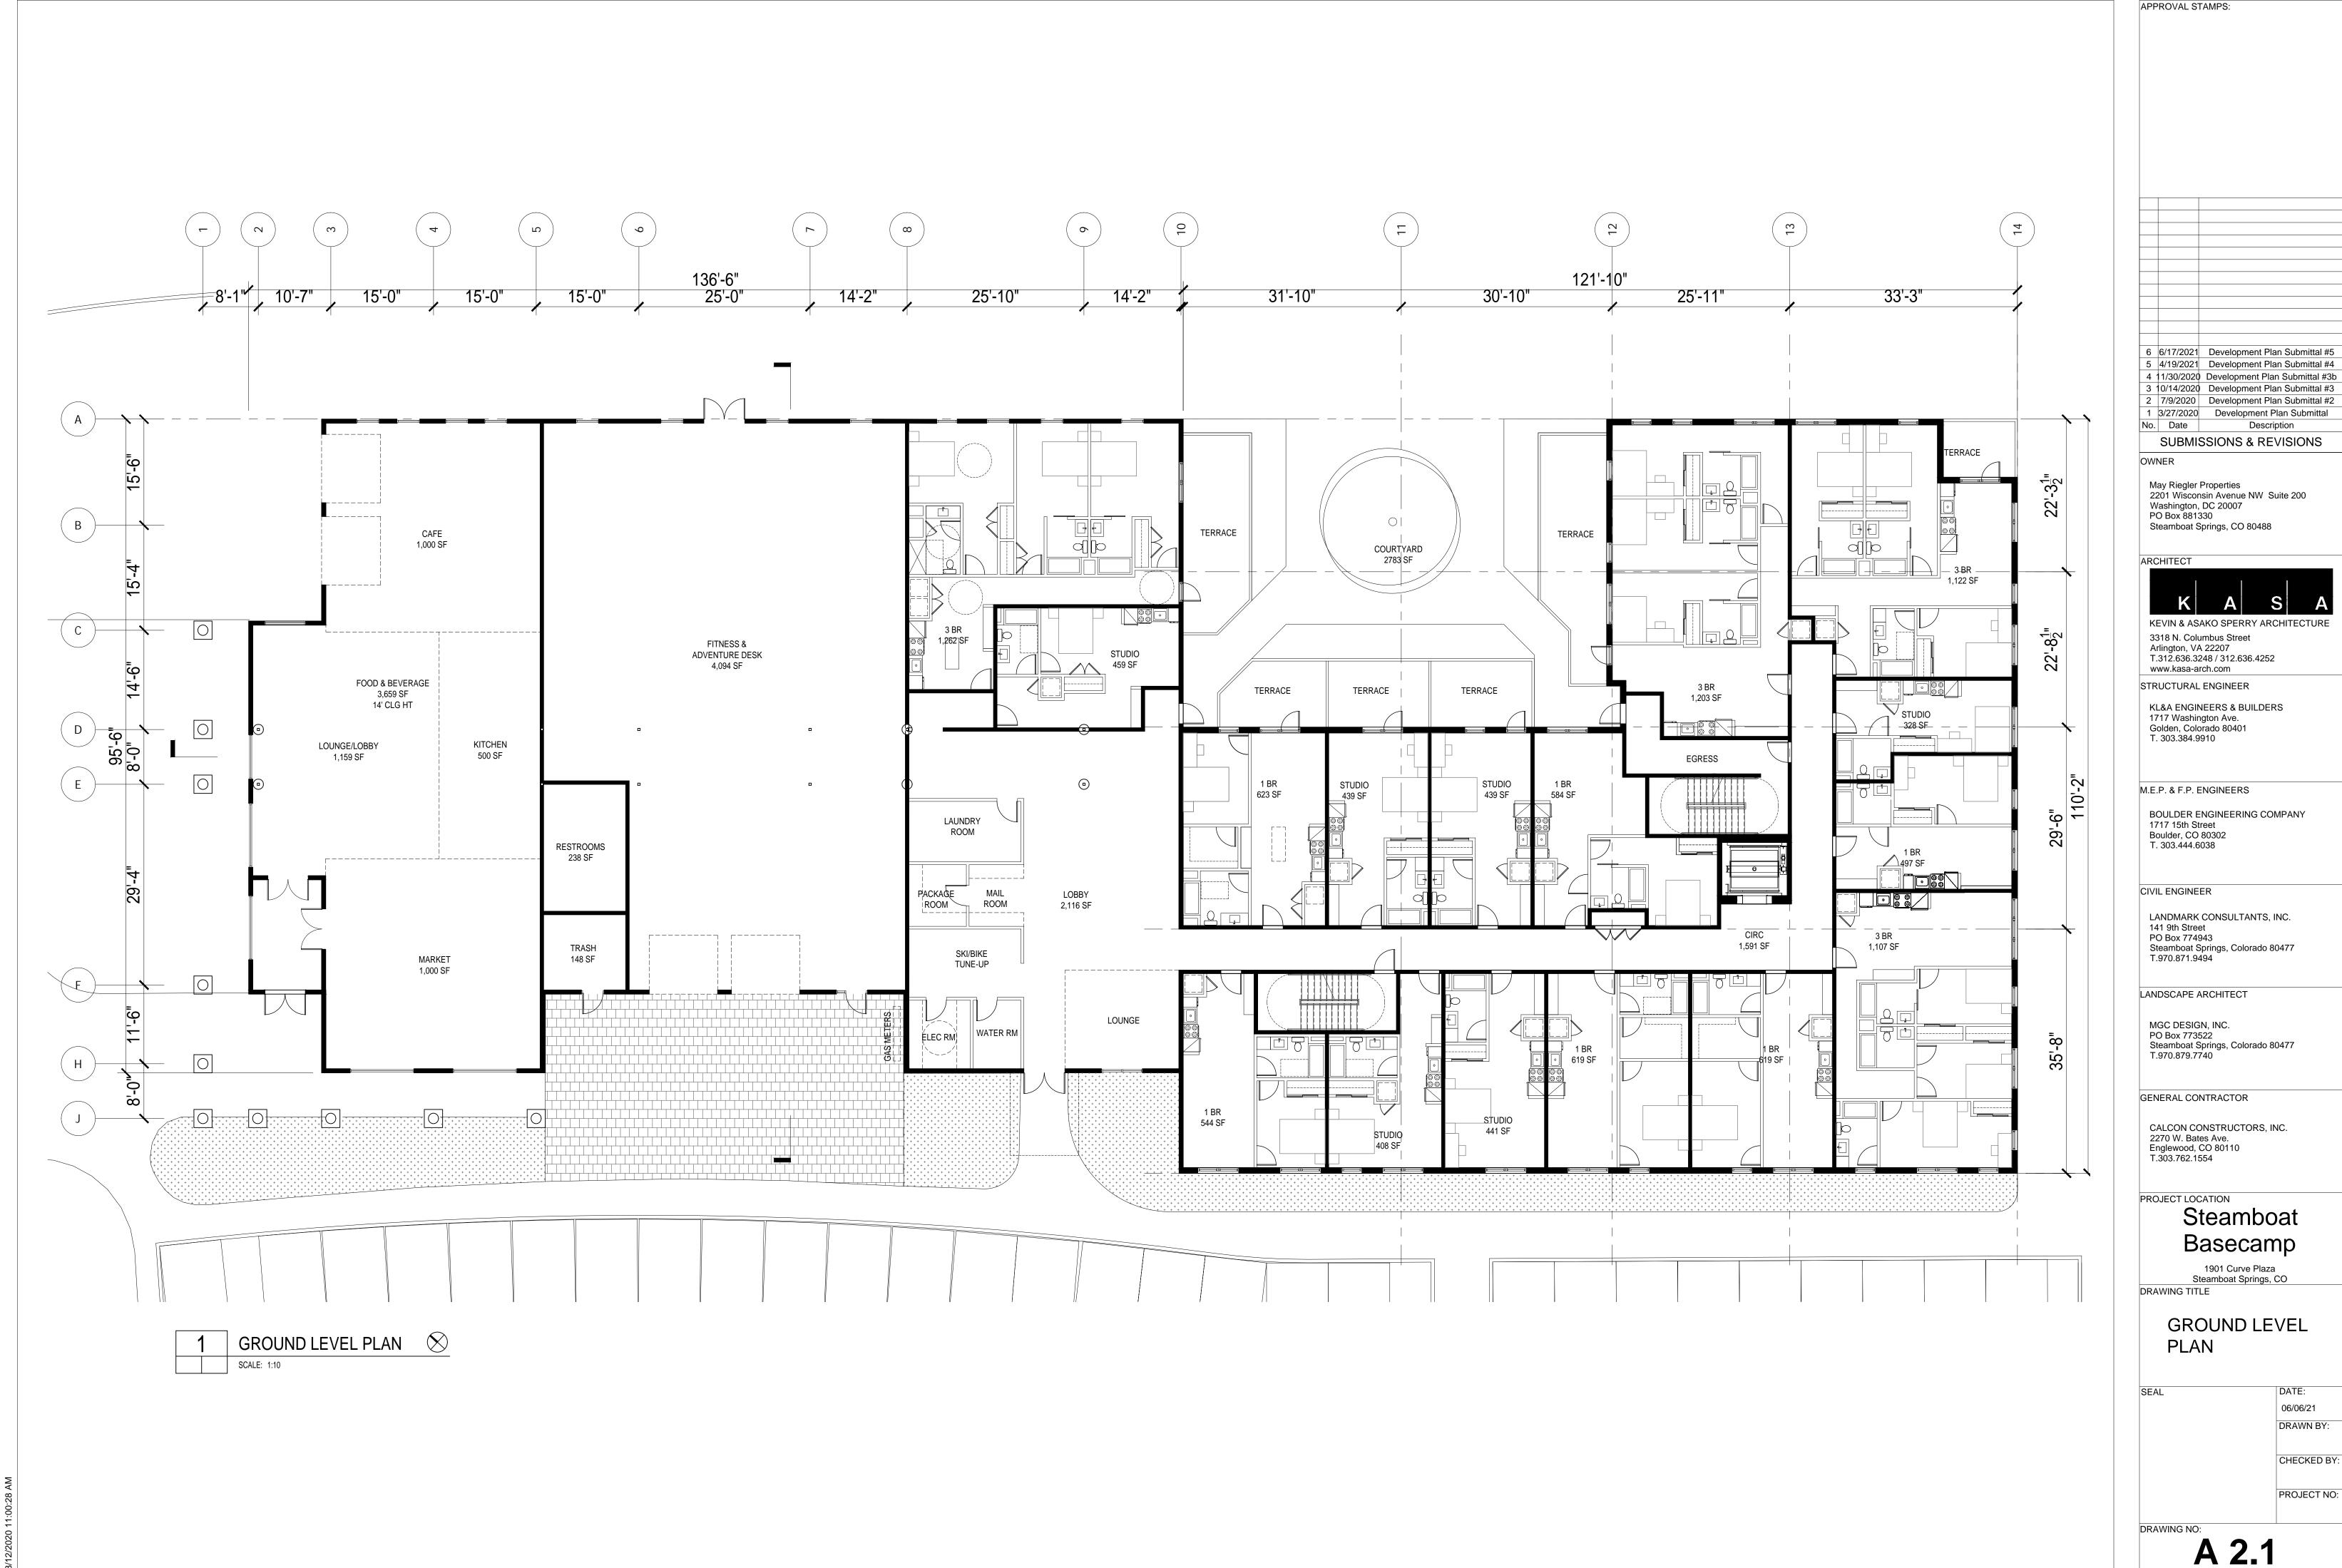


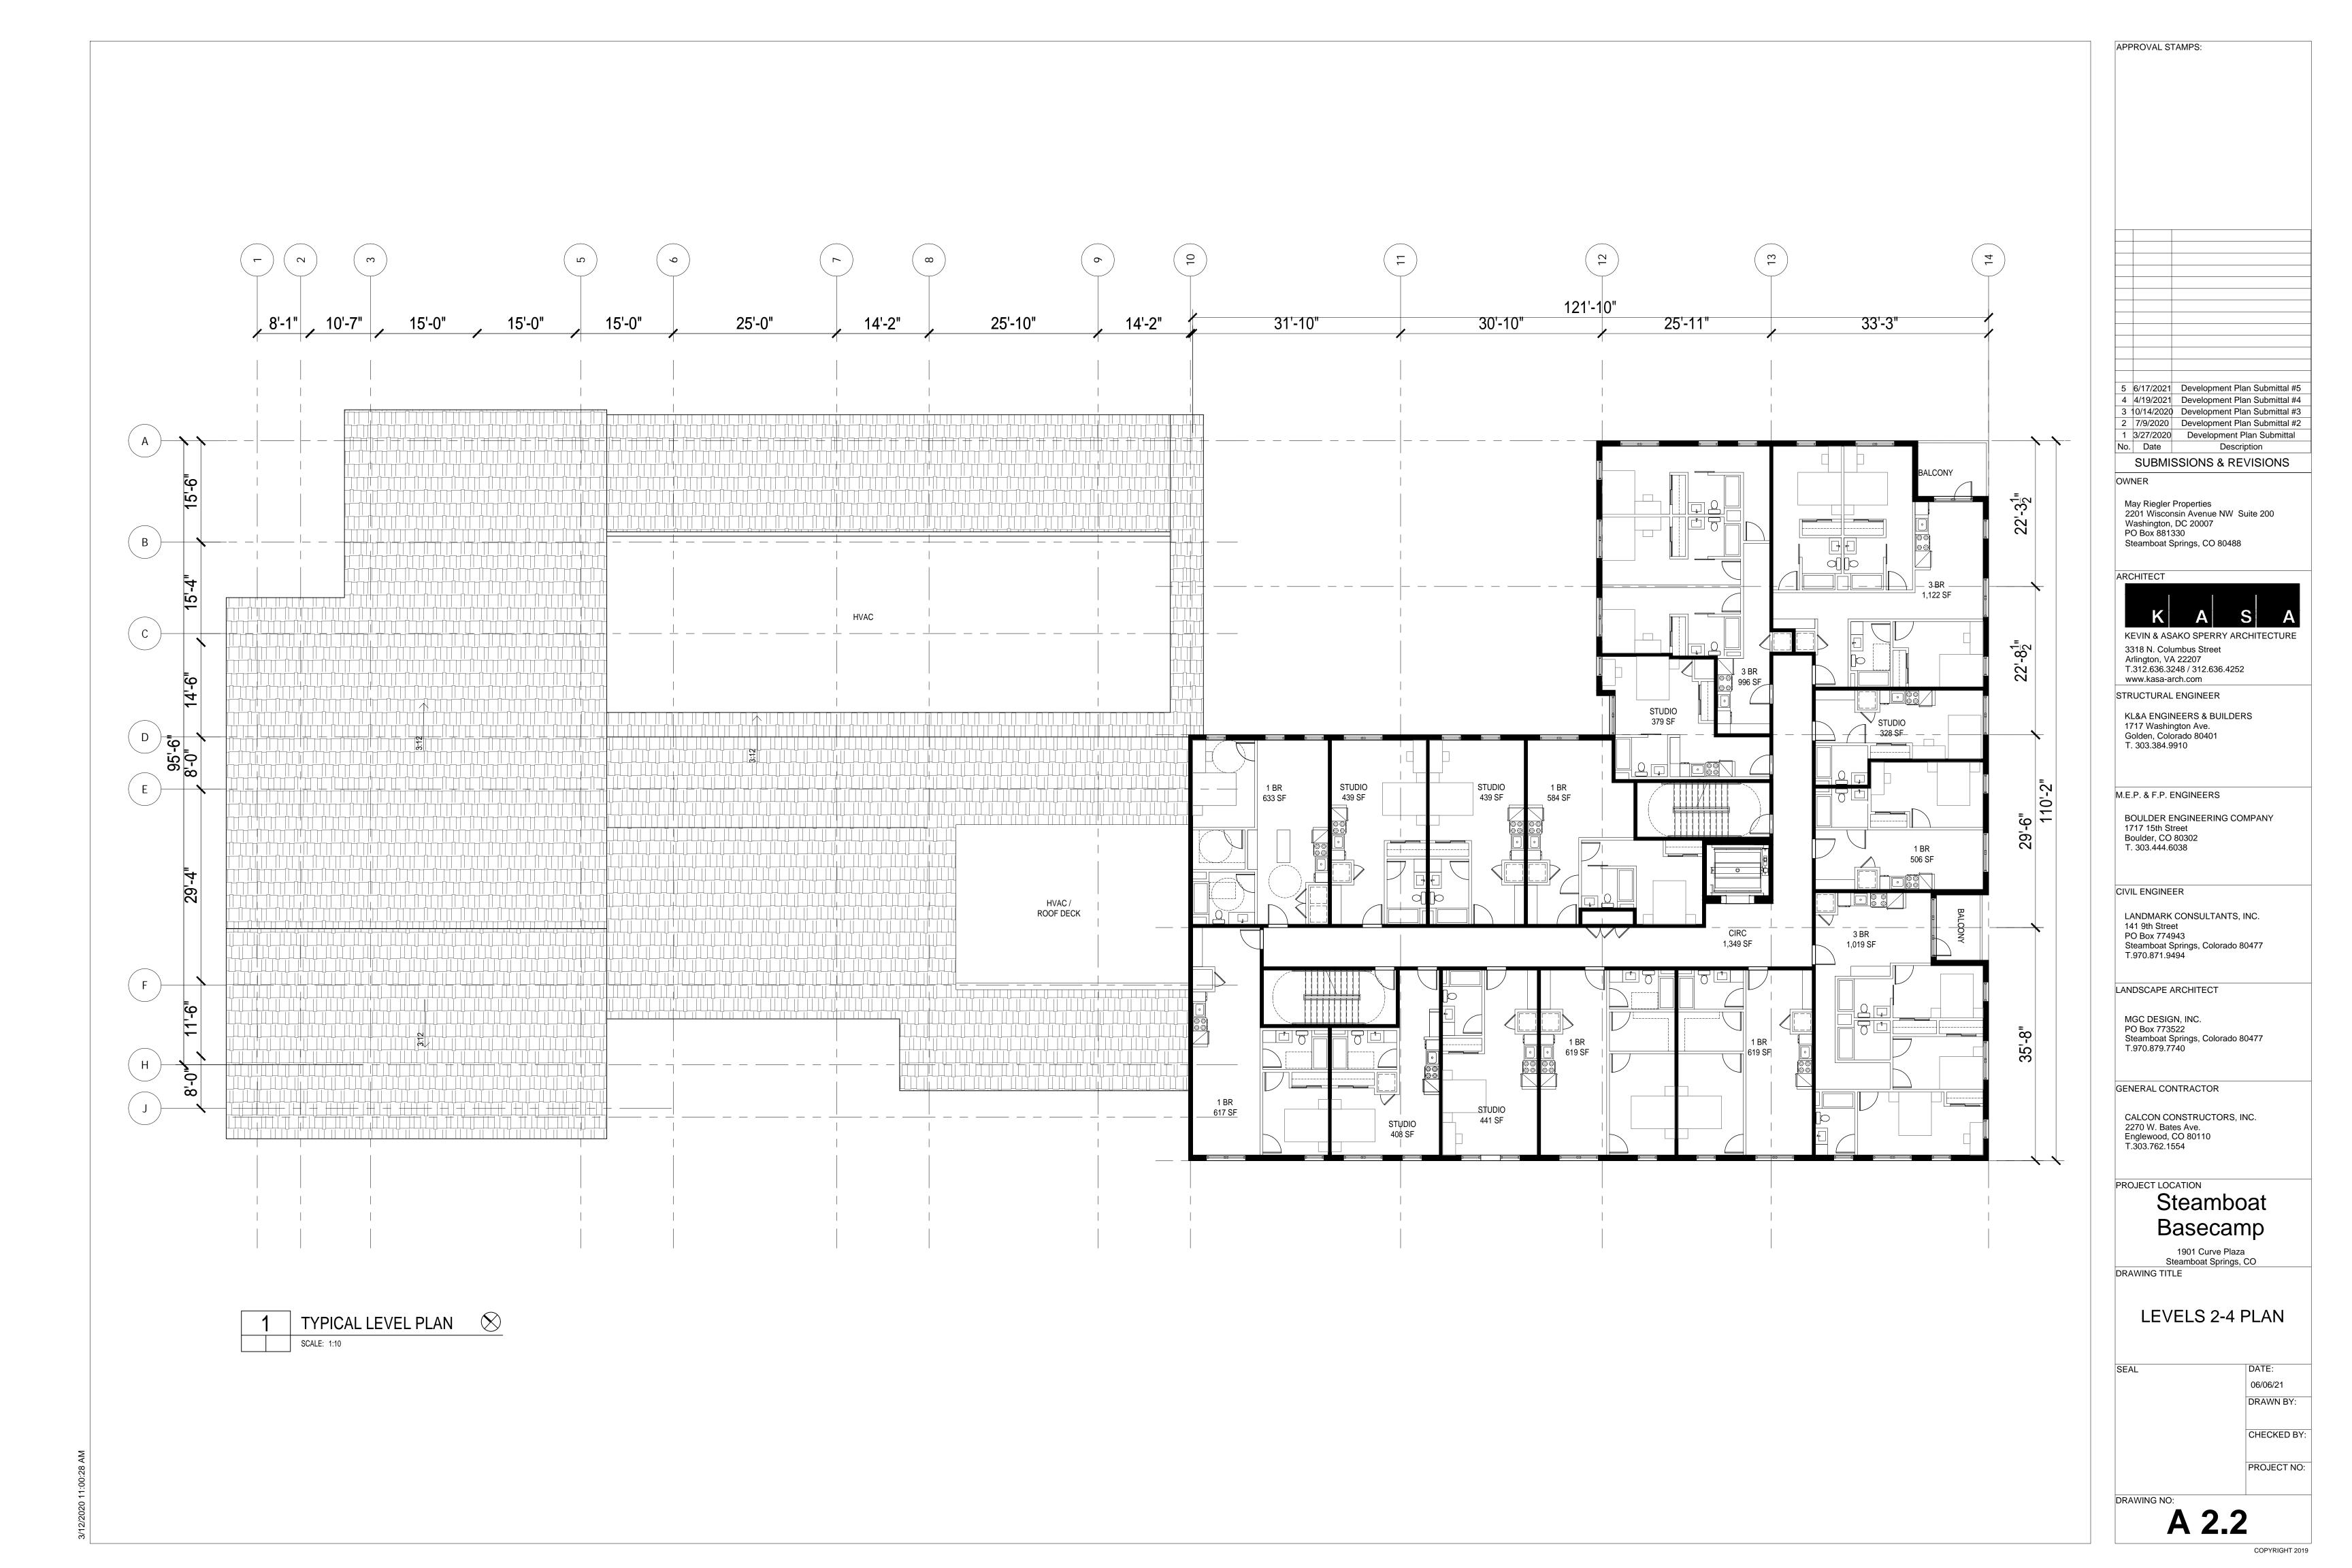


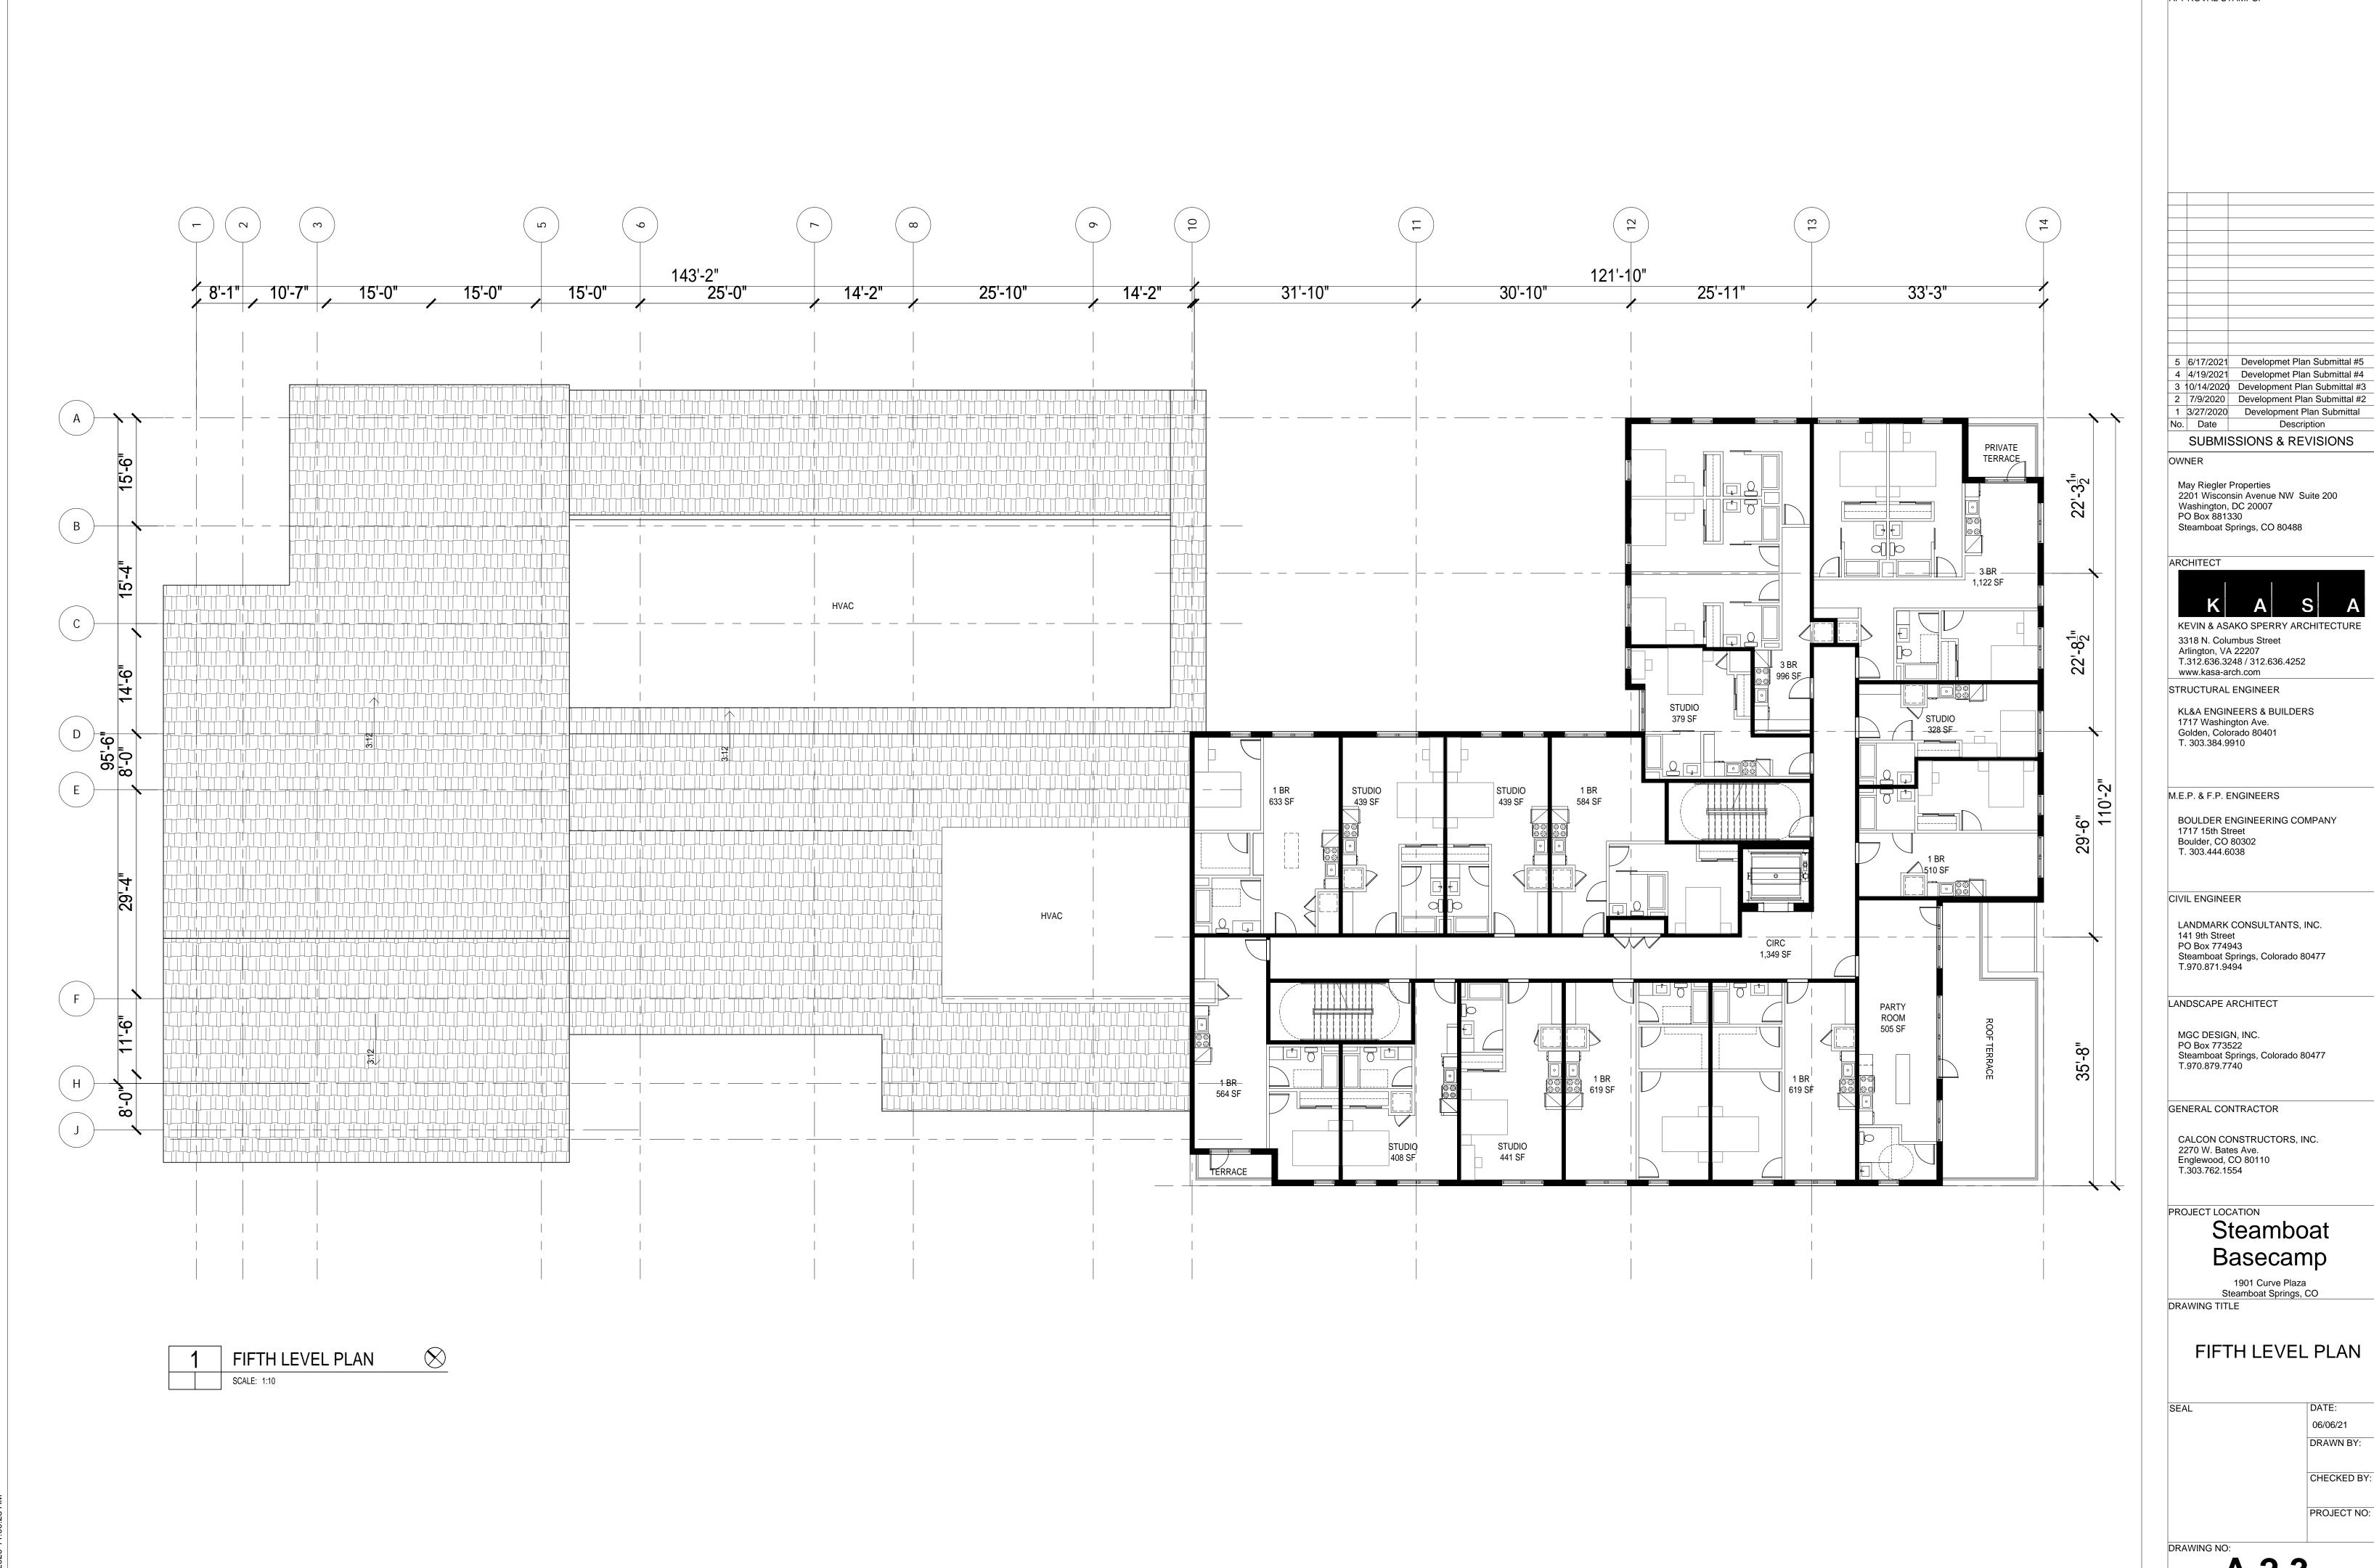
APPROVAL STAMPS:



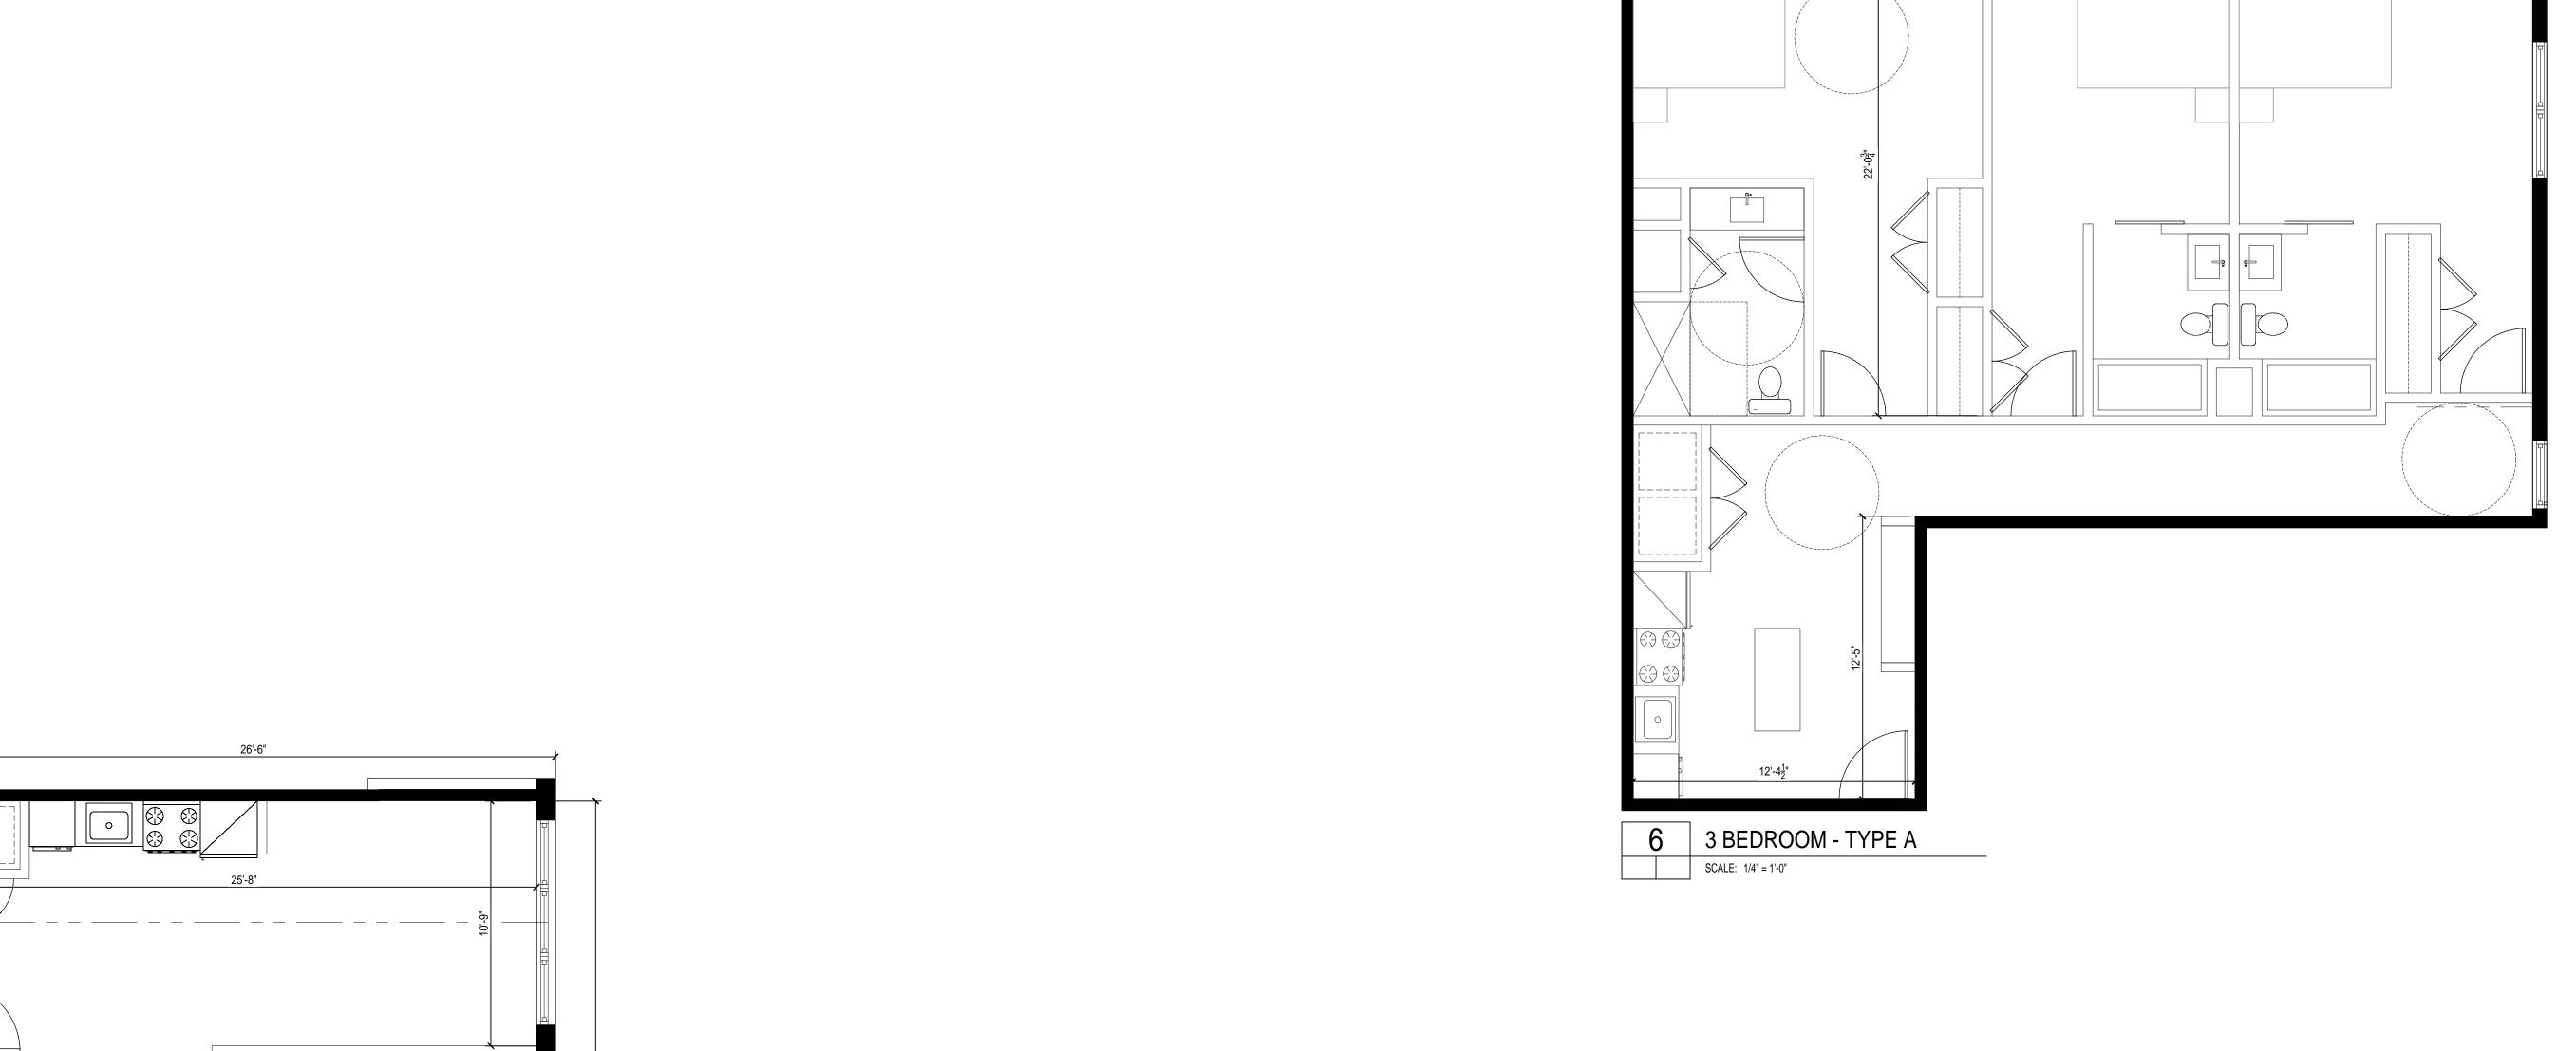


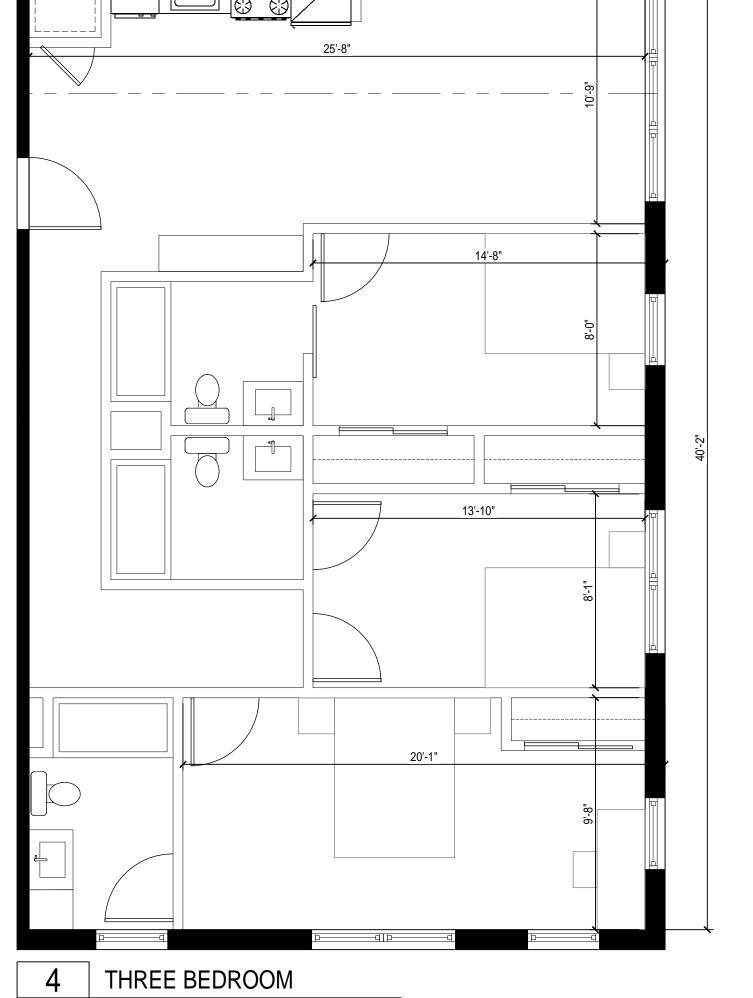

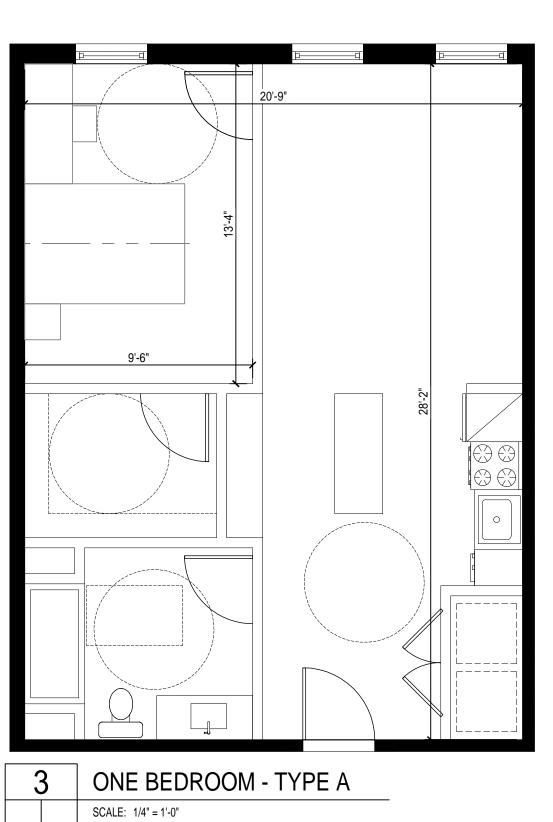

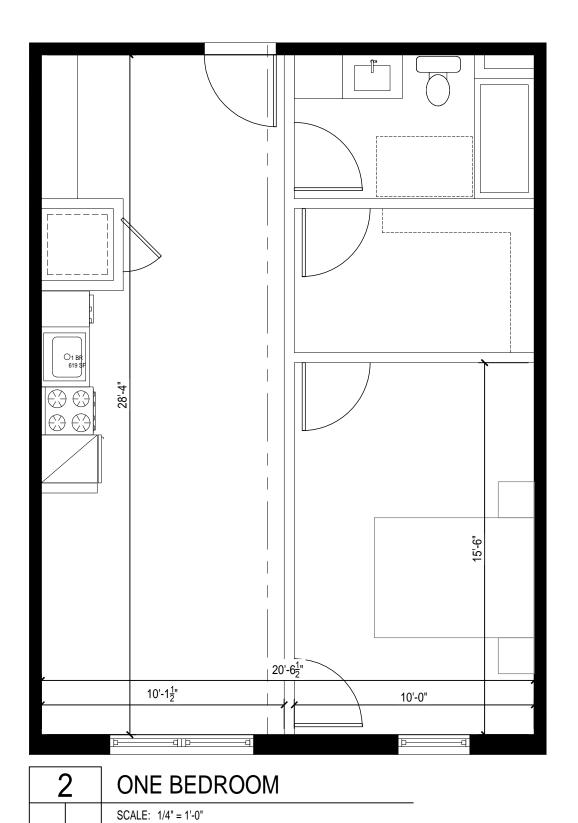


15'-4"

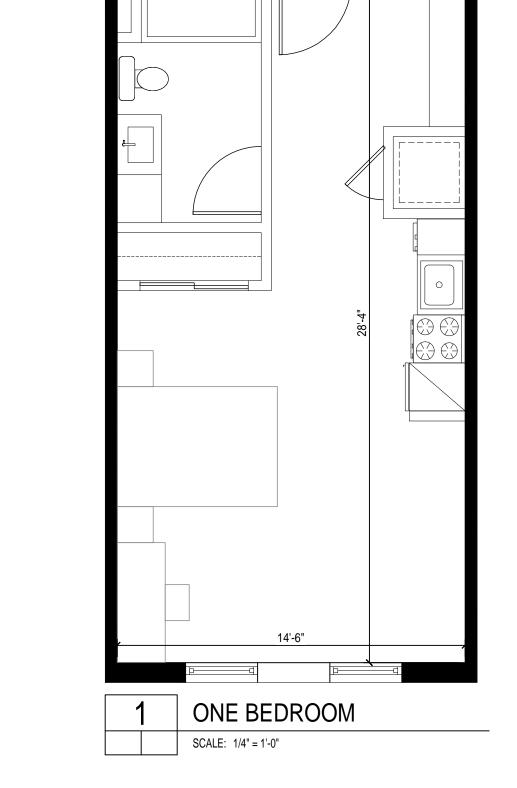


12'-10<u>1</u>"

10'-5"

39'-5<del>1</del>"

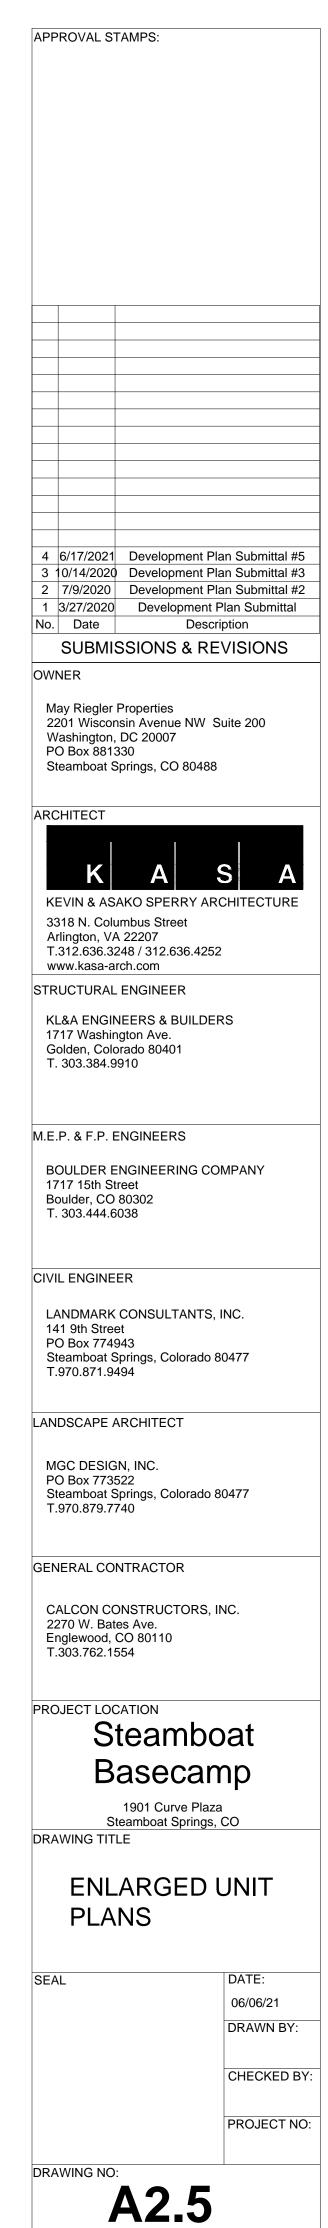

SCALE: 1/4" = 1'-0"

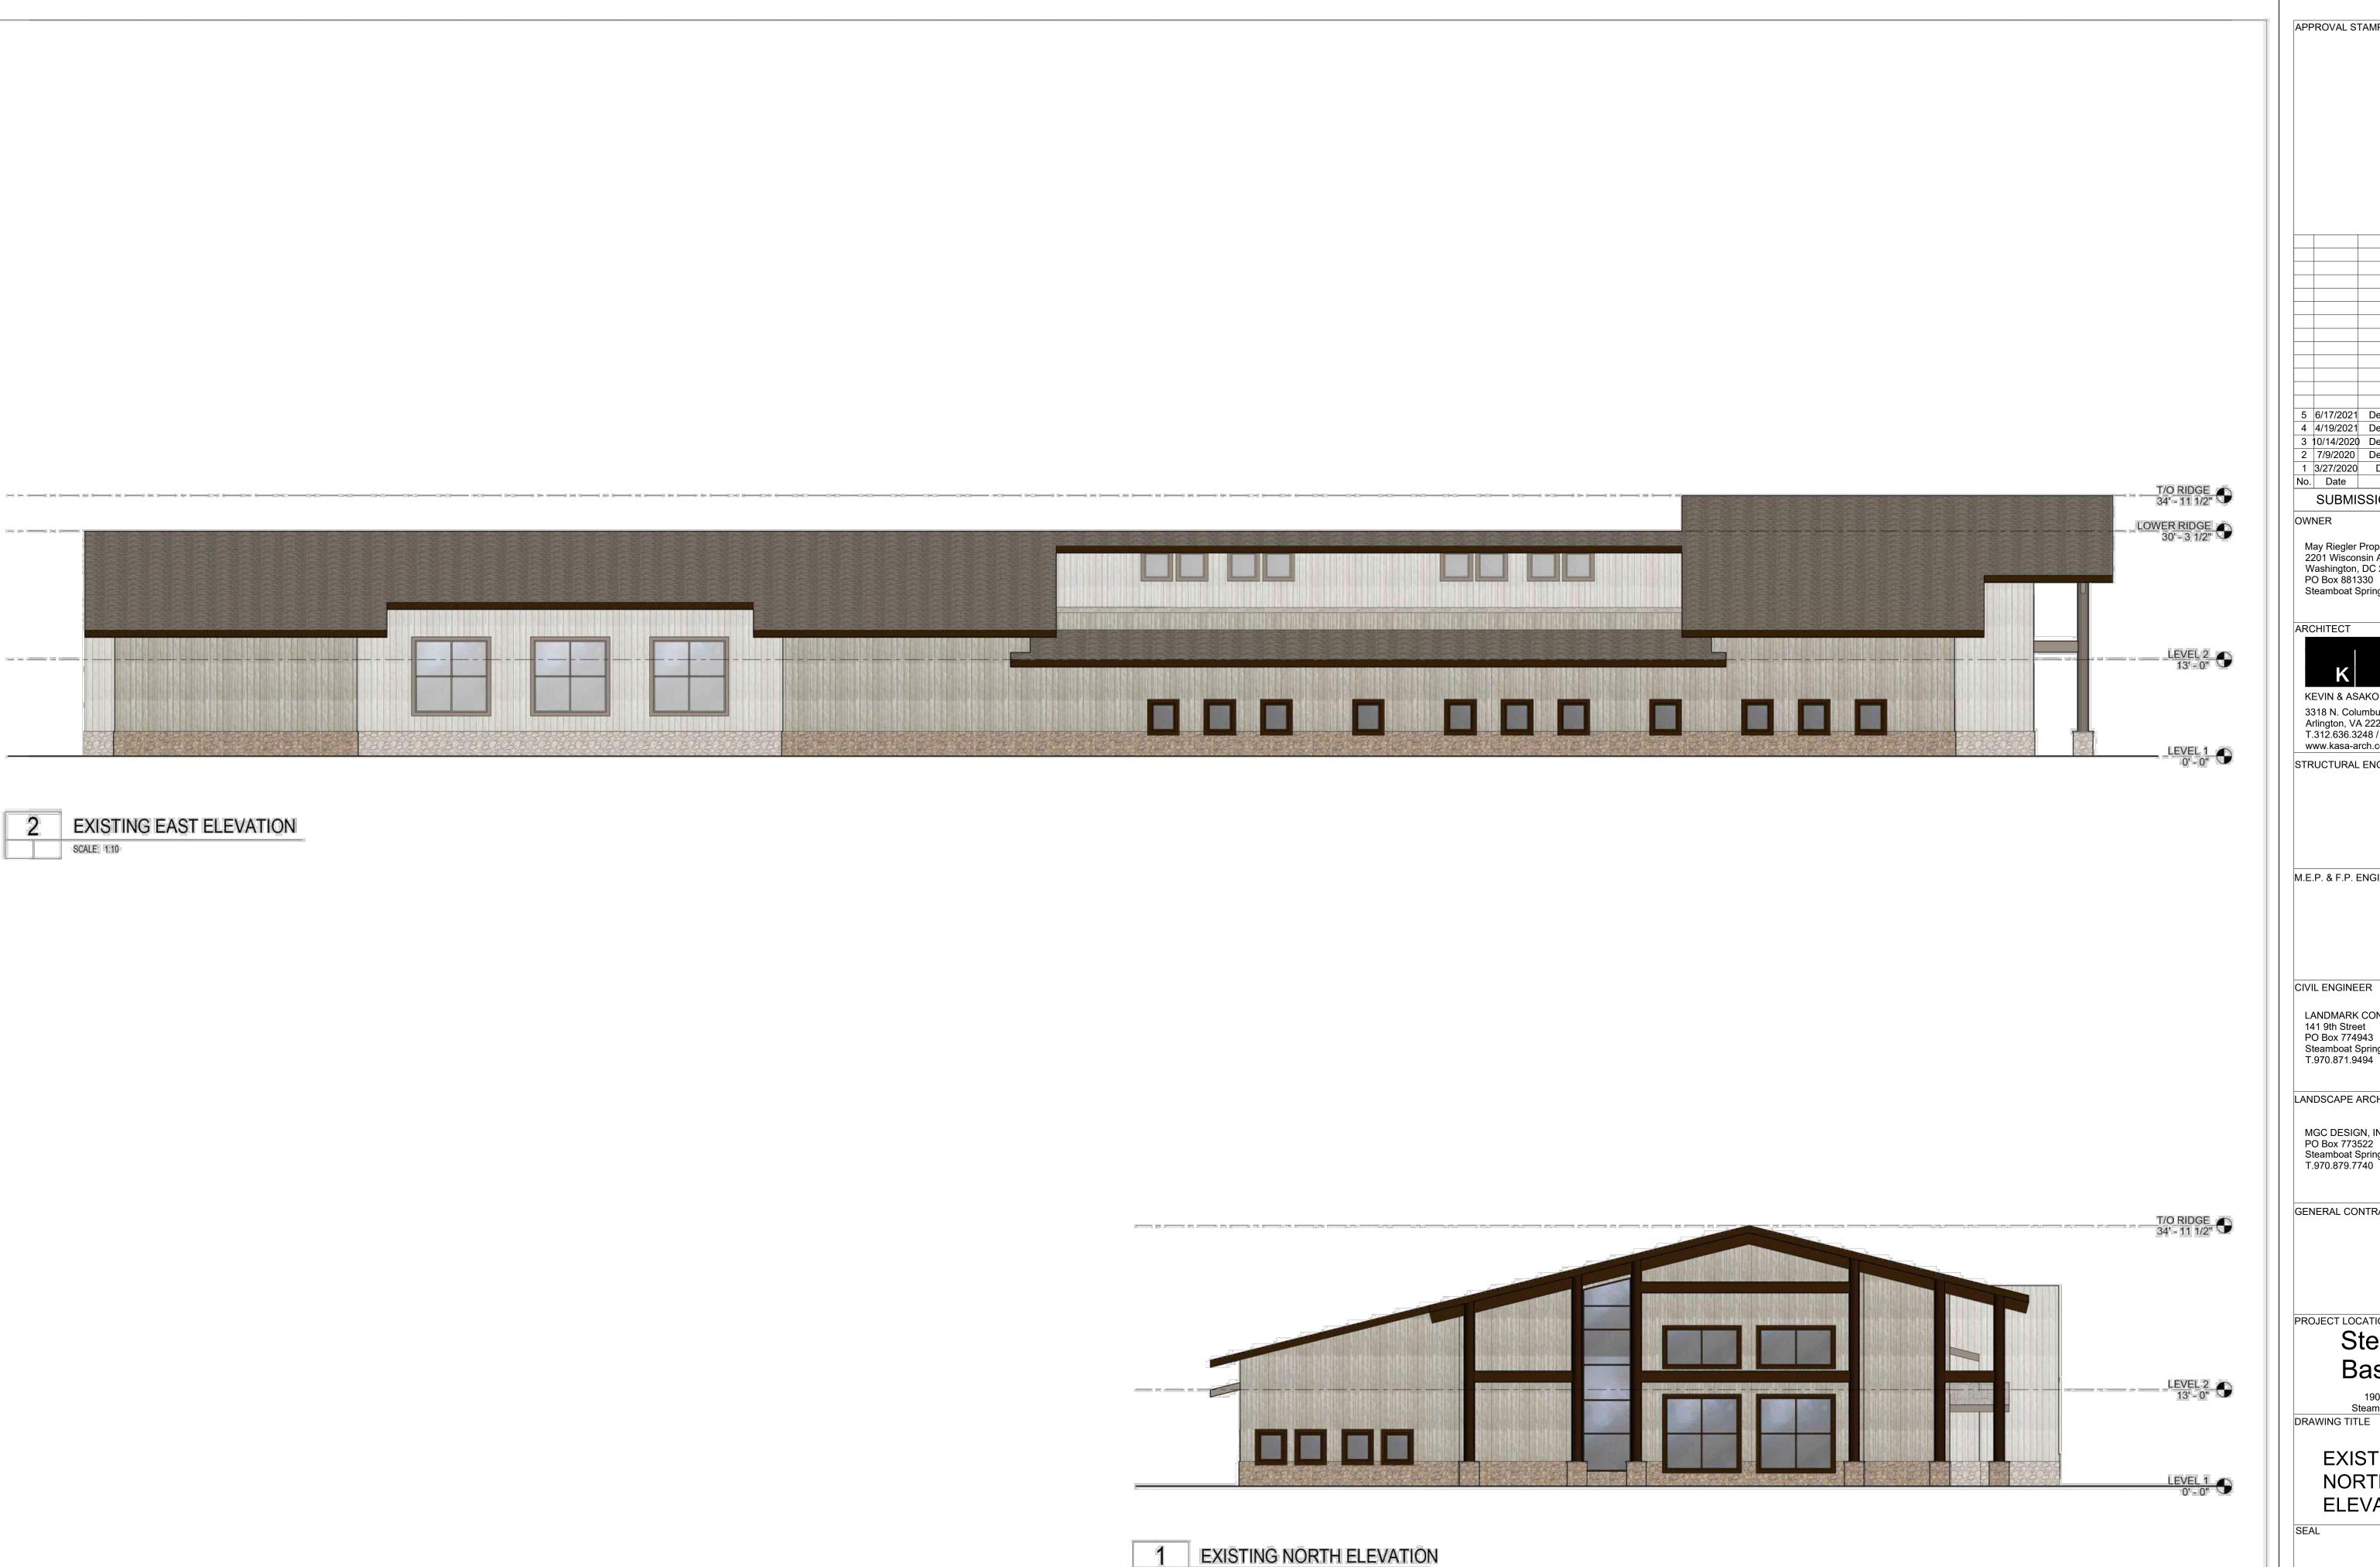

SCALE: 1:10

APPROVAL STAMPS: 5 6/17/2021 Development Plan Submittal #5 4 4/19/2021 Development Plan Submittal #4 3 10/14/2020 Development Plan Submittal #3 2 7/9/2020 Development Plan Submittal #2 1 3/27/2020 Development Plan Submittal No. Date Description SUBMISSIONS & REVISIONS May Riegler Properties
2201 Wisconsin Avenue NW Suite 200
Washington, DC 20007
PO Box 84 Springs CO 20408 Steamboat Springs, CO 80488 ARCHITECT KEVIN & ASAKO SPERRY ARCHITECTURE 3318 N. Columbus Street Arlington, VA 22207 T.312.636.3248 / 312.636.4252 www.kasa-arch.com STRUCTURAL ENGINEER M.E.P. & F.P. ENGINEERS CIVIL ENGINEER

LANDMARK CONSULTANTS, INC. 141 9th Street PO Box 774943 Steamboat Springs, Colorado 80477 T.970.871.9494

LANDSCAPE ARCHITECT

MGC DESIGN, INC. PO Box 773522 Steamboat Springs, Colorado 80477 T.970.879.7740

GENERAL CONTRACTOR

PROJECT LOCATION

#### Steamboat Basecamp

1901 Curve Plaza Steamboat Springs, CO

**EXISTING NORTH & EAST ELEVATIONS** 

> 03/27/20 DRAWN BY:

CHECKED BY: PROJECT NO:

DRAWING NO:

A3.02



2 EXISTING WEST ELEVATION



1 EXISTING SOUTH ELEVATION
SCALE 1:10

APPROVAL STAMPS:

5 6/17/2021 Development Plan Submittal #5
4 4/19/2021 Development Plan Submittal #4
3 10/14/2020 Development Plan Submittal #3
2 7/9/2020 Development Plan Submittal #2
1 3/27/2020 Development Plan Submittal Mo. Date Description

SUBMISSIONS & REVISIONS

OWNER

May Riegler Properties 2201 Wisconsin Avenue NW Suite 200 Washington, DC 20007 PO Box 881330 Steamboat Springs, CO 80488

ARCHITECT



KEVIN & ASAKO SPERRY ARCHITECTURE 3318 N. Columbus Street Arlington, VA 22207 T.312.636.3248 / 312.636.4252 www.kasa-arch.com

STRUCTURAL ENGINEER

M.E.P. & F.P. ENGINEERS

CIVIL ENGINEER

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LANDSCAPE ARCHITECT

MGC DESIGN, INC. PO Box 773522 Steamboat Springs, Colorado 80477 T.970.879.7740

GENERAL CONTRACTOR

PROJECT LOCATION

#### Steamboat Basecamp

1901 Curve Plaza Steamboat Springs, CO

EXISTING

SOUTH & WEST ELEVATIONS

EAL

DATE:
03/27/20
DRAWN BY:
CHECKED BY:

PROJECT NO:

DRAWING NO:

A3.01






TRASH ENCLOSURE ELEVATIONS

SCALE: 1:10

APPROVAL STAMPS: B 6/17/2021 Development Plan Submittal 2 4/19/2021 Development Plan Submittal 1 3/27/2020 Development Plan Submittal Description SUBMISSIONS & REVISIONS May Riegler Properties
2201 Wisconsin Avenue NW Suite 200
Washington, DC 20007
PO Box 881330 Steamboat Springs, CO 80488 ARCHITECT KEVIN & ASAKO SPERRY ARCHITECTURE 3318 N. Columbus Street Arlington, VA 22207 T.312.636.3248 / 312.636.4252 www.kasa-arch.com STRUCTURAL ENGINEER M.E.P. & F.P. ENGINEERS CIVIL ENGINEER LANDMARK CONSULTANTS, INC. 141 9th Street PO Box 774943 Steamboat Springs, Colorado 80477 T.970.871.9494 LANDSCAPE ARCHITECT MGC DESIGN, INC. PO Box 773522 Steamboat Springs, Colorado 80477 T.970.879.7740 GENERAL CONTRACTOR PROJECT LOCATION Steamboat Basecamp 1901 Curve Plaza Steamboat Springs, CO DRAWING TITLE PROPOSED SOUTH & WEST **ELEVATIONS** 04/16/21 DRAWN BY: CHECKED BY: PROJECT NO: DRAWING NO: **A3.11** 



EAST ELEVATION SCALE: 1:10

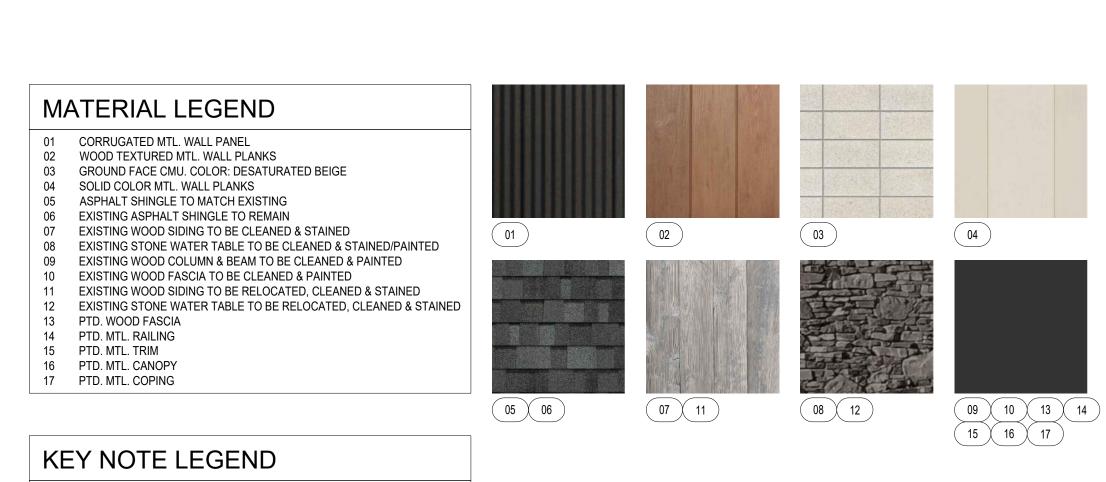

TRANSPARENCY	/ CALCUI	_ATIONS			
PRIMARY STREET FACADES - NEW CO	NSTRUCTION				
FACADE LOCATION	AREA	% REQUIREMENT	TRANSPARENCY REQUIRED	TRANSPARENCY PROVIDED	% PROVIDED
NORTH FACADE / GROUND LEVEL:	2,581 SF	30%	774.3 SF	557.8 SF	21.6%
EAST FACADE / GROUND LEVEL:	3,001 SF	30%	900.3 SF	306.1 SF	10.2%
SOUTH FACADE / GROUND LEVEL:	1,128 SF	30%	270.1 SF	213.3 SF	18.9%
WEST FACADE / GROUND LEVEL:	4,243 SF	30%	1,272.9 SF	1,032.4 SF	24.3%
NORTH FACADE / UPPER LEVELS:	N/A	N/A	N/A	N/A	N/A
EAST FACADE / UPPER LEVELS:	6,230 SF	25%	1,557.5 SF	1,309 SF	21%
SOUTH FACADE / UPPER LEVELS:	4,185 SF	25%	1,046 SF	882.5 SF	21.1%
WEST FACADE / GROUND LEVELS:	5,350 SF	25%	1,337.5 SF	1,195.1 SF	22.3%

A NEW EXTERIOR LIGHT FIXTURES. REFER TO A.XX & A.XX FOR DETAILS

B HATCHED WINDOWS INDICATE EXISTING TO REMAIN

C GARAGE DOOR STOREFRONT

F WALL MURAL

WOOD PRIVACY FENCE



A3.12

APPROVAL STAMPS:

3 6/17/2021 Development Plan Submittal 2 4/19/2021 Development Plan Submittal

SUBMISSIONS & REVISIONS

May Riegler Properties
2201 Wisconsin Avenue NW Suite 200
Washington, DC 20007
PO Box 881330

KEVIN & ASAKO SPERRY ARCHITECTURE

Steamboat Springs, CO 80488

3318 N. Columbus Street Arlington, VA 22207 T.312.636.3248 / 312.636.4252

LANDMARK CONSULTANTS, INC.

Steamboat Springs, Colorado 80477 T.970.871.9494

PO Box 773522 Steamboat Springs, Colorado 80477 T.970.879.7740

Steamboat

Basecamp

1901 Curve Plaza

Steamboat Springs, CO

PROPOSED

**NORTH & EAST** 

**ELEVATIONS** 

DRAWING NO:

141 9th Street PO Box 774943

LANDSCAPE ARCHITECT

MGC DESIGN, INC.

www.kasa-arch.com STRUCTURAL ENGINEER

ARCHITECT

Description


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04/16/21

DRAWN BY:

CHECKED BY:

PROJECT NO:

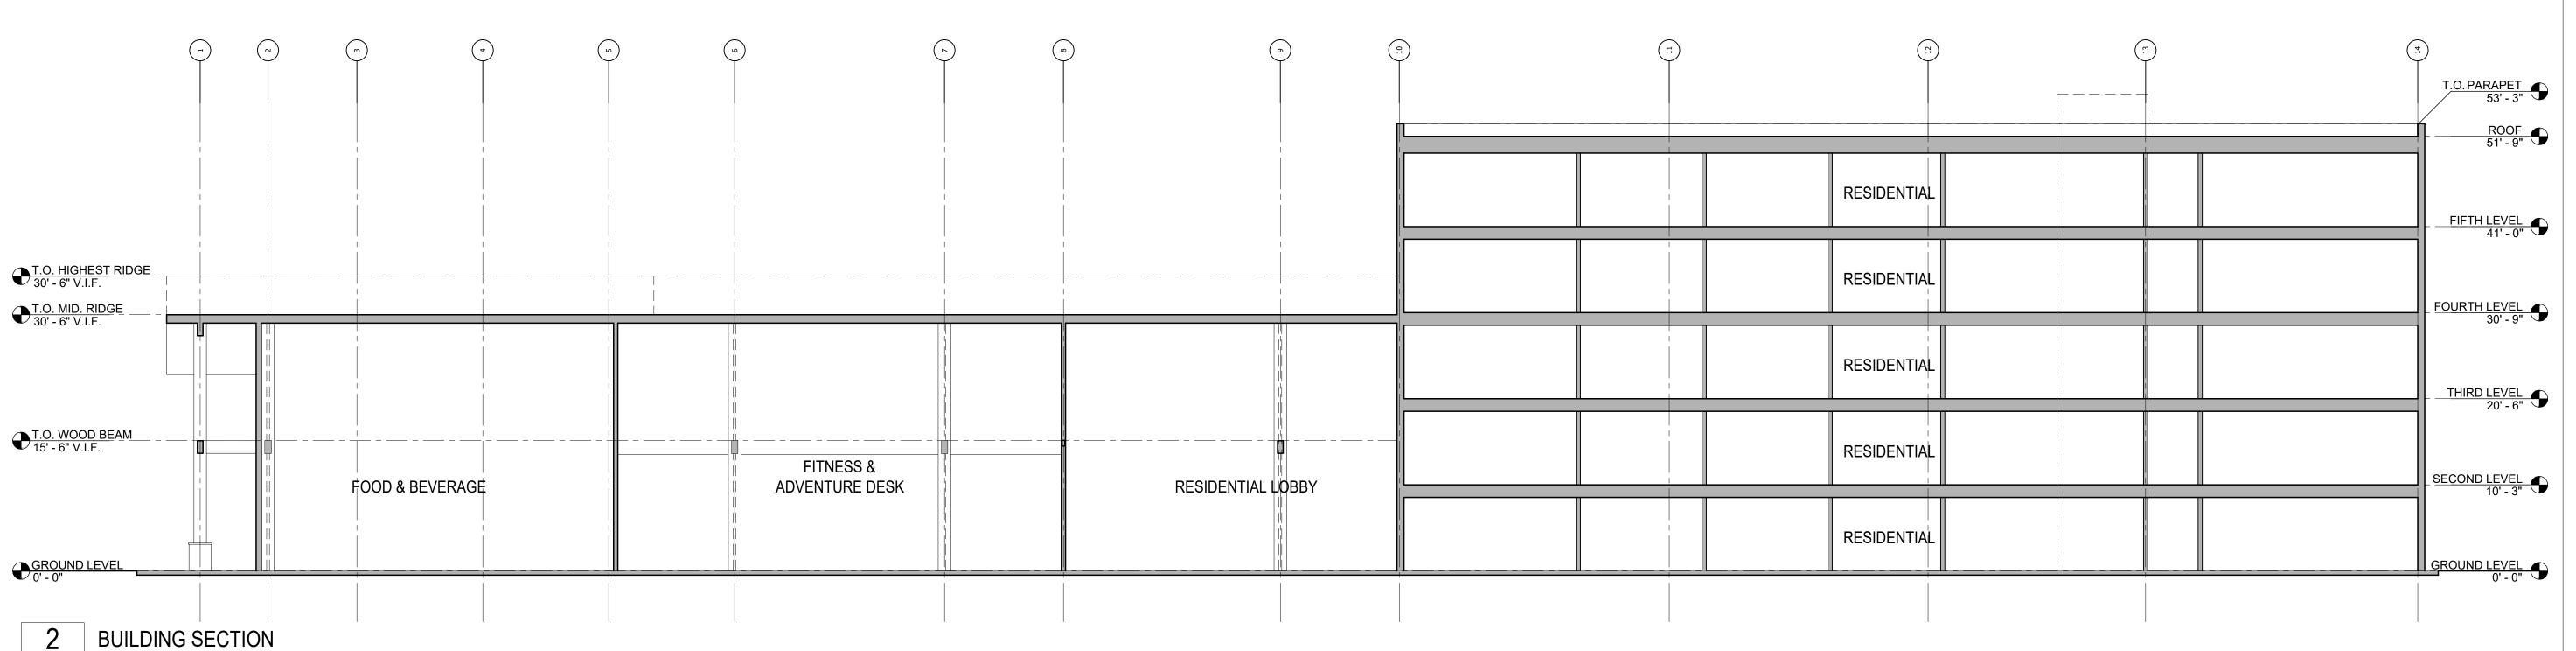

SCALE: 1:10

PEAK OF ROOF 35' - 1" V.I.F. T.O. RIDGE 30' - 6" V.I.F. T.O. STEEL BEAM 14' - 10 1/2" V.I.F. FITNESS & ADVENTURE DESK GROUND LEVEL 0' - 0" **BUILDING SECTION** SCALE: 1:10

3 6/17/2021 Development Plan Submittal 2 4/19/2021 Development Plan Submittal 1 3/27/2020 Development Plan Submittal Description SUBMISSIONS & REVISIONS

APPROVAL STAMPS:

May Riegler Properties 2201 Wisconsin Avenue NW Suite 200 Washington, DC 20007 PO Box 881330 Steamboat Springs, CO 80488

ARCHITECT



www.kasa-arch.com STRUCTURAL ENGINEER

M.E.P. & F.P. ENGINEERS

CIVIL ENGINEER

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LANDSCAPE ARCHITECT

MGC DESIGN, INC. PO Box 773522 Steamboat Springs, Colorado 80477 T.970.879.7740

GENERAL CONTRACTOR

PROJECT LOCATION Steamboat Basecamp

1901 Curve Plaza Steamboat Springs, CO DRAWING TITLE

> PROPOSED BUILDING

SECTIONS DATE: 04/16/21 DRAWN BY: CHECKED BY: PROJECT NO:

DRAWING NO:

**A3.2** 



PERSPECTIVE RENDERING

SCALE: N.T.S.

APPROVAL STAMPS:

5 6/17/2021 Development Plan Submittal #5 4 4/19/2021 Development Plan Submittal #4 3 10/14/2020 Development Plan Submittal #3 2 7/9/2020 Development Plan Submittal #2 1 3/27/2020 Development Plan Submittal

Description

SUBMISSIONS & REVISIONS

OWNER

No. Date

May Riegler Properties
2201 Wisconsin Avenue NW Suite 200
Washington, DC 20007
PO Box 881330 Steamboat Springs, CO 80488

ARCHITECT



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LANDMARK CONSULTANTS, INC. 141 9th Street PO Box 774943 Steamboat Springs, Colorado 80477 T.970.871.9494

LANDSCAPE ARCHITECT

MGC DESIGN, INC. PO Box 773522 Steamboat Springs, Colorado 80477 T.970.879.7740

GENERAL CONTRACTOR

PROJECT LOCATION

Steamboat Basecamp

1901 Curve Plaza Steamboat Springs, CO DRAWING TITLE

> PROPOSED PERSPECTIVE RENDERING

03/27/20 DRAWN BY:

PROJECT NO:

CHECKED BY:

DRAWING NO:



PERSPECTIVE RENDERING

SCALE: N.T.S.

APPROVAL STAMPS:

5 6/17/2021 Development Plan Submittal #5 4 4/19/2021 Development Plan Submittal #4 3 10/14/2020 Development Plan Submittal #3 2 7/9/2020 Development Plan Submittal #2 1 3/27/2020 Development Plan Submittal

Description

SUBMISSIONS & REVISIONS

OWNER

No. Date

May Riegler Properties
2201 Wisconsin Avenue NW Suite 200
Washington, DC 20007
PO Box 881330 Steamboat Springs, CO 80488



3318 N. Columbus Street Arlington, VA 22207 T.312.636.3248 / 312.636.4252 www.kasa-arch.com

STRUCTURAL ENGINEER

M.E.P. & F.P. ENGINEERS

CIVIL ENGINEER

LANDMARK CONSULTANTS, INC. 141 9th Street PO Box 774943 Steamboat Springs, Colorado 80477 T.970.871.9494

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PROJECT NO:

DRAWING NO:



PERSPECTIVE RENDERING SCALE: N.T.S.

APPROVAL STAMPS:

5 6/17/2021 Development Plan Submittal #5 4 4/19/2021 Development Plan Submittal #4

2 7/9/2020 Development Plan Submittal #2 1 3/27/2020 Development Plan Submittal No. Date Description

SUBMISSIONS & REVISIONS

3 10/14/2020 Development Plan Submittal #3

OWNER

May Riegler Properties 2201 Wisconsin Avenue NW Suite 200 Washington, DC 20007 PO Box 881330 Steamboat Springs, CO 80488

ARCHITECT

KEVIN & ASAKO SPERRY ARCHITECTURE 3318 N. Columbus Street Arlington, VA 22207 T.312.636.3248 / 312.636.4252 www.kasa-arch.com

STRUCTURAL ENGINEER

M.E.P. & F.P. ENGINEERS

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LANDSCAPE ARCHITECT

MGC DESIGN, INC. PO Box 773522 Steamboat Springs, Colorado 80477 T.970.879.7740

GENERAL CONTRACTOR

PROJECT LOCATION

Steamboat Basecamp


1901 Curve Plaza Steamboat Springs, CO DRAWING TITLE

> PROPOSED PERSPECTIVE RENDERING

03/27/20 DRAWN BY:

> CHECKED BY: PROJECT NO:

DRAWING NO:

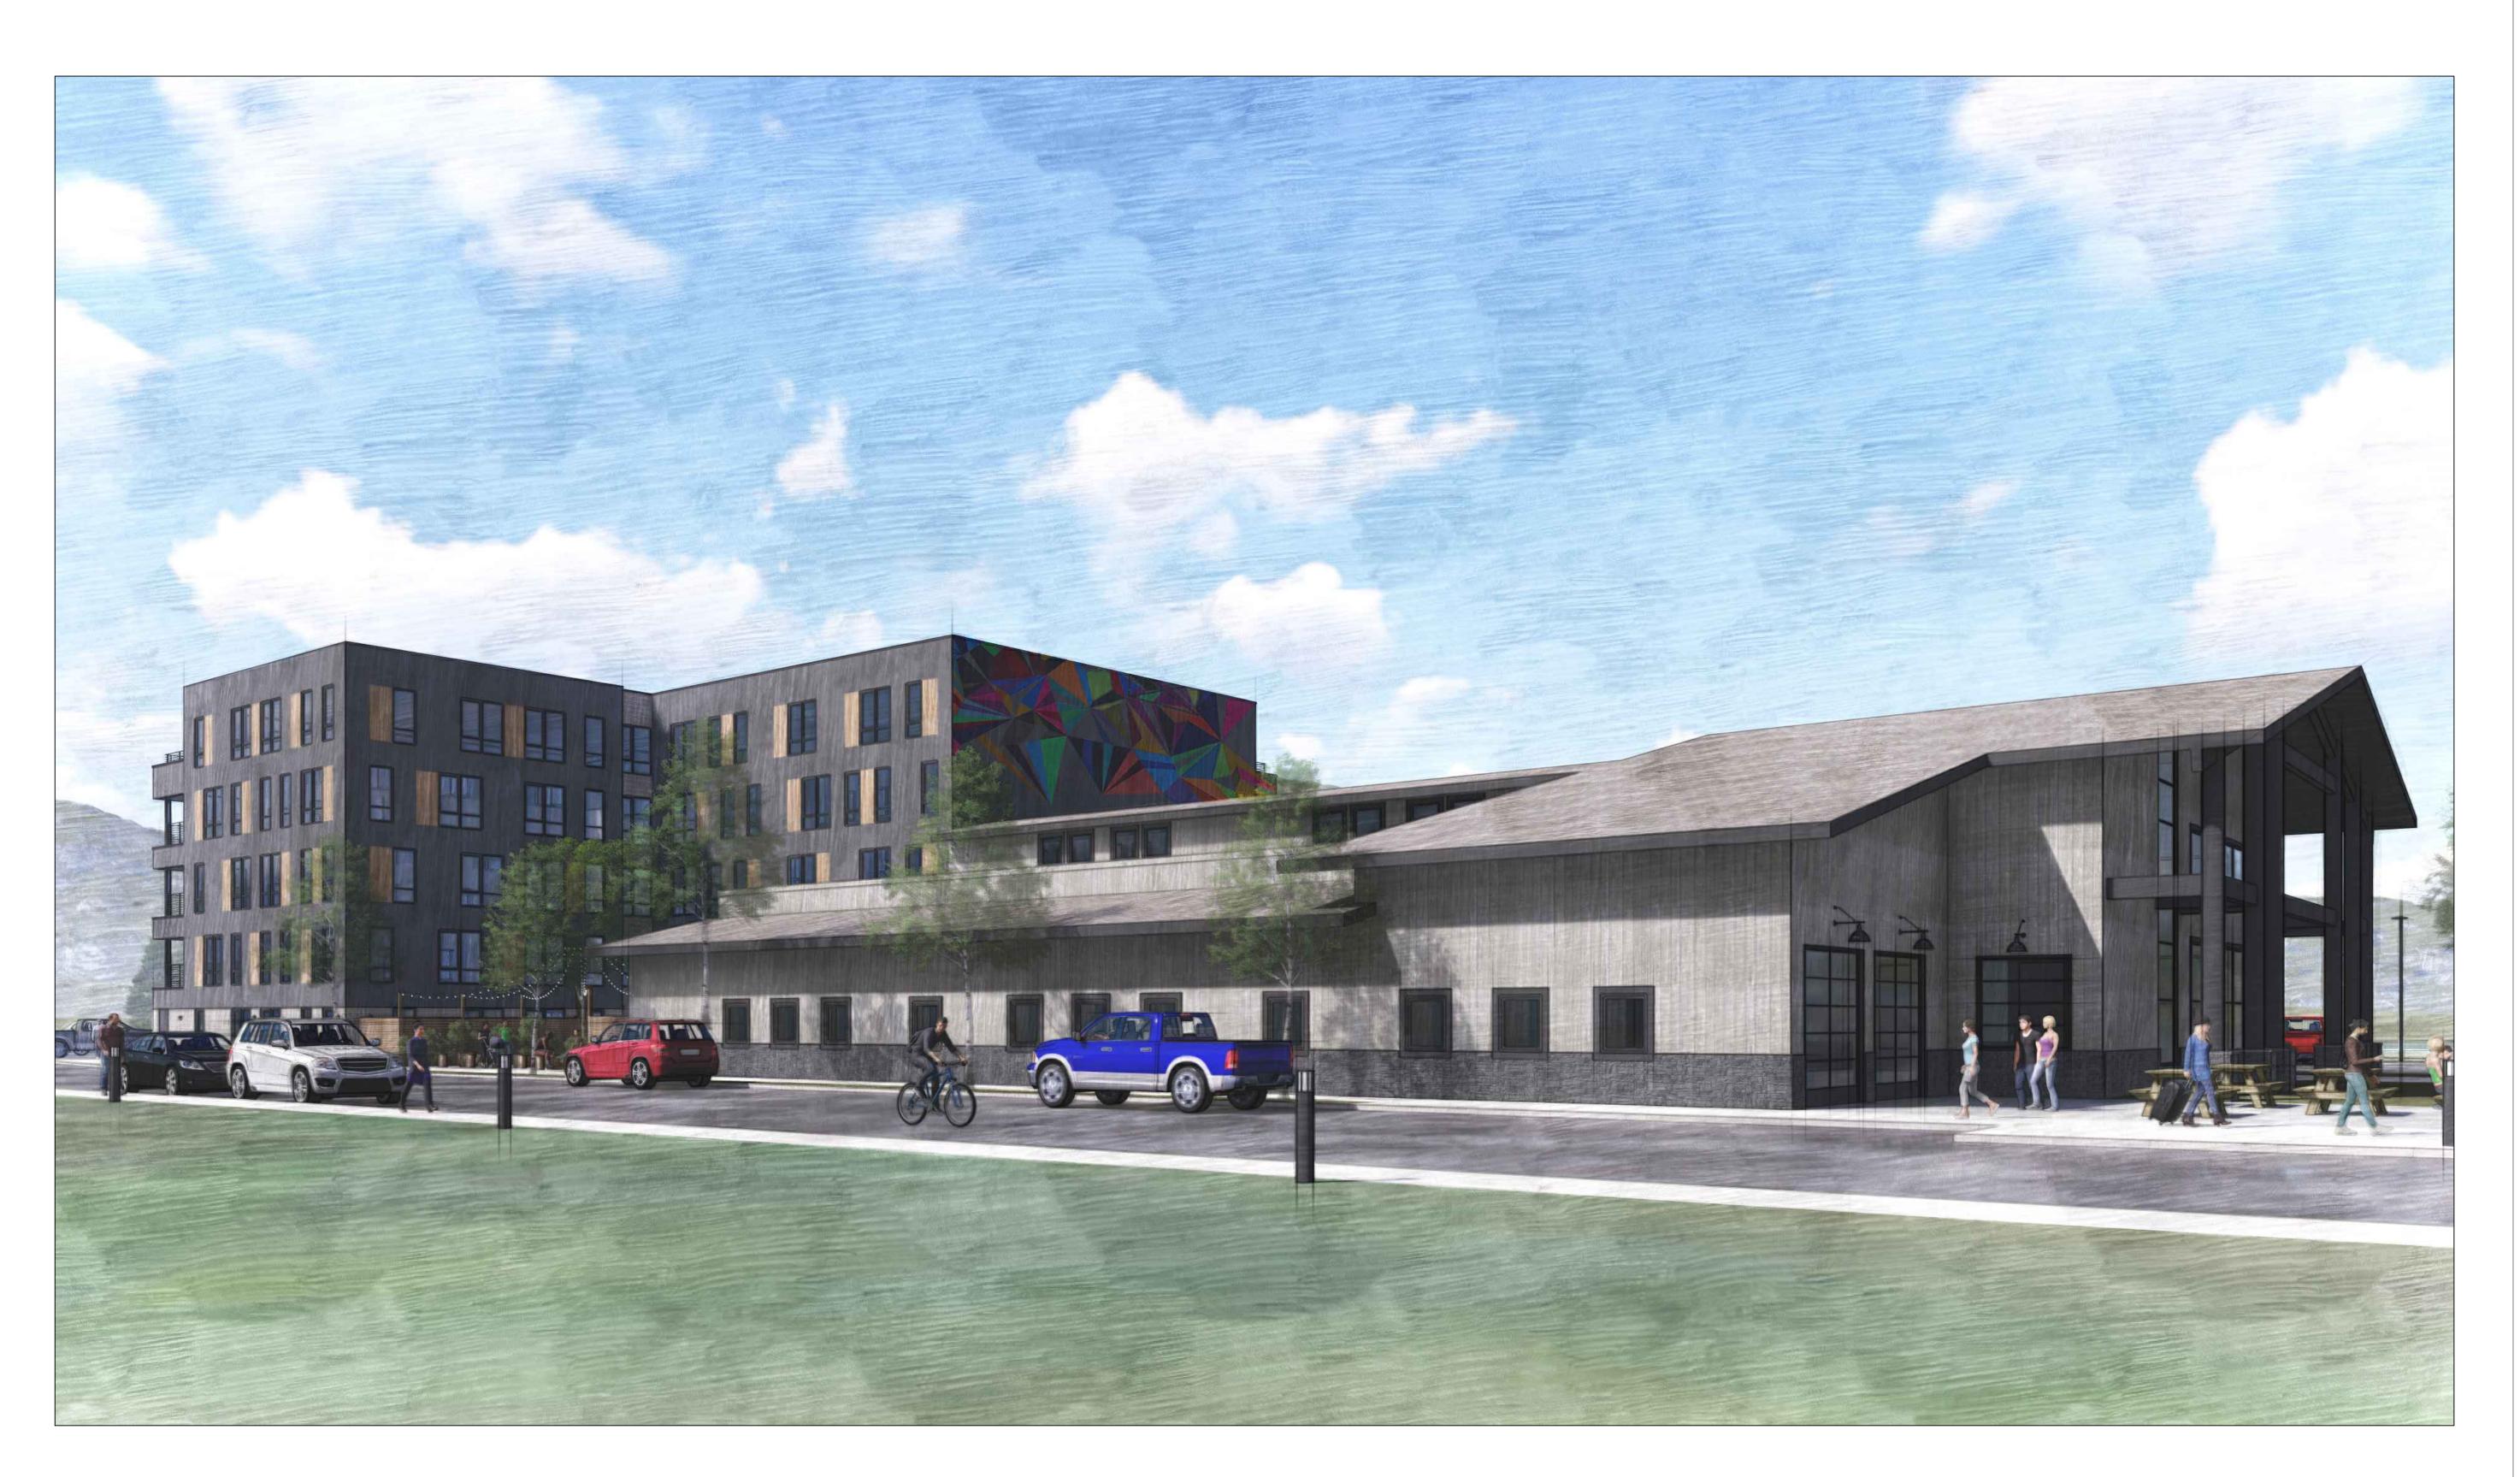

PERSPECTIVE RENDERING SCALE: N.T.S.

5 6/17/2021 Development Plan Submittal #5 4 4/19/2021 Development Plan Submittal #4 3 10/14/2020 Development Plan Submittal #3 2 7/9/2020 Development Plan Submittal #2 1 3/27/2020 Development Plan Submittal No. Date SUBMISSIONS & REVISIONS OWNER May Riegler Properties
2201 Wisconsin Avenue NW Suite 200
Washington, DC 20007
PO Box 881330 Steamboat Springs, CO 80488 ARCHITECT KEVIN & ASAKO SPERRY ARCHITECTURE 3318 N. Columbus Street Arlington, VA 22207 T.312.636.3248 / 312.636.4252 www.kasa-arch.com STRUCTURAL ENGINEER M.E.P. & F.P. ENGINEERS CIVIL ENGINEER

Description

APPROVAL STAMPS:

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LANDSCAPE ARCHITECT

MGC DESIGN, INC. PO Box 773522 Steamboat Springs, Colorado 80477 T.970.879.7740

GENERAL CONTRACTOR

PROJECT LOCATION Steamboat

Basecamp

1901 Curve Plaza Steamboat Springs, CO DRAWING TITLE


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03/27/20 DRAWN BY:

> CHECKED BY: PROJECT NO:

> > COPYRIGHT 2019

DRAWING NO:

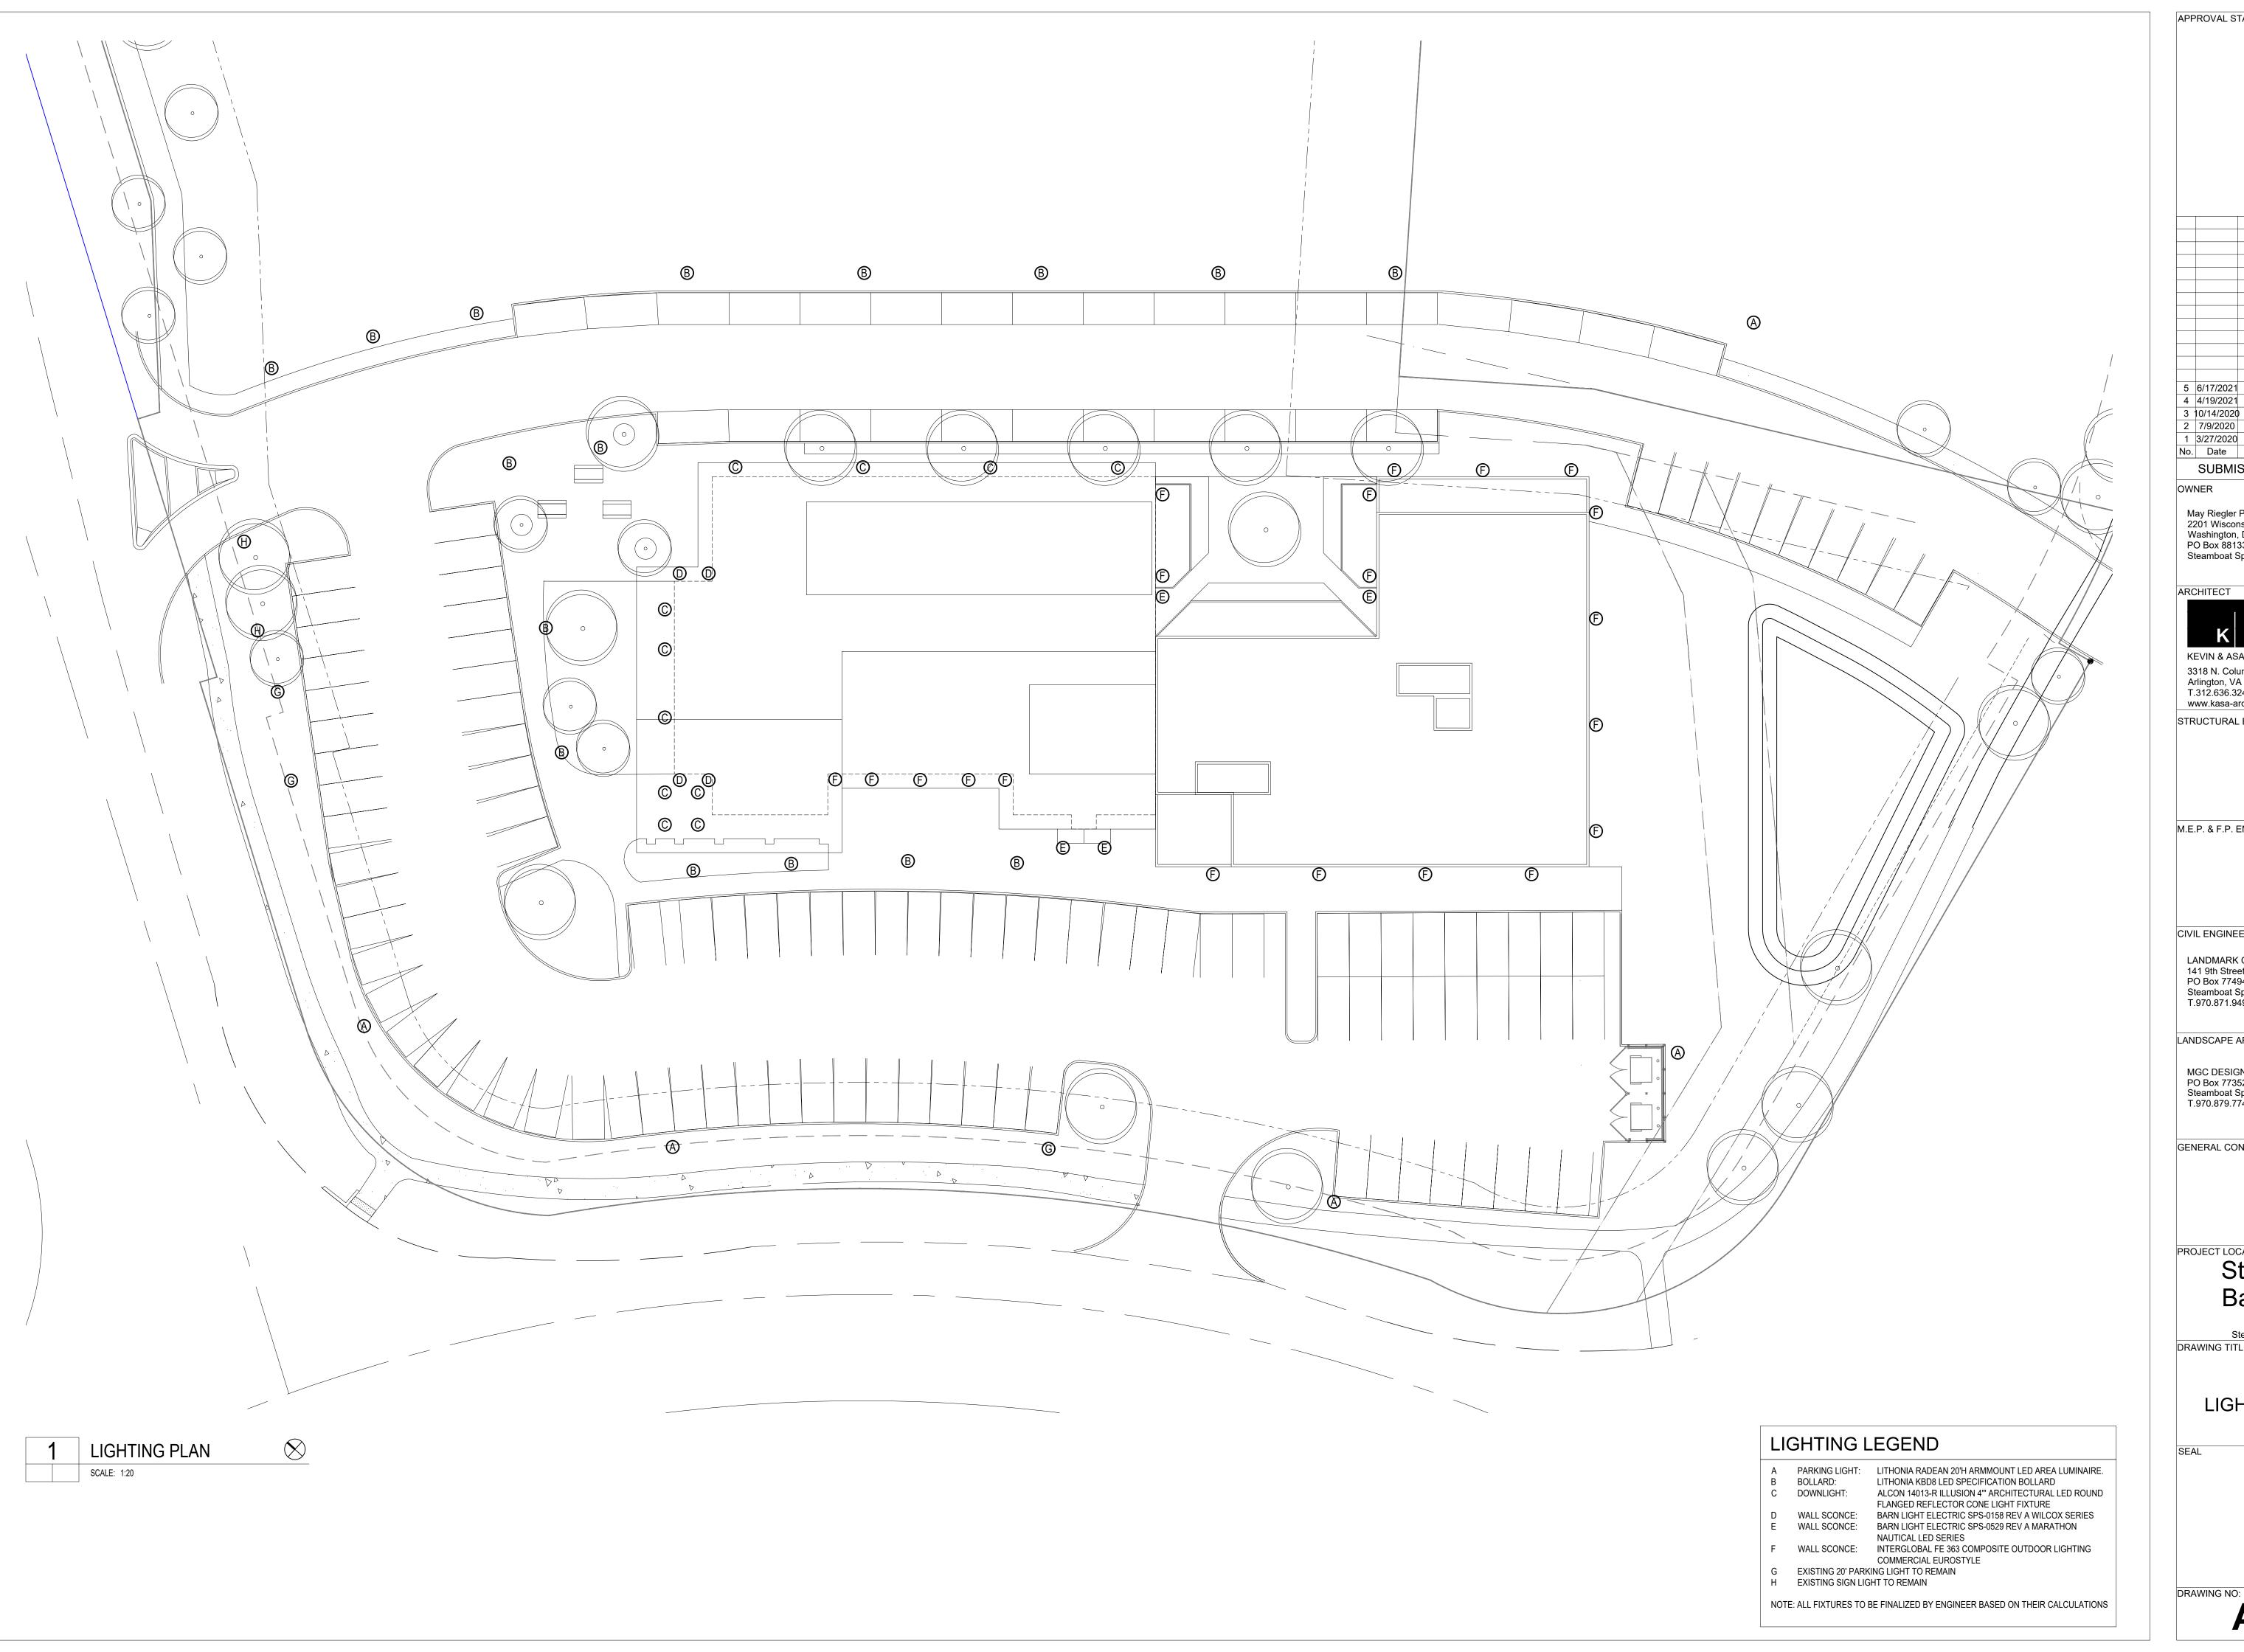


APPROVAL STAMPS: 5 6/17/2021 Development Plan Submittal #5 4 4/19/2021 Development Plan Submittal #4 3 10/14/2020 Development Plan Submittal #3 2 7/9/2020 Development Plan Submittal #2 1 3/27/2020 Development Plan Submittal No. Date Description SUBMISSIONS & REVISIONS OWNER May Riegler Properties 2201 Wisconsin Avenue NW Suite 200 Washington, DC 20007 PO Box 881330 Steamboat Springs, CO 80488 ARCHITECT KEVIN & ASAKO SPERRY ARCHITECTURE 3318 N. Columbus Street Arlington, VA 22207 T.312.636.3248 / 312.636.4252 www.kasa-arch.com STRUCTURAL ENGINEER M.E.P. & F.P. ENGINEERS CIVIL ENGINEER LANDMARK CONSULTANTS, INC. 141 9th Street PO Box 774943 Steamboat Springs, Colorado 80477 T.970.871.9494 LANDSCAPE ARCHITECT MGC DESIGN, INC. PO Box 773522 Steamboat Springs, Colorado 80477 T.970.879.7740 GENERAL CONTRACTOR PROJECT LOCATION Steamboat Basecamp 1901 Curve Plaza Steamboat Springs, CO DRAWING TITLE LIGHTING PLAN

DATE:
03/27/20
DRAWN BY:


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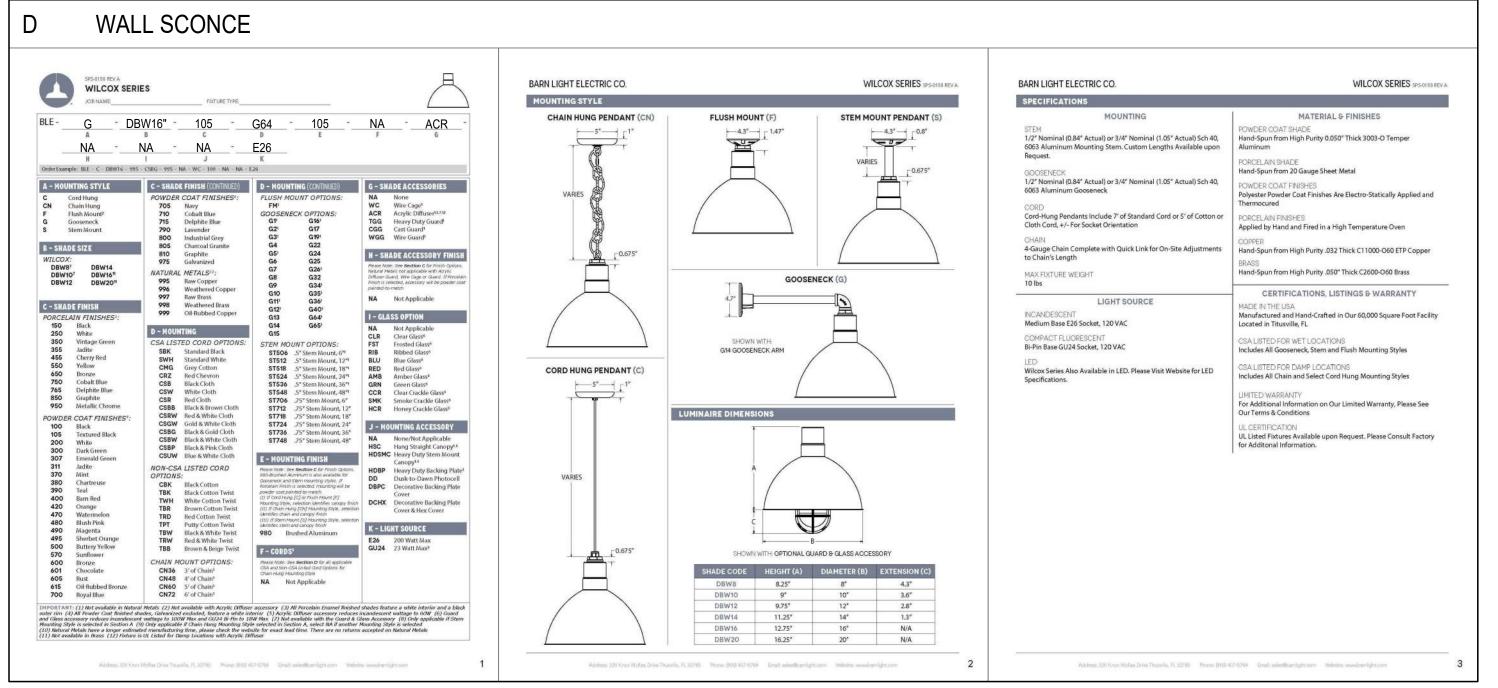
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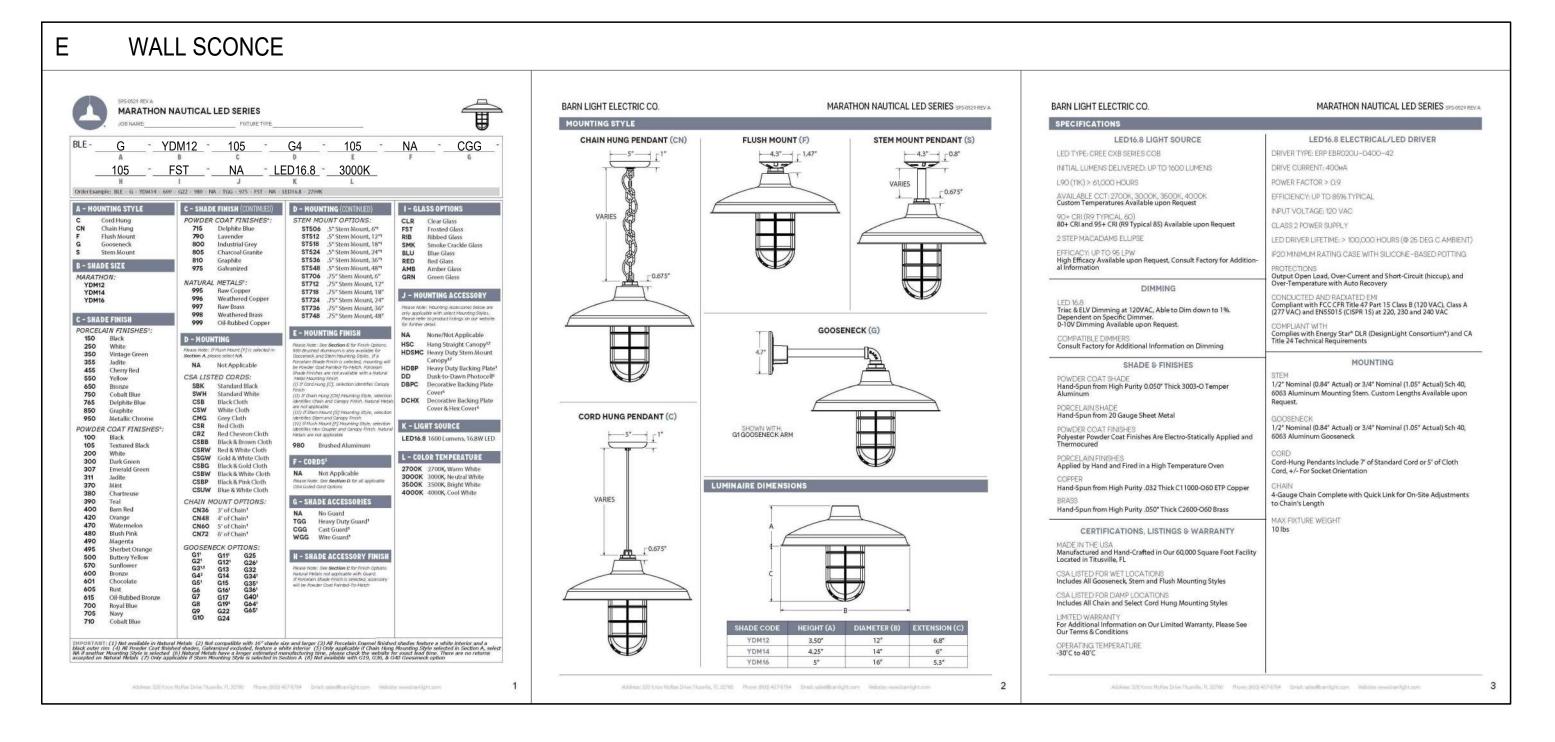
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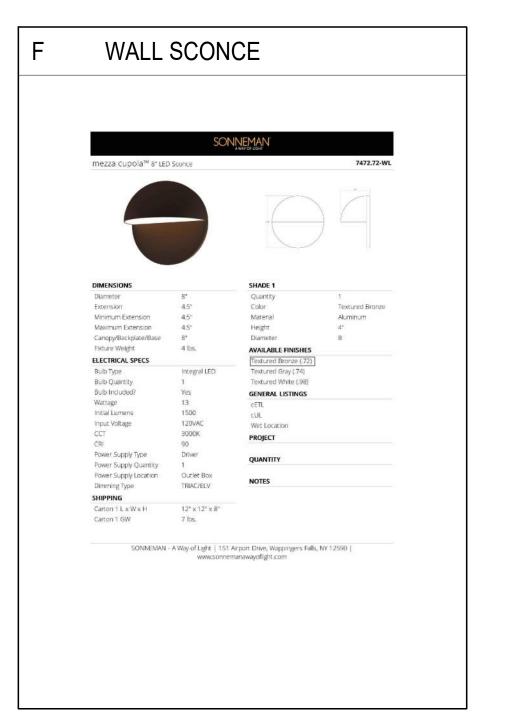






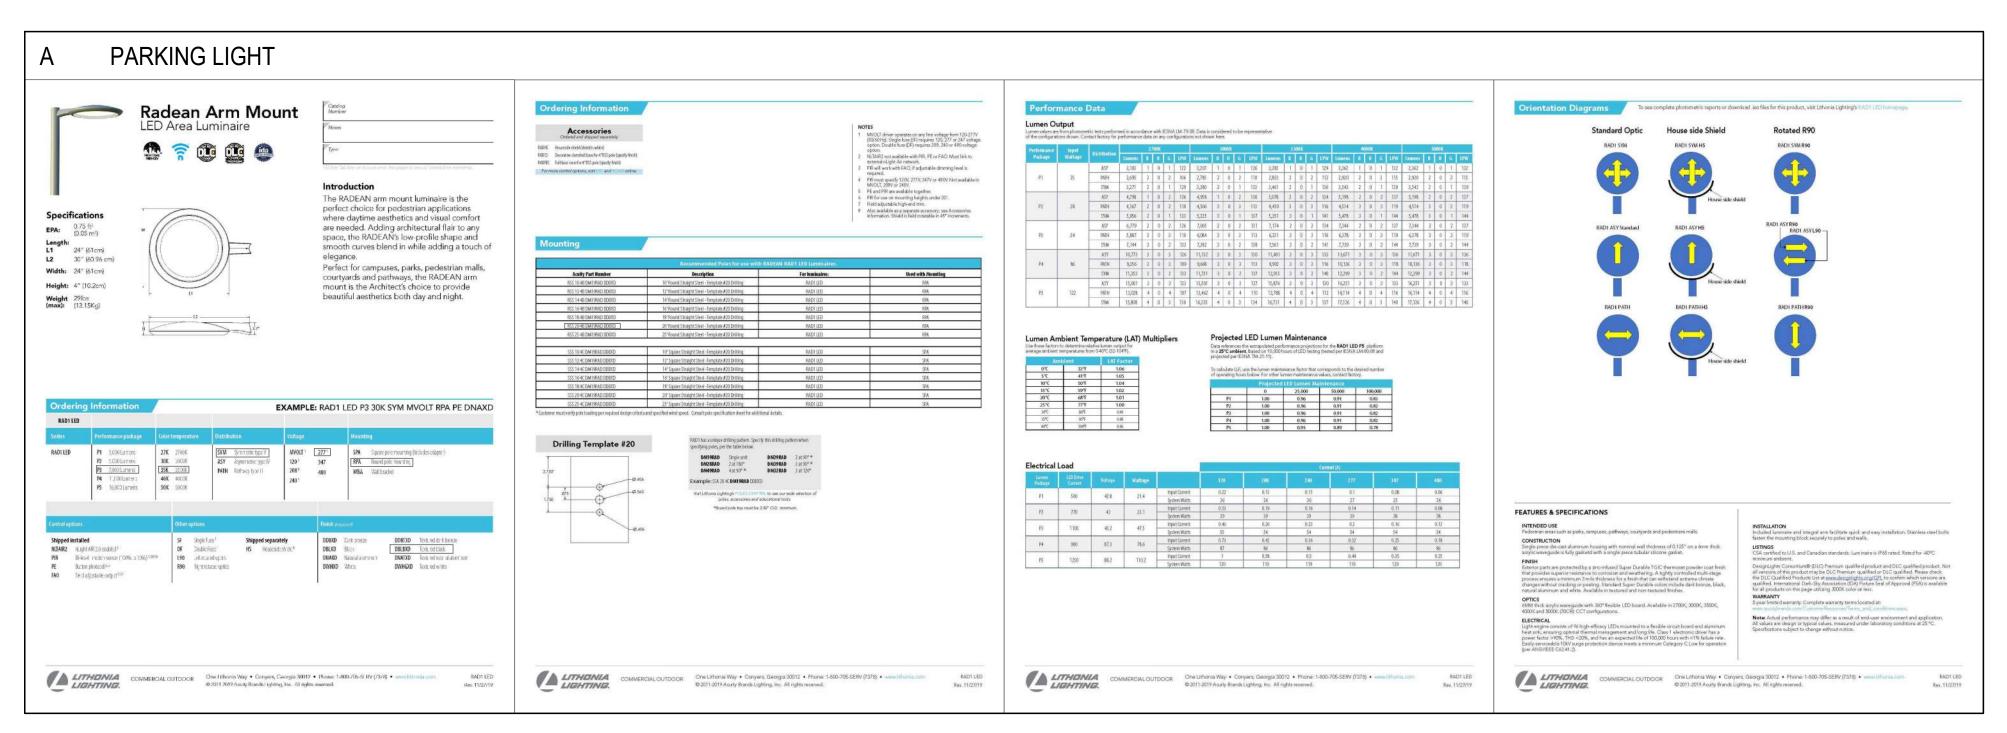



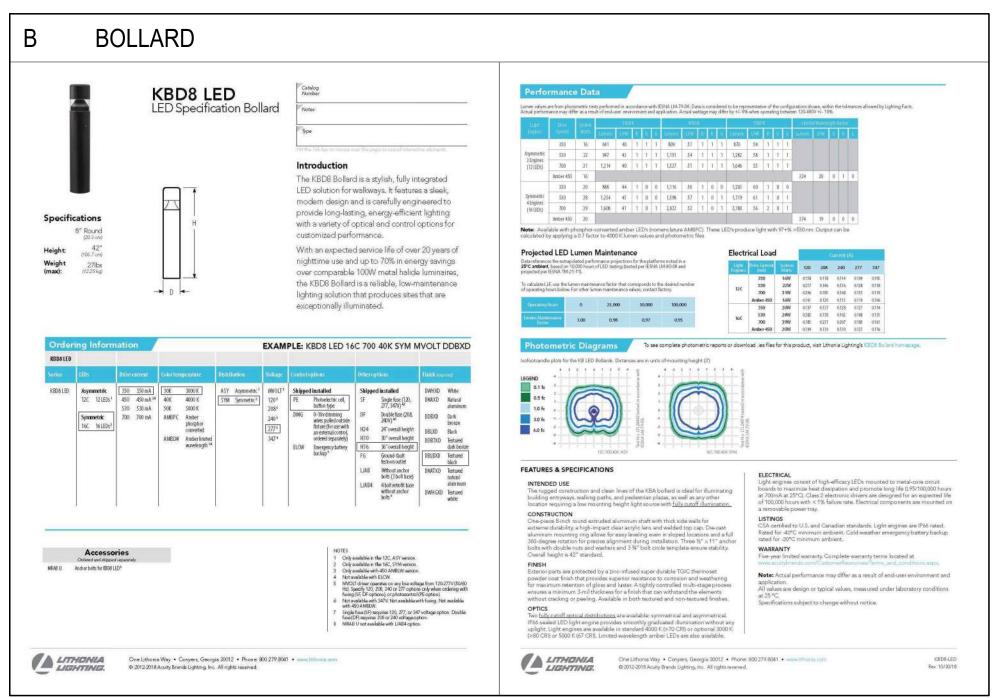

NOTE: ALL FIXTURES TO BE FINALIZED BY ENGINEER BASED ON THEIR CALCULATIONS

5 6/17/2021 Development Plan Submittal #5
4 4/19/2021 Development Plan Submittal #4
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No. Date Description
SUBMISSIONS & REVISIONS
OWNER

APPROVAL STAMPS:

:R

May Riegler Properties
2201 Wisconsin Avenue NW Suite 200
Washington, DC 20007
PO Box 881330
Steamboat Springs, CO 80488

ARCHITECT



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GENERAL CONTRACTOR

PROJECT LOCATION


### Steamboat Basecamp

1901 Curve Plaza Steamboat Springs, CO DRAWING TITLE

> LIGHTING SPECIFICATIONS


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> > CHECKED BY:
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> > PROJECT NO:

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#### LEGEND

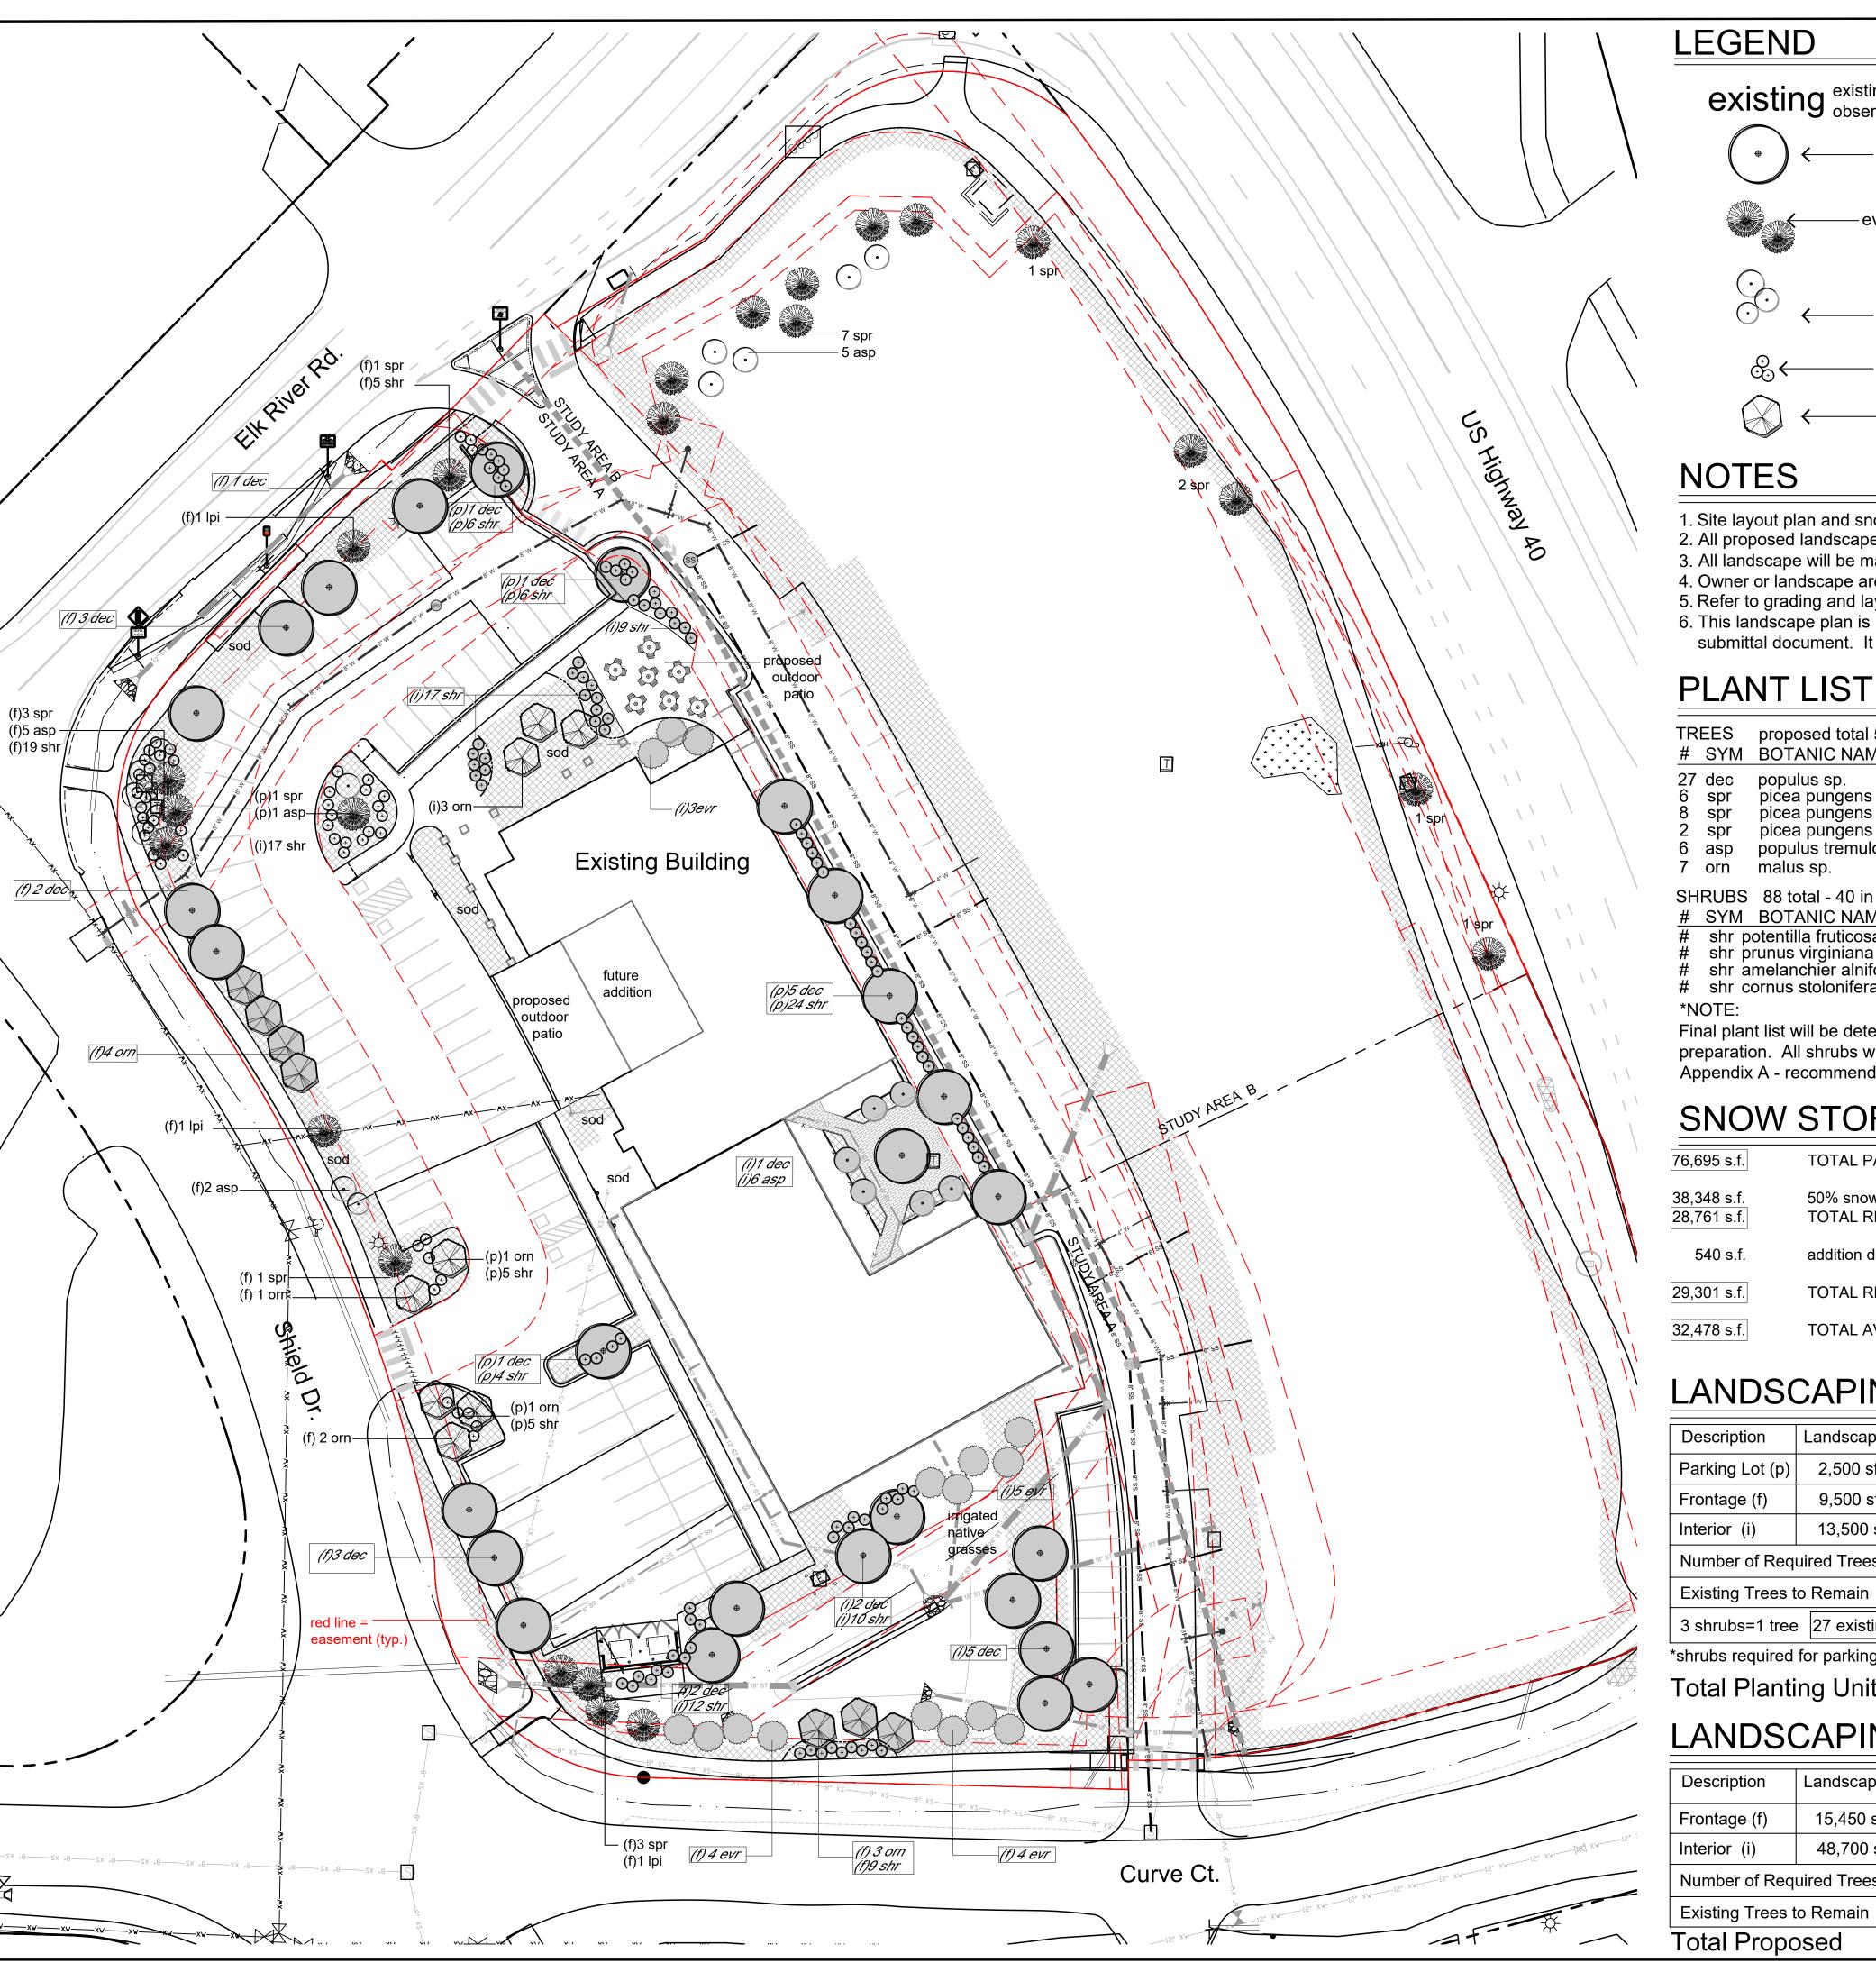existing existing plants are per field observation - not survey







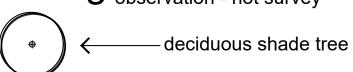








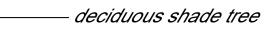

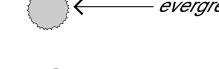

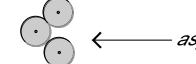

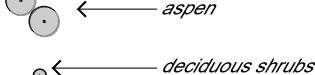

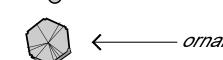

### — ornamental tree

#### NOTES

- 1. Site layout plan and snow storage calculations provided by Landmark Consultants Inc.
- 2. All proposed landscape plantings will be under an automatic irrigation system.
- 3. All landscape will be maintained in a professional manner to industry standard. 4. Owner or landscape architect to approve layout of all proposed work prior to installation.
- 5. Refer to grading and layout and materials plans for additional information on all proposed work.
- 6. This landscape plan is intended only as a City of Steamboat Springs planning submittal document. It does not contain the necessary information for construction.

— deciduous shrubs

— ornamental tree

SYM BOTANIC NAME	COMMON NAME	SIZE
dec populus sp.	cottonwood	2.5" cal.
spr picea pungens	colorado spruce	6'-7' ht.
spr picea pungens	colorado spruce	8'-9' ht.
spr picea pungens	colorado spruce	10' ht
asp populus tremuloides	quaking aspen	2" cal.
orn malus sp.	ornamental crabtree	2" cal.
RUBS 88 total - 40 in parking lot,	48 shrub for tree substitution	
SYM BOTANIC NAME	COMMON NAME	SIZE
shr potentilla fruticosa	native yellow potentilla	5 gal.
shr ˈprunus virginiana	native chokecherry	"
shr amelanchier alnifolia	saskatoon serviceberry	
shr cornus stolonifera	colorado dogwood	

Final plant list will be determined at time of construction document

preparation. All shrubs will be low water usage plants and be within Appendix A - recommended plant list - in the Community Development Code.

### SNOW STORAGE CALCULATIONS

TOTAL PAVED AREA

38,348 s.f.

50% snow storage requirement TOTAL REQUIRED (after 25% reduction for elevation) 28,761 s.f.

addition due 18 evergreen trees in storage areas

TOTAL REQUIRED 29,301 s.f.

32,478 s.f. TOTAL AVAILABLE

## LANDSCAPING STANDARDS TABLE - STUDY AREA A

Description	Landscape Area	CS Zone district Requirements	Required	Existing	Proposed	Evr ex	Tree	Dec	Tree	Orn	Tree
Parking Lot (p)	2,500 sf	1 tree/200sf + 4 shrubs/200sf	12/50*	4/10	8/40*	1	0	0	8	3	0
Frontage (f)	9,500 sf	Category EC - 1tree/200sf	48	21	24/3	11	8	0	8	10	7
Interior (i)	13,500 sf	Category EC3 - 1tree/500sf	27	3	24	0	8	0	11	3	6
Number of Required Trees/Planting Units		87				•					
Existing Trees to Remain			28								
3 shrubs=1 tree 27 existing in frontage=0 trees 48 proposed= int. 16 trees				0	16						
*shrubs required for parking lot landscape not a part of shrub for tree substituti			on	28	59						
Total Planting Units					87						

## LANDSCAPING STANDARDS TABLE - STUDY AREA B

Description	Landscape Area	CS Zone district Requirements	Required	Existing	Proposed		Evr Tree Dec Tree ex pro		Orn Tree		
Frontage (f)	15,450 sf	Category EC - 1tree/200sf	77	17	0	12		0	0	0	5
Interior (i)	48,700 sf	Category EC3 - 1tree/500sf	97	0	0	7	0	0	0	6	0
Number of Red	quired Trees/Planting Units		174								
Existing Trees	to Remain			17							
Total Proposed					0			•		•	


date 4-9-2020 city submittal rev. 7-14-2020 city submittal rev. 4-20-21 city submittal rev. 6-18-21 city submittal

> rev. 6-23-21 city submittal

> > plan landscap

Steamboat Steamboat



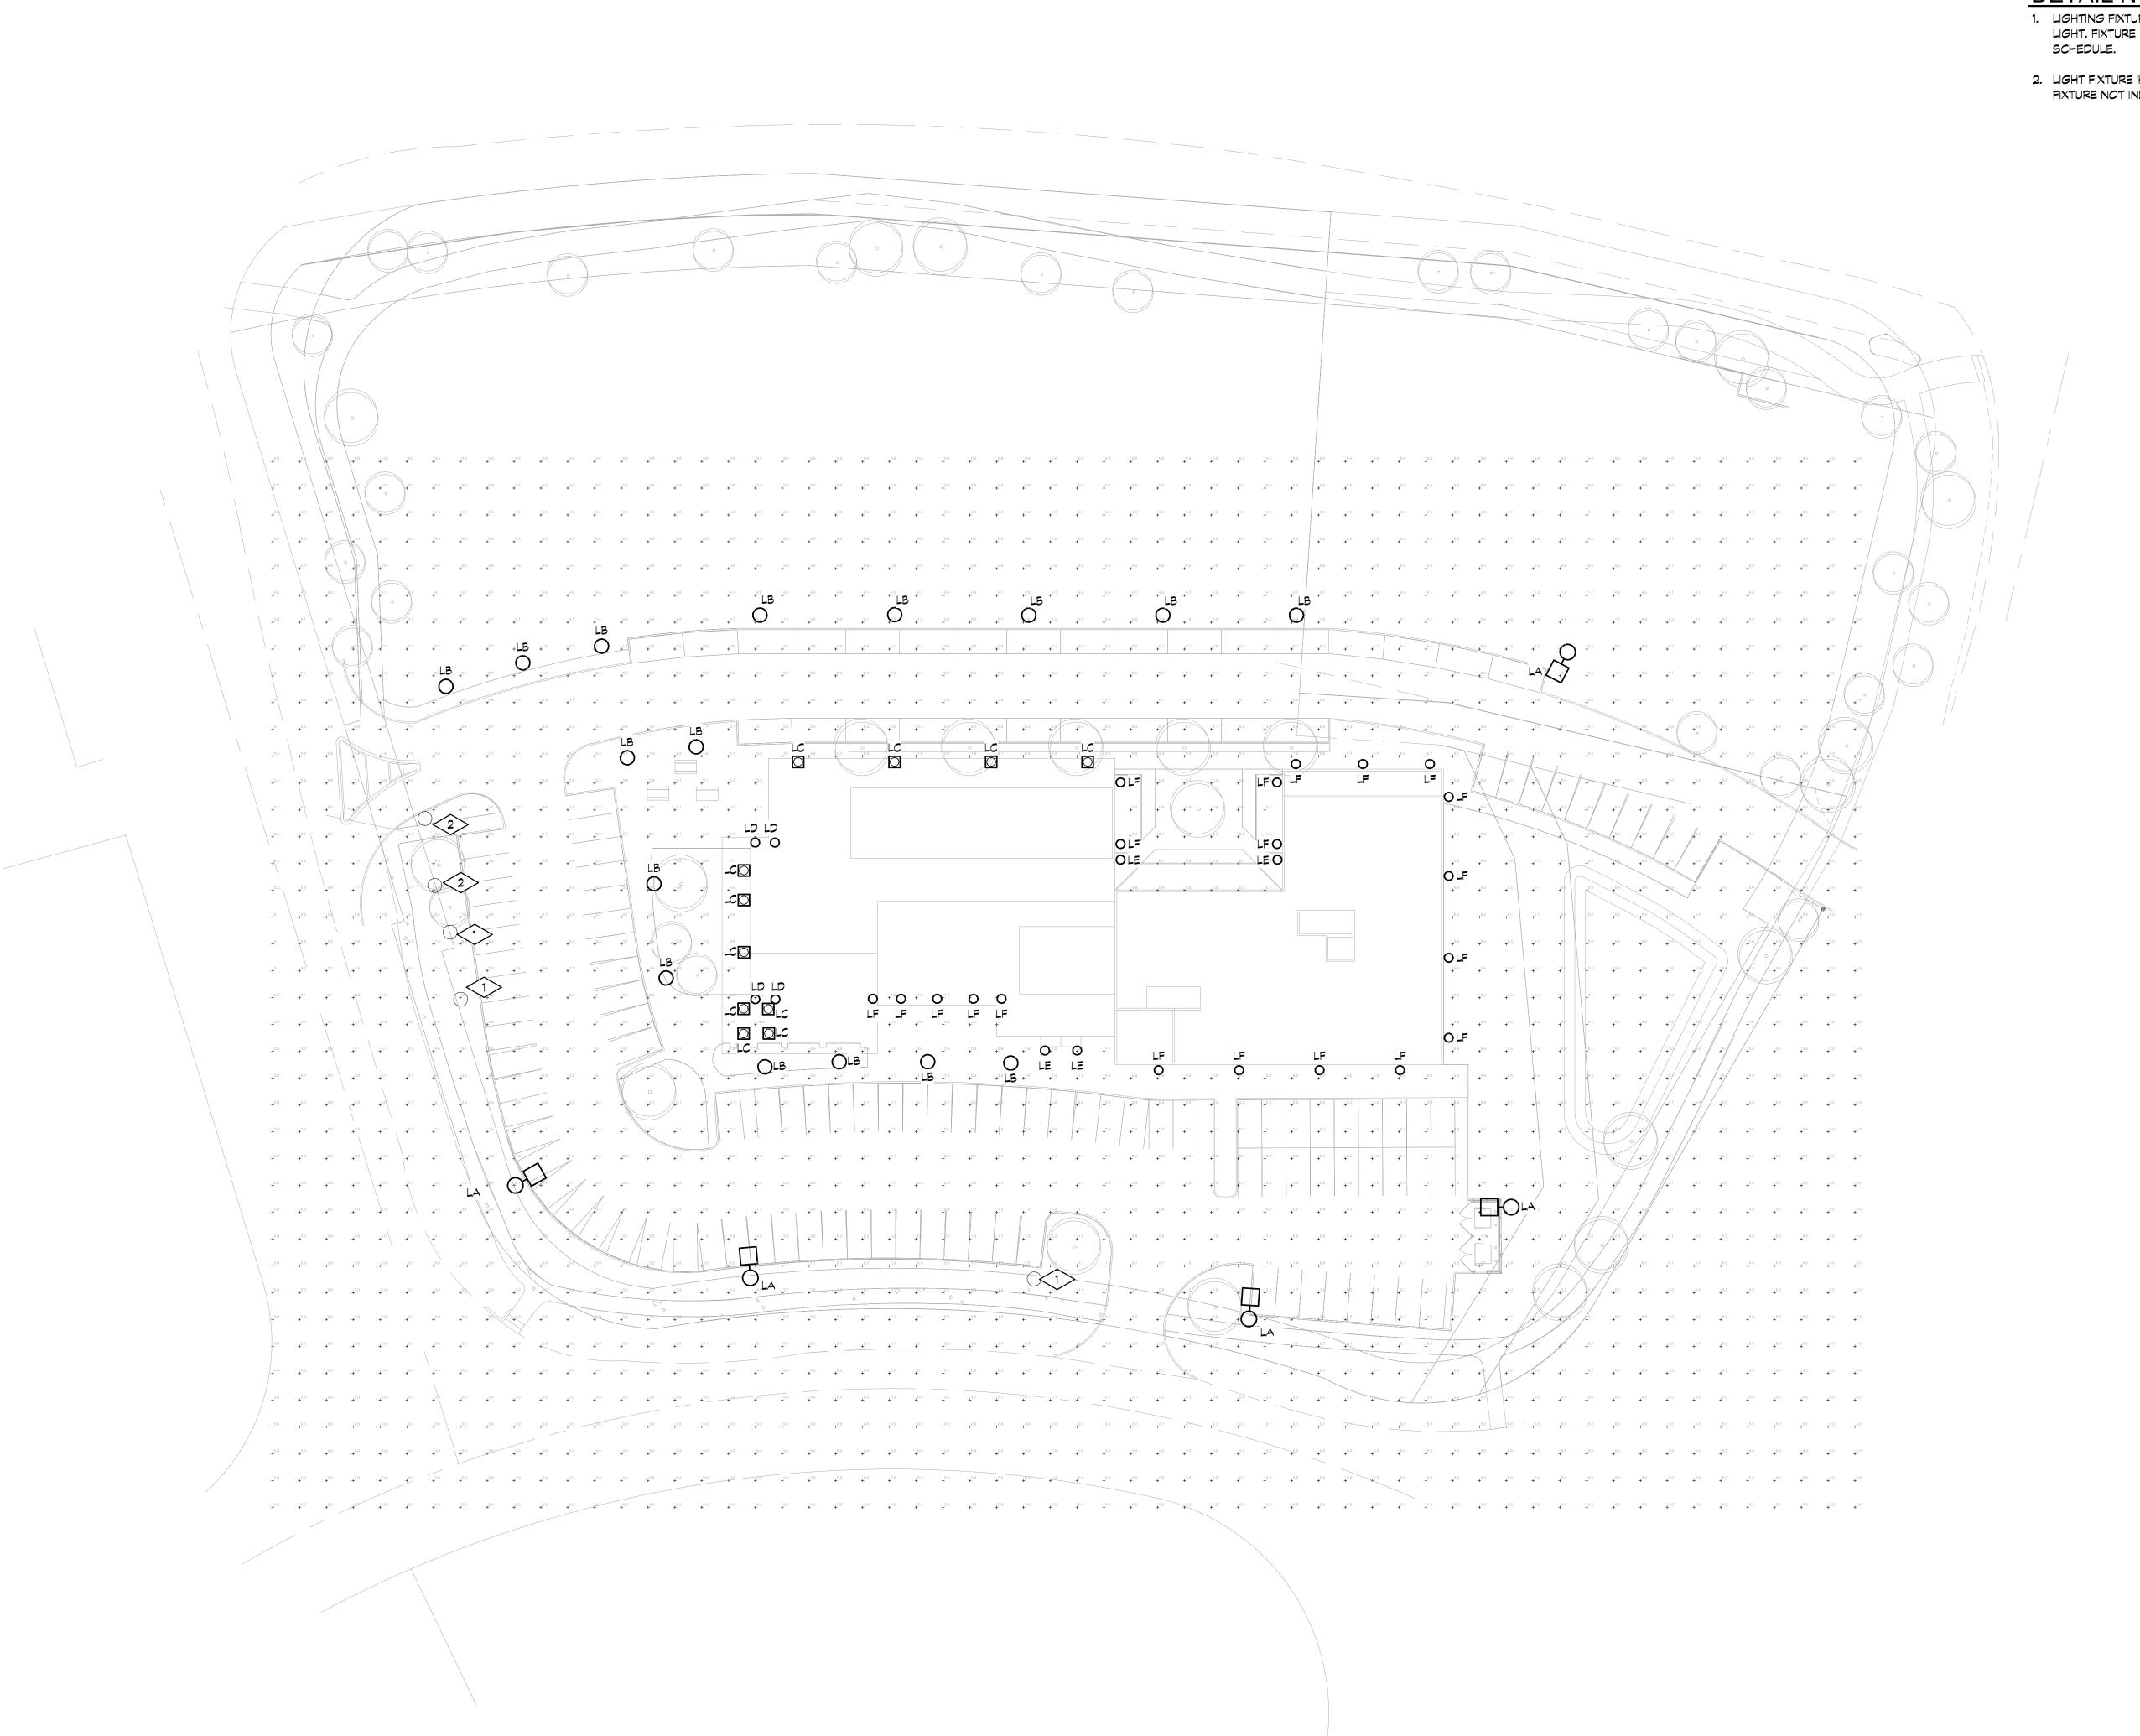

PHOTOMETRIC SITE PLAN

#### DETAIL NOTES THIS SHEET

 LIGHTING FIXTURE 'G' IS EXISTING TO REMAIN PARKING LIGHT. FIXTURE NOT INDCLUDED IN LIGHTING FIXTURE SCHEDULE.

2. LIGHT FIXTURE 'H' IS EXISTING TO REMAIN SIGN LIGHT. FIXTURE NOT INDCLUDED IN LIGHTING FIXTURE SCHEDULE.




and electrical 1717 15th Street Boulder, CO 80302

303.444.6038 phone 303.442.1172 fax staff@boulderengineering.com

METRIC

No.DescriptionDate1Revision 1Date 1

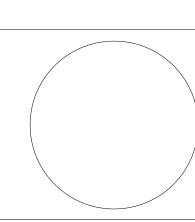



Issue PERMIT SET
Date 06.18.2021
Project Number 20061
Drawn by MOD
Checked by EM
Sheet
Title:
PHOTOMETRIC

SITE PLAN

Sheet Number

MEP 1

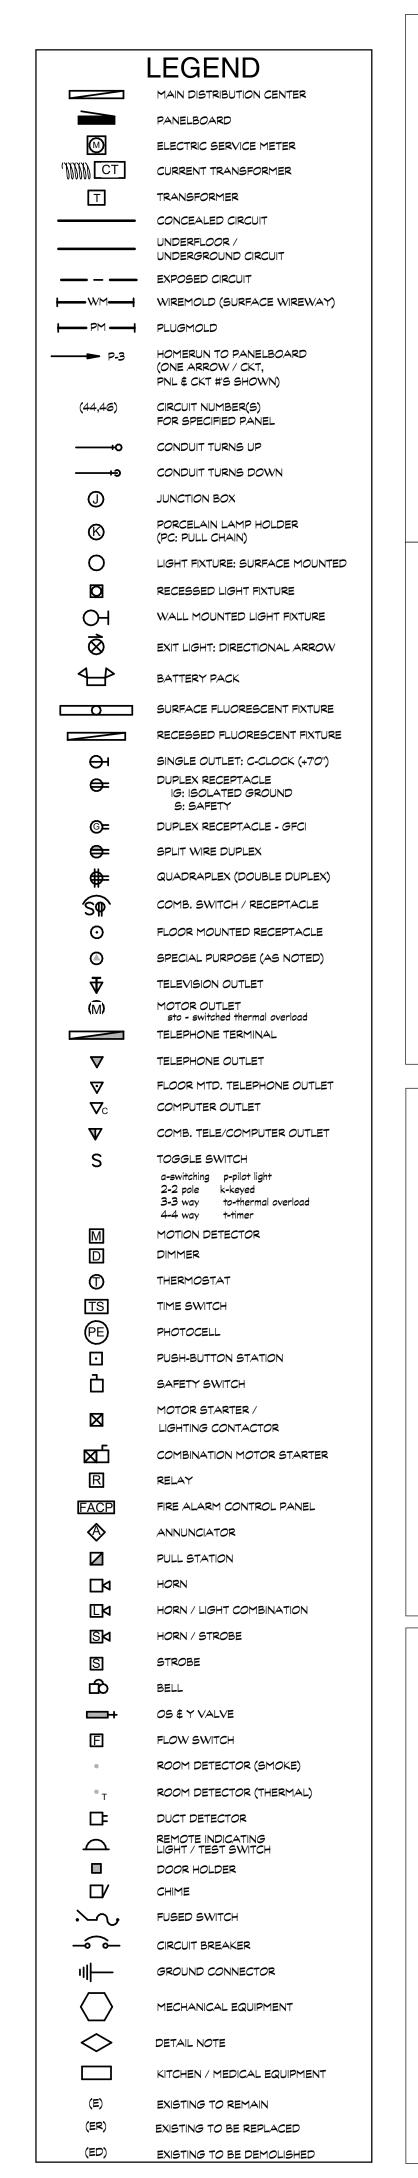


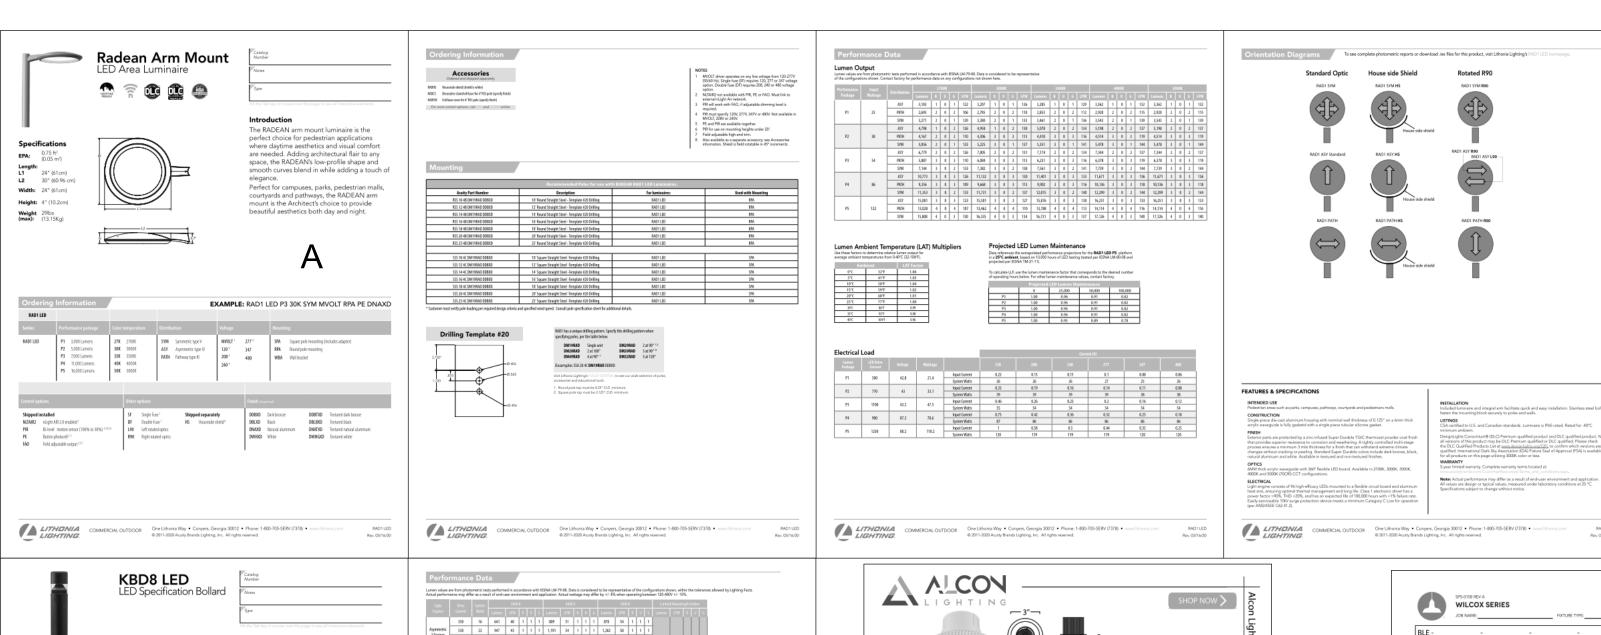



All values are design or typical values, measured under laboratory conditions


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SHADE CODE HEIGHT (A) DIAMETER (B) EXTENSION (C)




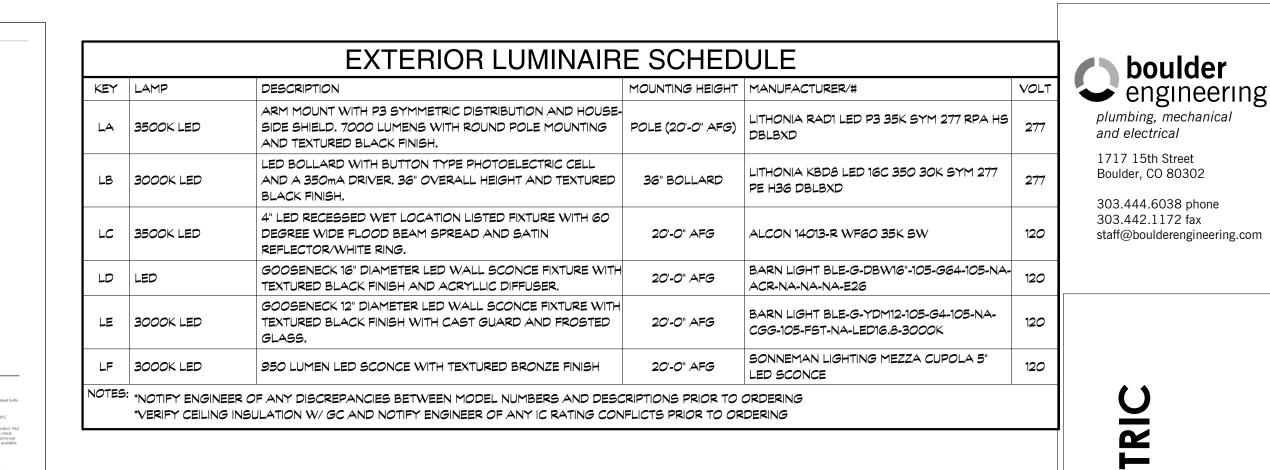

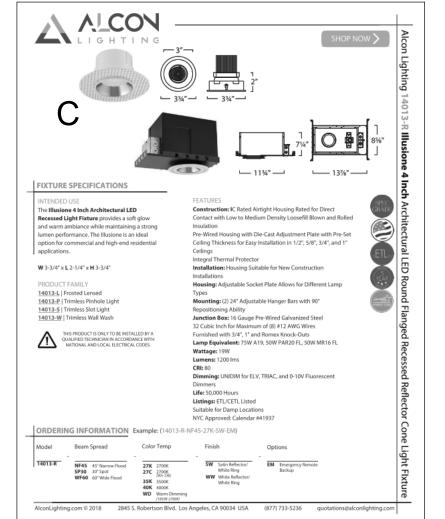

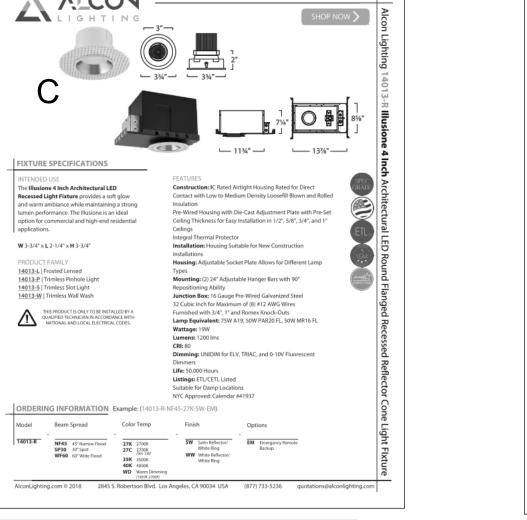
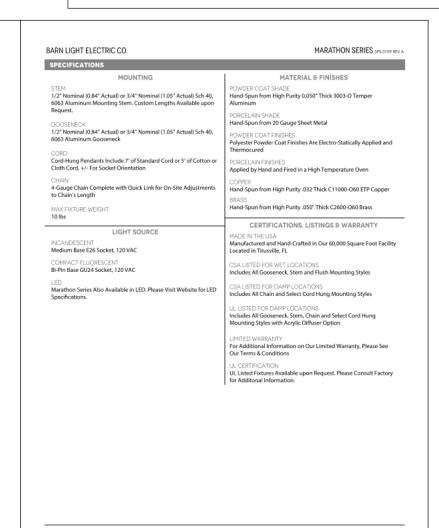
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LED solution for walkways. It features a sleek,

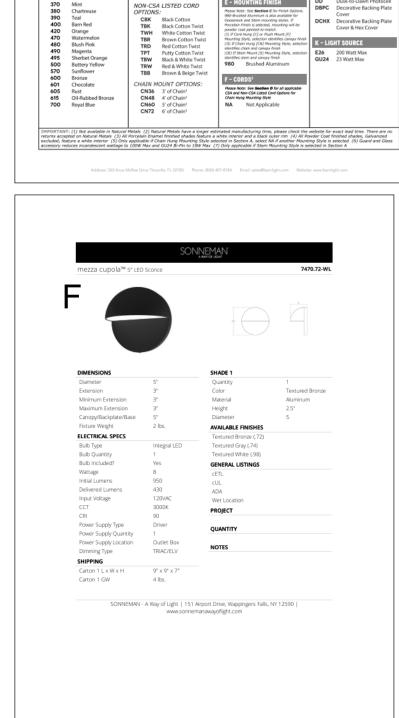orovide long-lasting, energy-efficient lighting

with a variety of optical and control options f With an expected service life of over 20 years of

nighttime use and up to 70% in energy savings

over comparable 100W metal halide luminaire the KBD8 Bollard is a reliable, low-maintenan-lighting solution that produces sites that are

EXAMPLE: KBD8 LED 16C 700 40K SYM MVOLT DDBXI

Chija wallable in the 13C, ASY warsion.
Chija wallable in the 15C, SYM warsion.
Chija wallable with 15C, SYM warrion.
Chija wallable with ELC.W.
MNCCLI driven operation on any line sinchage from 133-277V (SIAMO Hol.) Speech (120, 25E, 284 or 277 options only when certaining stiff in optioning plb. (File option).
File standards with 33TV. Not available with fautre, Mast available with 450 AMSEW, 1

Single fuse (SF) requires 120, 277, or 347 voltage option. Double fuse (DF) requires 208 or 240 voltage option.

MRAB U not available with L/AB4 option.

NA Not Applicable I - GLASS OPTION

Accise K - LIGHT SOURCE

exceptionally illuminated.

Projected LED Lumen Maintenance

FEATURES & SPECIFICATIONS

BARN LIGHT ELECTRIC CO.

CORD HUNG PENDANT (C)

17

Data references the extrapolated performance projections for the platforms noted in a 25°C archivest, based on 10,000 hours of LED testing (tested per IESNA LM-80-06 and projected per IESNA TM-21-11).

To calculate LLE, use the lumen maintenance factor that corresponds to the desired number of consisting four hallow. For other house maintenance values, contact factors

Operating Notes 0 25,000 50,000 100,000

Lanser Maintenance 1.00 0.98 0.97 0.95

modern design and is carefully engineered

Specifications

Weight 27lbs (max): (12.25 kg)

Accessories

Ordered and displayed Imparately.

MERE U Archar belts for WEEG LED.\*


SPS-0109 REV A
MARATHON SERIES
JOB NAME

B - SHADE SIZE

LITHONIA Cne Lithoria Way • Coryers, Georgia 30012 • Phone: 800 279,8041 • www.

Example: BLE - C - YDM16 - 999 - SBK - 200 - NA - WGG - 975 - FST - NA - E26

NON-CSA LISTED CORD
OPTIONS:
CBK Black Cotton
TBK Black Cotton Twist
TWH White Cotton Twist

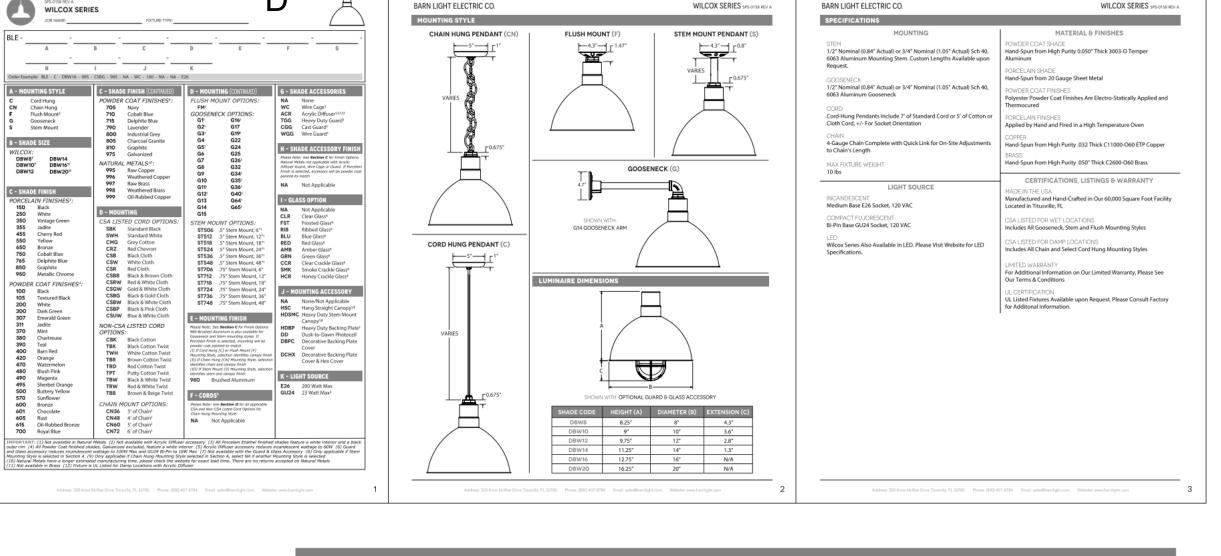



Max

Avg

**Statistics** 

Description Symbol

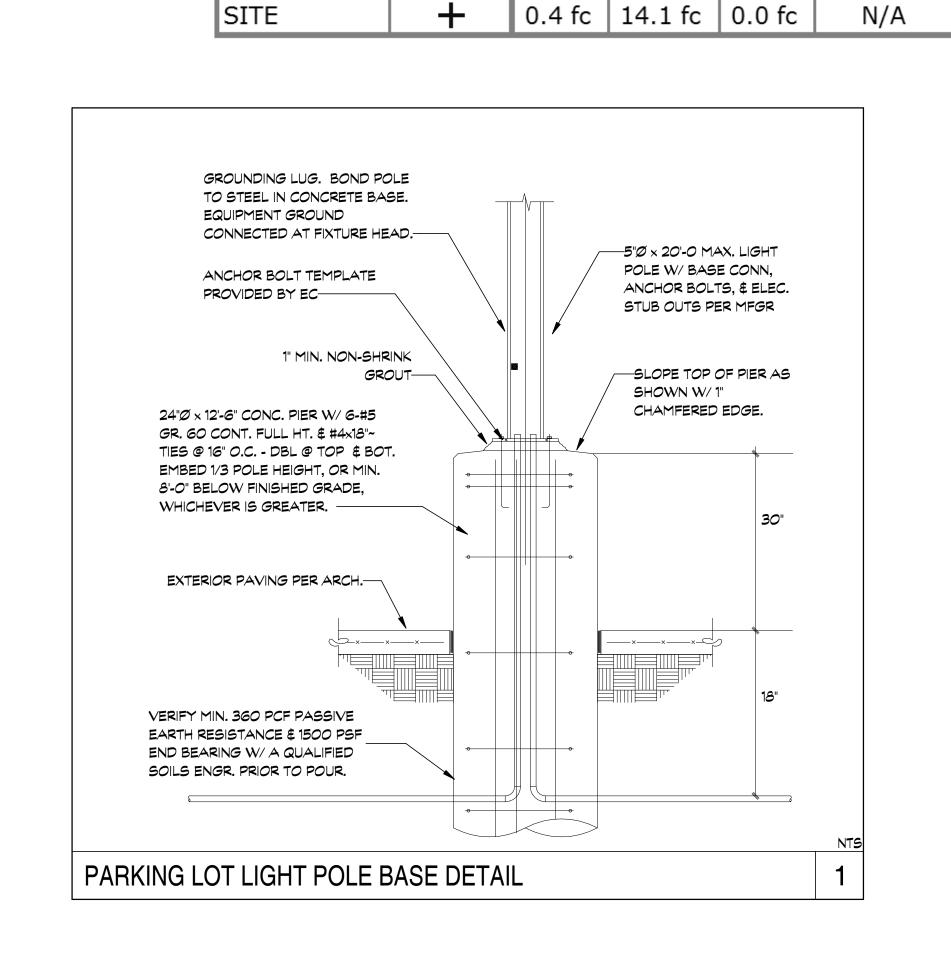

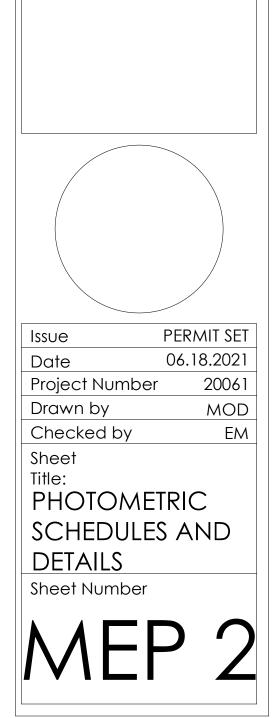

boulder

)20 ARAPAHOE , BOULDER, CO 8

<

Min Max/Min Avg/Min

N/A

No. Description Date