


PROPOSED LAND USE PLAN

OF RIVERFRONT PARK FILINGS NO. 1, 2, AND 3 LOCATED IN THE NW $\frac{1}{4}$ OF SECTION 7, TOWNSHIP 6 NORTH, RANGE 84 WEST OF THE 6TH P.M., STEAMBOAT SPRINGS, **ROUTT COUNTY, COLORADO**

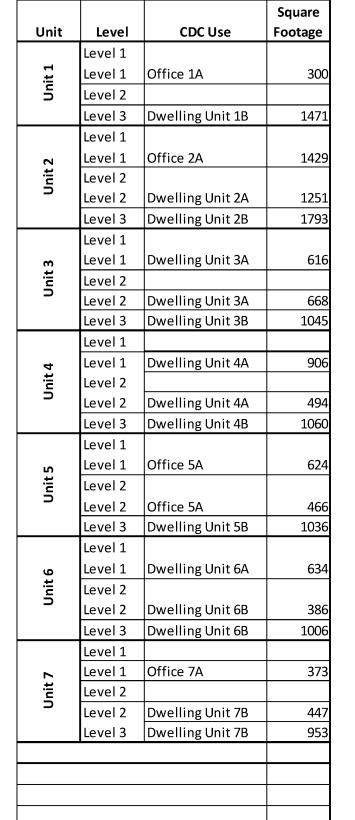

| Unit | Level | CDC Use | Square Footage |
|----------|---------|-------------------|-------------------|
| | Level 1 | | |
| ∞ | Level 1 | Dwelling Unit 8A | 592 |
| Unit 8 | Level 2 | | |
| _ | Level 2 | Dwelling Unit 8A | 404 |
| | Level 3 | Dwelling Unit 8B | 941 |
| | Level 1 | | |
| 63 | Level 1 | Dwelling Unit 9A | 671 |
| Unit 9 | Level 2 | | |
| _ | Level 2 | Dwelling Unit 9A | 592 |
| | Level 3 | Dwelling Unit 9B | 898 |
| | Level 1 | | |
| 10 | Level 1 | Dwelling Unit 10A | 567 |
| Unit 10 | Level 2 | | |
| - | Level 2 | Dwelling Unit 10A | 434 |
| | Level 3 | Dwelling Unit 10B | 907 |
| Unit 11 | Level 1 | | |
| | Level 1 | Dwelling Unit 11A | 741 |
| | Level 2 | | |
| | Level 2 | Dwelling Unit 11A | 554 |
| | Level 3 | Dwelling Unit 11B | 1004 |
| | Level 1 | | |
| 12 | Level 1 | Dwelling Unit 12A | 886 |
| Jnit 12 | Level 2 | | |
| - | Level 2 | Dwelling Unit 12A | 509 |
| | Level 3 | Dwelling Unit 12B | 975 |
| | Level 1 | | |
| m | Level 1 | Dwelling Unit 13A | 713 |
| Unit 13 | Level 2 | | |
| n D | Level 2 | Dwelling Unit 13A | 252 |
| | Level 2 | | |
| | Level 3 | Dwelling Unit 13B | 903 |
| | Level 1 | | |
| 14 | Level 1 | Dwelling Unit 14A | 510 |
| Unit 14 | Level 2 | | |
|) | Level 2 | Dwelling Unit 14A | 518 |
| | Level 3 | Dwelling Unit 14B | 975 |
| | | | |
| | | | |

| POINTS | |
|--------|--|
| FOUR | |

440 S. Lincoln Ave, Suite 4A

P.O. Box 775966

| Dwelling Unit Su | mamry | Steamboat Springs, CO 8048 (970)-871-6772 www.fourpointsse.com | | | | | 87 | | | |
|--------------------------------|--------------|--|---------|--------|--|--|----|-----|--|--|
| Unit 1A total | N/A | | | | | | Т | | | |
| Unit 1 B Total | 1471 | <u>K</u> | | | | | | | | |
| | | | | | | | | | | |
| Unit 2A Dwelling | 1251 | | | | | | | | | |
| Unit 2 A Total | 2514 | | | | | | | | | |
| Unit 2B Total | 1793 | S | | | | | | | | |
| Unit 3A Dwelling Unit 3A Total | 1284 2066 | REVISIONS | | | | | | | | |
| Unit 3B Total | 1045 | | | | | | | | | |
| | | DATE | | | | | | | | |
| Unit 4A Dwelling | 1400 | No. | | | | | | | | |
| Unit 4A Total | 2039 | | | | | | | | | |
| Unit 4B Total | 1060 | | ~ |) | | | | | | |
| | | | 1 2 8 3 | } | | | | | | |
| Unit 5A Total | N/A | | () | V 1 | | | 1 | > | | |
| Unit 5B Total | 1036 | | _ | 4 | | | • | 182 | | |

| Unit 7A Total | N/A |
|---------------|------|
| Unit 7B Total | 1400 |

Unit 6A Total

Unit 6B Total

Dwelling Unit 6B

| | | | Square |
|----------|---------|-------------------|---------|
| Unit | Level | CDC Use | Footage |
| | Level 1 | | |
| ∞ | Level 1 | Dwelling Unit 8A | 592 |
| Unit 8 | Level 2 | | |
| ے | Level 2 | Dwelling Unit 8A | 404 |
| | Level 3 | Dwelling Unit 8B | 941 |
| | Level 1 | | |
| 6 | Level 1 | Dwelling Unit 9A | 671 |
| Unit 9 | Level 2 | | |
| – | Level 2 | Dwelling Unit 9A | 592 |
| | Level 3 | Dwelling Unit 9B | 898 |
| | Level 1 | | |
| 10 | Level 1 | Dwelling Unit 10A | 567 |
| Unit 10 | Level 2 | | |
| ⊃ | Level 2 | Dwelling Unit 10A | 434 |
| | Level 3 | Dwelling Unit 10B | 907 |
| | Level 1 | | |
| 11 | Level 1 | Dwelling Unit 11A | 741 |
| Unit 11 | Level 2 | | |
| Ō | Level 2 | Dwelling Unit 11A | 554 |
| | Level 3 | Dwelling Unit 11B | 1004 |
| | Level 1 | | |
| 12 | Level 1 | Dwelling Unit 12A | 886 |
| Unit 12 | Level 2 | | |
| Ō | Level 2 | Dwelling Unit 12A | 509 |
| | Level 3 | Dwelling Unit 12B | 975 |
| | Level 1 | | |
| •• | Level 1 | Dwelling Unit 13A | 713 |
| Unit 13 | Level 2 | | |
| Uni | Level 2 | Dwelling Unit 13A | 252 |
| _ | Level 2 | | |
| | Level 3 | Dwelling Unit 13B | 903 |
| | Level 1 | | |
| 14 | Level 1 | Dwelling Unit 14A | 510 |
| Unit 14 | Level 2 | | |
| 5 | Level 2 | Dwelling Unit 14A | 518 |
| | Level 3 | Dwelling Unit 14B | 975 |
| | revel 2 | Dweining Outt 140 | 373 |
| | | | |

| Dwelling Unit Sumamry | | | | |
|-----------------------|-----|--|--|--|
| | | | | |
| Unit 8A Dwelling | 99 | | | |
| Unit 8A Total | 154 | | | |
| Unit 8B Total | 94 | | | |
| | | | | |
| | | | | |
| Unit 9A Dwelling | 126 | | | |
| Unit 9A Total | 168 | | | |
| Unit 9B Total | 89 | | | |
| | | | | |
| | | | | |
| Unit 10A Dwelling | 100 | | | |
| Unit 10A Total | 154 | | | |
| Unit 10B Total | 90 | | | |
| | | | | |
| Unit 11A Dwelling | 129 | | | |
| Unit 11A Total | 184 | | | |
| Unit 11B Total | 100 | | | |
| | | | | |
| Hait 124 Decalling | 120 | | | |
| Unit 12A Dwelling | 139 | | | |
| Unit 12A Total | 176 | | | |
| Unit 12B Total | 97 | | | |
| Г | | | | |
| Unit 13A Dwelling | 96 | | | |
| Unit 13A Total | 155 | | | |
| Dwelling Unit 13B | 90 | | | |
| Unit 13B Total | 106 | | | |
| | | | | |

Unit 14A Total

Unit 14B Total

Dwelling Unit 14B

| RIVERFRONT PARK FILINGS NO. 1, 2 | 1940 BRIDGE LANE STEAMBOAT SPRINGS CO 80487 |
|----------------------------------|---|
|----------------------------------|---|

Horizontal Scale

Contour Interval = 2 ft

IF THIS DRAWING IS PRESENTED IN A FORMAT OTHER THAN 24" X 36", THE GRAPHIC SCALE SHOULD BE UTILIZED.


DATE: 6-13-2024

JOB #: 2349-001

DRAWN BY: MDM DESIGN BY: WNM

REVIEW BY: WNM

SHEET#

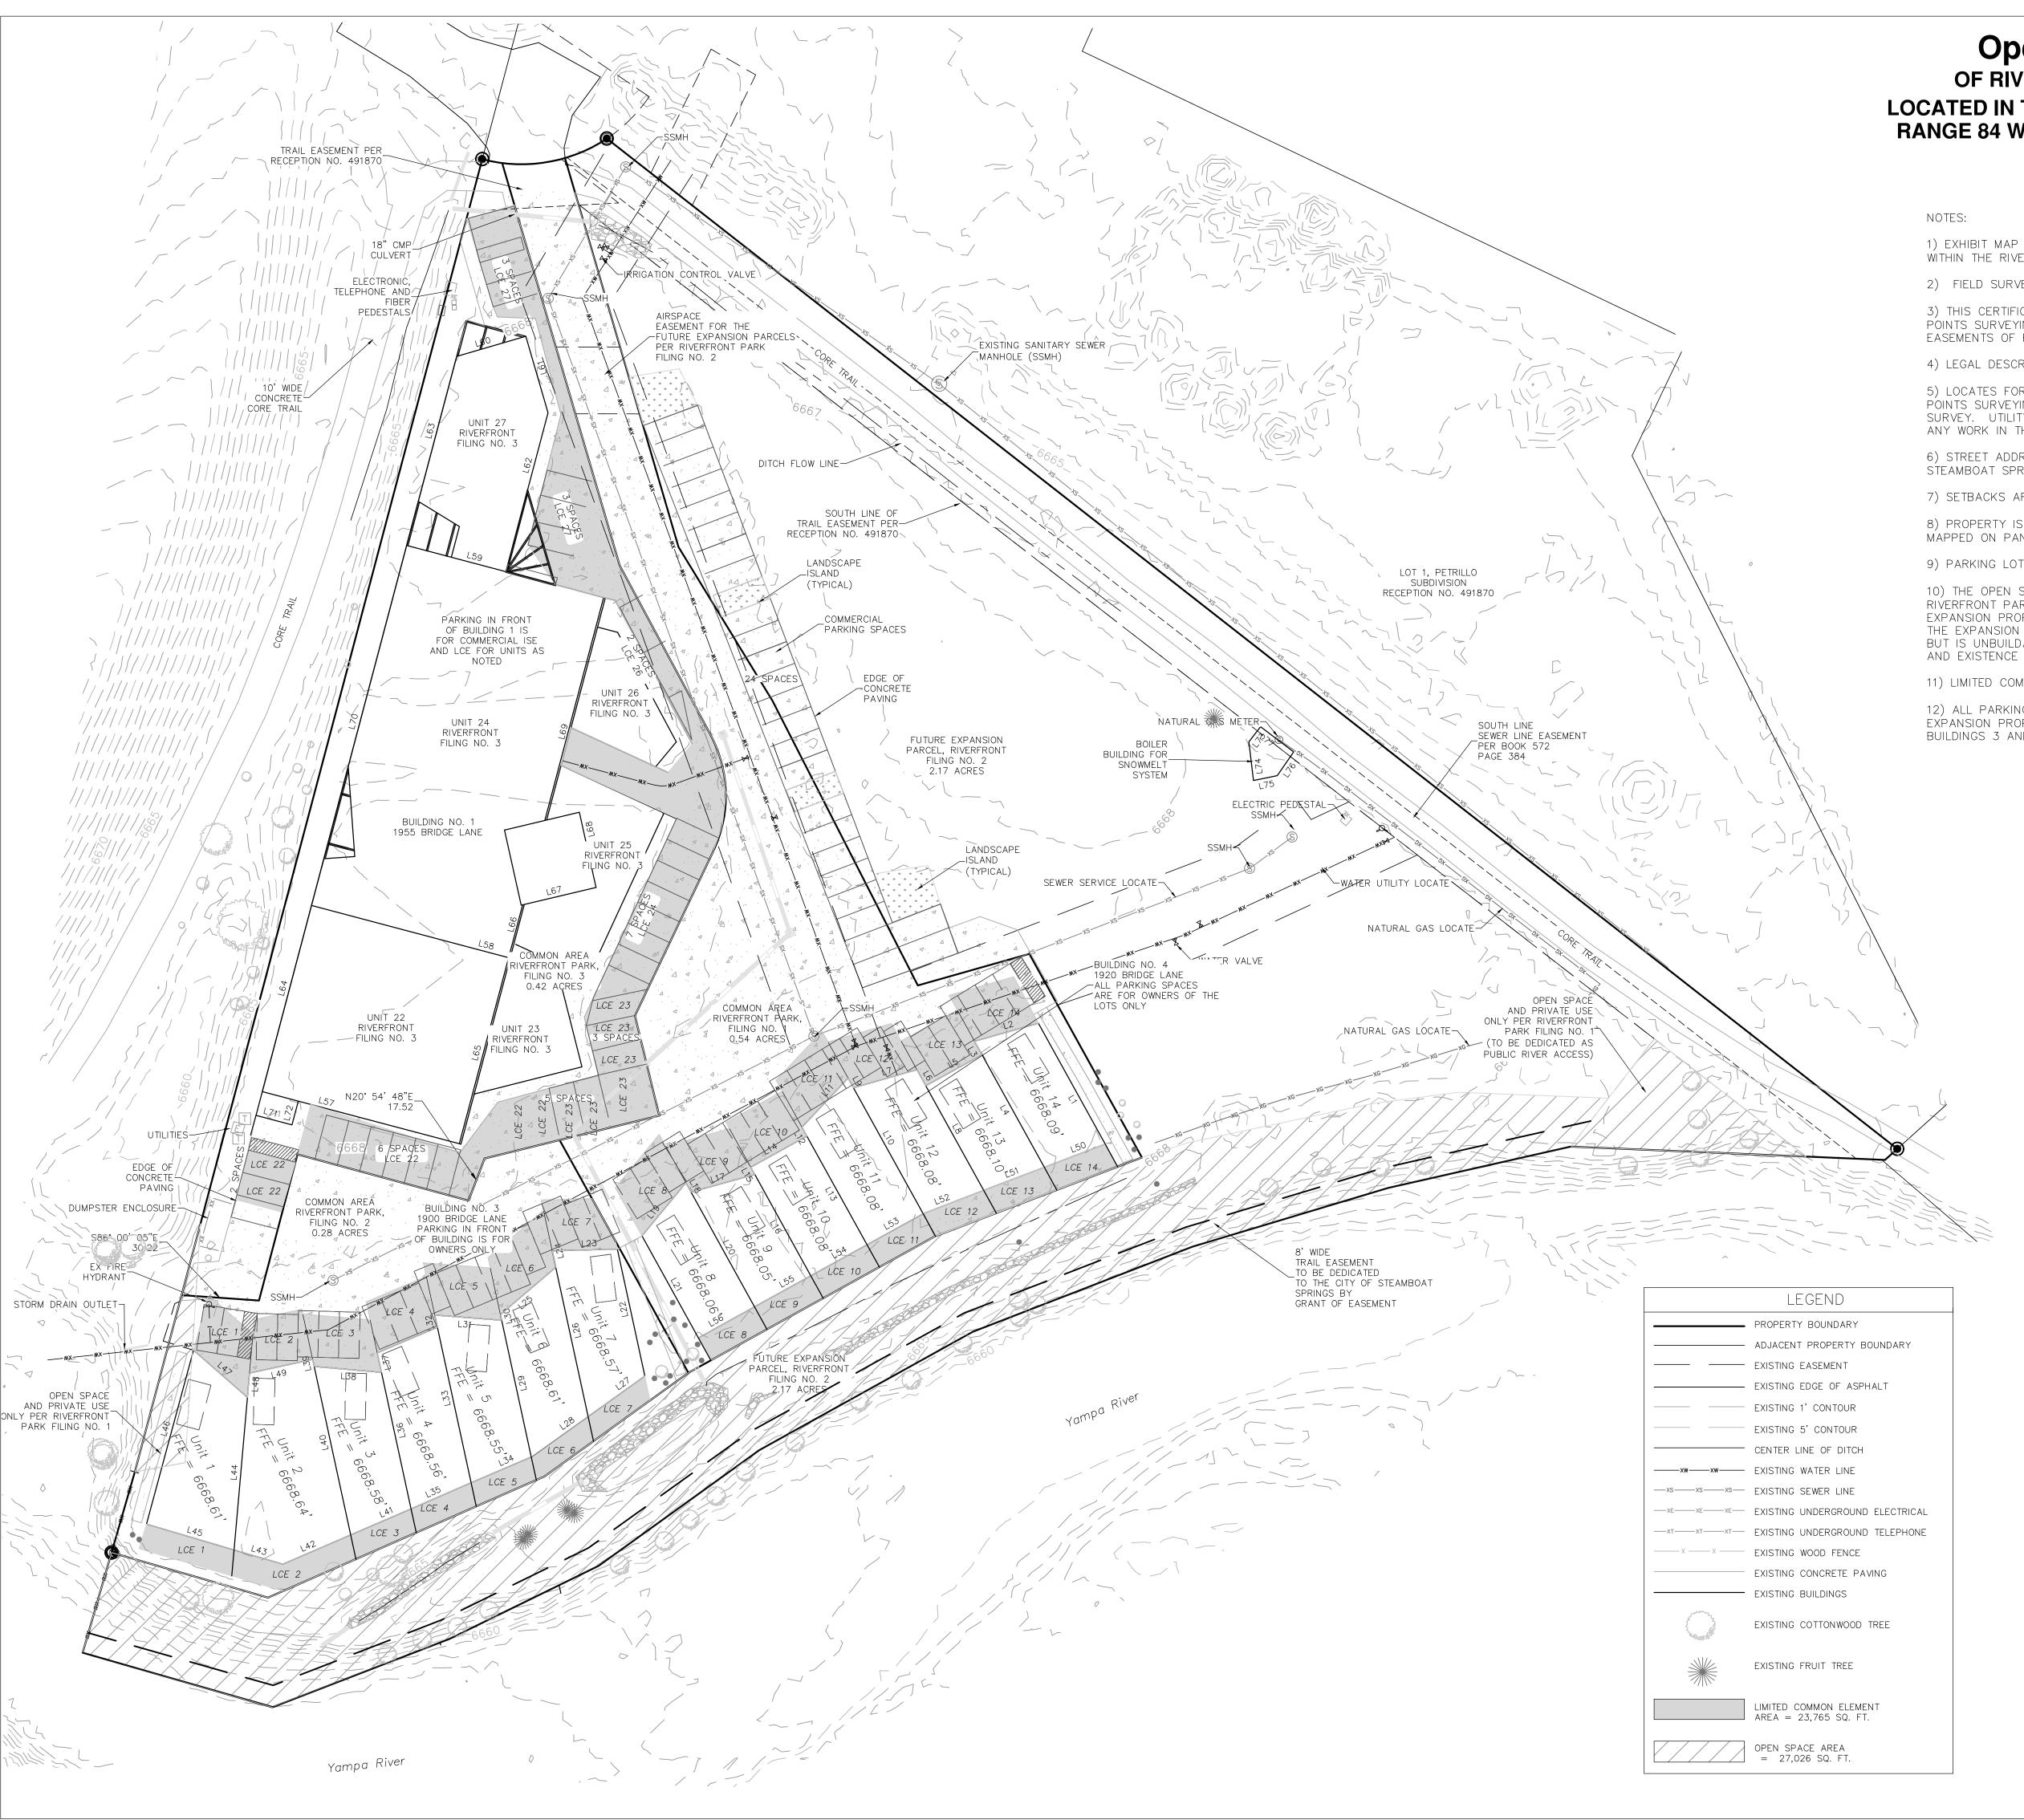



OF RIVERFRONT PARK FILINGS NO. 1, 2, AND 3
LOCATED IN THE NW ¼ OF SECTION 7, TOWNSHIP 6 NORTH,
RANGE 84 WEST OF THE 6TH P.M., STEAMBOAT SPRINGS,
ROUTT COUNTY, COLORADO

1) EXHIBIT MAP OF THE LMITED COMMON ELEMENTS AND OPEN SPACE WITHIN THE RIVERFRONT PARK FILINGS NO. 1, 2, AND 3.

2) FIELD SURVEYING COMPLETED MAY 8, 2024.

3) THIS CERTIFICATE DOES NOT CONSTITUTE A TITLE SEARCH BY FOUR POINTS SURVEYING AND ENGINEERING, INC. TO DETERMINE OWNERSHIP OR EASEMENTS OF RECORD.

4) LEGAL DESCRIPTION PROVIDED BY ROUTT COUNTY ASSESSOR.

5) LOCATES FOR UTILITIES WERE NOT REQUESTED OR OBTAINED BY FOUR POINTS SURVEYING AND ENGINEERING, INC. IN CONJUNCTION WITH THIS SURVEY. UTILITY LOCATES SHOULD BE OBTAINED PRIOR TO PERFORMING ANY WORK IN THE REFERENCED AREA.

6) STREET ADDRESS: 1900, 1920, 1940, 1955, AND 1960 BRIDGE LANE, STEAMBOAT SPRINGS.

7) SETBACKS ARE PER THE RIVERFRONT PARK PUD.

8) PROPERTY IS WITHIN THE FEMA FLOODPLAIN AND FLOODWAY AS MAPPED ON PANEL 08107C0876D

9) PARKING LOT IS ALL HEATED CONCRETE FROM A GAS BOILER

10) THE OPEN SPACE IS A COMBINATION OF THE OPEN SPACE FROM RIVERFRONT PARKING FILING NO. 1 AND THE SOUTH END OF THE EXPANSION PROPERTY IN RIVERFRONT FILING NO. 2. THIS SOUTH END OF THE EXPANSION PROPERTY IS CURRENTLY NOT DESIGNATED OPEN SPACE BUT IS UNBUILDABLE DUE TO THE WIDTH, PROXIMITY TO THE YAMPA RIVER AND EXISTENCE OF THE WATER QUALITY PONDS WITHIN THE PARCEL AREA.


11) LIMITED COMMON ELEMENTS ARE DESIGNATED IN FILING NO. 1 AND 2.

12) ALL PARKING IN FRONT OF BUILDING 1 AND THE WEST SIDE OF THE EXPANSION PROPERTY IS COMMERCIAL SPACE. PARKING IN FRONT OF BUILDINGS 3 AND 4 IS FOR OWNERS OF THOSE UNITS ONLY.

| | Line | Table | | Line | Table |
|--------|--------|------------------|--------|--------|------------------|
| Line # | Length | Direction | Line # | Length | Direction |
| L1 | 53.70 | N28° 57' 01.76"W | L42 | 28.77 | N66° 37′ 35.01″E |
| L2 | 25.80 | N74° 14' 10.47"E | L43 | 19.81 | S73° 39' 16.83"E |
| L3 | 5.95 | N28° 57' 01.76"W | L44 | 59.57 | N4° 59' 29.17"E |
| L4 | 50.09 | N28° 57′ 01.76″W | L45 | 35.55 | S73° 39′ 16.83″E |
| L5 | 25.00 | N61° 02' 58.24"E | L46 | 70.17 | N15° 07' 30.94"E |
| L6 | 7.20 | S28° 57' 01.76"E | L47 | 27.91 | S48° 45′ 38.11″E |
| L7 | 25.70 | N73° 58' 04.12"E | L48 | 9.48 | S4° 59' 28.86"W |
| L8 | 46.55 | S28° 57' 01.76"E | L49 | 25.17 | S77° 45′ 28.13″W |
| L9 | 4.30 | S28° 57' 01.76"E | L50 | 25.37 | N69° 05' 35.14"E |
| L10 | 55.98 | S28° 57' 01.76"E | L51 | 25.25 | N69° 05' 35.14"E |
| L11 | 26.20 | N43° 17' 53.07"E | L52 | 24.84 | N69° 05' 35.14"E |
| L12 | 4.00 | N28° 57' 01.76"W | L53 | 25.13 | N61° 02' 58.23"E |
| L13 | 48.30 | N28° 57' 01.76"W | L54 | 25.00 | N61° 02' 58.23"E |
| L14 | 25.00 | N61° 02' 58.24"E | L55 | 25.03 | N61° 02' 58.23"E |
| L15 | 3.30 | N28° 57' 01.76"W | L56 | 24.99 | N61° 02' 58.23"E |
| L16 | 45.00 | N28° 57' 01.76"W | L57 | 80.00 | S75° 11′ 41.08″E |
| L18 | 4.15 | S28° 57' 01.76"E | L58 | 80.00 | S75° 09' 18.04"E |
| L19 | 26.86 | N39° 30' 50.17"E | L59 | 80.00 | S75° 11′ 41.08″E |
| L20 | 51.07 | S28° 57' 01.76"E | L60 | 28.04 | N73° 48' 18.48"E |
| L21 | 45.35 | S28° 57' 01.76"E | L61 | 31.00 | S16° 11' 41.52"E |
| L22 | 50.53 | N12° 14' 31.87"W | L62 | 64.02 | N14° 48′ 22.21"E |
| L23 | 25.37 | N88° 24' 10.20"E | L63 | 75.07 | N14° 48′ 18.92″E |
| L24 | 6.51 | S12° 14' 11.25"E | L64 | 75.00 | N14° 48′ 18.92″E |
| L25 | 28.37 | S49° 28' 53.49"W | L65 | 96.22 | N14° 50′ 41.96″E |
| L26 | 59.42 | S12° 14' 11.25"E | L66 | 21.60 | N14° 48′ 18.92″E |
| L27 | 27.14 | N54° 31' 13.72"E | L67 | 30.00 | N76° 41' 54.78"E |
| L28 | 26.85 | N54° 31' 13.72"E | L68 | 30.00 | S12° 30' 17.08"E |
| L29 | 54.38 | S12° 14′ 31.87″E | L69 | 89.45 | N14° 48′ 18.92″E |
| L30 | 2.26 | S12° 14′ 31.87″E | L70 | 145.00 | N14° 48' 18.92"E |
| L31 | 26.12 | N85° 35' 54.82"W | L71 | 14.50 | S75° 11' 41.08"E |
| L32 | 66.78 | N12° 14′ 31.87"W | L72 | 9.52 | N14° 48′ 18.92″E |
| L33 | 66.78 | N12° 14' 31.87"W | L73 | 7.42 | S37° 27' 53.48"W |
| L34 | 25.81 | N66° 37' 35.01"E | L74 | 15.15 | S6° 39' 28.03"E |
| L35 | 25.48 | N66° 37' 35.01"E | L75 | 9.47 | N78° 32' 49.13"E |
| L36 | 54.33 | S12° 14' 31.87"E | L76 | 11.27 | N34° 35' 16.83"E |
| L37 | 7.76 | S12° 14' 31.87"E | L77 | 16.20 | N52° 52' 41.73"W |
| L38 | 26.31 | N85° 00' 31.14"W | | | |
| L39 | 2.81 | N12° 14′ 31.87"W | | | |

L40 67.06 N12 14 23.19 W L41 25.61 N66 37 35.01 E



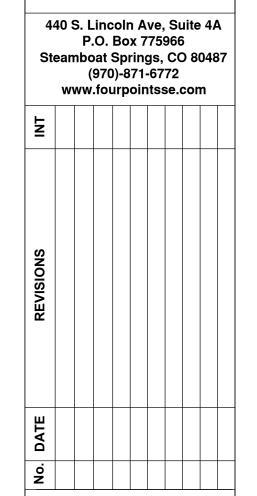

1940 BRIDGE LANE STEAMBOAT SPRINGS, CO 80487

Horizontal Scale

1" = 30'

Contour Interval = 1 ft

DATE: 5-31-2024

JOB #: 2349-001

DRAWN BY: WNM

DESIGN BY:

REVIEW BY:

IF THIS DRAWING IS PRESENTED


IF THIS DRAWING IS PRESENTED IN A FORMAT OTHER THAN 24" X 36", THE GRAPHIC SCALE SHOULD BE UTILIZED.

> EN SPACE AND ITED COMMON MENT EXHIBIT

OP

SHEET#

1

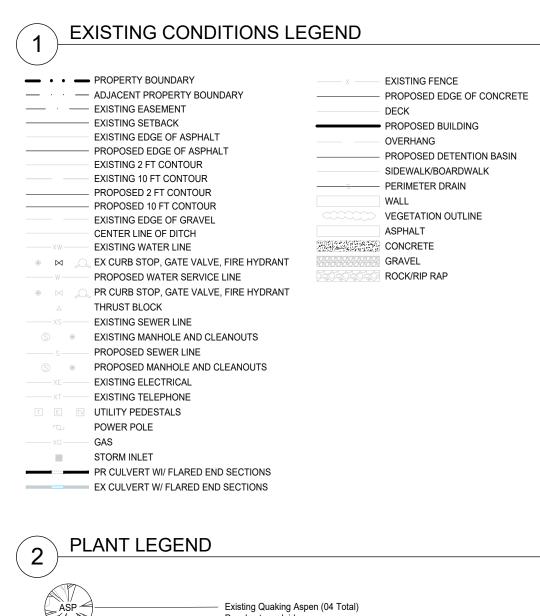

Existing Quaking Aspen (04 Total) Populus tremuloides Size Varies: 2.50" - 3.50" Caliper Existing native and cultivated deciduous shrubs (20 Total = 07 Plantings) Prunus, Cornus, Rosa, etc. Size: #5 Container Minimum Existing Ornamental Trees (09 Total) Spring Snow Crabapple and Chokecherry Size Varies: 2.50" - 4.00" Caliper CTN / WIL Existing Deciduous Trees (42 Total) Narrowleaf Cottonwood and Golden Willow Size: 6.00" - 36.00" Caliper Existing Evergreen Trees (01 Total) Picea pungens, Pinus ponderosa, etc. Size: 12' Height

EXISTING PLANT LIST

| | | DECIDUOUS & | EVERGREEN TREES | |
|--|----------------------------------|---|--|--|
| LABEL | QUANTITY | COMMON NAME | SCIENTIFIC NAME: | SIZE |
| SSC SPR CTN ASP CHT WIL | 04 01 35 04 05 07 | Spring Snow Crabapple Colorado Blue Spruce Narrowleaf Cottonwood Quaking Aspen Chokecherry Weeping Golden Willow | Malus 'Spring Snow' Picea pungens ' Glauca' Populus angustifolia Populus tremuloides Prunus virginiana Salix babylonica | 2.50" - 4.00" ca 12' Height 6.00" - 36.00" c 2.50" - 3.50" ca 2.50" - 4.00" ca 6.00" - 36.00" c |
| | | DECIDU | OUS SHRUBS | |
| LABEL | QUANTITY | COMMON NAME | SCIENTIFIC NAME: | SIZE |
| RTD JUN POT | 11 02 05 | Redtwig Dogwwod Common Juniper Yellow Potentilla | Cornus stolonifera Juniperus communis Potentilla fruticosa | #5 Pot #5 Pot #5 Pot |





440 S. Lincoln Ave, Suite 4B P.O. Box 775966 Steamboat Springs, CO 80487 (970)-871-6772 matthew@fourpointsse.com

| Z | - | • | • | | | |
|-----------|---|---|---|--|--|--|
| REVISIONS | | | | | | |
| DATE | - | | | | | |
| O | - | - | | | | |

PARK

RIVERFRON
Riverfront Par
1920 Bridge I

Horizontal Scale

1" = 30'

Contour Interval = 2 ft

DATE: 06/14/2024

DATE: 06/14/2024

JOB #: 2349-001

DRAWN BY: AAB

DESIGN BY:

REVIEW BY:

IF THIS DRAWING IS PRESENTED IN A FORMAT OTHER THAN 24" X 36", THE GRAPHIC SCALE SHOULD BE UTILIZED.

EXISTING
CONDITIONS
TREE INVENTO

SHEET#

X1

PLANTING NOTES

- 1. Prior to the start of any excavation for the project both on and off the site, the contractor shall notify the utility notification center of colorado at: 1-800-922-1987 and verify that all existing utilities have been located and marked. 2. Contractor(s) shall thoroughly familiarize themselves with all construction documents, specifications, and site conditions prior to bidding and prior to construction. Any discrepancies between drawings, specifications, and site conditions shall be reported
- immediately to the Landscape Designer for clarification and resolution prior to bidding or construction. 3. All trees to be located outside of the water and sewer utility easements.
- 4. All dimensions are taken to face of building except where otherwise noted.
- . For layout and dimensioning of lots, see engineering drawings. 6. Screened images show existing conditions. Where existing conditions lie under or are impinged upon by proposed buildings and/or site elements, the existing condition will be removed, abandoned and/or capped or demolished as required.
- Contractor shall begin maintenance immediately after planting and will continue until final acceptance. The landscape contractor shall guarantee all plant materials for one (1) full year from date of acceptance.
- 8. The landscape contractor shall supply all plant materials in quantities sufficient to complete all plantings shown on this drawing. All plant materials are subject to the approval of the Landscape Designer, at the nursery, and at the site. 9. All plant materials shall conform to the guidelines established by the american association of nurserymen. All plants to be balled in burlap or containerized, and shall bear the same relationship to finish grade as to original grades before digging.
- 10. Mulch for planted areas to be aged cedar bark: partially decomposed, dark brown in color and free of wood chips thicker than 1/4 inch. Stone mulch for planted areas to be a mixture of native stone, pea gravel, and other varied sizes of indigenous material to be placed in such a way to be random and visually (natural) in appearance.
- 11. Planting soil mix: excavated soil to be thoroughly incorporated with black gold soil conditioner (or equivalent) to be added per manufacturer's recommended rates. 12. All areas of the site which have been disturbed and not otherwise developed shall be loamed and seeded with a minimum depth of
- 13. All plant materials to be under an automatic drip irrigation system to be installed.

PLANTING SPECIFICATIONS - GENERAL

SOIL PREPARATION AND PLANTING

- 1. Lay out individual tree and shrub locations and the areas for multiple plantings. Stake tree locations and outline planting areas before start of planting work. Make minor adjustments as may be required. Landscape Designer or Owners Representative approval required before installation.
- PREPARATION OF PLANTING SOIL 1. Topsoil (Stockpiled): Clean topsoil of roots, plants, stones, clay lumps, and other extraneous materials harmful or toxic to plant
- 2. Mix Black Gold Soil Contidioner (or approved substitute soil amendments) and fertilizer with topsoil as required based on existing soil conditions. Preparation of the planting soil shall not occur if planting will not follow within a few days. Stockpile covered
- 3. Pit and Trench Backfill: Mix planting soil prior to backfilling, and stockpile at site.
- 4. Planting Beds: Mix planting soil either prior to planting, or apply on surface of topsoil and mix thoroughly before planting.
- PREPARATION OF PLANTING BEDS 1. Spread planting soil mixture to minimum depth required to meet lines, grades, and elevations shown, after light rolling and natural settlement. Place approximately 1/2 of total amount of planting soil required. Work into top of loosened sub-grade to create a
- transition layer, then place remainder of the planting soil. Remove 8 inches to 10 inches of soil and replace with prepared planting soil mixture. Backfill for each bed with three parts topsoil and one part Black Gold Soil Conditioner (or approved substitute) thoroughly mixed prior to placing.

EXCAVATION FOR TREES AND SHRUBS

- . Excavate pits, beds, and trenches with vertical sides and with bottom of excavation slightly raised at center to provide proper drainage. Loosen hard sub-soil in bottom of excavation. A. For ball and burlap (B&B) trees, make excavations at least half again as wide as the ball diameter and equal to the ball depth, plus following allowance for setting of ball on a layer of compacted backfill.
- B. Allow for 3 inch thick setting layer of planting soil mixture. C. For container grown stock, excavate as specified for ball and burlap stock, adjusted to size of container width and depth. Dispose of subsoil removed from planting excavations. Do not mix with planting soil or use as backfill.
- Fill excavations for trees and shrubs with water and allow water to percolate out prior to planting. . Backfill pits with three parts topsoil and one part Black Gold Soil Conditioner (or approved substitute) thoroughly mixed prior to
- 5. Place Agriform Tree Fertilizer Tablets (or approved substitute) in planting pit prior to back filling at the following rate: three per each tree, one per each shrub.


PLANTING TREES AND SHRUBS

- 1. Set ball and burlap (B&B) stock on layer of compacted planting soil mixture, plumb and in center of pit or trench with top of ball at same elevation as adjacent finished landscape grades. Remove burlap from sides of balls; retain on bottoms. When set, place additional back fill around base and sides of ball, and work each layer to settle backfill and eliminate voids and air pockets. When excavation is approximately 2/3 full, water thoroughly before placing remainder of backfill. Repeat watering until no more is absorbed. Water again after placing final layer of backfill. Set container grown stock, as specified, for balled burlapped stock, except cut cans on 2 sides with an approved can cutter an
- from plant ball so as not to damage root balls. Apply anti-desiccant, using power spray, to provide an adequate film over trunks, branches, stems, twigs and foliage.
- A. If deciduous trees or shrubs are moved when in full-leaf, spray with anti-desiccant at nursery before moving and spray again 2 weeks after planting. Remove and replace excessively pruned or disfigured stock resulting from improper pruning.
- 6. Wrap tree trunks of 2 inches caliper and larger, start at ground and cover trunk to height of first branches and securely attach. Inspect tree trunks for injury, improper pruning and insect infestation and take corrective measures before wrapping.
- 7. Guy and stake trees immediately after planting, as indicated.

| | | DECIDUOUS & EVE | RGREEN TREES | |
|------------|----------|--|---|----------------------------|
| LABEL | QUANTITY | COMMON NAME | SCIENTIFIC NAME: | SIZE |
| ASP | 00 | Quaking Aspen | Populus tremuloides | 1.5" - 3.5" |
| NAH | 00 | Northern Acclaim Honeylocust | Gleditsia triacanthos inermis 'Northern Acclaim | |
| PFC | 00 00 | Prairie Fire Crabapple | Malus 'Prairie Fire' Malus 'Red Baron' | 2.0" - 2.5' 2.0" - 2.5' |
| RBC SSC | 00 | Red Baron Crabapple Spring Snow Crabapple | Malus 'Spring Snow' | 2.0 - 2.5 |
| | | EVERGREEN | . 0 | |
| LABEL | QUANTITY | COMMON NAME | SCIENTIFIC NAME: | SIZE |
| GLB | 00 | Globe Spruce | Picea pungens ' Glauca Globosa ' | #7 Po |
| MUG | 00 | Mugo Pine | Pinus mugo 'Slowmound' | #7 Po |
| 3CJ | 00 | Blue Chip Juniper | Juniperus horizontalis 'Blue Chip' | #5 Po |
| BUJ | 00 | Buffalo Juniper | Juniperus sabina 'Buffalo' | #5 Po |
| | | DECIDUOUS | SHRUBS | |
| LABEL | QUANTITY | COMMON NAME | SCIENTIFIC NAME: | SIZE |
| SER | 00 | Saskatoon Serviceberry | Amelanchier alnifolia | #7 Po |
| RTD | 00 | Redtwig Dogwwod | Cornus stolonifera | #5 Po |
| OBL | 00 | Diablo Ninebark | Physocarpus opulifolius 'Monlo' | #5 Po #5 Po |
| /PT PPT | 00 00 | Yellow Potentilla Pink Potentilla | Potentilla fruticosa Potentilla fruticosa 'pink beauty' | #5 Po #5 Po |
| ARH | 00 | Arnold's Red Honey Suckle | Lonicera involucrata 'Arnold's Red' | #3 P0 #7 Po |
| SPI | 00 | Goldflame Spirea | Ribes aureum | #5 Po |
| ROS | 00 | Native Pink Shrub Rose | Rosa woodsii | #5 Po |
| .IL | 00 | Common Lilac | Syrangia vulgaris | #7 Po |
| | | PERENI | NIALS | |
| LABEL | QUANTITY | COMMON NAME | SCIENTIFIC NAME: | SIZE |
| COL | 00 | Rocky Mountain Columbine | Aquilegia caerulea | #1 Po |
| AST | 00 | Showy Daisy | Aster alpinus 'goliath' | #1 Po |
| COR | 00 | Lance-leaf Coreopsis | Coreopsis lanceolata | #1 Po |
| DIA | 00 | Granite Pinks Dianthus | Dianthus spp. | #1 Po |
| CP | 00 | Purple Coneflower | Echinacea purpurea | #1 Po #1 Po |
| GER DAY | 00 00 | Cranesbill Geranium Rocky Mountain Summer Daylily | Geranium spp. Hemerocallis 'Rocky Mountain Summer' | #1 Po |
| NBF | 00 | Western Blue Flag | Iris missouriensis | #1 Po |
| UP. | 00 | Blue Lupine | Lupinus 'the govenor' | #1 Po |
| MON | 00 | Red Bee-Balm | Monarda 'scarlet red' | #1 Po |
| POP | 00 | Oriental Poppy | Papaver orientale | #1 Po |
| RMP | 00 | Roocky Mountain Penstemon | Penstemon strictus | #1 Po |
| RUD | 00 | Black-eyed Susan | Rudbeckia fulgida 'goldstrum' | #1 Po |
| | | ORNAMENTAL | _ GRASSES | |
| LABEL | QUANTITY | COMMON NAME | SCIENTIFIC NAME: | SIZE |
| KFG BOG | 00 00 | Karl Foerster Feather Reed Grass Blue Oat Grass | Calamagrostis x acutiflora 'Karl Foerster' Helictotrichon sempervirens | #1 Po #1 Po |
| | | CDOLINDO | · | |
| LABEL | QUANTITY | GROUNDO COMMON NAME | SCIENTIFIC NAME: | SIZE |
| SWD | 00 | Sweet Woodruff | Galium odoratum | Flat - F |
| BCP | 00 | Blue Creeping Phlox | Phlox subulata 'emerald blue' | Flat - F |
| CPT | 00 | Creeping Yellow Potentilla | Potentilla repens | Flat - F |
| SAP | 00 | Rock Soapwort | Saponaria ocymoides | Flat - F |
| SMS | 00 | Goldmoss Stonecrop | Sedum acre evergreen | Flat - F |
| SED | 00 | Dragon's Blood Seedum | Sedum 'Dragon's Blood' | Flat - F |
| VER | 00 | Creeping Speedwell Periwinkle | Veronica repens Vinca Minor | Flat - F |
| VIN | 00 | | | |

SITE PLAN LEGEND

| PROPERTY BOUNDARY |
|--------------------------------------|
| — · · · — ADJACENT PROPERTY BOUNDARY |
| EXISTING EASEMENT |
| EXISTING SETBACK |
| EXISTING EDGE OF ASPHALT |
| PROPOSED EDGE OF ASPHALT |
| EXISTING 2 FT CONTOUR |
| EXISTING 10 FT CONTOUR |
| PROPOSED 2 FT CONTOUR |
| PROPOSED 10 FT CONTOUR |
| EXISTING EDGE OF GRAVEL |
| CENTER LINE OF DITCH |
| X EXISTING FENCE |
| — – – PHASE LINE |

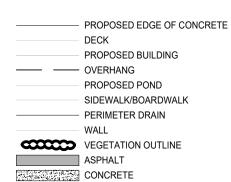

GRAVEL ROCK/RIP RAP

IRRIGATION SPECIFICATIONS - GENERAL

IRRIGATION SYSTEM DESIGN GUIDELINES

- All irrigation systems shall be designed to avoid runoff onto hardscape from low head drainage, overspray and other similar conditions where water flows onto adjacent property, non-irrigated areas, walks, roadways or structures.
- The irrigation system shall be automatic, constructed to discourage vandalism and simple to maintain.
- All equipment shall be of proven design with local service available.
- Control valves should be rated at 200 PSI
- Visible sprinklers adjacent to hardscape shall be of pop-up design. All heads should have a minimum number of wearing pieces with an extended life cycle. Lawn and shrub spray head.s shall be set back from hardscape a minimum of 18 inches. Rotor type heads shall be set back a
- minimum of 4 feet from hardscape. Design sprayhead and rotor head stations with consideration for worst wind conditions. Close spacing and low-angle nozzles are required in high and frequent wind areas.
- Spacing of sprinkler heads shall not exceed manufacturer's maximum recommendations for proper coverage.
-). Only irrigation heads with matched precipitation rates shall be used on the same valve. Valve circuiting shall be designed to be consistent with hydrozones.

4. Trees in turf areas shall be on a separate station to provide proper deep watering.

Sprinklers, drippers, valves, etc., must be operated within manufacturer's specifications. 13. The use of drip or pressure compensating bubblers is encouraged for all shrubs and trees. Small, narrow and irregularly shaped or sloping areas shall be irrigated with drip, micro-spray or pressure-compensating bubbler heads.

DRIP IRRIGATION DESIGN GUIDELINES

- The drip system must be sized for mature-size plants. All drip valves may be operated at any one time during an irrigation cycle provided gpm does not exceed supply.
- Distribution tubing (microtubing) shall be buried no more then 6 inches below grade. Tthe end of $\frac{1}{4}$ distribution tube must be secured by a stake. The maximum length of microtubing must be specified on the plan to be 10 feet or less.

4. All proposed drip emitters shall match the gallons per day per plant according to plant size and plant type.

SPECIFICATIONS FOR IRRIGATION EFFICIENCY rigation efficiencies are expected from well-designed and maintained systems. The following are required:

- 1. High flow check valves shall be installed in or under all heads where damage could occur to property due to flooding, unless controllers with flow sensor capabilities are specified that can automatically shut off individual control valves when excess flow is
- Pressure compensating screens/devices shall be specified on all spray heads to reduce radius as needed to prevent overthrow
- onto hardscape and/or to control high pressure misting Soil moisture sensing systems for turf grass hydrozones shall be used. The moisture sensing system shall provide at least one
- sensor location in the turf grass. Controller systems with the capabilities of automatically making daily schedule adjustments according to plant water needs, derived from weather sensing and recording equipment on or near the site are recommended and may be substituted for a
- moisture sensing system. If a soil moisture sensing system is not used and the controller cannot automatically make daily schedule adjustments from local data, then provide an irrigation schedule for all each of the following conditions:
- a. Plant establishment period. c. Temporarily irrigated areas

Schedules shall include: Irrigation run times per cycle, cycles per day, and days per week (month) for each plant hydrozone and

application rate. Irrigating shall be scheduled for the cooler time of each day to avoid irrigating during periods of strong winds and

high temperatures, with high evaporation loss. Electronic multi-program controllers shall be specified where there is a combination of different hydrozones or when using

different types of irrigation equipment.

Prunus, Cornus, Rosa, etc.

Size: #5 Container Minimun

Perennials (55 Total)

Varieties vary

PLANT LEGEND Proposed Ornamental Trees (13 Total) Flowering Crabapple-Malus hybrids Size: 2.50" Minimum Caliper Native and cultivated evergreen shrubs (07 Total) Juniperus, Picea, Pinus spp. Size: #5 Container Minimum Native and cultivated deciduous shrubs (28 Total)

GRASS SEED MIXTURES

| RADE OR INDUSTRY NAME: | SEED COMMON NAME | PERCENT OF MIX | Broadcom/Medifis Rate: |
|----------------------------|--------------------------------|----------------|-------------------------|
| RANSITION TURF MIX | Smooth Brome, VNS | 40% | 1-2 lbs. per 1,000 SF |
| | Perennial Ryegrass, VNS | 25% | |
| | Tall Fescue, Turf Type, VNS | 25% | |
| | Canada Bluegrass, VNS | 10% | |
| | o , | | Broadcast Seeding Rate: |
| OW GROW HIGH ALTITUDE | Crested Wheatgrass, Ephraim | 30% | 30-35 lbs. per Acre |
| | Perennial Ryegrass, VNS | 25% | |
| | Sheep Fescue, VNS | 15% | |
| | Chewing Fescue, Shadow II | 15% | |
| | Upland Bluegrass, Drayler | 15% | |
| | | | Broadcast Seeding Rate: |
| OUNTAIN MEADOW MIX | Winter Rye (cereal grain) | 20% | 40-60 lbs. per Acre |
| | Forage Perennial Ryegrass, VNS | 20% | |
| | Mountain Brome, Bromar | 20% | |
| | Timothy, Climax | 15% | |
| | Forage Kentucky Bluegrass, VNS | 14% | |
| | Orchardgrass, Potomac | 10% | |
| | Alsike Clover | 01% | |
| | | | Broadcast Seeding Rate: |
| LL-BLUE KENTUCKY BLUEGRASS | Kentucky Bluegrass, Jackpot | 20% | 3-5 lbs. per 1,000 SF |
| | Kentucky Bluegrass, Milagro | 20% | |
| | Kentucky Bluegrass, Blue Devil | 20% | |
| | Kentucky Bluegrass, Mercury | 20% | |
| | Kentucky Bluegrass Pocketar | 20% | |

Application rates per manufacturers specifications. Accepted methods of application include: Broadcast with Penn Mulch, and


IRRIGATION NOTES

- 1. All plant material shown will be controlled by an automatic irrigation system to be designed. The irrigation system shall be designed using common industry practices and principals. The system shall be installed in such a manner as to maintain efficiency and performance. The existing conditions of the site will determine the ultimate design and layout of the irrigation
- 2. At the request of the owner, an as-built plan will be required for submission at the conclusion of the project. All field changes will be recorded, and updated as necessary. 3. Valve box locations are not to be installed in sod areas whenever possible. Take advantage of planting beds, and native turf areas outside the fence for potential valve box locations.
- Provide mainline isolation wherever possible through the use of schedule 40 pvc ball valves (to be sized as necessary). 5. Multiple Points-of-Connection to be provided for providing irrigation water for the system. Locations have not been determined at this time. Locations to be designated prior to construction. Site plumber to provide 1-1/2" copper (minimum) extending 12" from the foundation wall, a minimum of 18" below grade. A fitting should be provided for conversion to PVC. When not located in building mechanical rooms, remote locations may be provided. 6. Controller locations have not been determined at this time. A 110v dedicated circuit will be required as a power source for the controllers. Locations to be specified prior to installation. Mounting and connection of 110v power to controller will be






440 S. Lincoln Ave, Suite 4B P.O. Box 775966 Steamboat Springs, CO 80487 (970)-871-6772 matthew@fourpointsse.com

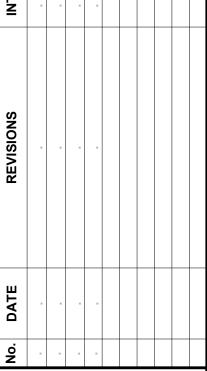

Horizontal Scale

Contour Interval = 2 ft DATE: 06/14/2024 JOB #: 2349-001 DRAWN BY: AAB DESIGN BY: **REVIEW BY:** IF THIS DRAWING IS PRESENTED IN A FORMAT OTHER THAN 24" X 36", THE GRAPHIC SCALE SHOULD BE UTILIZED

SHEET#

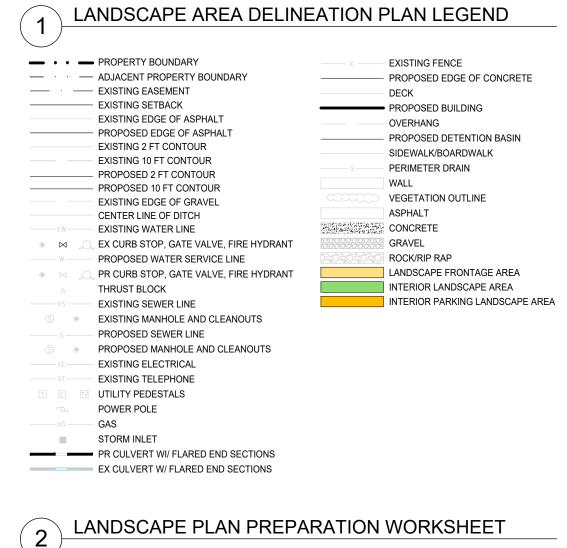

1920 Bridge Lane Steamboat Springs, CO 80477 Submission Date 06-14-2024 Steamboat Springs, LLC Spokane, WA 99203-3563 Project Zoning: Industrial (CS & I) Project Land Use: Landscape Requirements:

INTERIOR PARKING LOT LANDSCAPING AREA: 200 sf per 9 Parking Spaces FRONTAGE LANDSCAPE AREA: 1 tree per 200 Square Feet

INTERIOR LANDSCAPE AREA: 1 tree per 500 Square Feet Entry Corridor Overlay Zone: Yes____ No_X_

DISTRIBUTION OF PLANT MATERIAL:

INTERIOR PARKING LOT LANDSCAPE AREA CALCULATIONS: 200 sf per 9 Parking Spaces Required

PLANT DISTRIBUTION CALCULATIONS: NEW PARKING SPACES (required per current building and development codes) (00 / 9) = 0 (x 200) = _____ sf of Interior Parking Landscape Area Required (0 sf provided) EXISTING PARKINGS SPACES (utilized to meet building code requirements as approved) (101/9) = 12 (x 200) = 2,400 sf of Interior Parking Landscape Area Required 2,400 sf Total Required (2,439 sf total provided)

Deciduous Trees Required: 1 per 200 sf (minimum) = 12 each (2.50" Caliper) - 12 TOTAL PROVIDED Shrubs Required: 4 per 200 sf (minimum) = 48 each (#5 Pot) - 33 TOTAL PROVIDED


LANDSCAPE FRONTAGE AREA CALCULATIONS: 1 Planting per 400 sf of Landscape Frontage Area Required PLANT DISTRIBUTION CALCULATIONS: 02 Total Plantings Required as Calculated Above Existing Tree Preservation Credits = 0 Distribution of 02 Total Plantings Required per the City of Steamboat Springs Community Development Code 10% Evergreen Trees (10'+) = 00 15% Evergreen Trees (8'-9') = 00 10% Evergreen Trees (6'-7') = 00 20% Deciduous Trees (2.50") = 00 15% Ornamental Trees (2.50") = 01 15% Shrubs (#5 Container) = 01 (x 3 Each) = 03 02 Calculated Plantings per Minimum Percentages Required + 00 Additional Plantings Provided
00 Deciduous Trees 00 Ornamental Trees
00 Plantings (x3 Shrubs Each) = 03 Shrubs
= 02 Total Plantings Provided

INTERIOR LANDSCAPE AREA CALCULATIONS: 1 Planting per 500 sf of Interior Landscape Area Required $\frac{31,163 \text{ sf } / 500}{\text{Square Feet Calculated}} = \frac{63}{\text{Plantings}}$ PLANT DISTRIBUTION CALCULATIONS: 63 Total Plantings Required as Calculated Above Existing Tree Preservation Credits = 63 Distribution of 00 Total Plantings Required per the City of Steamboat Springs Community Development Code 10% Evergreen Trees (10'+) = 00 NOTE: 63 existing tree preservation credits have been applied to the calculation 15% Evergreen Trees (8'-9') = 00 of the plantings required. 10% Evergreen Trees (6'-7') = 00 20% Deciduous Trees (2.50") = 00 15% Ornamental Trees (2.50") = 00 15% Shrubs (#5 Container) = 00 (x 3 Each) = 00 00 Calculated Plantings per Minimum Percentages Required <u>+ 00 Additional Plantings Provided</u> 00 Deciduous Trees 00 Ornamental Trees 00 Plantings (x3 Shrubs Each) = 00 Shrubs = 00 Total Plantings Provided





440 S. Lincoln Ave, Suite 4B P.O. Box 775966 Steamboat Springs, CO 80487 (970)-871-6772 matthew@fourpointsse.com

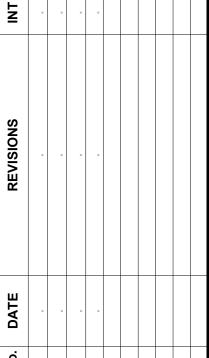

Horizontal Scale Contour Interval = 2 ft DATE: 06/14/2024 JOB #: 2349-001

DRAWN BY: AAB **DESIGN BY: REVIEW BY:** IF THIS DRAWING IS PRESENTED IN A FORMAT OTHER THAN 24" X 36", THE GRAPHIC SCALE SHOULD BE UTILIZED.

SHEET#

| SHADING KEY |
|--------------------------|
| = PROPOSED OFFICE USE |
| = PROPOSED ACCESSORY USE |
| = PROPOSED STUDIO USE |
| = PROPOSED WAREHOUSE USE |
| = STAIRWELL |


| | Building 1 - | First Floor Use: | 5 |
|---------|--------------|------------------|-------|
| Unit 22 | Level 1 | Warehouse | 5835 |
| Unit 23 | Levei 1 | Warehouse | 1324 |
| Unit 24 | Level 1 | Studio | 11156 |
| Unit 25 | Levei i | Studio | 857 |
| Unit 25 | Level 1 | Office | 1766 |
| Unit 26 | Levei I | Studio | 1065 |
| Unit 27 | tevet 1 | Office | 3076 |

OWNER: UNITS 22, 23, 24, 25, 26, AND 27, RIVERFRONT PARK, FILING 3
BRIDGEOUSANTE REATLY, LLC

BY: Dan McEntu 325ADCGAGGET/490 (SIGNATURE)

Managing Partner

Dan McEntee (PRINT NAME) DATE: 2/11/2024

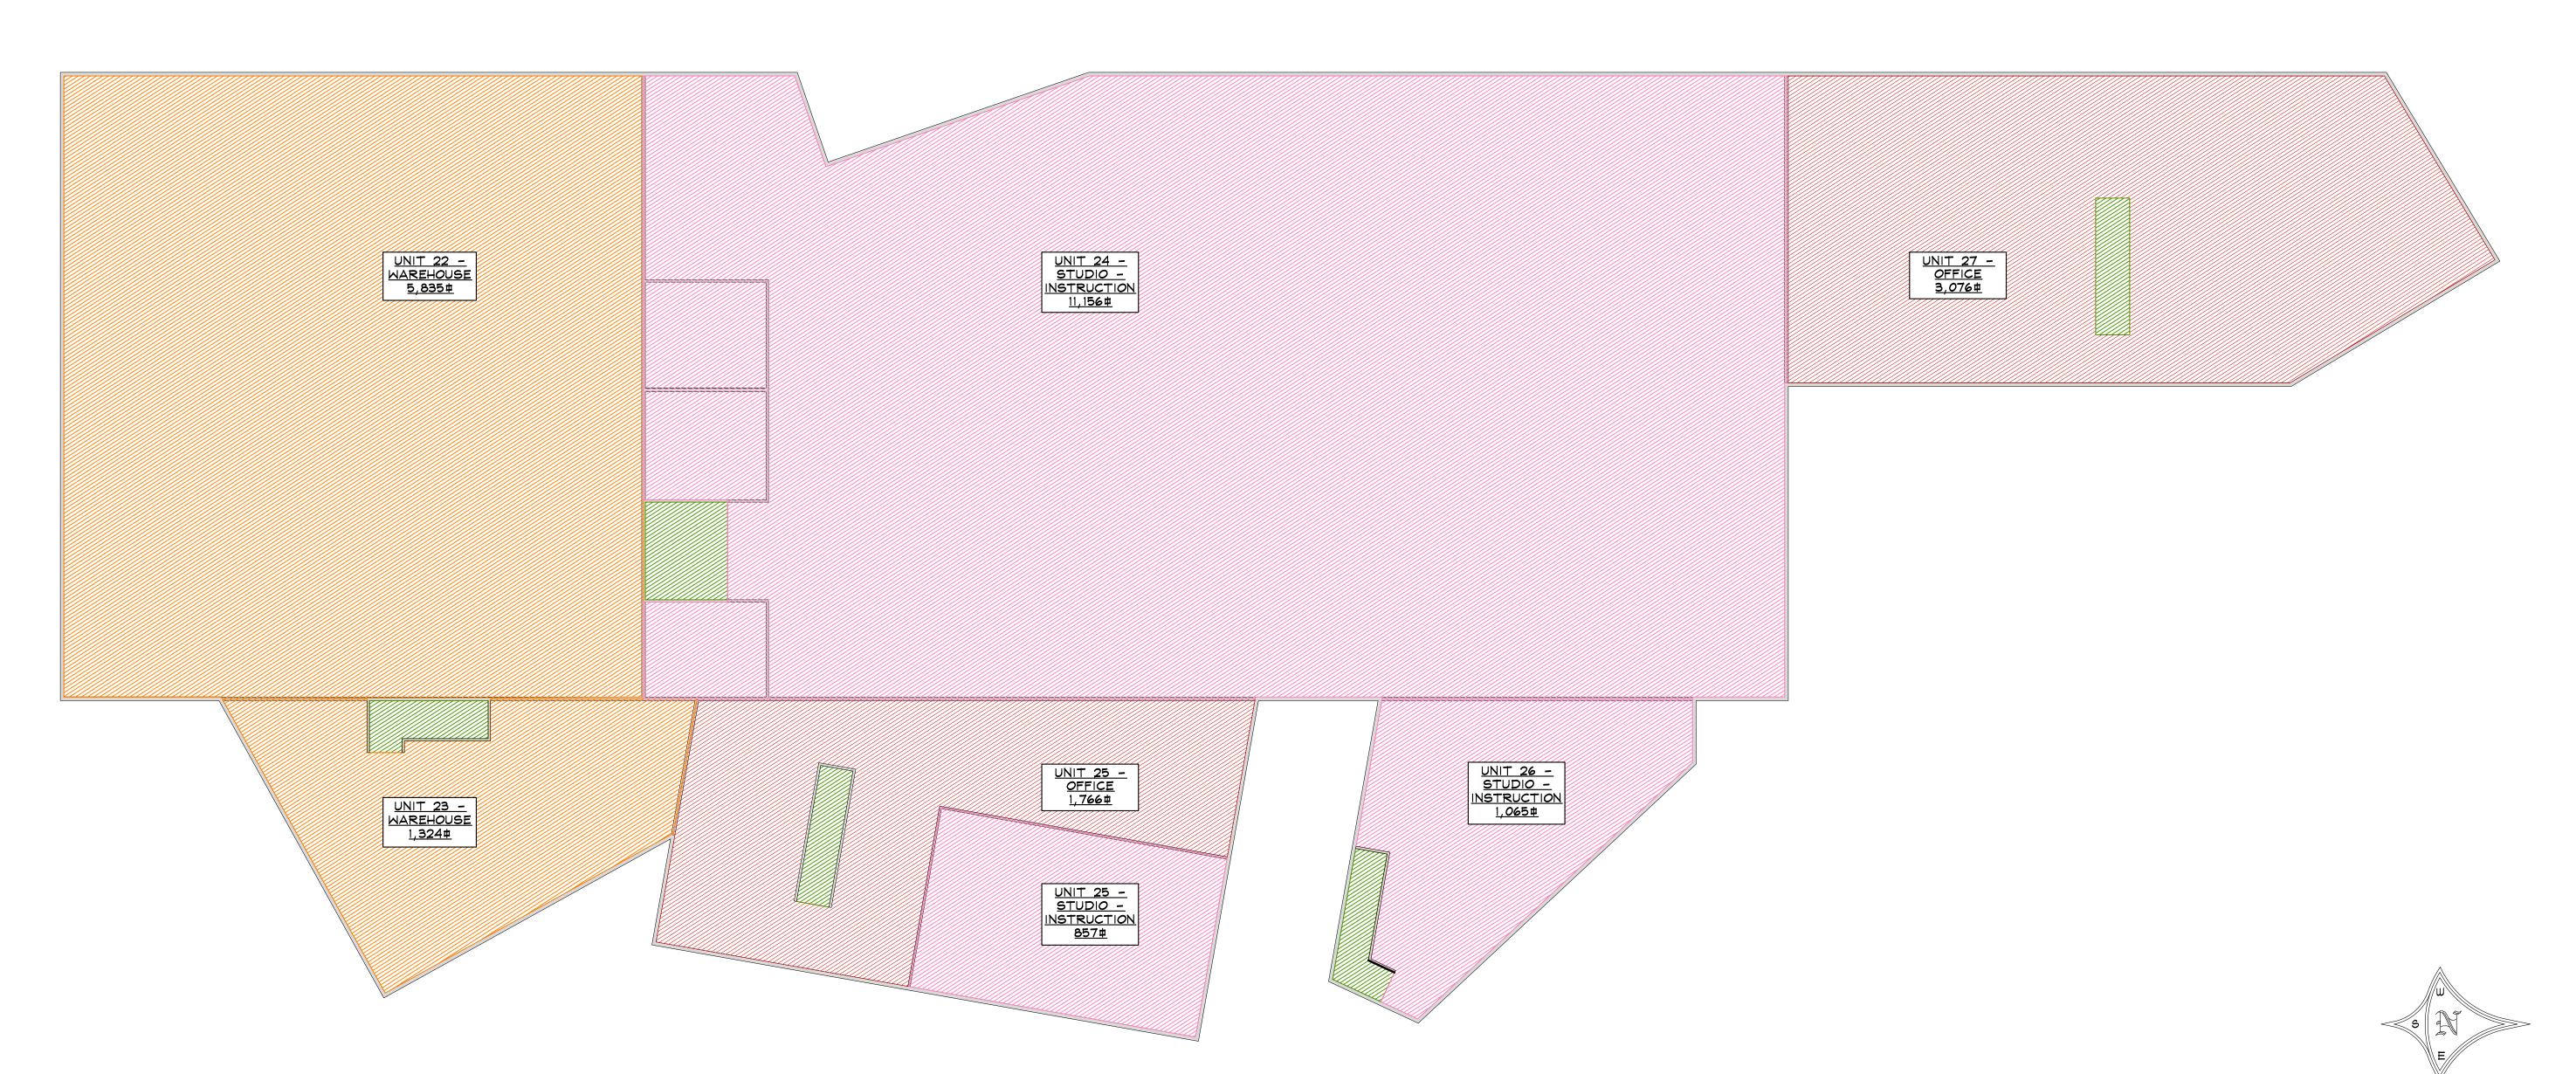

NOT FOR CONSTRUCTION



BUILDING

02 . 08 . 24 REVIEW DP

DRAWN BY: RPM REVIEWED BY: CWM PROJECT # 21099 OVERALL BUILDING 1 IST LEVEL FLOOR PLAN

PLAN

OVERALL BUILDING 1 1ST LEVEL FLOOR PLAN - USE SHADING

SCALE: N.T.S.


| SHADII | NG KEY |
|-------------------|-----------|
| = PROPOSED OFFICE | USE |
| = PROPOSED ACCES | SORY USE |
| = PROPOSED STUDI | O USE |
| = PROPOSED WARE | HOUSE USE |
| = STAIRWELL | |

| Building 1 - Second Floor Uses | | | |
|--------------------------------|---------|--------|------|
| Unit 23 | Level 2 | Office | 559 |
| Unit 24 | Level 2 | Studio | 274 |
| Unit 25 | Level 2 | Office | 327 |
| Unit 26 | Level 2 | Studio | 732 |
| Unit 27 | Level 2 | Office | 3076 |

OWNER: UNITS 22, 23, 24, 25, 26, AND 27, RIVERFRONT PARK, FILING 3
BRIDGE CLANE: REATLY, LLC

BY: Dan McEntu (STGNATURE) ITS:_____ Dan McEntee

(PRINT NAME)
2/11/2024

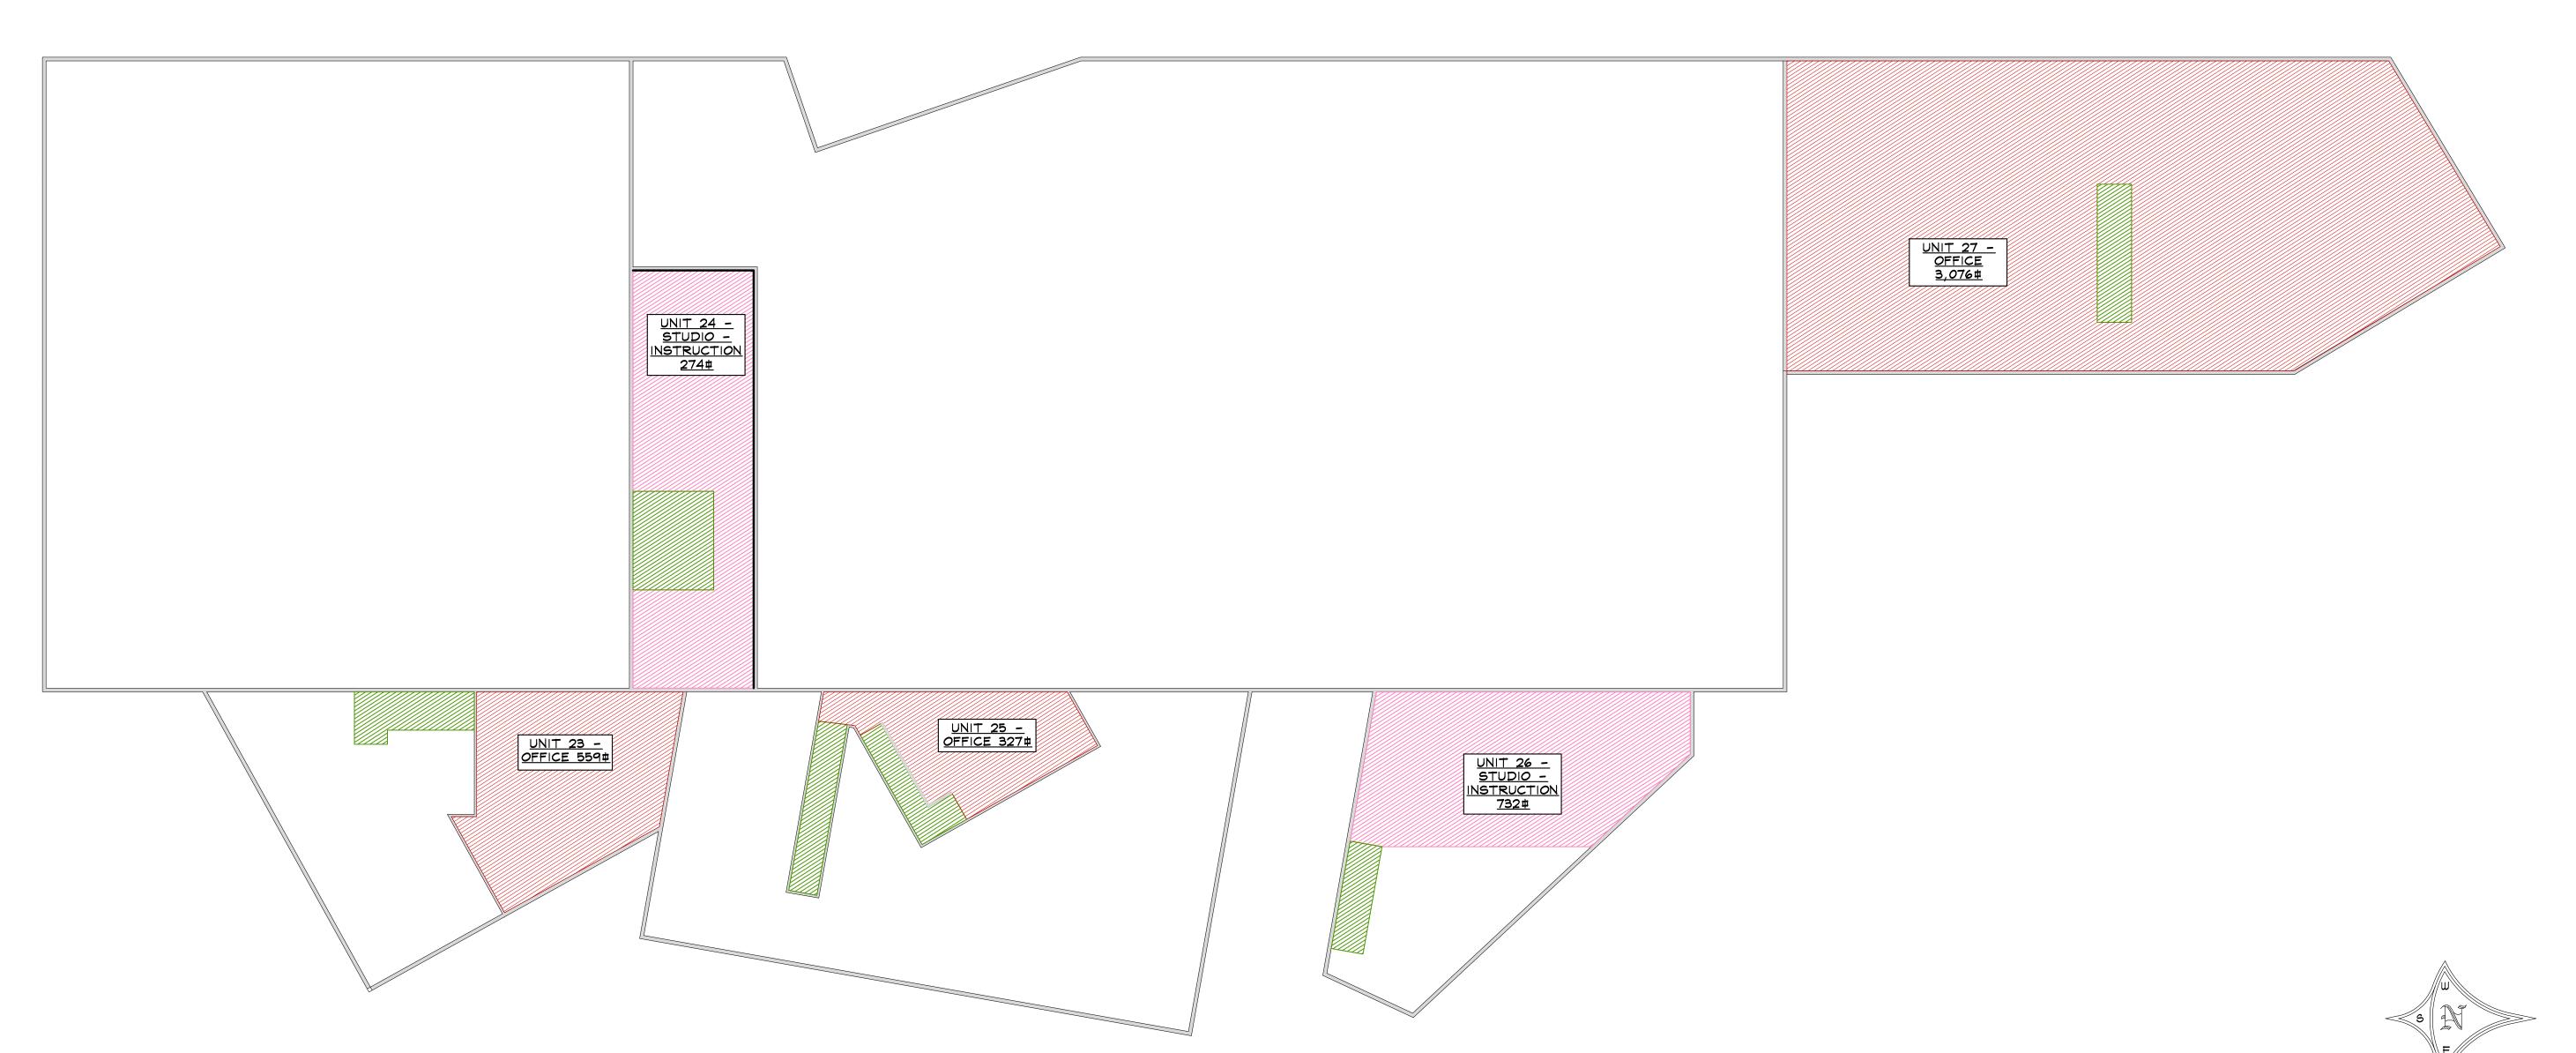

NOT FOR CONSTRUCTION

02 . 08 . 24 REVIEW 02 . XX . 24 DP

DRAWN BY: RPM REVIEWED BY: CWM PROJECT # 21099 OVERALL BUILDING 1 2ND LEVEL FLOOR PLAN

PLAN

OVERALL BUILDING 1 2ND LEVEL FLOOR PLAN - USE SHADING

SCALE: N.T.S.

| SHADING KEY |
|--------------------------|
| = PROPOSED OFFICE USE |
| = PROPOSED ACCESSORY USE |
| = PROPOSED STUDIO USE |
| = PROPOSED WAREHOUSE USE |
| = STAIRWELL |

| | Building 1 - | Third Floor Use | es : |
|---------|--------------|-----------------|------|
| Unit 25 | Level 3 | Accessory | 299 |
| Unit 27 | Level 3 | Accessory | 373 |


OWNER: UNITS 22, 23, 24, 25, 26, AND 27, RIVERFRONT PARK, FILING 3
BRIPGEON REATLY, LLC

BY: Dan McEntu (SIGNATURE)

ITS: Managing Partner

Dan McEntee (PRINT NAME)

DATE: 2/11/2024

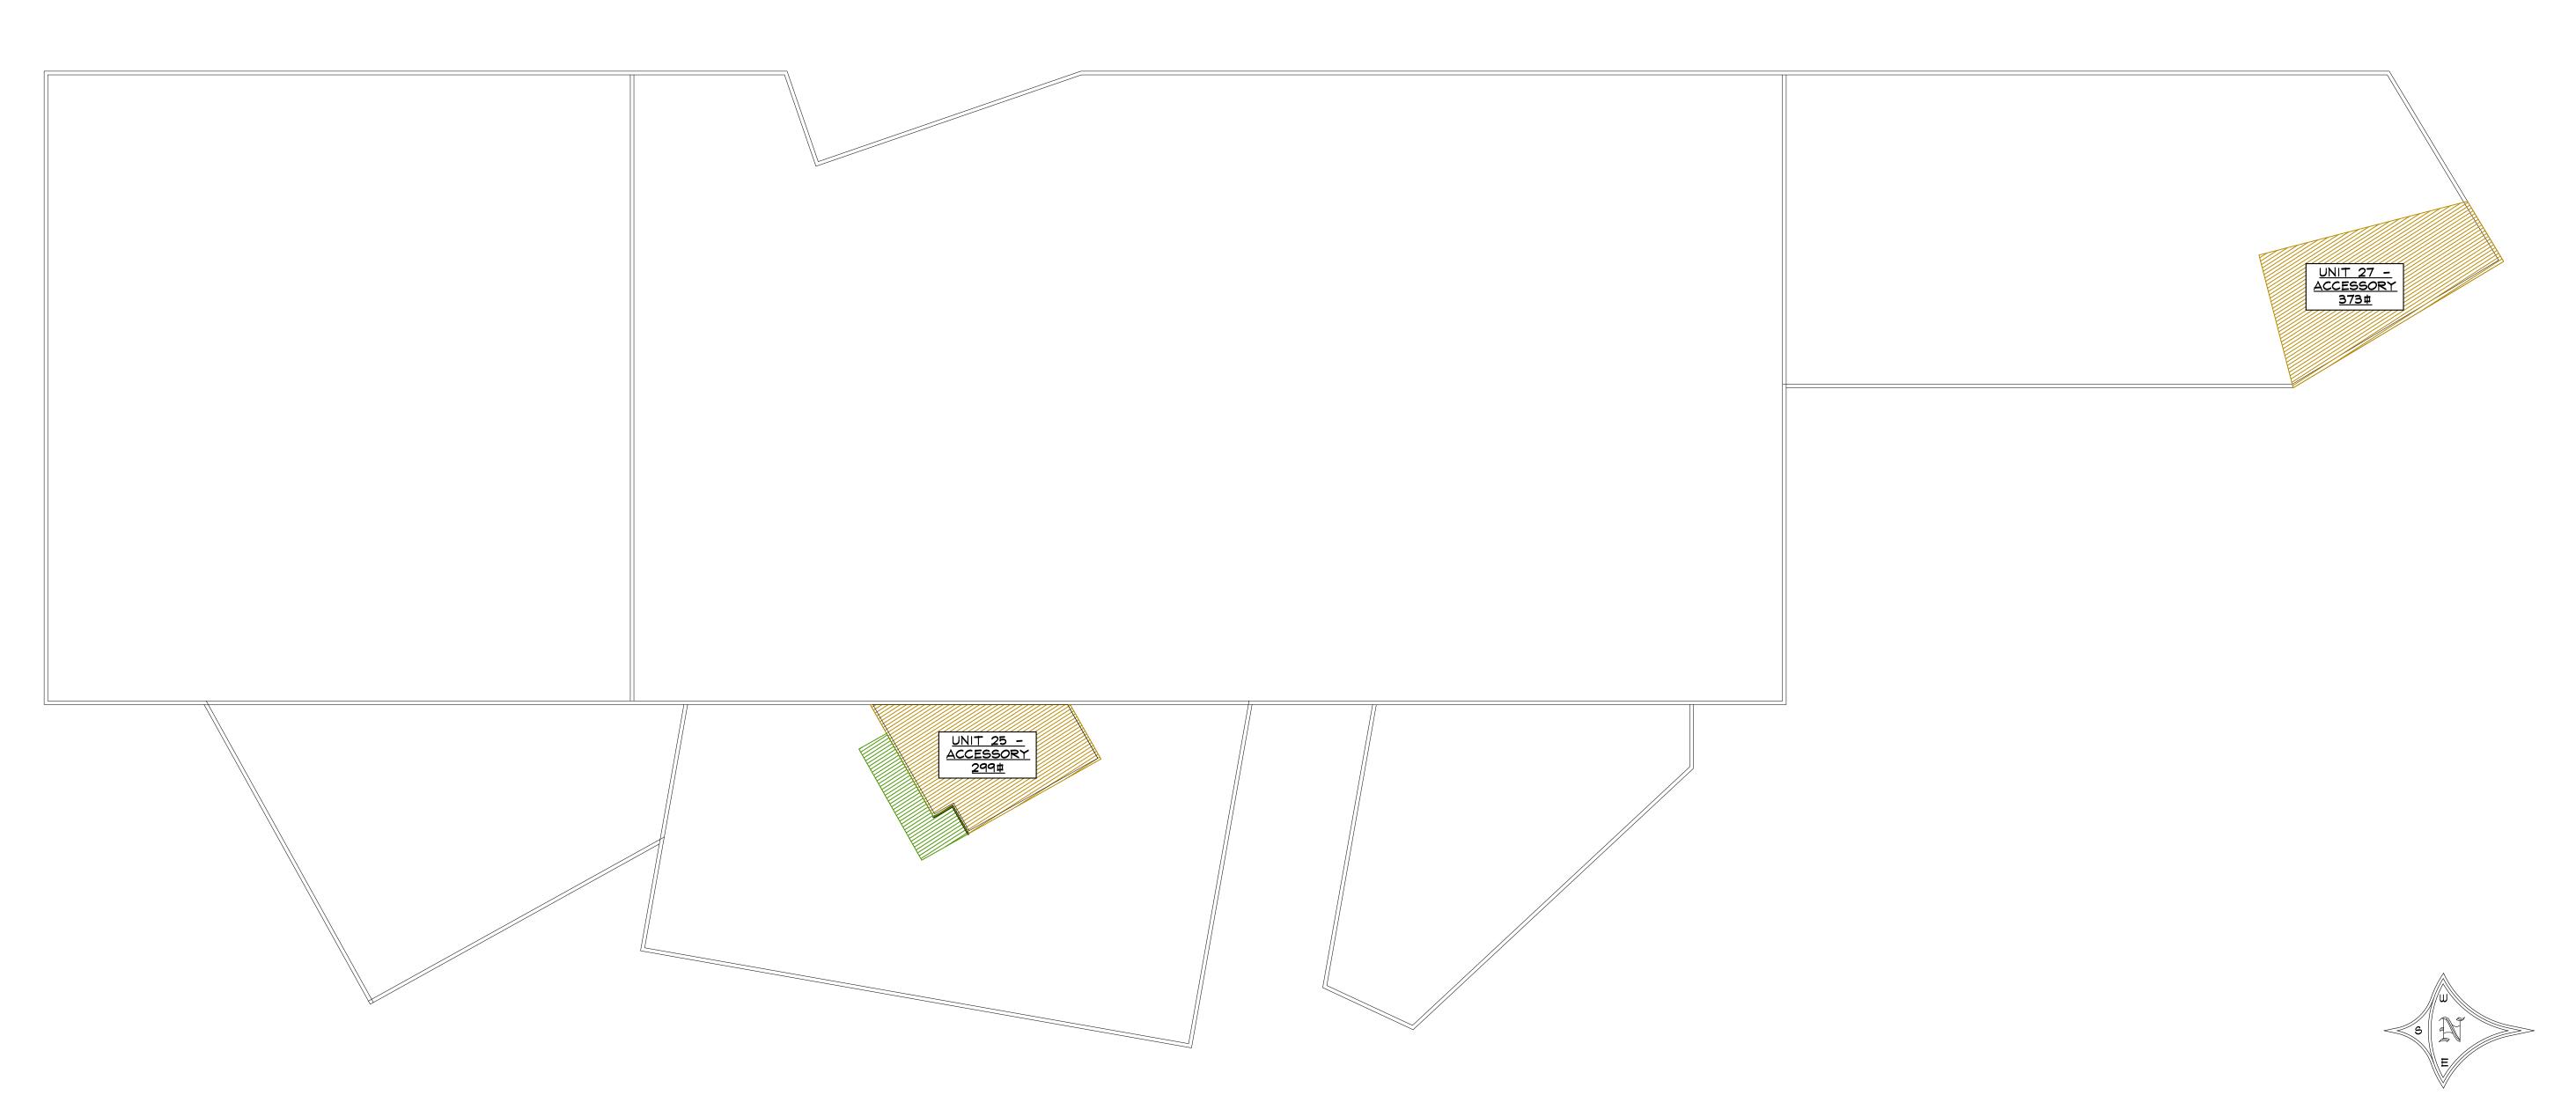

NOT FOR CONSTRUCTION




02 . 08 . 24 REVIEW DP

DRAWN BY: RPM REVIEWED BY: CWM PROJECT # 21099 OVERALL BUILDING 1 3RD LEVEL FLOOR PLAN

PLAN

OVERALL BUILDING 3RD LEVEL FLOOR PLAN - USE SHADING

SCALE: N.T.S.

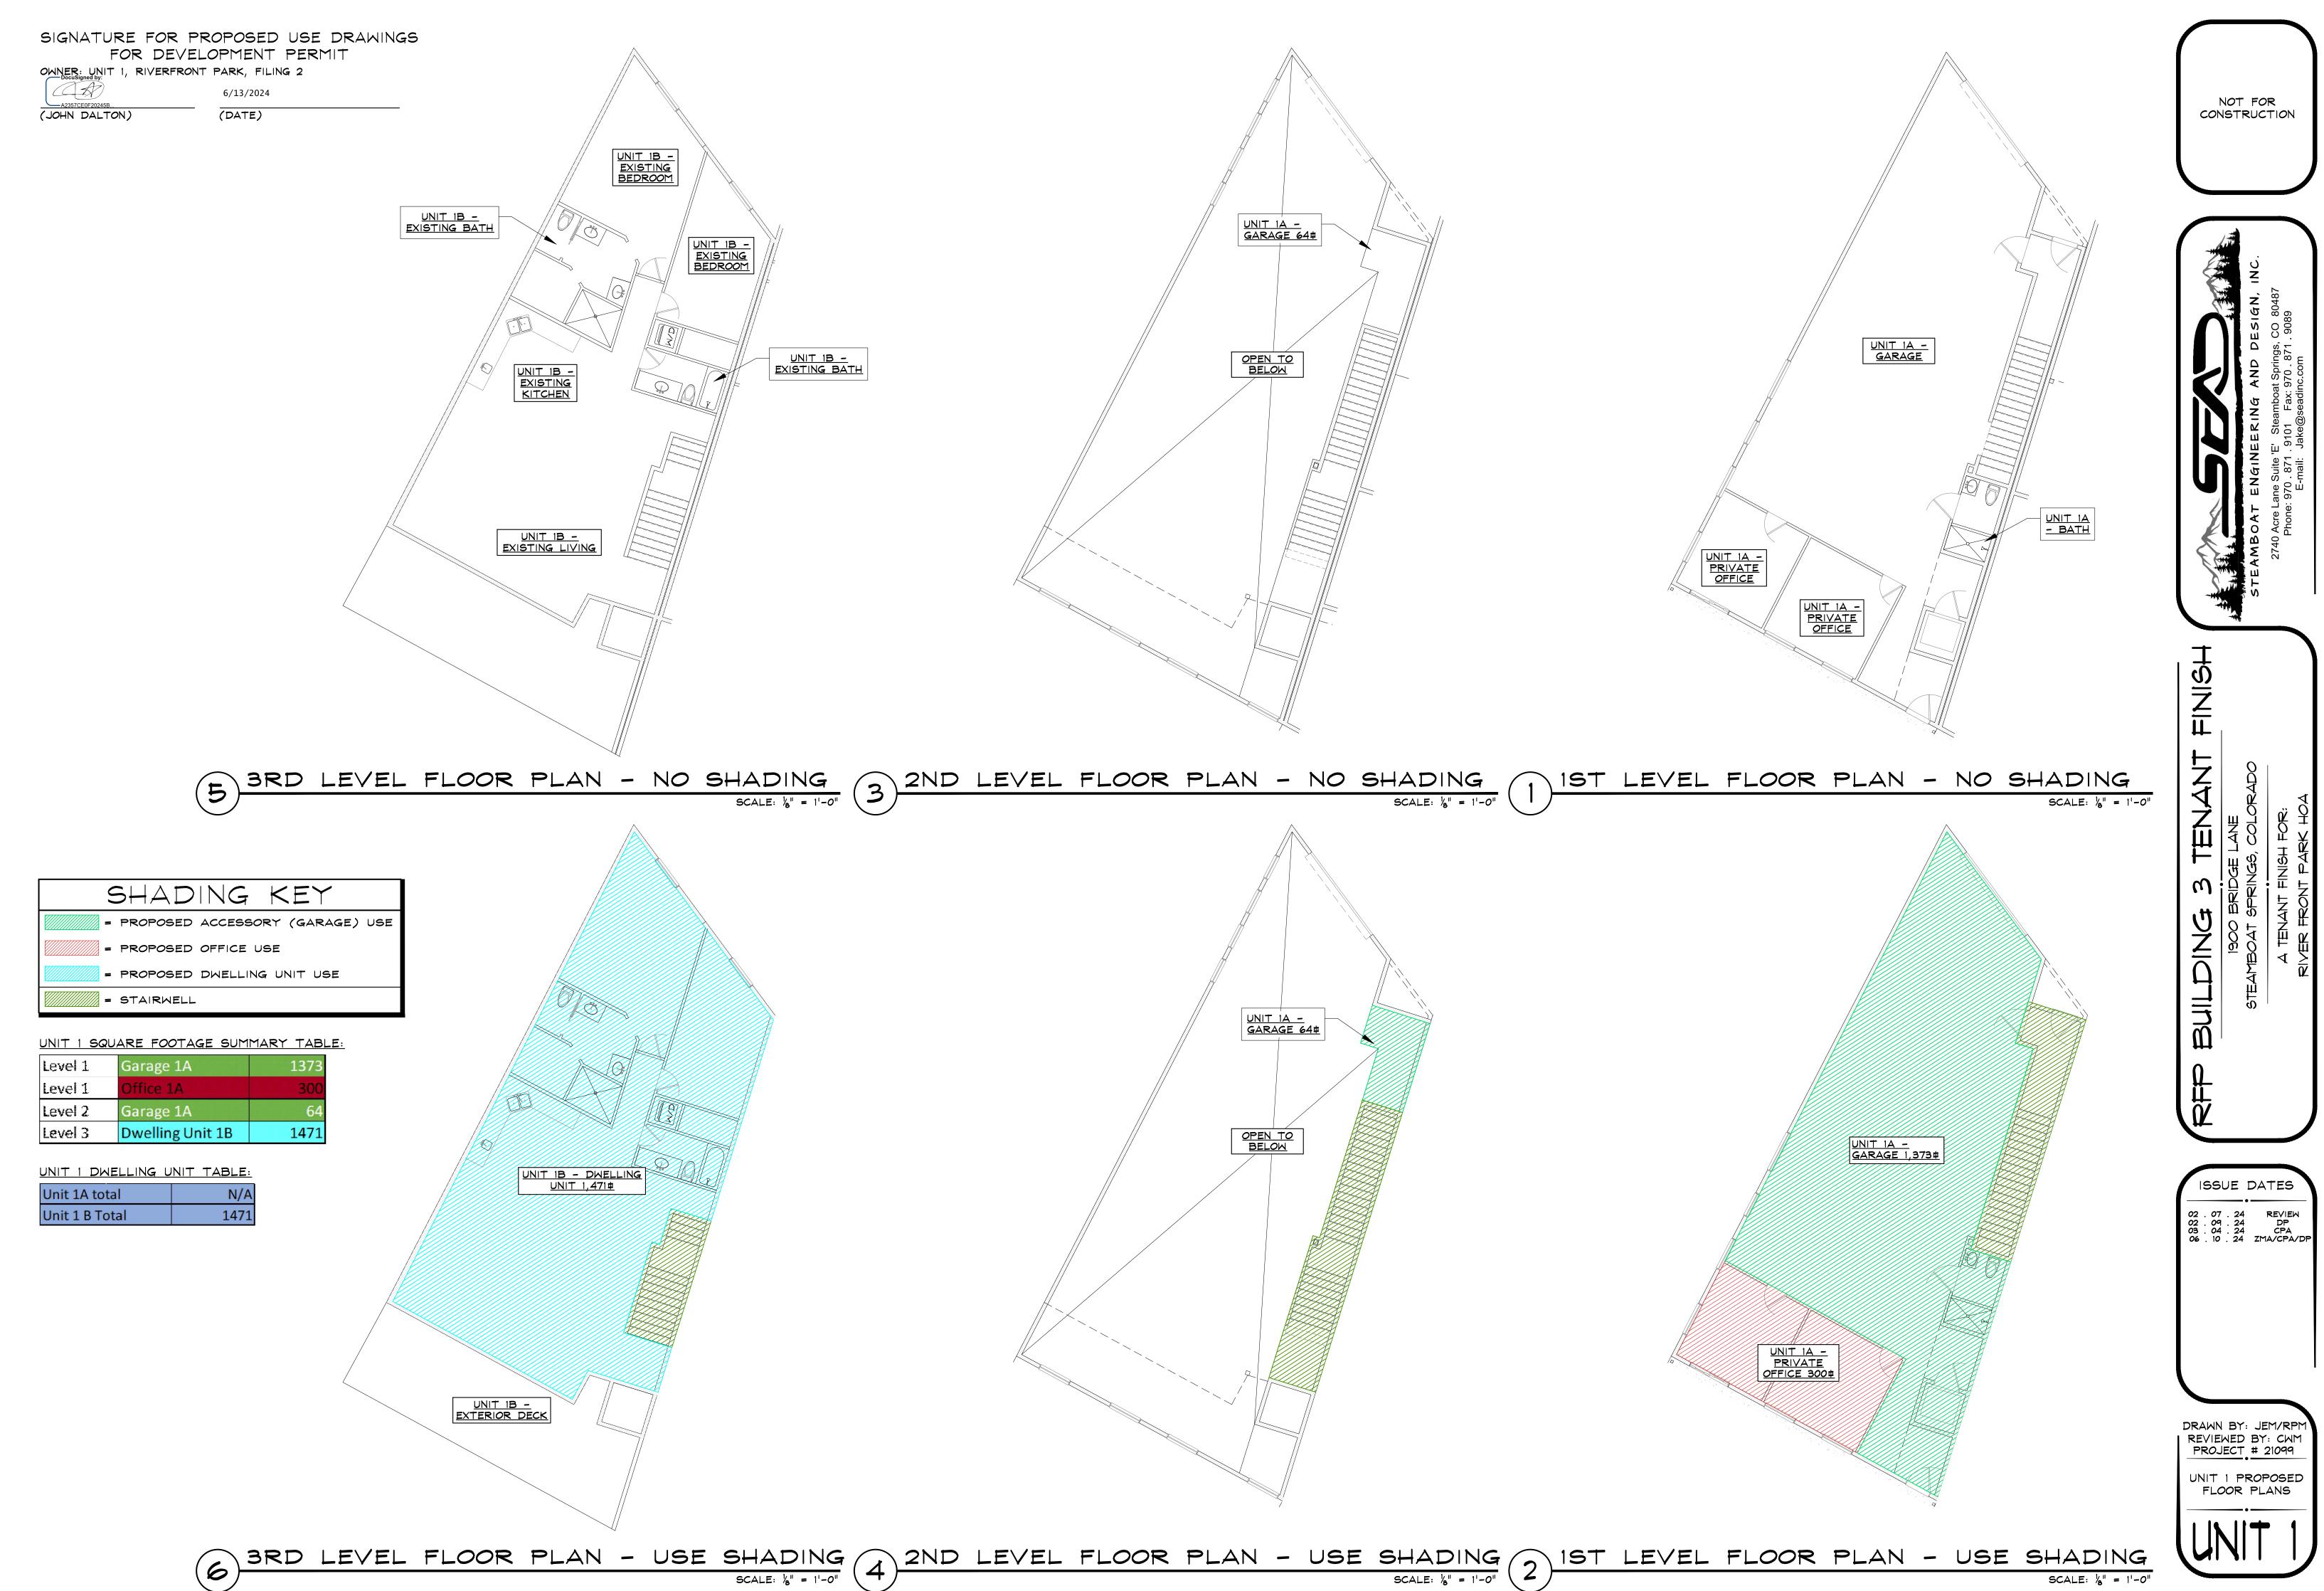

Z:\2021\21099_RFP Tenant Finish\Drawings\Building 3\21099_ArchSheets3_Building3.dwg, 6/10/2024 12:05:48 PM


SIGNATURE FOR PROPOSED USE DRAWINGS OWNER: UNIT 2, RIVERFRONT PARK, FILING 2


RIVERPRONTY PROPERTIES, LLC


BY! Scott Budder (SIGNATURE)

Scott Buchler (PRINT NAME)

DATE:_____

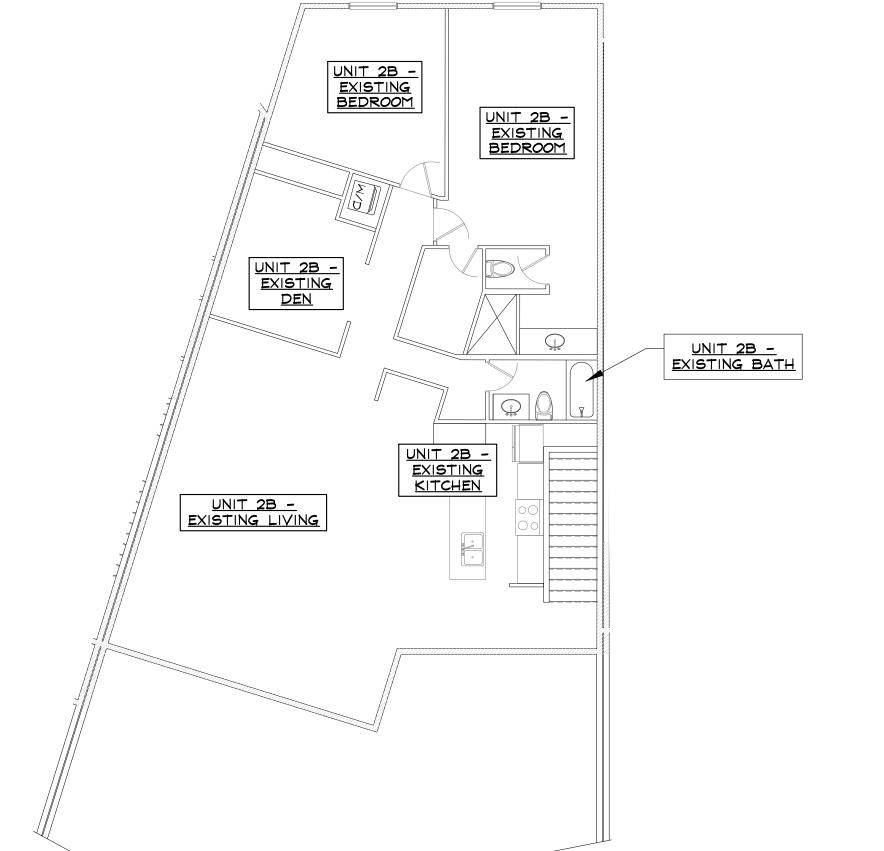

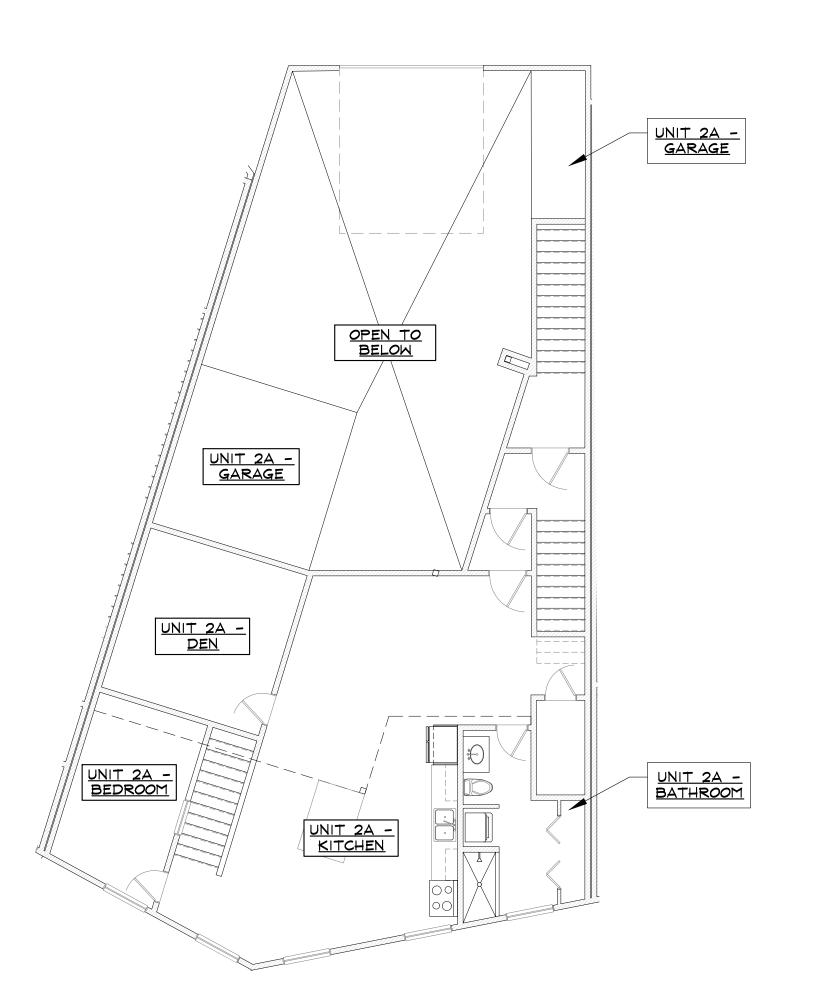

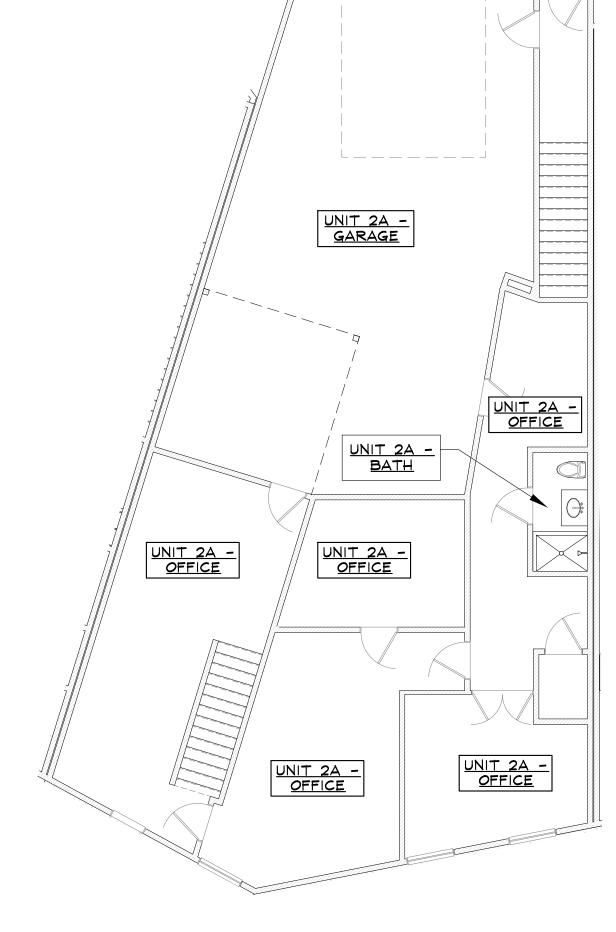

3 2ND LEVEL FLOOR PLAN - NO SHADING 5 3RD LEVEL FLOOR PLAN - NO SHADING

SCALE: 1/8" = 1'-0" 1ST LEVEL FLOOR PLAN - NO SHADING


SHADING KEY = PROPOSED ACCESSORY (GARAGE) USE = PROPOSED OFFICE USE = PROPOSED DWELLING UNIT USE = STAIRWELL


UNIT 2 SQUARE FOOTAGE SUMMARY TABLE:


| Level 1 | Garage 2A | 1010 |
|---------|------------------|------|
| Level 1 | Office 2A | 1429 |
| Level 2 | Garage 2A | 253 |
| Level 2 | Dwelling Unit 2A | 1251 |
| Level 3 | Dwelling Unit 2B | 1793 |

UNIT 2 DWELLING UNIT TABLE:

| Unit 2A Garage | 1263 |
|------------------|------|
| Unit 2A Dwelling | 1251 |
| Unit 2 A Total | 2514 |
| Unit 2B Total | 1793 |

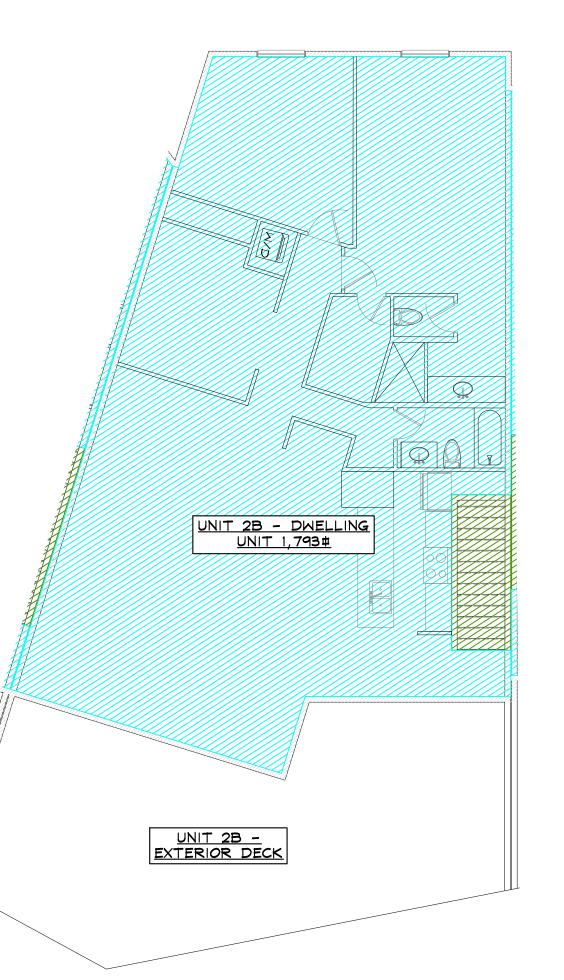

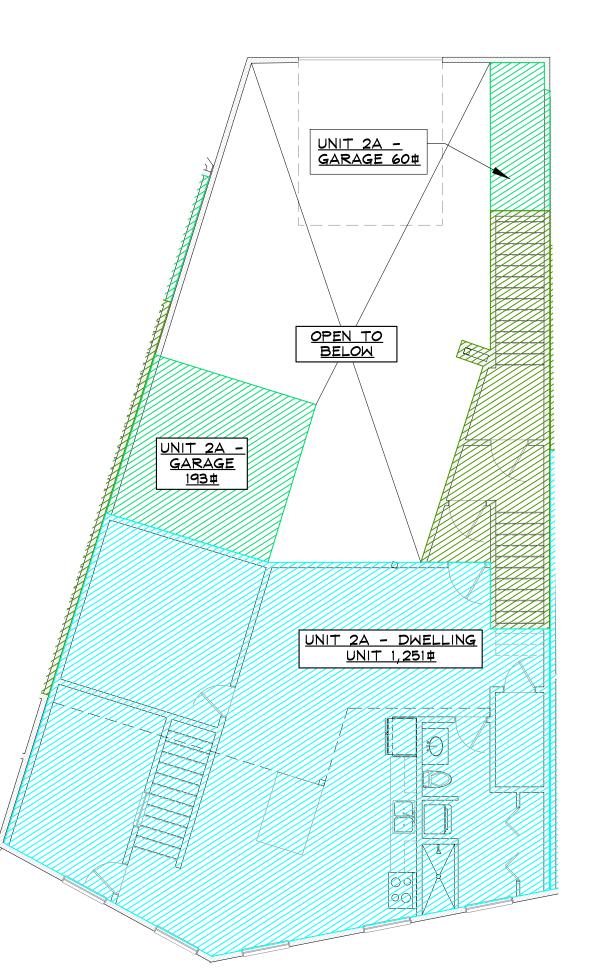


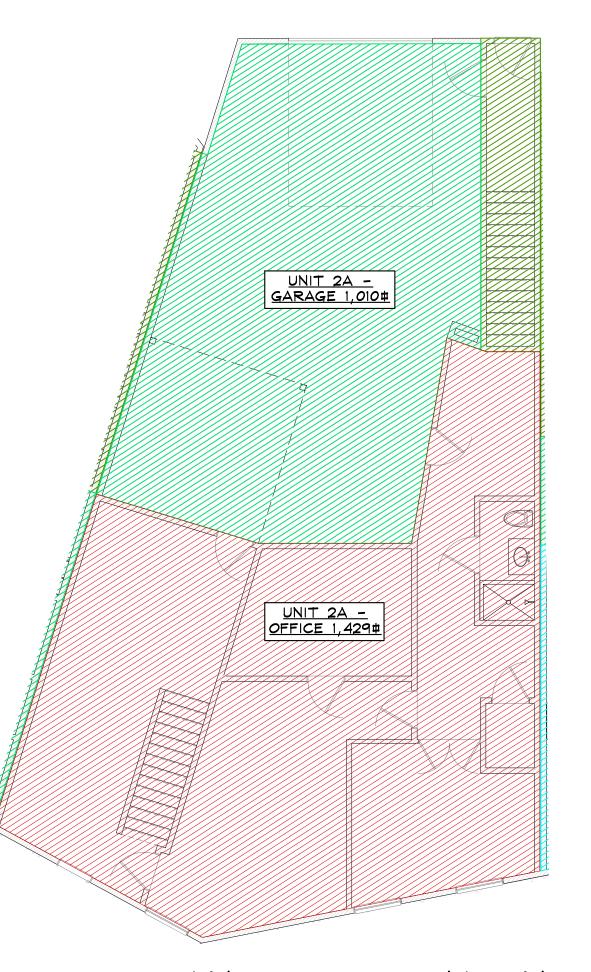


3RD LEVEL FLOOR PLAN - USE SHADING (4) 2ND LEVEL FLOOR PLAN - USE SHADING SCALE: 1/8" = 1'-0" (4) 2ND LEVEL FLOOR PLAN - USE SHADING SCALE: 1/8" = 1'-0"

SCALE: 1 = 1-0

NOT FOR CONSTRUCTION

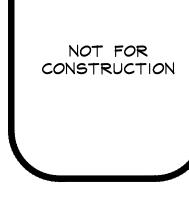

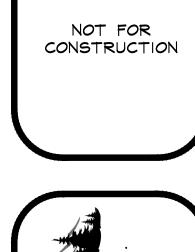

02 . 07 . 24 REVIEW 02 . 09 . 24 DP 03 . 04 . 24 CPA 06 . 10 . 24 ZMA/CPA/DP

DRAWN BY: JEM/RPM REVIEWED BY: CWM PROJECT # 21099 UNIT 2 PROPOSED FLOOR PLANS (SIGNATURE)


ITS: Managing Member


SIGNATURE FOR PROPOSED USE DRAWINGS FOR DEVELOPMENT PERMIT OWNER: UNIT 3, RIVERFRONT PARK, FILING 2


NS INVESTIMENTS, LLC Stephanie Yarbrough

Stephanie Yarbrough

(PRINT NAME) 6/12/2024 DATE:__

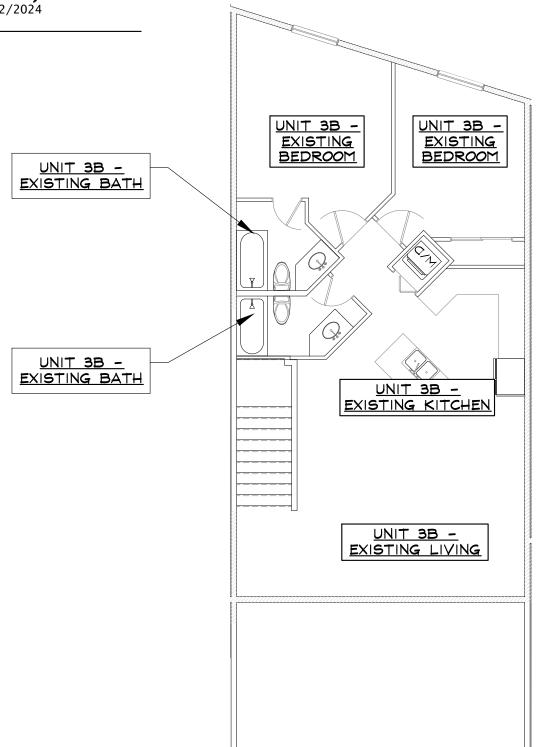

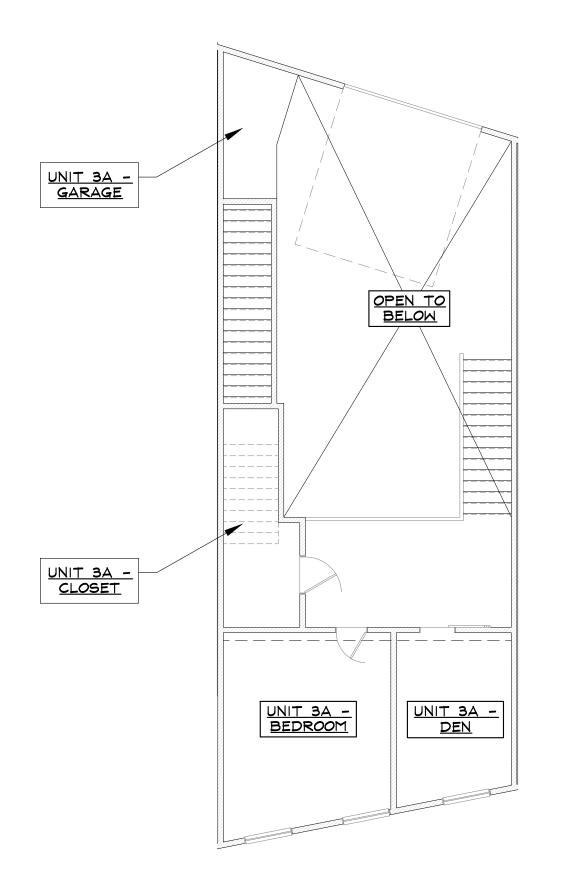

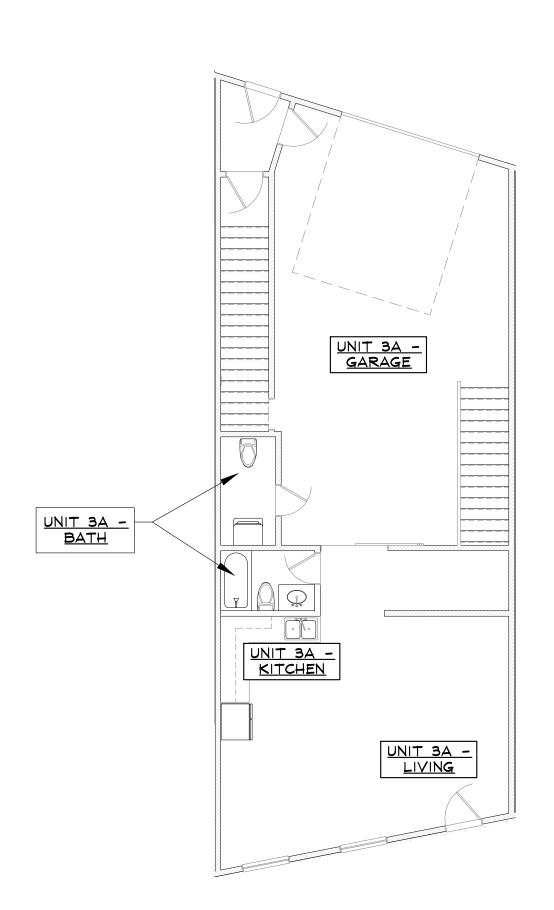


3 2ND LEVEL FLOOR PLAN - NO SHADING SCALE: 1/8" = 1'-0" 5 3RD LEVEL FLOOR PLAN - NO SHADING


SCALE: 1/8" = 1'-0" 1ST LEVEL FLOOR PLAN - NO SHADING SCALE: %" = 1'-0"


SHADING KEY = PROPOSED ACCESSORY (GARAGE) USE = PROPOSED OFFICE USE = PROPOSED DWELLING UNIT USE = STAIRWELL

| UNIT 3 SQUARE FOOTAGE SUMMARY TABLE: | | | |
|--------------------------------------|------------------|------|--|
| Level 1 | Garage 3A | 725 | |
| Level 1 | Dwelling Unit 3A | 616 | |
| Level 2 | Garage 3A | 57 | |
| Level 2 | Dwelling Unit 3A | 668 | |
| Level 3 | Dwelling Unit 3B | 1045 | |

| UNIT 3 DWELLING UN | IT TABLE: |
|--------------------|-----------|
| Unit 3A Garage | 782 |
| Unit 3A Dwelling | 1284 |
| Unit 3A Total | 2066 |
| Unit 2R Total | 10/15 |

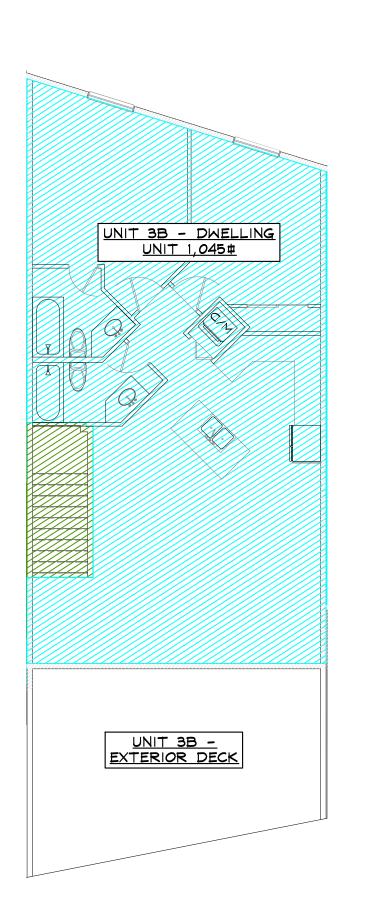

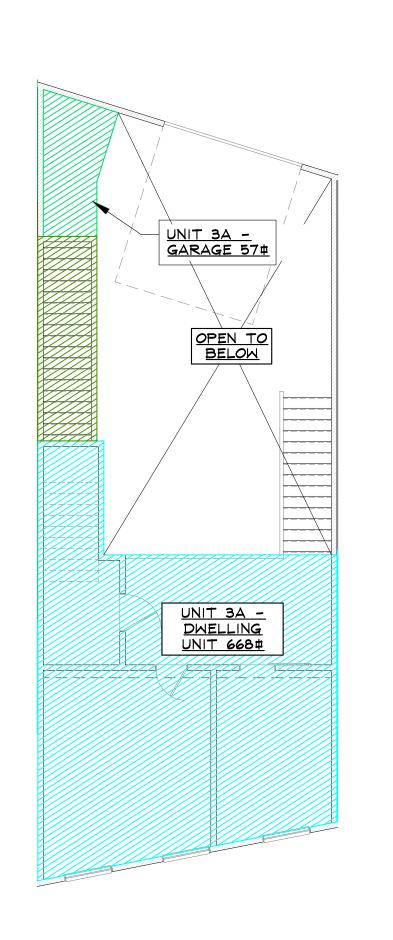

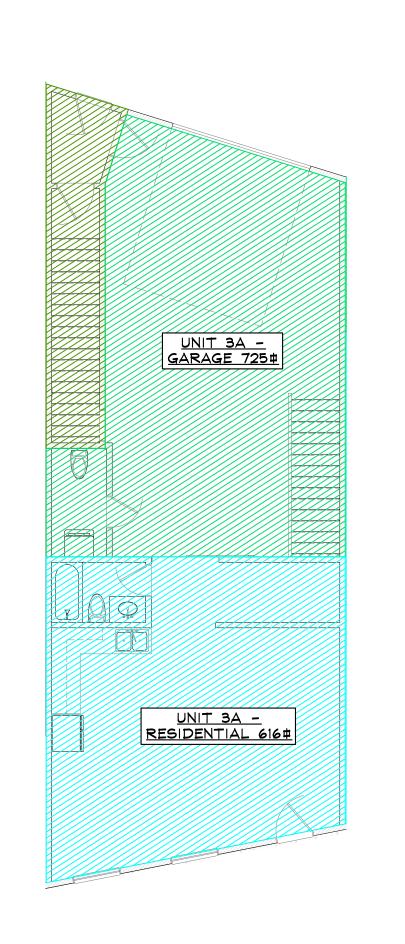



NOT FOR CONSTRUCTION

02 . 07 . 24 REVIEW 02 . 09 . 24 DP 03 . 04 . 24 CPA 06 . 10 . 24 ZMA/CPA/DP


DRAWN BY: JEM/RPM REVIEWED BY: CWM PROJECT # 21099


UNIT 3 PROPOSED FLOOR PLANS


3RD LEVEL FLOOR PLAN - USE SHADING
SCALE: 1/3 = 1/3 2ND LEVEL FLOOR PLAN - USE SHADING
SCALE: 1/3 = 1/3 0 SCALE: 1

ONNERISHEUNIT 4, RIVERFRONT PARK, FILING 2 6/14/2024

(DATE) 6/14/2024 (HEATHER 29LYNN BERTINI) (DATE)

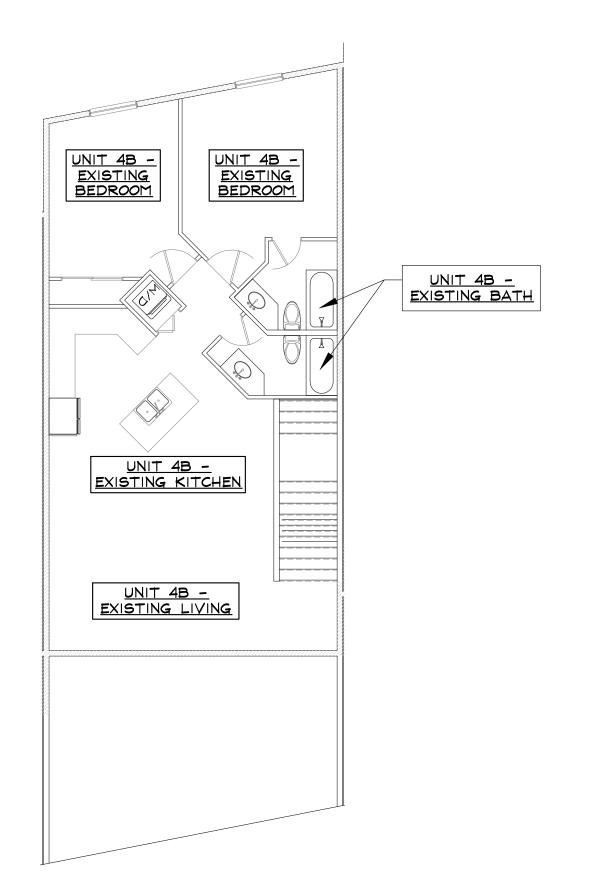

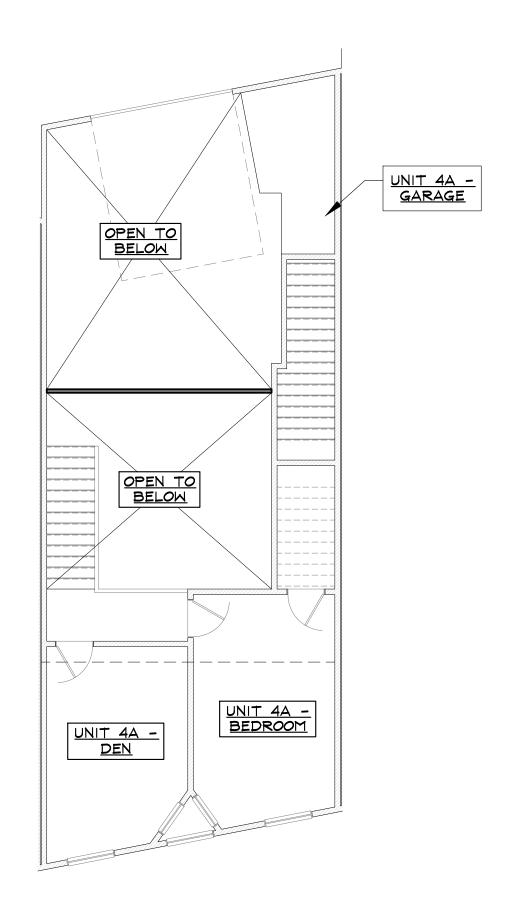

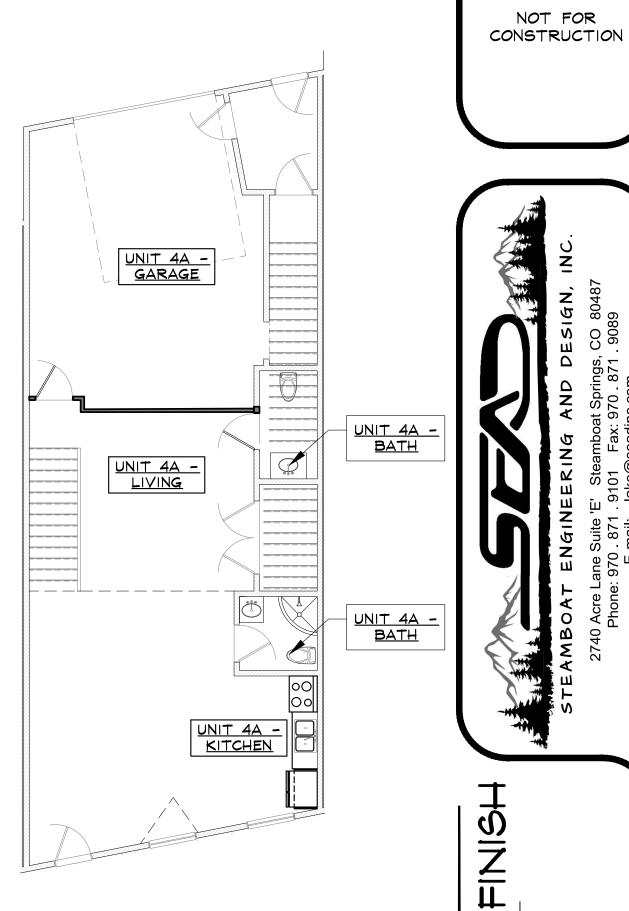

NOT FOR

3 2ND LEVEL FLOOR PLAN - NO SHADING SCALE: 1/9 = 1/-0" 5 3RD LEVEL FLOOR PLAN - NO SHADING


SCALE: 1/8" = 1'-0" 1ST LEVEL FLOOR PLAN - NO SHADING SCALE: $\frac{1}{8}$ = 1'-0"


SHADING KEY = PROPOSED ACCESSORY (GARAGE) USE = PROPOSED OFFICE USE = PROPOSED DWELLING UNIT USE = STAIRWELL


UNIT 4 SQUARE FOOTAGE SUMMARY TABLE:


| Levei 1 | Garage 4A | 482 |
|------------------|------------------|------|
| ievell | Dwelling Unit 4A | 906 |
| Level 2 | Garage 4A | 157 |
| čev e ! 2 | Dwelling Unit 4A | 494 |
| tevet3 | Dwelling Unit 4B | 1060 |

UNIT 4 DWELLING UNIT TABLE: Init 4A Garage Jnit 4A Dwelling 2039 Unit 4A Total Unit 4B Total

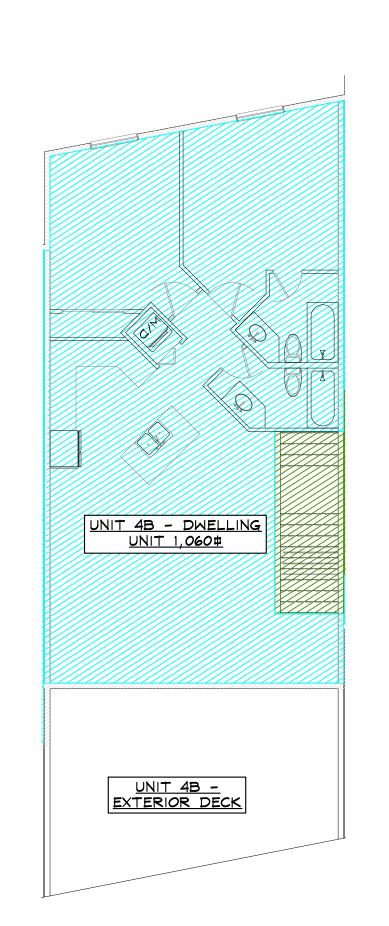

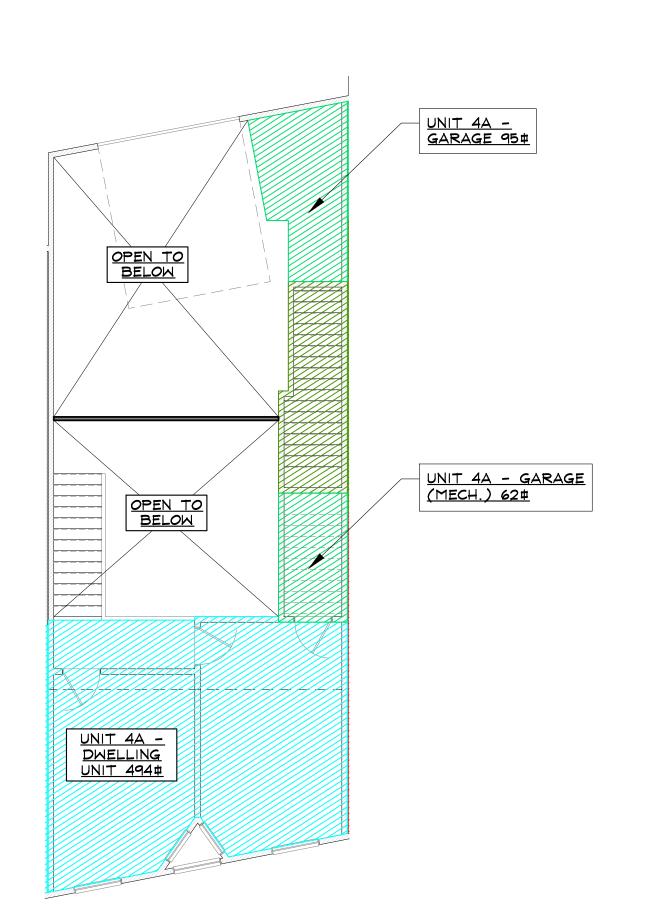

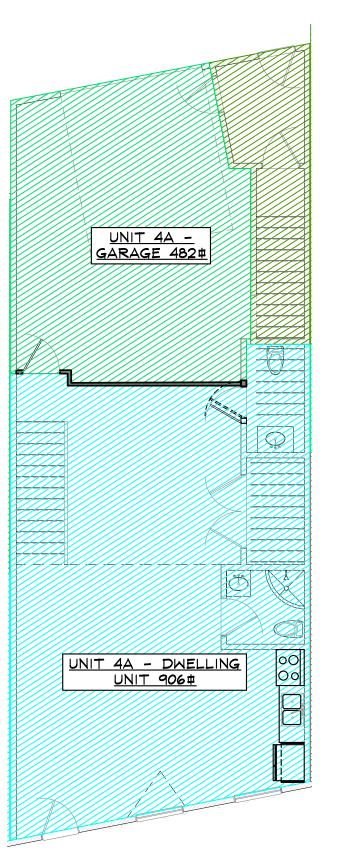

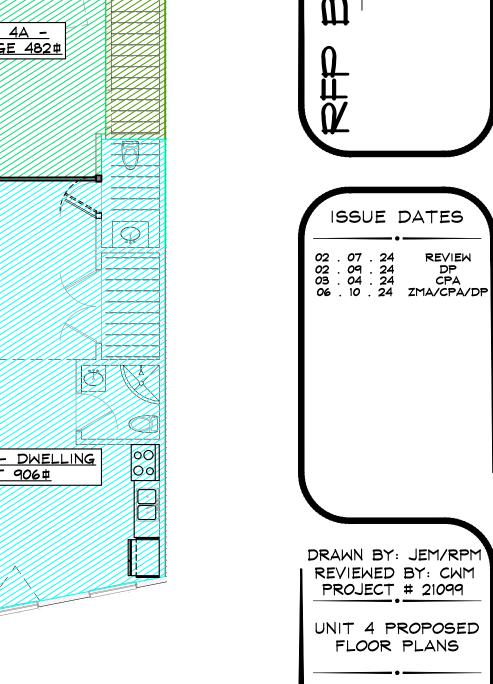

OWNER: UNIT 5, RIVERFRONT PARK, FILING 2


FW PROPERTYES, LLC


Dianne Fox-Welch


(SIGNATURE)

(PRINT NAME)

6/14/2024 DATE:____

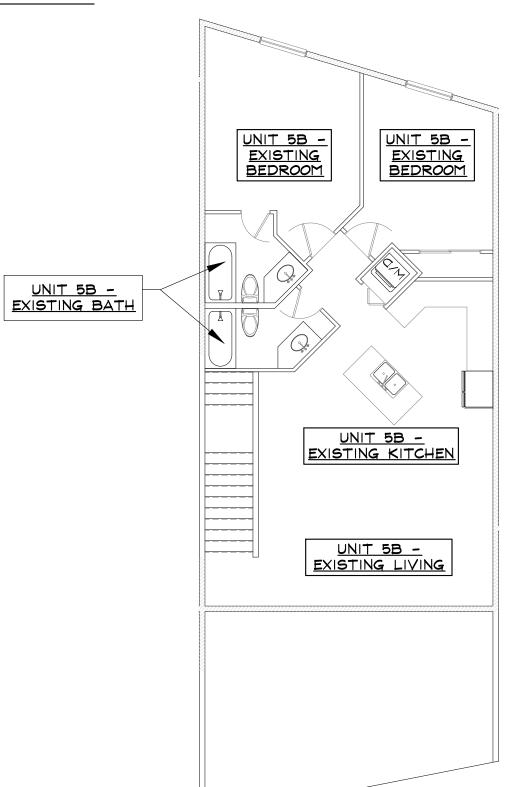

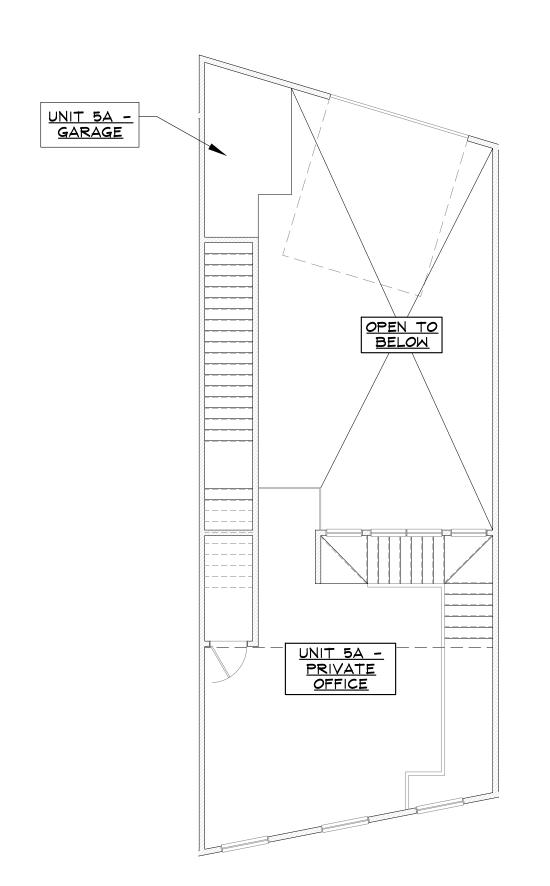

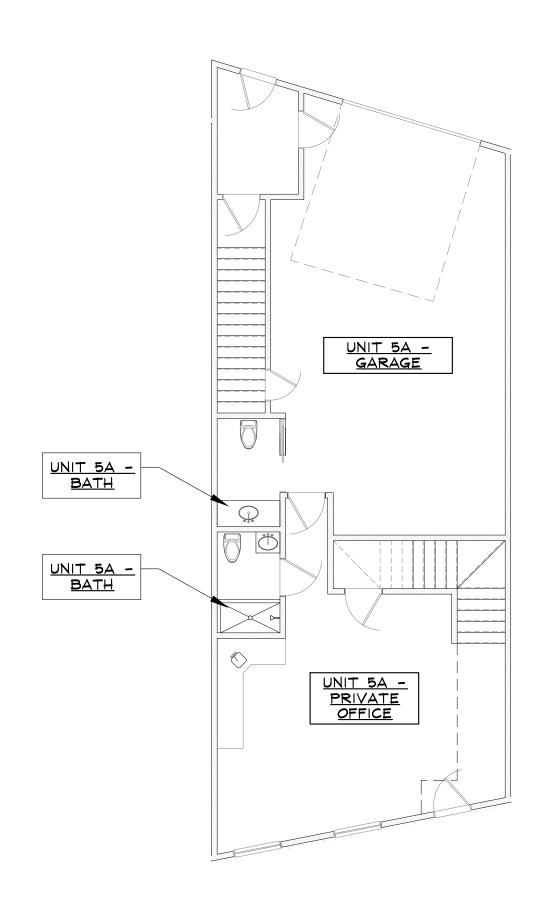

3 2ND LEVEL FLOOR PLAN - NO SHADING 5 3RD LEVEL FLOOR PLAN - NO SHADING

SCALE: 1/8" = 1'-0" 1ST LEVEL FLOOR PLAN - NO SHADING SCALE: %" = 1'-0"


SHADING KEY = PROPOSED ACCESSORY (GARAGE) USE = PROPOSED OFFICE USE = PROPOSED DWELLING UNIT USE = STAIRWELL


| UNIT 5 SQUARE FOOTAGE SUMMARY TABLE: | | |
|--------------------------------------|------------------|------|
| Level 1 | Garage 5A | 696 |
| Level 1 | Office 5A | 624 |
| Level 2 | Garage 5A | 93 |
| Level 2 | Office 5A | 466 |
| Level 3 | Dwelling Unit 5B | 1036 |


1036


UNIT 5 DWELLING UNIT TABLE: **Unit 5A Total**

Unit 5B Total

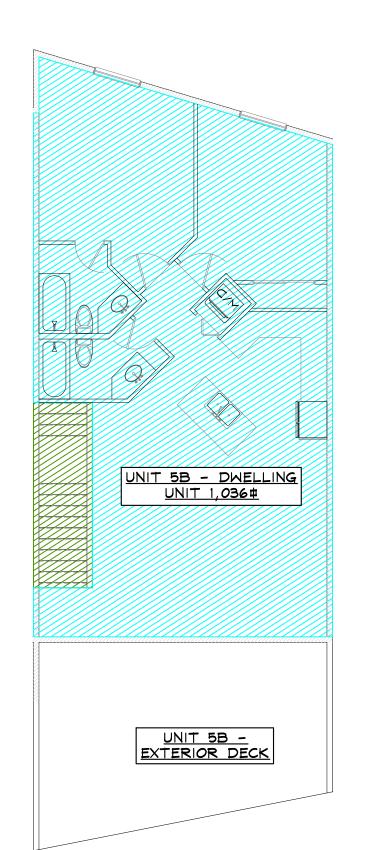

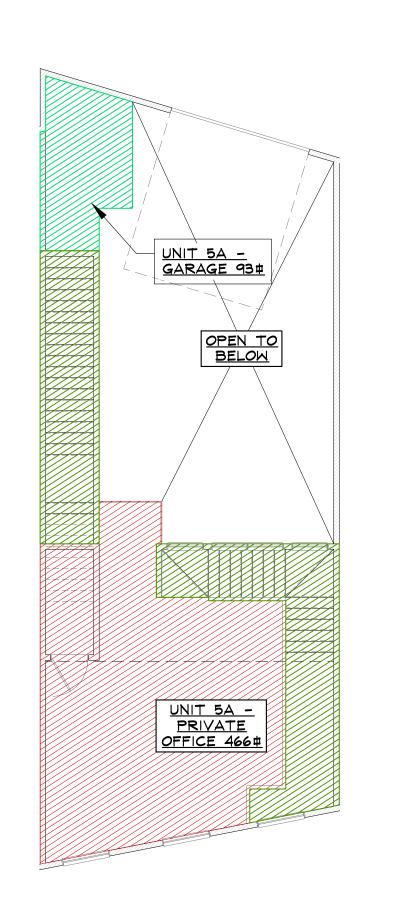

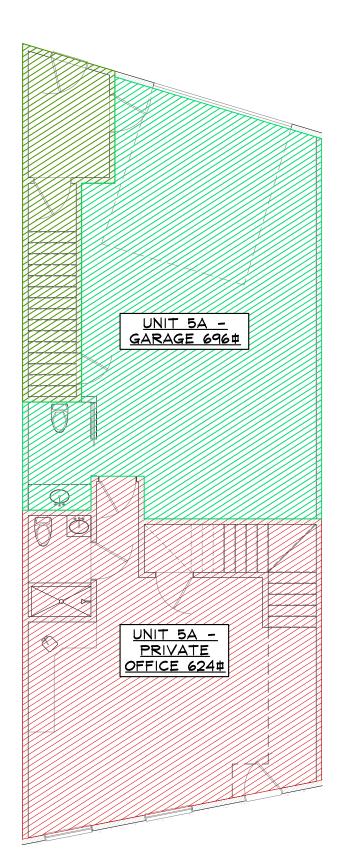

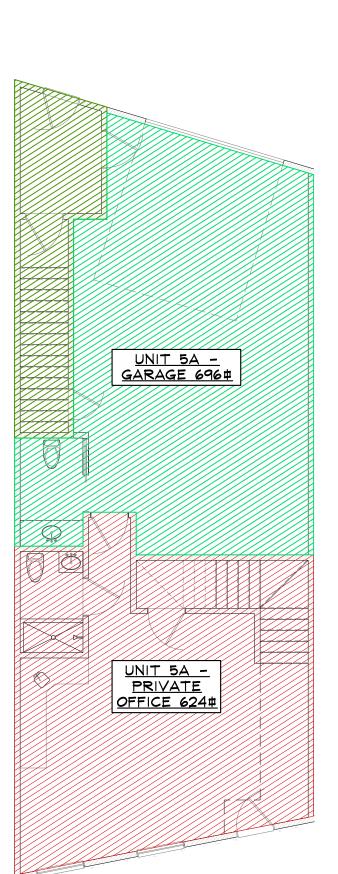

NOT FOR

CONSTRUCTION

02 . 07 . 24 REVIEW 02 . 09 . 24 DP 03 . 04 . 24 CPA 06 . 10 . 24 ZMA/CPA/DP DRAWN BY: JEM/RPM REVIEWED BY: CWM PROJECT # 21099 UNIT 5 PROPOSED FLOOR PLANS

3RD LEVEL FLOOR PLAN - USE SHADING
SCALE: 1/3 = 1/-0"


3RD LEVEL FLOOR PLAN - USE SHADING
SCALE: 1/3 = 1/-0"


SCALE: 1/3 = 1/-0"


SCALE: 1/3 = 1/-0"

OMN原原ed WNIT 6, RIVERFRONT PARK, FILING 2 (DATE) 6/14/2024

(AUDRET BY KLAWITER) (DATE) (CAMERON KLAWITER)

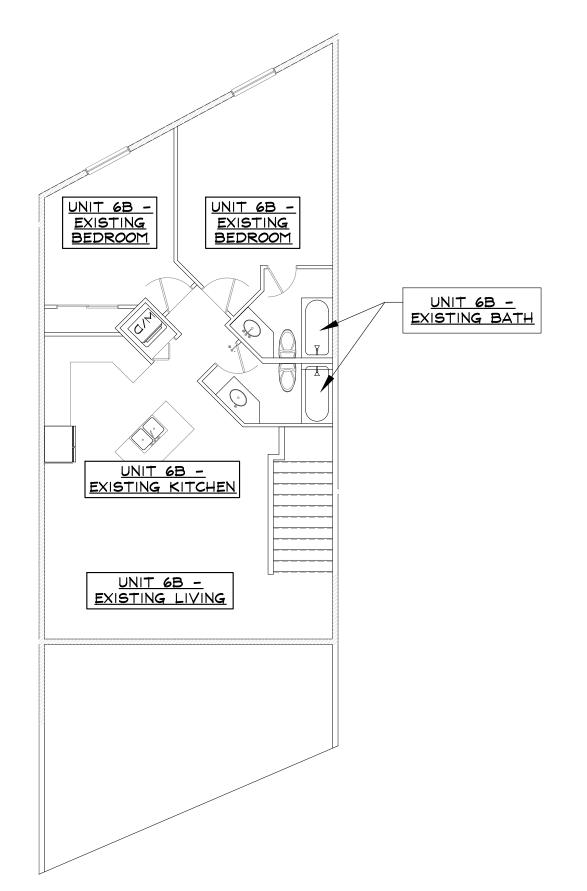

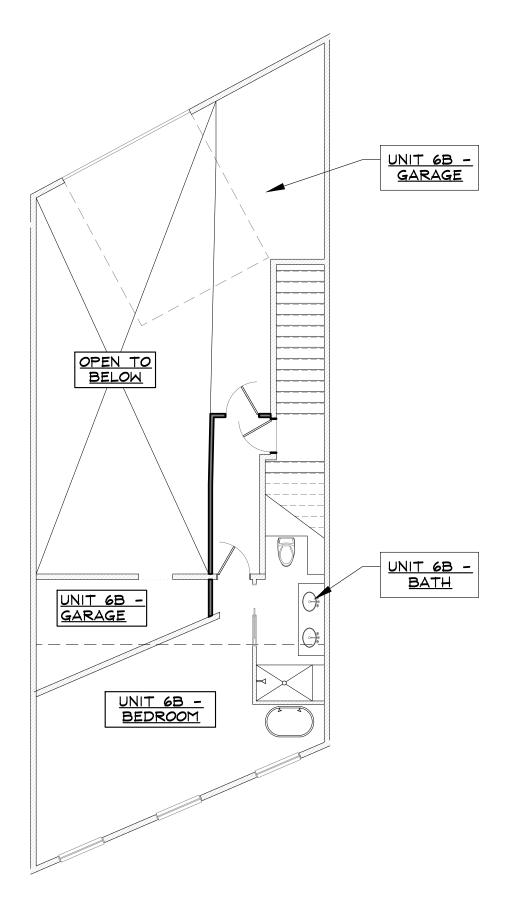

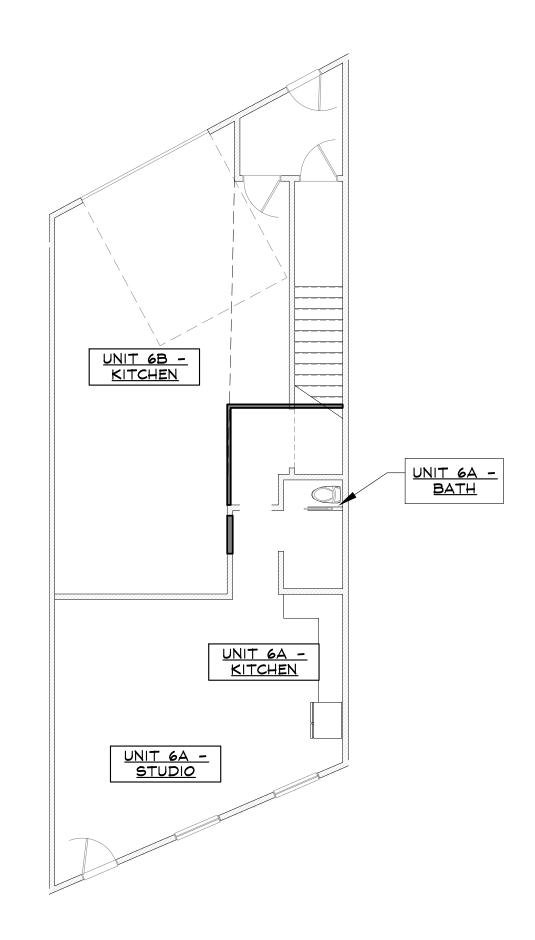

3 2ND LEVEL FLOOR PLAN - NO SHADING

SCALE: 1/8" = 1'-0" SCALE: 1/-0" 1ST LEVEL FLOOR PLAN - NO SHADING SCALE: 1/8" = 1'-0"


SHADING KEY = PROPOSED ACCESSORY (GARAGE) USE = PROPOSED OFFICE USE = PROPOSED DWELLING UNIT USE = STAIRWELL


UNIT 6 SQUARE FOOTAGE SUMMARY TABLE:


| Level 1 | Garage 6B | 620 |
|---------|------------------|------|
| Level 1 | Dwelling Unit 6A | 634 |
| Level 2 | Garage 6B | 325 |
| Level 2 | Dwelling Unit 6B | 386 |
| Level 3 | Dwelling Unit 6B | 1006 |


UNIT 6 DWELLING UNIT TABLE:


| Unit 6A Total | 945 |
|------------------|------|
| Unit 6B Garage | 945 |
| Dwelling Unit 6B | 1392 |
| Unit 6B Total | 2337 |
| | · · |

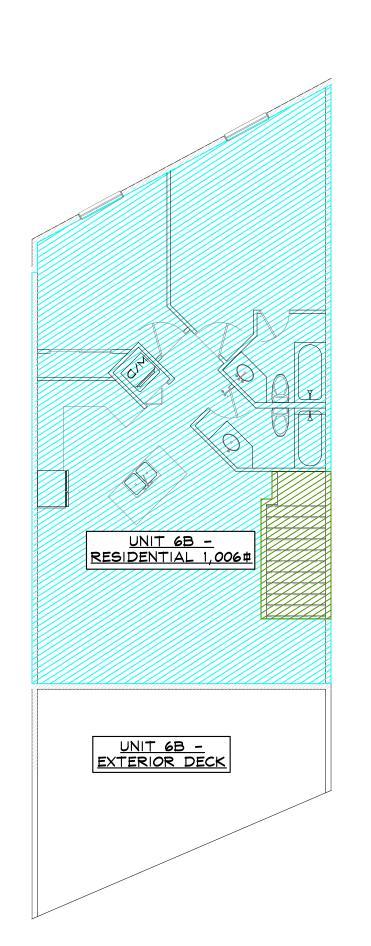

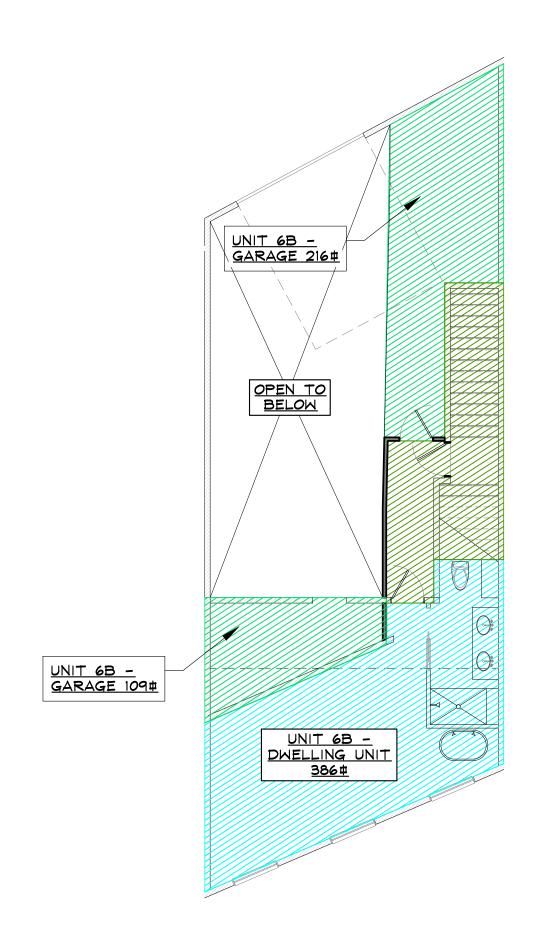

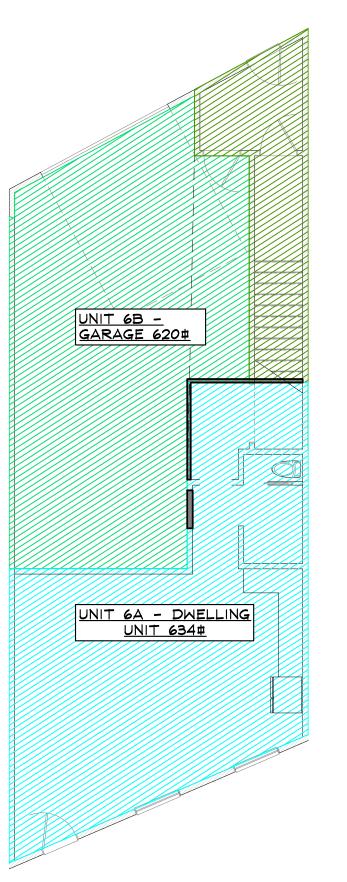

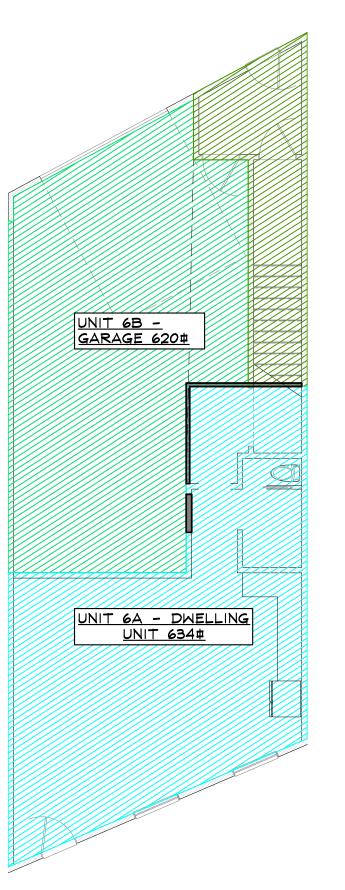

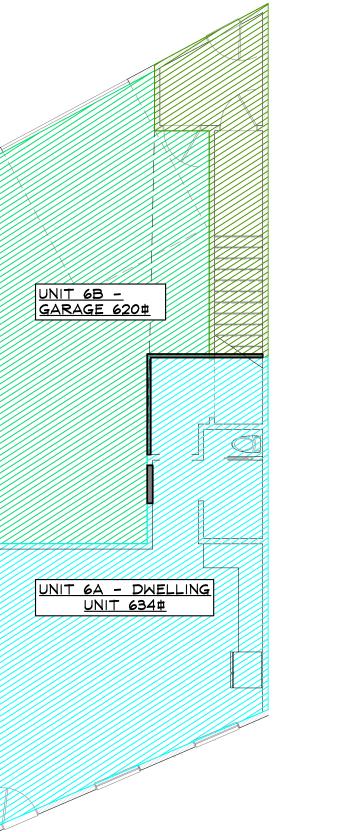



02 . 07 . 24 REVIEW 02 . 09 . 24 DP 03 . 04 . 24 CPA 06 . 10 . 24 ZMA/CPA/DP DRAWN BY: JEM/RPM REVIEWED BY: CWM PROJECT # 21099 UNIT 6 PROPOSED FLOOR PLANS


NOT FOR CONSTRUCTION

3RD LEVEL FLOOR PLAN - USE SHADING
SCALE: 1/5 = 1/50 4 2ND LEVEL FLOOR PLAN - USE SHADING
SCALE: 1/5 = 1/50 5CALE: 1/6 = 1/50 15T LEVEL FLOOR PLAN - USE SHADING
SCALE: 1/5 = 1/50 15T LEVEL FLOOR PLAN - USE SHADING

OWNER GOOD TO THE PARK, FILING 2 6/14/2024 (NICHOLAS SALTER) (DATE)

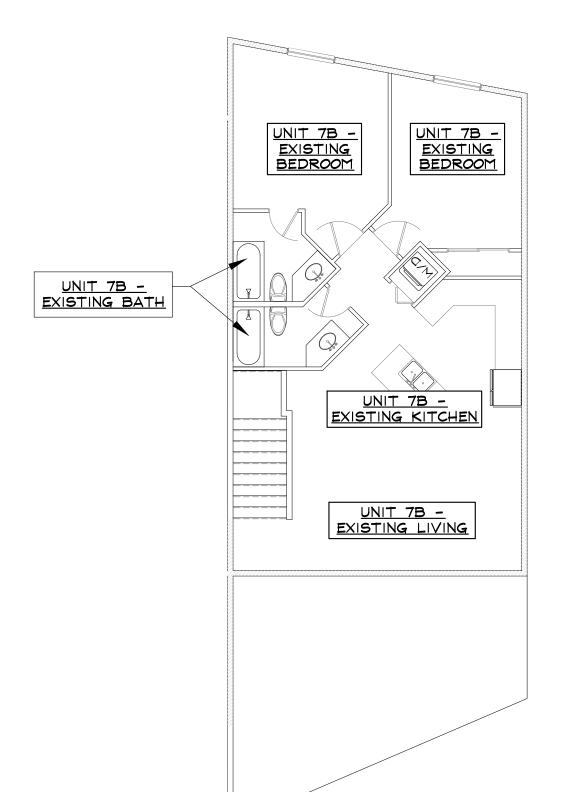

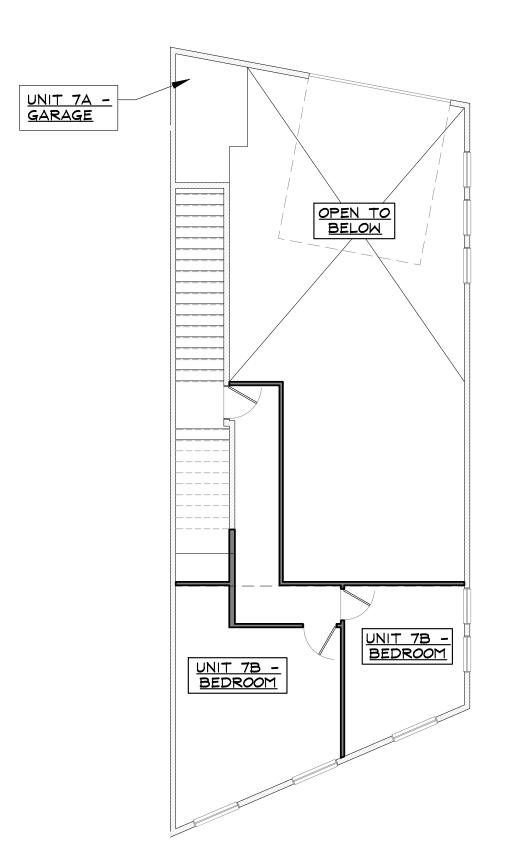

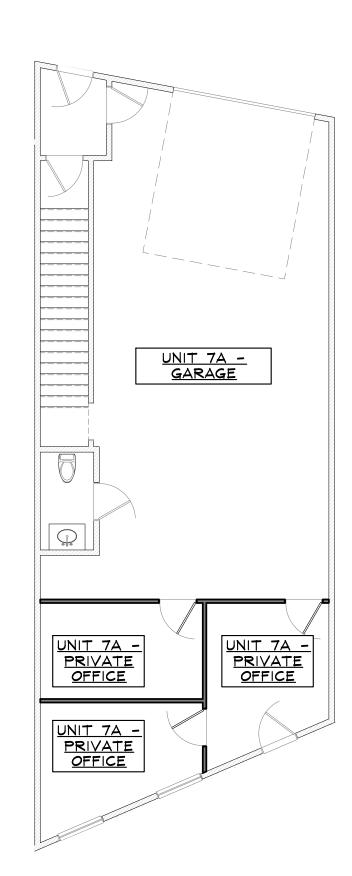

3 2ND LEVEL FLOOR PLAN - NO SHADING

SCALE: 1/8" = 1'-0" SCALE: 1/-0" 1ST LEVEL FLOOR PLAN - NO SHADING SCALE: 1/8" = 1'-0"


SHADING KEY = PROPOSED ACCESSORY (GARAGE) USE = PROPOSED OFFICE USE = PROPOSED DWELLING UNIT USE = STAIRWELL


UNIT 7 SQUARE FOOTAGE SUMMARY TABLE:


| Level 1 | Garage 7A | 865 |
|-----------------|------------------|-----|
| lev el 1 | Office 7A | 373 |
| Level 2 | Garage 7A | 58 |
| level 2 | Dwelling Unit 7B | 447 |
| Level3 | Dwelling Unit 7B | 953 |

UNIT 7 DWELLING UNIT TABLE:

| Unit 7A Total | N/A |
|---------------|------|
| Unit 7B Total | 1400 |

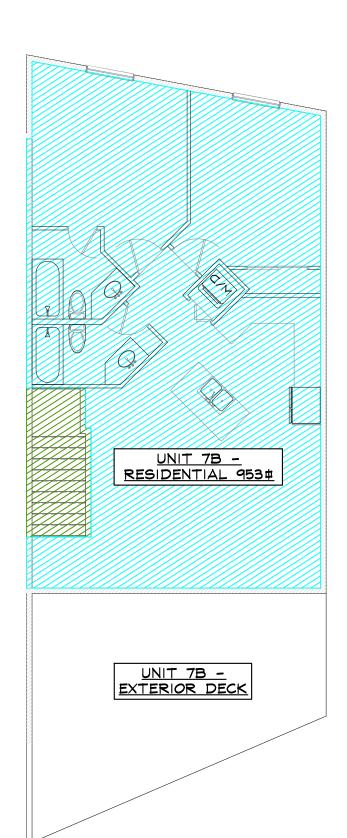

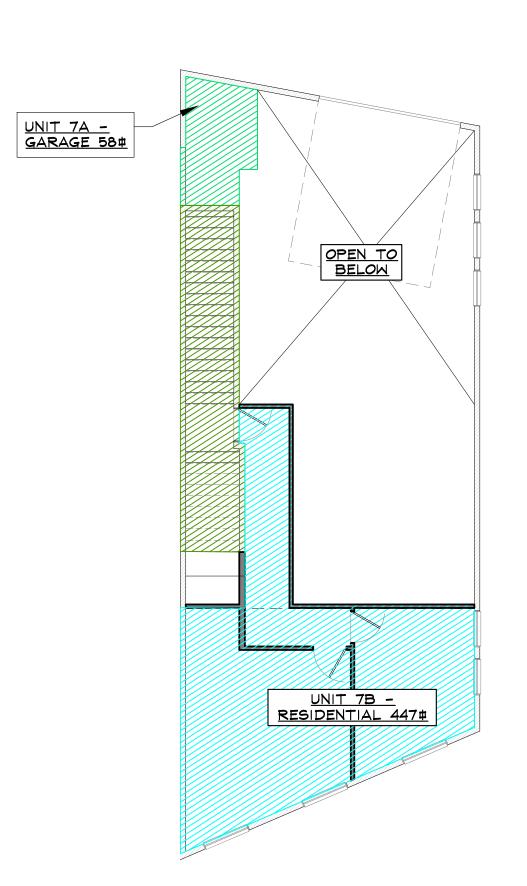

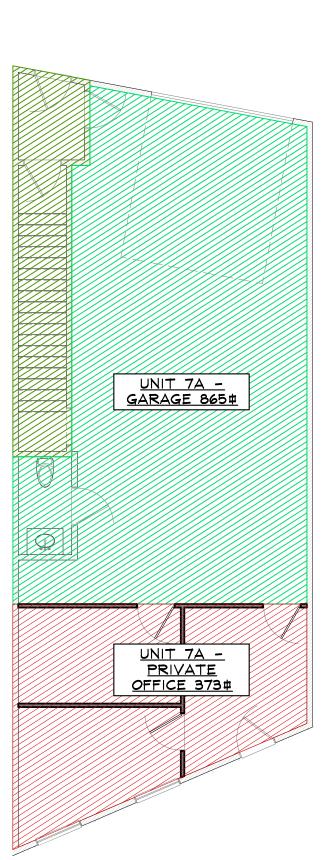

02 . 07 . 24 REVIEW 02 . 09 . 24 DP 03 . 04 . 24 CPA 06 . 10 . 24 ZMA/CPA/DP DRAWN BY: JEM/RPM REVIEWED BY: CWM PROJECT # 21099 UNIT 7 PROPOSED FLOOR PLANS


3RD LEVEL FLOOR PLAN - USE SHADING
SCALE: 1/3 = 1/-0"

3RD LEVEL FLOOR PLAN - USE SHADING
SCALE: 1/3 = 1/-0"

SCALE: 1/3 = 1/-0"


SCALE: 1/4 = 1/-0"


NOT FOR CONSTRUCTION

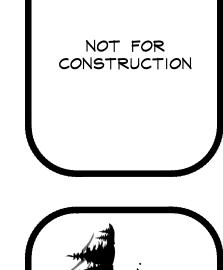


OWNER: UNIT 8, RIVERFRONT PARK, FILING 1 LOWRY CAPITAL, LLC

1 theresa lowry (SIGNATURE) (PRINT NAME) DATE: 6/14/2024

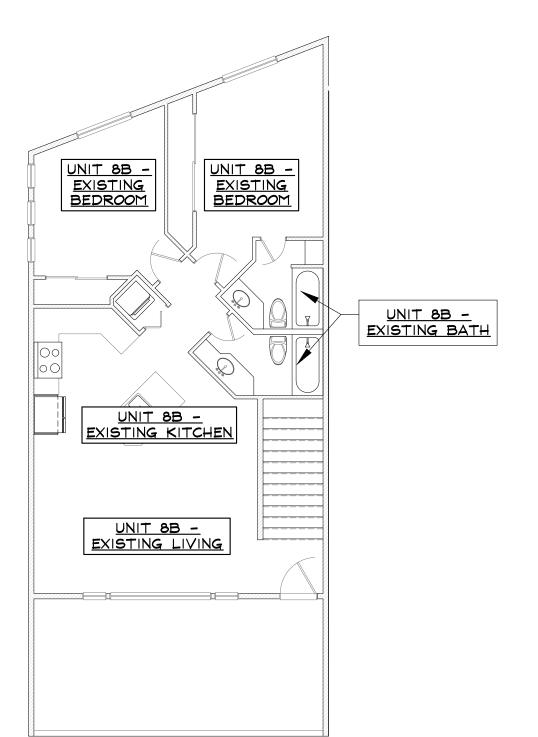

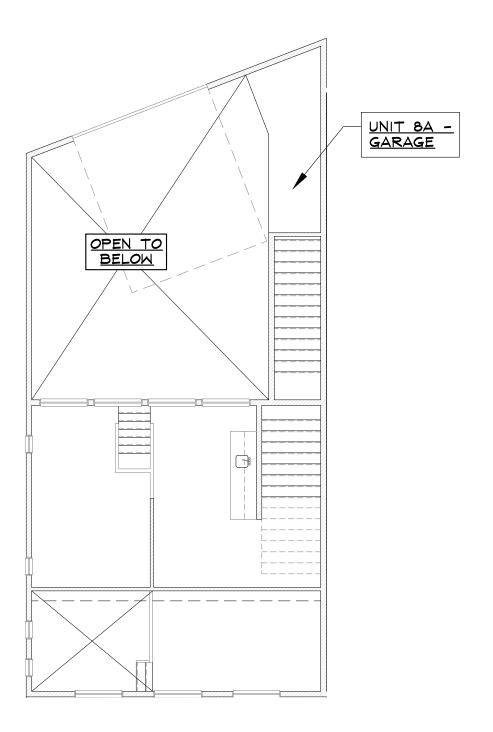

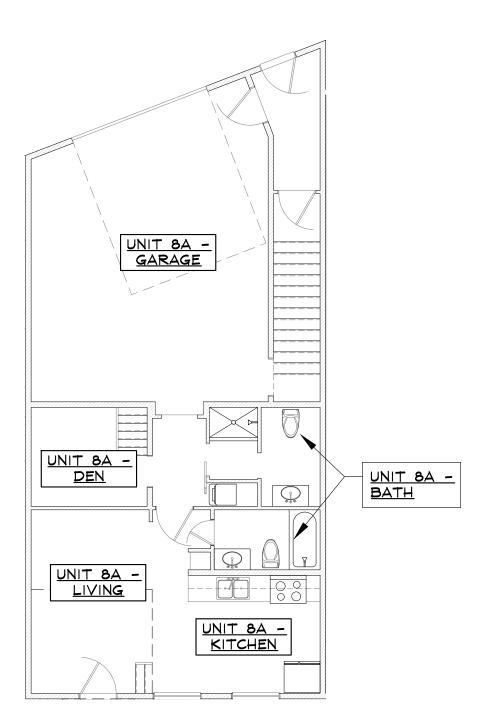

3 2ND LEVEL FLOOR PLAN - NO SHADING 5 3RD LEVEL FLOOR PLAN - NO SHADING


SCALE: 1/8" = 1'-0" 1ST LEVEL FLOOR PLAN - NO SHADING SCALE: $\frac{1}{8}$ = 1'-0"


SHADING KEY = PROPOSED ACCESSORY (GARAGE) USE = PROPOSED OFFICE USE = PROPOSED DWELLING UNIT USE = STAIRWELL


| UNIT 8 SQL | JARE FOOTAGE SUI | 1MARY TABLE: |
|------------|------------------|--------------|
| Level 1 | Garage 8A | 473 |
| Level 1 | Dwelling Unit 8A | 592 |
| Level 2 | Garage 8A | 75 |
| Level 2 | Dwelling Unit 8A | 404 |
| Level 3 | Dwelling Unit 8B | 941 |

| NIT 8 DWELLING | UNIT TABLE: |
|------------------|-------------|
| Init 8A Garage | 548 |
| Init 8A Dwelling | 996 |
| Init 8A Total | 1544 |
| Init 8B Total | 941 |



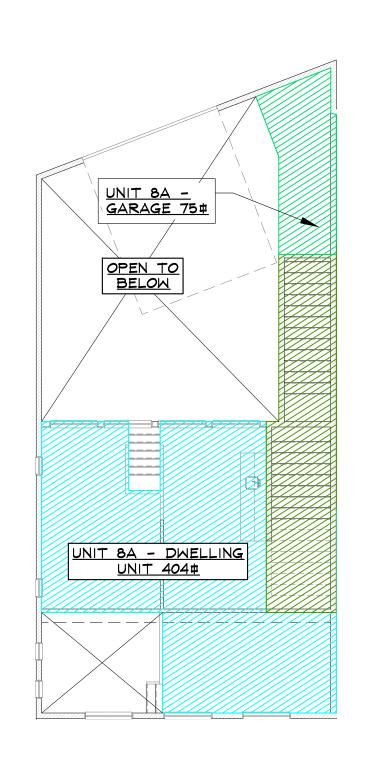


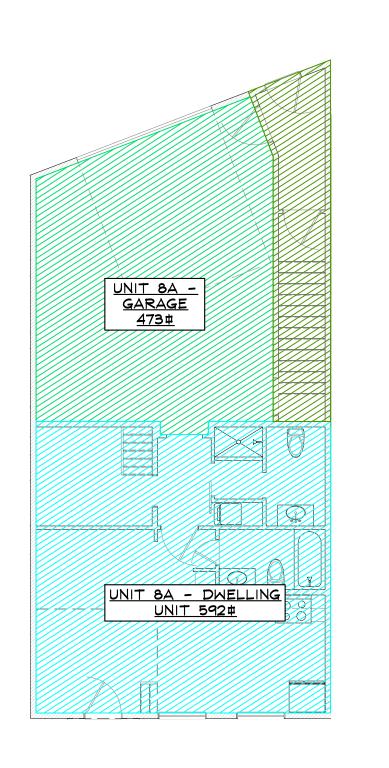

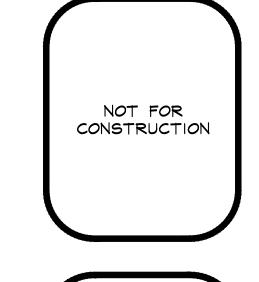



BUILDING

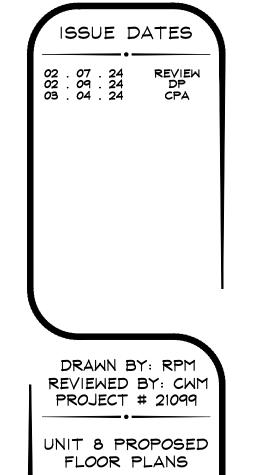

3RD LEVEL FLOOR PLAN - USE SHADING
SCALE: 1/3 = 1/-0"


3RD LEVEL FLOOR PLAN - USE SHADING
SCALE: 1/3 = 1/-0"


SCALE: 1/3 = 1/-0"


SCALE: 1/3 = 1/-0"


PHNEROUNT 9, RIVERFRONT PARK, FILING 1 6/14/2024 (DATE)

Shawn Bertini SHANN BERTINI) Dianne Bertini 6/14/2024 (DIANE D. BERTINI) (DATE)

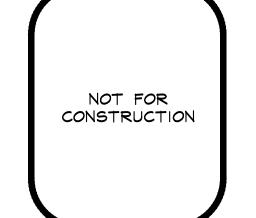

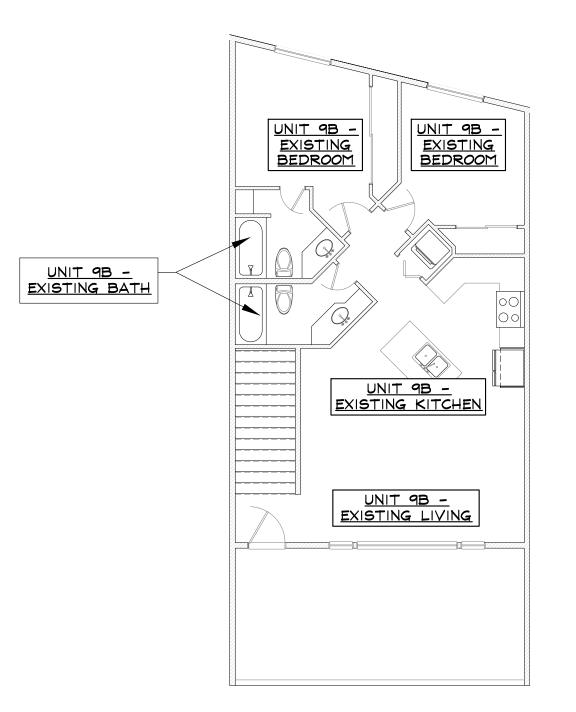

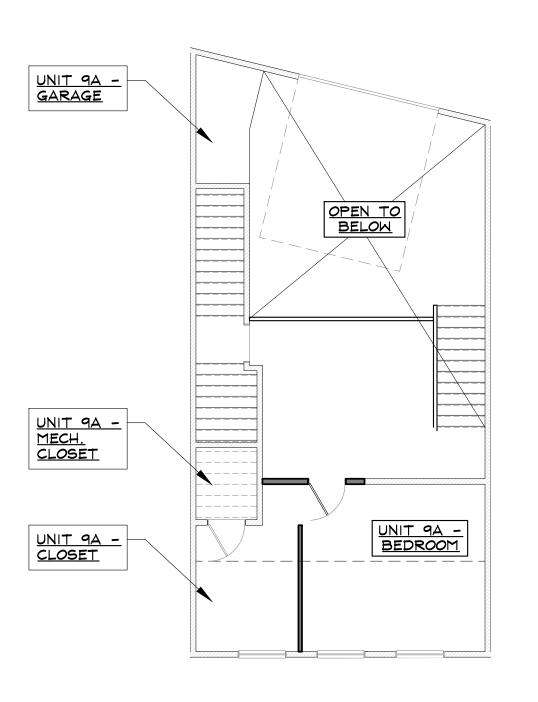

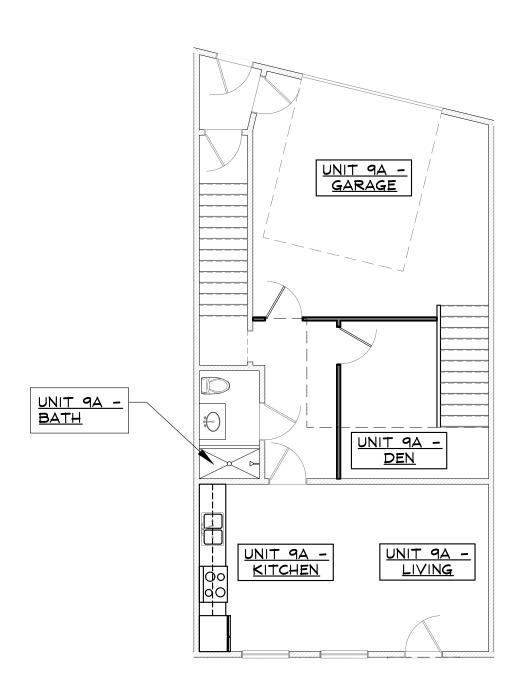


3 2ND LEVEL FLOOR PLAN - NO SHADING SCALE: 1/8" = 1'-0" 5 3RD LEVEL FLOOR PLAN - NO SHADING


SCALE: 1/8" = 1'-0" 1ST LEVEL FLOOR PLAN - NO SHADING SCALE: $\frac{1}{8}$ = 1'-0"


SHADING KEY = PROPOSED ACCESSORY (GARAGE) USE = PROPOSED OFFICE USE = PROPOSED DWELLING UNIT USE = STAIRWELL

| UNIT 9 SQU | ARE FOOTAGE SUMM | ARY TABLE: |
|------------|------------------|------------|
| Level 1 | Garage 9A | 372 |
| Level 1 | Dwelling Unit 9A | 671 |
| Level 2 | Garage 9A | 54 |
| Level 2 | Dwelling Unit 9A | 592 |
| Level 3 | Dwelling Unit 9B | 898 |



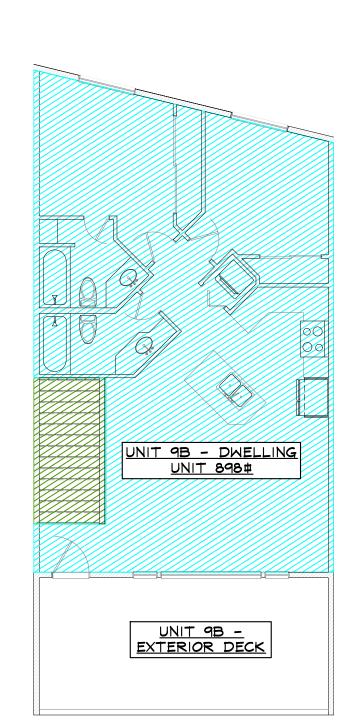

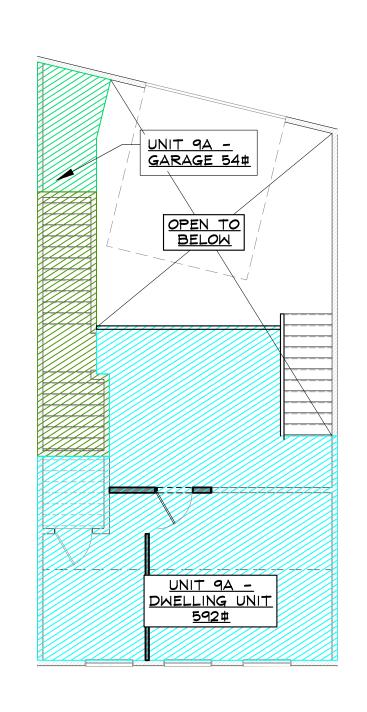

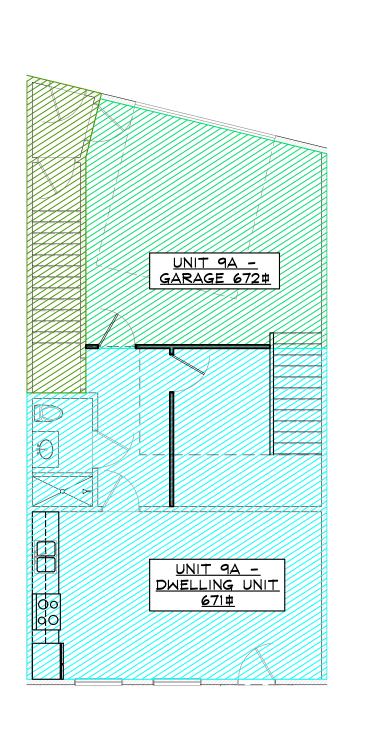

BUILDING


DRAWN BY: RPM REVIEWED BY: CWM PROJECT # 21099 UNIT 9 PROPOSED FLOOR PLANS


3RD LEVEL FLOOR PLAN - USE SHADING
SCALE: 1/8" = 1/1-0"


3RD LEVEL FLOOR PLAN - USE SHADING
SCALE: 1/8" = 1/1-0"


SCALE: 1/8" = 1/1-0"

SIGNATURE FOR PROPOSED USE DRAWINGS
FOR DEVELOPMENT PERMIT
OWNER inch UNIT 10, RIVERFRONT PARK, FILING 1

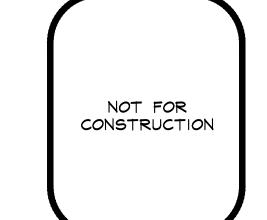

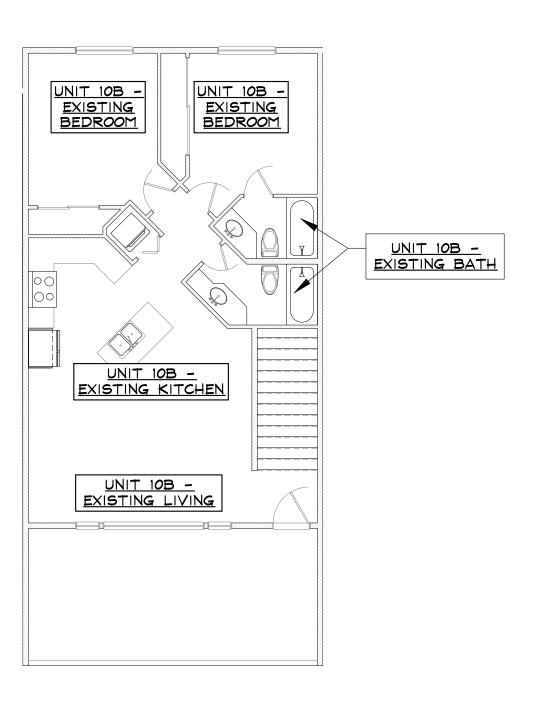

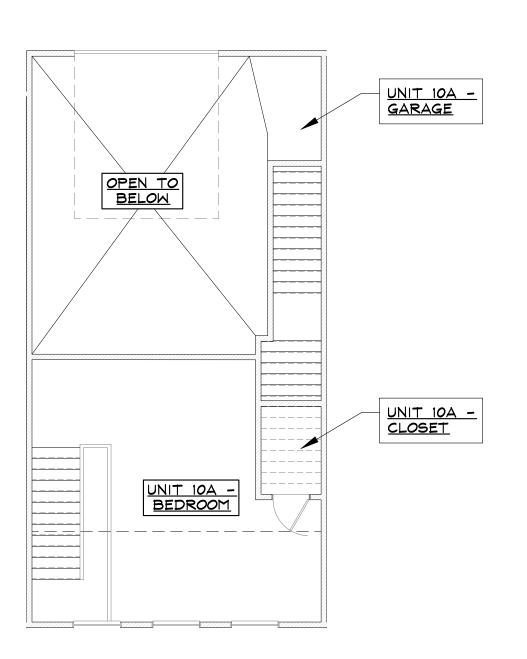

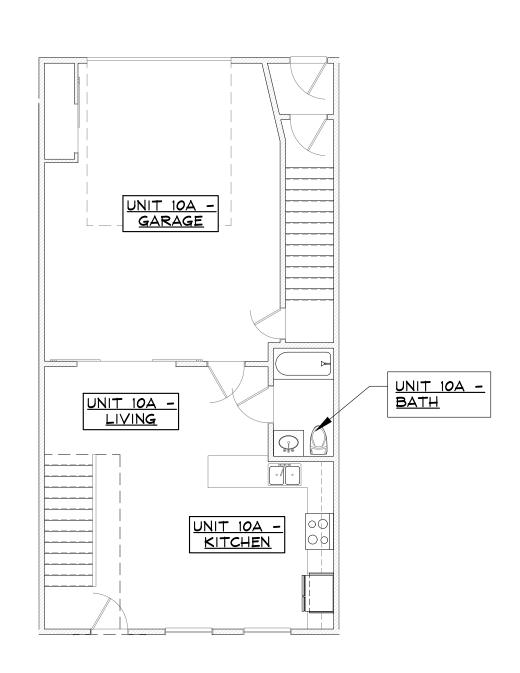

3 RD LEVEL FLOOR PLAN - NO SHADING

SCALE: 1/8" = 1/1-0"

SCALE: 1/8" = 1/1-0"

SCALE: 1/8" = 1/1-0"

SCALE: 1/8" = 1/1-0"

SHADING KEY

= PROPOSED ACCESSORY (GARAGE) USE

= PROPOSED OFFICE USE

= PROPOSED DWELLING UNIT USE


= STAIRWELL


UNIT 10 SQUARE FOOTAGE SUMMARY TABLE:


| Level 1 | Garage 10A | 491 |
|---------|-------------------|-----|
| Level 1 | Dwelling Unit 10A | 567 |
| Level 2 | Garage 10A | 48 |
| Level 2 | Dwelling Unit 10A | 434 |
| Level 3 | Dwelling Unit 10B | 907 |


UNIT 10 DWELLING UNIT TABLE:

| Unit 10A Garage | 539 |
|-------------------|------|
| Unit 10A Dwelling | 1001 |
| Unit 10A Total | 1540 |
| Unit 10B Total | 907 |

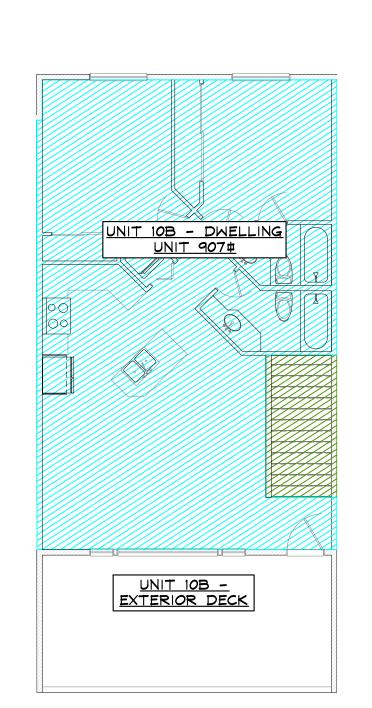

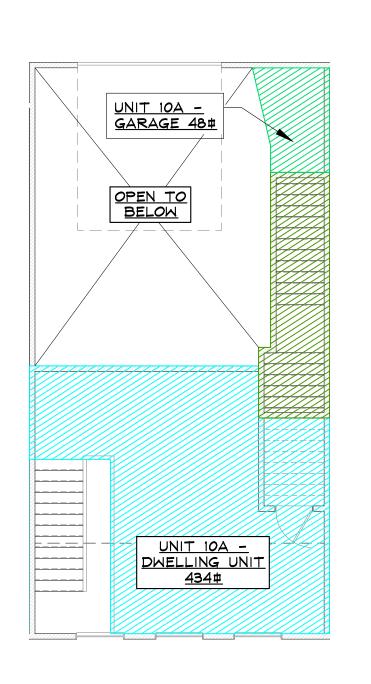

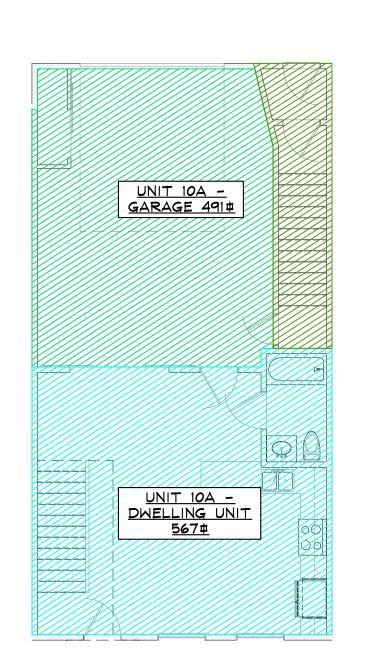

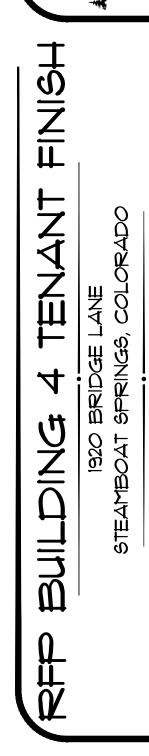

DRAWN BY: RPM
REVIEWED BY: CWM
PROJECT # 21099

UNIT 10 PROPOSED
FLOOR PLANS

3RD LEVEL FLOOR PLAN - USE SHADING
SCALE: 1/8" = 1'-0"

4 2ND LEVEL FLOOR PLAN - USE SHADING
SCALE: 1/8" = 1'-0"

SCALE: 1/8" = 1'-0"

5CALE: 1/8" = 1'-0"

OWNER: UNIT 11, RIVERFRONT PARK, FILING 1 STEAMBOAGHED RESIDENTIAL, LLC


BY: Enc Rogers (PF


Managing Member


PRINT NAME)

DATE:

NOT FOR CONSTRUCTION

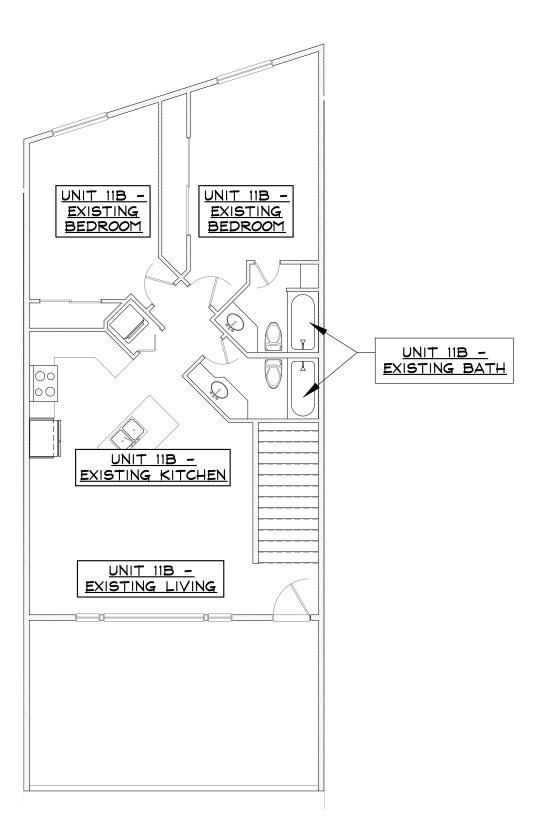

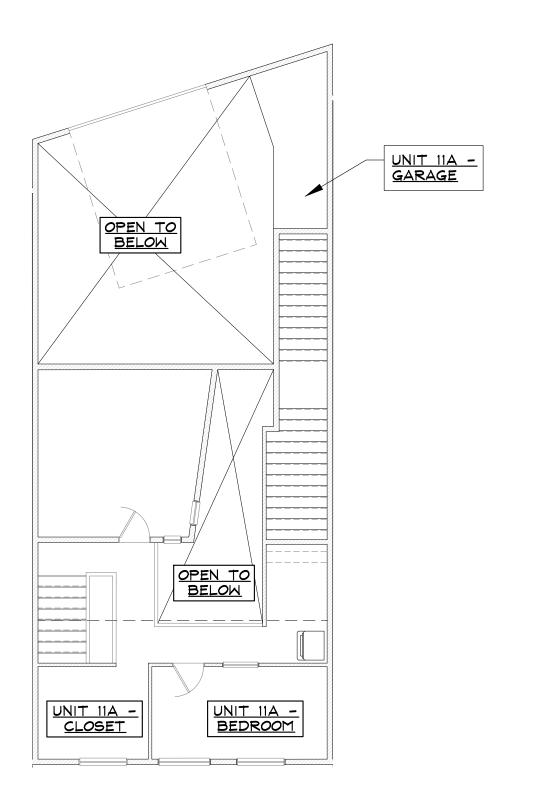

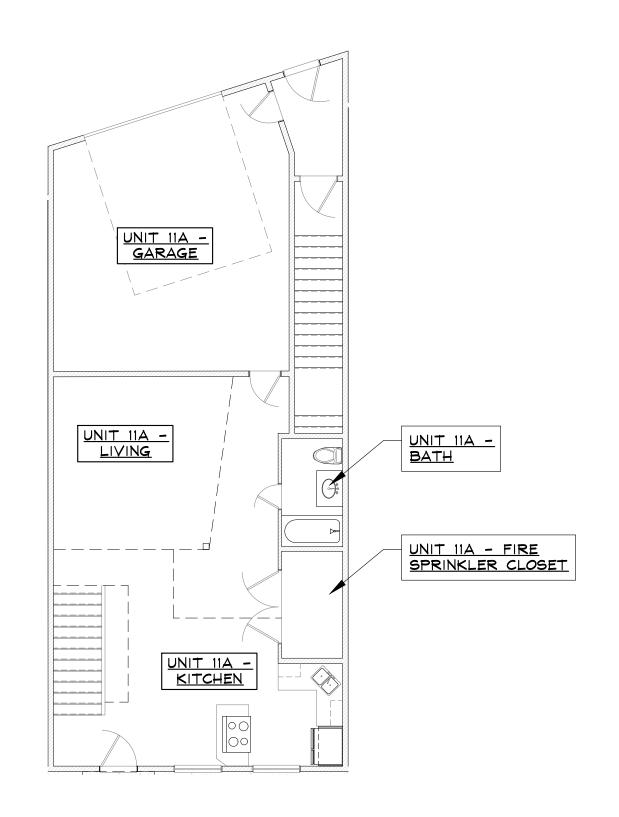

(5) 3RD LEVEL FLOOR PLAN - NO SHADING
SCALE: 1/8" = 1/-0"

3) 2ND LEVEL FLOOR PLAN - NO SHADING
SCALE: 1/8" = 1/-0"

1 ST LEVEL FLOOR PLAN - NO SHADING
SCALE: 1/8" = 1/-0"

SHADING KEY

= PROPOSED ACCESSORY (GARAGE) USE

= PROPOSED OFFICE USE

= PROPOSED DWELLING UNIT USE


= STAIRWELL


UNIT 11 SQUARE FOOTAGE SUMMARY TABLE:


| level 1 | Garage 11A | 479 |
|---------|-------------------|------|
| level 1 | Dwelling Unit 11A | 741 |
| Level 2 | Garage 11A | 74 |
| leve#2 | Dwelling Unit 11A | 554 |
| leve#3 | Dwelling Unit 11B | 1004 |
| | | |

UNIT 11 DWELLING UNIT TABLE:

| Unit 11A Garage | 553 |
|-------------------|------|
| Unit 11A Dwelling | 1295 |
| Unit 11A Total | 1848 |
| Unit 11B Total | 1004 |

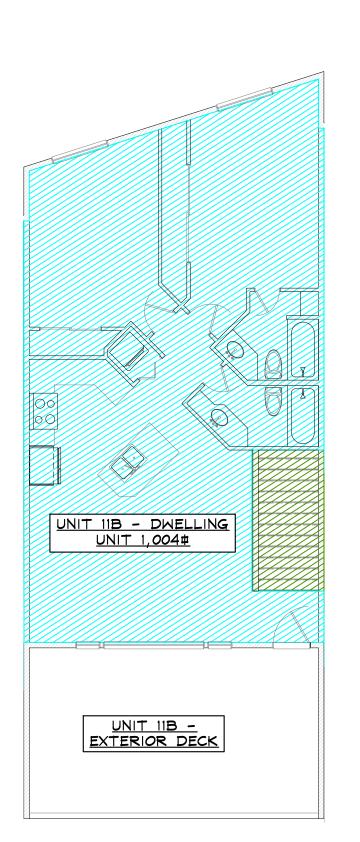

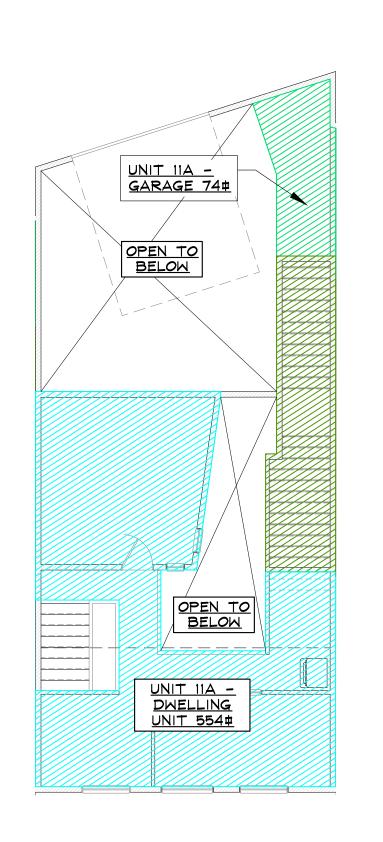

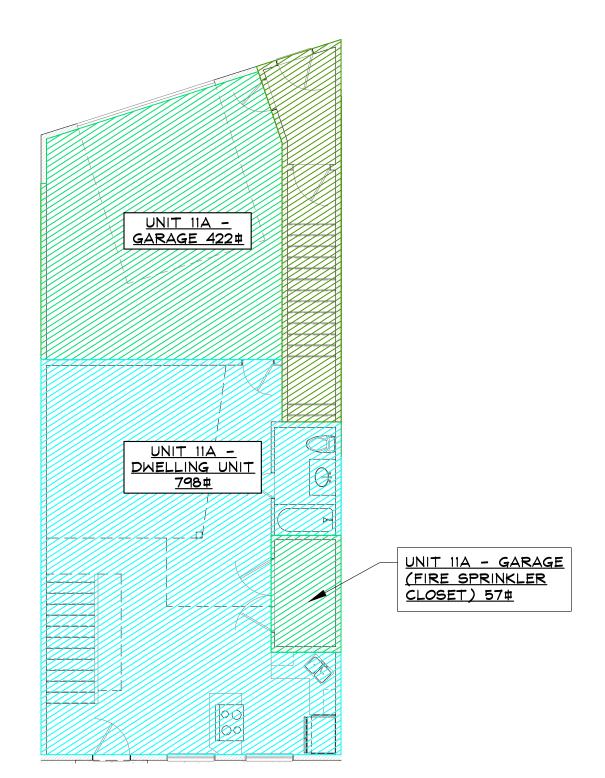

BULDING

SEAMBOAT S

SEAMBOAT S

ORAM REVIEWED BY: SEA DPA

ORAM REVIEWED BY: COPA

ORAM REVIEWED BY: COPA

ORAM PROJECT # 210999

DRAWN BY: CWM
PROJECT # 210999

UNIT 11 PROPOSED
FLOOR PLANS

3RD LEVEL FLOOR PLAN - USE SHADING
SCALE: 1/8" = 1/1-0"


4 2ND LEVEL FLOOR PLAN - USE SHADING
SCALE: 1/8" = 1/1-0"


SCALE: 1/8" = 1/1-0"


Z:\2021\21099_RFP Tenant Finish\Drawings\Building 4\21099_ArchSheets_Building4.dwg, 6/12/2024 5:34:04 PM


ONNER med binit 12, RIVERFRONT PARK, FILING 1

lawi (leverly 6/13/2024 (LANI K. CLEVERLY) (DATE)

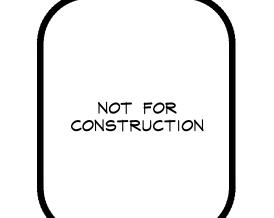

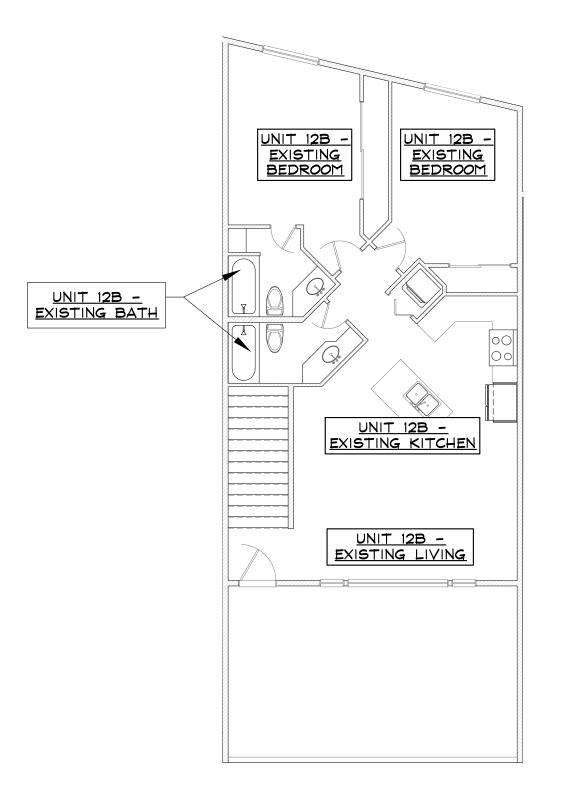

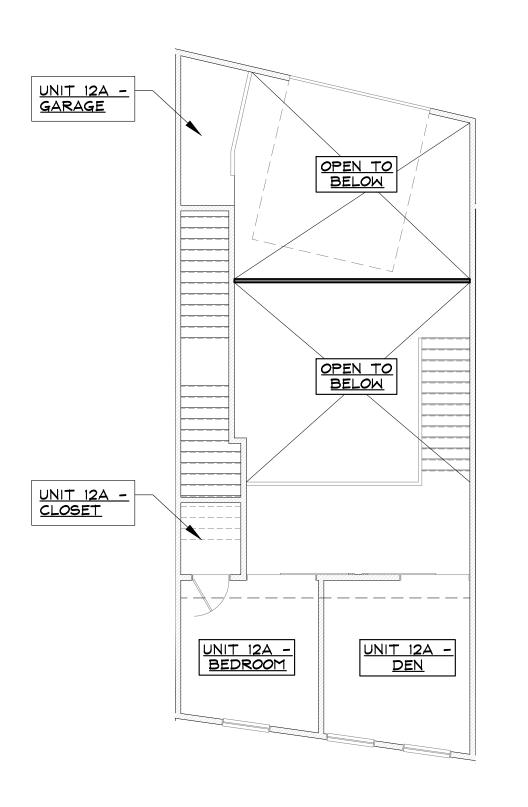

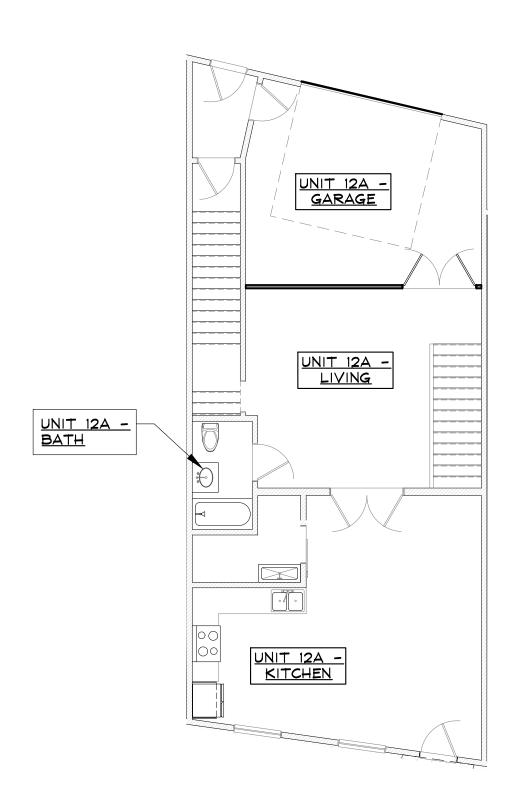



3 2ND LEVEL FLOOR PLAN - NO SHADING SCALE: 1/8" = 1'-0" SCALE: 1/-0" 1ST LEVEL FLOOR PLAN - NO SHADING SCALE: $\frac{1}{8}$ = 1'-0"


SHADING KEY = PROPOSED ACCESSORY (GARAGE) USE = PROPOSED OFFICE USE = PROPOSED DWELLING UNIT USE = STAIRWELL


| UNIT 12 SQUARE FOOTAGE SUMMARY TABLE | | | | |
|--------------------------------------|-------------------|-----|--|--|
| Level 1 | Garage 12A | 304 | | |
| lev el 1 | Dwelling Unit 12A | 886 | | |
| Levei 2 | Garage 12A | 62 | | |
| lev e! 2 | Dwelling Unit 12A | 509 | | |
| levei3 | Dwelling Unit 12B | 975 | | |


| | 0 |
|--------------------|-------------|
| JNIT 12 DWELLING L | JNIT TABLE: |
| Unit 12A Garage | 366 |
| Unit 12A Dwelling | 1395 |
| Unit 12A Total | 1761 |
| Unit 12B Total | 975 |

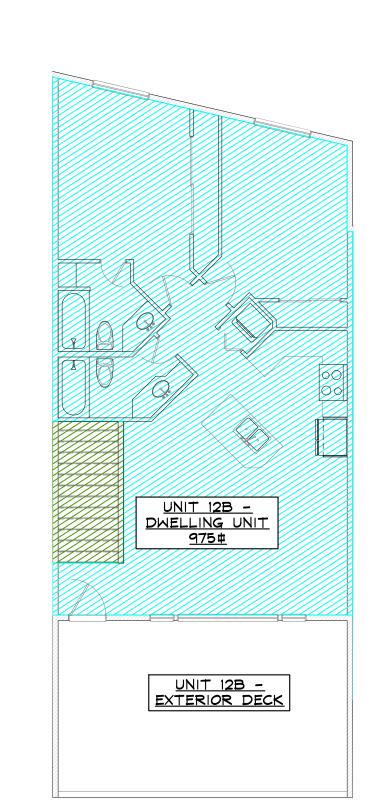

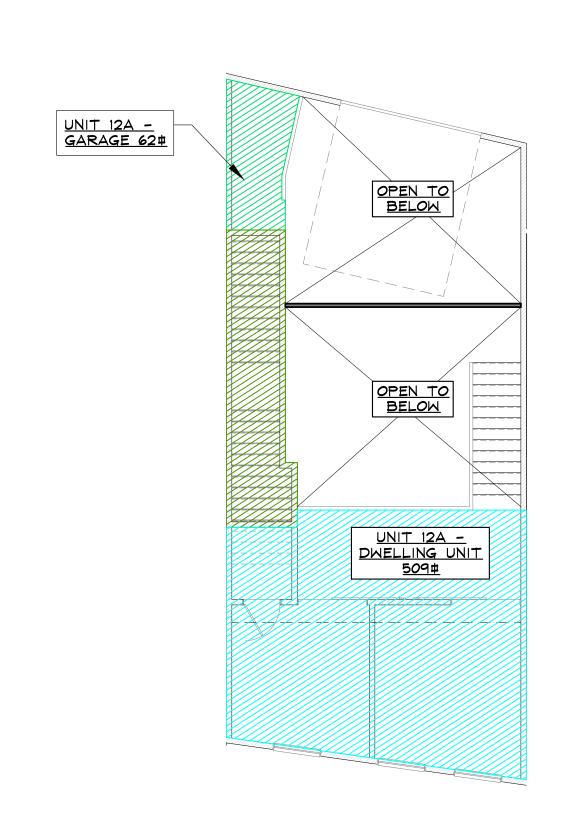

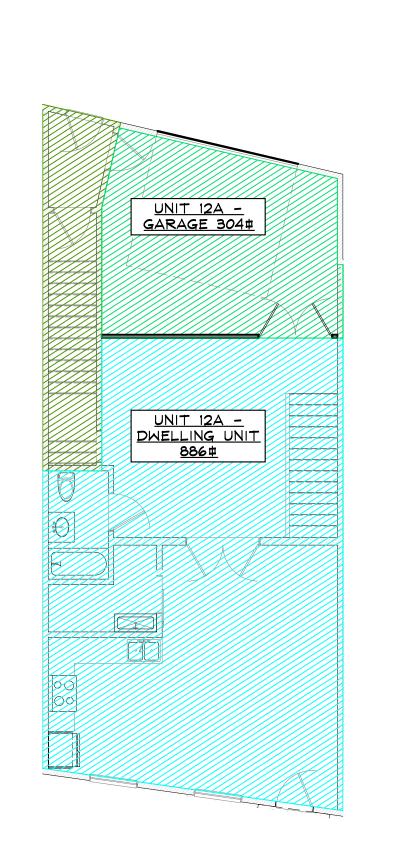

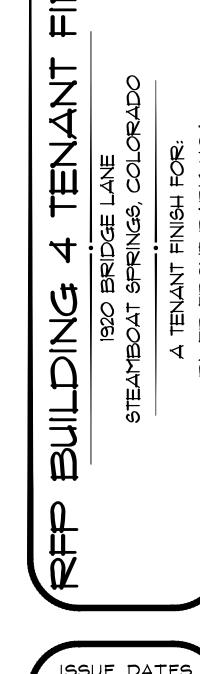

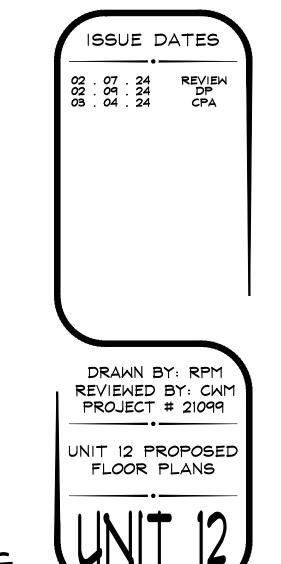



3RD LEVEL FLOOR PLAN - USE SHADING
SCALE: 1/8" = 1'-0"


3RD LEVEL FLOOR PLAN - USE SHADING
SCALE: 1/8" = 1'-0"


SCALE: 1/8" = 1'-0"

ONNERGIEUNIT 13, RIVERFRONT PARK, FILING 1
6/12/2024 (MILO ROBERT VELTUS RUBIN) (DATE)

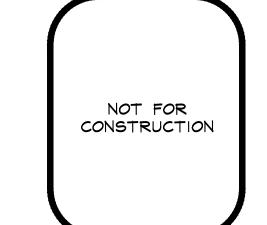

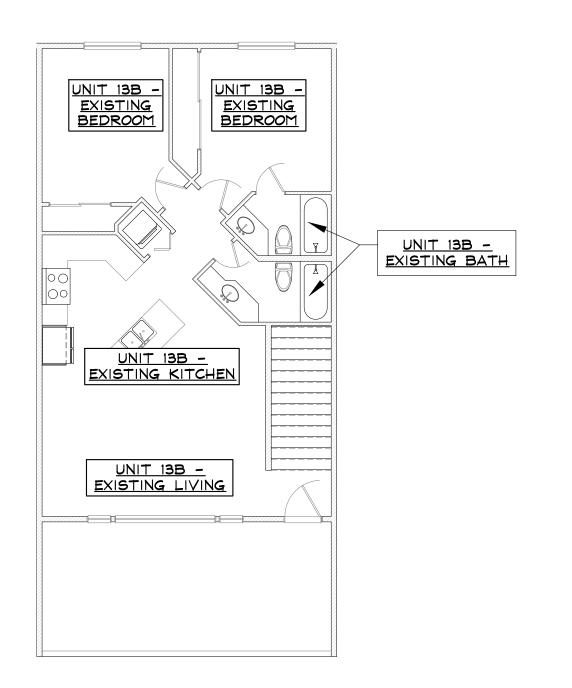

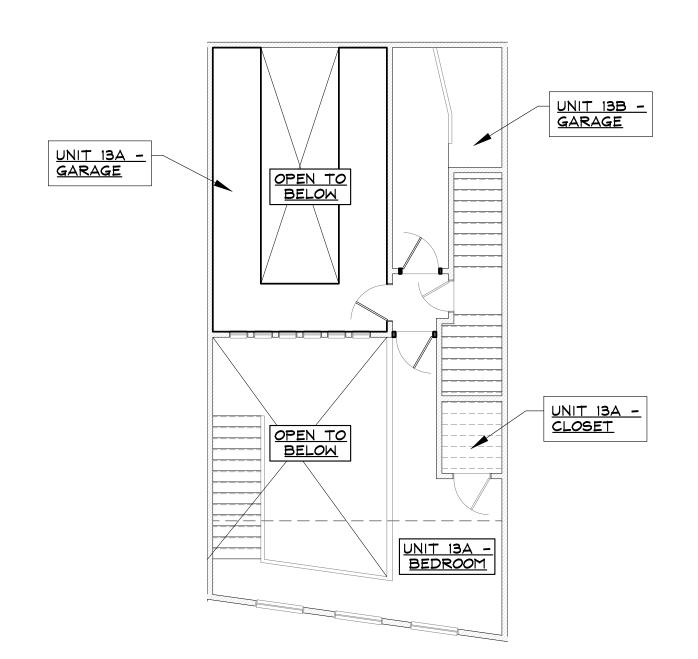

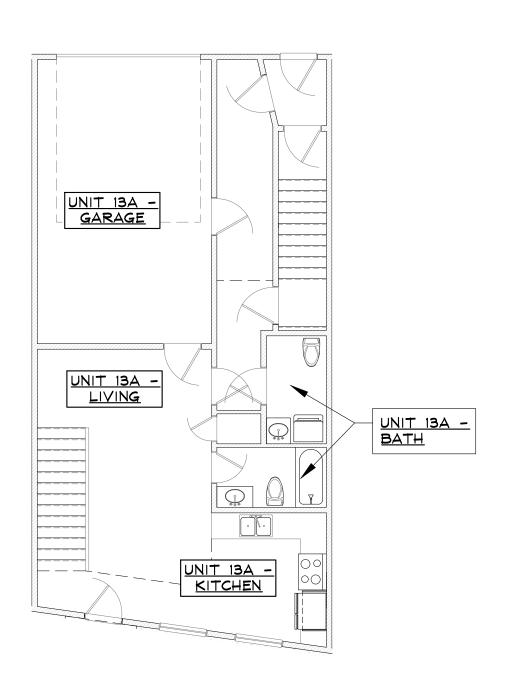

3 2ND LEVEL FLOOR PLAN - NO SHADING SCALE: 1/9 = 1/-0" 1ST LEVEL FLOOR PLAN - NO SHADING SCALE: $\frac{1}{8}$ = 1'-0"


SHADING KEY = PROPOSED ACCESSORY (GARAGE) USE = PROPOSED OFFICE USE = PROPOSED DWELLING UNIT USE = STAIRWELL


UNIT 13 SQUARE FOOTAGE SUMMARY TABLE:


| tevet 1 | Garage 13A | 355 | |
|-----------------|-------------------|-----|--|
| Level I | Dwelling Unit 13A | 713 | |
| Lev e! 2 | Garage 13A | 237 | |
| Levei 2 | Dwelling Unit 13A | 252 | |
| le ve! 2 | Garage 13B | 158 | |
| levei3 | Dwelling Unit 13B | 903 | |


UNIT 13 DWELLING UNIT TABLE:

| 592 |
|------|
| 965 |
| 1557 |
| 158 |
| 903 |
| 1061 |
| |

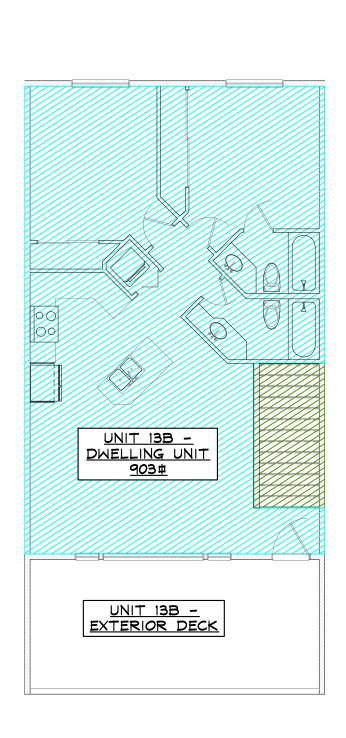

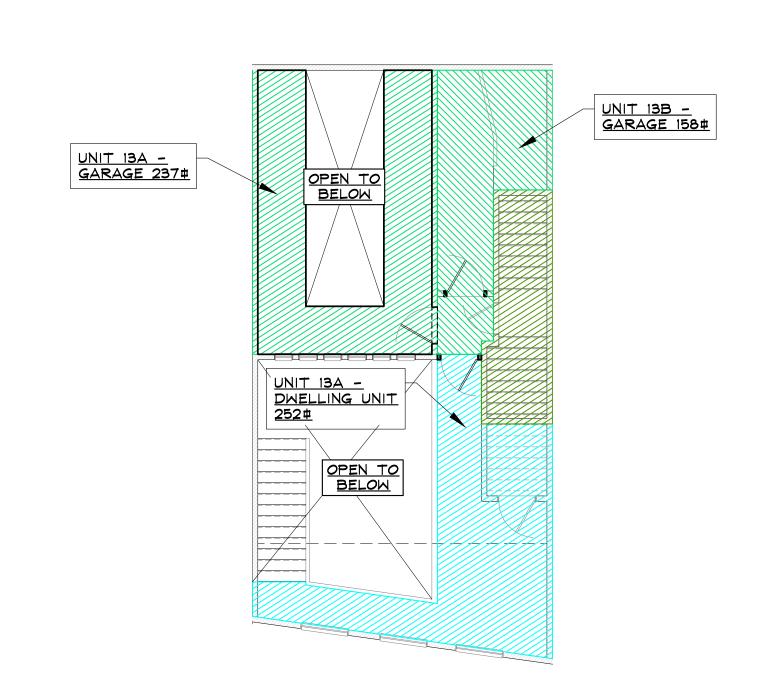

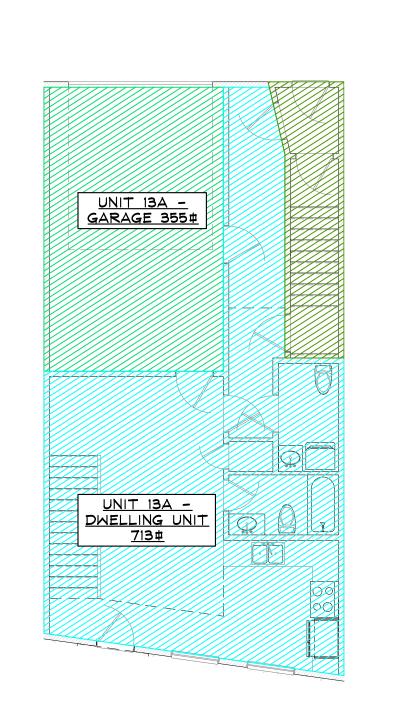

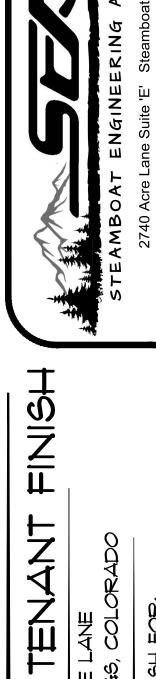

DRAWN BY: RPM REVIEWED BY: CWM PROJECT # 21099 UNIT 13 PROPOSED FLOOR PLANS

3RD LEVEL FLOOR PLAN - USE SHADING
SCALE: 1/8" = 1'-0"

4 2ND LEVEL FLOOR PLAN - USE SHADING
SCALE: 1/8" = 1'-0"


SCALE: 1/8" = 1'-0"


5CALE: 1/8" = 1'-0"


OWNER: UNIT 14, RIVERFRONT PARK, FILING CO MGDO HOLDINGS, LLC

karl Holt Karl Holt (SIGNATURE) I**TS**: President

(PRINT NAME) 0/12/2024 DATE:_____

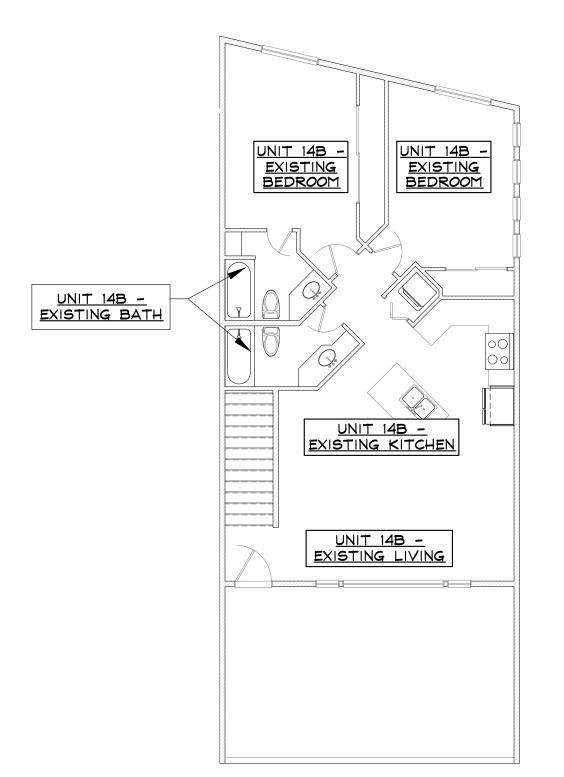

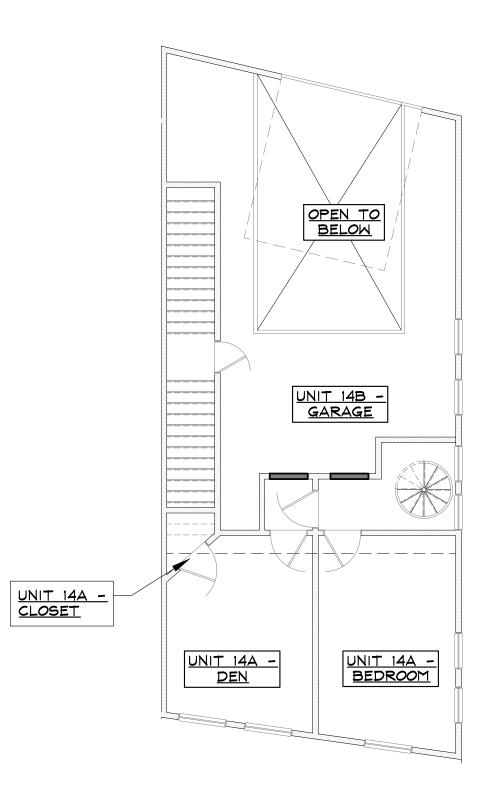

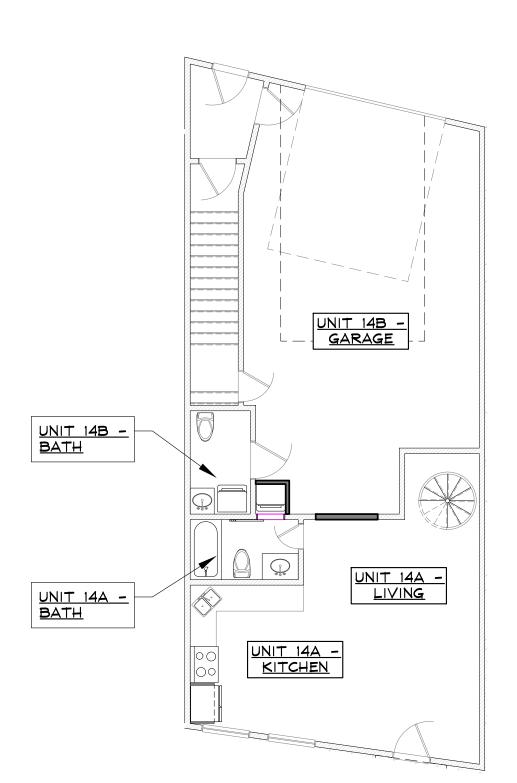

3 2ND LEVEL FLOOR PLAN - NO SHADING 5 3RD LEVEL FLOOR PLAN - NO SHADING

SCALE: 1/8" = 1/-0" 1ST LEVEL FLOOR PLAN - NO SHADING SCALE: %" = 1'-0"

SHADING KEY = PROPOSED ACCESSORY (GARAGE) USE = PROPOSED OFFICE USE = PROPOSED DWELLING UNIT USE = STAIRWELL


| <u>UNIT 14 SQL</u> | JARE FOOTAGE SUMM | <u>ARY</u> | TABLE |
|--------------------|-------------------|------------|-------|
| Level 1 | Garage 14B | | 664 |
| Level 1 | Dwelling Unit 14A | | 510 |
| Level 2 | Garage 14B | | 427 |
| | | | |


Dwelling Unit 14A


Dwelling Unit 14B

| UNIT 14 DWELLING | LINIT TABLE |
|-------------------|-------------|
| | |
| Unit 14A Total | 1028 |
| Unit 14B Garage | 1091 |
| Dwelling Unit 14B | 975 |
| Unit 14B Total | 2066 |

Level 3

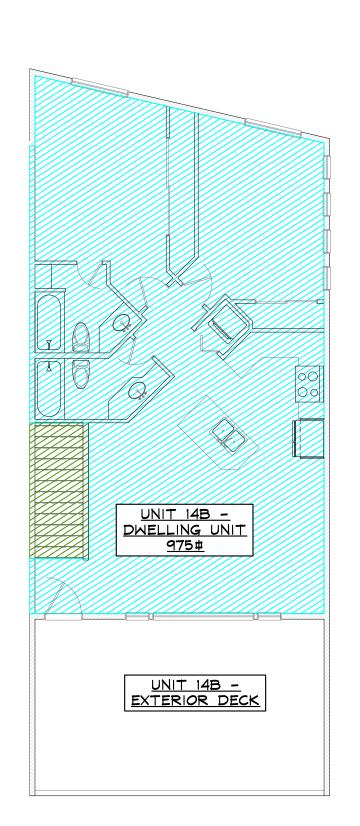

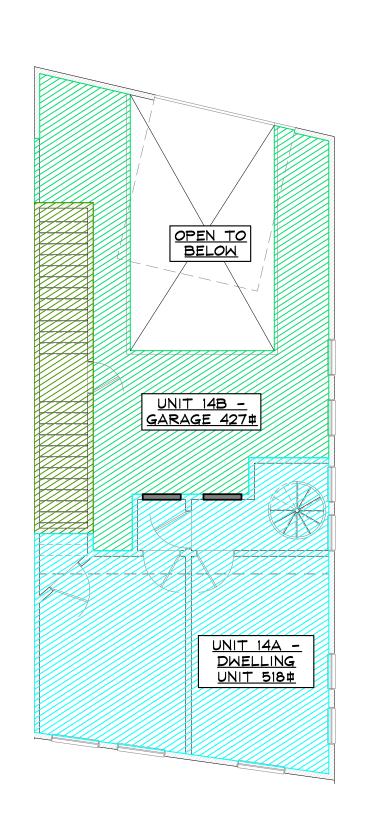

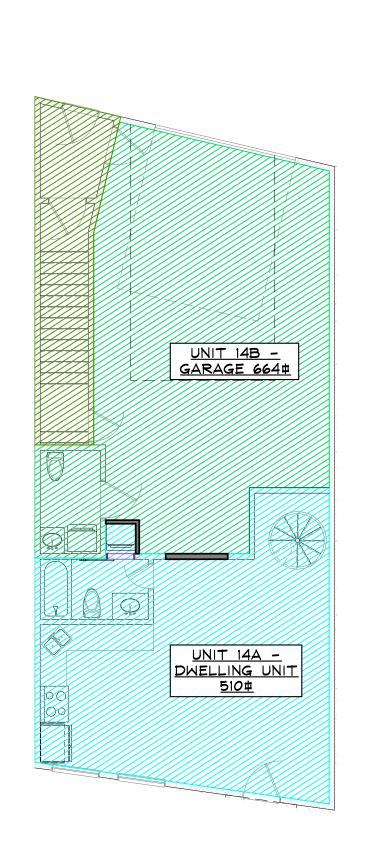

NOT FOR CONSTRUCTION



BUILDING



3RD LEVEL FLOOR PLAN - USE SHADING
SCALE: 1/8" = 1/1-0"

3RD LEVEL FLOOR PLAN - USE SHADING
SCALE: 1/8" = 1/1-0"

SCALE: 1/8" = 1/1-0"