

GENERAL NOTES

- 1. TOPOGRAPHIC AND EXISTING CONDITIONS MAPPED BY LANDMARK CONSULTANTS, INC.
2. CITY OF STEAMBOAT SPRINGS PLAN REVIEW AND APPROVAL IS ONLY FOR GENERAL CONFORMANCE WITH CITY DESIGN CRITERIA AND THE CITY CODE...
3. ONE COPY OF THE APPROVED CONSTRUCTION PLANS AND SPECIFICATIONS SHALL BE KEPT ON THE JOB SITE AT ALL TIMES...

- 36. ACCESS TO ALL ADJACENT PROPERTIES AND FACILITIES SHALL BE MAINTAINED AT ALL TIMES. REQUIRED INTERRUPTION OF ACCESS SHALL BE COORDINATED WITH THE PROPERTY AND PROJECT OWNERS.
37. IF HAZARDOUS MATERIAL OR SUSPECT MATERIAL IS ENCOUNTERED NOTIFY THE OWNER AND ENGINEER BEFORE CONTINUING WORK...
38. THE APPROPRIATE CONTRACTOR SHALL BE RESPONSIBLE FOR THE SOURCE OF CONSTRUCTION WATER FOR USE ON THIS PROJECT.

CONSTRUCTION NOTES

A. GRADING AND DRAINAGE

- 44. NO WORK SHALL OCCUR IN WETLANDS OR FLOODPLAINS WITHOUT PERMITS. ANY WORK SHALL BE IN ACCORDANCE WITH ISSUED PERMITS.
45. VEGETATED SLOPES GREATER THAN 3:1 REQUIRE SOIL STABILIZATION.
46. CLEAN ALL INSTALLED CURBS/VERTS AND STORM SEWERS PRIOR TO SUBSTANTIAL COMPLETION INSPECTIONS.

B. CONSTRUCTION SITE AND STORMWATER MANAGEMENT

- 51. A GEOTECHNICAL REPORT FOR THIS PROJECT WAS PREPARED UNDER THE TITLE OF 'SUBSOIL AND FOUNDATION INVESTIGATION, STEAMBOAT BASE AREA REDEVELOPMENT, STEAMBOAT SPRINGS, COLORADO' BY NVCC DATED DECEMBER 30, 2020, AND THEIR RECOMMENDATIONS ARE HEREBY INCORPORATED HEREIN...
52. CONTRACTOR SHALL SUBMIT A CONSTRUCTION SITE MANAGEMENT PLAN TO THE CITY FOR APPROVAL PRIOR TO BUILDING PERMIT ISSUANCE...
57. ALL STRUCTURAL EROSION CONTROL MEASURES SHALL BE INSTALLED AT THE LIMITS OF CONSTRUCTION AND AT AREAS WITH DISTURBED SOIL...

C. PAVING

- 64. UNLESS NOTED OTHERWISE, THE PAVEMENT SECTION SHALL CONSIST OF:
A. 8-INCH THICK AGGREGATE SUBBASE COURSE; MODIFIED CDOT STANDARD CLASS 3 BASE AGGREGATE OR WELL GRADED PIT RUN CONFORMING TO CDOT STANDARD SPECIFICATION SECTION 703 FOR AGGREGATES.
B. 4-INCH THICK AGGREGATE BASE COURSE; CDOT STANDARD SPECIFICATIONS SECTION 703.03 FOR CLASS 6 AGGREGATE BASE COURSE;
C. 4-INCH THICK ASPHALT PAVEMENT; CDOT STANDARD SPECIFICATIONS, LATEST EDITION, WITH TYPE SX GRADATION AND PG58-28 BINDER.
TACK COATS SHALL BE SS-SH AND CONFORM TO ASHTO M162 PAVING OF PUBLIC STREETS SHALL NOT START UNTIL SUBGRADE COMPACTION AND MATERIAL TESTS ARE TAKEN AND ACCEPTED BY THE PUBLIC WORKS DIRECTOR.

- 71. PRIOR TO PLACEMENT OF H.B.P. OR CONCRETE WITHIN THE STREET AND AFTER MOISTURE/DENSITY TESTS HAVE BEEN TAKEN ON THE SUBGRADE MATERIAL (WHEN A FULL DEPTH SECTION IS PROPOSED) OR ON THE SUBGRADE AND BASE MATERIAL (WHEN A COMPOSITE SECTION IS PROPOSED), A MECHANICAL "PROOF ROLL" WILL BE REQUIRED...
72. NO UNDERMINING OF EXISTING PAVEMENT SHALL BE ALLOWED. IF UNDERMINING IS EVIDENT, PAVEMENT SHALL BE CUT BACK ACCORDINGLY...
79. WATER AND SEWER NOTES
11. ALL WATER AND SEWER CONSTRUCTION SHALL BE PER MT. WERNER WATER STANDARD SPECIFICATIONS, LATEST EDITION, AS APPLICABLE.
12. MAINTAIN 10" HORIZONTAL AND 18" VERTICAL MINIMUM SEPARATION BETWEEN ALL SANITARY SEWER MAINS, WATER MAINS & SERVICES.

PROJECT NOTES:

- 89. AN AUTOCAD COMPATIBLE FILE WILL BE PROVIDED FOR CONSTRUCTION STAKING PURPOSES, UPON ACCEPTANCE OF LANDMARK'S CAD RELEASE POLICY.
90. IF THESE DRAWINGS ARE PRESENTED IN A FORMAT OTHER THAN 24" X 36", THE GRAPHIC SCALE SHOULD NOT BE USED.

THE CONTRACTOR SHALL RESOLVE ALL REPORTED APPLICABLE DEFICIENCIES WITH LANDMARK PRIOR TO AWARDED ANY SUBCONTRACTS OR STARTING WORK WITH THE CONTRACTOR'S OWN EMPLOYEES. IF ANY DEFICIENCIES CANNOT BE RESOLVED BY THE CONTRACTOR WITHOUT ADDITIONAL TIME OR ADDITIONAL EXPENSES, THE CONTRACTOR SHALL SO INFORM THE OWNER IN WRITING...

CONSTRUCTION PHASE SERVICES:

IT IS UNDERSTOOD AND AGREED THAT LANDMARK DOES NOT HAVE AN OBLIGATION TO CONDUCT CONSTRUCTION OBSERVATION OR REVIEW OF THE CONTRACTOR'S PERFORMANCE OR ANY OTHER CONSTRUCTION PHASE SERVICES, AND THAT SUCH SERVICES WILL BE PROVIDED FOR BY THE OWNER AS MAY BE REQUIRED BY THE AUTHORITY HAVING JURISDICTION OF STEAMBOAT SPRINGS...

Table with 2 columns: Abbreviations and Description. Includes terms like ADA, APR, BMP, BOT, BVCS, BVCE, BW OR BOW, CAC, CAD, CAS, CIP, CL, CENTERLINE, CMP, CLEAR CUT, CP, CONCRETE PIPE, CSP, CORRUGATED STEEL PIPE, DIA, DIAP, DUCTILE IRON PIPE, EG, EXISTING GROUND, EL, ELEVATION, EOA OR EA, EDGE OF ASPHALT, EDC, EDGE OF CONCRETE, ECP, EDGE OF PAVEMENT, EVCS, END VERTICAL CURVE ELEVATION, EVCB, END VERTICAL CURVE STATION, EX, EXISTING, F&G, FRAME & GRADE, FAC, FRAME & COVER, FES, FLARED END SECTION, FFE, FINISH FLOOR ELEVATION, FH, FIRE HYDRANT, FL, FLOW LINE, FG, FINISH GRADE, FGBW, FINISH GRADE AT BOTTOM OF WALL, GB, GRADE BREAK, GFFE, GARAGE FINISH FLOOR ELEVATION, GFD, GRADE TO DRAIN, HDPE, HIGH DENSITY POLYETHYLENE PIPE, HWY, HWY, LBS, POUNDS, LOD, LIMITS OF DISTURBANCE, MEPP, MECHANICAL, ELECTRIC, AND PLUMBING, MAX, MAXIMUM, ME, MATCH EXISTING, MH, MANHOLE, MIN, MINIMUM, MJ, MECHANICAL JOINT, NAP OR N.A.P., NOT A PART (NOT INCLUDED IN SCOPE), NTS, NOT TO SCALE, OFF, OFFSET, PC, POINT OF CURVE, PI, POINT OF INTERSECTION, PCC, POINT OF CONCAVE CURVE, PDRP, POROUS LANDSCAPE DETENTION POND, PRC, POINT OF REVERSE CURVE, PT, POINT OF TANGENT, PVT, POINT OF VERTICAL CURVE, PVD, POLYVINYL CHLORIDE PIPE, PVI, POINT OF VERTICAL INTERSECTION, PVT, POINT OF VERTICAL TANGENT, R, RADIUS, RCP, REINFORCED CONCRETE PIPE, REQ, REQUIRED, RFB, RIGHT OF WAY, STA, STATION, TB, THRUST BLOCK, TRC, TOP BACK OF CURB, TRB, TO BE REMOVED, TG, TOP OF GRADE, TP, TOP OF PIPE, TRF, TARPED TO GRADE, TW OR TOW, TOP OF WALL, TYP, TYPICAL, VCP, VITRIFIED CLAY PIPE, VOL, VOLUME, W, WITH.



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RCRBD Record Set TC 06/29/2021

Table with 2 columns: Date, Description. Row 1: 2021.05.19 B3: GOLDWALK - ISSUE FOR BID AND PERMIT



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Seal / Signature

Project Name GOLD WALK

SSRC | BASE AREA IMPROVEMENTS


Project Number 003.7835.000

Description Civil Construction Notes


Scale SEE GRAPHICAL SCALE

1B-C.002

KEY PLAN

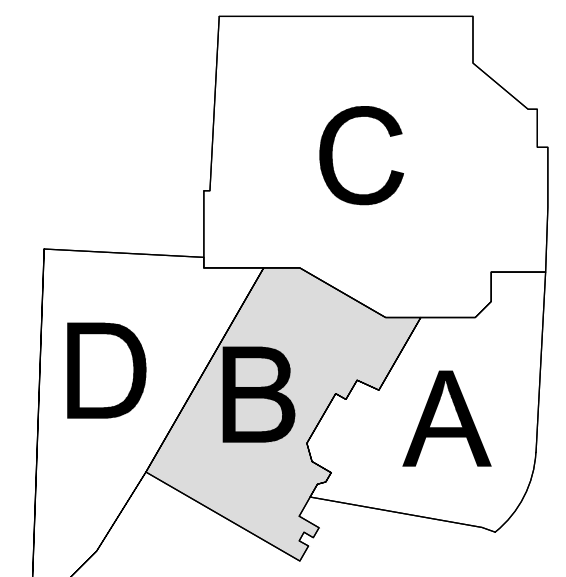

Vertical text on the left margin containing project details and dates.

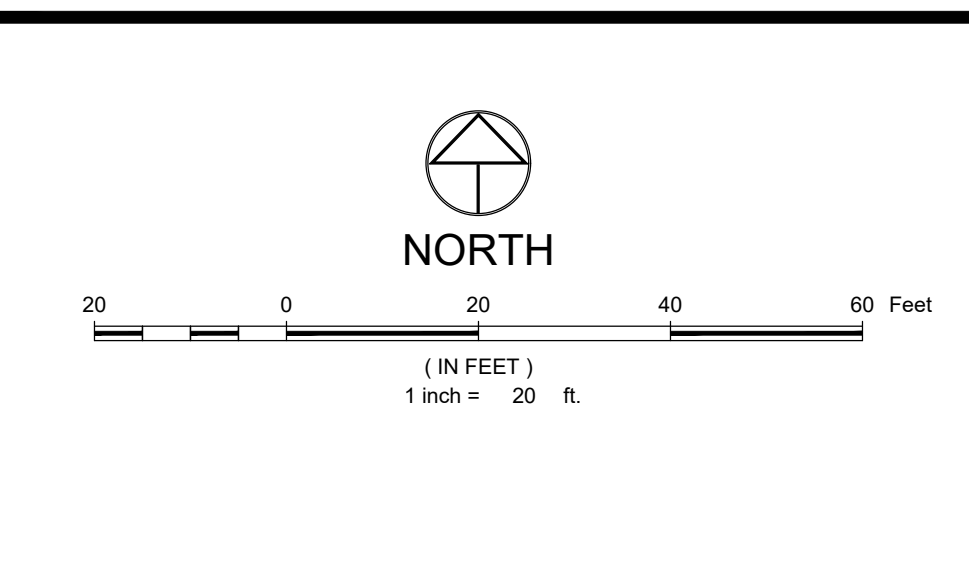


LEGEND

BUILDING	[Symbol]
ROOF LINE/OVERHANG	[Symbol]
DECK	[Symbol]
WALL	[Symbol]
FENCE	[Symbol]
MAJOR CONTOUR	[Symbol]
MINOR CONTOUR	[Symbol]
ASPHALT	[Symbol]
CONCRETE	[Symbol]
GRAVEL	[Symbol]
WOOD DECKING	[Symbol]
SIGN	[Symbol]
SANITARY SEWER LINE MARKER	[Symbol]
MANHOLE AND CLEANOUT	[Symbol]
SEPTIC TANK LID AND VENT PIPE	[Symbol]
WATER LINE MARKER, FIRE HYDRANT	[Symbol]
GATE VALVE, CURB STOP & BLOWOFF	[Symbol]
VENT PIPE, WATER MANHOLE AND WELL	[Symbol]
GAS LINE MARKER, VALVE, MANHOLE/VAULT AND METER	[Symbol]
CABLE LINE MARKER, VAULT AND PEDESTAL	[Symbol]
FIBER OPTIC LINE MARKER, VAULT & PEDESTAL	[Symbol]
SATELLITE DISH	[Symbol]
TELEPHONE LINE MARKER, VAULT, METER AND MANHOLE	[Symbol]
ELECTRIC LINE MARKER, TRANSFORMER, METER AND SECONDARY CONNECTION	[Symbol]
SNOW MELT DISTRIBUTION LINE AND VAULT	[Symbol]
SNOW MAKING WATER MAIN	[Symbol]
ELECTRIC MANHOLE, OUTLET, GENERATOR AND JUNCTION BOX	[Symbol]
LIGHT POLE AND LIGHT POLE W/ MAST	[Symbol]
PROPOSED DITCH / SWALE	[Symbol]
UTILITY POLE, GUY POLE & GUY WIRE	[Symbol]
DITCH/SWALE	[Symbol]
CULVERT W/ END SECTIONS	[Symbol]
STORM MANHOLE, AREA DRAIN, GRATE INLET AND CURB INLET	[Symbol]
AIR CONDITIONER, MAILBOX, NEWSSTAND AND TRASH CAN	[Symbol]
BOLLARD, AREA LIGHT AND FLAG POLE	[Symbol]
CONIFEROUS AND DECIDUOUS TREE (SCALED TO APPROX. DRIPLINE)	[Symbol]
CONIFEROUS AND DECIDUOUS SHRUB (SCALED TO APPROX. DRIPLINE)	[Symbol]
FINISHED FLOOR ELEVATION (SEE NOTE 10)	[Symbol]

NOTES

- THIS EXISTING CONDITIONS PLAN DOES NOT REPRESENT A MONUMENTED LAND SURVEY OR IMPROVEMENT SURVEY. IT IS INTENDED ONLY TO DEPICT THAT INFORMATION REQUESTED BY OUR CLIENT.
- PARCEL AND RIGHT OF WAY BOUNDARIES ARE SHOWN HEREON BASED UPON THE APPLICABLE SUBDIVISION PLATS AND AVAILABLE PROPERTY CORNER MONUMENTS.
- BASES OF HORIZONTAL CONTROL: COLORADO NORTH ZONE, STATE PLANE COORDINATE SYSTEM, NAD83(2011).
- UNITS SHOWN HEREON ARE IN US SURVEY FEET AND THE STANDARD OF DISTANCE ACCURACY FOR THIS MAP HAS BEEN DETERMINED TO BE GREATER THAN 1:10,000.
- SITE BENCHMARK: A RECOVERED 3" BRASS CAP MONUMENTING THE NORTHEAST CORNER OF SECTION 28, TOWNSHIP 6 NORTH, RANGE 84 WEST OF THE 6TH P.M. 35th BRASS CAP ALSO BEING CITY OF STEAMBOAT SPRINGS GIS CONTROL POINT NUMBER 344, HAVING AN ELEVATION OF 6935.31 BASED ON THE NORTH AMERICAN VERTICAL DATUM OF 1988 (NAVD88), AS SHOWN HEREON.
- CONTOUR INTERVAL = 1 FOOT
- BURIED UTILITIES AND/OR PIPE LINES ARE SHOWN PER VISIBLE SURFACE EVIDENCE, AS-BUILT DRAWINGS OF THE CONSTRUCTED UTILITY LINES AND MARKINGS PROVIDED BY A UTILITY LOCATING SERVICE. LOCATIONS SHOWN ARE APPROXIMATE. IF ANY UNDERGROUND UTILITY LOCATIONS ARE REQUIRED, THEY WILL HAVE TO BE VERIFIED BY FIELD POT-HOLING THE UTILITIES. LANDMARK CONSULTANTS, INC. AND THE SURVEYOR OF RECORD SHALL NOT BE LIABLE FOR THE LOCATION OF OR THE FAILURE TO NOTE THE LOCATION OF NON-VISIBLE UTILITIES.
- THE LAST FIELD INSPECTION OF THE SITE WAS ON JANUARY 5, 2021.
- ALL SYMBOLS ARE ONLY GRAPHICALLY REPRESENTED AND ARE NOT TO SCALE.
- FINISH FLOOR ELEVATIONS WERE OBTAINED BY MEASUREMENTS MADE ON LANDINGS OR DOOR SILLS OUTSIDE THE BUILDING. INTERIOR FLOOR ELEVATIONS SHOULD BE VERIFIED WHERE APPROPRIATE.
- WHERE 'MD' IS NOTED FOR STORM/AREA DRAIN INVERTS, THE DRAINS WERE MEASURED DOWN BUT IT WAS UNKNOWN WHETHER THE MEASUREMENT WAS TO A WYE, BEND OR INVERT DUE TO LACK OF VISIBILITY. THE 'MD' IS INTENDED TO REPRESENT MEASURED DEPTH. SOME DISCREPANCIES MAY EXIST.

KEY PLAN

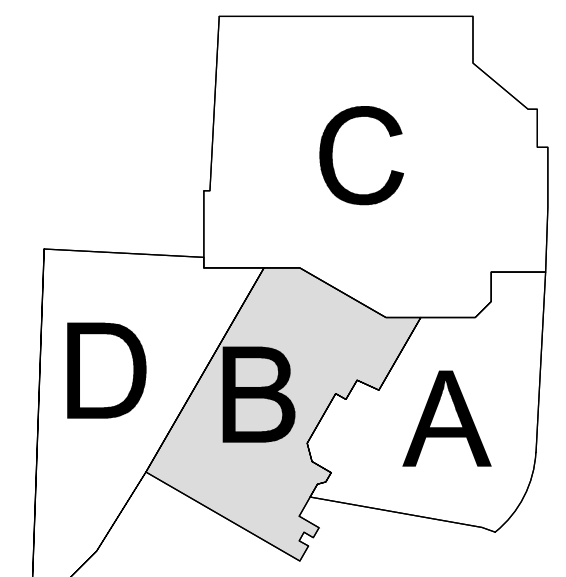

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Date	Description
2021.05.19	BP3: GOLDWALK - ISSUE FOR BID AND PERMIT




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Project Name: GOLD WALK
 SSRC | BASE AREA IMPROVEMENTS
 Project Number: 003.7835.000
 Description: Existing Conditions Plan

Scale: SEE GRAPHICAL SCALE

1B-C.003



EASEMENT LEGEND

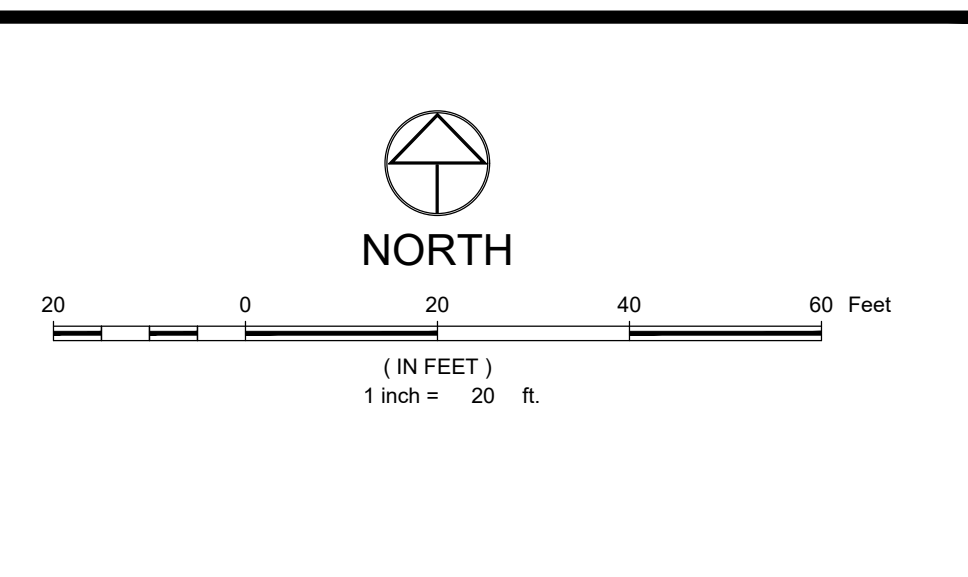- 1 RECEPTION NO. 693016 20' ACCESS EASEMENT EAST HOTEL ACROSS OSP
- 2 BOOK 729, PAGE 339, RECEPTION NO. 746975, BUDDY'S RUN DECK ENCROACHMENT EASEMENT
- 3 RECEPTION NO. 693287 INTERFACE EASEMENT
- 4 RECEPTION NO. 693287 INTERFACE EASEMENT, REVOCABLE PORTION
- 5 BOOK 552, PAGE 600 10' SANITARY SEWER EASEMENT
- 6 RECEPTION NO. 693286 PARKING, ACCESS & MAINTENANCE EASEMENT
- 7 BOOK 729, PAGE 338, RECEPTION NO. 487253, RECEPTION NO. 706974 EAST HOTEL ACCESS EASEMENT AS AMENDED BY RECEPTION NO.
- 8 BOOK 614, PAGE 49 10' PEDESTRIAN AND BICYCLE PATH EASEMENT
- 9 RECEPTION NO. 307130, FILE NO. 8023 12' PEDESTRIAN EASEMENT
- 10 BOOK 374, PAGE 365, BOOK 376, PAGE 316, RECEPTION NO. 770069 20' WATER LINE EASEMENT
- 11 BOOK 337, PAGE 337 PERPETUAL VISUAL EASEMENT
- 12 BOOK 393, PAGE 509 & BOOK 395, PAGE 376 ROAD EASEMENT
- 13 BOOK 412, PAGE 341 ENTRYWAY EASEMENT
- 14 BOOK 412, PAGE 343 ACCESS EASEMENT
- 15 BOOK 560, PAGE 70, RECEPTION NO. 727257, RECEPTION NO. 727903 LANDSCAPING AND ACCESS EASEMENT (BEAR CLAW PI)
- 16 BOOK 745, PAGE 286 20' SEWER EASEMENT
- 17 RECEPTION NO. 673610 & 709075, RECEPTION NO. 709075, RECEPTION NO. 780275 SEWER EASEMENT
- 18 RECEPTION NO. 673610 & 709075, RECEPTION NO. 709075 SEWER EASEMENT RELOCATION AREA
- 19 RECEPTION NO. 789275 SEWER ENCROACHMENT AREA
- 20 RECEPTION NO. 678005 FIRE SEPARATION EASEMENT
- 21 RECEPTION NO. 692162 SKI EASEMENT
- 22 RECEPTION NO. 693153 WATER MAINS EASEMENT
- 23 RECEPTION NO. 696297, RECEPTION NO. 749729, RECEPTION NO. 702319, RECEPTION NO. 713742, PUBLIC IMPROVEMENTS EASEMENT (PATCHED)
- 24 RECEPTION NO. 696297, RECEPTION NO. 713742, PUBLIC IMPROVEMENTS EASEMENT (BOLLER HOUSE)
- 25 RECEPTION NO. 696720 SEWER MAINS EASEMENT
- 26 RECEPTION NO. 696721 WATER MAINS EASEMENT
- 27 RECEPTION NO. 716909, RECEPTION NO. 738617, PUBLIC IMPROVEMENTS EASEMENT (LITTLE P EASEMENT)
- 28 RECEPTION NO. 728242 ACCESS AND LANDSCAPE EASEMENT
- 29 BOOK 583, PAGE 238 & RECEPTION NO. 693278 ACCESS EASEMENT (1ST AMENDMENT EAST HOTEL ACCESS)
- 30 RECEPTION NO. 693296 STORM SEWER & ACCESS AND MAINTENANCE EASEMENT
- 31 RECEPTION NO. 693152 SANITARY SEWER EASEMENT
- 32 RECEPTION NO. ELECTRIC EASEMENT
- 33 RECEPTION NO. GAS EASEMENT
- 34 BOOK 552, PAGE 756 TELEPHONE EASEMENT
- 35 BOOK 601, PAGE 648 10' BICYCLE AND PEDESTRIAN EASEMENT
- 36 RECEPTION NO. 789275 DECK EASEMENT AGREEMENT
- 37 BOOK 629, PAGE 632 PEDESTRIAN ACCESS EASEMENT
- 38 BOOK 552, PAGE 620, BOOK 532, PAGE 774 10' SANITARY SEWER EASEMENT
- 39 BOOK 765, PAGE 976 BUILDING ENCROACHMENT EASEMENT
- 40 RECEPTION NO. 513746 (FILE NO. 12770), RECEPTION NO. 307130 (FILE NO. 8023) STORM SEWER EASEMENT
- 41 BOOK 552, PAGE 756 10' TELEPHONE EASEMENT
- 42 BOOK 568, PAGE 451 EXCLUSIVE PARKING SPACES, ENTRANCE FROM ACCESS ROUTE NO. 1, ENTRANCE FROM ACCESS ROUTE NO. 2, VEHICULAR AND PEDESTRIAN INGRESS AND EGRESS ACCESS EASEMENT, ACCESS ROUTE 2, STORAGE, CLOSET, ELEVATOR & STAIRWAY
- 43 BOOK 552, PAGE 774 10' ELECTRIC EASEMENT
- 44 BOOK 729, PAGE 342 HOTEL ACCESS EASEMENT
- 45 RECEPTION NO. 307130 ACCESS EASEMENT SKI HILL SUBDIVISION
- 46 BOOK 559, PAGE 98 TRUCK TURNAROUND LICENSE AGREEMENT
- 47 RECEPTION NO. 693286 INTERFACE EASEMENT
- 48 RECEPTION NO. 693285 NO BUILD EASEMENT
- 49 BOOK 598, PAGE 1487, EX C-7 BUILDING IMPROVEMENT EASEMENT
- 50 RECEPTION NO. 693980 AERIAL TRAMWAY EASEMENT
- 51 RECEPTION NO. 690175 SHORING EASEMENT AGREEMENT
- 52 RECEPTION NO. 690206 GONDOLA EXPANSION EASEMENT (MULTIPLE EXHIBITS), GONDOLA SQUARE ACCESS EASEMENT, WEST SIDE DRAINAGE EASEMENT, ETC.
- 53 RECEPTION NO. 693283 PEDESTRIAN ACCESS EASEMENT OSP
- 54 BOOK 552, PAGE 802 10' WATERLINE EASEMENT
- 55 RECEPTION NO. 693285 PATIO EASEMENT, DOORWAY EASEMENT, ENTRY EASEMENTS
- 56 RECEPTION NO. 693280 SANITARY SEWER EASEMENT
- 57 RECEPTION NO. 693283 EMERGENCY ACCESS EASEMENT OSP
- 58 RECEPTION NO. 693289 SKI AREA EASEMENT, STORM SEWER & DRAINAGE EASEMENT, RECIPROCAL UTILITY EASEMENT, GONDOLA SQUARE ACCESS EASEMENT
- 59 RECEPTION NO. 693016, BOOK 729, PAGE 338 AGREEMENT (ACCESS TO EASTERN SIDE OF HOTEL)
- 60 RECEPTION NO. 693278 DECLARATION OF EASEMENT
- 61 RECEPTION NO. 690979 ACCESS EASEMENT
- 62 BOOK 598, PAGE 1487, EX C-7 WALKWAY EASEMENT
- 63 RECEPTION NO. 690209, BOOK 598, PAGE 1487, EX C-8 AND C-9 STORM SEWER LINE EASEMENT AND STORM LINE EASEMENT
- 64 BOOK 588, PAGE 473 PRIVATE RIGHT-OF-WAY
- 65 RECEPTION NO. 691698 OSP EASEMENT AREA
- 66 RECEPTION NO. 693018 RIGHT OF WAY EASEMENT (ELECTRIC)
- 67 RECEPTION NO. 693279 SNOWMOWING LINE EASEMENT
- 68 BOOK 588, PAGE 238 30' ACCESS EASEMENT
- 69 BOOK 519, PAGE 577 10' TELEPHONE EASEMENT
- 70 BOOK 729, PAGE 343 HOTEL BRIDGE ACCESS, PEDESTRIAN AND EMERGENCY AND MAINTENANCE VEHICLE ACCESS
- 71 BOOK 552, PAGE 762 ELECTRIC EASEMENT


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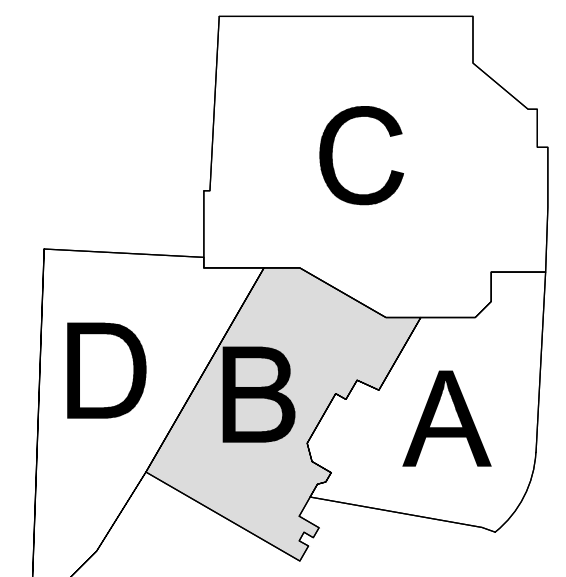


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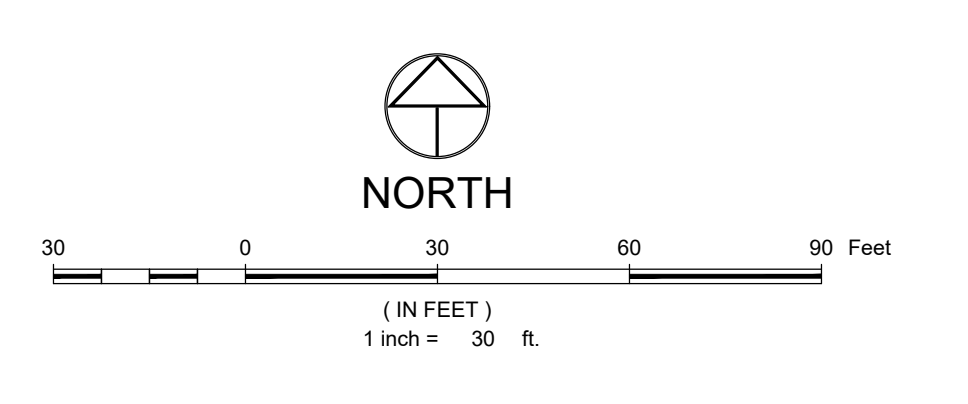
KEY PLAN




Project Name: GOLD WALK
 SSRC | BASE AREA IMPROVEMENTS
 Project Number: 003.7835.000
 Description: Existing Property Easement Exhibit

Scale: SEE GRAPHICAL SCALE

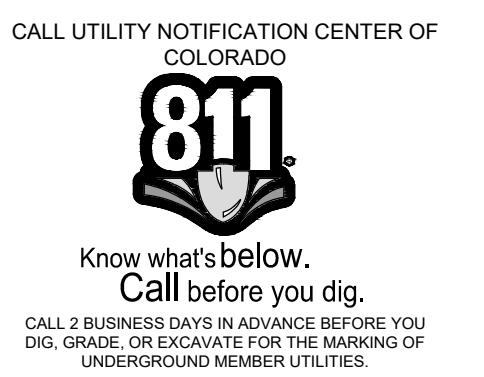1B-C.004



LEGEND

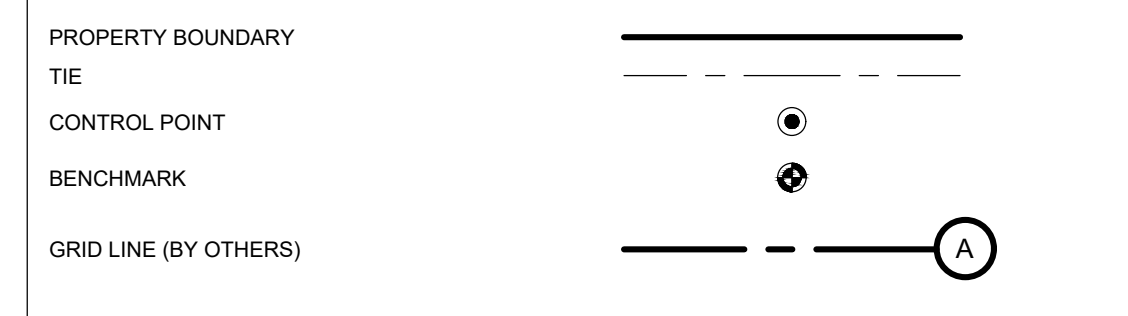

NOTES

- ALL REFERENCES HEREON TO BOOKS, PAGES, FILES, RECEPTION NUMBERS AND FILE NUMBERS ARE TO PUBLIC DOCUMENTS FILED IN THE RECORDS OF ROUTT COUNTY, COLORADO.
- COORDINATES AND BEARINGS SHOWN HEREON ARE COLORADO COORDINATE SYSTEM, NORTH ZONE 6501, US SURVEY FEET, NAD83(2011).
- BASIS OF BEARINGS: A GRID BEARING OF 73°07'30" BETWEEN THE PROJECT BENCHMARKS AS MONUMENTED AND SHOWN HEREON.
- THE POSITION AND ALIGNMENT OF THE GRIDLINES SHOWN HEREON MUST BE COORDINATED WITH THE ARCHITECTURAL AND STRUCTURAL PLANS.

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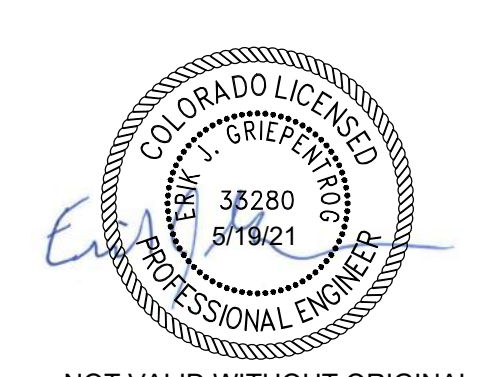
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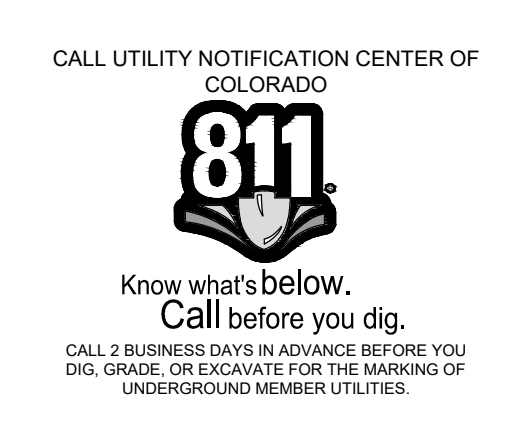
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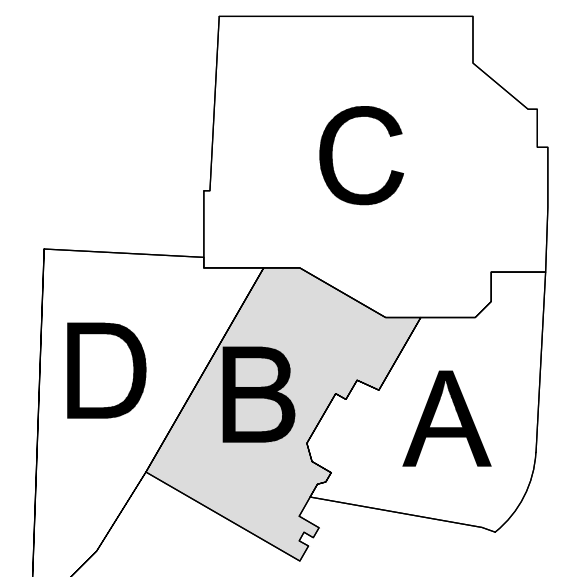


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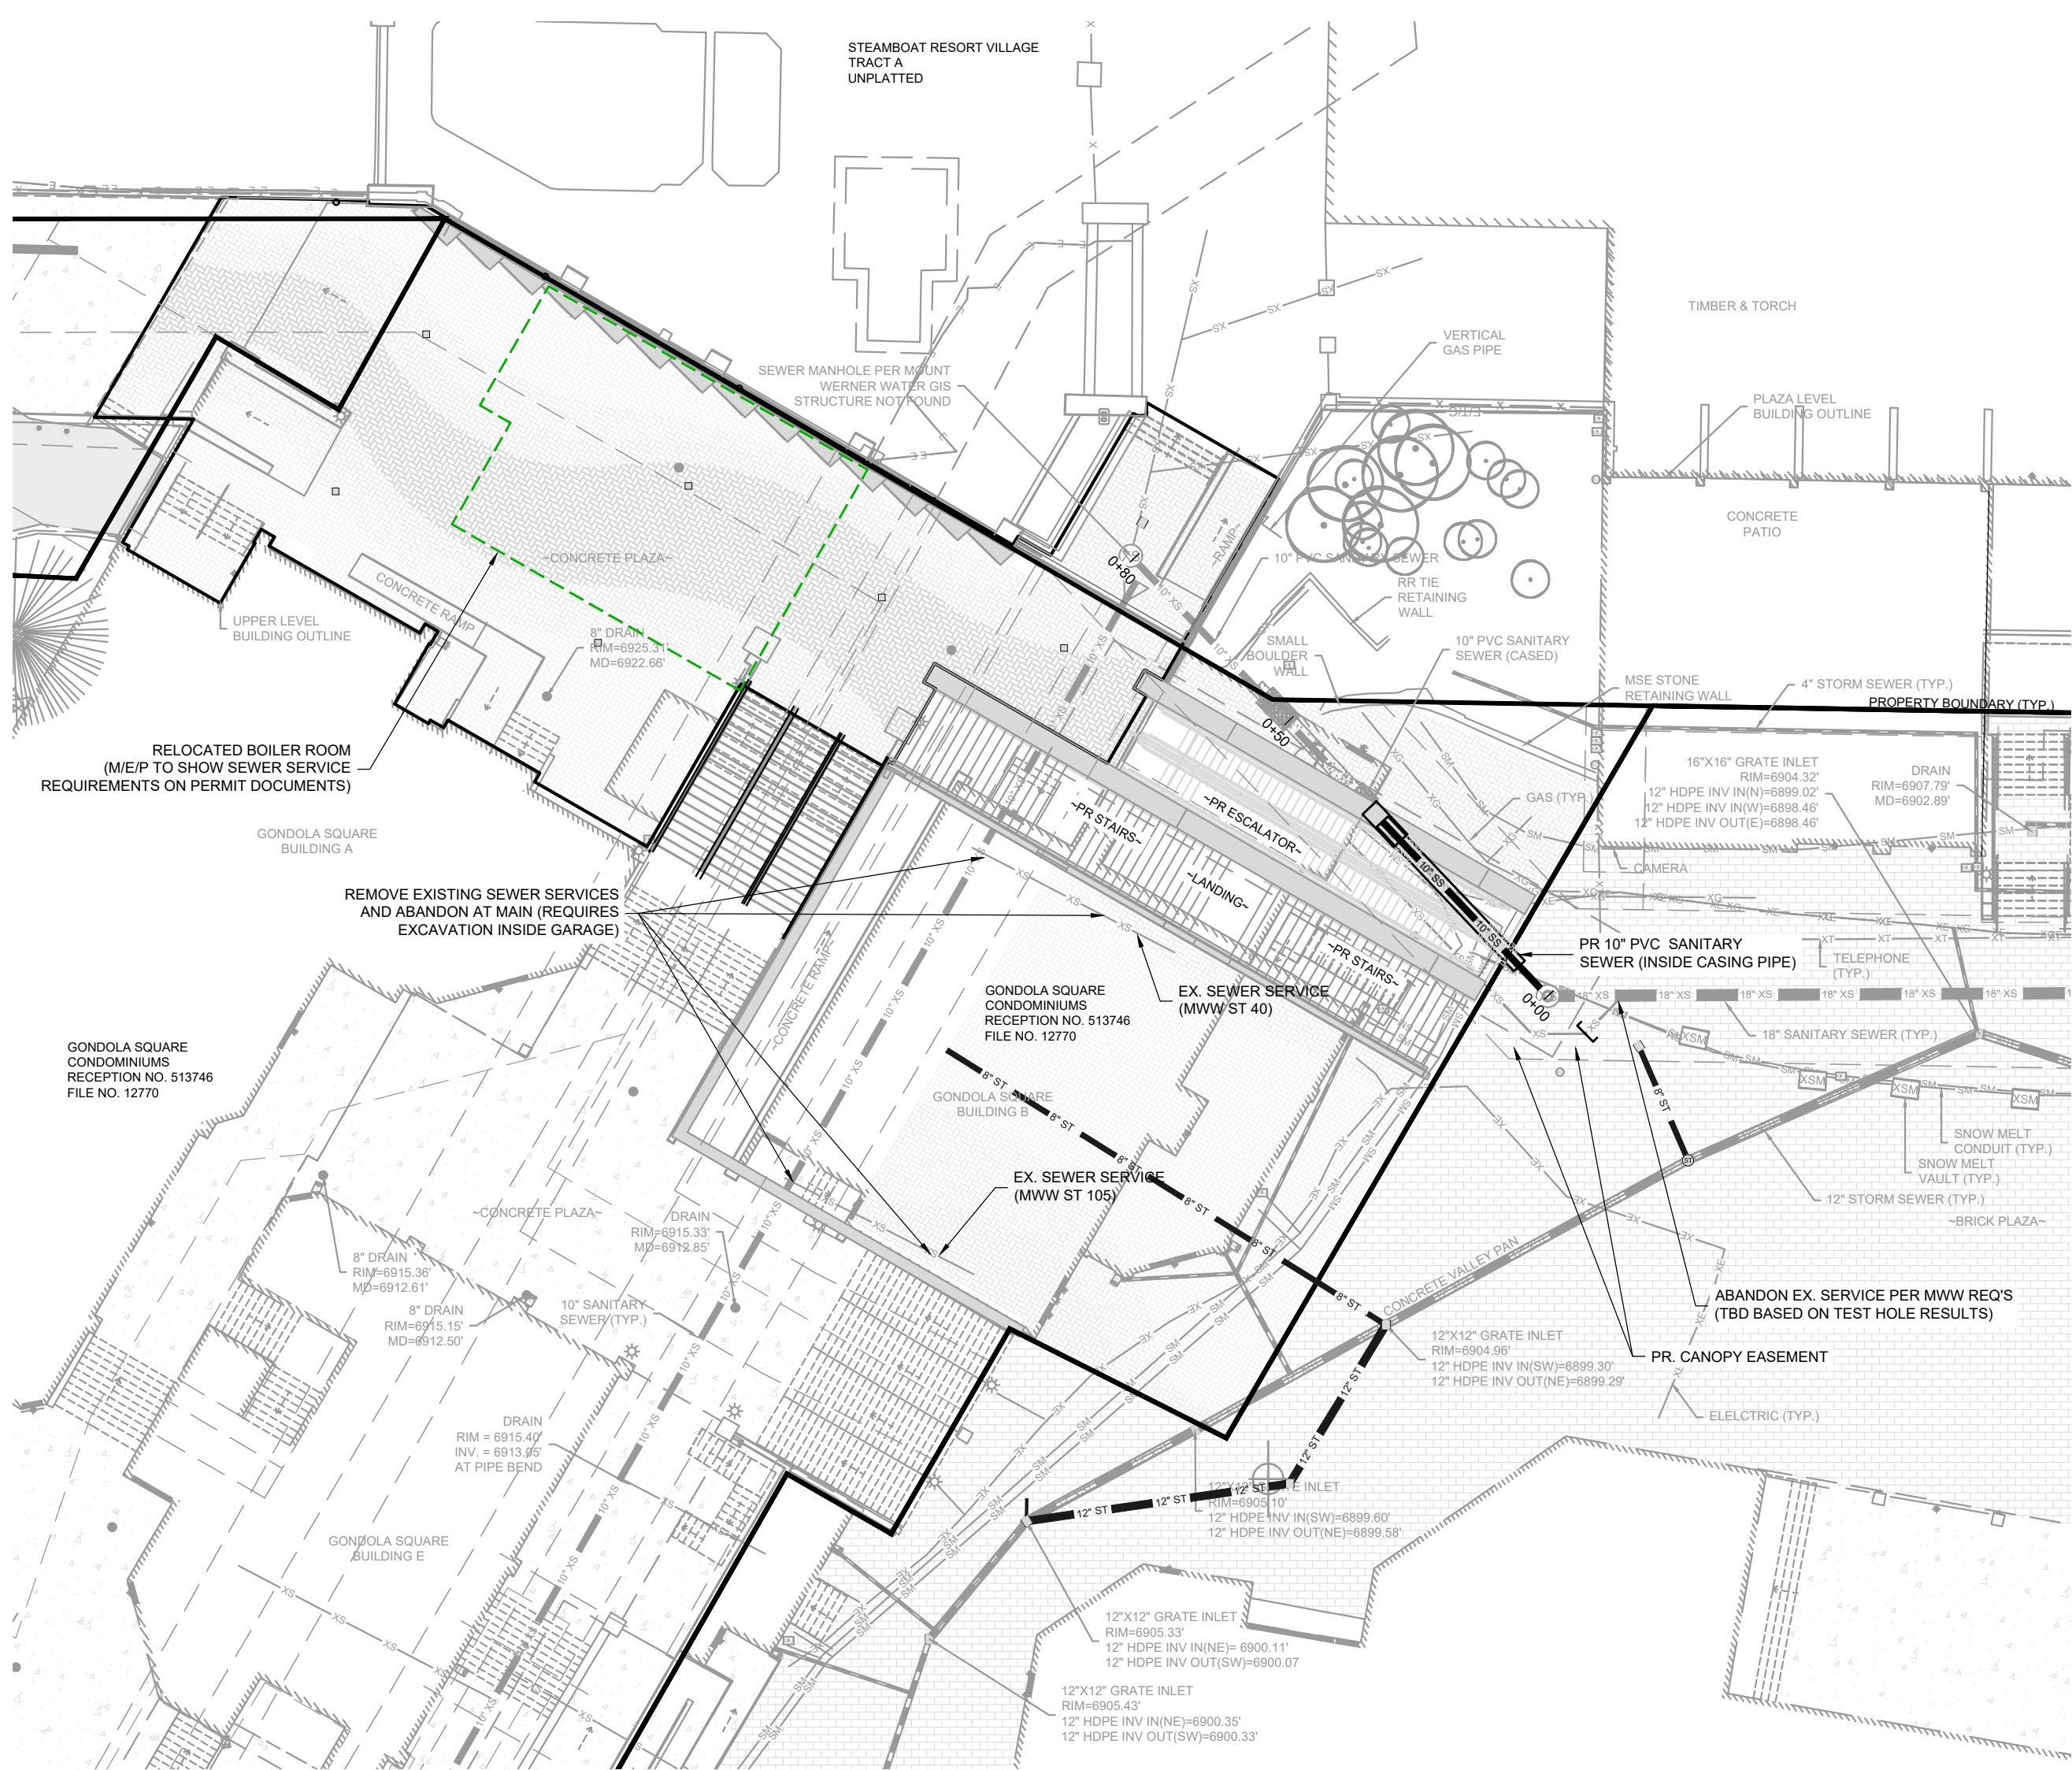
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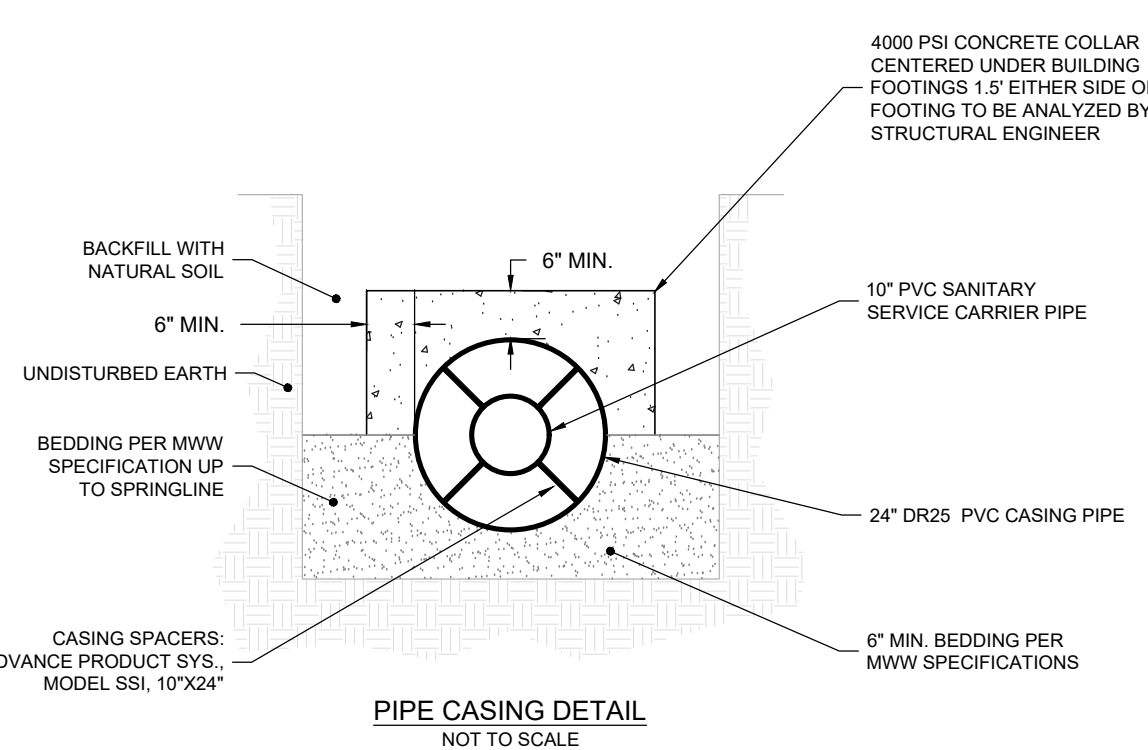
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 Project Number: 003.7835.000
 Description: HORIZONTAL CONTROL PLAN

Scale: SEE GRAPHICAL SCALE


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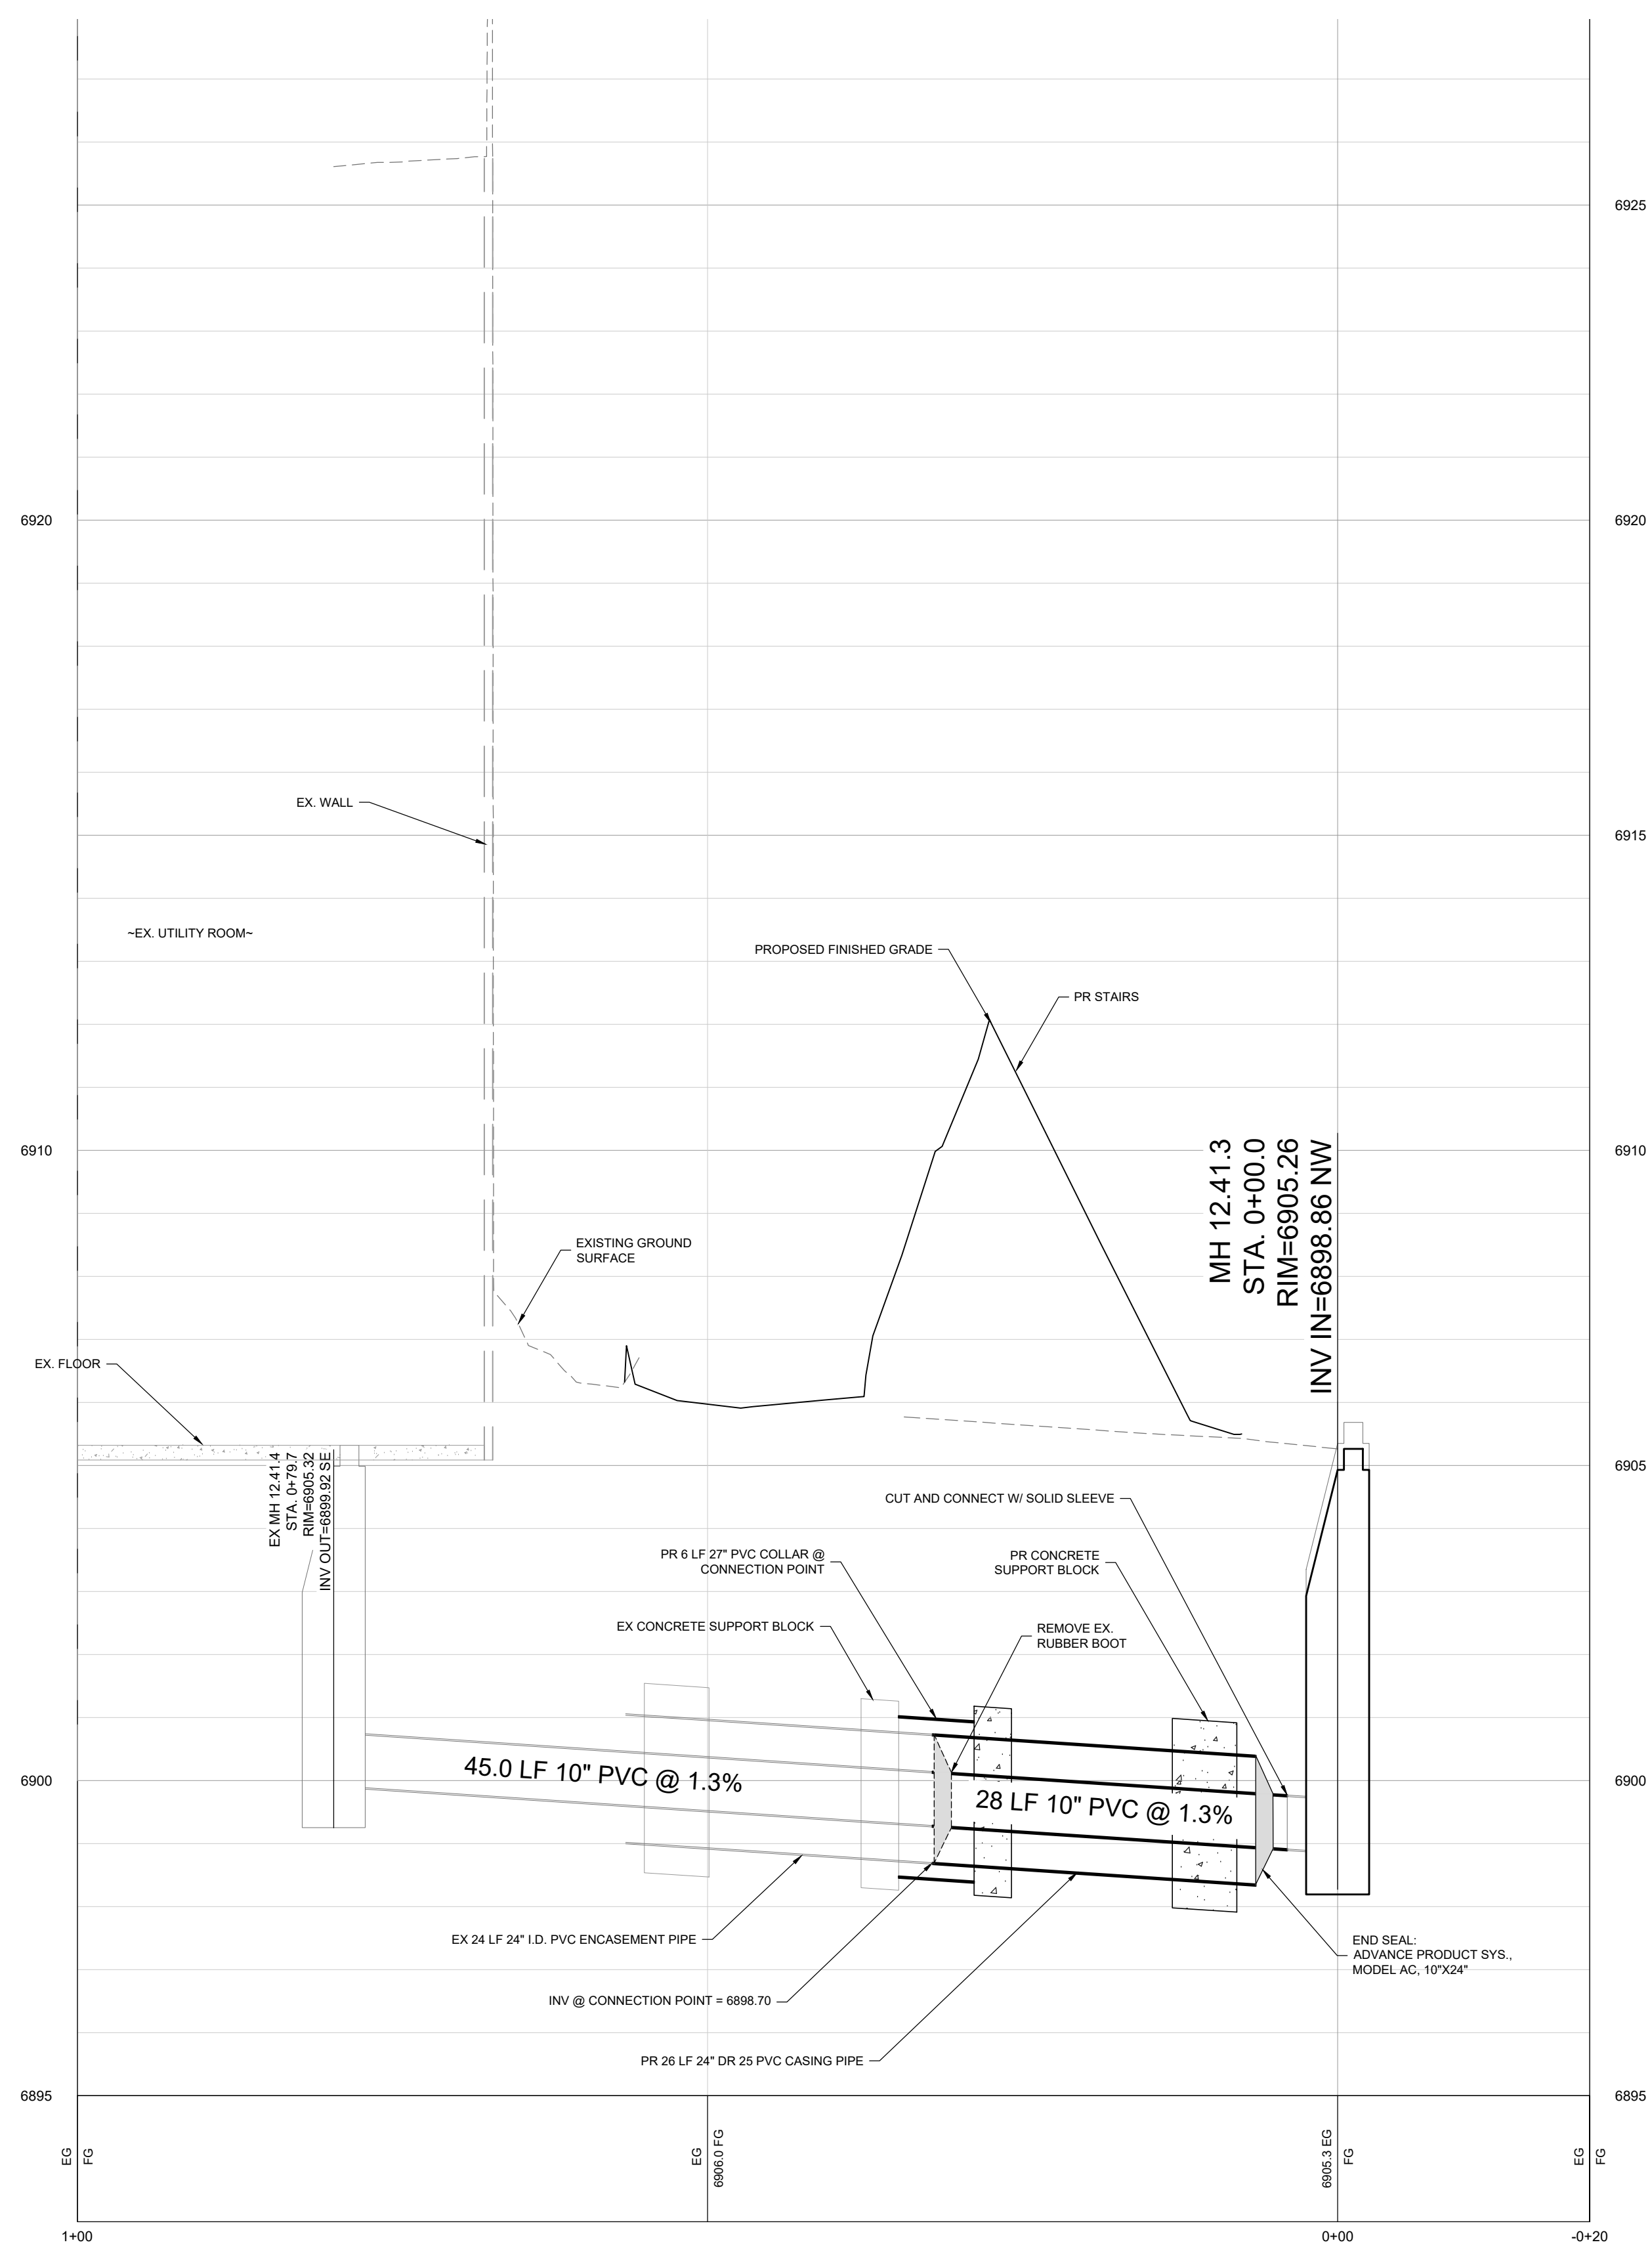
SEWER PLAN
SCALE: 1" = 20'



PIPE CASING DETAIL
NOT TO SCALE



SEWER PLAN & PROFILE (STA 0+00 - 0+80)
SCALE: 1" = 10' (H) 1" = 1' (V)

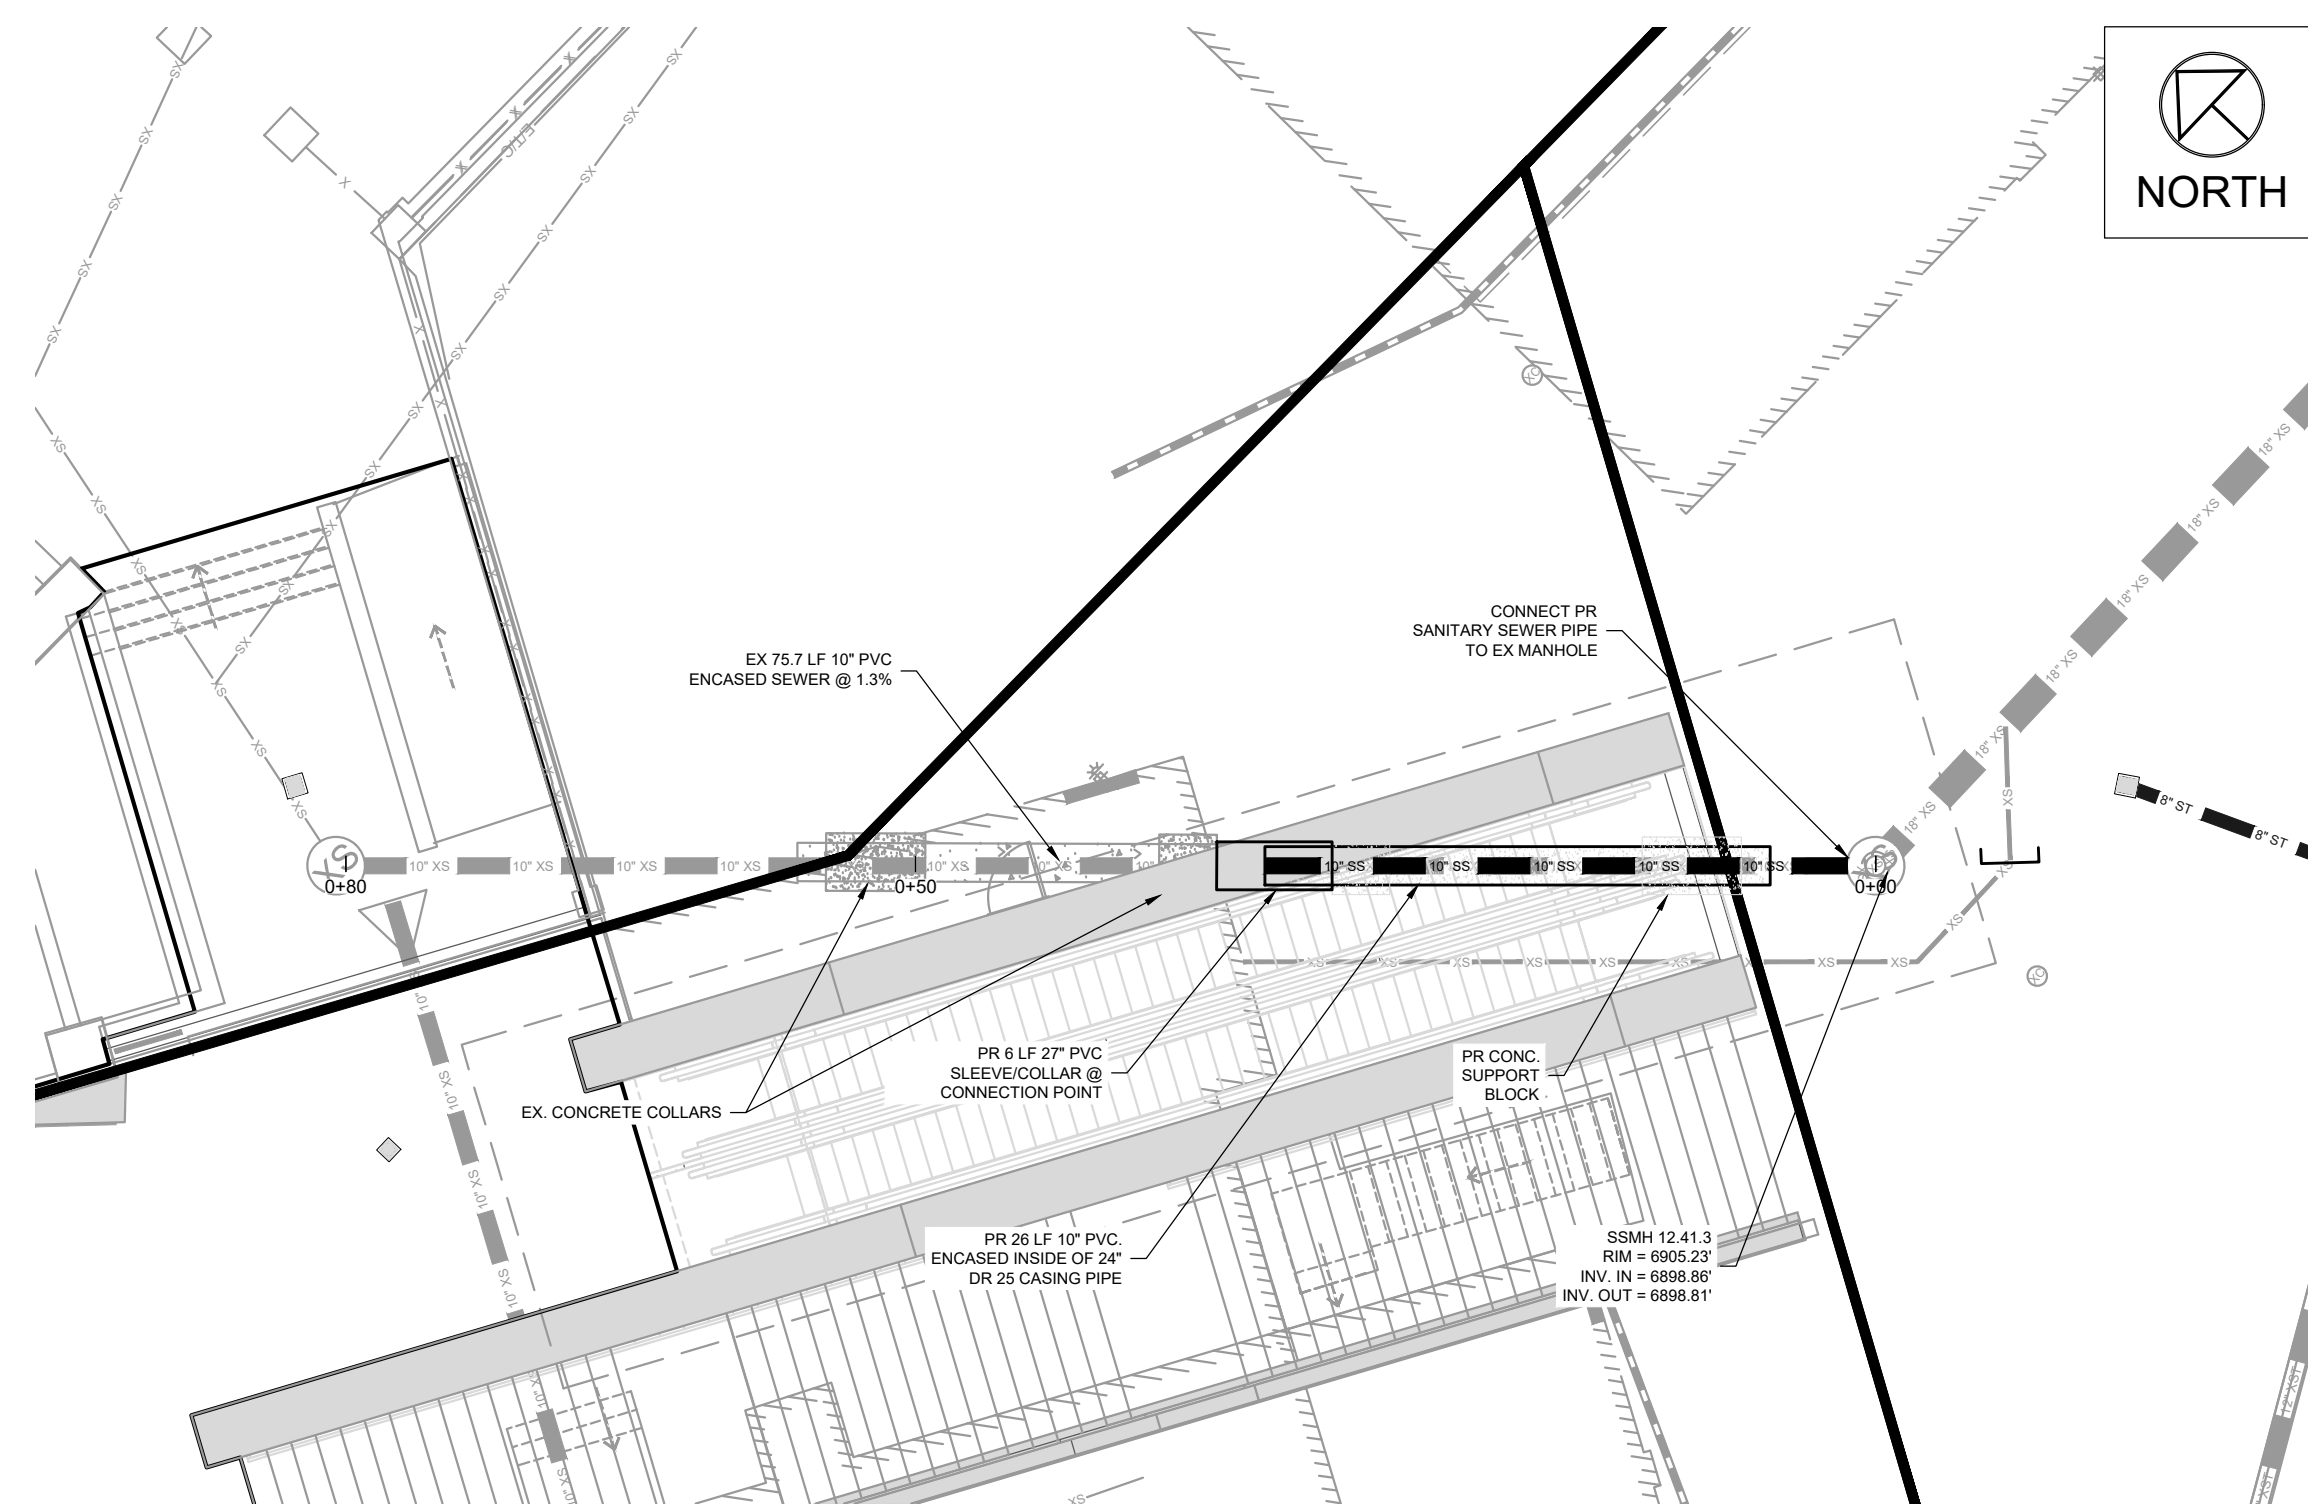


LEGEND

PROPOSED 8" SANITARY SEWER W/ MH & C.O.	8" SB
EXISTING 8" SANITARY SEWER W/ MH & C.O.	8" EX
EX. SANITARY SEWER TO BE REMOVED OR ABANDONED	XS DEMO
PROPOSED 8" WATER PIPE	8" W
PROPOSED GV, FH & CS	8" W
EXISTING WATER	8" EX W
EX. WATER TO BE REMOVED OR ABANDONED	XW DEMO
EXISTING GV & FH	8" EX W
PROPOSED STORMCULVERT, INLET, MH, END SECTION WITH RIPRAP	ST
EXIST 8" STORMCULVERT, INLET, MH, END SECTION WITH RIPRAP	ST EX
EX. STORMCULVERT TO BE REMOVED OR ABANDONED	XST DEMO
PROPOSED CONDUIT/DUCT BANK	CD

NOTES

- THE SIZE, TYPE AND LOCATION OF ALL KNOWN UNDERGROUND UTILITIES ARE APPROXIMATE WHEN SHOWN ON THESE DRAWINGS. IT SHALL BE THE RESPONSIBILITY OF THE CONTRACTOR TO VERIFY THE EXISTENCE OF ALL UNDERGROUND UTILITIES IN THE AREA OF THE WORK. BEFORE COMMENCING NEW CONSTRUCTION, THE CONTRACTOR SHALL BE RESPONSIBLE FOR LOCATING ALL UNDERGROUND UTILITIES AND SHALL BE RESPONSIBLE FOR ALL UNKNOWN UNDERGROUND UTILITIES.
- EXISTING UNDERGROUND AND OVERHEAD PUBLIC AND PRIVATE UTILITIES AS SHOWN ARE INDICATED ACCORDING TO THE BEST INFORMATION MADE AVAILABLE TO THE ENGINEER. THE ENGINEER DOES NOT GUARANTEE NOR IS RESPONSIBLE FOR THE ACCURACY OF SUCH INFORMATION. EXISTING UTILITY MAINS AND SERVICES MAY NOT BE STRAIGHT LINES OR AS INDICATED ON THESE DRAWINGS. CONTRACTOR TO VERIFY EXISTING HORIZONTAL AND VERTICAL LOCATIONS PRIOR TO CONSTRUCTION.
- ALL SEWER CONSTRUCTION SHALL BE PER MOUNT WERNER WATER STANDARD SPECIFICATIONS, LATEST EDITION.
- MAINTAIN 12" HORIZONTAL AND 18" VERTICAL MINIMUM SEPARATION BETWEEN ALL SANITARY SEWER MAINS, WATER MAINS & SERVICES.
- MANHOLES LOCATED OUTSIDE OF PAVEMENTS SHALL PROTRUDE 1" ABOVE EXISTING GRADE TO REDUCE INFILTRATION. GRADE SURFACE TO DRAIN AROUND/AWAY FROM MANHOLE RIMS.
- ALL MANHOLES LOCATED IN PAVEMENTS SHALL HAVE RIM ELEVATIONS ADJUSTED TO 1/2" BELOW FINISHED GRADE. IF NECESSARY, CONE SECTIONS SHALL BE ROTATED TO PREVENT LIDS BEING LOCATED WITHIN VEHICLE OR BICYCLE WHEEL PATHS.
- SEWER SERVICE SHALL HAVE A MINIMUM OF 4-FT OF COVER.
- WATER SERVICE SHALL HAVE A MINIMUM OF 7-FT OF COVER.
- ALL WATER PIPE SHALL BE INSTALLED WITH A #10 SOLID COPPER WIRE COATED WITH 45 MIL POLYETHYLENE FOR LOCATING PURPOSES. "GLENN TEST STATIONS" BY VALVCO, INC TRACKER WIRE TEST STATIONS SHALL BE INSTALLED ADJACENT TO ALL FIRE HYDRANTS. ADDITIONAL LOCATIONS MAY BE REQUIRED.
- ALL MATERIALS USED FOR BACKFILL SHALL BE FREE FROM REFUSE ORGANIC MATERIAL, COBBLES, BOULDERS, LARGE ROCKS OR STONES OR FROZEN SOILS GREATER THAN 6-INCHES IN DIAMETER.
- ALL TRENCHES SHALL BE COMPACTED TO 95% AS DETERMINED BY ASTM D698 (STANDARD PROCTOR) OR AS SPECIFIED BY GEOTECHNICAL ENGINEER.
- BEDDING AND SHADING MATERIALS SHALL ONLY BE 3/4-INCH WASHED OR SCREENED ROCK, 3/4-INCH MINUS, SQUEEGEE OR REJECT SAND, OR CLASS 6 AGGREGATE BASE COURSE IS NOT ALLOWED.

KEY PLAN

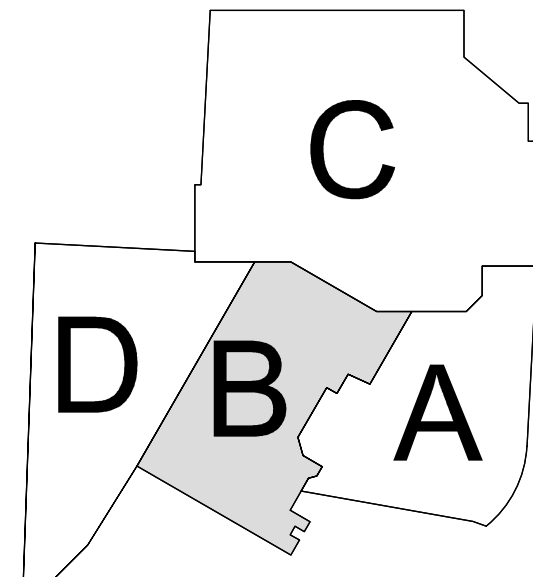

Scale
SEE GRAPHICAL SCALE

1B-C.200

Date	Description
2021.05.19	BP3: GOLDWALK - ISSUE FOR BID AND PERMIT



NOT VALID WITHOUT ORIGINAL SIGNATURE AND DATE

Seal / Signature

Project Name GOLD WALK


SSRC | BASE AREA IMPROVEMENTS

Project Number 003.7835.000

Description Sewer Plan and Profile

Scale SEE GRAPHICAL SCALE

1B-C.200

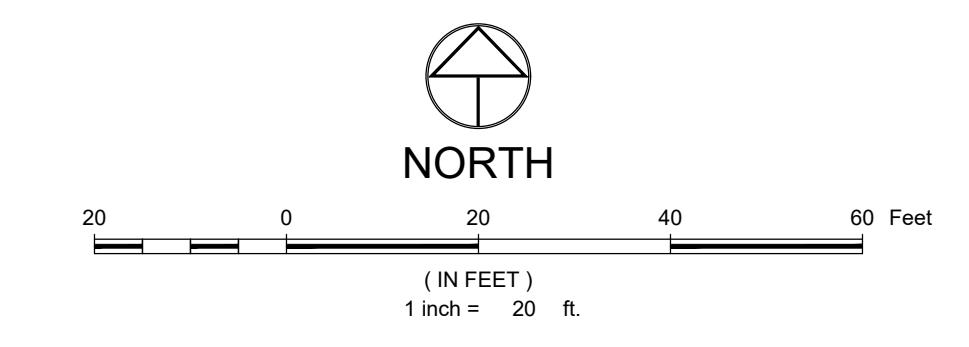

LEGEND


PROPOSED 8" SANITARY SEWER W/ MH & C.O.	
EXISTING 8" SANITARY SEWER W/ MH & C.O.	
EX. SANITARY SEWER TO BE REMOVED OR ABANDONED	
PROPOSED 8" WATER PIPE	
PROPOSED GV, FH & CS	
EXISTING WATER	
EX. WATER TO BE REMOVED OR ABANDONED	
EXISTING GV & FH	
PROPOSED STORMCULVERT, INLET, MH, END SECTION WITH RIPRAP	
EXIST 8" STORMCULVERT, INLET, MH, END SECTION WITH RIPRAP	
EX. STORMCULVERT TO BE REMOVED OR ABANDONED	
PROPOSED CONDUIT/DUCT BANK	

NOTES

1. THE SIZE, TYPE AND LOCATION OF ALL KNOWN UNDERGROUND UTILITIES ARE APPROXIMATE WHEN SHOWN ON THESE DRAWINGS. IT SHALL BE THE RESPONSIBILITY OF THE CONTRACTOR TO VERIFY THE EXISTENCE OF ALL UNDERGROUND UTILITIES IN THE AREA OF THE WORK. BEFORE COMMENCING NEW CONSTRUCTION, THE CONTRACTOR SHALL BE RESPONSIBLE FOR LOCATING ALL UNDERGROUND UTILITIES AND SHALL BE RESPONSIBLE FOR ALL UNKNOWN UNDERGROUND UTILITIES.
2. EXISTING UNDERGROUND AND OVERHEAD PUBLIC AND PRIVATE UTILITIES AS SHOWN ARE INDICATED ACCORDING TO THE BEST INFORMATION MADE AVAILABLE TO THE ENGINEER. THE ENGINEER DOES NOT GUARANTEE NOR IS RESPONSIBLE FOR THE ACCURACY OF SUCH INFORMATION. EXISTING UTILITY MAINS AND SERVICES MAY NOT BE STRAIGHT LINES OR AS INDICATED ON THESE DRAWINGS. CONTRACTOR TO VERIFY EXISTING HORIZONTAL AND VERTICAL LOCATIONS PRIOR TO CONSTRUCTION.
3. ALL SEWER CONSTRUCTION SHALL BE PER MOUNT WERNER WATER STANDARD SPECIFICATIONS, LATEST EDITION.
4. MAINTAIN 12" HORIZONTAL AND 18" VERTICAL MINIMUM SEPARATION BETWEEN ALL SANITARY SEWER MAINS, WATER MAINS & SERVICES.
5. MANHOLES LOCATED OUTSIDE OF PAVEMENTS SHALL PROTRUDE 1" ABOVE EXISTING GRADE TO REDUCE INFILTRATION. GRADE SURFACE TO DRAIN AROUND/AWAY FROM MANHOLE RIMS.
6. ALL MANHOLES LOCATED IN PAVEMENTS SHALL HAVE RIM ELEVATIONS ADJUSTED TO 1/4" BELOW FINISHED GRADE. IF NECESSARY, CONE SECTIONS SHALL BE ROTATED TO PREVENT LIDS BEING LOCATED WITHIN VELOCITY OR BICYCLE WHEEL PATHS.
7. SEWER SERVICE SHALL HAVE A MINIMUM OF 4-FT. OF COVER.
8. WATER SERVICE SHALL HAVE A MINIMUM OF 7-FT. OF COVER.
9. ALL WATER PIPE SHALL BE INSTALLED WITH A #10 SOLID COPPER WIRE COATED WITH 45 MIL POLYETHYLENE FOR LOCATING PURPOSES. "GLENN TEST STATIONS" BY VALVO, INC TRACER WIRE TEST STATIONS SHALL BE INSTALLED ADJACENT TO ALL FIRE HYDRANTS. ADDITIONAL LOCATIONS MAY BE REQUIRED.
10. ALL MATERIALS USED FOR BACKFILL SHALL BE FREE FROM REFUSE ORGANIC MATERIAL, COBBLES, BOULDERS, LARGE ROCKS OR STONES OR FROZEN SOILS GREATER THAN 6-INCHES IN DIAMETER.
11. ALL TRENCHES SHALL BE COMPACTED TO 95% AS DETERMINED BY ASTM D698 (STANDARD PROCTOR) OR AS SPECIFIED BY GEOTECHNICAL ENGINEER.
12. BEDDING AND SHADING MATERIALS SHALL ONLY BE 3/4-INCH WASHED OR SCREENED ROCK, 3/4-INCH MINUS, SQUEEGEE OR REJECT SAND, OR CLASS 6 AGGREGATE BASE COURSE IS NOT ALLOWED.

CONCEPTUAL BYPASS NOTES:


- THE CONCEPTUAL BYPASS INFORMATION DEPICTED HEREON IS INTENDED TO ESTABLISH AN EXPECTATION OF THE ANTICIPATED MINIMUMS FOR CONSIDERATION TO CONSTRUCTION OF THE NECESSARY SEWER IMPROVEMENTS. ADDITIONAL INFORMATION WILL BE INCLUDED IN THE CONSTRUCTION DOCUMENTS AS THE FINAL PLAN PROGRESSES FOR THE MEANS AND METHODS TO PERFORM THE WORK.
1. THE CONTRACTOR SHALL DEVELOP A PLAN TO CONSTRUCT THE REQUIRED SEWER IMPROVEMENTS AND PRESENT TO ENGINEER AND MT. WERNER WATER FOR REVIEW. AFTER ANY NECESSARY REVISIONS HAVE BEEN ADDRESSED, THE CONTRACTOR'S PLAN WILL BE PRESENTED TO THE OWNER FOR COORDINATION WITH THE SHERATON OPERATORS.
 2. CONTRACTOR TO OBTAIN BEST AVAILABLE FLOW DATA FROM SHERATON OPERATORS AND/OR MT. WERNER WATER FOR DETERMINING PUMP CAPACITY.
 3. CONTRACTOR TO EXPOSE THE EXISTING SEWER ENCASUREMENT IN PRESENCE OF ENGINEER TO DETERMINE OR CONFIRM BRAND AND MODEL SPECIFICS FOR CASING PIPE, PIPE SPACERS AND THE RUBBER BOOT PRIOR TO PROCUREMENT.
 4. TO REDUCE THE PERIOD OF BY-PASS PUMPING, THE CONTRACTOR SHALL EXPOSE THE LIMITS OF PIPE TO BE REPLACED AND PREPARE THE MANHOLE FOR ACCESSING THE WORK. PRE-ASSEMBLE THE PIPE ENCASUREMENT TO THE EXTENT PRACTICABLE.
 5. PRIOR TO INTERRUPTING THE SEWER SERVICE, PROVIDE 48 HOURS ADVANCE NOTIFICATION TO OWNER FOR COORDINATING WITH THE AFFECTED PARTIES.
 6. CONTRACTOR TO PROVIDE ADEQUATE PERSONNEL TO SIMULTANEOUSLY WORK ON PIPE INSTALLATION AND MANHOLE CONNECTION WHILE MONITORING PUMPING SYSTEM.
 7. POSITION PUMP DISCHARGE HOSE AROUND LIMITS OF PIPE AND MANHOLE WORK AND PROTECT FROM CONSTRUCTION ACTIVITY. IT IS ANTICIPATED THAT THE HOSE WILL EITHER RUN OUT OF THE UTILITY ROOM THROUGH THE EXISTING WALL VENT OR, IF TIMING ALLOWS, THROUGH THE BOILER ROOM RELOCATION PATH. A BACKUP GAS POWERED GENERATOR SHALL BE ON-HAND IN THE EVENT OF A POWER FAILURE.
 8. PLUG DOWNSTREAM OUTLET OF MH 12.41.4 AND PUMP INTO MH 12.41.2. CONTRACTOR MAY ELECT TO CONDUCT AIR LEAKAGE TEST ON EXISTING SYSTEM PRIOR TO COMMENCEMENT. DO NOT DISCHARGE INTO ADJACENT CLEANOUT.
 9. CUT EXISTING PIPE AT PREPARED LOCATION AND INSTALL PRE-ASSEMBLED CASED PIPE.
 10. AFTER INSTALLATION, CONTRACTOR TO PERFORM AIR LEAKAGE TEST PRIOR TO PLACING CONCRETE COLLARS AND CORRECT ANY AREAS OF DEFICIENCY.
 11. COMPLETE ENCASUREMENT AND INITIAL BACKFILL.
 12. REPEAT AIR TEST.
 13. REMOVE PLUG AND END BY-PASS PUMPING AFTER ENGINEER APPROVAL.

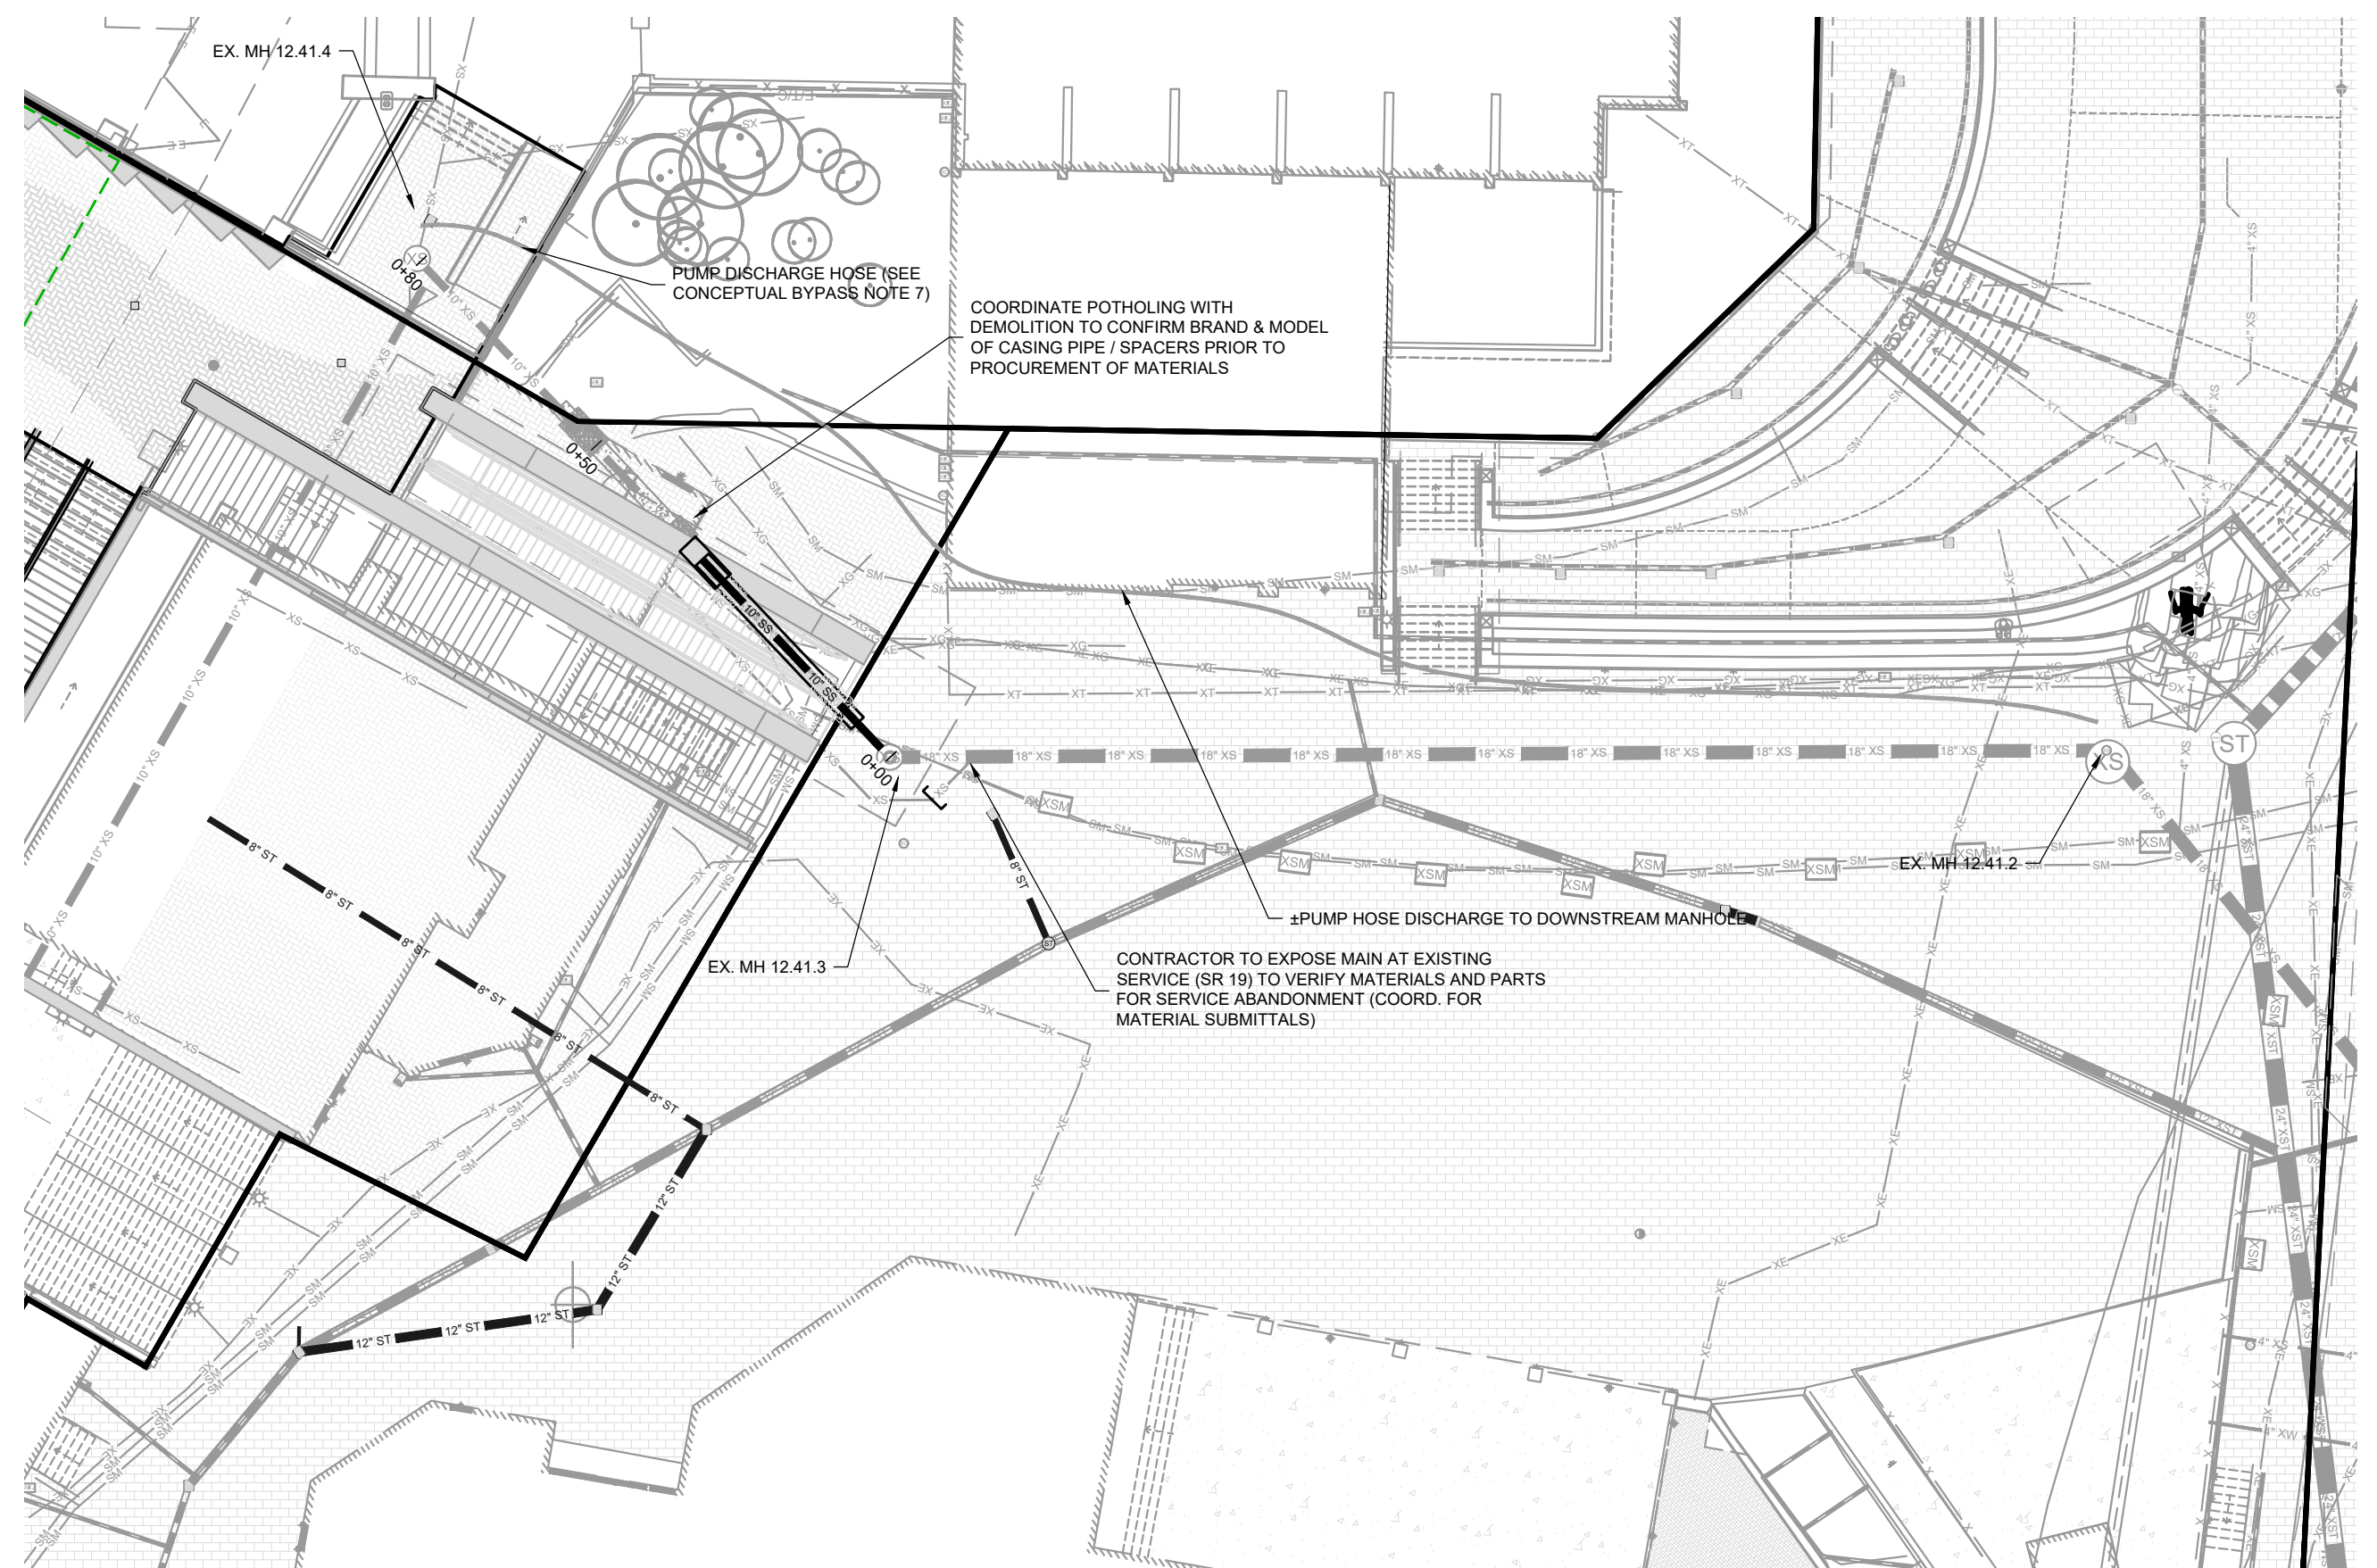

CONCEPTUAL SEWER BYPASS PUMPING PLAN
SCALE: 1" = 20'



KEY PLAN

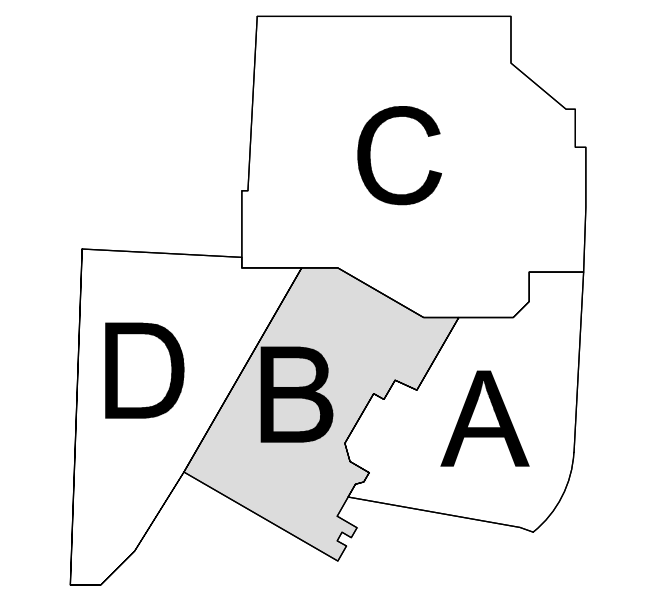

Date	Description
2021.05.19	BP3: GOLDWALK - ISSUE FOR BID AND PERMIT




NOT VALID WITHOUT ORIGINAL SIGNATURE AND DATE

Seal / Signature

Project Name: GOLD WALK
SSRC | BASE AREA IMPROVEMENTS
Project Number: 003.7835.000
Description: Sewer Construction Exhibit

Scale: SEE GRAPHICAL SCALE

1B-C.250

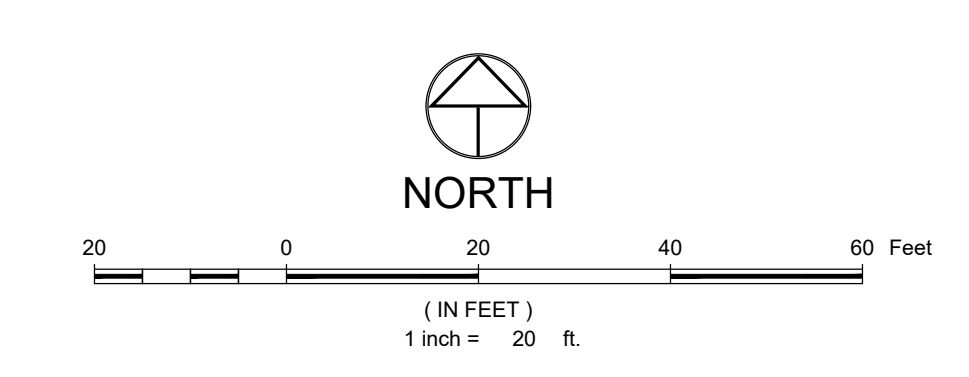


LEGEND

EXISTING STORM SEWER	
PROPOSED STORM SEWER	
PROPOSED STORM INLET (CURB & AREA)	
PROPOSED MAJOR CONTOUR	
PROPOSED MINOR CONTOUR	
EXISTING MAJOR CONTOUR	
EXISTING MINOR CONTOUR	
PROPOSED SWALE	
PROPOSED CURB & GUTTER	
PROPERTY BOUNDARY	
PROPOSED LOT LINE	
EXISTING RIGHT OF WAY	
FLOOD HAZARD LIMITS	
PROPOSED SPOT ELEVATION	
EXISTING SPOT ELEVATION	
PROPOSED OVERLAND FLOW DIRECTION W/SLOPE	
EXISTING OVERLAND FLOW DIRECTION W/SLOPE	
PROPOSED CHANNELIZED FLOW DIRECTION W/ SLOPE	
EXISTING CHANNELIZED FLOW DIRECTION	


NOTES

1. THE SIZE, TYPE AND LOCATION OF ALL KNOWN UNDERGROUND UTILITIES ARE APPROXIMATE WHEN SHOWN ON THESE DRAWINGS. IT SHALL BE THE RESPONSIBILITY OF THE DEVELOPER TO VERIFY THE EXISTENCE OF ALL UNDERGROUND UTILITIES IN THE AREA OF THE WORK. BEFORE COMMENCING NEW CONSTRUCTION, THE CONTRACTOR SHALL BE RESPONSIBLE FOR LOCATING ALL UNDERGROUND UTILITIES AND SHALL BE RESPONSIBLE FOR ALL UNKNOWN UNDERGROUND UTILITIES.
2. ALL PROJECT DATA IS ON VERTICAL DATUM, NAVD 88. SEE NOTES SHEET FOR BENCHMARK REFERENCES.
3. ELEVATIONS FOR IMPROVEMENTS THAT ARE CONTROLLED BY ADJACENT EXISTING FACILITIES (SUCH AS PROPOSED GUTTERS ALONG EXISTING ASPHALT) MAY REQUIRE ADJUSTMENT BASED ON ACTUAL CONDITIONS. COORDINATE WITH ENGINEERS TO ENSURE A CONSISTENT SECTION WITH SMOOTH TRANSITIONS WHERE NECESSARY.
4. SEE SOILS REPORT FOR PAVEMENT, SUBGRADE AND MATERIAL PREPARATION, DESIGN AND RECOMMENDATIONS.
5. ALL CURB SPOTS SHOWN ARE FLOWLINE ELEVATIONS, UNLESS NOTED OTHERWISE. ALL OTHER SPOTS ARE FINISHED GRADE ELEVATIONS.

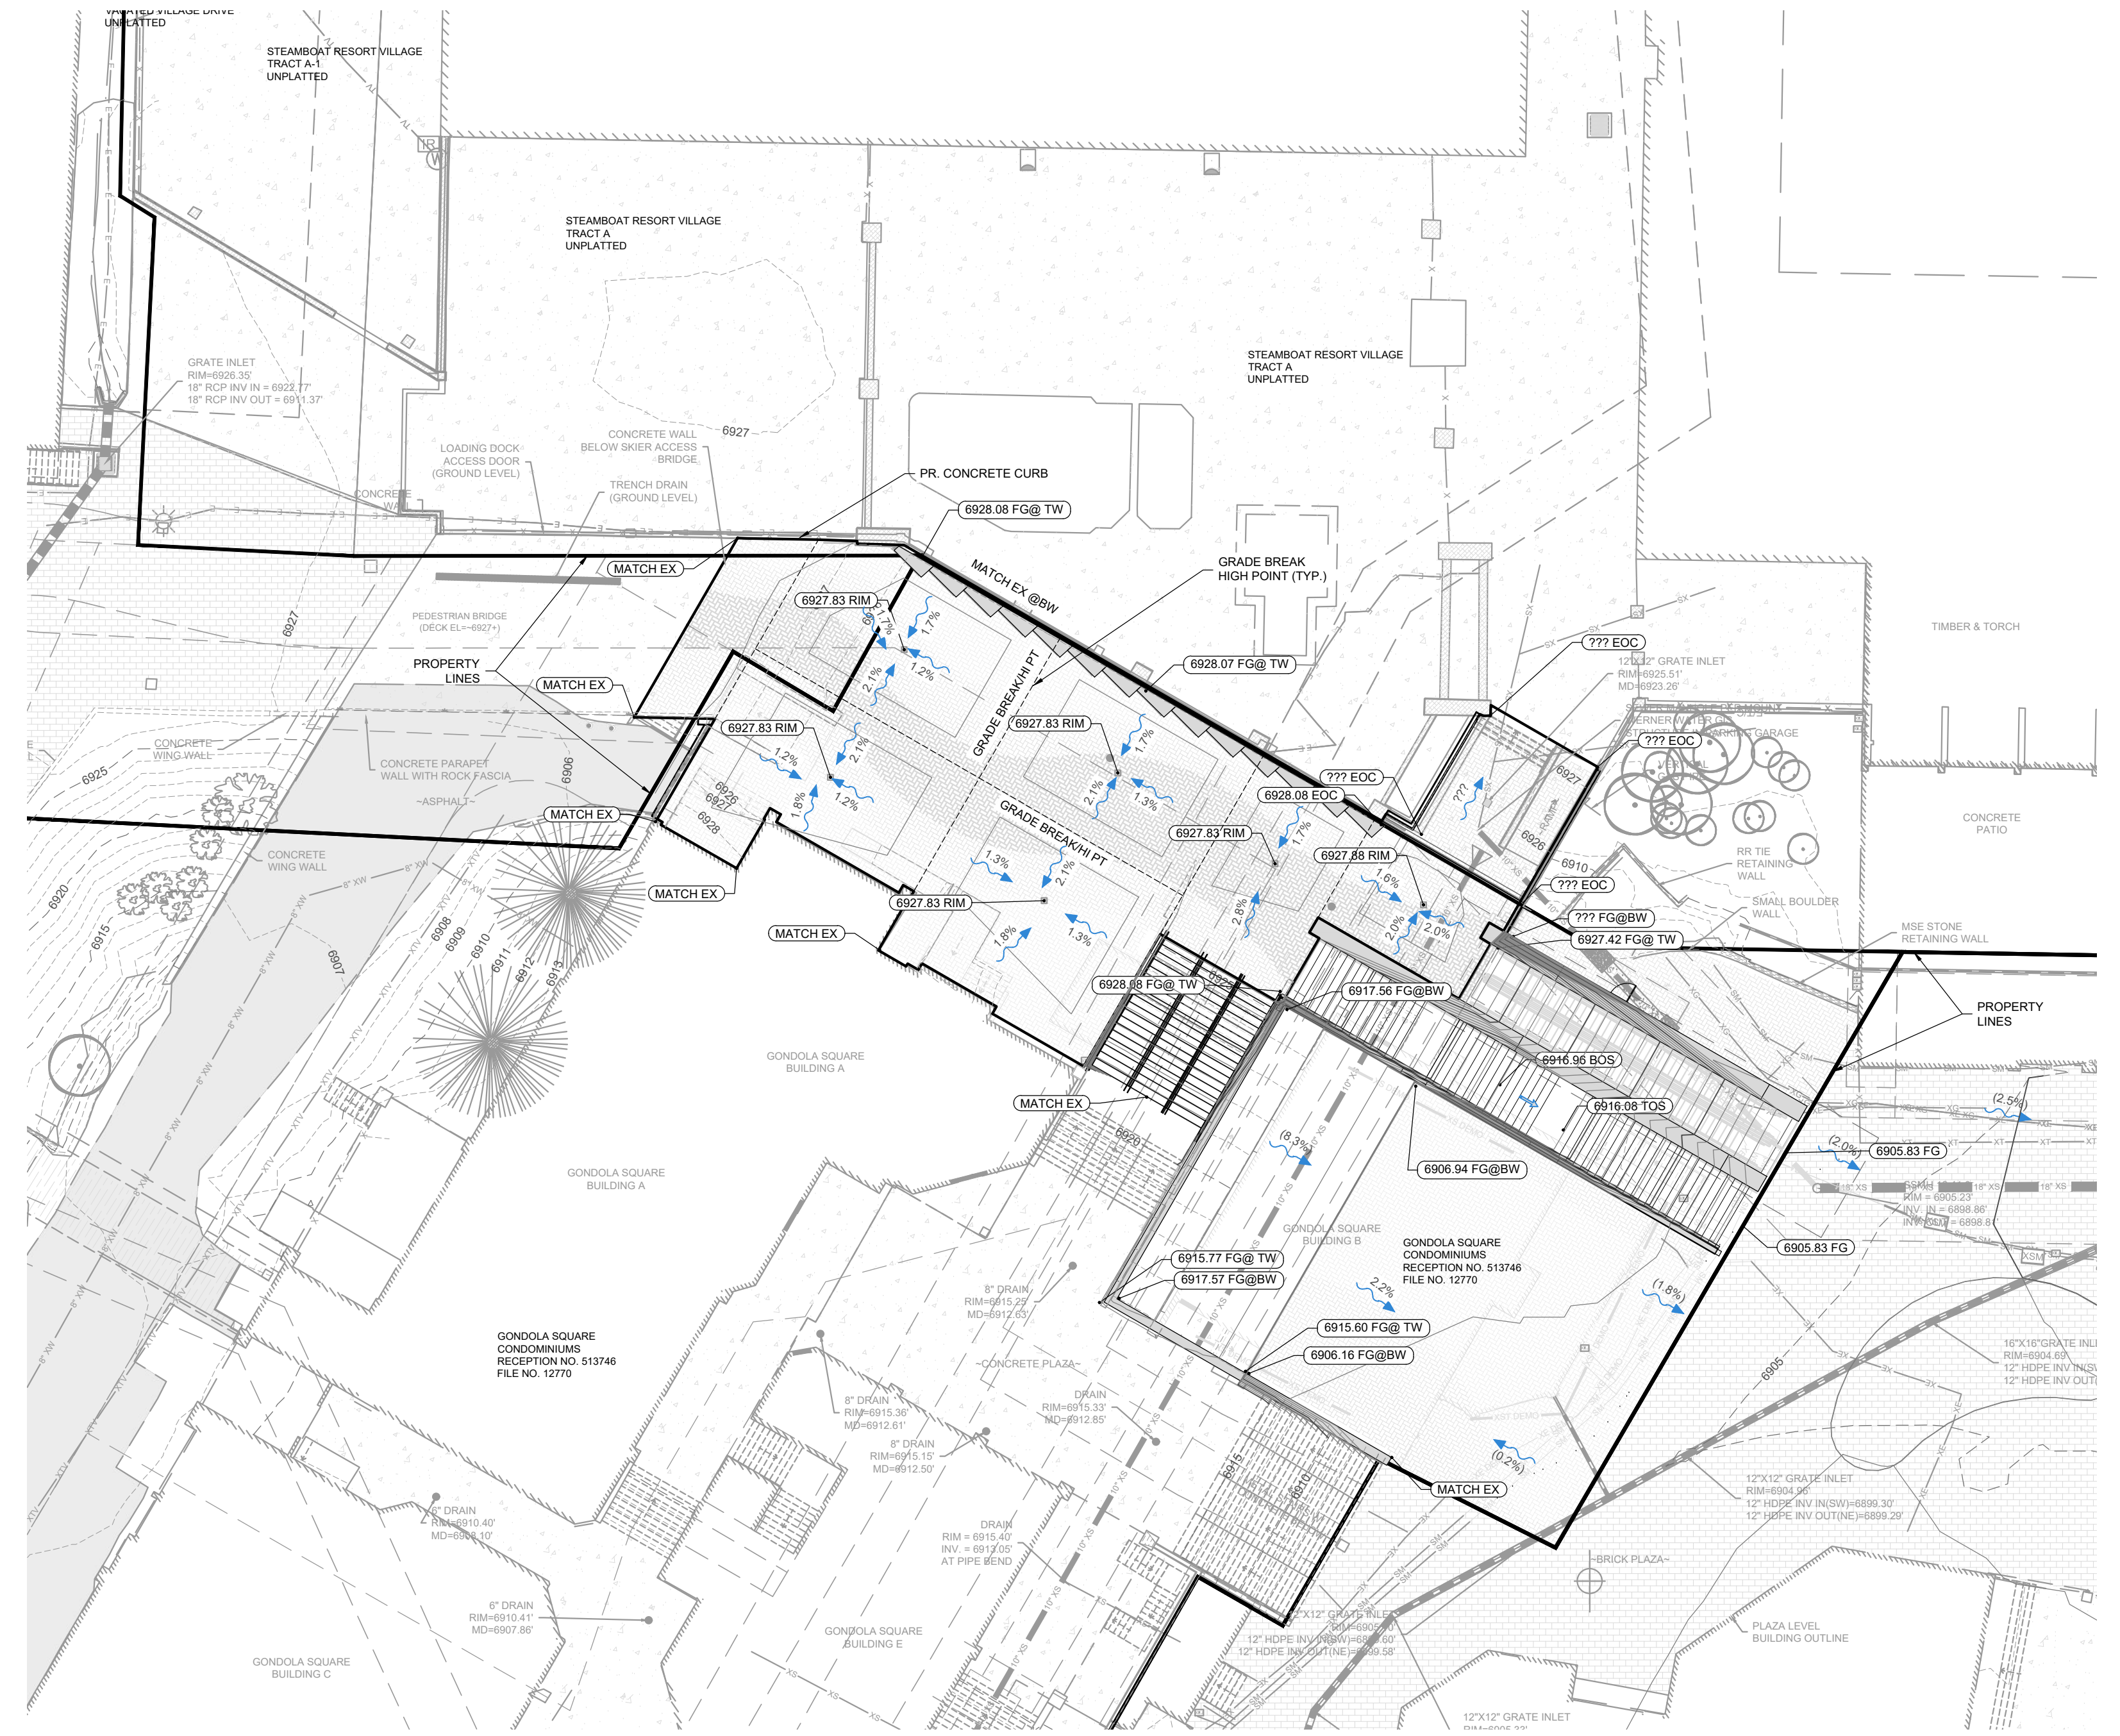

NOTE: ALL INFORMATION SHOWN ON OR ABOVE STRUCTURES ARE FOR CONVENIENCE ONLY. REFER TO GRADING INFORMATION BY OTHERS.

KEY PLAN

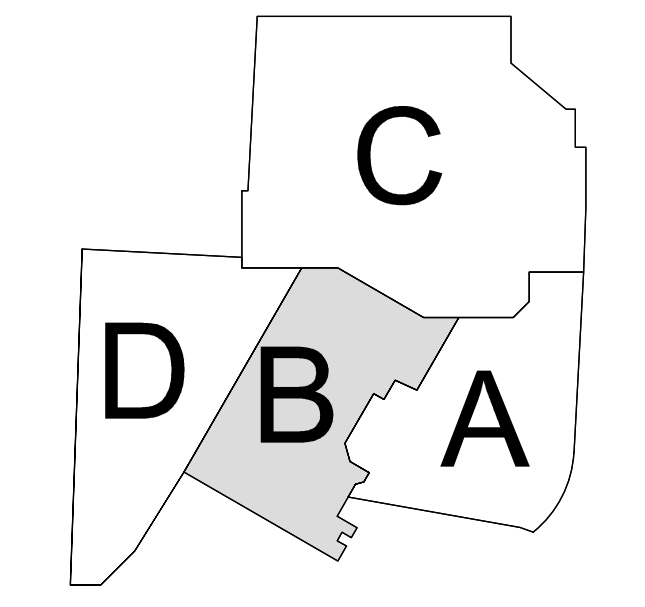

Date	Description
2021.05.19	BP3: GOLDWALK - ISSUE FOR BID AND PERMIT



NOT VALID WITHOUT ORIGINAL SIGNATURE AND DATE

Seal / Signature

Project Name: GOLD WALK
 SSRC | BASE AREA IMPROVEMENTS
 Project Number: 003.7835.000
 Description: Overall Grading Plan

Scale: SEE GRAPHICAL SCALE

1B-C.300

STORMCEPTOR DESIGN NOTES

THE STANDARD STC1200 CONFIGURATION IS SHOWN.

SITE SPECIFIC DATA REQUIREMENTS

STRUCTURE ID	
WATER QUALITY FLOW RATE (GPD LUG)	
PEAK FLOW RATE (GPD LUG)	
RETURN PERIOD OF PEAK FLOW (YRS)	
R/R ELEVATION	
PIPE DATA	INVERT MATERIAL DIAMETER
INLET PIPE 1	
INLET PIPE 2	
OUTLET PIPE	

NOTES/SPECIAL REQUIREMENTS:

GENERAL NOTES

- CONTECH TO PROVIDE ALL MATERIALS UNLESS NOTED OTHERWISE.
- FOR SITE SPECIFIC DRAWINGS WITH DETAILED STRUCTURE DIMENSIONS AND WEIGHT, PLEASE CONTACT YOUR CONTECH ENGINEERED SOLUTIONS LLC REPRESENTATIVE. www.contechES.com
- STORMCEPTOR WATER QUALITY STRUCTURE SHALL BE IN ACCORDANCE WITH ALL DESIGN DATA AND INFORMATION CONTAINED IN THIS DRAWING. CONTRACTOR TO CONFIRM STRUCTURE MEETS REQUIREMENTS OF PROJECT.
- STORMCEPTOR STRUCTURE SHALL MEET AASHTO H20D-44 HS20-100 LOAD RATING, ASSUMING EARTH COVER OF 2'-2" (R/S), AND GROUNDWATER ELEVATION AT OR BELOW THE OUTLET PIPE INVERT ELEVATION. ENGINEER OF RECORD TO CONFIRM ACTUAL GROUNDWATER ELEVATION. CASTINGS SHALL MEET AASHTO M240 AND BE CAST WITH THE CONTECH LOGO.
- STORMCEPTOR STRUCTURE SHALL BE PRECAST CONCRETE CONFORMING TO ASTM C475 AND AASHTO LOAD FACTOR DESIGN METHOD. ALTERNATE UNITS ARE SHOWN IN MILLIMETERS [mm].

INSTALLATION NOTES

- ANY SUB-BASE BACKFILL DEPTH AND/OR ANTI-FLUTATION PROVISIONS ARE SITE SPECIFIC DESIGN CONSIDERATIONS AND SHALL BE SPECIFIED BY ENGINEER OF RECORD.
- CONTRACTOR TO PROVIDE EQUIPMENT WITH SUFFICIENT LIFTING AND REACH CAPACITY TO LIFT AND SET THE STORMCEPTOR MANHOLE STRUCTURE.
- CONTRACTOR TO INSTALL JOINT SEALANT BETWEEN ALL STRUCTURE SECTIONS AND ASSEMBLY STRUCTURE.
- CONTRACTOR TO PROVIDE, INSTALL, AND GROUT INLET AND OUTLET PIPE(S). MATCH PIPE INVERTS WITH ELEVATIONS SHOWN. ALL PIPE CENTERLINES TO MATCH PIPE OPENING CENTERLINES.
- CONTRACTOR TO TAKE APPROPRIATE MEASURES TO ASSURE UNIT IS WATER TIGHT, HOLDING WATER TO FLOWLINE INVERT MINIMUM. IT IS SUGGESTED THAT ALL JOINTS BELOW PIPE INVERTS ARE GROUTED.

STC1200 STORMCEPTOR STANDARD DETAIL

CONTECH ENGINEERED SOLUTIONS LLC
www.contechES.com
 8025 Centre Pointe Dr., Suite 400, West Chester, OH 45390
 800-328-1178 513-846-7500 513-846-7505 FAX

1 EXECUTION

4.1 CONCRETE INSTALLATION: THE INSTALLATION OF THE CONCRETE HOUSING DEVICE SHOULD CONFORM TO STATE HIGHWAY, MUNICIPAL, OR LOCAL SPECIFICATIONS FOR THE CONSTRUCTION OF MANHOLES. SELECTED SECTIONS OF A GENERAL SPECIFICATION THAT ARE APPLICABLE ARE SUMMARIZED BELOW.

4.2 EXCAVATION

4.2.1 EXCAVATION FOR THE INSTALLATION OF THE STORMWATER QUALITY TREATMENT DEVICE SHOULD CONFORM TO STATE HIGHWAY, MUNICIPAL, OR LOCAL SPECIFICATIONS. TOPSOIL THAT IS REMOVED DURING THE EXCAVATION FOR THE STORMWATER QUALITY TREATMENT DEVICE SHOULD BE STOCKPILED IN DESIGNATED AREAS AND SHOULD NOT BE MIXED WITH SUBSOIL OR OTHER MATERIALS. TOPSOIL, STOCKPILES, AND THE GENERAL SITE PREPARATION FOR THE INSTALLATION OF THE WATER QUALITY DEVICE SHOULD CONFORM TO STATE HIGHWAY, MUNICIPAL, OR LOCAL SPECIFICATIONS.

4.2.2 THE HOUSING DEVICE SHOULD NOT BE INSTALLED ON FROZEN GROUND. EXCAVATION SHOULD EXTEND A MINIMUM OF 12 INCH (300 MM) FROM THE PRECAST CONCRETE SURFACES PLUS AN ALLOWANCE FOR BRACING AND BRACING WHERE REQUIRED. IF THE BOTTOM OF THE EXCAVATION PROVIDES AN UNSUITABLE FOUNDATION ADDITIONAL EXCAVATION MAY BE REQUIRED.

4.2.3 IN AREAS WITH A HIGH WATER TABLE, CONTINUOUS DEWATERING SHOULD BE PROVIDED TO ENSURE THAT THE EXCAVATION IS STABLE AND FREE OF WATER.

4.3 BACKFILLING: BACKFILL MATERIAL SHOULD CONFORM TO STATE HIGHWAY, MUNICIPAL, OR LOCAL SPECIFICATIONS. BACKFILL MATERIAL SHOULD BE PLACED IN UNIFORM LAYERS NOT EXCEEDING 12 INCHES (300 MM) IN DEPTH AND COMPACTED TO STATE HIGHWAY, MUNICIPAL, OR LOCAL SPECIFICATIONS.

4.4 WATER QUALITY DEVICE CONSTRUCTION SEQUENCE

4.4.1 THE CONCRETE WATER QUALITY DEVICE IS INSTALLED IN SECTIONS IN THE FOLLOWING SEQUENCE:

- BASE SLAB
- TREATMENT CHAMBER SECTIONS: SHALL INCLUDE THE INTERNALS BOLTED/SECURED TO THE PRECAST WALLS AND WATER TIGHT SEALED PRIOR TO ARRIVAL AT THE PROJECT SITE TO ENSURE QUALITY CONTROL.
- TRANSITION SLAB (IF REQUIRED)
- IN-PASS SECTION
- CONNECT INLET AND OUTLET PIPES
- RISER SECTION (AND/OR TRANSITION SLAB IF REQUIRED)
- MAINTENANCE RISER SECTION(S) (IF REQUIRED)
- FRAME AND ACCESS COVER

4.4.1.1 THE PRECAST BASE SHOULD BE PLACED LEVEL AT THE SPROUDED GRADE. THE ENTIRE BASE SHOULD BE IN CONTACT WITH THE UNDERLYING COMPACTED GRANULAR MATERIAL. SUBSEQUENT SECTIONS COMPLETE WITH JOINT SEALS SHOULD BE INSTALLED IN ACCORDANCE WITH THE PRECAST CONCRETE MANUFACTURER'S RECOMMENDATIONS.

4.4.2 ADJUSTMENT OF THE STORMWATER QUALITY TREATMENT DEVICE CAN BE PERFORMED BY LIFTING THE UPPER SECTIONS FREE OF THE EXCAVATED AREA. RELEVELING THE BASE AND RE-INSTALLING THE SECTIONS. DAMAGED SECTIONS AND GASKETS SHOULD BE REPAIRED OR REPLACED AS NECESSARY. ONCE THE STORMWATER QUALITY TREATMENT (WQ) DEVICE HAS BEEN CONSTRUCTED, ANY LIFT HOLES MUST BE PLOUGGED WITH MORTAR.

4.4.3 FRAME AND COVER OR FRAME AND GRATE INSTALLATION: PRECAST CONCRETE ADJUSTMENT UNITS SHOULD BE INSTALLED TO SET THE FRAME AND COVER AT THE REQUIRED ELEVATION. THE ADJUSTMENT UNITS SHOULD BE LAID IN A FULL BED OF MORTAR WITH SUCCESSIVE UNITS BEING JOINED USING SEALANT RECOMMENDED BY THE MANUFACTURER. FRAMES FOR THE COVER SHOULD BE SET IN A FULL BED OF MORTAR AT THE ELEVATION SPECIFIED.

EXISTING CONDITION NOTES

- THE DEPICTED ILLUSTRATION IS BASED ON DRAFT PLANS FROM THE ORIGINAL CONSTRUCTION. ACTUAL CONDITIONS MAY VARY AND LIKELY WILL VARY.
- REPLACE ALL MODIFIED FRAMES AND GRATES - DO NOT REUSE WITHOUT SPECIFIC APPROVAL AFTER INSPECTION.
- PERFORM DEMOLITION WITH CARE TO PROTECT EXISTING BASIN AS PRACTICABLE.
- PERFORM DEMOLITION WITH CARE TO PROTECT EXISTING BASIN AS PRACTICABLE.

INTERIM CONDITION NOTES

THE DEPICTED ILLUSTRATION IS BASED ON DRAFT PLANS FROM THE ORIGINAL CONSTRUCTION. ACTUAL CONDITIONS MAY VARY AND LIKELY WILL VARY.

- REPLACE ALL MODIFIED FRAMES AND GRATES - DO NOT REUSE WITHOUT SPECIFIC APPROVAL AFTER INSPECTION.
- PERFORM DEMOLITION WITH CARE TO PROTECT EXISTING BASIN AS PRACTICABLE.
- PER NVCC'S REFERENCE GEOTECHNICAL RECOMMENDATIONS, THE FINISHED SUBGRADE SURFACE SHOULD BE PROOF ROLLED WITH A LOADED TANDEN DUMP TRUCK OR LOADED WATER TRUCK PRIOR TO PLACING THE SUBGRADE AGGREGATE. PROTECT INLET ACCORDINGLY.

FINAL CONDITION NOTES

- ALL NEW MATERIALS AND INSTALLATION SHALL BE INSTALLED PER THE MANUFACTURER'S RECOMMENDATIONS.
- VERIFY FRAME/GRATE ELEVATION PRIOR TO INSTALLING CONCRETE COLLAR.
- PERFORM SURFACE FLOW TEST TO ENSURE ADEQUATE DRAINAGE AND NO STANDING WATER UPON COMPLETION.
- PROTECT DURING CONSTRUCTION ACTIVITY AND REPAIR/REPLACE DAMAGE AT NO ADDITIONAL COST TO OWNER.
- JET AND CLEAN STORM SEWER SYSTEM AT PROJECT COMPLETION. ENSURE THAT DEBRIS IS COLLECTED AT DOWNSTREAM LOCATION PRIOR TO DISCHARGE INTO EXISTING STORM SYSTEM.

PROBABLE EXISTING CONDITION

N.T.S.

INTERIM CONDITION

N.T.S.

FINAL CONDITION

N.T.S.

ADJUSTING EX. NYLOPLAST BASINS TO PR. GRADE

N.T.S.

DIAMETER	MIN COVER	CORR. PROFILE
8"-10"	12"	12/10/2"
12"-48"	12"	23/10/2"
54"-96"	12"	3'X1', 5'X1"
102"-144"	DB	3'X1', 5'X1"

BACKFILL REQUIREMENTS FOLLOW THE GUIDELINES OF AASHTO LOAD AND BRIDGE DESIGN (SEC 13) AND CONSTRUCTION (SEC 26).

- MINIMUM TRENCH WIDTH MUST ALLOW ROOM FOR PROPER COMPACTION OF HAUNCH MATERIALS UNDER THE PIPE.
 PIPE < 12" D = 18"
 PIPE > 12" D = 12"
- MINIMUM EMBANKMENT WIDTH (in feet) FOR INITIAL FILL ENVELOPE (12.6.6.2):
 PIPE < 24" D = 300"
 PIPE 24" - 144" D = 450"
 PIPE > 144" D = 1000"
- THE FOUNDATION UNDER THE PIPE AND SIDE BACKFILL SHALL BE ADEQUATE TO SUPPORT THE LOADS ACTING UPON IT (26.6.2).
- BEDDING MATERIAL SHALL BE A RELATIVELY LOOSE MATERIAL THAT IS ROUGHLY SHAPED TO FIT THE BOTTOM OF THE PIPE, AND A MINIMUM OF TWICE THE CORROGATION DEPTH IN THICKNESS, WITH THE MAXIMUM PARTICLE SIZE OF ONE-HALF OF THE CORROGATION DEPTH (26.6.1, 26.5.3).
- CORROGATED STEEL PIPE (CSP) (HEL-COR):
- HAUNCH ZONE MATERIAL SHALL BE HAND SHOVELED OR SHOVEL SLICED INTO PLACE TO ALLOW FOR PROPER COMPACTION (26.5.4).
- INITIAL BACKFILL FOR PIPE EMBEDMENT TO MEET AASHTO A-1, A-2 OR A-3 CLASSIFICATION OR APPROVED EQUAL, COMPACTED TO 90% STANDARD PROCTOR (7.6). MAXIMUM PARTICLE SIZE NOT TO EXCEED 1/2 (2.4) (2.4) ALL LIFTS PLACED IN A CONTROLLED MANNER. IT IS RECOMMENDED THAT LIFTS NOT EXCEED AN 8" UNCOMPACTED LIFT HEIGHT TO PREVENT UNEVEN LOADING, AND THE LESSER OF 1/3 THE DIAMETER OR 24" AS THE MAXIMUM DIFFERENTIAL SIDE TO SIDE (26.5.4).
- INITIAL BACKFILL ABOVE PIPE MAY INCLUDE ROAD BASE MATERIAL, AND RIGID PAVEMENT (IF APPLICABLE), SEE TABLE ABOVE.
- TOTAL HEIGHT OF COMPACTED COVER FOR CONVENTIONAL HIGHWAY LOADS IS MEASURED FROM TOP OF PIPE TO BOTTOM OF FLEXIBLE PAVEMENT OR TOP OF RIGID PAVEMENT (12.6.6.3).
- FINAL BACKFILL MATERIAL SELECTION AND COMPACTION REQUIREMENTS SHALL FOLLOW THE PROJECT PLANS AND SPECIFICATIONS PER THE ENGINEER OF RECORD (26.5.4.1).

NOTES:

- GEOTEXTILE SHOULD BE CONSIDERED FOR USE TO PREVENT SOIL MIGRATION INTO VARYING SOIL TYPES (PROJECT ENGINEER).
- FOR MULTIPLE BARREL INSTALLATIONS THE RECOMMENDED STANDARD SPACING BETWEEN PARALLEL PIPE RUNS SHALL BE PIPE DIA/2 BUT NO LESS THAN 12" OR 30" FOR PIPE DIAMETERS 72" AND LARGER. CONTACT YOUR CONTECH REPRESENTATIVE FOR NONSTANDARD SPACING (TABLE C12.6.7-1).

230-CSP-STANDARD BACKFILL-ROUND-AASHTO

CONTECH ENGINEERED SOLUTIONS LLC www.contechES.com 8025 Centre Pointe Dr., Suite 400, West Chester, OH 45390 800-328-1178 513-846-7500 513-846-7505 FAX	CONTECH PIPE SOLUTIONS	230 - CSP ROUND STANDARD BACKFILL DETAIL AASHTO
DATE DRAWN: 11/15/15	REV #	REV DATE
SCALE: N.T.S.	DRAWING TYPE	

DETAIL EXTRACTED FROM NVCC'S "SUBSOIL AND FOUNDATION INVESTIGATION, STEAMBOAT BASE AREA REDEVELOPMENT (STEAMBOAT SPRINGS, COLORADO)" DATED DECEMBER 30, 2020. REFER TO THEIR REPORT FOR ADDITIONAL INFORMATION. SNOWMELT SYSTEM AND PAVEMENT SPECIFICS BY OTHERS.

Brick Pavers

2-Inches of ASTM D-33 Concrete Sand
 Compacted to at least 75% of Maximum Relative Density

12-Inches of CDOT Class 6 ABC - Place in 6 inch loose lifts and compact to at least 95% of Modified Proctor Density.

Geotextile and/or Geogrid may be required over scarified and recompacted subgrade soils if unstable or can't meet compaction

Exposed Subgrade Soils - Scarify 12 inches, moisture condition and recompact to at least 95% of Standard Proctor Density

TITLE: BRICK PAVER CROSS SECTION	DATE: 12/18/2020	REV #	REV DATE
JOB NAME: Steamboat Base Area Redevelopment	JOB NO: 22-12000	FIGURE #	14
LOCATION: Steamboat Ski Area, Steamboat Springs, Colorado			

CALL UTILITY NOTIFICATION CENTER OF COLORADO
811
 Know what's below. Call before you dig.
 CALL 2 BUSINESS DAYS IN ADVANCE BEFORE YOU DIG. GRADE. OR EXCAVATE FOR THE MARKING OF UNDERGROUND MEMBER UTILITIES.

Date	Description
2021.05.19	BP3: GOLDWALK - ISSUE FOR BID AND PERMIT

Seal / Signature

NOT VALID WITHOUT ORIGINAL SIGNATURE AND DATE

Project Name: GOLD WALK
 SSRC | BASE AREA IMPROVEMENTS
 Project Number: 003.7835.000
 Description: Civil Construction Details

Scale: SEE GRAPHICAL SCALE




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 SSRC | BASE AREA IMPROVEMENTS
 Project Number: 003.7835.000
 Description: Civil Construction Details

Scale: SEE GRAPHICAL SCALE

1B-C.500

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2. Added Part. Sect. Note: 11/08
1. Changed Company Name 1/00

REVISION HISTORY:

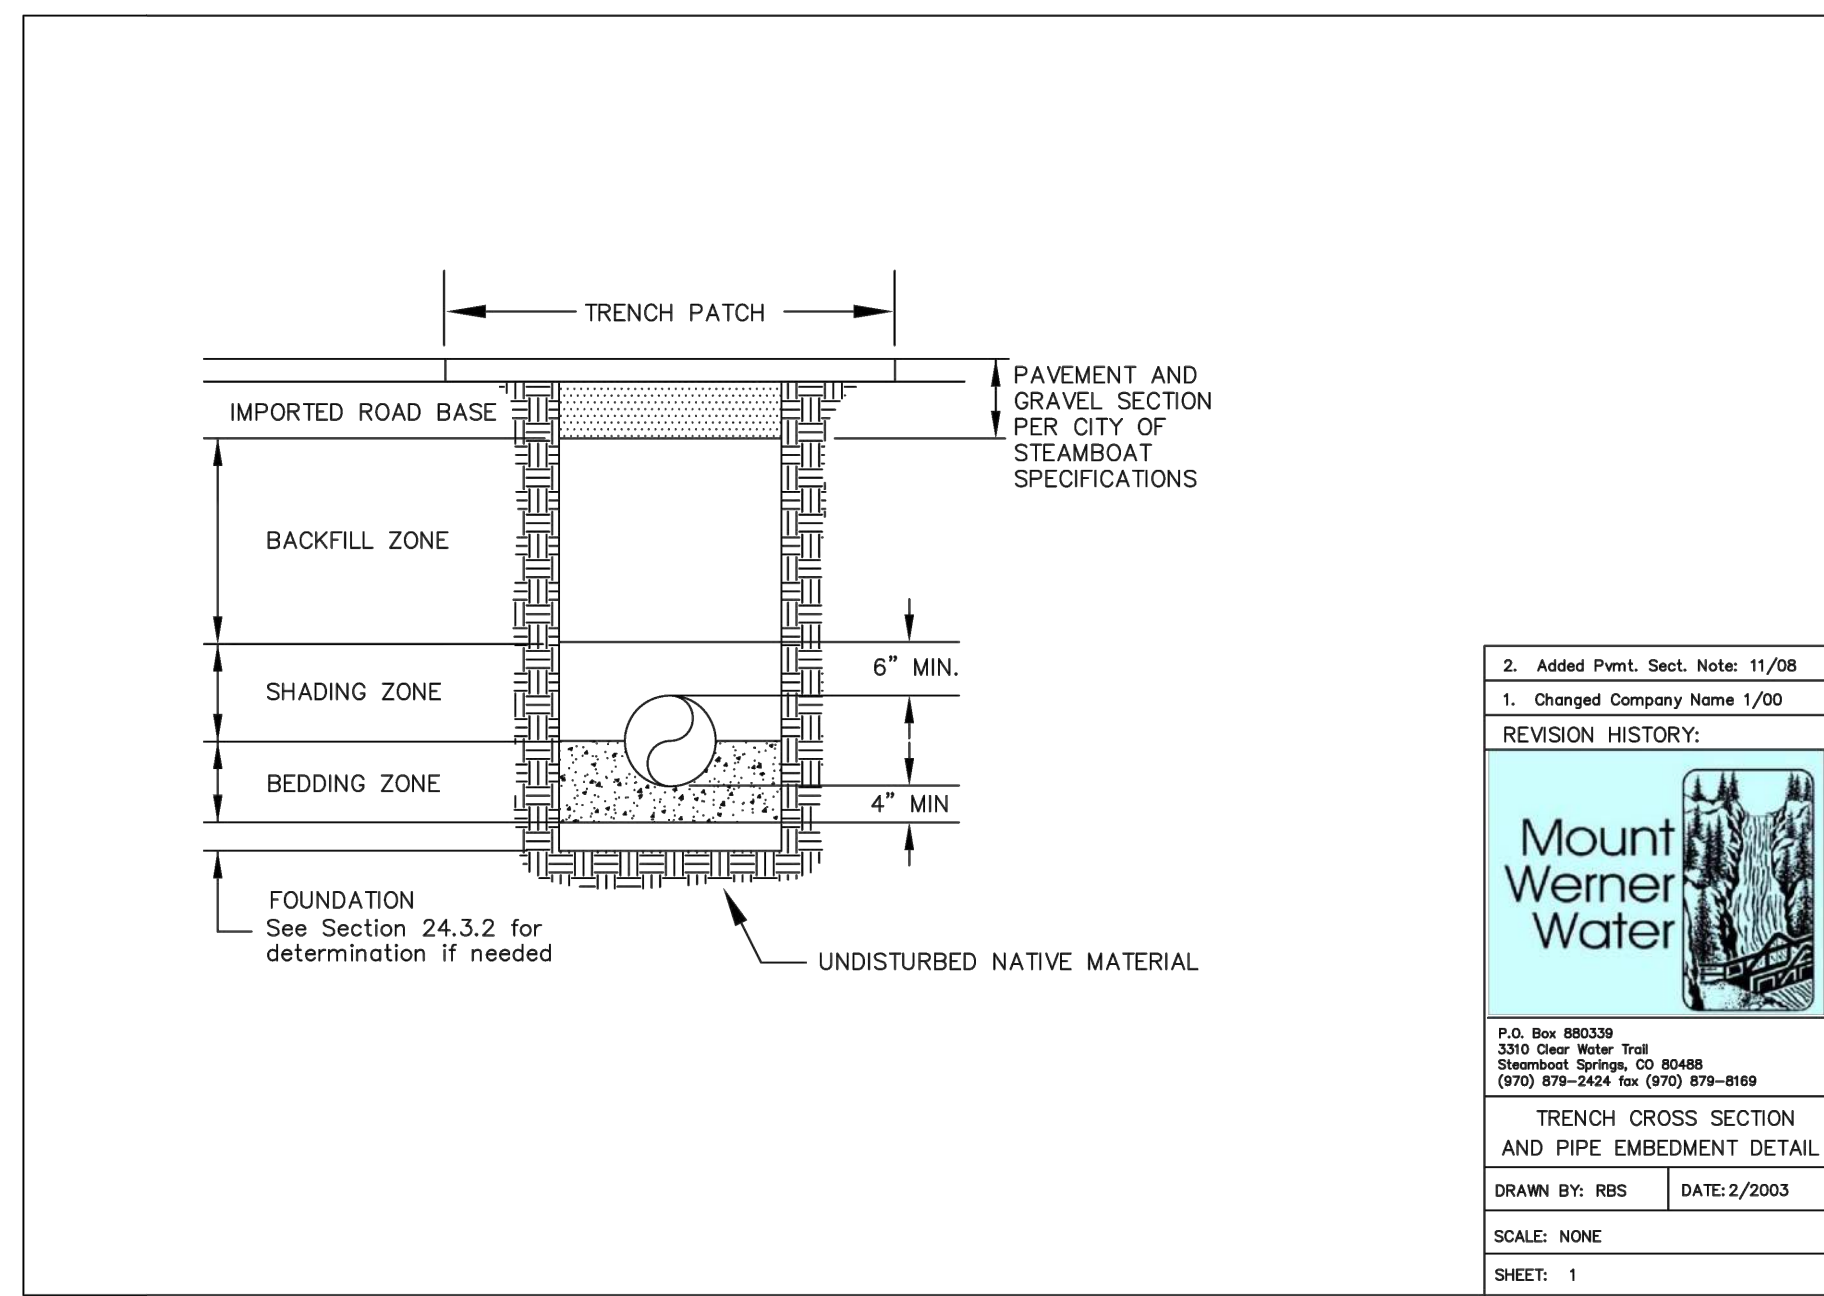Mount Werner Water


P.O. Box 890339
300 Clear Water, Inc.
Steamboat Springs, CO 80488
(970) 879-2424 fax (970) 879-8169

TRENCH CROSS SECTION AND PIPE EMBEDMENT DETAIL

DRAWN BY: RBS DATE: 2/2003

SCALE: NONE

SHEET: 1

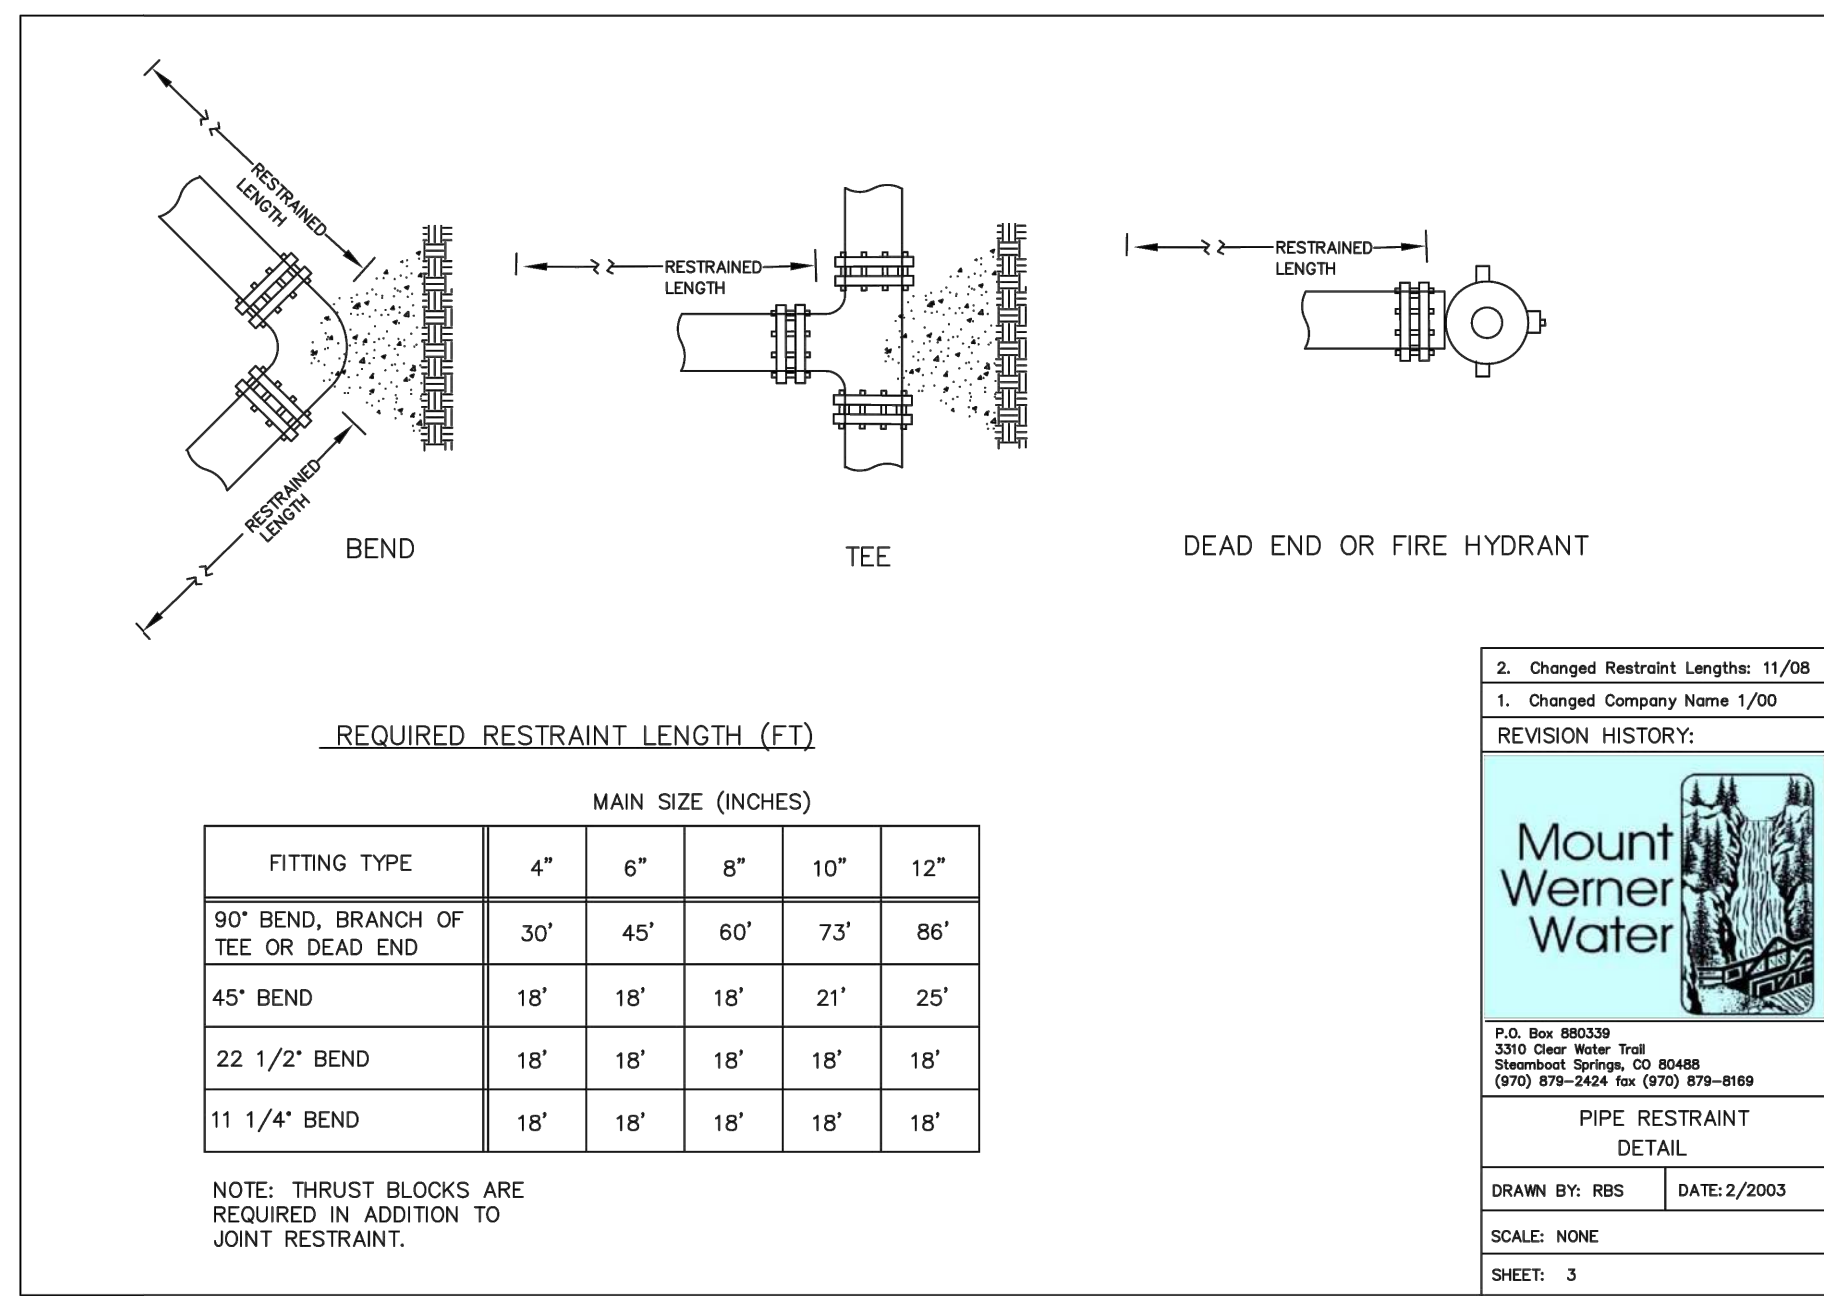

2. Changed Restraint Lengths: 11/08
1. Changed Company Name 1/00

REVISION HISTORY:

Mount Werner Water


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300 Clear Water, Inc.
Steamboat Springs, CO 80488
(970) 879-2424 fax (970) 879-8169

PIPE RESTRAINT DETAIL

DRAWN BY: RBS DATE: 2/2003

SCALE: NONE

SHEET: 3

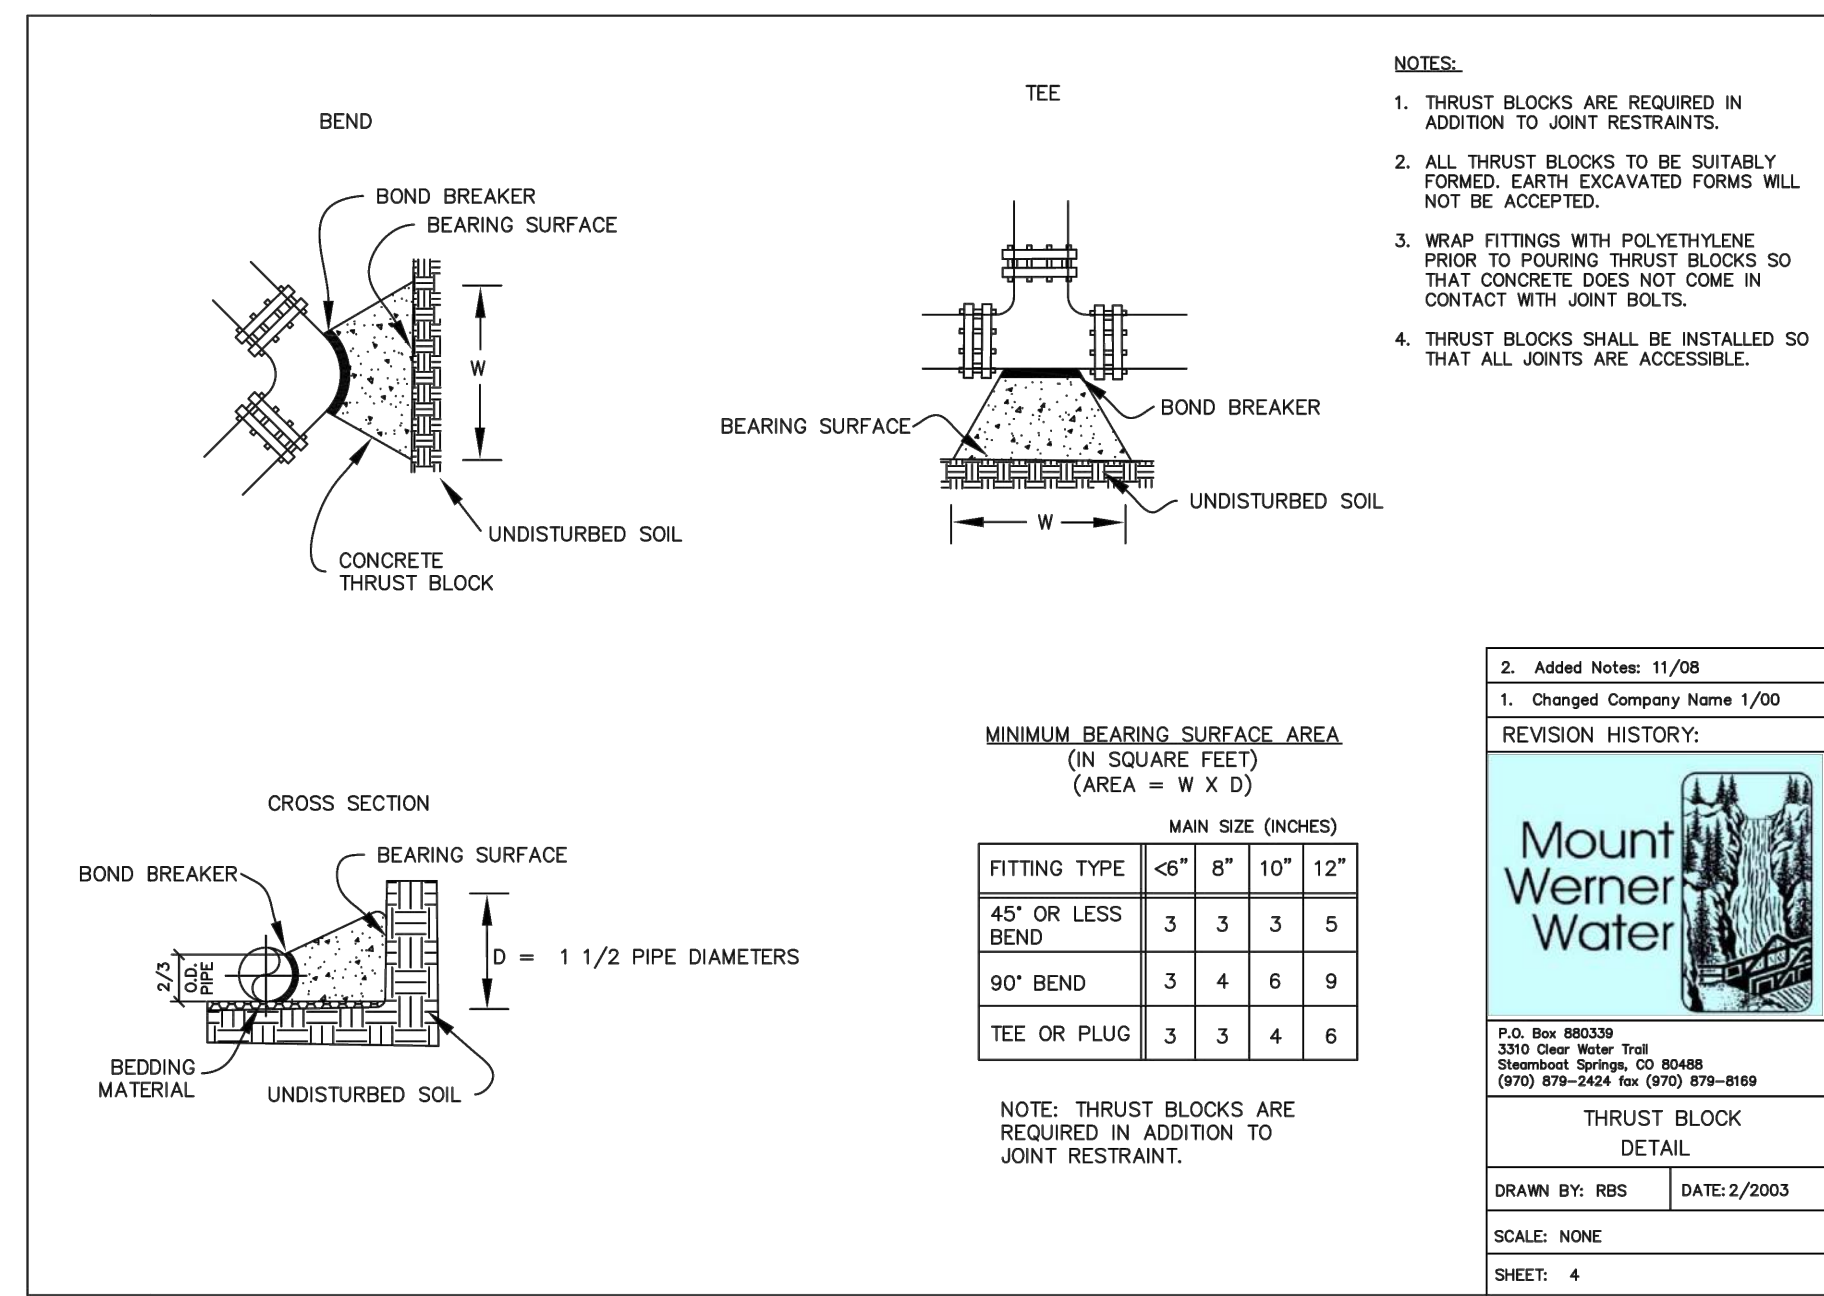

1. Added Notes: 11/08
1. Changed Company Name 1/00

REVISION HISTORY:

Mount Werner Water


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300 Clear Water, Inc.
Steamboat Springs, CO 80488
(970) 879-2424 fax (970) 879-8169

THRUST BLOCK DETAIL

DRAWN BY: RBS DATE: 2/2003

SCALE: NONE

SHEET: 4

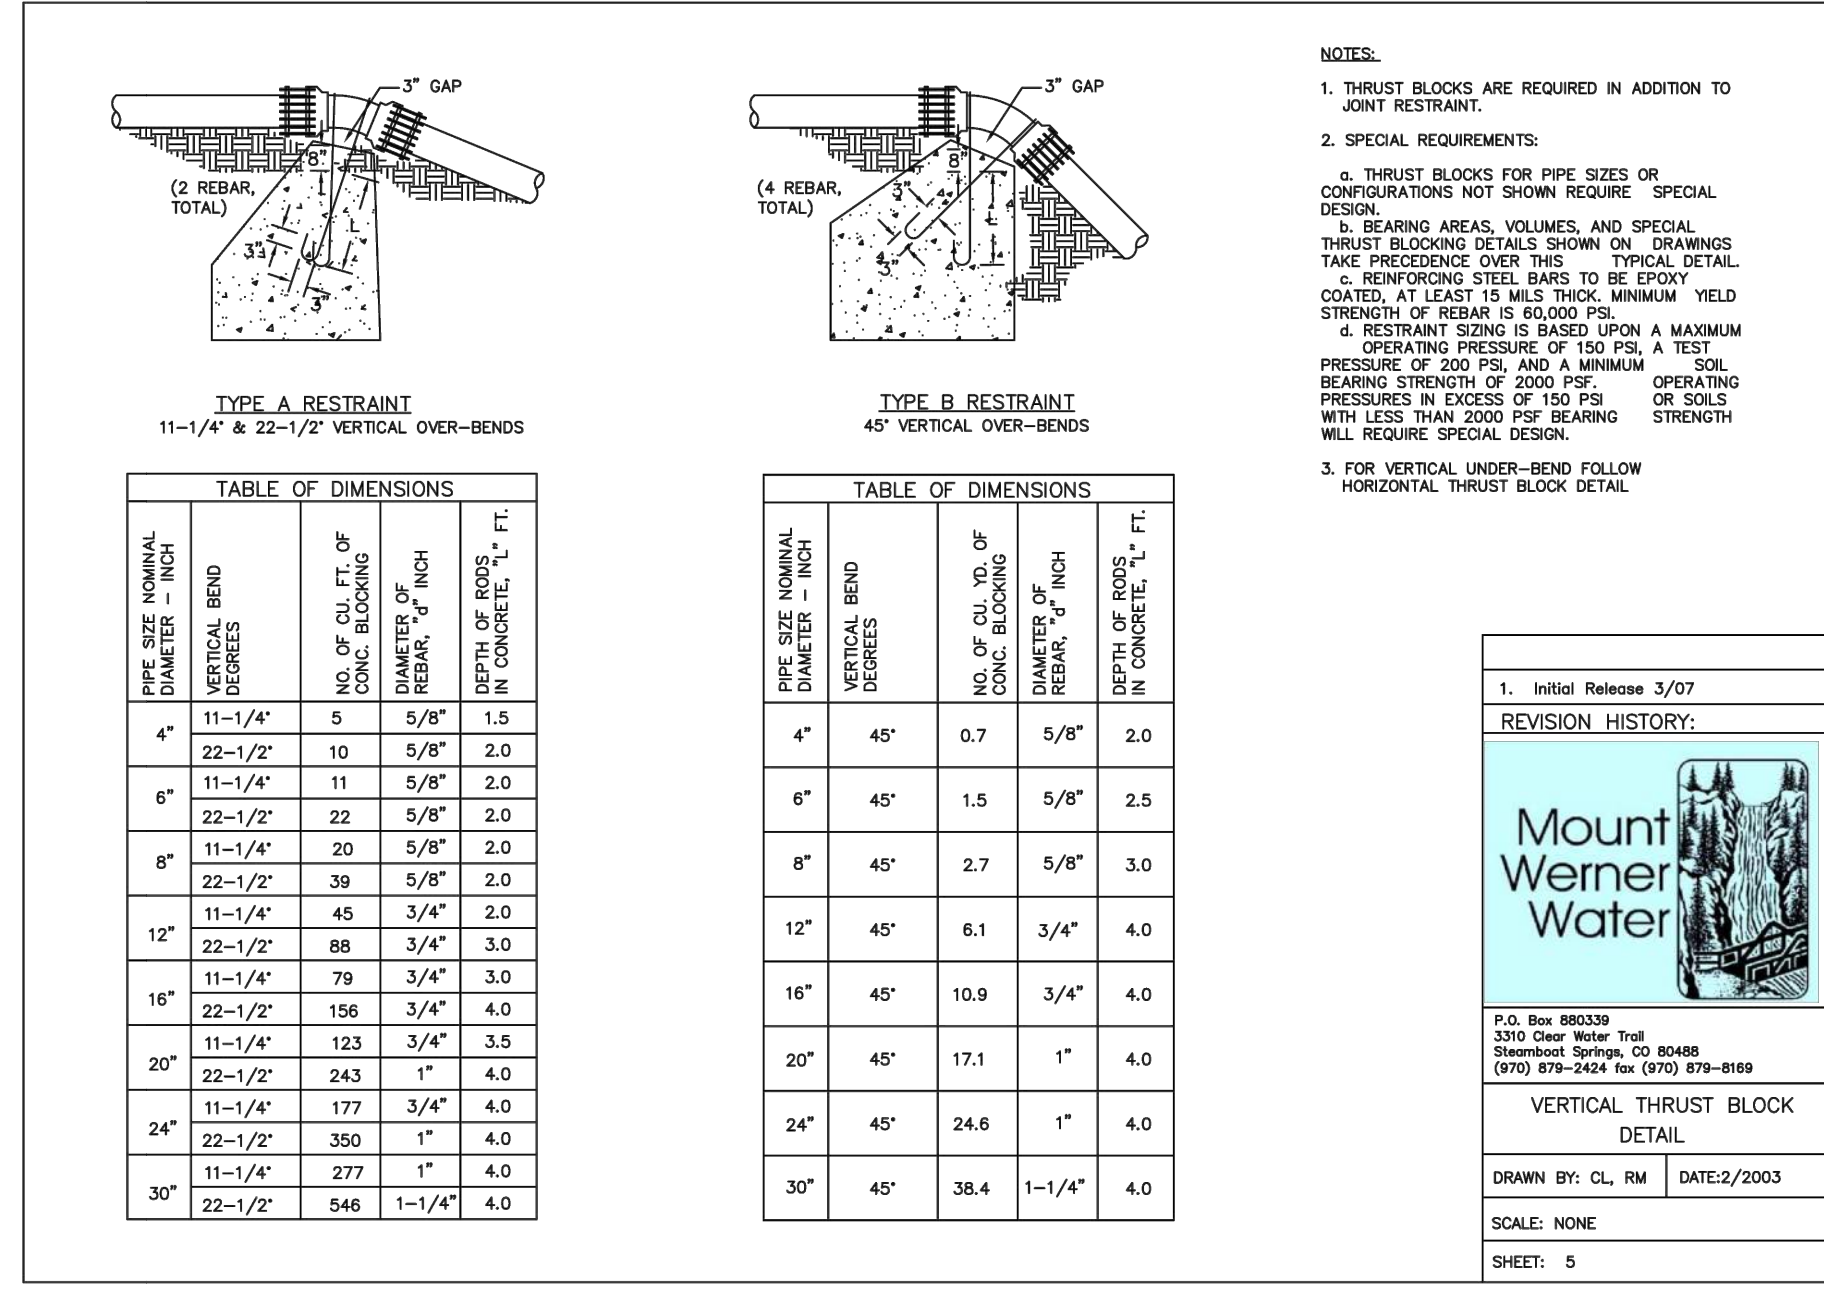

1. Initial Release 5/07

REVISION HISTORY:

Mount Werner Water


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Steamboat Springs, CO 80488
(970) 879-2424 fax (970) 879-8169

VERTICAL THRUST BLOCK DETAIL

DRAWN BY: CL, RM DATE: 2/2003

SCALE: NONE

SHEET: 5

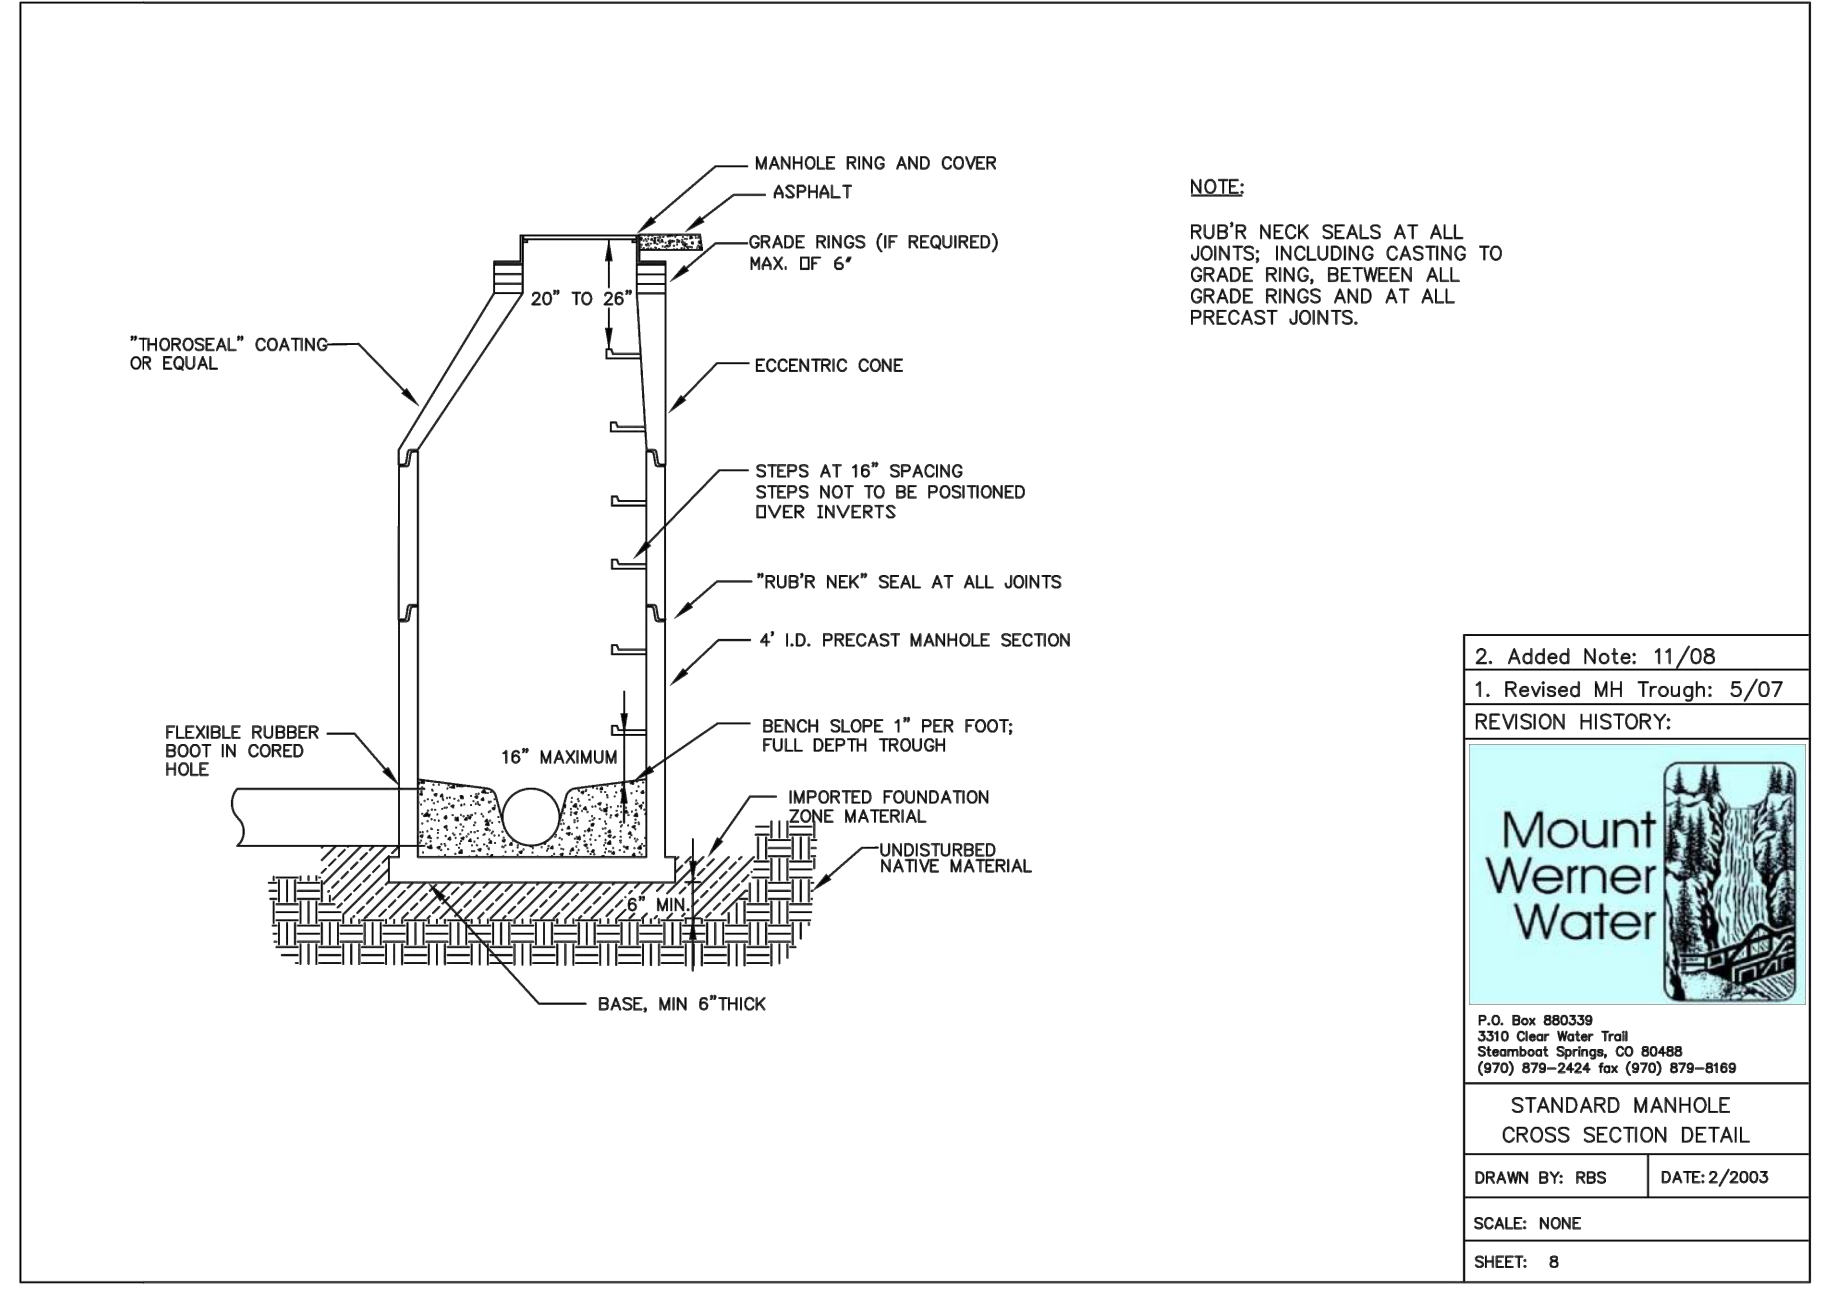

2. Added Note: 11/08
1. Revised Min Through: 5/07

REVISION HISTORY:

Mount Werner Water


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STANDARD MANHOLE CROSS SECTION DETAIL

DRAWN BY: RBS DATE: 2/2003

SCALE: NONE

SHEET: 8

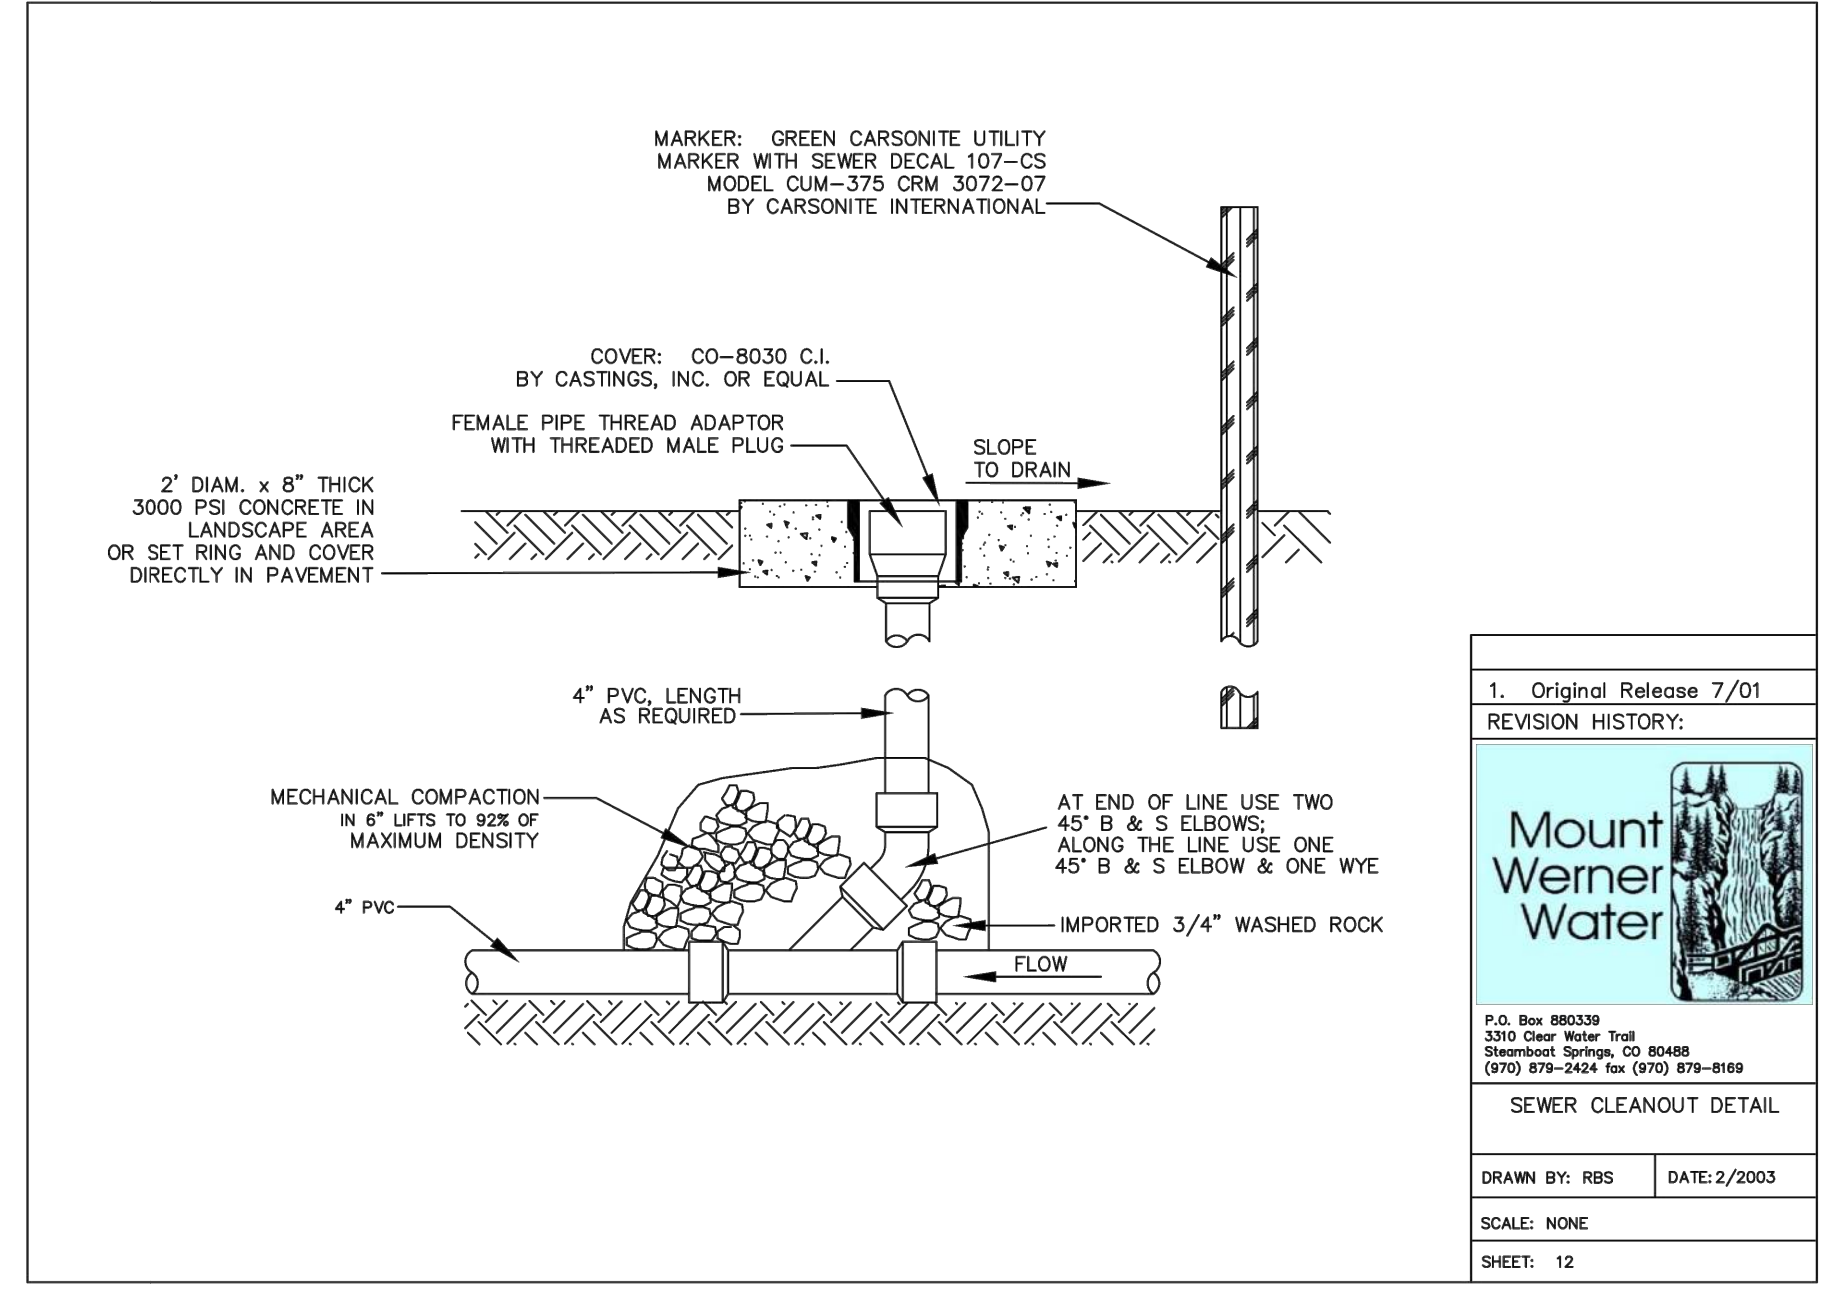

1. Original Release 7/01

REVISION HISTORY:

Mount Werner Water


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SEWER CLEANOUT DETAIL

DRAWN BY: RBS DATE: 2/2003

SCALE: NONE

SHEET: 12

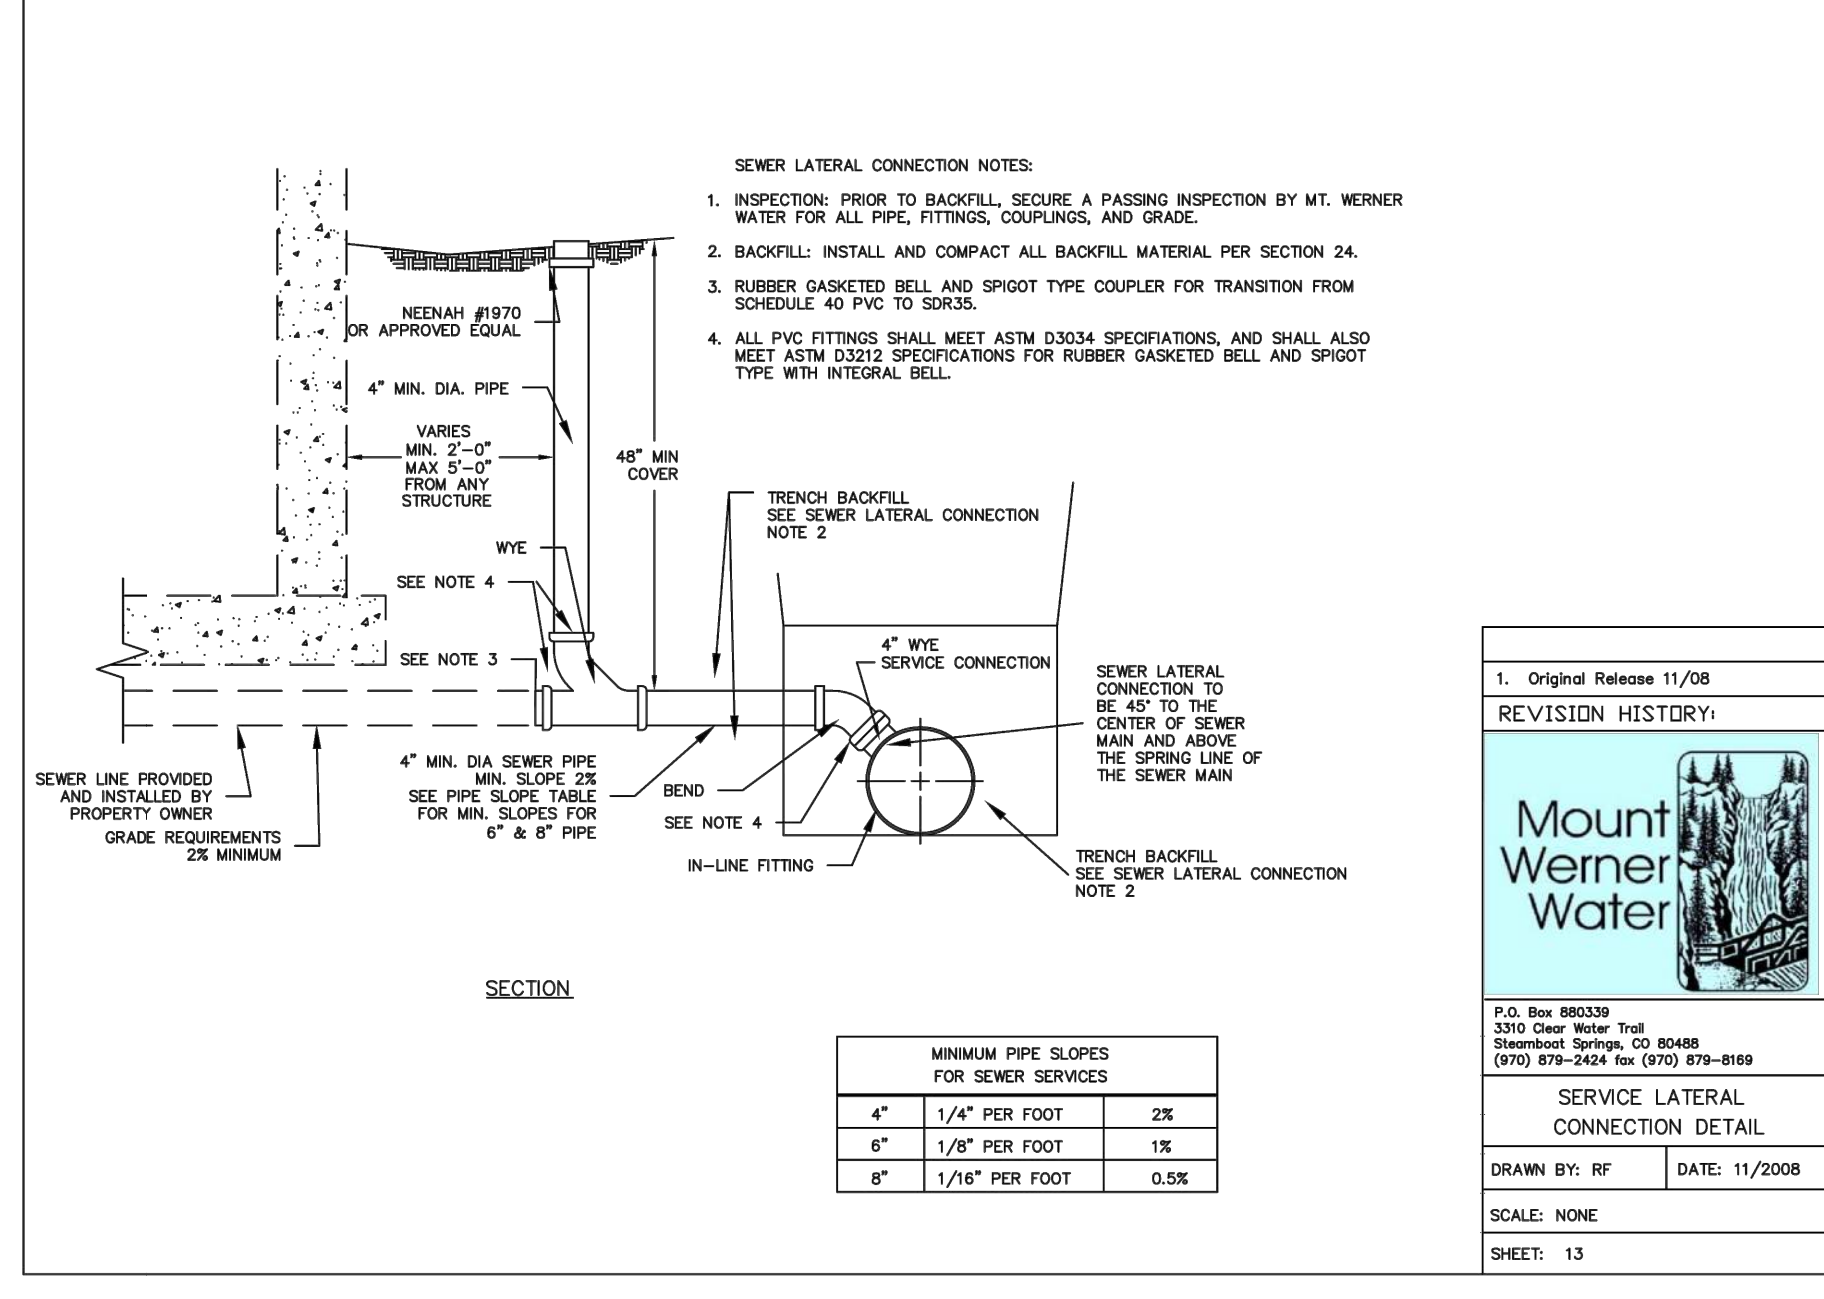

1. Original Release 11/08

REVISION HISTORY:

Mount Werner Water


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SERVICE LATERAL CONNECTION DETAIL

DRAWN BY: RY DATE: 11/2008

SCALE: NONE

SHEET: 13

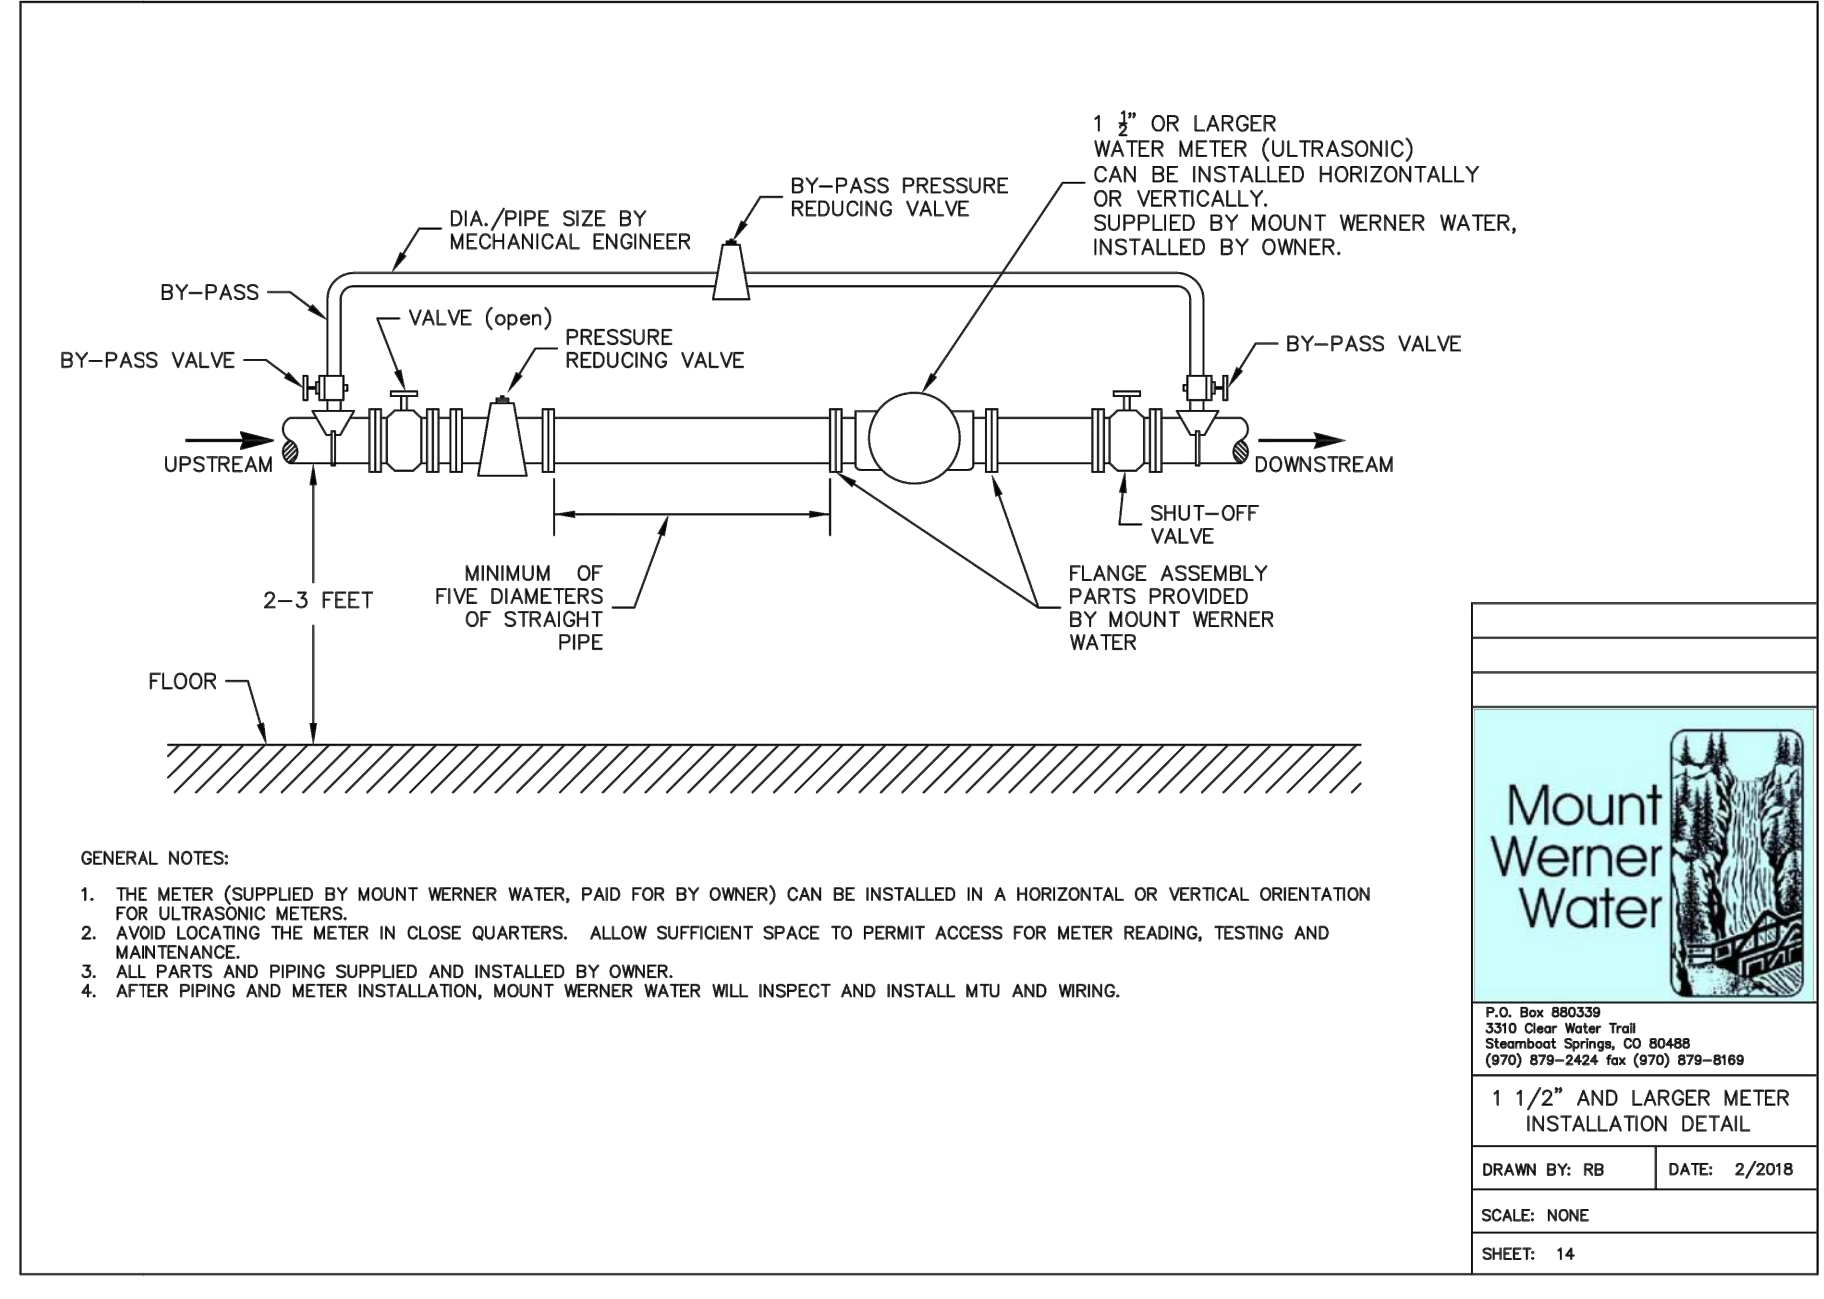

1. Original Release 2/04

REVISION HISTORY:

Mount Werner Water


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TRACER WIRE INSTALLATION DETAIL

DRAWN BY: RBS DATE: 2/2004

SCALE: NONE

SHEET: 17

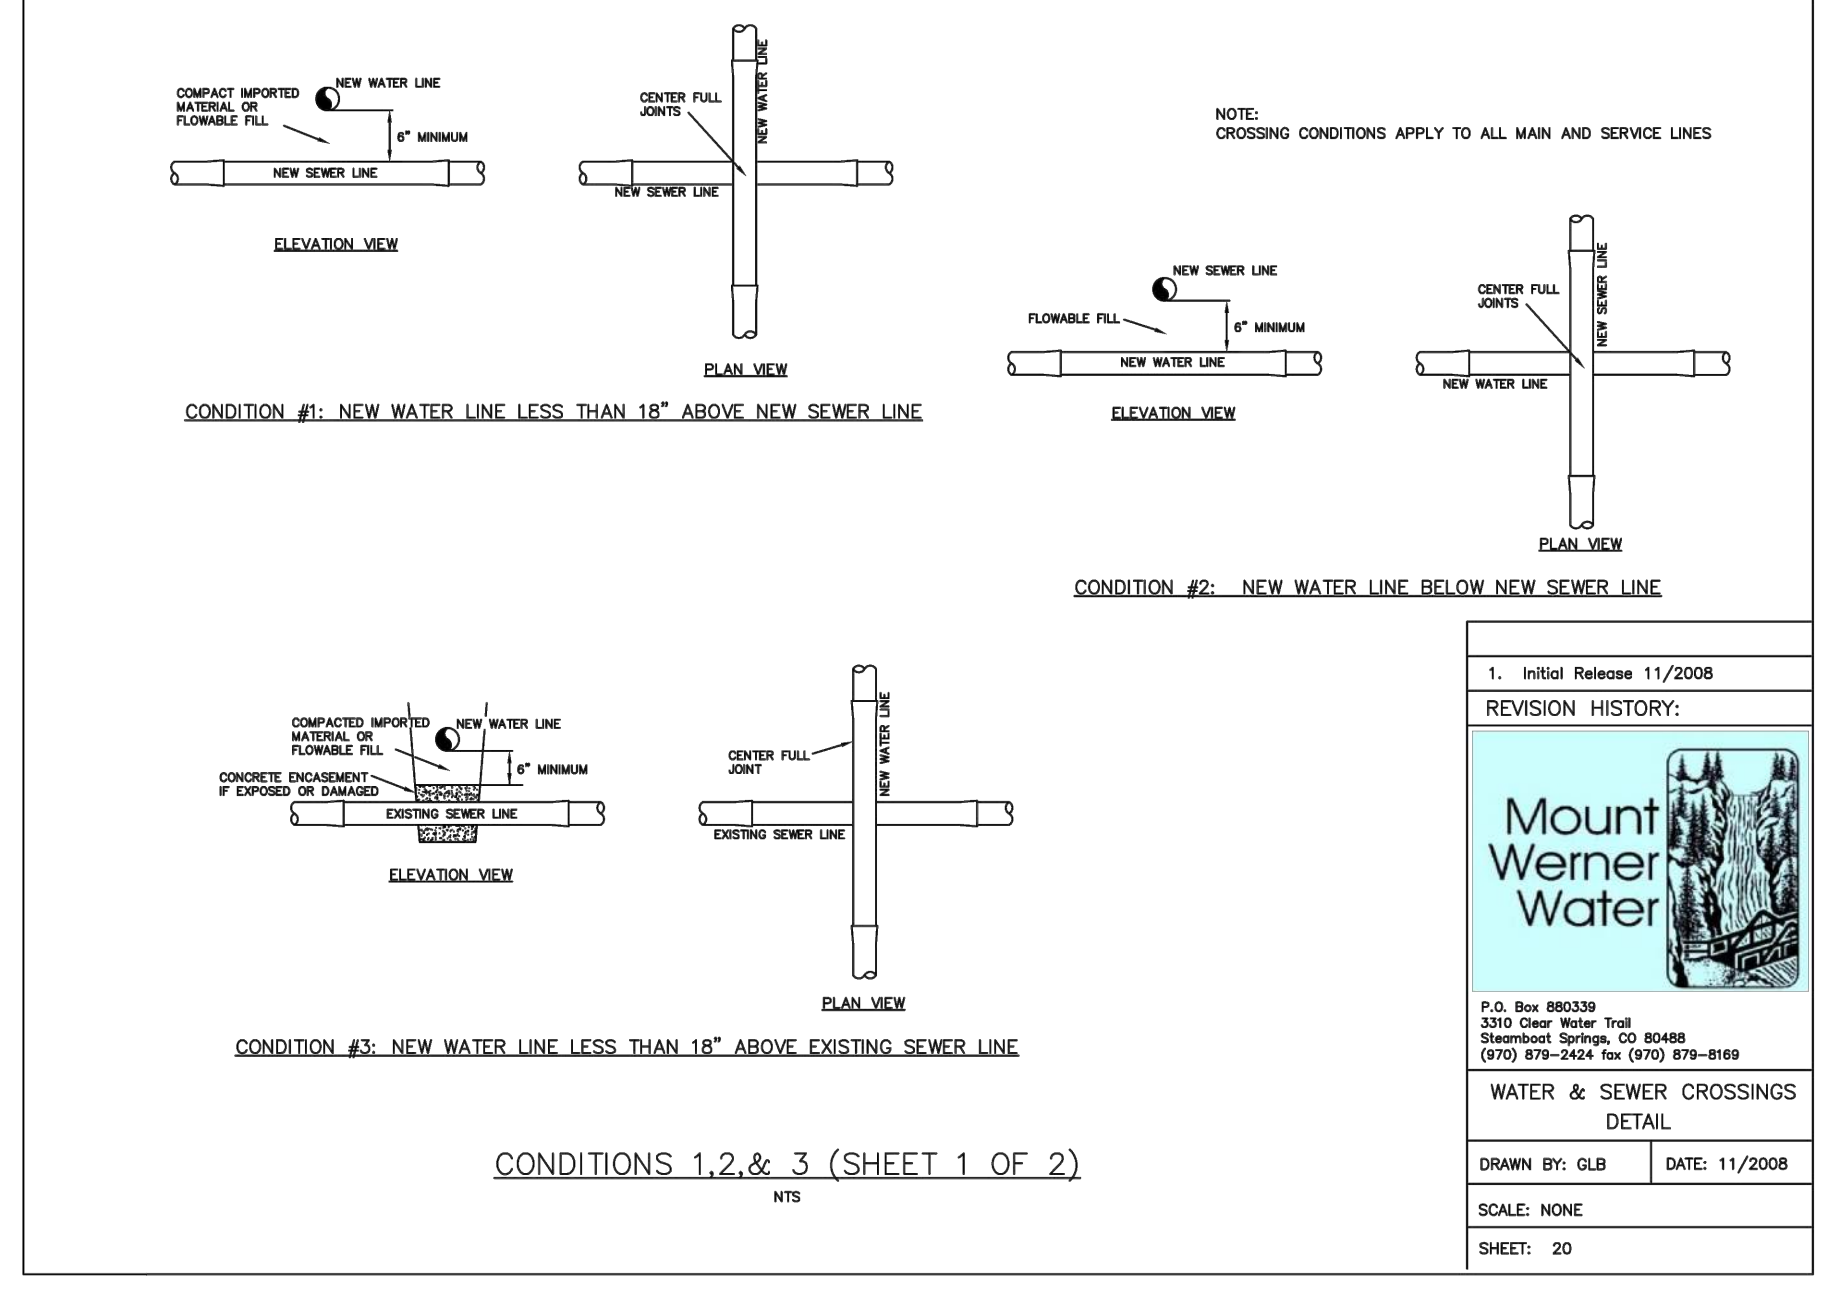

1. Initial Release 11/2008

REVISION HISTORY:

Mount Werner Water


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WATER & SEWER CROSSINGS DETAIL

DRAWN BY: GLB DATE: 11/2008

SCALE: NONE

SHEET: 20

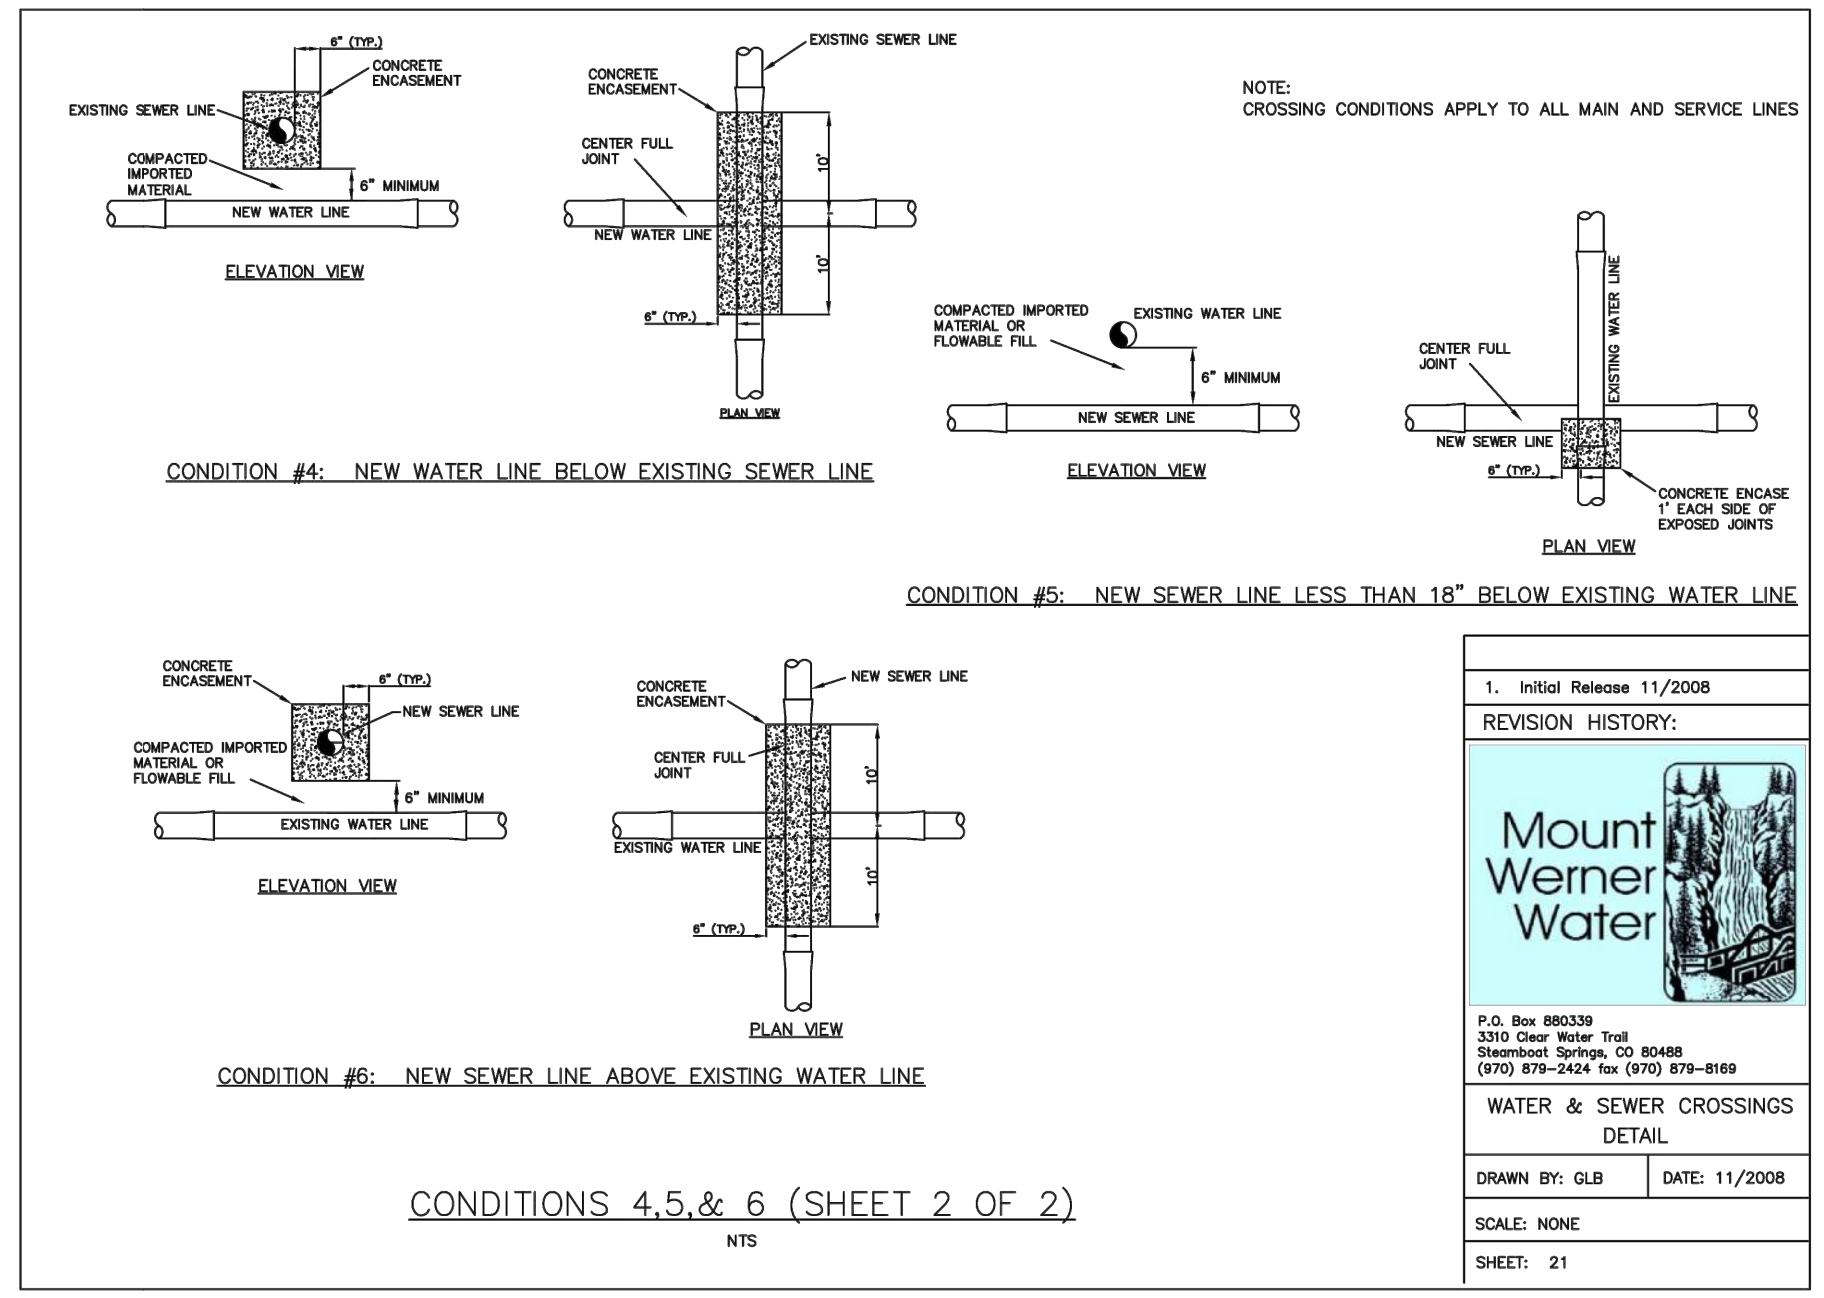

1. Initial Release 11/2008

REVISION HISTORY:

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WATER & SEWER CROSSINGS DETAIL

DRAWN BY: GLB DATE: 11/2008

SCALE: NONE

SHEET: 21

Steamboat
ALTRERA east west partners
MOUNTAIN COMPANY

2305 Mount Werner Circle
Steamboat Springs, CO 80487

Gensler

1225 17th Street Suite 150
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United States

1390 Lawrence Street Suite 100
Denver, CO 80204
Tel 303.623.5186

141 9th Street PO Box 774943
Steamboat Springs, CO 80477
Tel 970.871.9494

1390 Lawrence Street Suite 300
Golden, CO United States
Tel 303.421.6655

14143 Denver West Pkwy Suite 300
Golden, CO United States
Tel 303.421.6655

2021.05.19 BP3: GOLDWALK - ISSUE FOR BID AND PERMIT

Date	Description
2021.05.19	BP3: GOLDWALK - ISSUE FOR BID AND PERMIT

NOT VALID WITHOUT ORIGINAL SIGNATURE AND DATE

Seal / Signature

Project Name: GOLD WALK

SSRC | BASE AREA IMPROVEMENTS

Project Number: 003.7835.000

Description: MWW Standard Details

Scale: SEE GRAPHICAL SCALE

811
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KEY PLAN

1B-C.520

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