16 GA STEEL, FACTORY PRIMED.

BASIS-OF-DESIGN FOR HOLLOW METAL DOORS & FRAMES CECO DOOR (ASSA ABLOY) OR APPROVED EQUAL www.cecordoor.com 888-264-7474

PRODUCT:

FIRE RATED AND NON FIRE RATED STEEL FRAMES SERIES SU STEEL FRAMES (UNEQUAL RABBET) FOR 1 3/4" THICK DOORS STANDARD WALL APPLICATION, HANDED KNOCK DOWN CORNER AT EXISTING WALLS, WELDED CORNERS AT NEW WALLS

SUBMITTALS:

PRODUCT DATA: DOOR MANUFACTURER'S TECHNICAL DATA FOR EACH TYPE OF FRAME. SHOP DRAWINGS: SUBMIT SHOP DRAWINGS INDICATING LOCATION AND SIZE OF EACH DOOR. FRAME, ELEVATION OF EACH KIND OF DOOR, HAND OF EACH COMPONENT, DETAILS OF CONSTRUCTION, LOCATION AND EXTENT OF HARDWARE BLOCKING, FIRE RATINGS, REQUIREMENTS FOR FACTORY FINISHING AND OTHER PERTINENT DATA.

WARRANTY LIFETIME LIMITED.

08 13 00 METAL DOORS:

DOOR LOCATION IS INDICATED ON DRAWINGS AND IN SCHEDULE

BASIS-OF-DESIGN FOR HOLLOW METAL DOORS & FRAMES CECO DOOR (ASSA ABLOY) OR APPROVED EQUAL www.cecordoor.com 888-264-7474

FIRE RATED AND NON FIRE RATED METAL DOORS REGENT (RI) OR OMEGA (OI) HONEYCOMB CORE DOORS (FLUSH AND EMBOSSED PANEL STEEL DOORS, BEVELED LOCK EDGE) SIZE: 1 3/4" THICK 18 GA STEEL DOOR PANEL FACE, FACTORY PRIME. PREP DOOR FOR HARDWARE

EXTERIOR METAL DOOR

VERSADOOR (VU) POLYURETHANE FOAM CORE (FLUSH AND EMBOSSED PANEL STEEL DOORS, NON-HANDED) 18 GA STEEL DOOR PANEL FACE, FACTORY PRIME.

PREP DOOR FOR HARDWARE

PRODUCT DATA: DOOR MANUFACTURER'S TECHNICAL DATA FOR EACH TYPE OF DOOR. INCLUDING DETAILS OF CORE AND EDGE CONSTRUCTION, TRIM FOR OPENINGS AND FACTORY FINISHING SPECIFICATIONS. SHOP DRAWINGS: SUBMIT SHOP DRAWINGS INDICATING LOCATION AND SIZE OF EACH DOOR, ELEVATION OF EACH KIND OF DOOR, HAND OF EACH COMPONENT, DETAILS OF CONSTRUCTION, LOCATION AND EXTENT OF HARDWARE BLOCKING, FIRE RATINGS, REQUIREMENTS FOR

FACTORY FINISHING AND OTHER PERTINENT DATA. Provide tempered glass as required by code, and all weather-stripping, jamb extensions, adjustable thresholds, nailing fins, drip caps, etc. Attach door units as recommended by manufacturer. Doors shall be hung and shimmed, plumb and square, providing smooth operation and even closing.

WARRANTY LIFETIME LIMITED.

08 31 00 ACCESS DOORS AND PANELS

Basis of Design - The Williams Brothers Corporation of America (www.wbdoors.com)

WB-FR 800 Series Standard Insulated Metal Fire Rated Access Door: 2-hour rated for floor/ceiling, 1-1/2 hour rated for wall assembly. Size as appropriate. Keep size as small as possible.

Paint all doors to match adjacent surface

WB-DW 400 Series for Drywall Access Door: Non-Rated Wall Assembly: size as appropriate. Keep size as small as possible. Paint all doors to match adjacent

Accessories, connectors, and related materials shall be as per manufacturer's instructions and building code

requirements. Install per manufacturers recommendations.

**08 70 00 DOOR HARDWARE:** WORK INCLUDED:

The work in this section shall include furnishing of all items of finish hardware as hereinafter specified or obviously necessary to complete the building, except those items, which are specifically excluded from this section of the

RELATED WORK SPECIFIED ELSEWHERE: Metal Frames: Section 08 12 00 Metal Doors: Section 08 13 00

REFERENCES: A. ANSI/NFPA 80 - Fire Doors and Windows B. AWI - Architectural Woodwork Institute C. BHMA - Builders' Hardware Manufacturers Association D. DHI - Door and Hardware Institute

E. NAAMM - National Association of Architectural Metal Manufacturers F. NFPA 101 - Life Safety Code

G. ANSI/BHMA A156.17

**DESCRIPTION OF WORK:** 

Furnish material to complete hardware work indicated, as specified herein, or as may be required by actual conditions at building. Include all necessary screws, bolts, expansion shield, other devices, if necessary as required for proper hardware application. The hardware supplier shall assume all responsibility for correct quantities.

All hardware shall meet the requirements of Federal, State, and Local codes and laws having jurisdiction over this project, notwithstanding any real or apparent conflict therewith in these specifications.

Fire-Rated Openings

Provide hardware for fire-rated openings in compliance with NFPA 80 and NFPA Standards No. 101. This requirement takes precedence over other requirements for such hardware. Provide hardware that has been tested and listed by UL for the types and sizes of doors required and complies with the requirements of the door and door frame labels.

Hardware as furnished shall conform to published template generally prepared for machine screw installation. Furnish each item complete with all screws required for installation. Typically, all exposed screw installation. Insofar as practical, furnish concealed type fasteners for hardware that is exposed. Screws shall be furnished with Phillips flat head, finished to match adjacent hardware.

Door closures and exit devices to be installed on wood or composite fire doors shall be attached with closed head through bolts (hex bolts).

Prior to ordering hardware, prepare and submit for review of hardware schedule covering all items required for entire job. Schedule to identify manufacturer of each item and shall give type numbers and finish symbols; including catalog cuts for each item. No horizontal schedule will be accepted. Review of the hardware schedule shall not relieve contractor from furnishing all necessary hardware specified in this section.

Furnish suitable templates, together with finish hardware schedule to contractor, for distribution to necessary trades. Furnish three sets of operating and maintenance manuals for all hardware.

Submit samples as requested of any items of hardware to be furnished for the project for final review. Architect-Engineer is sole judge of equality.

Submit keying schedule as directed by Owner or Architect/Engineer.

General Contractor to Submit copy of final approved hardware schedule to Building Department. unction

**DIVISION 08 – OPENINGS** 

08 70 00 DOOR HARDWARE (CONT): General Contractor to Submit copy of final approved hardware schedule to Building Department.

Basis of Design hardware products for door hardware listed below (or equal): Products: Manufacturer: Hinges (MC) McKinney / Sargent / Ives Cylinders (CR) Corbin/Russwin Locks/Latches (CR) Corbin/Russwin Exit Devices (CR) Corbin/Russwin Electronic Door Locks (AA) Assa Abloy VingCard Flex Closers (AA) Assa Abloy Exit Devices (AA) Assa Abloy Overhead Stop/Holders (RW) Rockwood Miscellaneous Door Trim (RW) Rockwood (Silencers, door stops, etc.)

Weatherstripping (PE) Pemco Overlapping Astragal (PE) Pemco Electric Strikes (AR) Adams Rite Magnetic Holders (RI) Rixson

Furnish all items in US26D Brushed Satin Chrome except as indicated in the Hardware Schedule. Use 2 pair of hinges or 2 each intermediate pivots at doors 7'-6" high and over. Use 5" x 4-1/2" hinges at doors 3'-6" wide and over.

Furnish glass bead kits at exit devices where required. Fasten all exit devices and closers with SNB's. Furnish all brackets required to mount closers, as required by frame or door details.

QUALITY ASSURANCE

Hardware furnished in connection with doors and frames requiring fire rated labels shall be approved for such use and have such labels as required.

Hardware shall meet the requirements of all applicable labeling authorities and shall complement the NFPA 80 and NFPA 101 requirements of Division 8.

Items not specifically listed, but incidental to or required for completion of project, shall be provided and shall conform in class, quality, and type as required for particular use or as specified in like and similar locations. All fastenings, templates, and all accessory items scheduled and/or required to complete project shall be provided.

A. Manufacturers: Companies specializing in manufacturing door hardware with minimum ten years experience. B. Hardware Supplier: Company specializing in supplying commercial door hardware who has maintained an office and has been furnishing hardware in the project's vicinity for a period of at least ten (10) years. Hardware supplier must be an authorized distributor of the products specified.

Hardware supplier shall have in his employment, at least one experienced Architectural Hardware Consultant

(AHC) who is available at reasonable times during business hours for consultation about project's hardware and

requirements to Owner, Architect and Contractor. WARRANTY:

All items, except overhead closers, shall be warranted in writing by the manufacturer against failure due to defective materials and workmanship for a period of one (5) years commencing on the Date of Final Completion and Acceptance. In the event of product failure, promptly repair or replace item with no additional cost to the Owner.

Closers shall be warranted in writing by the manufacturer against failure due to defective materials and workmanship for a period of ten (10) years commencing on the Date of Final completion and Acceptance. In the event of product failure, promptly repair or replace item with no additional cost to the Owner.

A. Architectural Hardware Consultant shall inspect complete installation and certify that hardware has been furnished and installed in accordance with manufacturer's instructions and as specified herein. B. Provide two copies of certifications to Architect.

Return to project one month after occupancy and adjust hardware for proper operation and function.

## **DIVISION 09 – FINISHES**

**SECTION 09 22 16 NON-STRUCTURAL MEAL FRAMING** Framing Members: Comply with ASTM C 754 for conditions indicated.

Steel Sheet Components: Comply with ASTM C 645 requirements for metal, unless otherwise indicated. Protective Coating: Coating with equivalent corrosion resistance of ASTM A 653/A 653M, G40 (Z120), hot-dip galvanized, unless otherwise indicated.

Studs: Manufacturer's standard profile for repetitive members, corner and end members, and fireresistance-rated assembly indicated on drawings.

Deflection: Limit H/360

Runner Tracks: Manufacturer's standard J-profile track with long-leg length as standard with Auxiliary Material.

Furring Channels (Furring Members): Hat-Shaped, Rigid Furring Channels: ASTM C 645, 7/8 inch (22.2 mm) deep.

Minimum Requirements: 25 gauge, hemmed edge detail required on all 25 gauge furring channel. Meets or exceeds SSMA requirements. Depth: 7/8 inch

Width Bottom: 2-1/2 inch wide minimum. Width Top: 1-1/4 inch wide

Steel Drill Screws: ASTM C 1002, unless otherwise indicated.

Track Fasteners: Power-driven fasteners of size and material required to withstand loading conditions imposed on assemblies without exceeding allowable design stress of track, fasteners, or structural substrates in which anchors are

Power-Actuated Anchors: Fastener system of type suitable for application indicated, fabricated from corrosion-resistant materials, with capability to sustain, without failure, a load equal to 10 times design load, as determined by testing per ASTM E 1190 conducted by a qualified testing agency.

Products: Subject to compliance with requirements, provide the following: Dietrich Metal Framing or approved equal.

Studs to be designed by manufacturer. Submit shop drawings for review and approval.

Install per manufacturers recommendations.

<u>09 29 00 GYPSUM BOARD</u>

TYPE-X gypsum board - "USG 5/8" Sheetrock" fire code "X" or (approved equal) Refer to sound isolation and noise reducing assemblies for additional requirements. Seal all penetrations with approved

Exterior Sheathing - 5/8" Georgia-Pacific DensGlass GOLD Sheathing or equal. Verify sheathing system with exterior

Exterior Soffit - 5/8" USG Sheetrock Exterior Gypsum Ceiling Board with Firecode C Core at fire rated soffits with soffit finish (board or other finish) over the top.

Shaft Walls: 1" gypsum board shaft liner - "USG Sheetrock Brand Gypsum Liner Panels" or approved equal. Refer to fire

rated assembly details for more information. Joint Treatment: "USG Durabond 90" joint compound

Panel Fastening Method: Screw all walls and ceilings at required spacing. Provide non-corrosive fasteners at all wet

Accessories: "USG" metal square corner beads (26 GA, Zinc Coated), casing beads, tape and reinforcement, unless shown otherwise in drawings.

Finish: GYPSUM BOARD WALLS AND CEILING FINISHES ARE TO BE LEVEL 4.

Provide a sample (3'-0" x 3'-0") for Owner review and approval before construction.

## **DIVISION 09 - FINISHES (CONT)**

09 91 13 EXTERIOR PAINTING

Provide the following paint systems for the various substrates, as indicated. The systems are based on Benjamin Moore and Co. and ICI, unless noted.

Exterior Railings - Pre-Finish

Provide pre-finished Kynar Finish (Or Approved Equal) on metal railings. Color: Black.

(i.e. flashing, exposed piping, louvers, vents, steel lintels, etc. Any non-pre finished exposed metal locations) (A) PRIMER: "BENJAMIN MOORE" IRONCLAD RETARDO RUST INHIBITIVE PAINT (163) (B) 1ST COAT: "BENJAMIN MOORE" MOORE'S SEMI-GLOSS EXTERIOR LATEX HOUSE PAINT (105) (C) 2ND COAT: SAME AS FIRST COAT"

Submit product literature and color selections, color to be similar to adjacent wall material.

Sand and prep all interior and exterior metal receiving field finish prior to applying finishes to produce a very smooth

Install per manufacture's requirements

PROVIDE THE FOLLOWING PAINT SYSTEMS FOR THE VARIOUS SUBSTRATES, AS INDICATED. THE SYSTEMS ARE BASED ON BENJAMIN MOORE AND CO, AND ICI, UNLESS NOTED.

GYPSUM BOARD OR CONCRETE TYPICAL PAINT (A) PRIOR TO DRYWALL TEXTURE (IF USED) APPLY ONE COAT OF "HAMILTON PREP COAT PLUS".

PAINTER TO APPLY THIS COAT AS REQUIRED. PATCH CONCRETE AS REQUIRED. (B) PRIMER: "BENJAMIN MOORE" REGAL CLASSIC PREMIUM INTERIOR LATEX PRIMER (N216).

DRY FILM THICKNESS OF NOMINAL 1.5-1.6 MILS (0.038 mm - 0.040 mm) (C) 1ST COAT: "BENJAMIN MOORE" REGAL CLASSIC PREMIUM INTERIOR 100% ACRYLIC EGGSHELL FINISH (N319). DRY FILM THICKNESS OF NOMINAL 1.2-1.5 MILS (0.030 mm - 0.038 mm). (D) 2ND COAT: SAME AS FIRST COAT

EXPOSED BRICK OR CMU PAINT

(A) PRIOR TO PRIMER: "BENJAMIN MOORE" SUPER SPEC MASONRY INTERIOR/EXTERIOR HI-BUILD BLOCK FILLER (206) AS NEEDED FOR PITS IN EXISTING MASONRY. PAINTER TO APPLY THIS COAT AS REQUIRED. (B) PRIMER (MINIMUM TWO COATS PRIMER, DRY FILM THICKNESS OF NOMINAL 8-12 MILS (0.20mm - 0.30

"BENJAMIN MOORE" REGAL CLASSIC PREMIUM INTERIOR LATEX PRIMER (N216)

(C) 1ST COAT: "BENJAMIN MOORE" REGAL CLASSIC PREMIUM INTERIOR 100% ACRYLIC EGGSHELL FINISH DRY FILM THICKNESS OF NOMINAL 1.2 - 1.5 MILS (0.030 mm - 0.038 mm)

(D) 2ND COAT: SAME AS FIRST COAT

INTERIOR EXPOSED METAL/FERROUS (A) PRIMER: "BENJAMIN MOORE" SUPER SPEC HP ACRYLIC METAL PRIMER (P04) OR SUPER SPEC HP ALKYL

PRIMER (P06) (B) 1ST COAT: 1ST COAT: "BENJAMIN MOORE" REGAL CLASSIC PREMIUM INTERIOR 100% ACRYLIC EGGSHELL FINISH

(C) 2ND COAT: SAME AS FIRST COAT

PAINT COLOR SELECTIONS: PAINT COLORS PER OWNER.

CONCRETE SLAB SEALANT:

BASIS OF DESIGN: WR MEADOWS SEALTIGHT. VOCOMP-30, WATER-BASED, ACRYLIC, CONCRETE CURING AND SEALING COMPOUND. INSTALL PER MANUFACTURES RECOMMENDATIONS.

PROVIDE SAMPLES AS NOTED UNDER SUBMITTALS BELOW FOR REVIEW BY OWNER AND ARCHITECT BEFORE PROVIDING ALL PAINT FOR PROJECT.

09 91 23 INTERIOR PAINTING (CONT)

Patch as needed, fill cracks and nail holes and correct any defects in substrate.

Examine surfaces to receive paint/stain and report any deficiencies that might impair the performance of the installation. Work indicates acceptance of substrate.

Remove all hardware, fixtures and accessories from surfaces to receive finish

Caulk/fill all interior trim work to walls.

finish coat.

Paint black all framing and exposed materials behind screened vent openings and grills including soffit vents and ventilation chimney locations.

Samples at the site of all exterior and all interior colors and finishes shall be provided for approval by Owners/Architect prior to any ordering or staining or painting of any of the materials. Follow manufacturer's directions for proper spreading rate, thickness and acceptable temperature and humidity range.

Finishes must be applied evenly; sags, runs and uneven finishes will not be accepted. Set all nail heads and fill holes with filler to match material. Filler to be compatible with finish. Paint all interior piping and mechanical and electrical equipment which is not prefinished and is exposed in finished spaces. Paint miscellaneous vents, louvers, trim to match adjacent wall color or material.

Product Data: Submit manufacturer's technical information including paint label analysis and application instructions for each material proposed for use.

Samples: Submit samples for Architect's review and color and texture only. Provide a listing of material and application for each coat of each finish sample.

On 4" x 8" hardboard, provide two samples of each color and material, with texture to simulate actual conditions. Resubmit samples as requested by Architect until acceptable sheen, color, and texture is achieved. On concrete masonry, provide two 4" x 8" samples of masonry for each type of finish and color, defining filler, prime and

On actual wall surfaces and other exterior and interior building components, duplicate painted finishes of prepared samples. On at least 100 sq. ft. of surface as directed, provide full coat finish samples until required sheen, color and texture is obtained; simulate finished lighting conditions for review of in place work.

## **DIVISION 10 - SPECIALTIES**

10 14 00 SIGNAGE:

SIGNAGE IS TO BE PROVIDED PER IBC 2018, ANSI A117.1 AND IN ACCORDANCE WITH ADA 2010 SECTION

216 AND SHALL COMPLY WITH ADA 2010 SECTION 703.

LOCATION: SIGNAGE TO BE PROVIDE FOR BUT IS NOT LIMITED TO THESE LOCATIONS: DIRECTIONAL SIGNAGE

**EGRESS SIGNAGE** MISCELLANEOUS IDENTIFICATION SIGNAGE FIRE EXTINGUISHER, FIRE ALARM RELATED SIGNAGE

PROVIDE AN ALLOWANCE OF FIVE THOUSAND DOLLARS (\$5,000.00) FOR SIGNAGE.

SIGNAGE PACKAGE TO BE PROVIDED BY CONTRACTOR FOR REVIEW BY OWNER AND ARCHITECT.

10 44 16 FIRE PROTECTION SPECIALTIES FIRE EXTINGUISHERS AND CABINETS

Provide fire extinguishers, cabinets, accessories manufactured by FIRE END & CROKER CORPORATION (www.croker.com) or approved equal.

LOCATIONS:

Boiler Room Actual locations and types of extinguishers to be determined/approved by local Fire Department.

INSTALL PER MANUFACTURERS REQUIREMENTS

## **DIVISION 14 – CONVEYING EQUIPMENT**

**14 20 00 ELEVATORS** HYDRAULIC PASSENGER ELEVATOR

RATED LOAD - 4000 LB RATED SPEED - 100 TO 150 FPM DOORS - 4'-0" WIDE X 7'-0" HIGH HOISTWAY - 9'-4" WIDE X 7'-0" DEEP

PIT DEPTH - 4'-0" SUMP PIT - REQUIRED TOTAL TRAVEL DISTANCE: 9'-6" LANDINGS - 2 FRONT OPENING, CENTERED OPERATION SYSTEM - AUTOMÁTIC OPERATION AS DEFINED IN ASME A17.1

**AUXILIARY OPERATIONS - BATTER-POWERED LOWERING** 

IN ADDITION TO LOCAL GOVERNING REGULATIONS AND INTERNATIONAL BUILDING CODE 2018. COMPLY WITH APPLICABLE PROVISIONS OF ASME A17.1 SAFETY CODE FOR ELEVATORS AND ESCALATORS AND

CEILING - EXPOSED FRAME WITH LAY-IN PANELS. SC02 LIGHTING - COMPACT FLUORESCENT DOWNLIGHTS

SYSTEM.

(OR EQUAL)

HANDRAILS - STAINLESS STEEL (PROVIDE ON 3 WALLS OF CAB) CAB - DECORATIVE WALLS PANELS TO BE BRUSHED STAINLESS STEEL DOORS AND FRAMES - STAINLESS STEEL

- AMERICANS WITH DISABILITIES ACT (ADA), ACCESSIBILITY GUIDELINES (ADAAG).

SILL - EXTRUDED METAL WITH GROOVED SURFACE ON NONSHRINK, NONMETALLIC GROUT. FLOORING - DIAMOND PLATE STEEL FLOORING

PROVIDE INSPECTION CERTIFICATE MOUNTED UNDER ACRYLIC OVER WITH STAIN STAINLESS-STEEL

PROVIDE PROTECTIVE BLANKET HOOKS AND TWO COMPLETE SETS OF FULL-HEIGHT BLANKETS. PROVIDE ALL CODE REQUIRED COMMUNICATION AND SIGNAL EQUIPMENT INCLUDING BUT NOT LIMITED TO: CAR CONTROL STATIONS, EMERGENCY COMMUNICATIONS SYSTEM, FIRE DEPARTMENT COMMUNICATION SYSTEM, CAR POSITION INDICATOR WITH TRAVEL DIRECTION ARROWS, HALL PUSH-

BUTTON STATIONS, HALL LANTERNS, ETC.

MINIMAL HEAT AND COOLING TO BE PROVIDED TO THE ELEVATOR MACHINE ROOM AND ELEVATOR HOISTWAY. MANUFACTURER TO PROVIDE MAX HEAT LOAD OF MACHINERY AND ALLOWABLE TEMPERATURE RANGES FOR MACHINE ROOM AND HOISTWAY TO USE FOR DESIGN OF HEATING/COOLING

FREIGHT: VERIFY THAT ELEVATOR CAN ACCOMMODATE FREIGHT AS WELL AS PASSENGERS. FREIGHT CARTS ARE 52" X 24" WIDE AND WEIGH +/- 600 LBS WHEN LOADED.

EXPECT (2) CARTS AND (2) STAFF MEMBERS IN THE LIFT AT ONE TIME.

PROVIDE SEPARATE ELEVATOR MACHINE ROOM (NO MACHINE ROOM-LESS APPLICATIONS DUE TO WEATHER RESTRICTIONS).

AVAILABLE MANUFACTURERS:
SCHINDLER ELEVATOR CORP (BASIS OF DESIGN) OTIS ELEVATOR CO

THYSSEN-KRUPP ELEVATOR GROUP OF NORTH AMERICA

**DIVISION 22 – PLUMBING** 

Plumbing specifications per Plumbing Engineer

DIVISION 23 – HEATING, VENTILATING AND AIR CONDITIONING HVAC specifications per Mechanical Engineer.

**DIVISION 26 – ELECTRICAL** 

Electrical specifications per Electrical Engineer

**DIVISION 26 – COMMUNICATIONS** 

Communications, Audio-Video, etc. specifications per Owner.

Job Number: 20034 12/30/20 Date: Author Checked By: Checker

CONSTRUCTION DOCUMENTS

**Sheet Number** 

OF COL ERIC P. APR 20 2027

NOTICE: DUTY OF COOPERATION Release of these plans contemplates further cooperation among the owner, his contractor and the architect. Design and construction are complex. Although the architect and his consultants have performed their services with due care and diligence they cannot guarantee perfection. Communication is imperfect and every contingency cannot be anticipated.

Any ambiguity or discrepancy discovered by the use of

relieve the architect of responsibility for all consequences arriving out of such changes. All design, documents and data prepared by Eric Smith Associates, P.C. as instruments of service shall remain property of Eric Smith Associates, P.C. and shall not be copied, changed or disclosed in any form whatsoever without first obtaining the express written consent of Eric Smith Associates, P.C. Eric Smith Associates, P.C

these plans shall be reported immediately to the architect. Failure to notify the architect compounds

misunderstanding and increases construction costs. A

failure to cooperate by a simple notice to the architect

shall relieve the architect from responsibility for the

consequences. Changes made from the plans without


consent of the architect are unauthorized and shall


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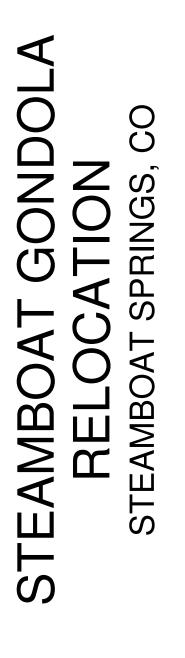
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Drawn By: **Project Phase** 

**Sheet Title** SPECIFICATIONS





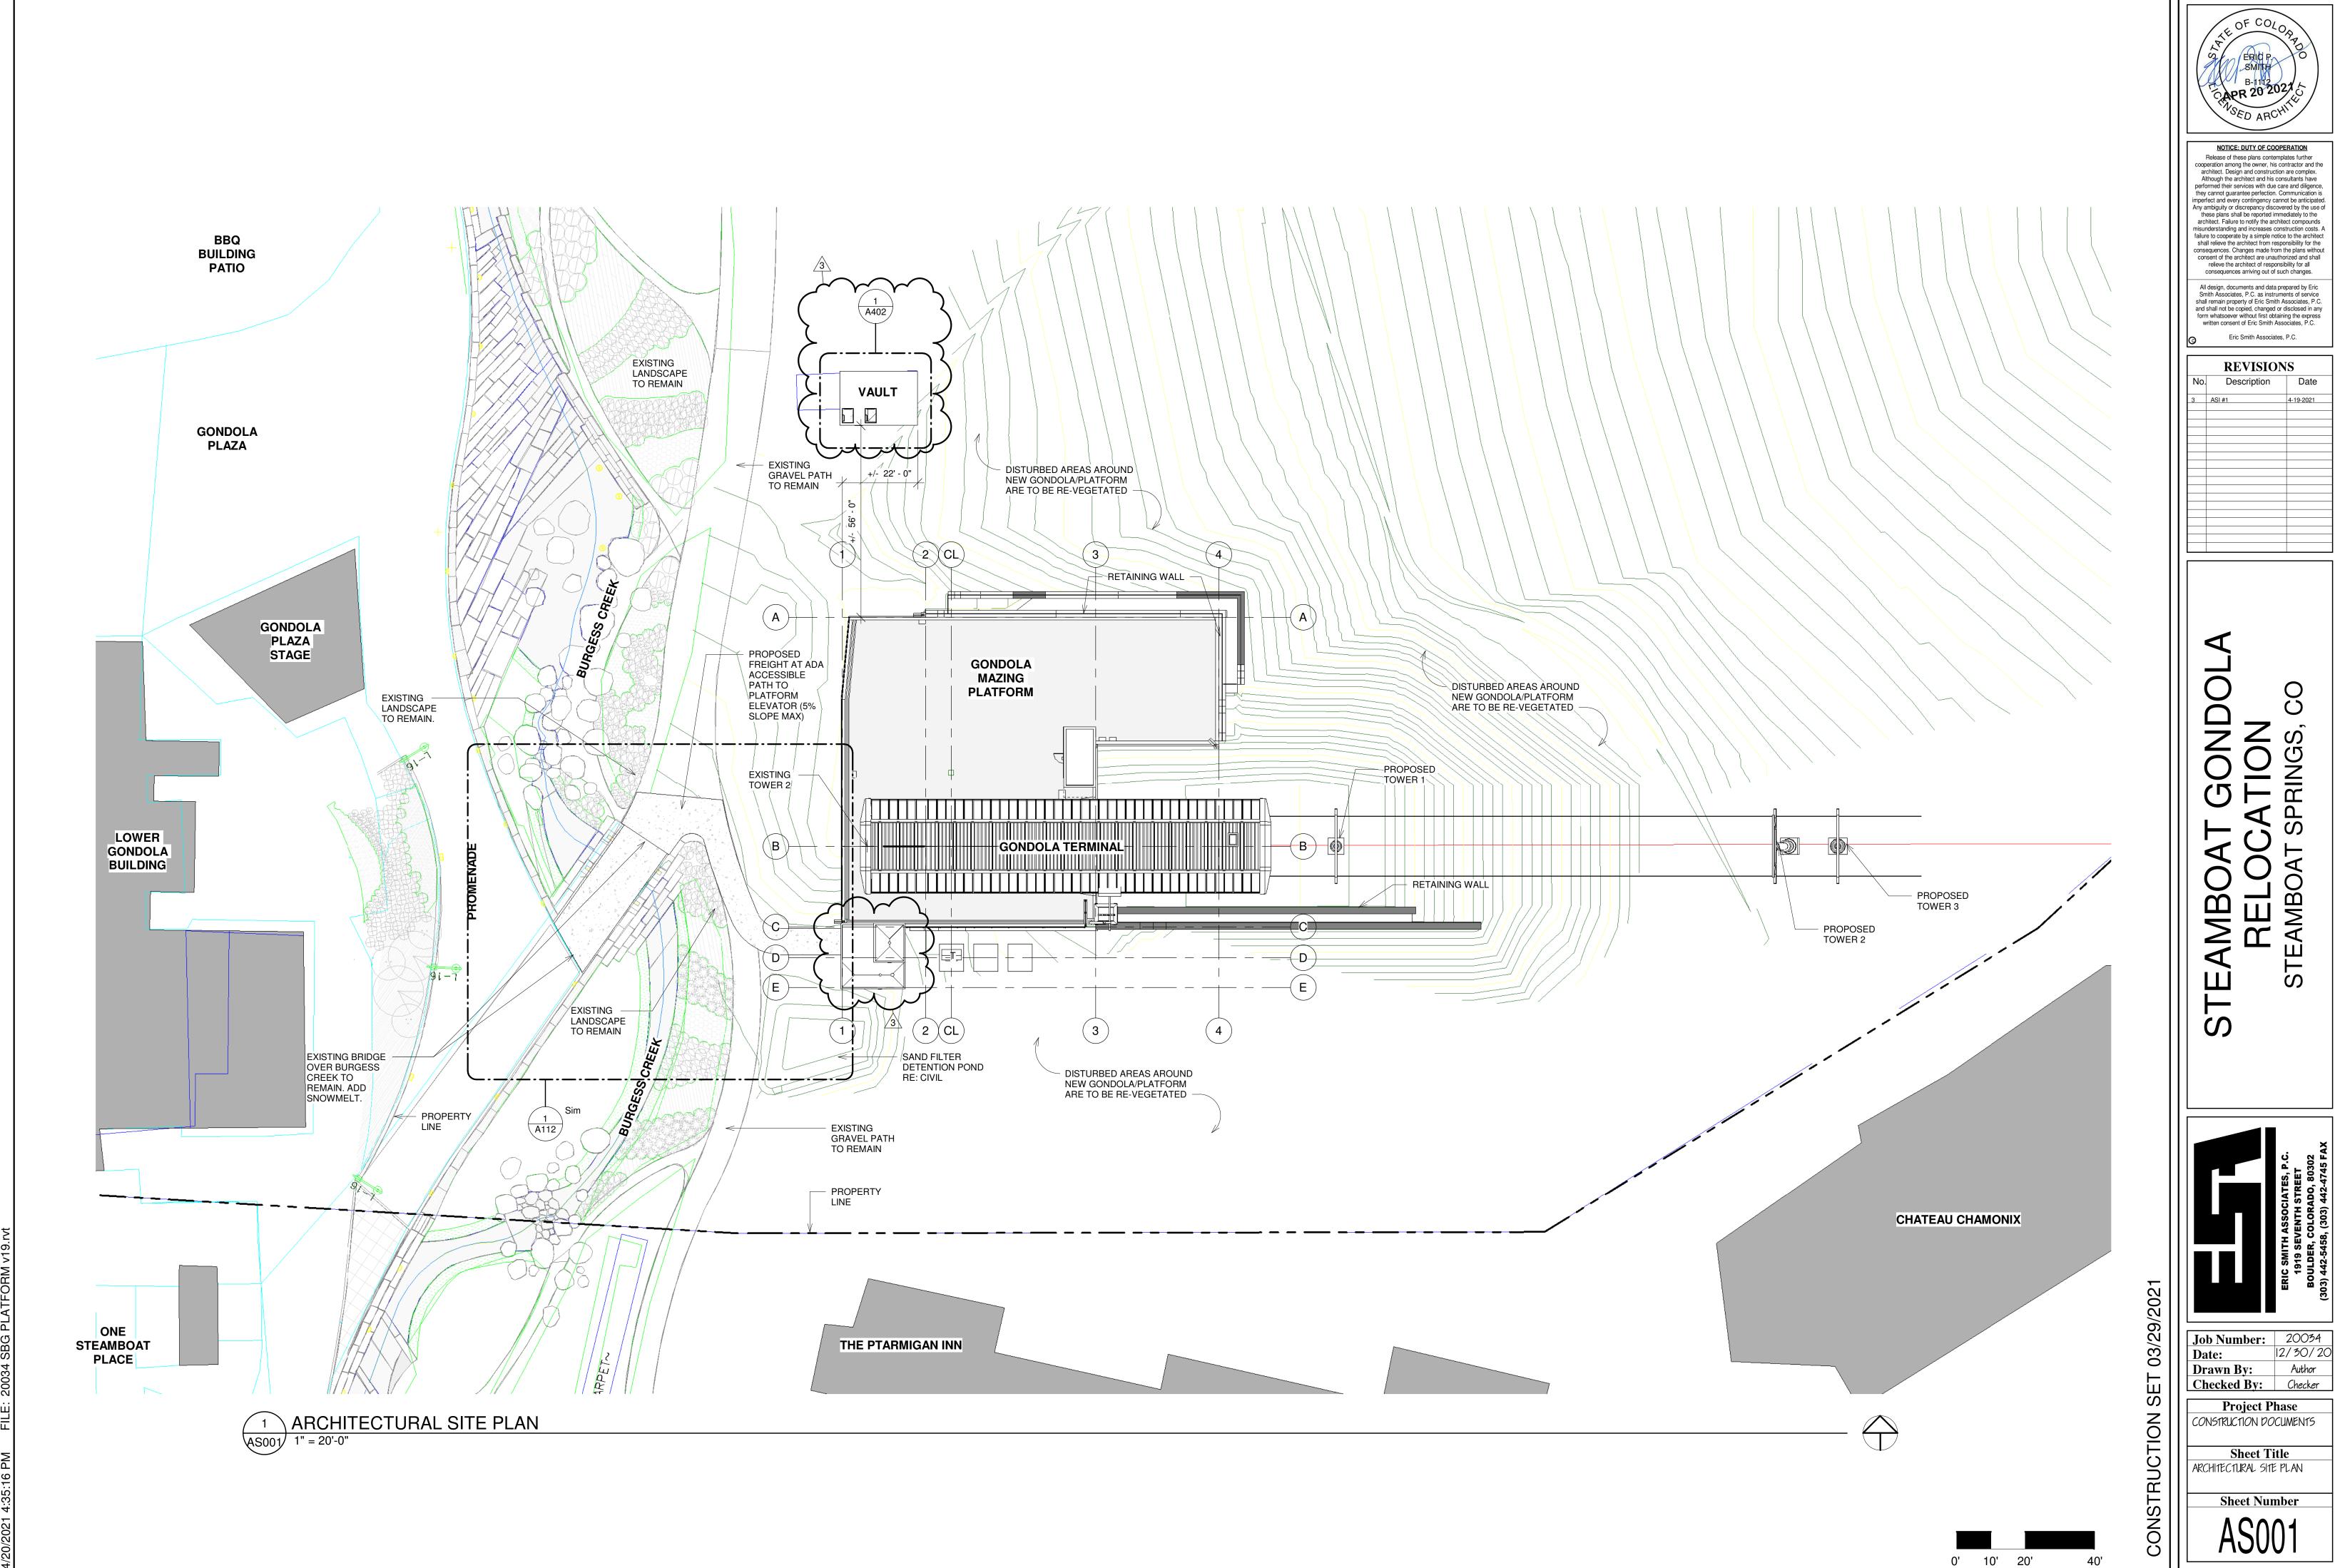
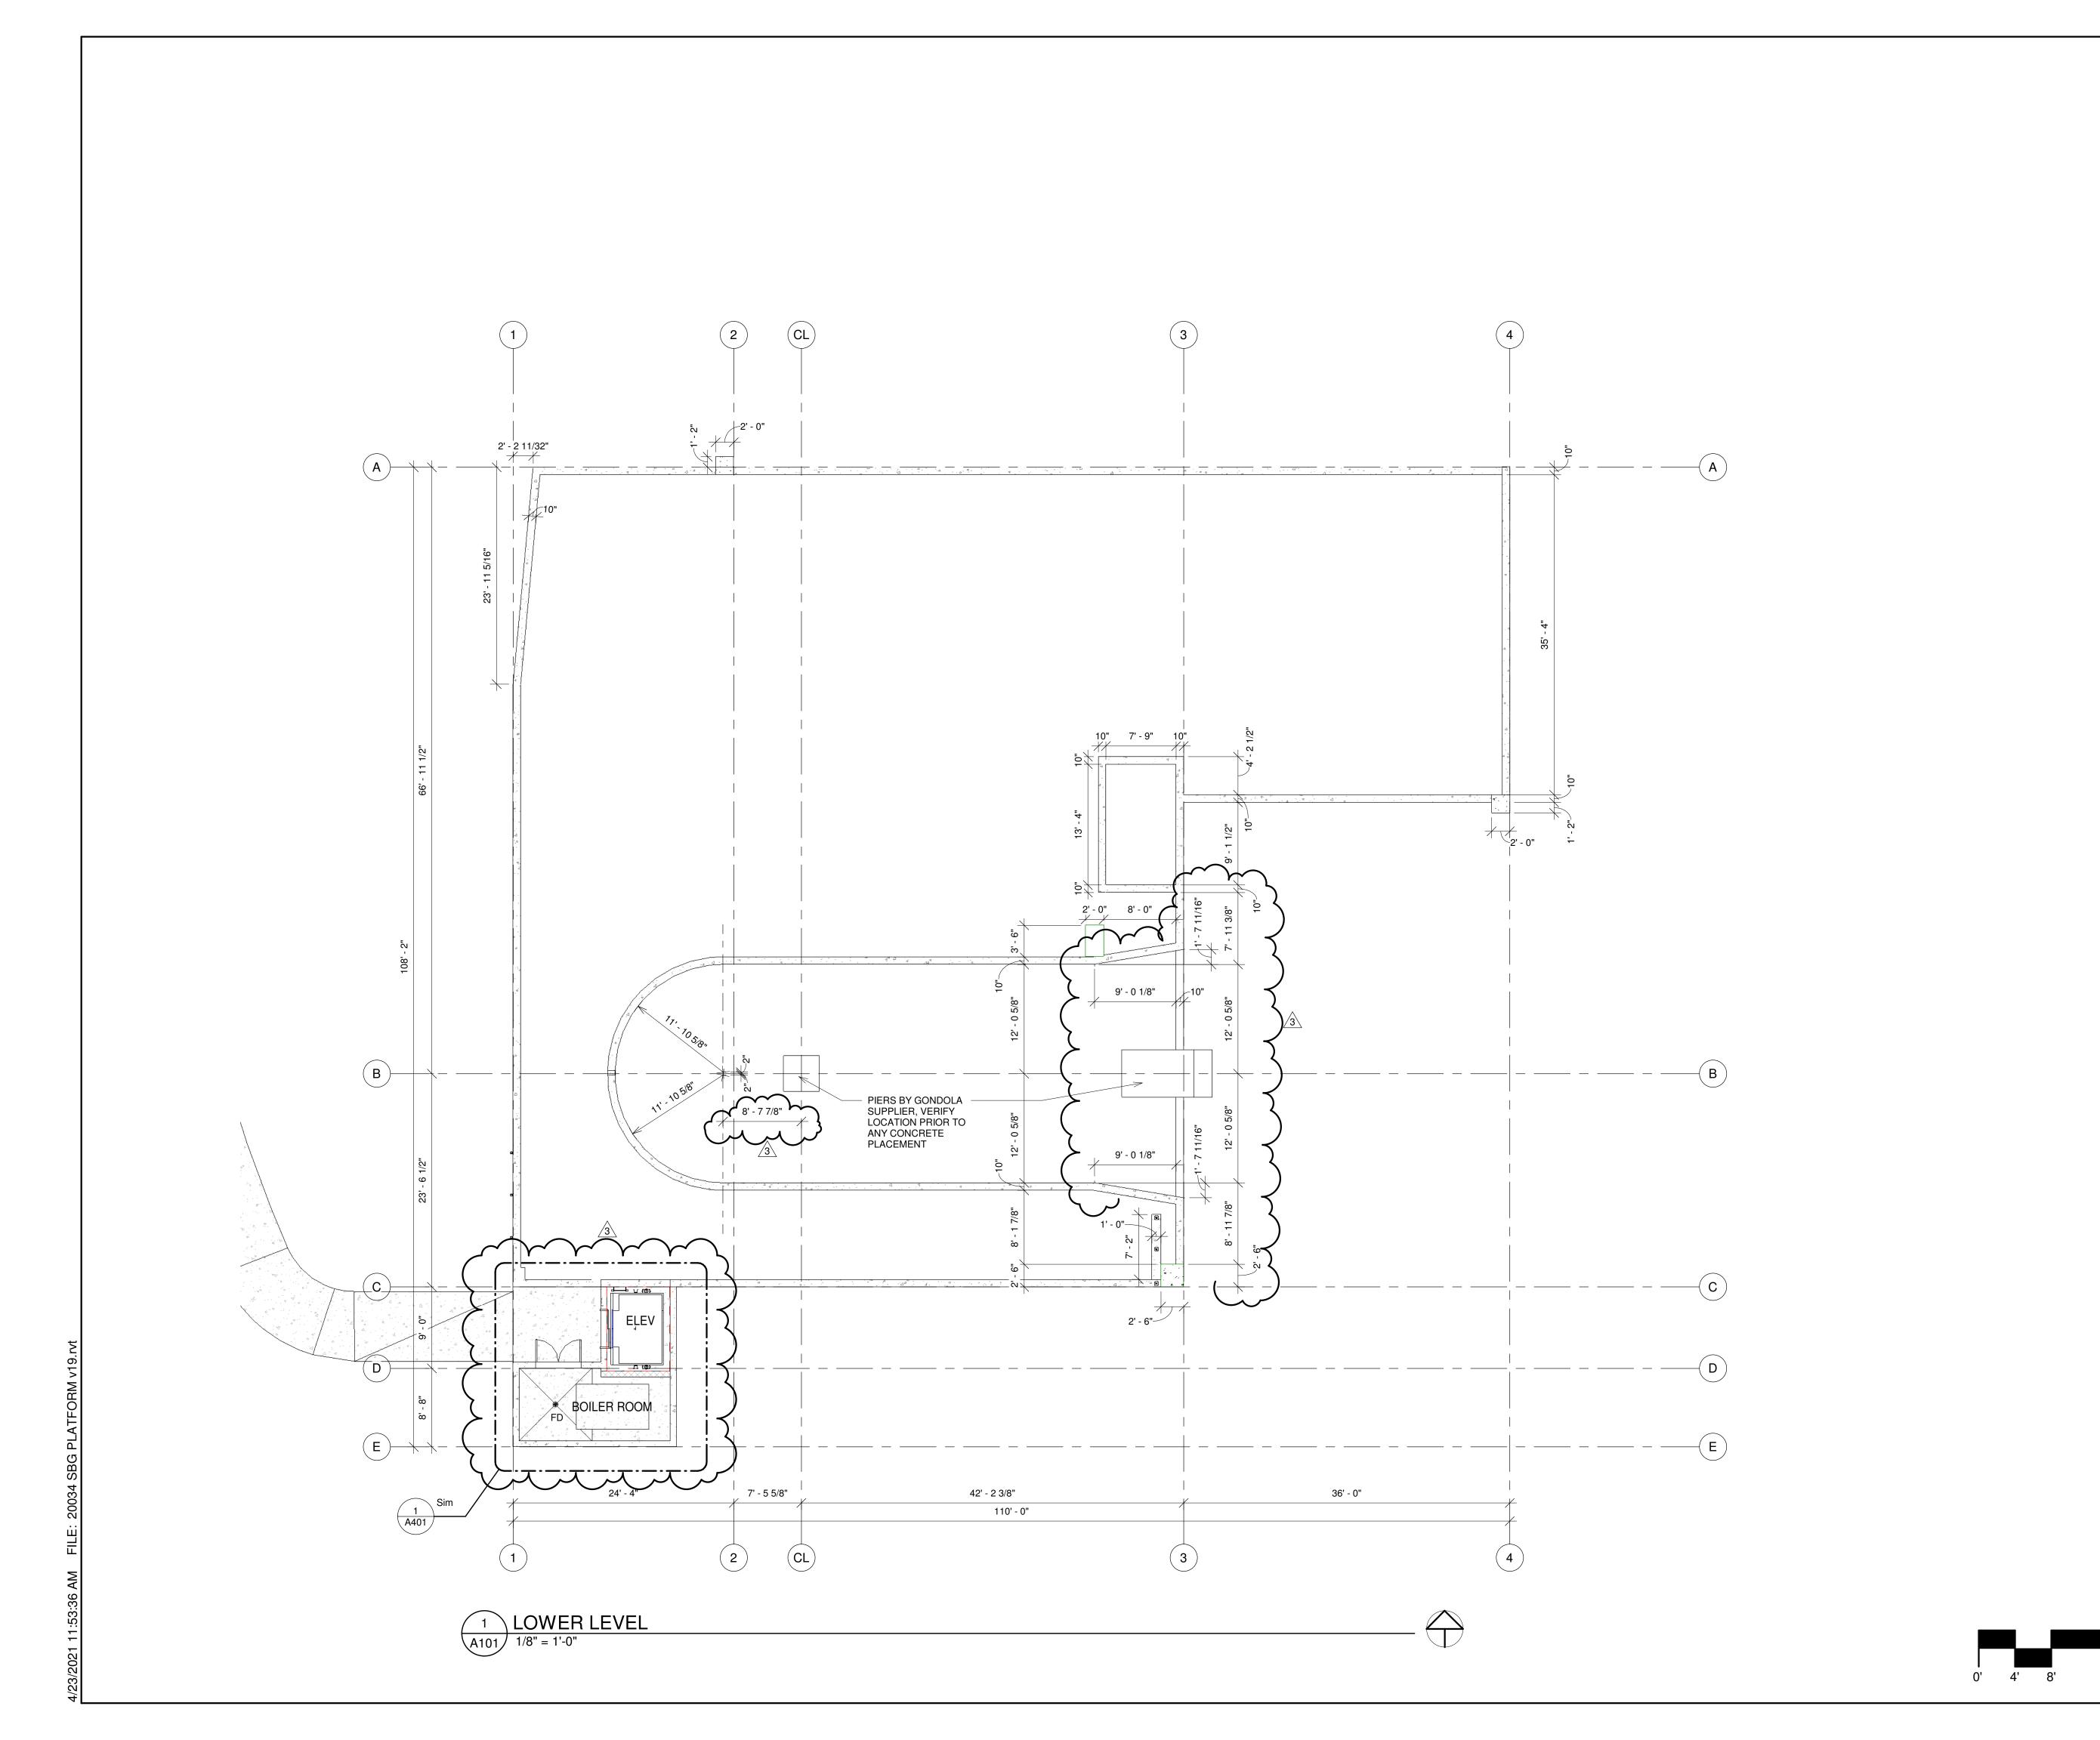
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Eric Smith Associates, P.C.

**REVISIONS** 

4-19-2021


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 20034

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Project Phase CONSTRUCTION DOCUMENTS

**Sheet Title** LOWER LEVEL PLAN




 
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Project Phase CONSTRUCTION DOCUMENTS

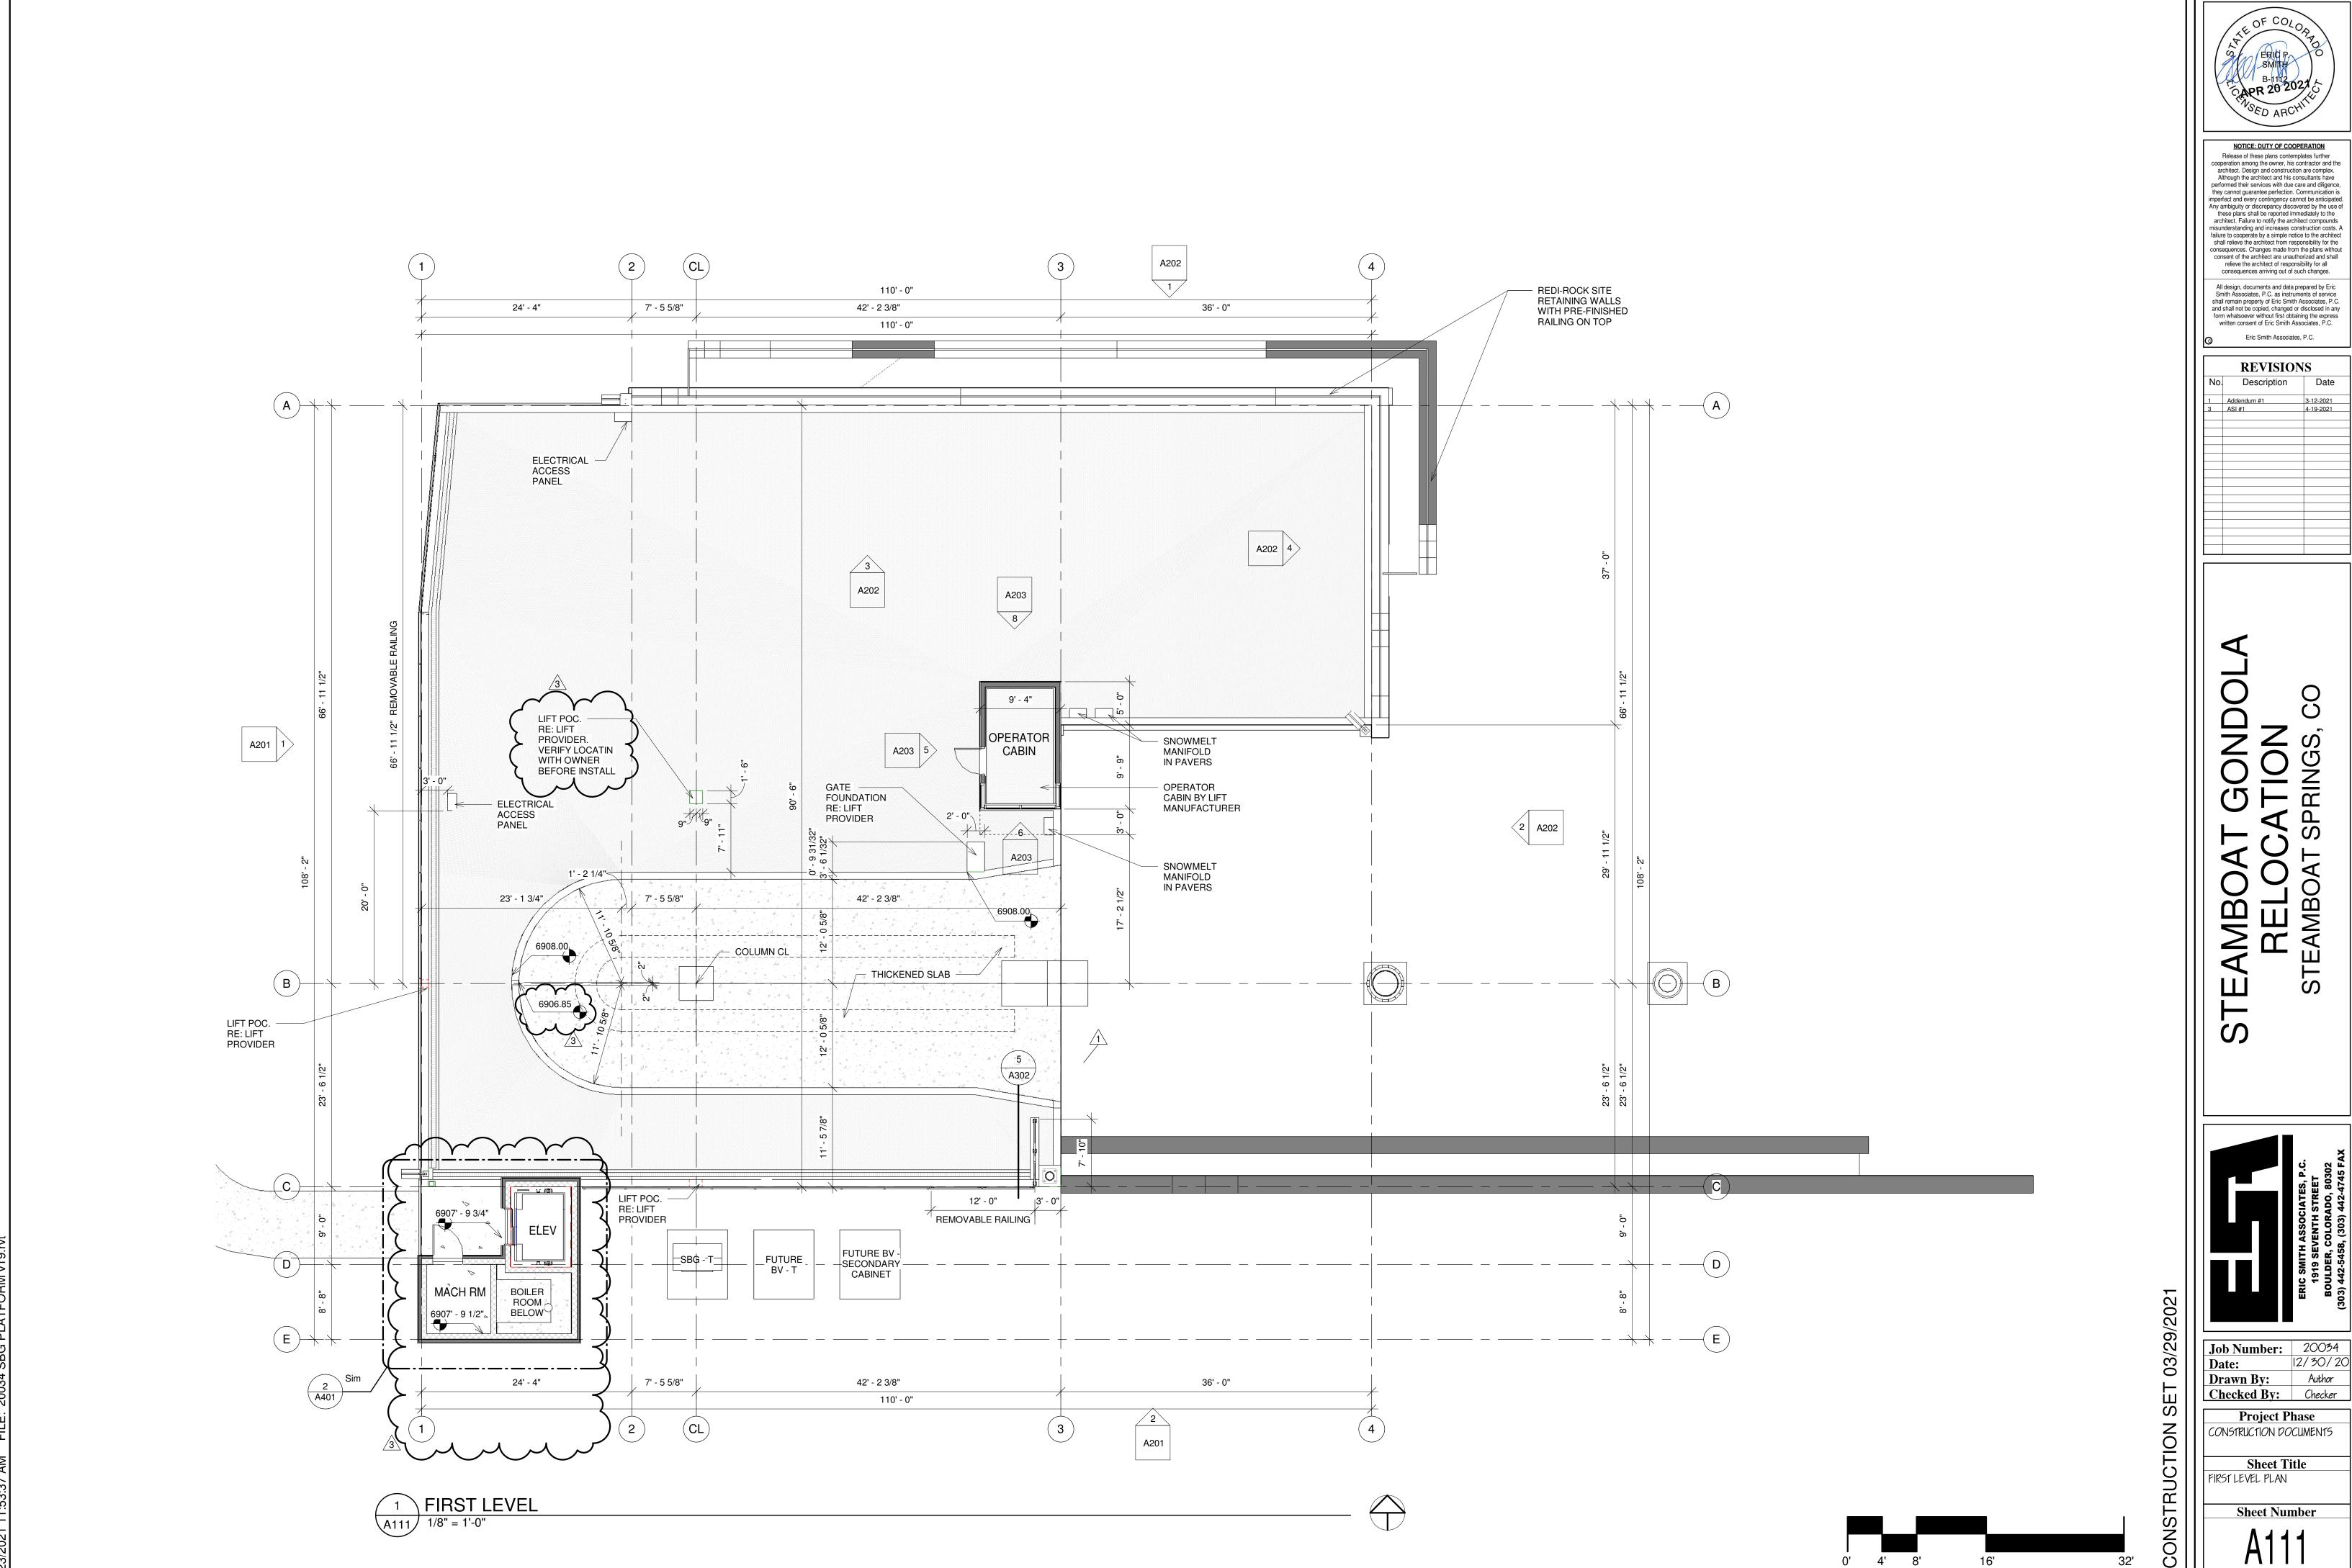**Sheet Number** 



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**REVISIONS** Description Date 4-19-2021

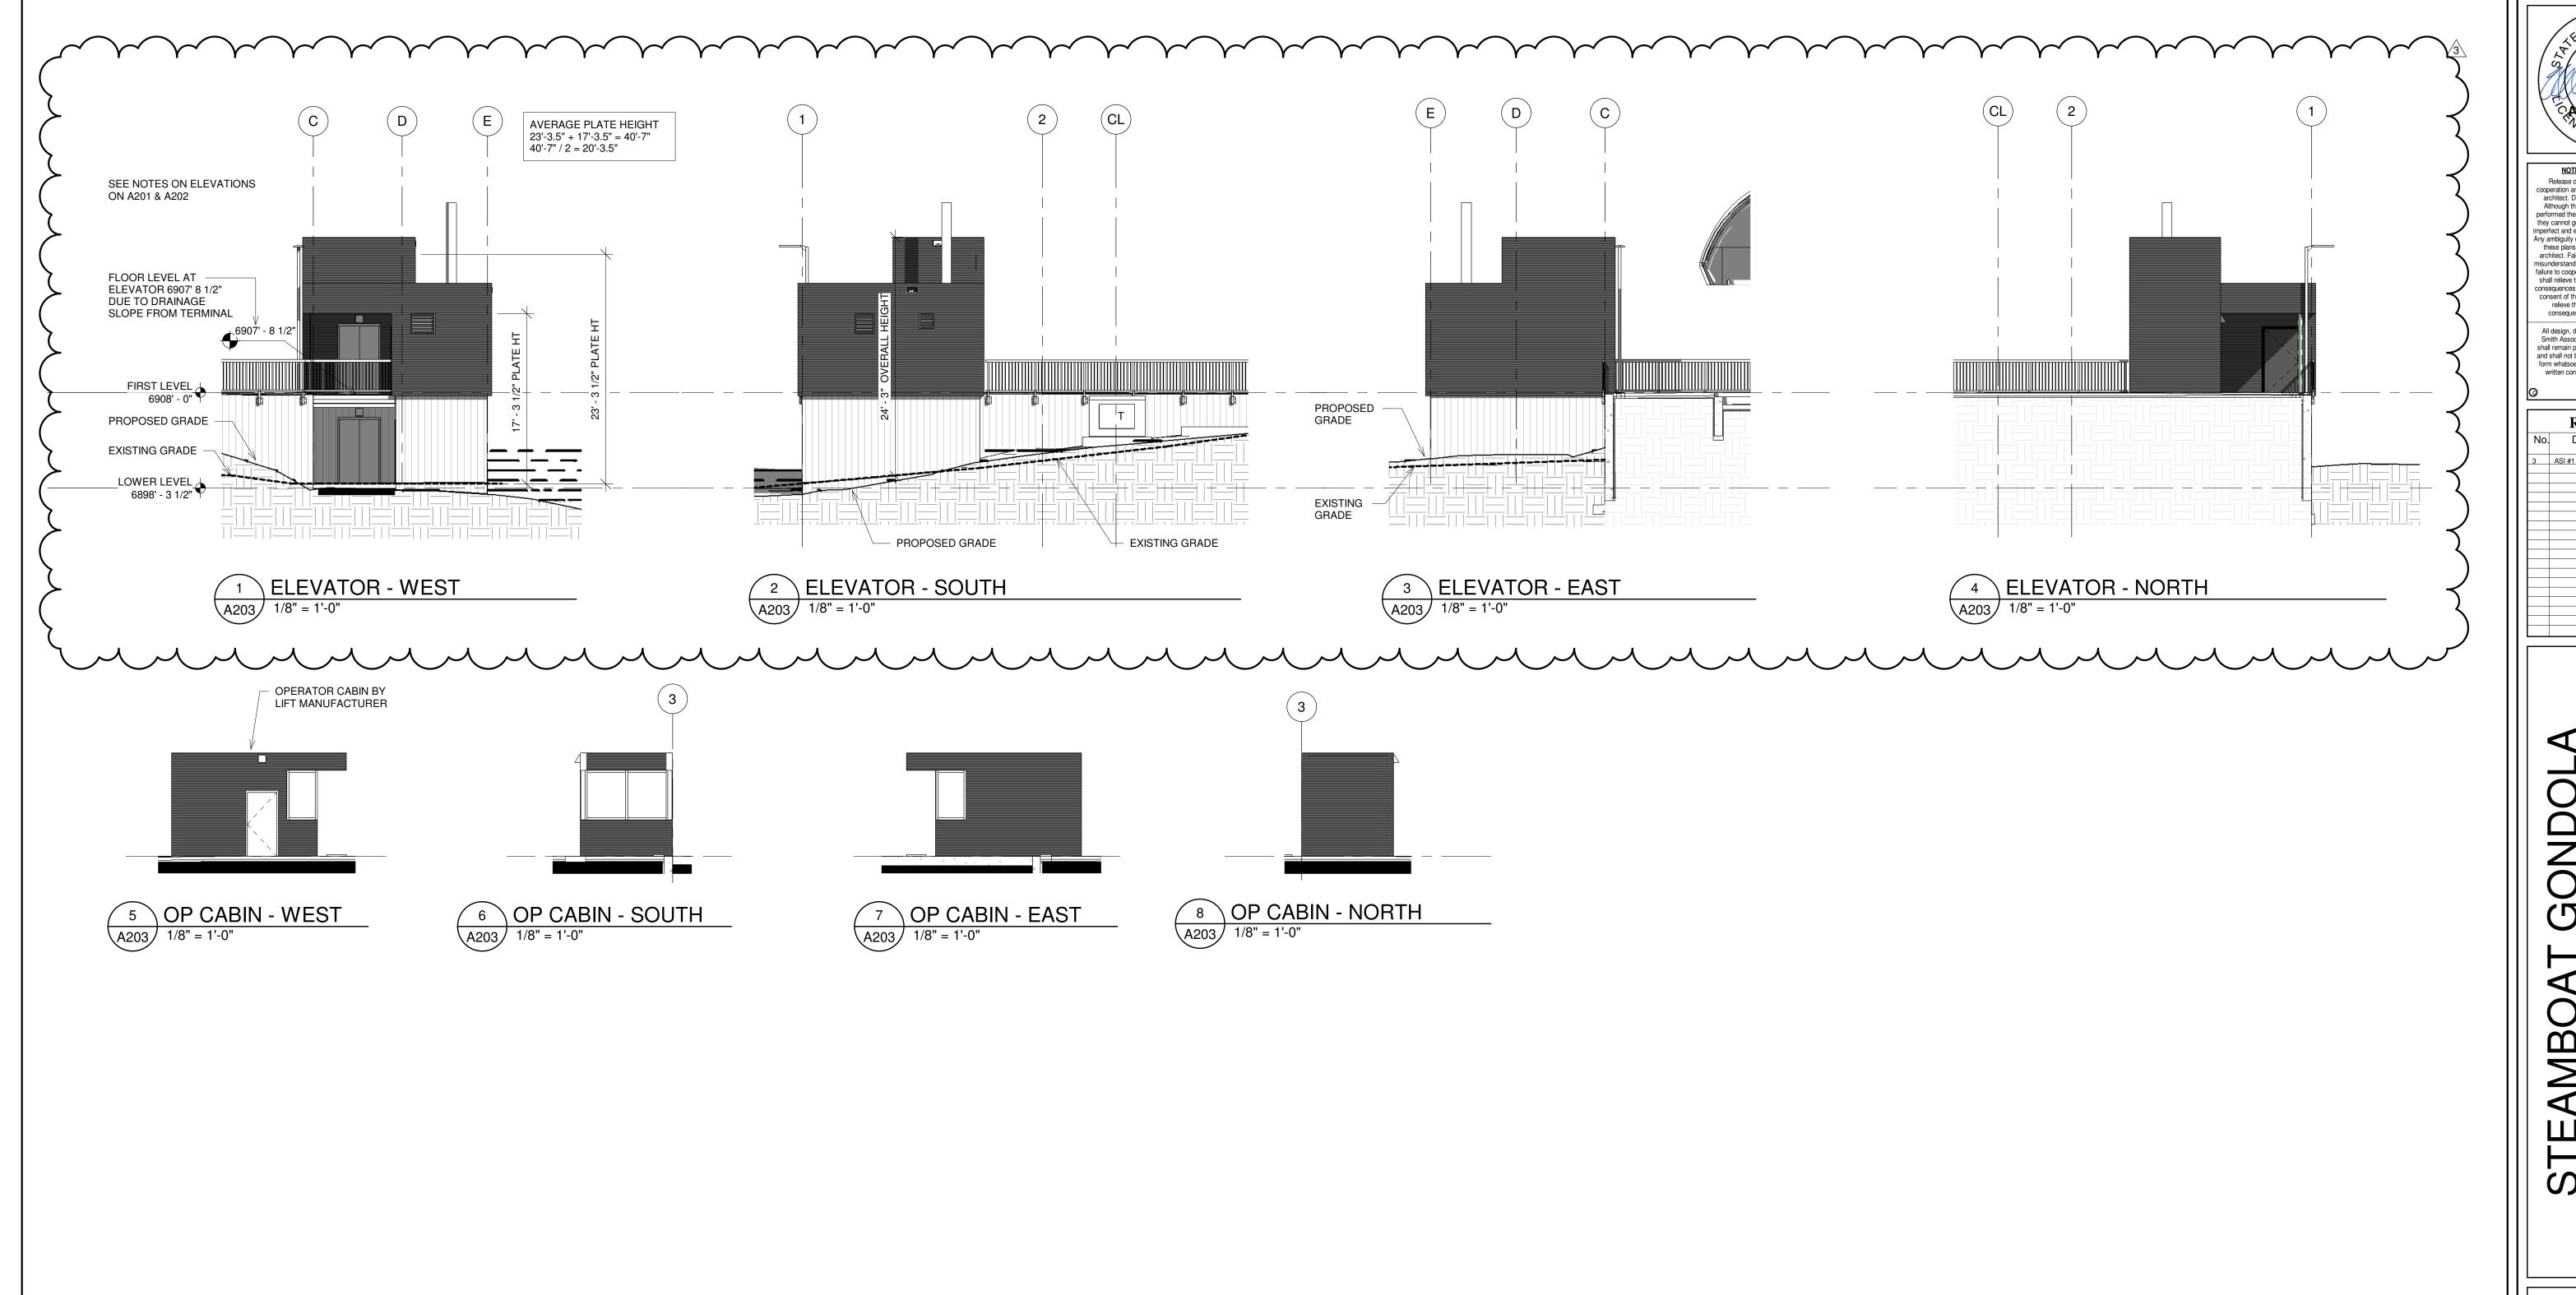
 
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Project Phase CONSTRUCTION DOCUMENTS

Sheet Title
EXTERIOR ELEVATIONS &

BLDG SECTIONS



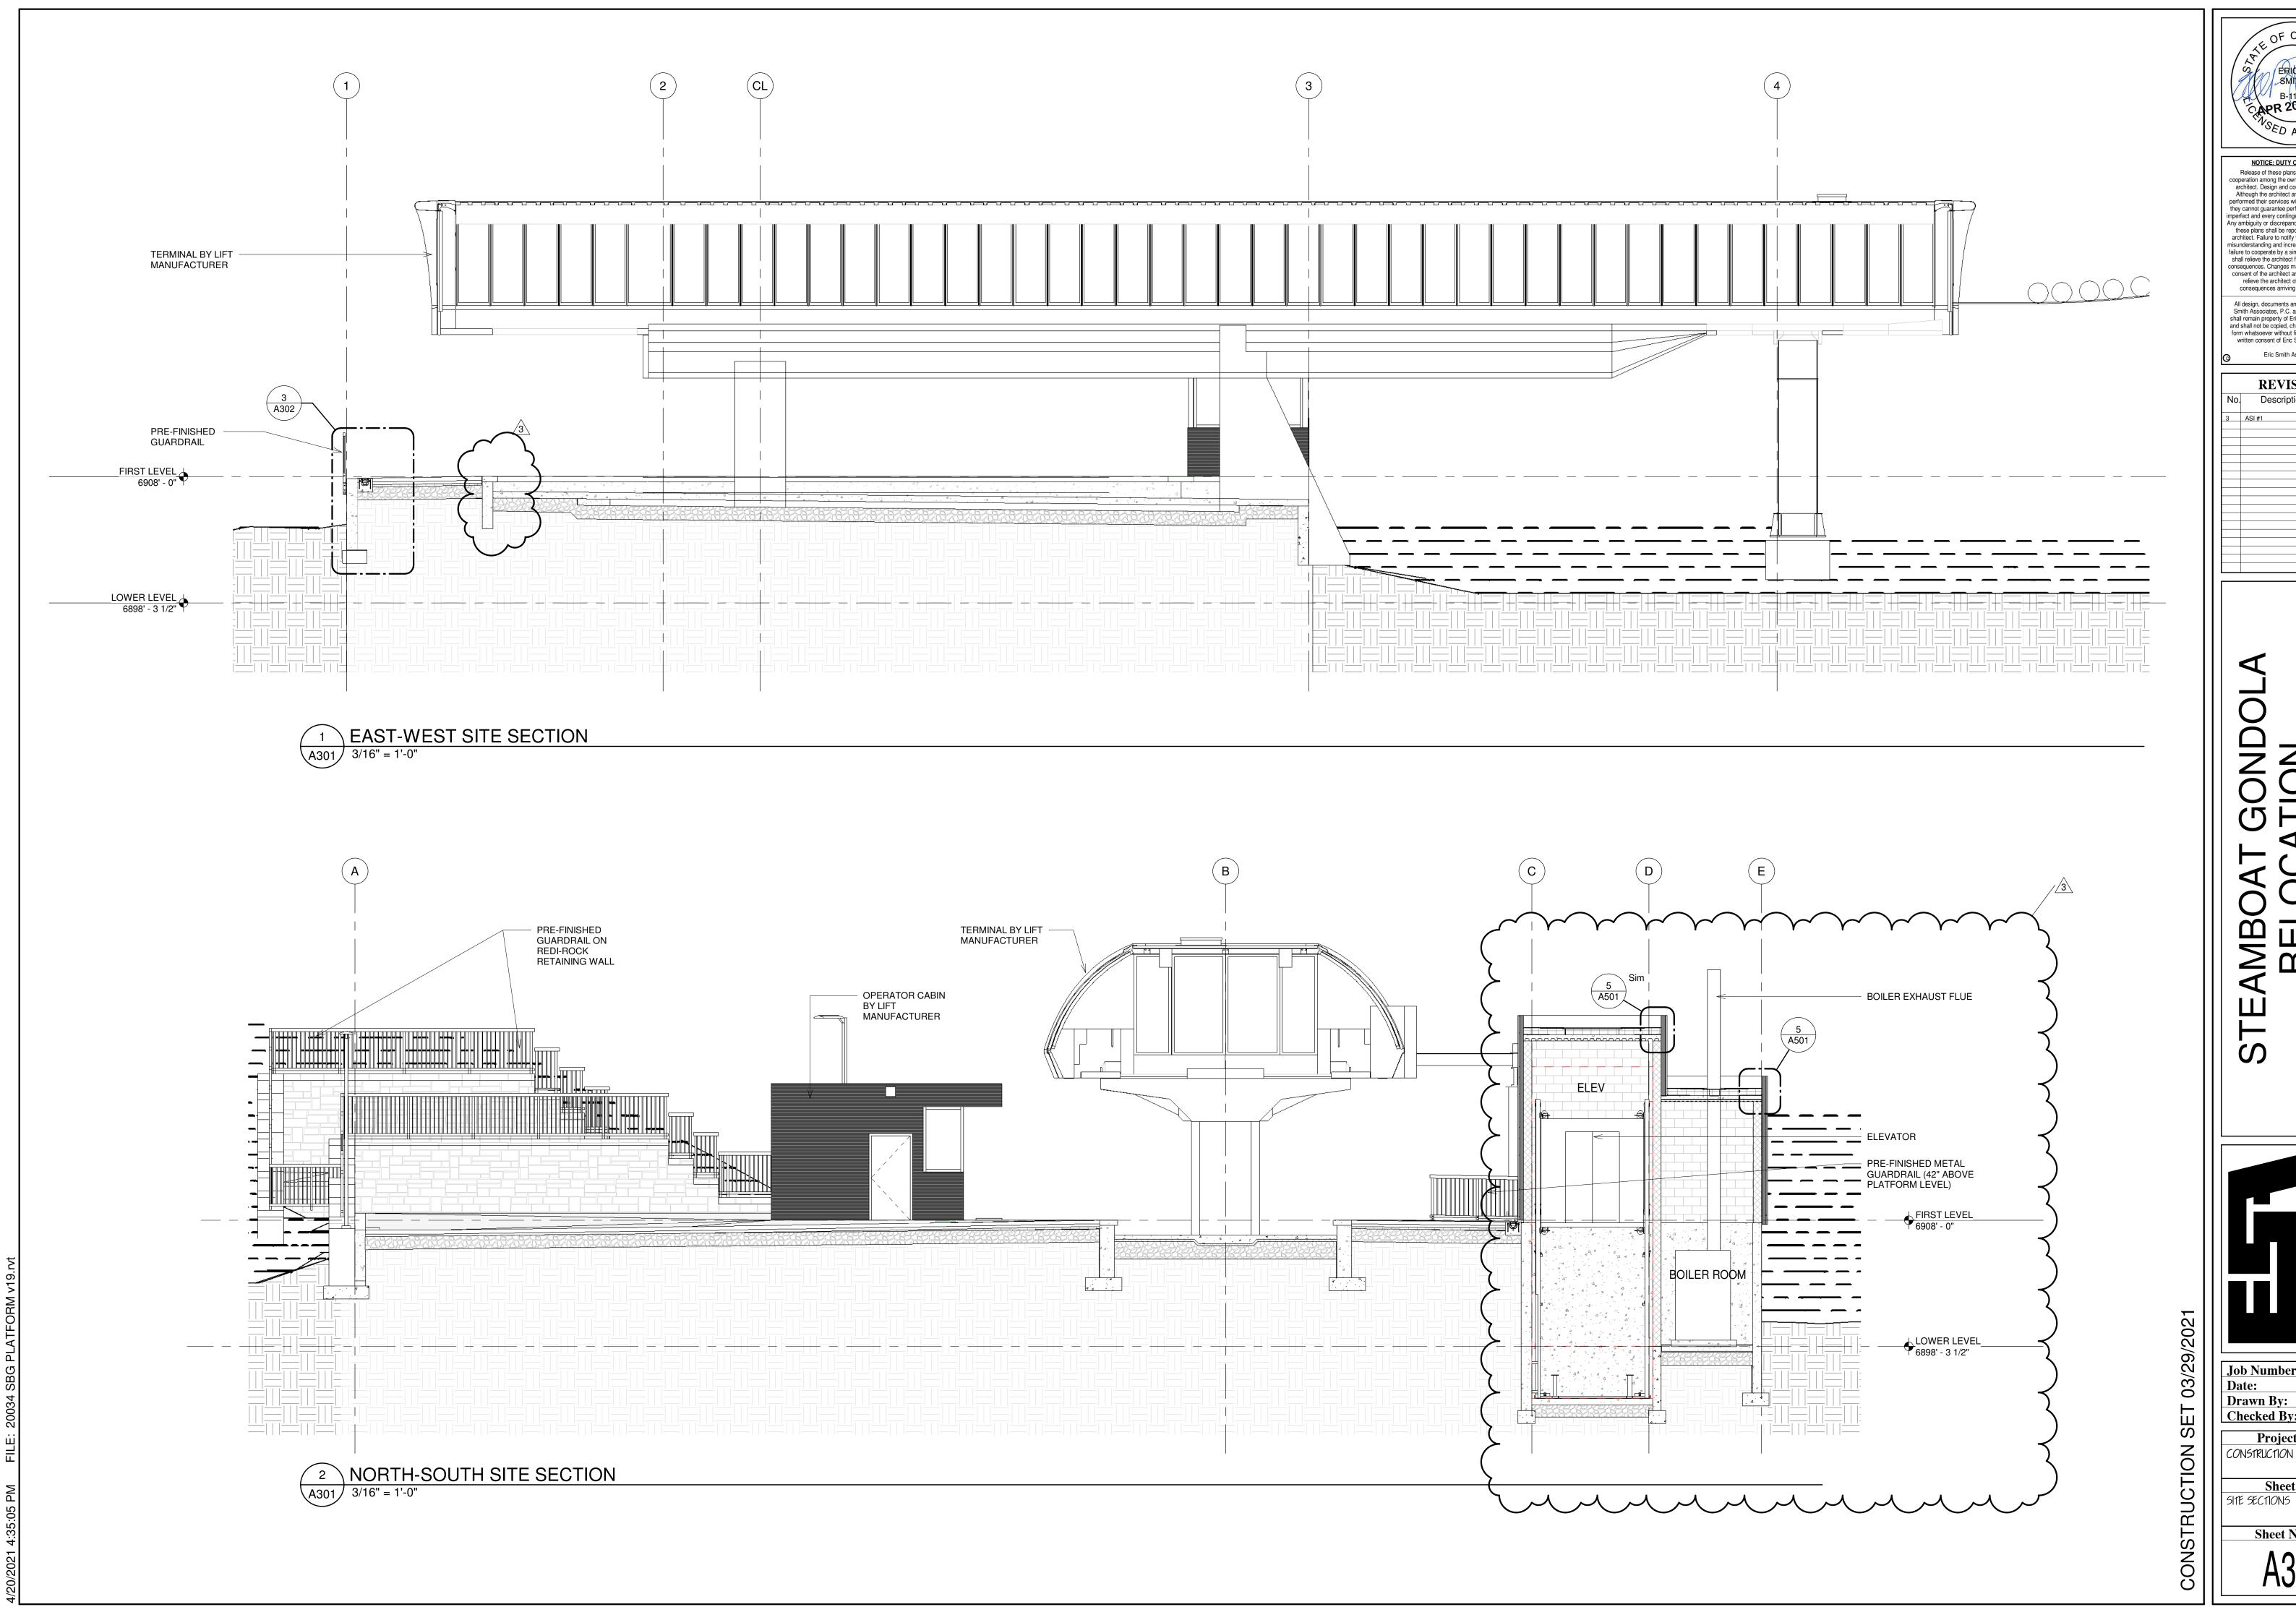

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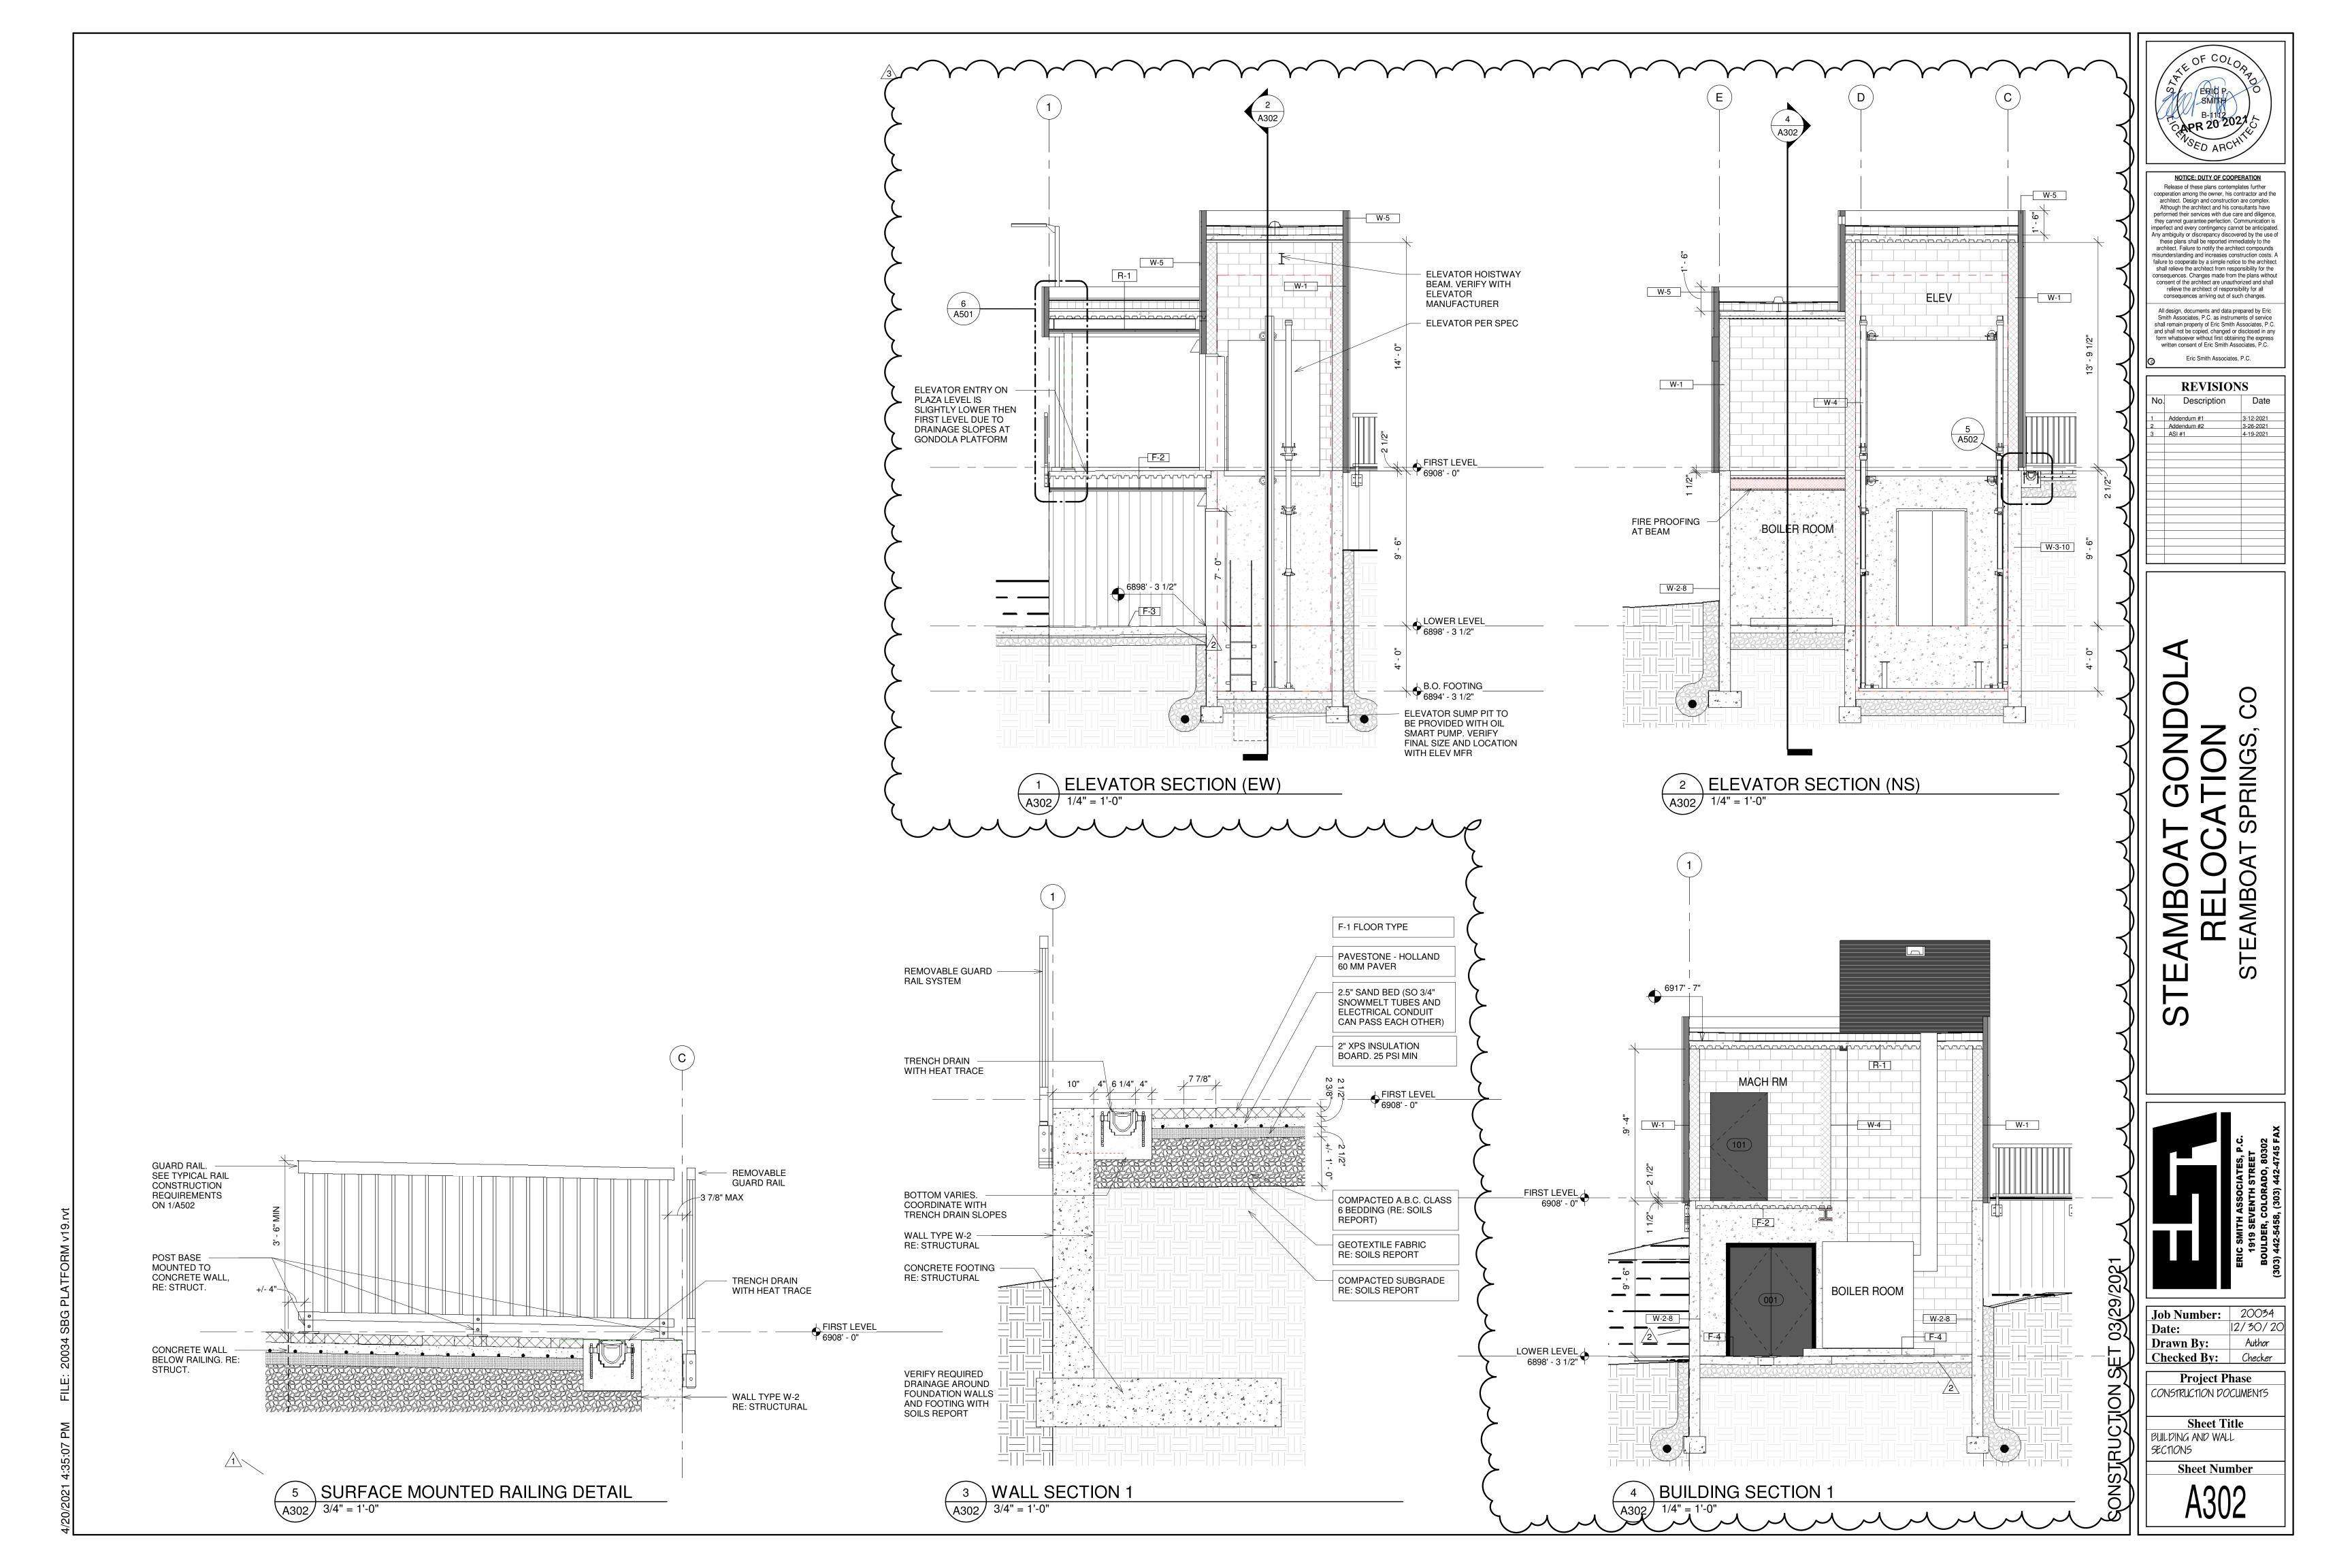
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Job Number: 20034 12/30/20 Author Drawn By: Checked By: Checker

**Project Phase** CONSTRUCTION DOCUMENTS

**Sheet Title** 

**Sheet Number** 



45 MIN

HG-2

PT

HM



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ELEV

HG-1 (001) Boiler Room (45 min)


R-1

<u>DOOR AND HARDWARE SCHEDULE NOTES:</u>
1. GENERAL CONTRACTOR TO COORDINATE THE NUMBER OF DOORS, SWING AND THE NUMBER OF ITEMS WITHIN EACH HARDWARE GROUP WITH EACH SPECIFIC DOOR AT TIME OF DOOR AND HARDWARE SUBMITTAL.

2. DOOR HARDWARE IS BASIS-OF-DESIGN PER SPECIFICATIONS. REVIEW HARDWARE WITH OWNER, INCLUDING FUTURE RFID REQUIREMENTS.

3. DOOR OPENING PRESSURE: THE OPENING DOOR FORCE REQUIRES TO BE 5 LBF MAX. ALTERNATIVELY, PROVIDE AN AUTOMATIC DOOR

OPENER WITH STANDBY POWER TO OPERATE DOOR. 2010 ADA (404.2.9)1. 4. COORDINATE ALL KEYING WITH OWNER. CORBIN RUSSWIN RU46.

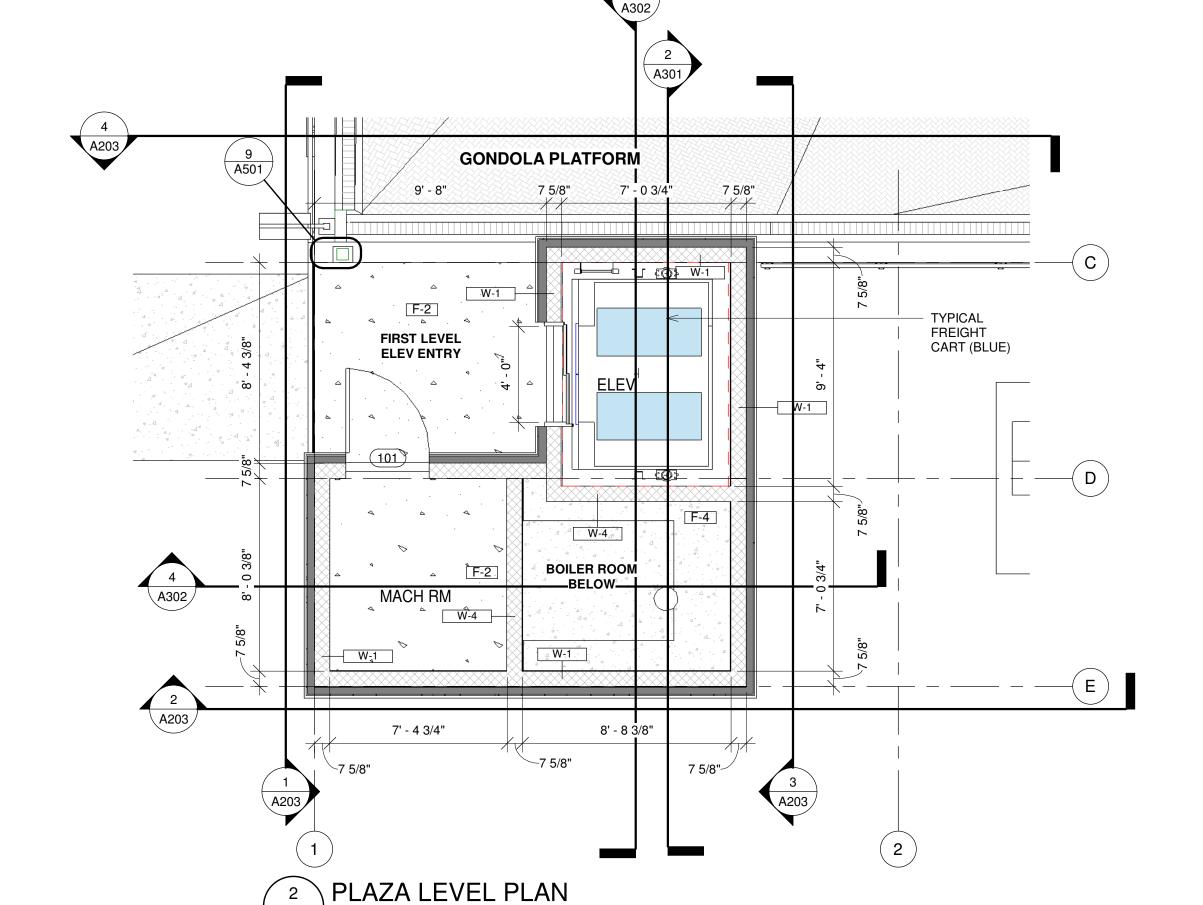


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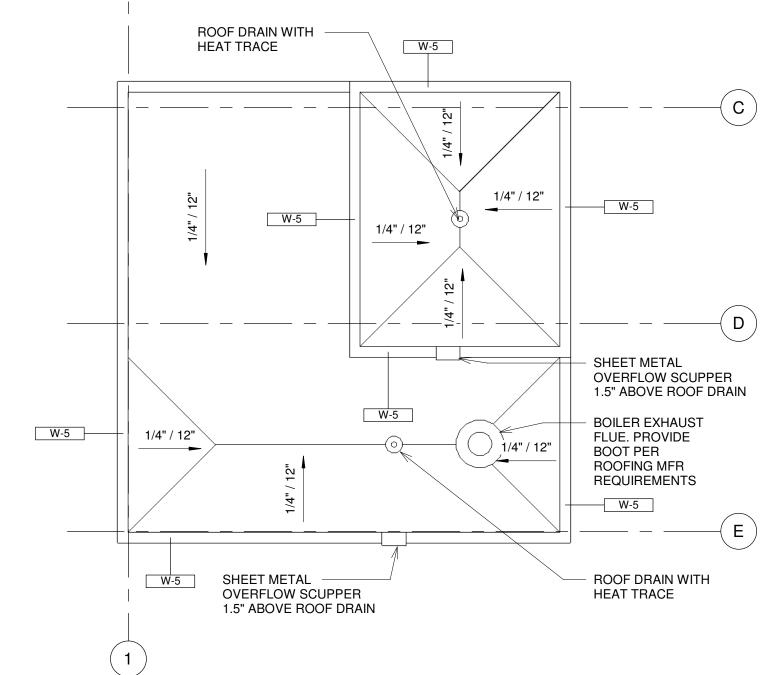
NO

5' - 0"

6' - 8"


A401 1/4" = 1'-0"



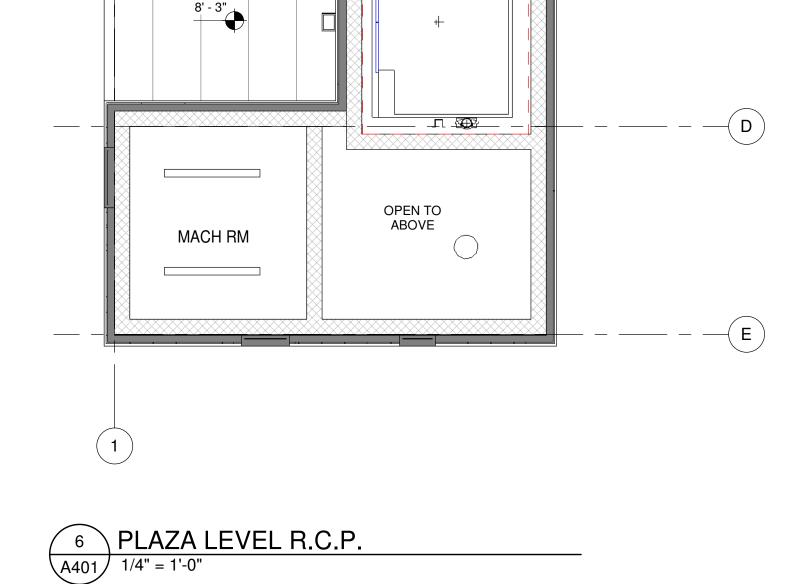

3 ROOF PLAN


A401 1/4" = 1'-0"

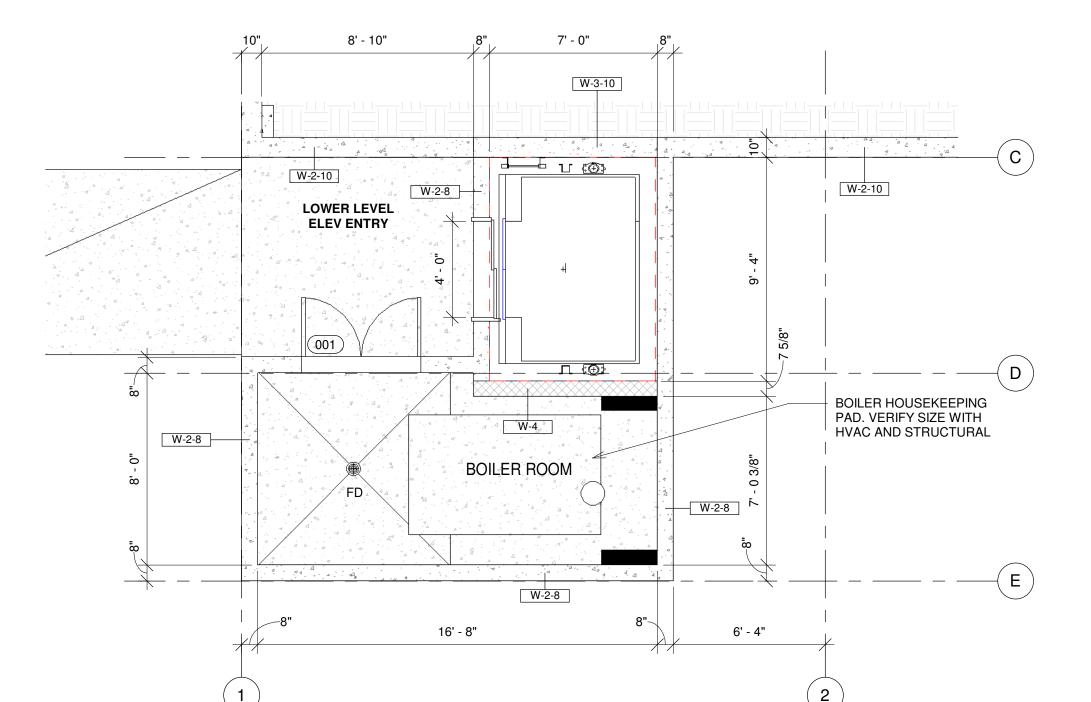

LOWER LEVEL PLAN

A401 1/4" = 1'-0"



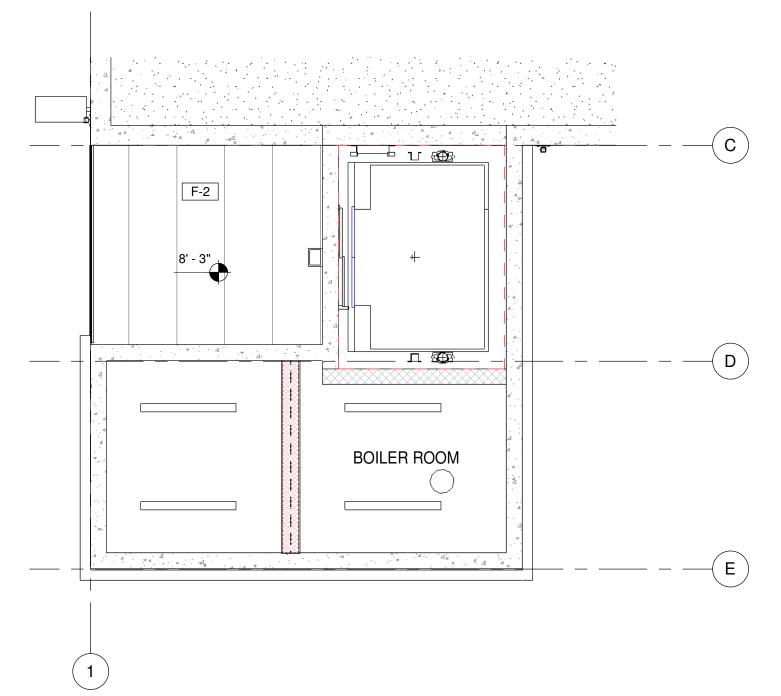

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ERIO P.

SAPR 20 2027

NOTICE: DUTY OF COOPERATION

Release of these plans contemplates further cooperation among the owner, his contractor and the

architect. Design and construction are complex.
Although the architect and his consultants have

performed their services with due care and diligence, they cannot guarantee perfection. Communication is imperfect and every contingency cannot be anticipated. Any ambiguity or discrepancy discovered by the use of these plans shall be reported immediately to the architect. Failure to notify the architect compounds

misunderstanding and increases construction costs. A failure to cooperate by a simple notice to the architect

shall relieve the architect from responsibility for the consequences. Changes made from the plans without consent of the architect are unauthorized and shall relieve the architect of responsibility for all consequences arriving out of such changes.

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Eric Smith Associates, P.C.

**REVISIONS** 

Date

4-19-2021


Description

Job Number: 20034 12/30/20 Drawn By: Checked By: Checker

**Project Phase** CONSTRUCTION DOCUMENTS

**Sheet Title** 

FLOOR AND CEILING PLANS

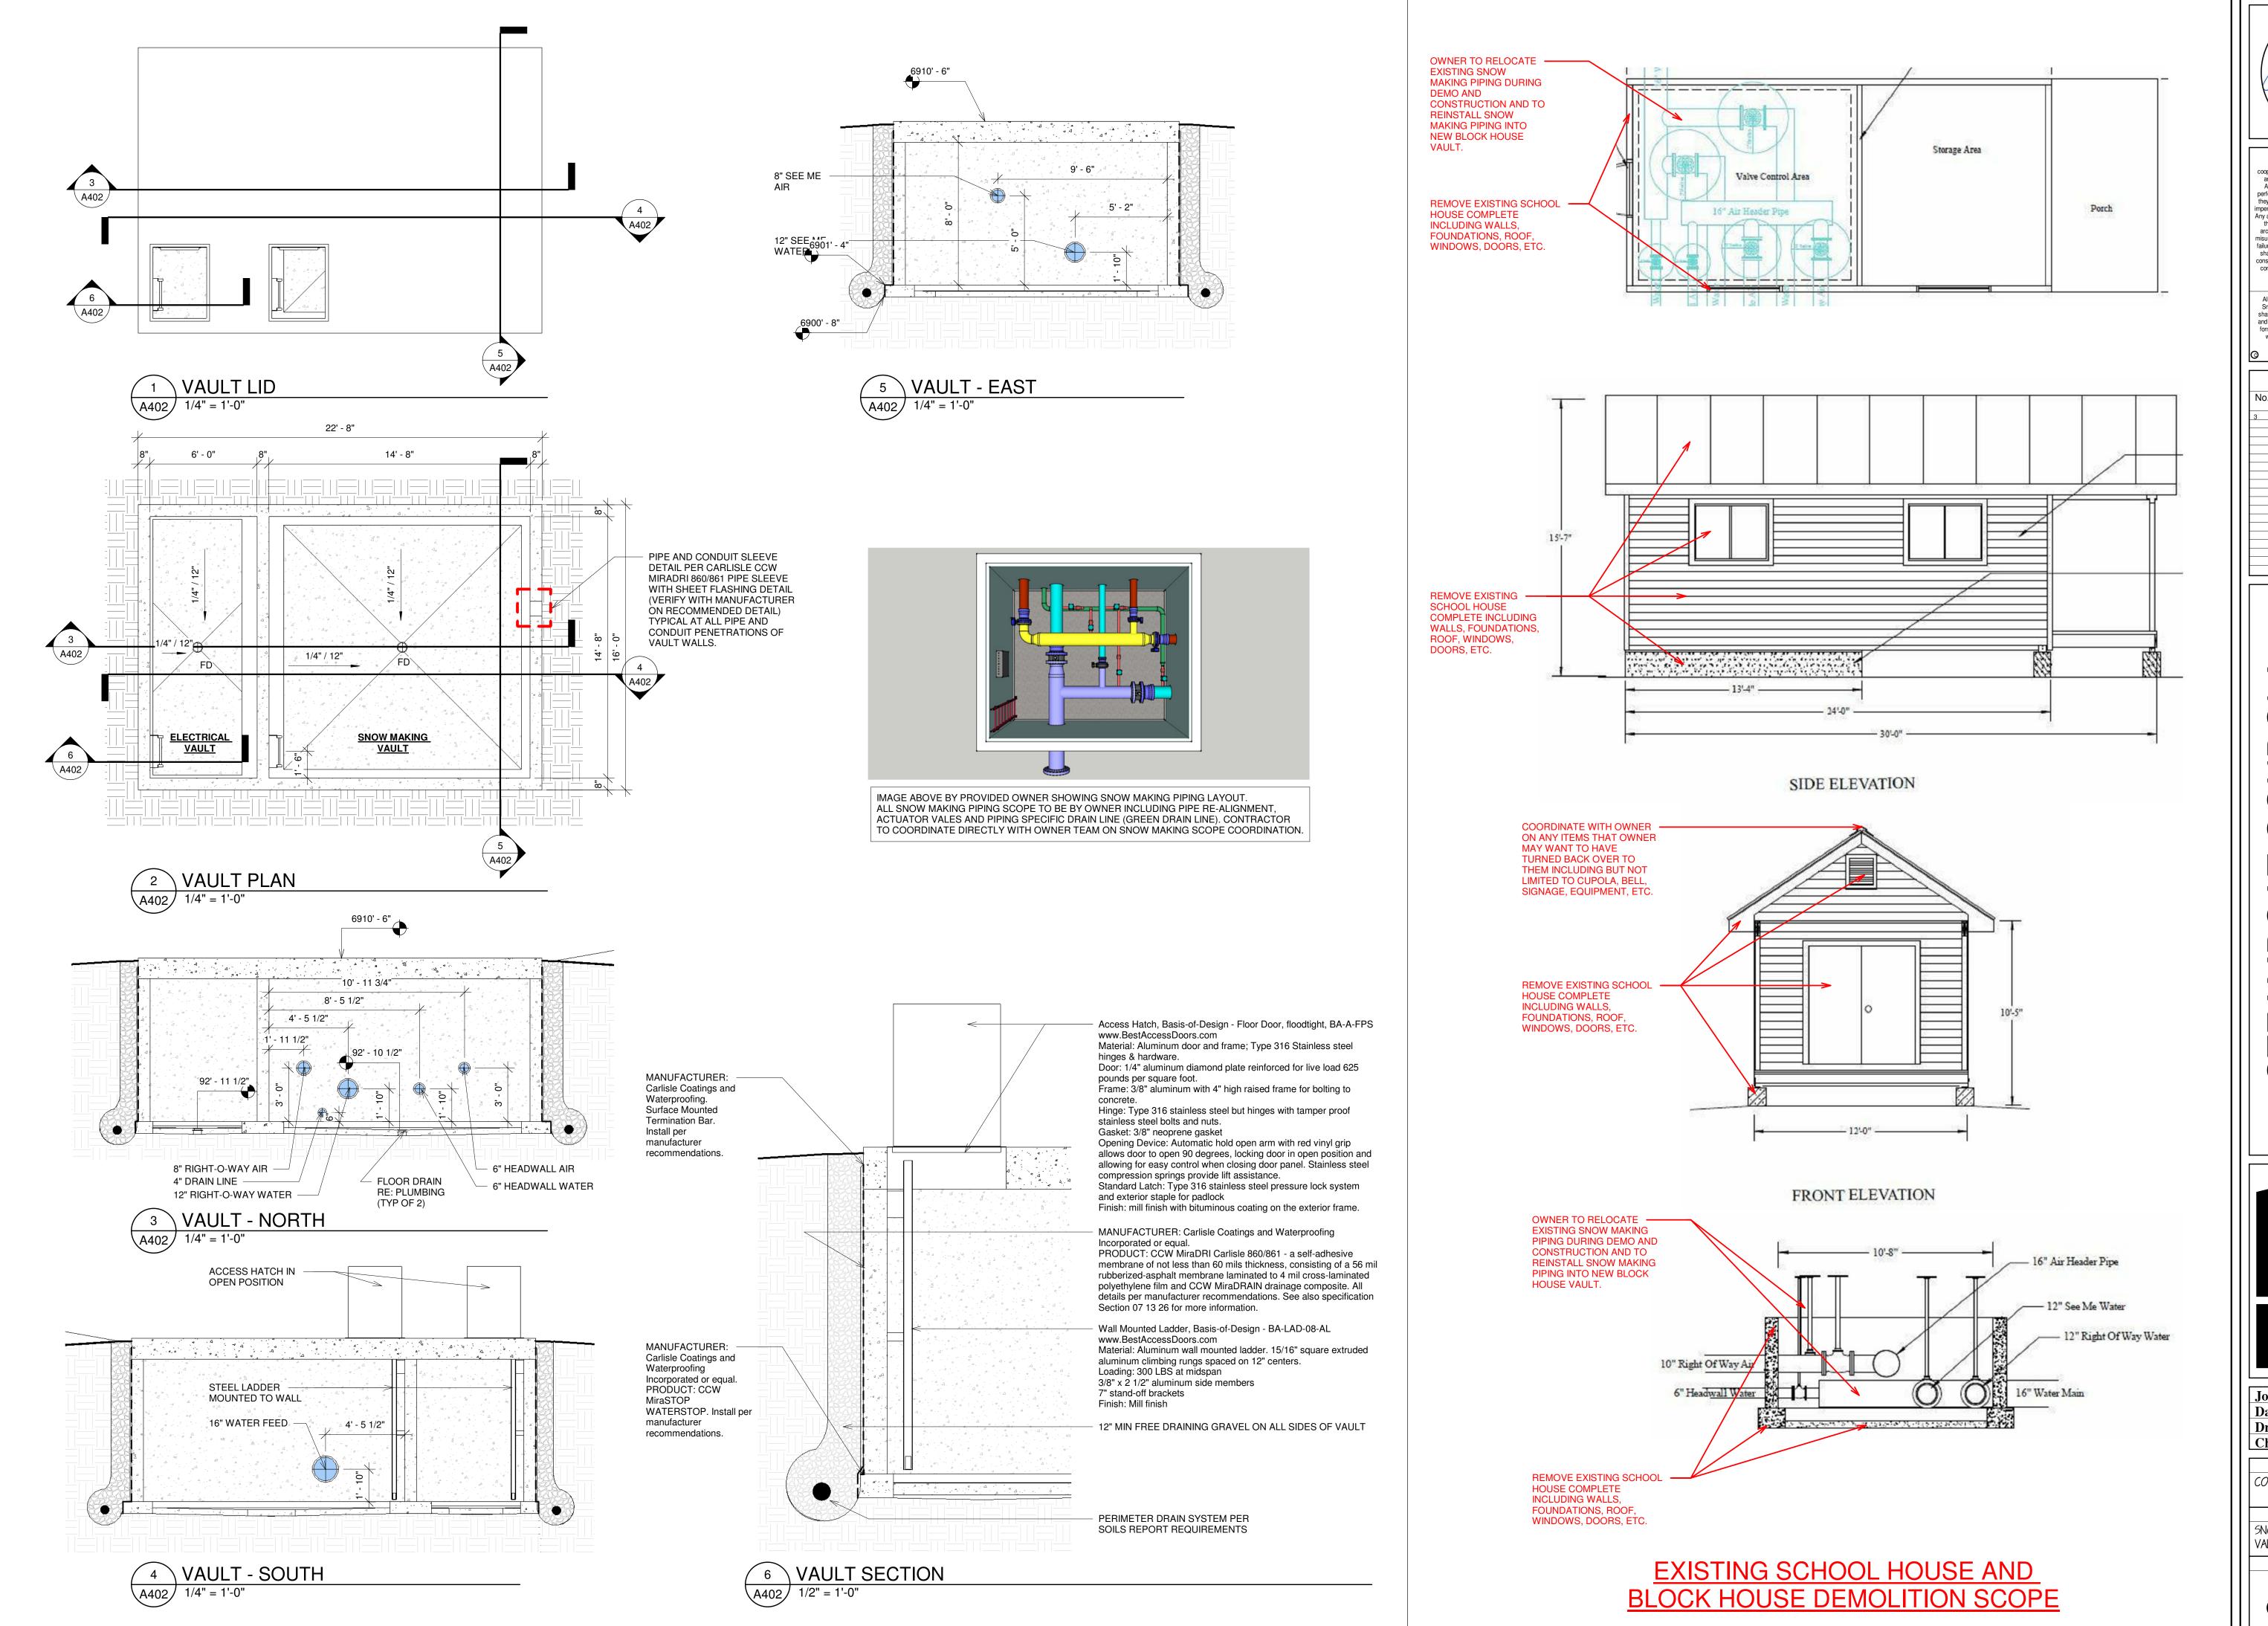



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Eric Smith Associates, P.C. REVISIONS

Date Description 4-19-2021

ST



Job Number: 20034 Author

12/30/20 Date: Drawn By: Checked By: Checker

**Project Phase** CONSTRUCTION DOCUMENTS

**Sheet Title** SNOW MAKING & ELECTRICAL