




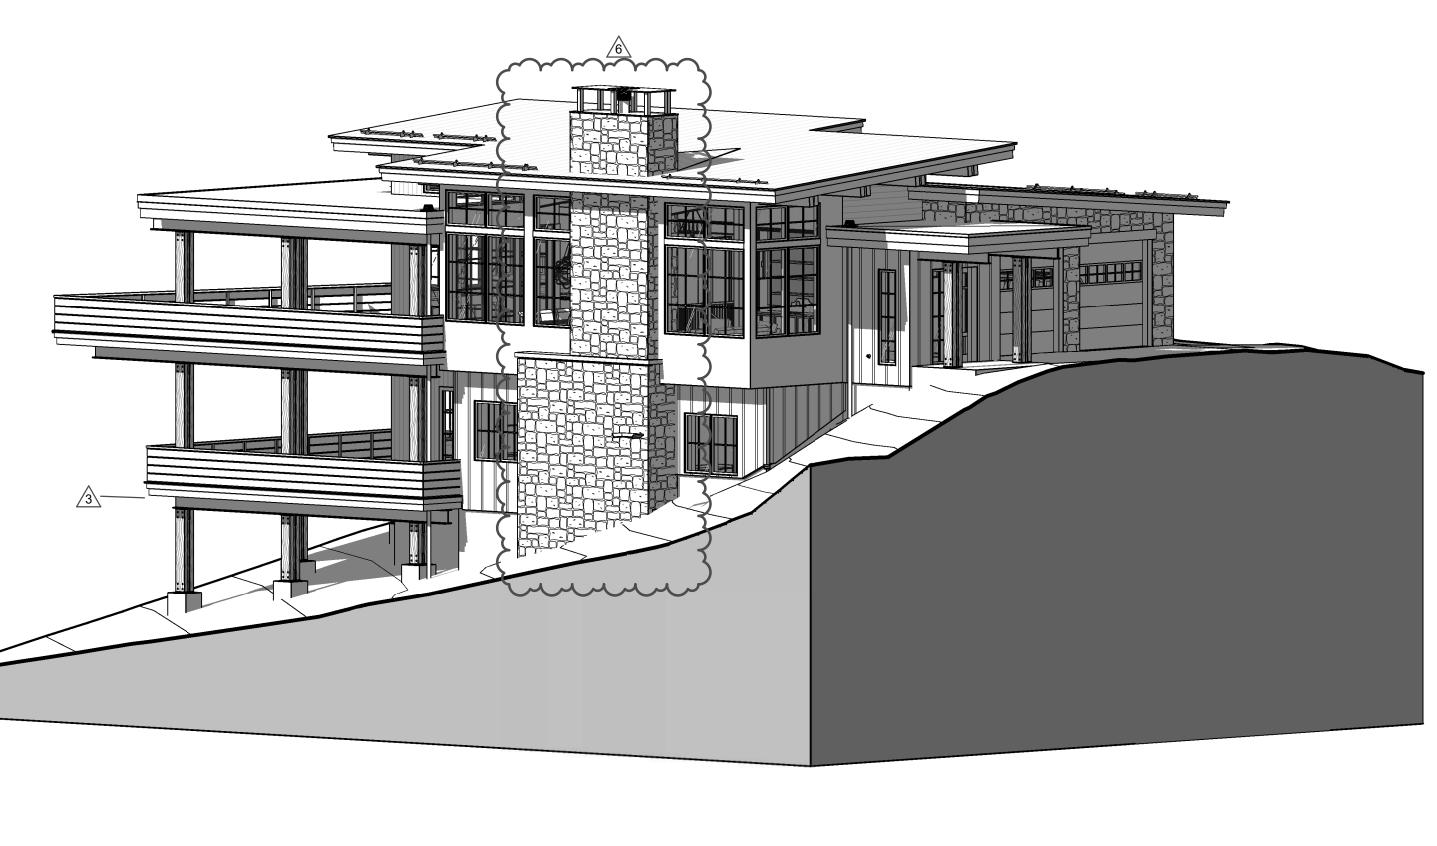

2 PERSPECTIVE #2

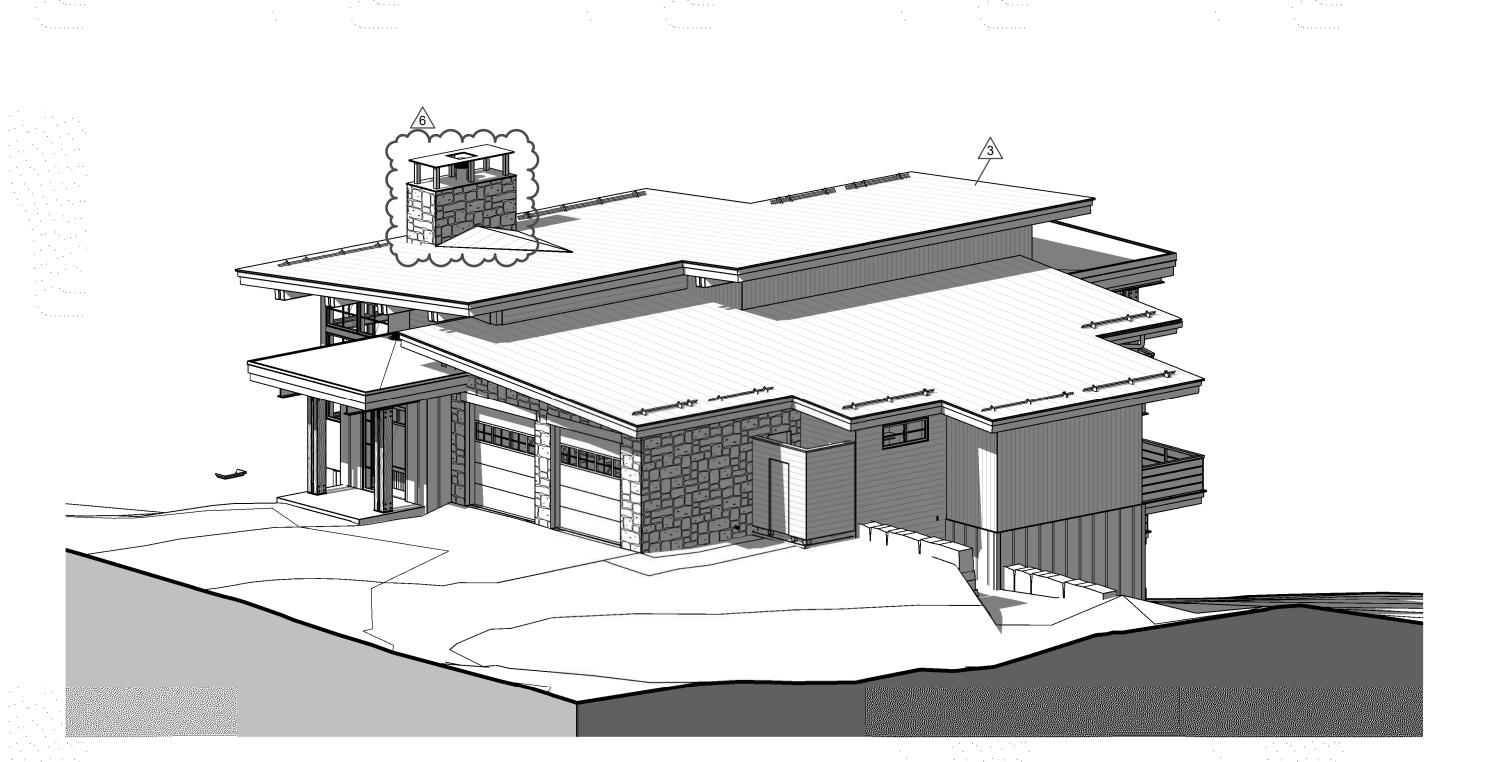

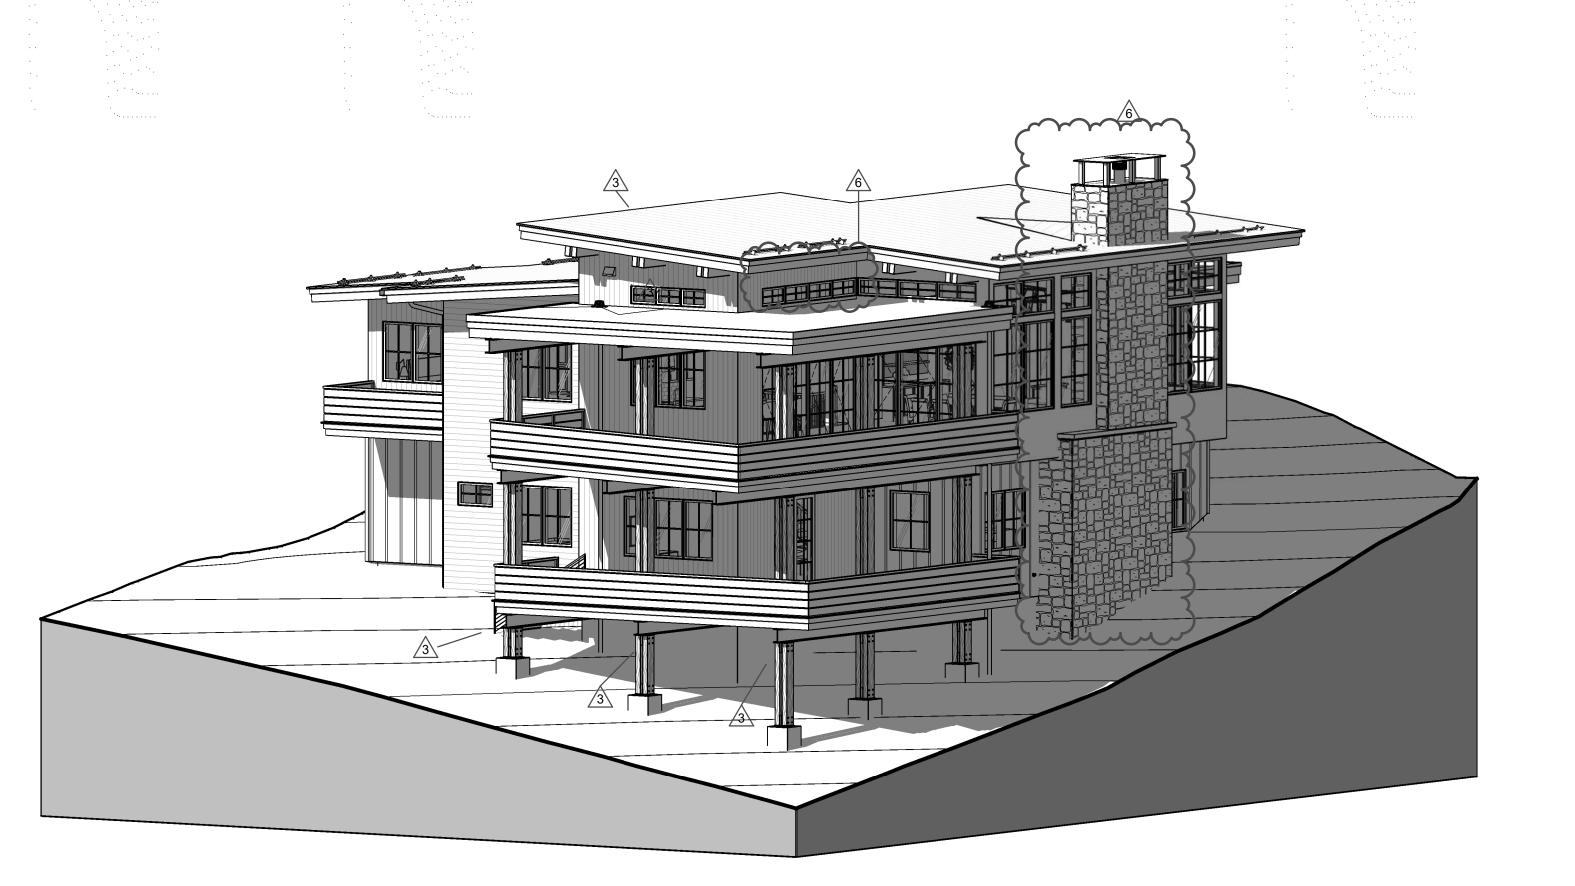



DRAWING TITLE PERSPECTIVES

A3.1

ARCHITECTURE

**PLANNING** 

LANDSCAPE

INTERIORS


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SARAH TIEDEKEN

(3) PERSPECTIVE #3

1) PERSPECTIVE #1



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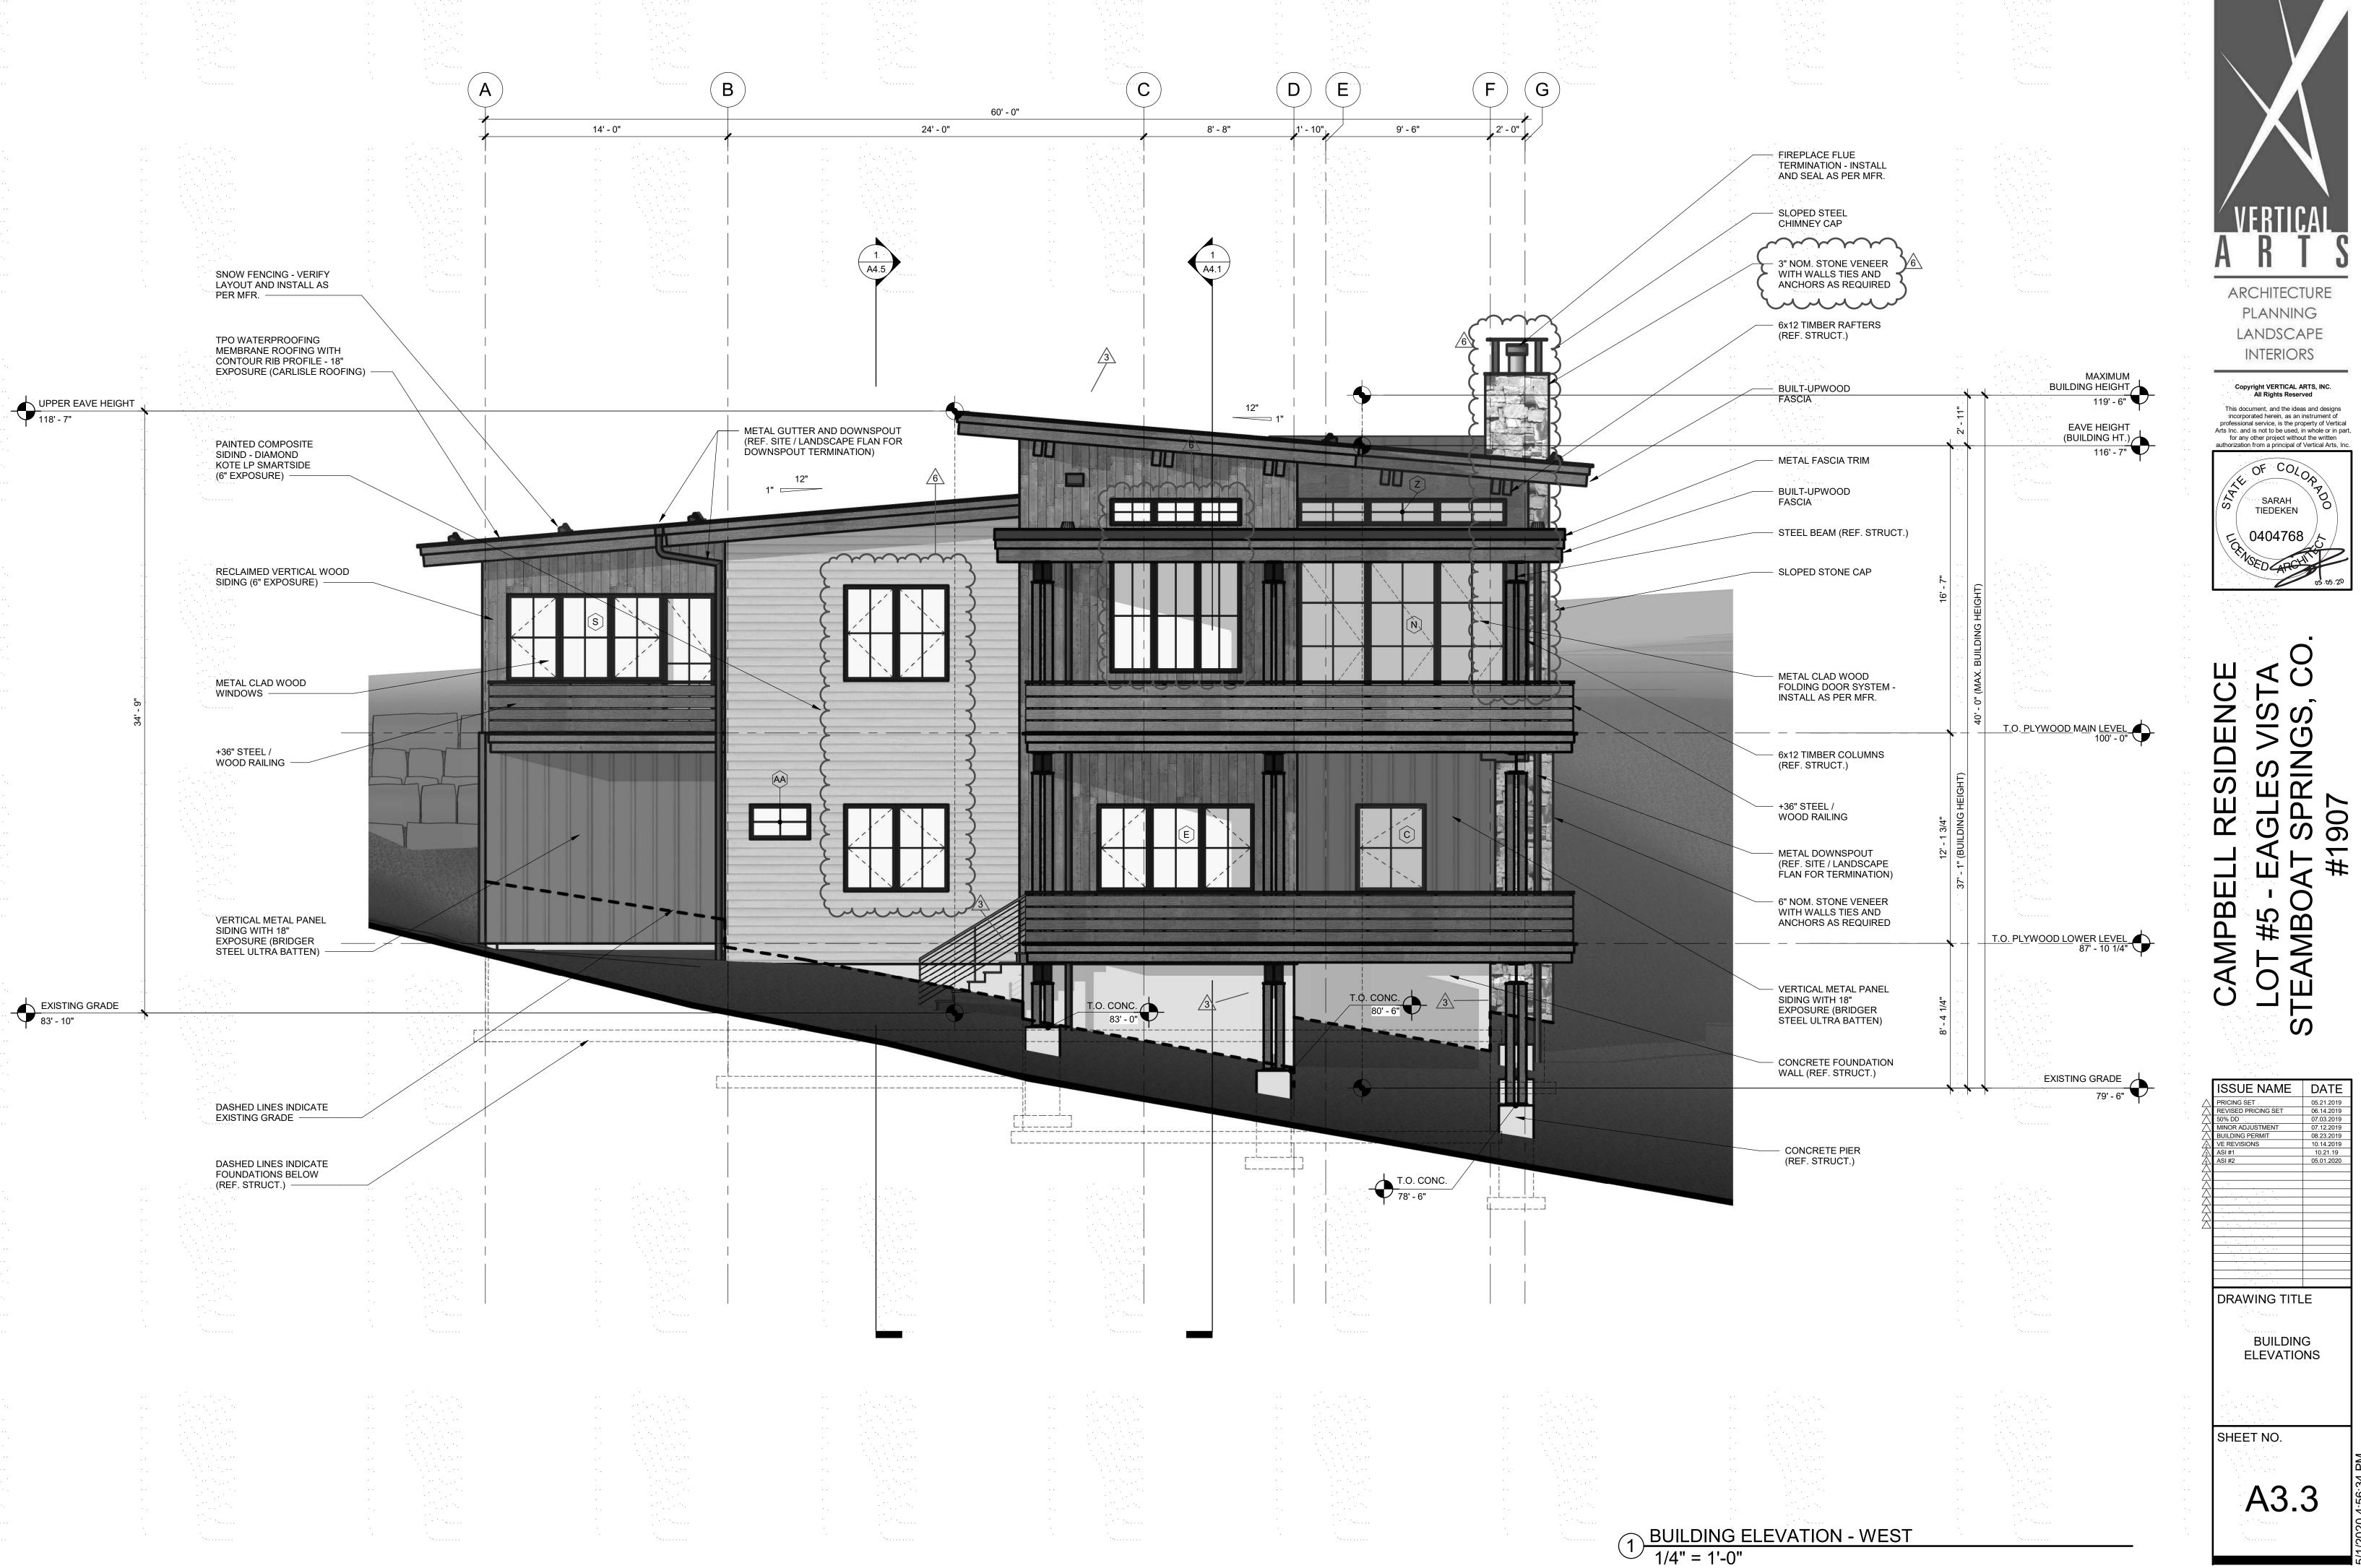
SARAH TIEDEKEN

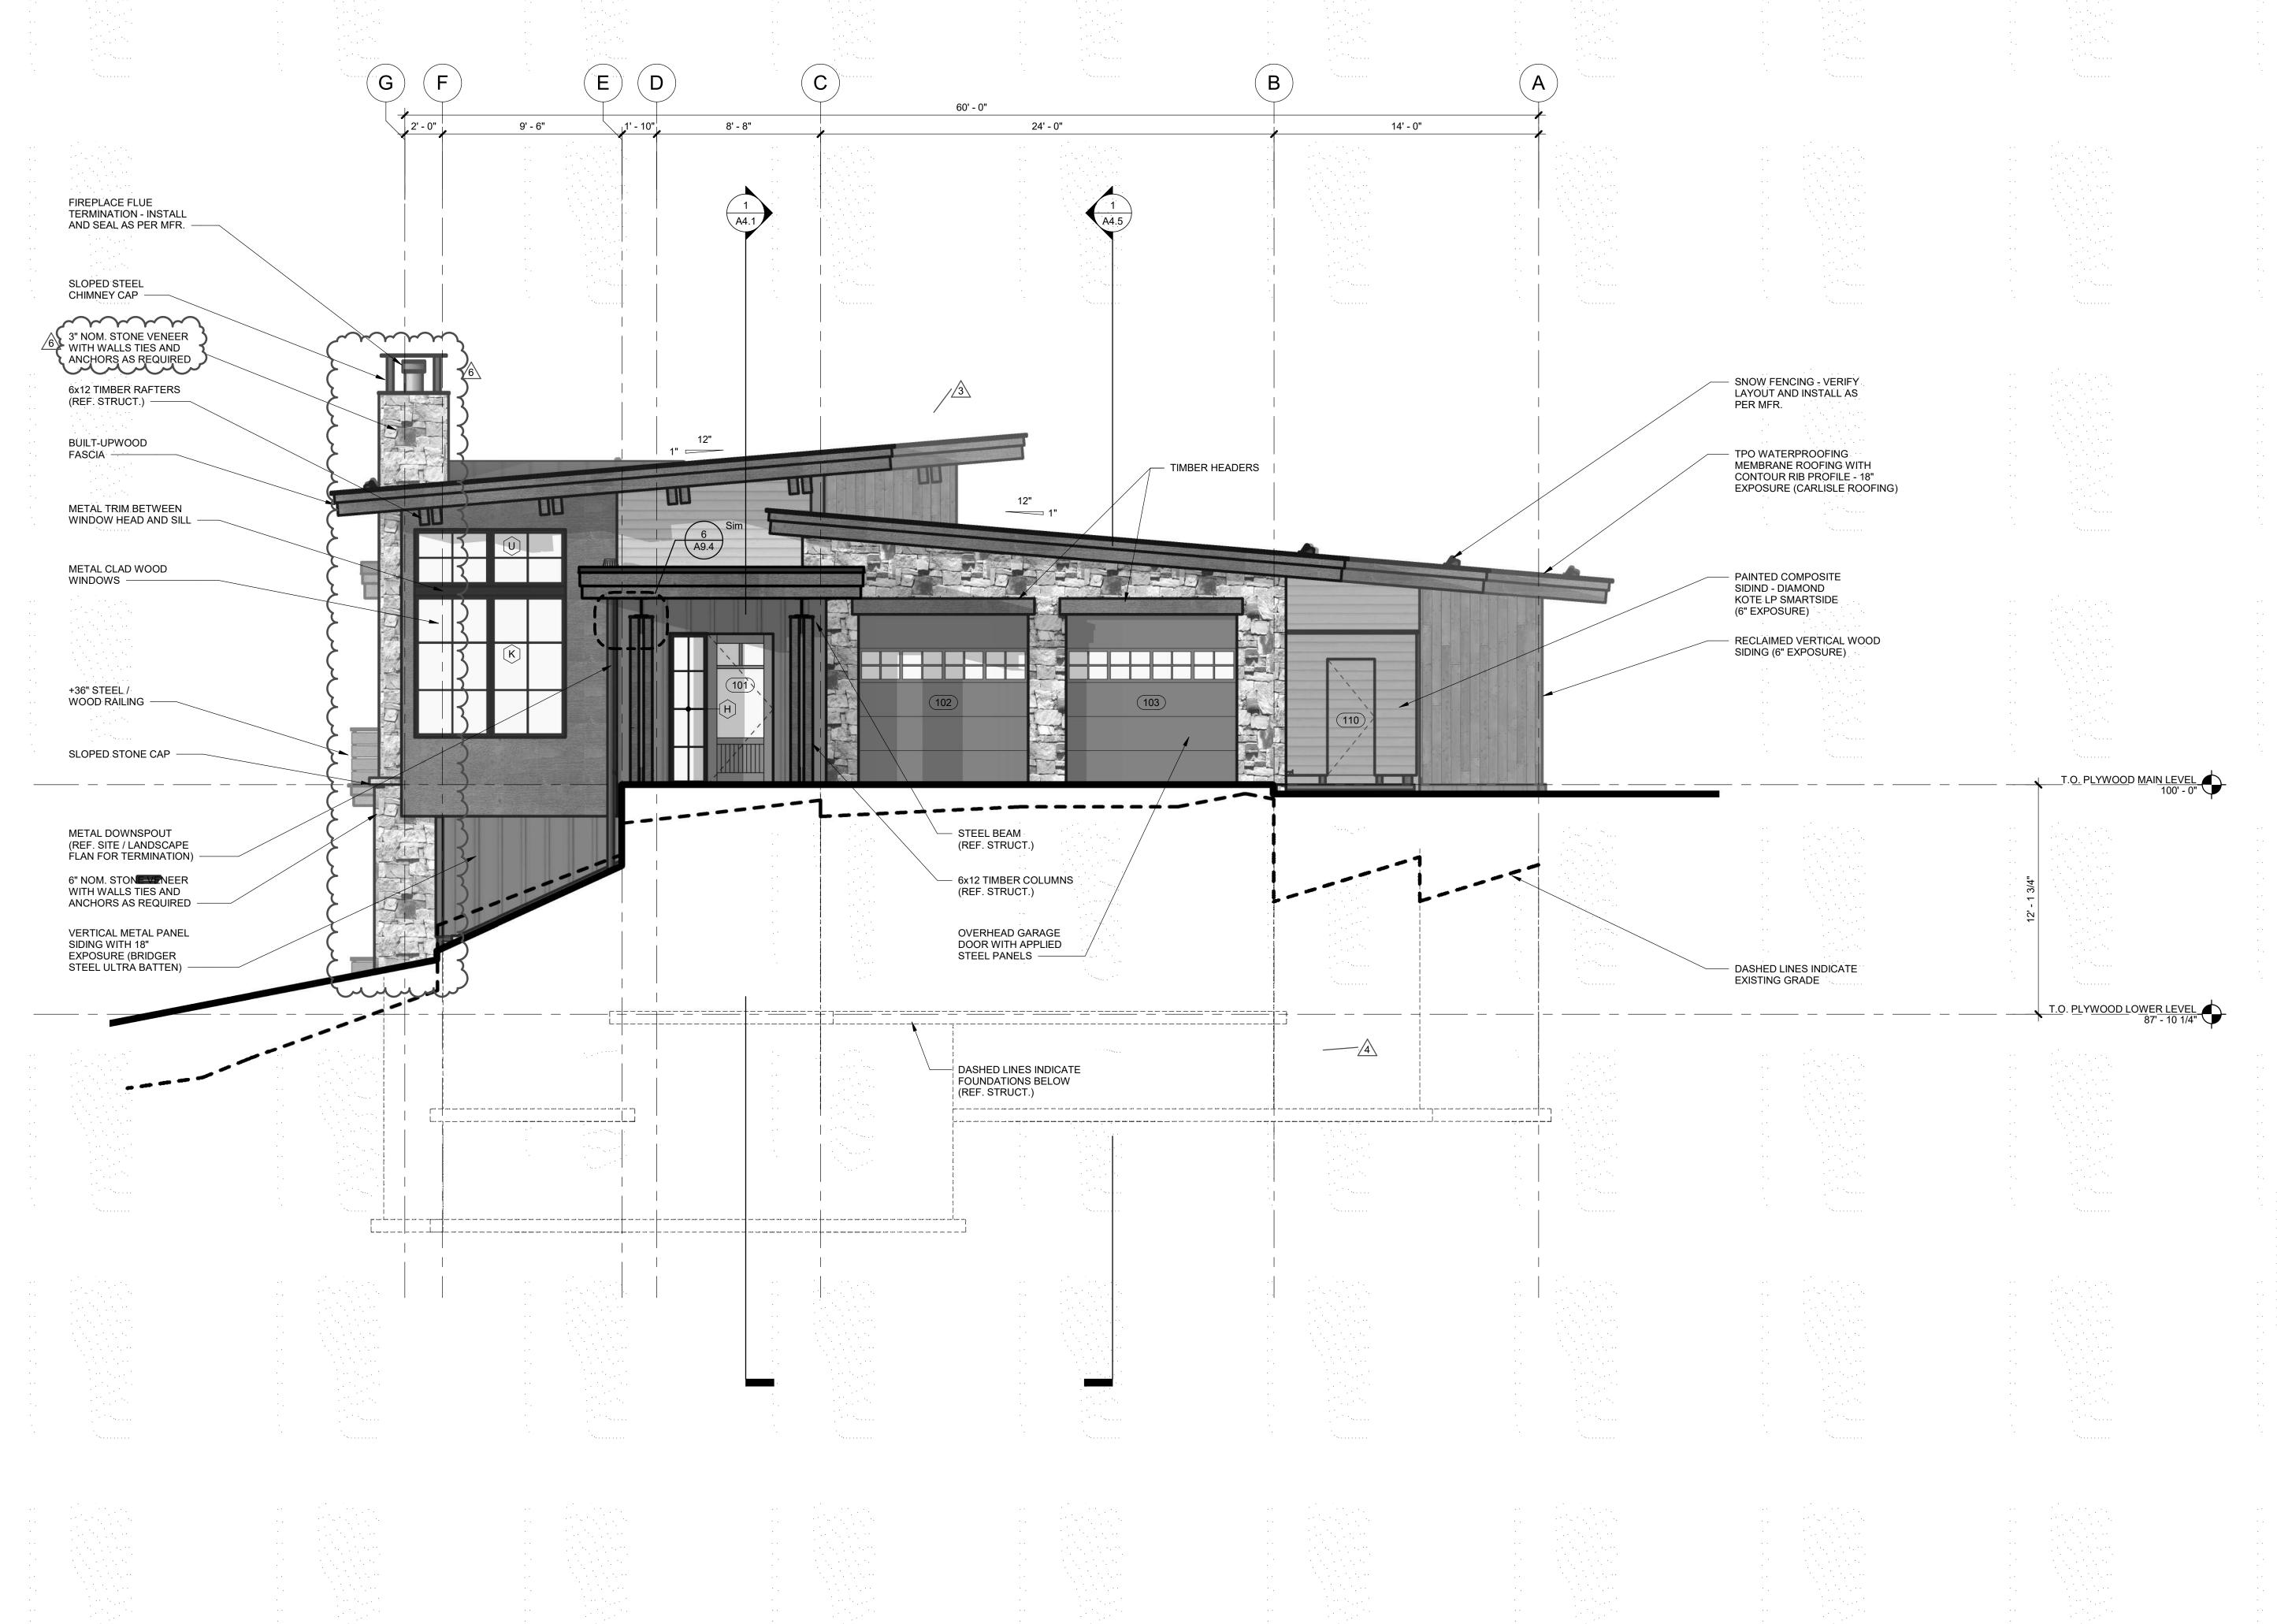**AMPBELI** LOT #5 -

ISSUE NAME DATE 50% DD MINOR ADJUSTMENT VE REVISIONS DRAWING TITLE BUILDING **ELEVATIONS** 

SHEET NO.

1) BUILDING ELEVATION - EAST



LOT #5 -

**PLANNING** 

LANDSCAPE

INTERIORS

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TIEDEKEN


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AMPBELL ISSUE NAME DATE 50% DD MINOR ADJUSTMENT

DRAWING TITLE BUILDING **ELEVATIONS** 

A3.3

SHEET NO.



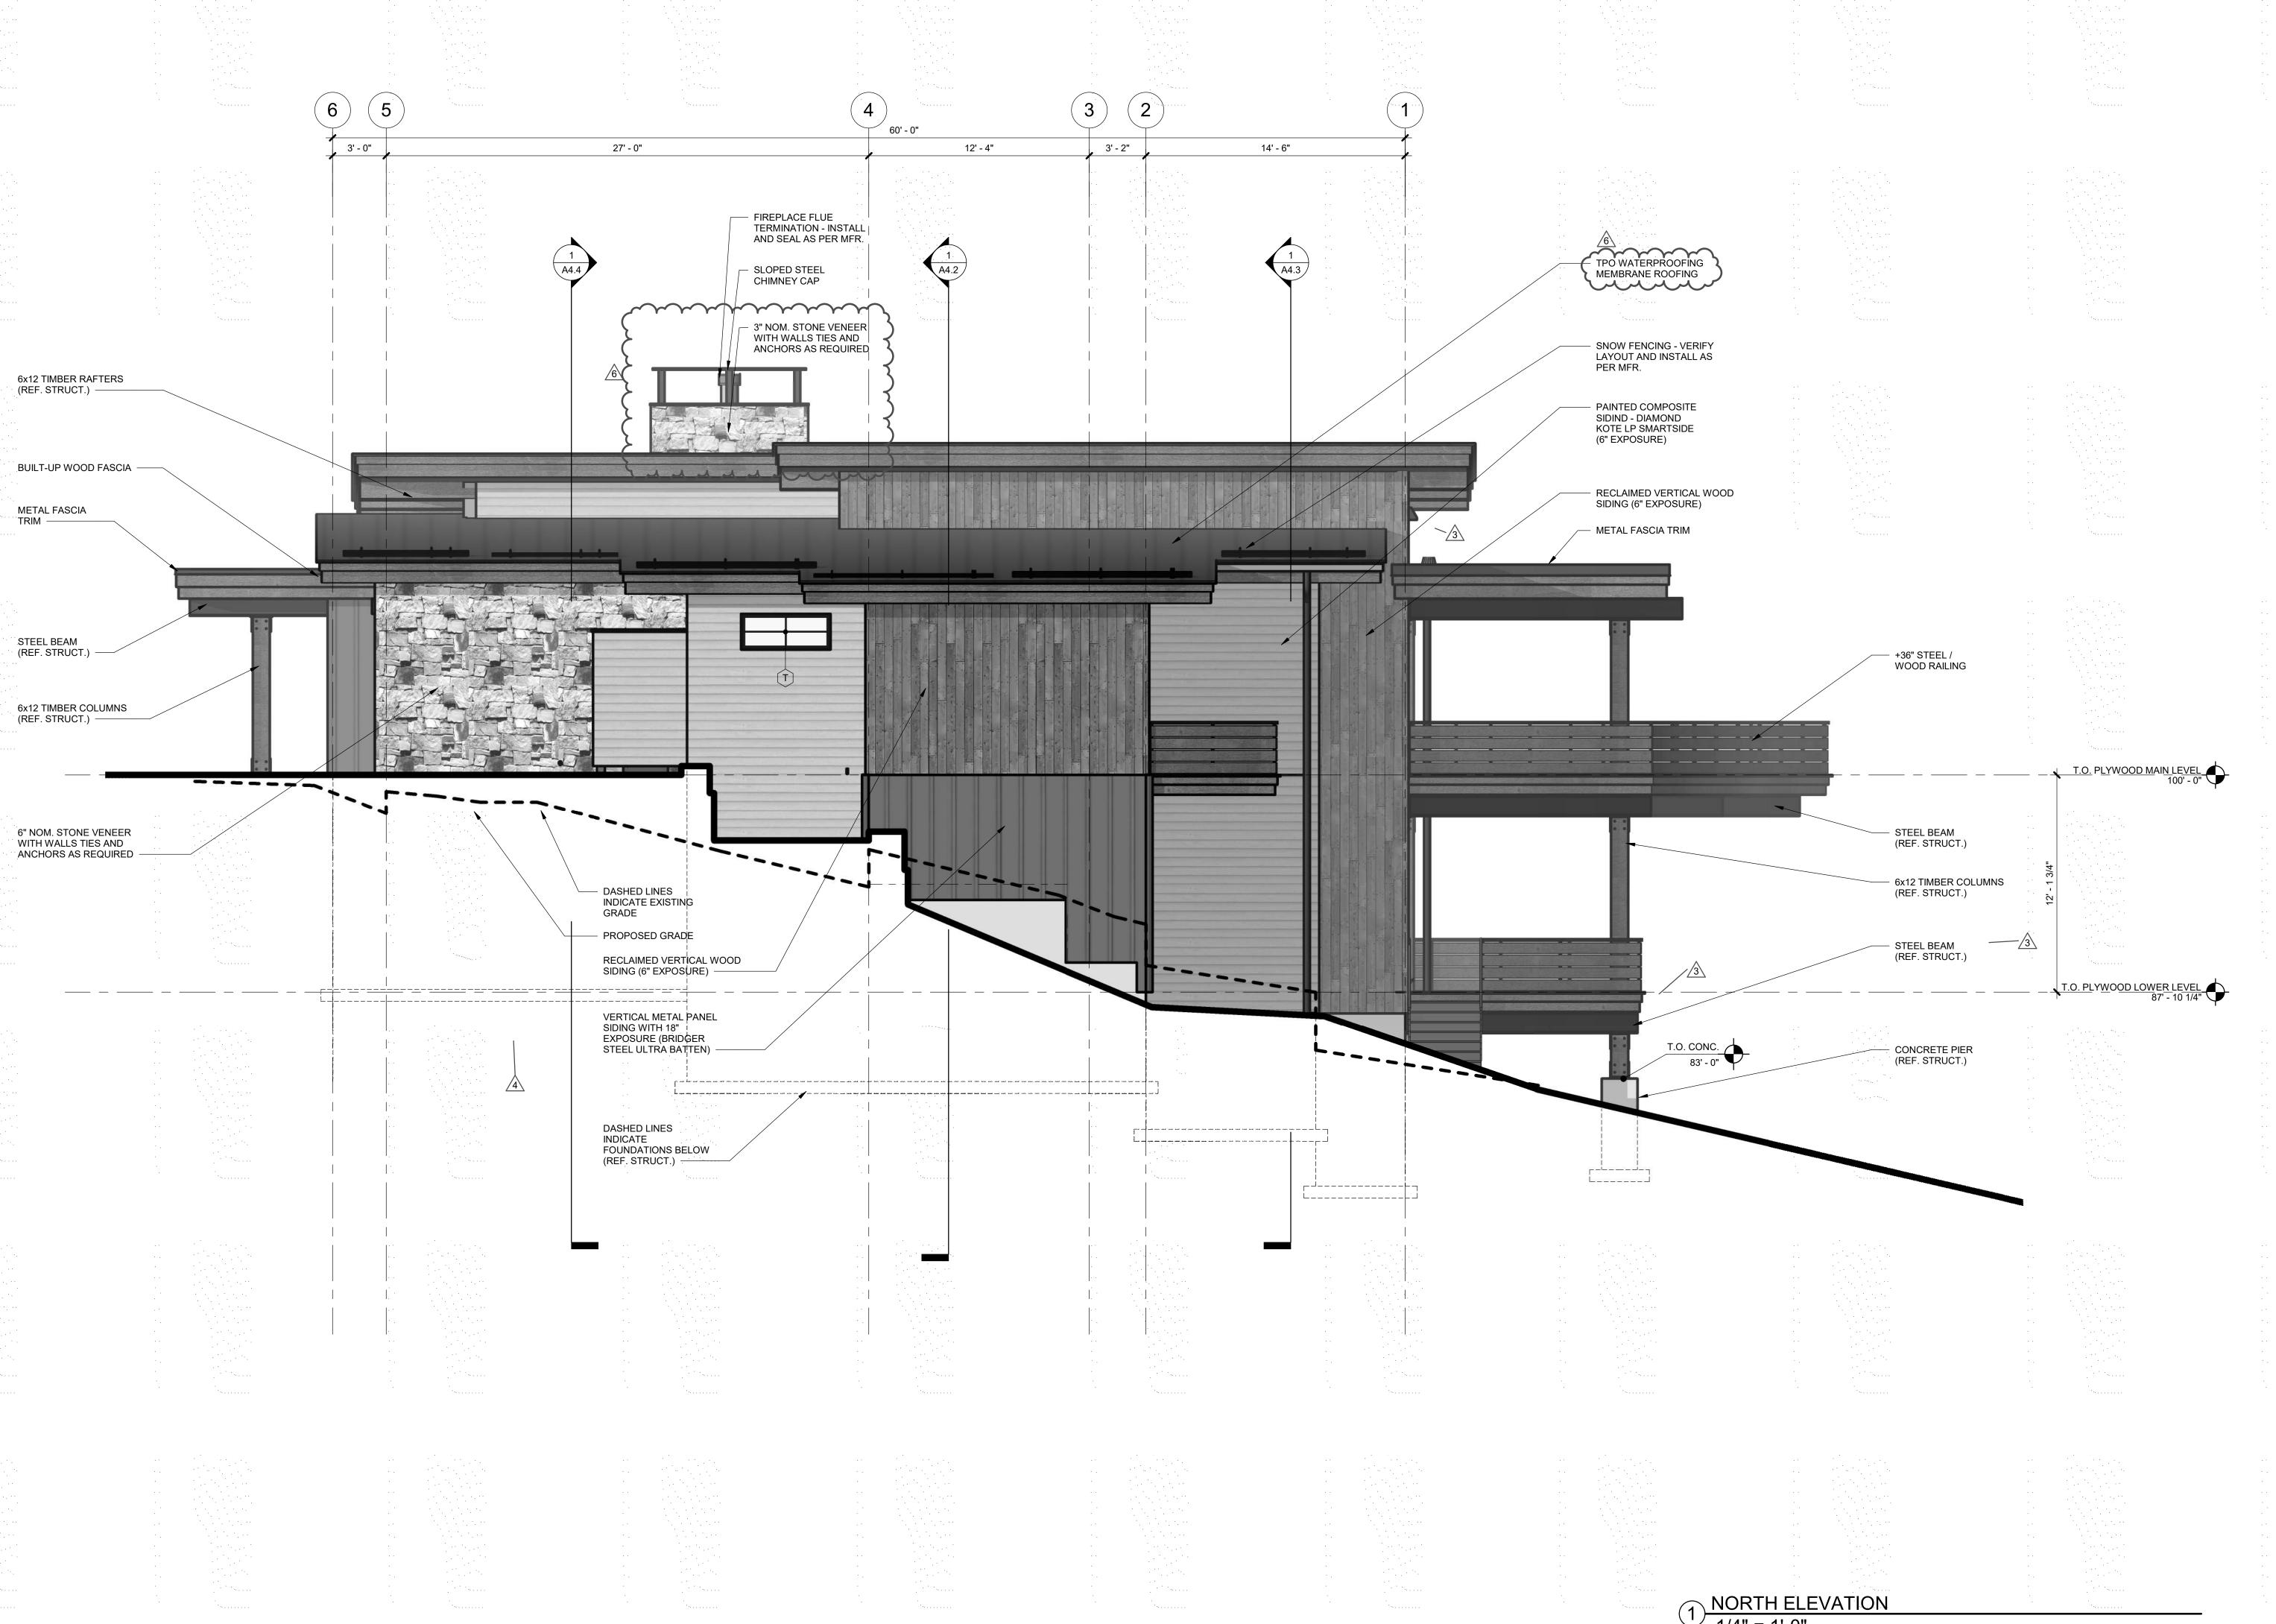


LOT #5 - EA STEAMBOAT AMPBELL ISSUE NAME DATE 50% DD MINOR ADJUSTMENT

DRAWING TITLE

SHEET NO.

BUILDING **ELEVATIONS** 

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**PLANNING** 

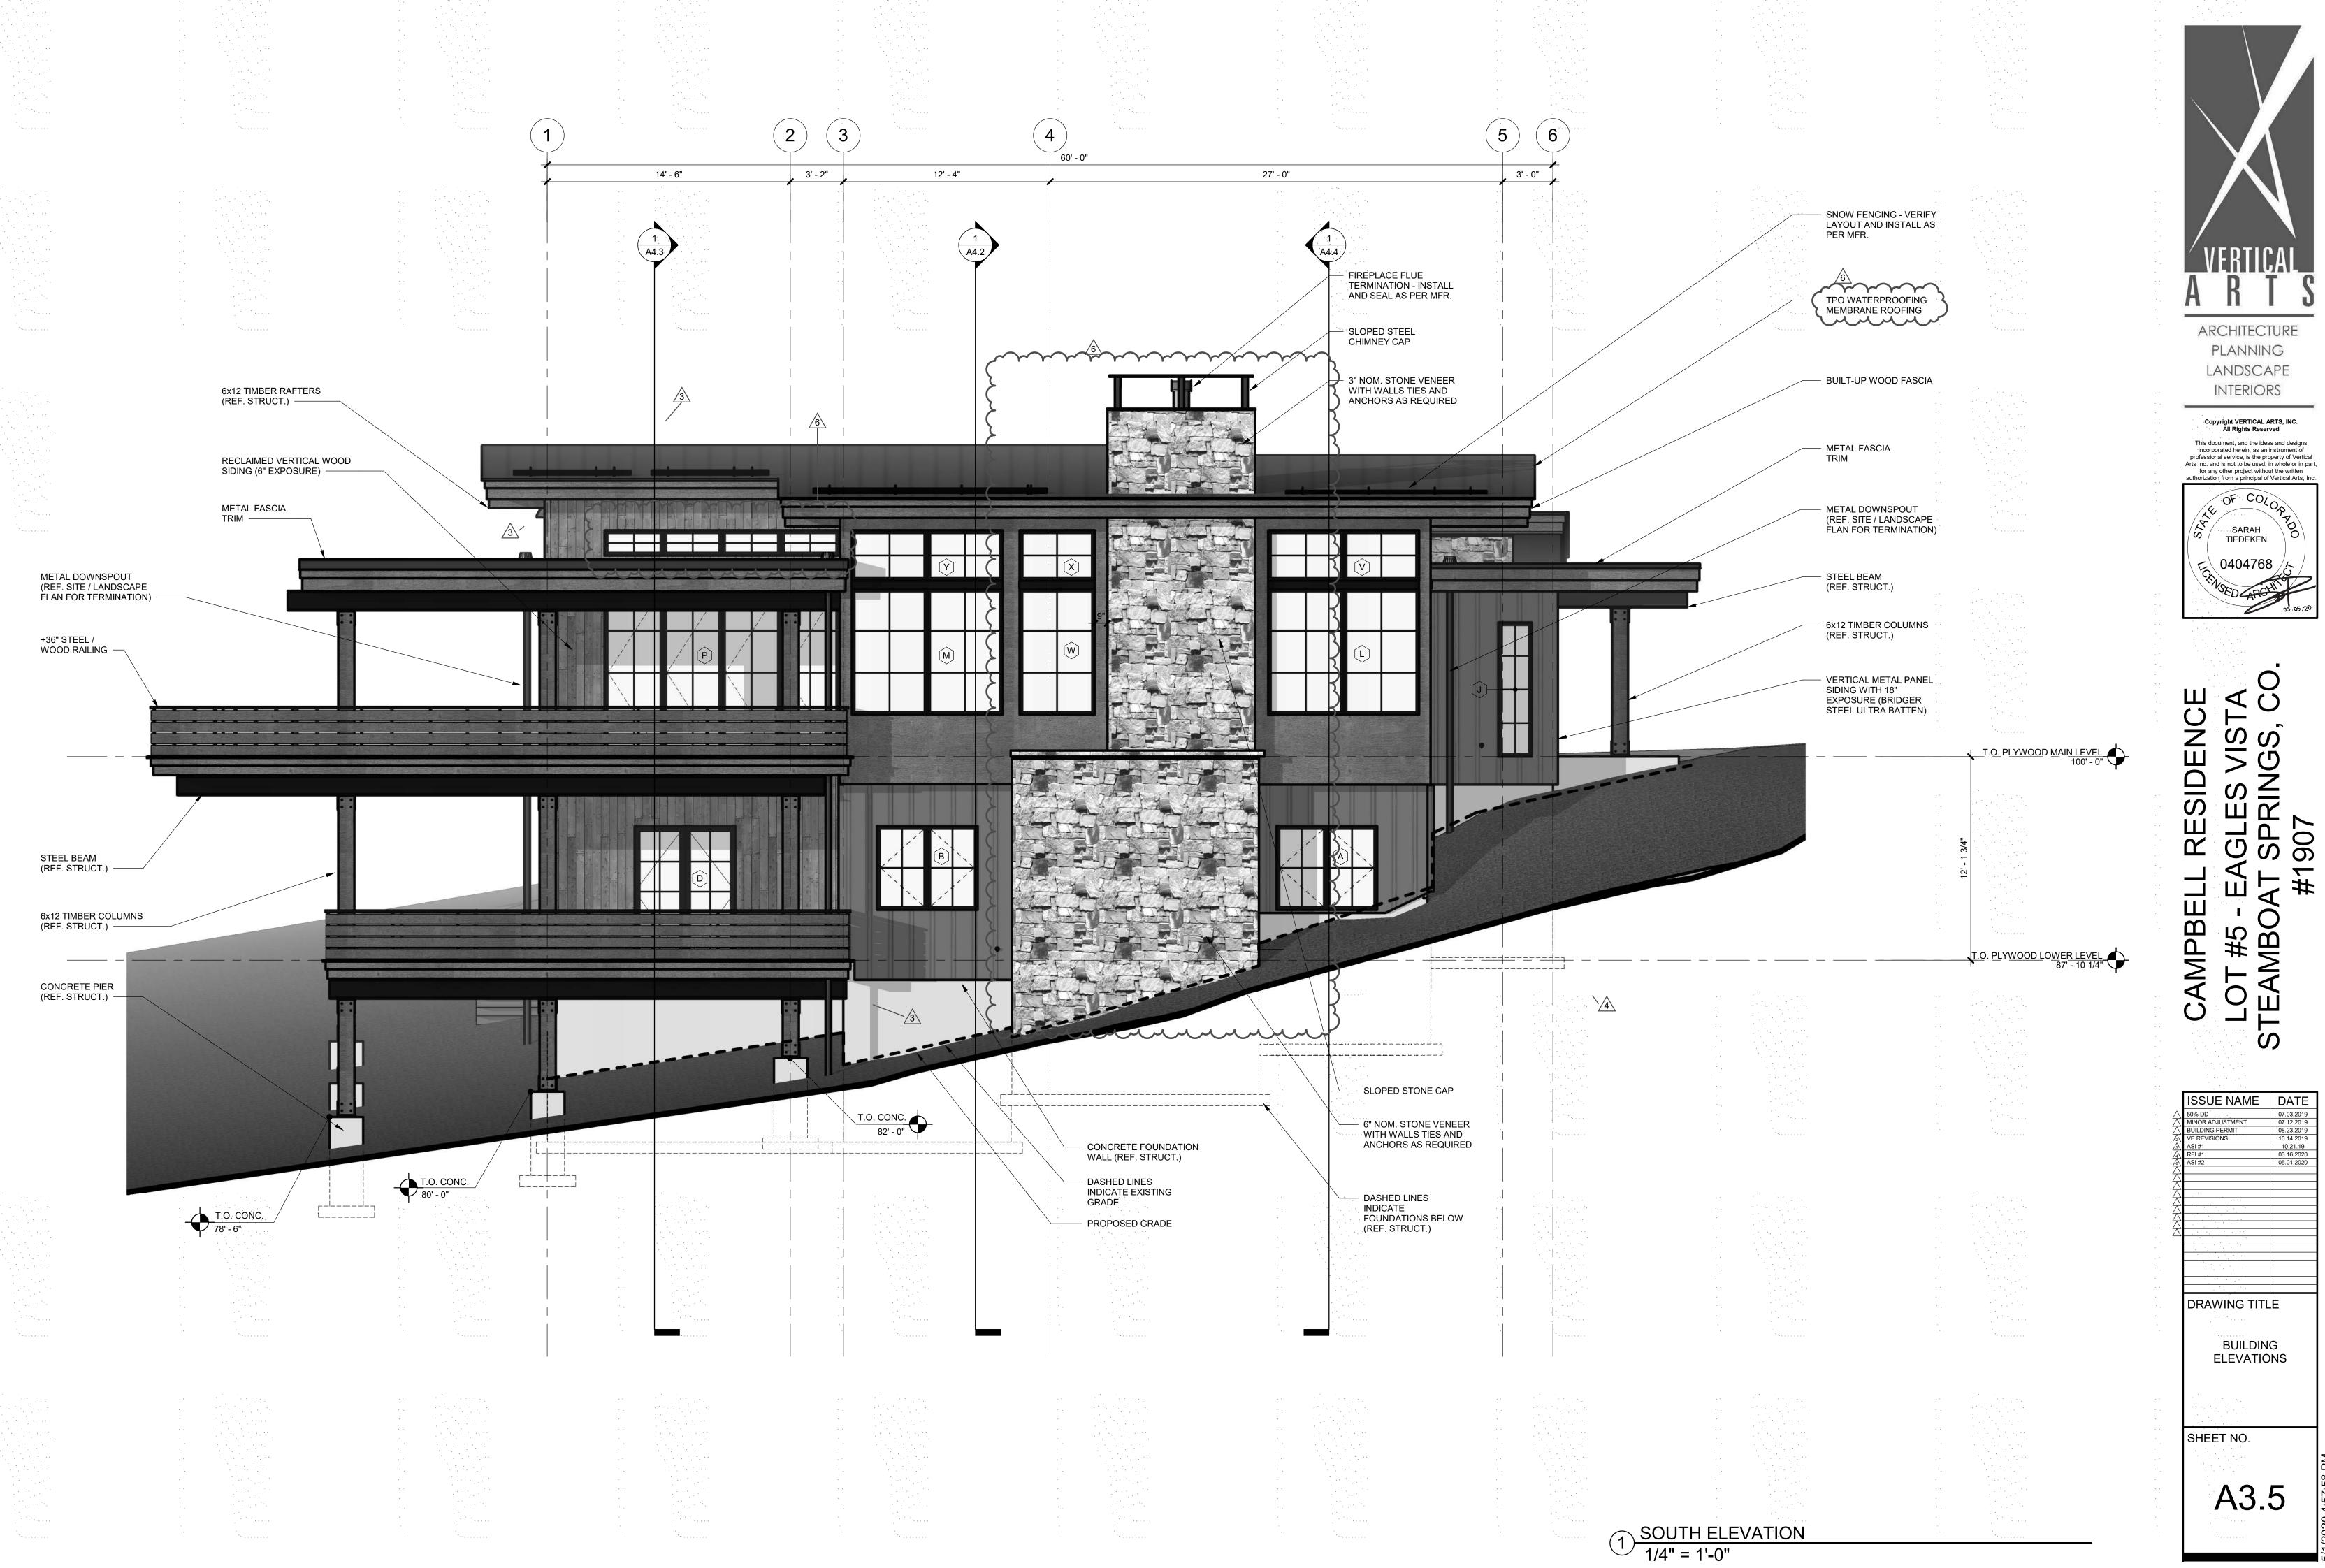LANDSCAPE

INTERIORS

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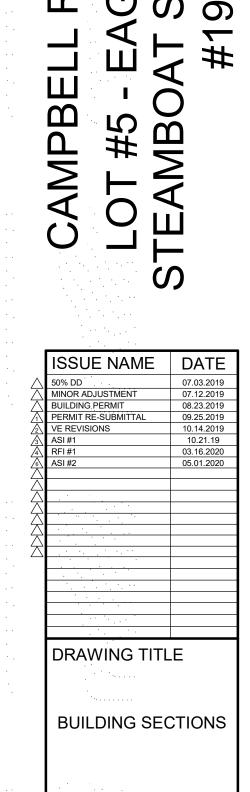
SARAH TIEDEKEN


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**AMPBELI** 


ISSUE NAME	DATE
50% DD	07.03.2019
MINOR ADJUSTMENT	07.12.2019
BUILDING PERMIT	08.23.2019
VE REVISIONS	10.14.2019
ASI #1	10.21.19
RFI#1	03.16.2020
ASI#2	05.01.2020
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SHEET NO. A3.5





A4.1

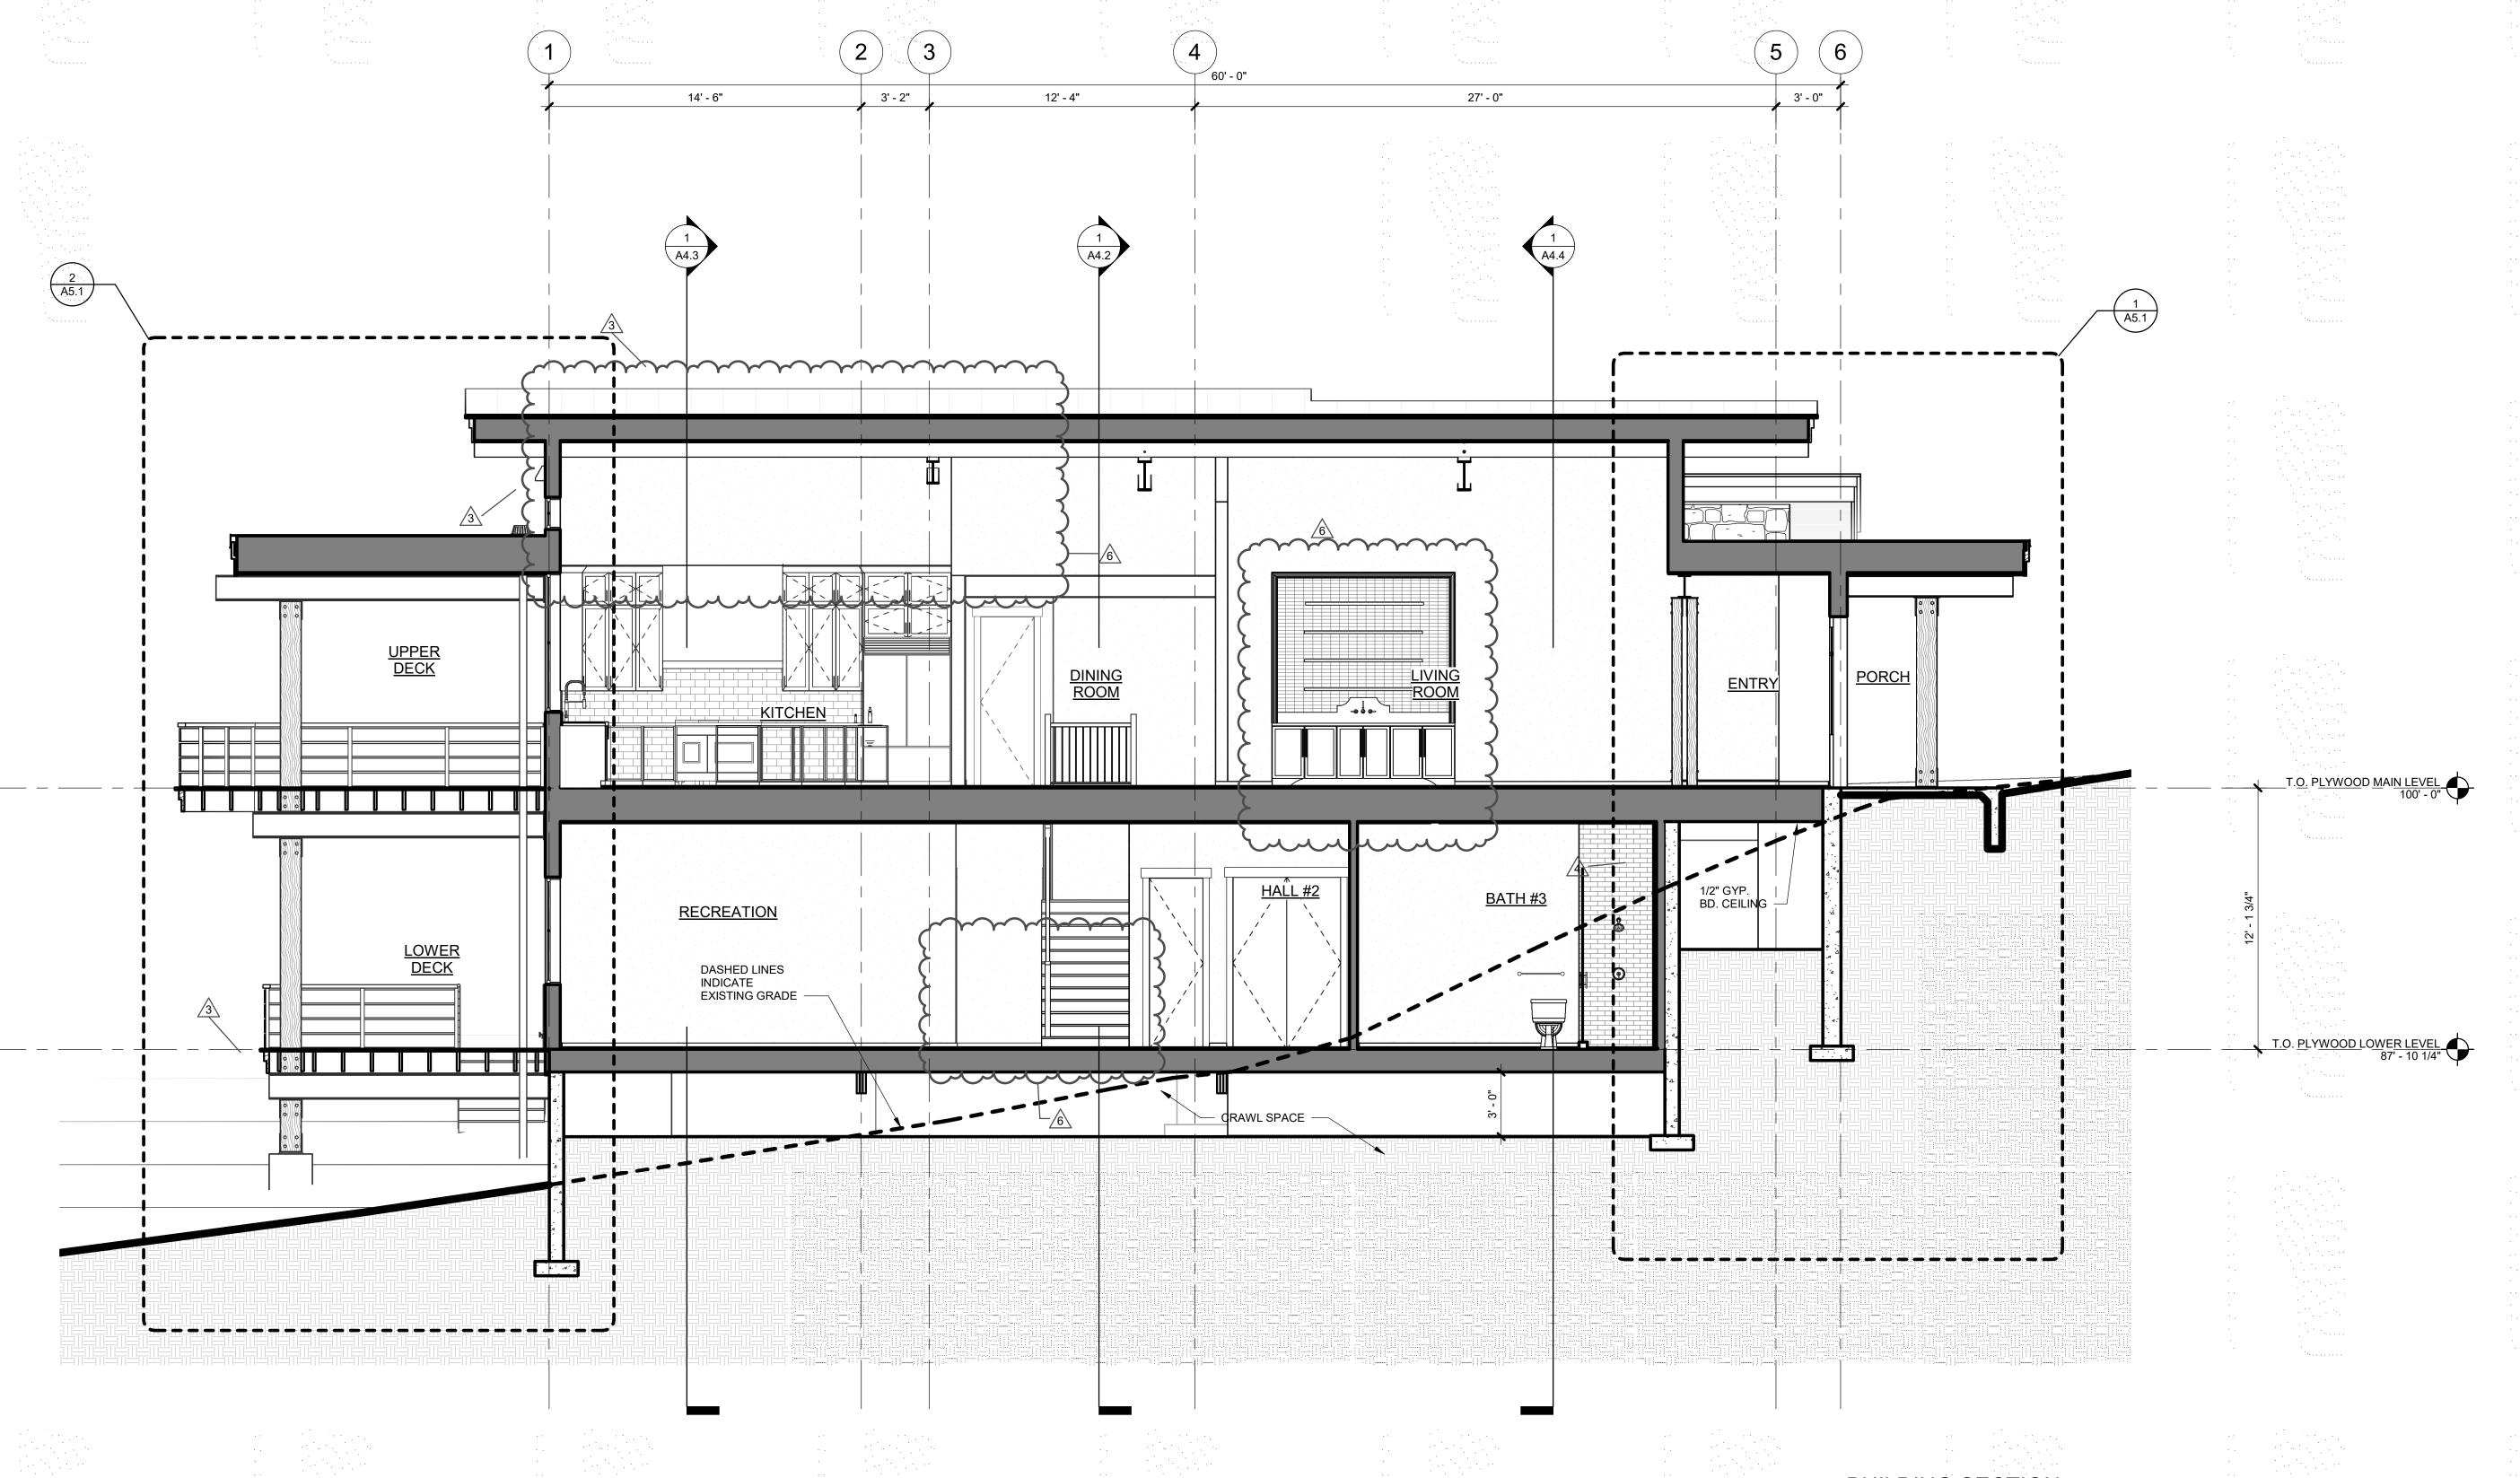

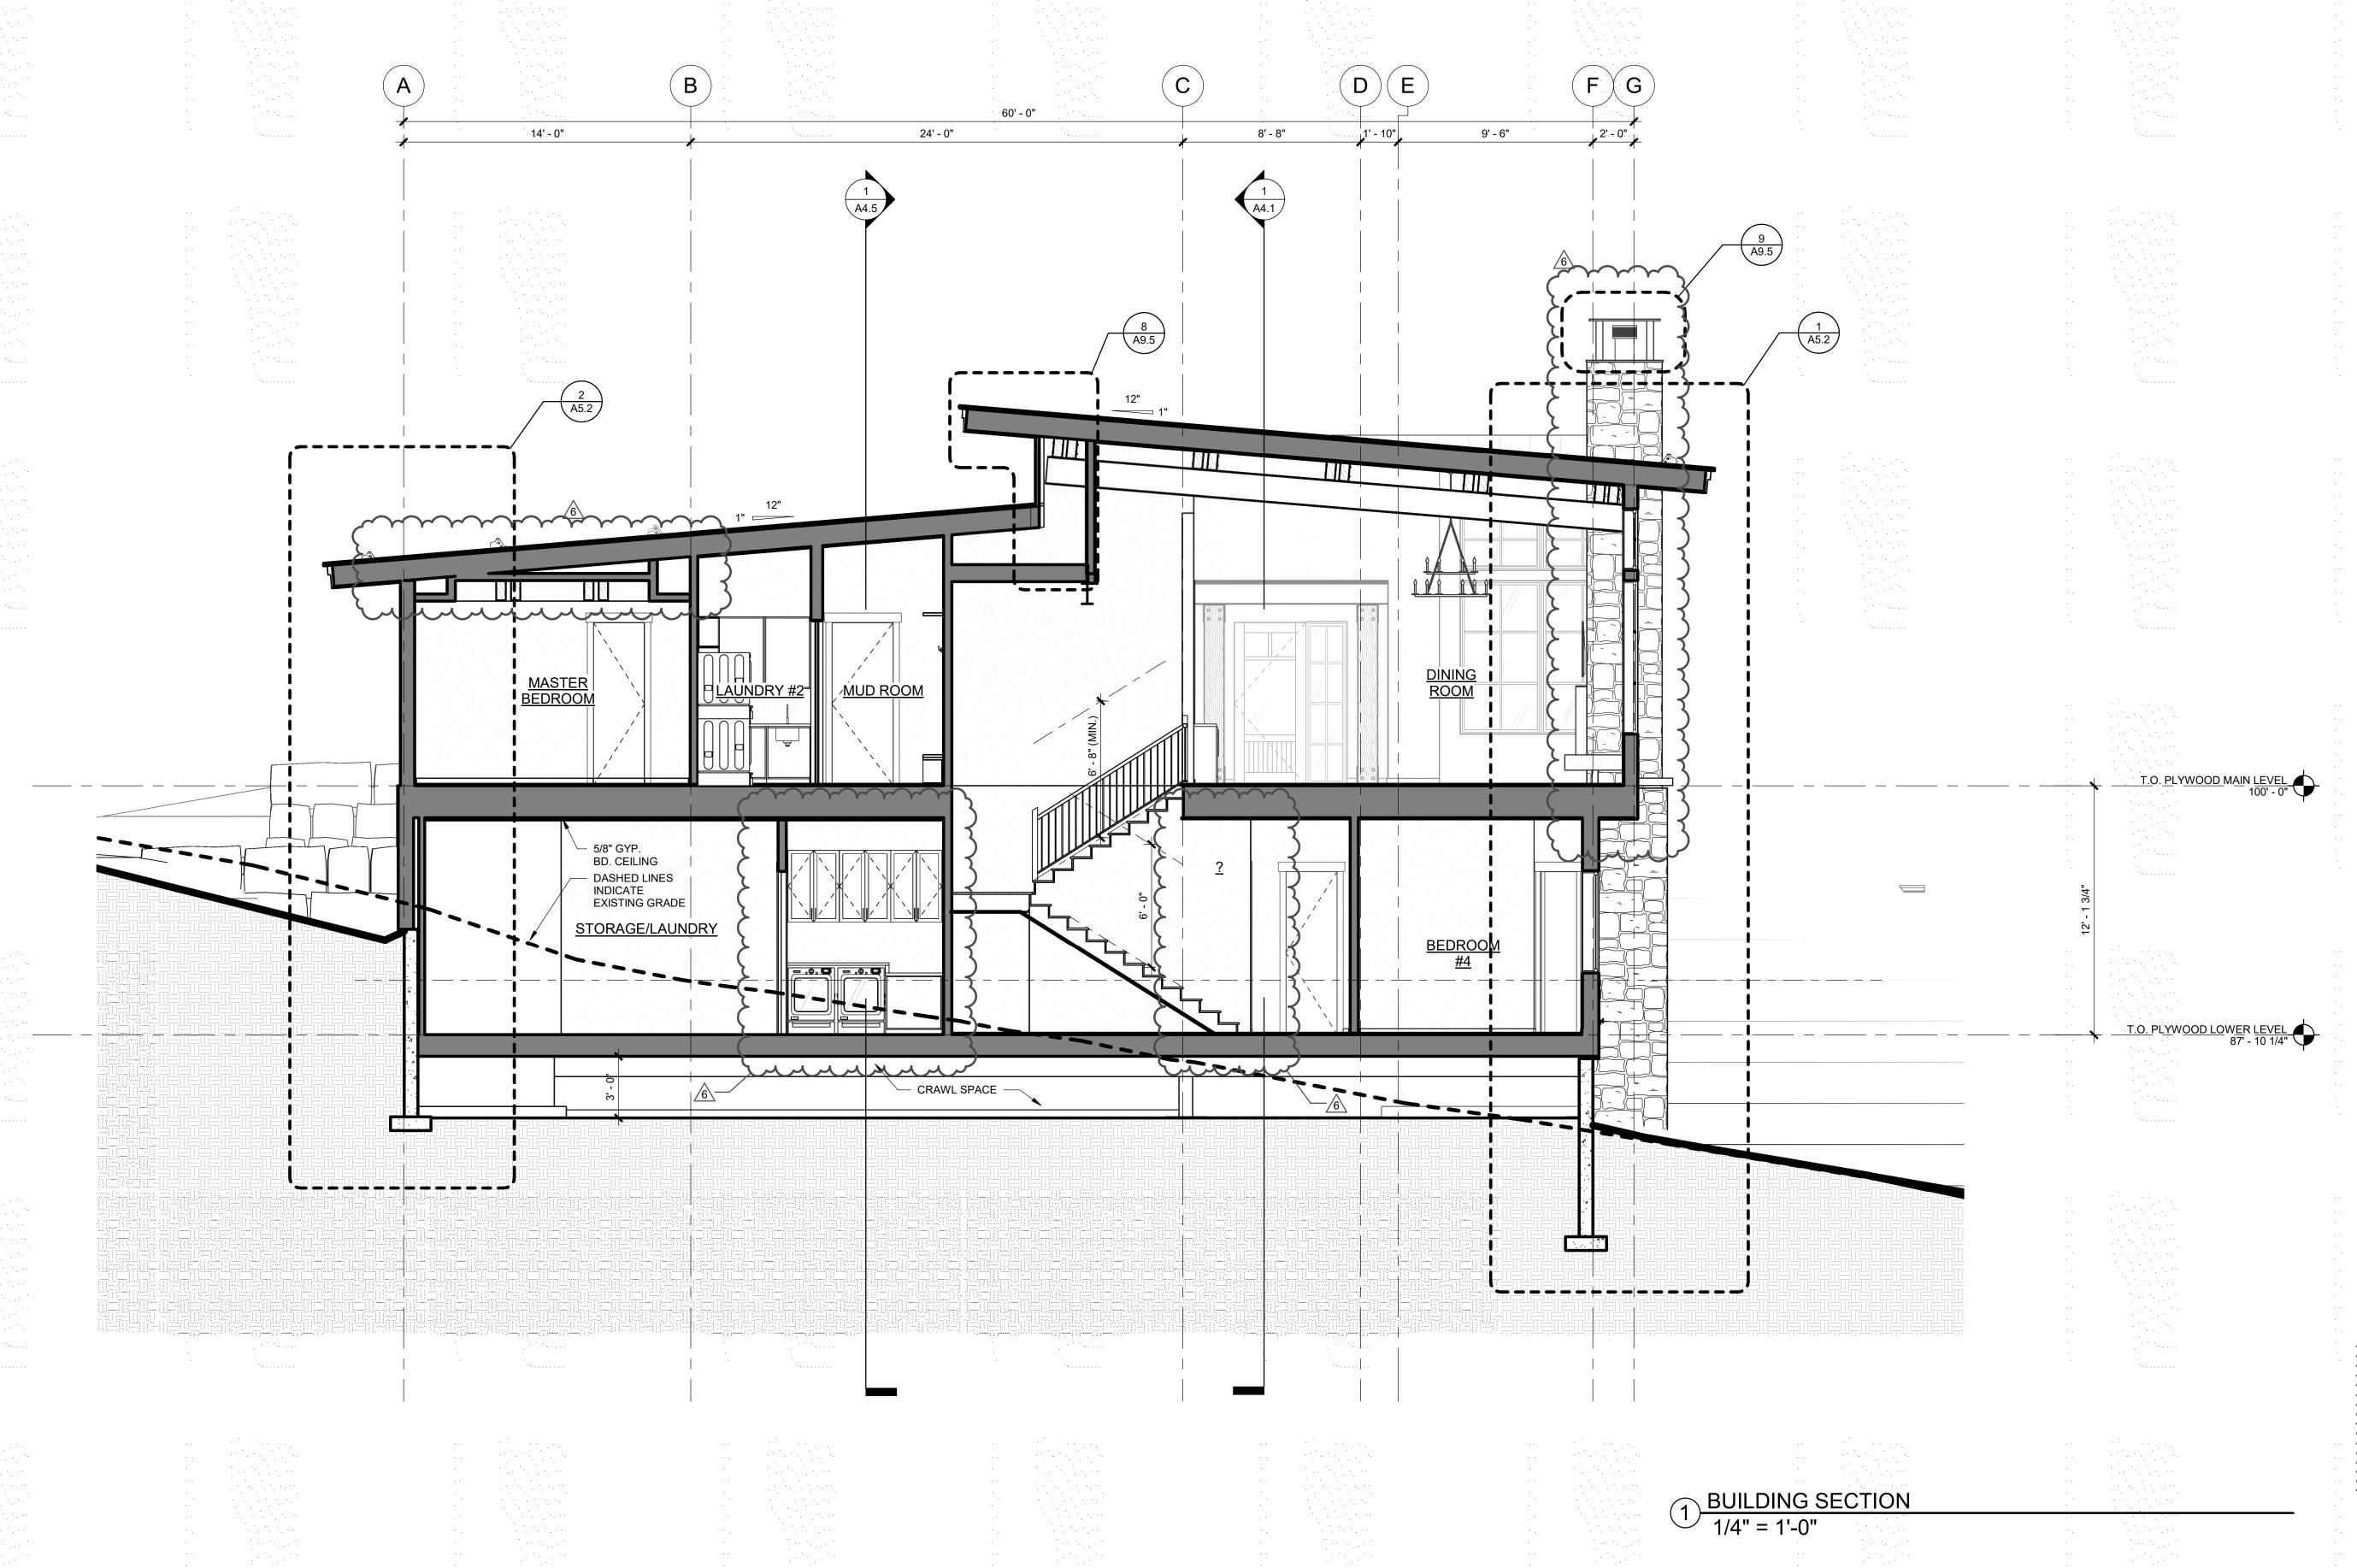
LOT #5 - EA( STEAMBOAT (

AMPBELL 50% DD MINOR ADJUSTMENT BUILDING PERMIT PERMIT RE-SUBMITTAL

DRAWING TITLE

**BUILDING SECTIONS** 

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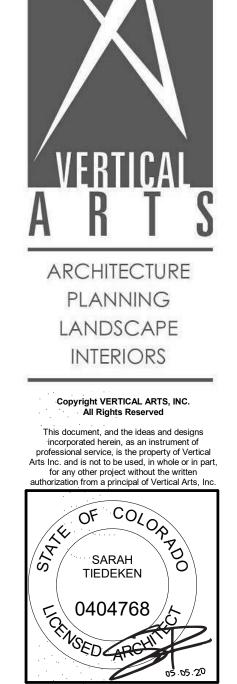
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BUILDING PERMIT 08.23.2019
VE REVISIONS 10.14.2019
ASI #1 10.21.19
ASI #2 05.01.2020

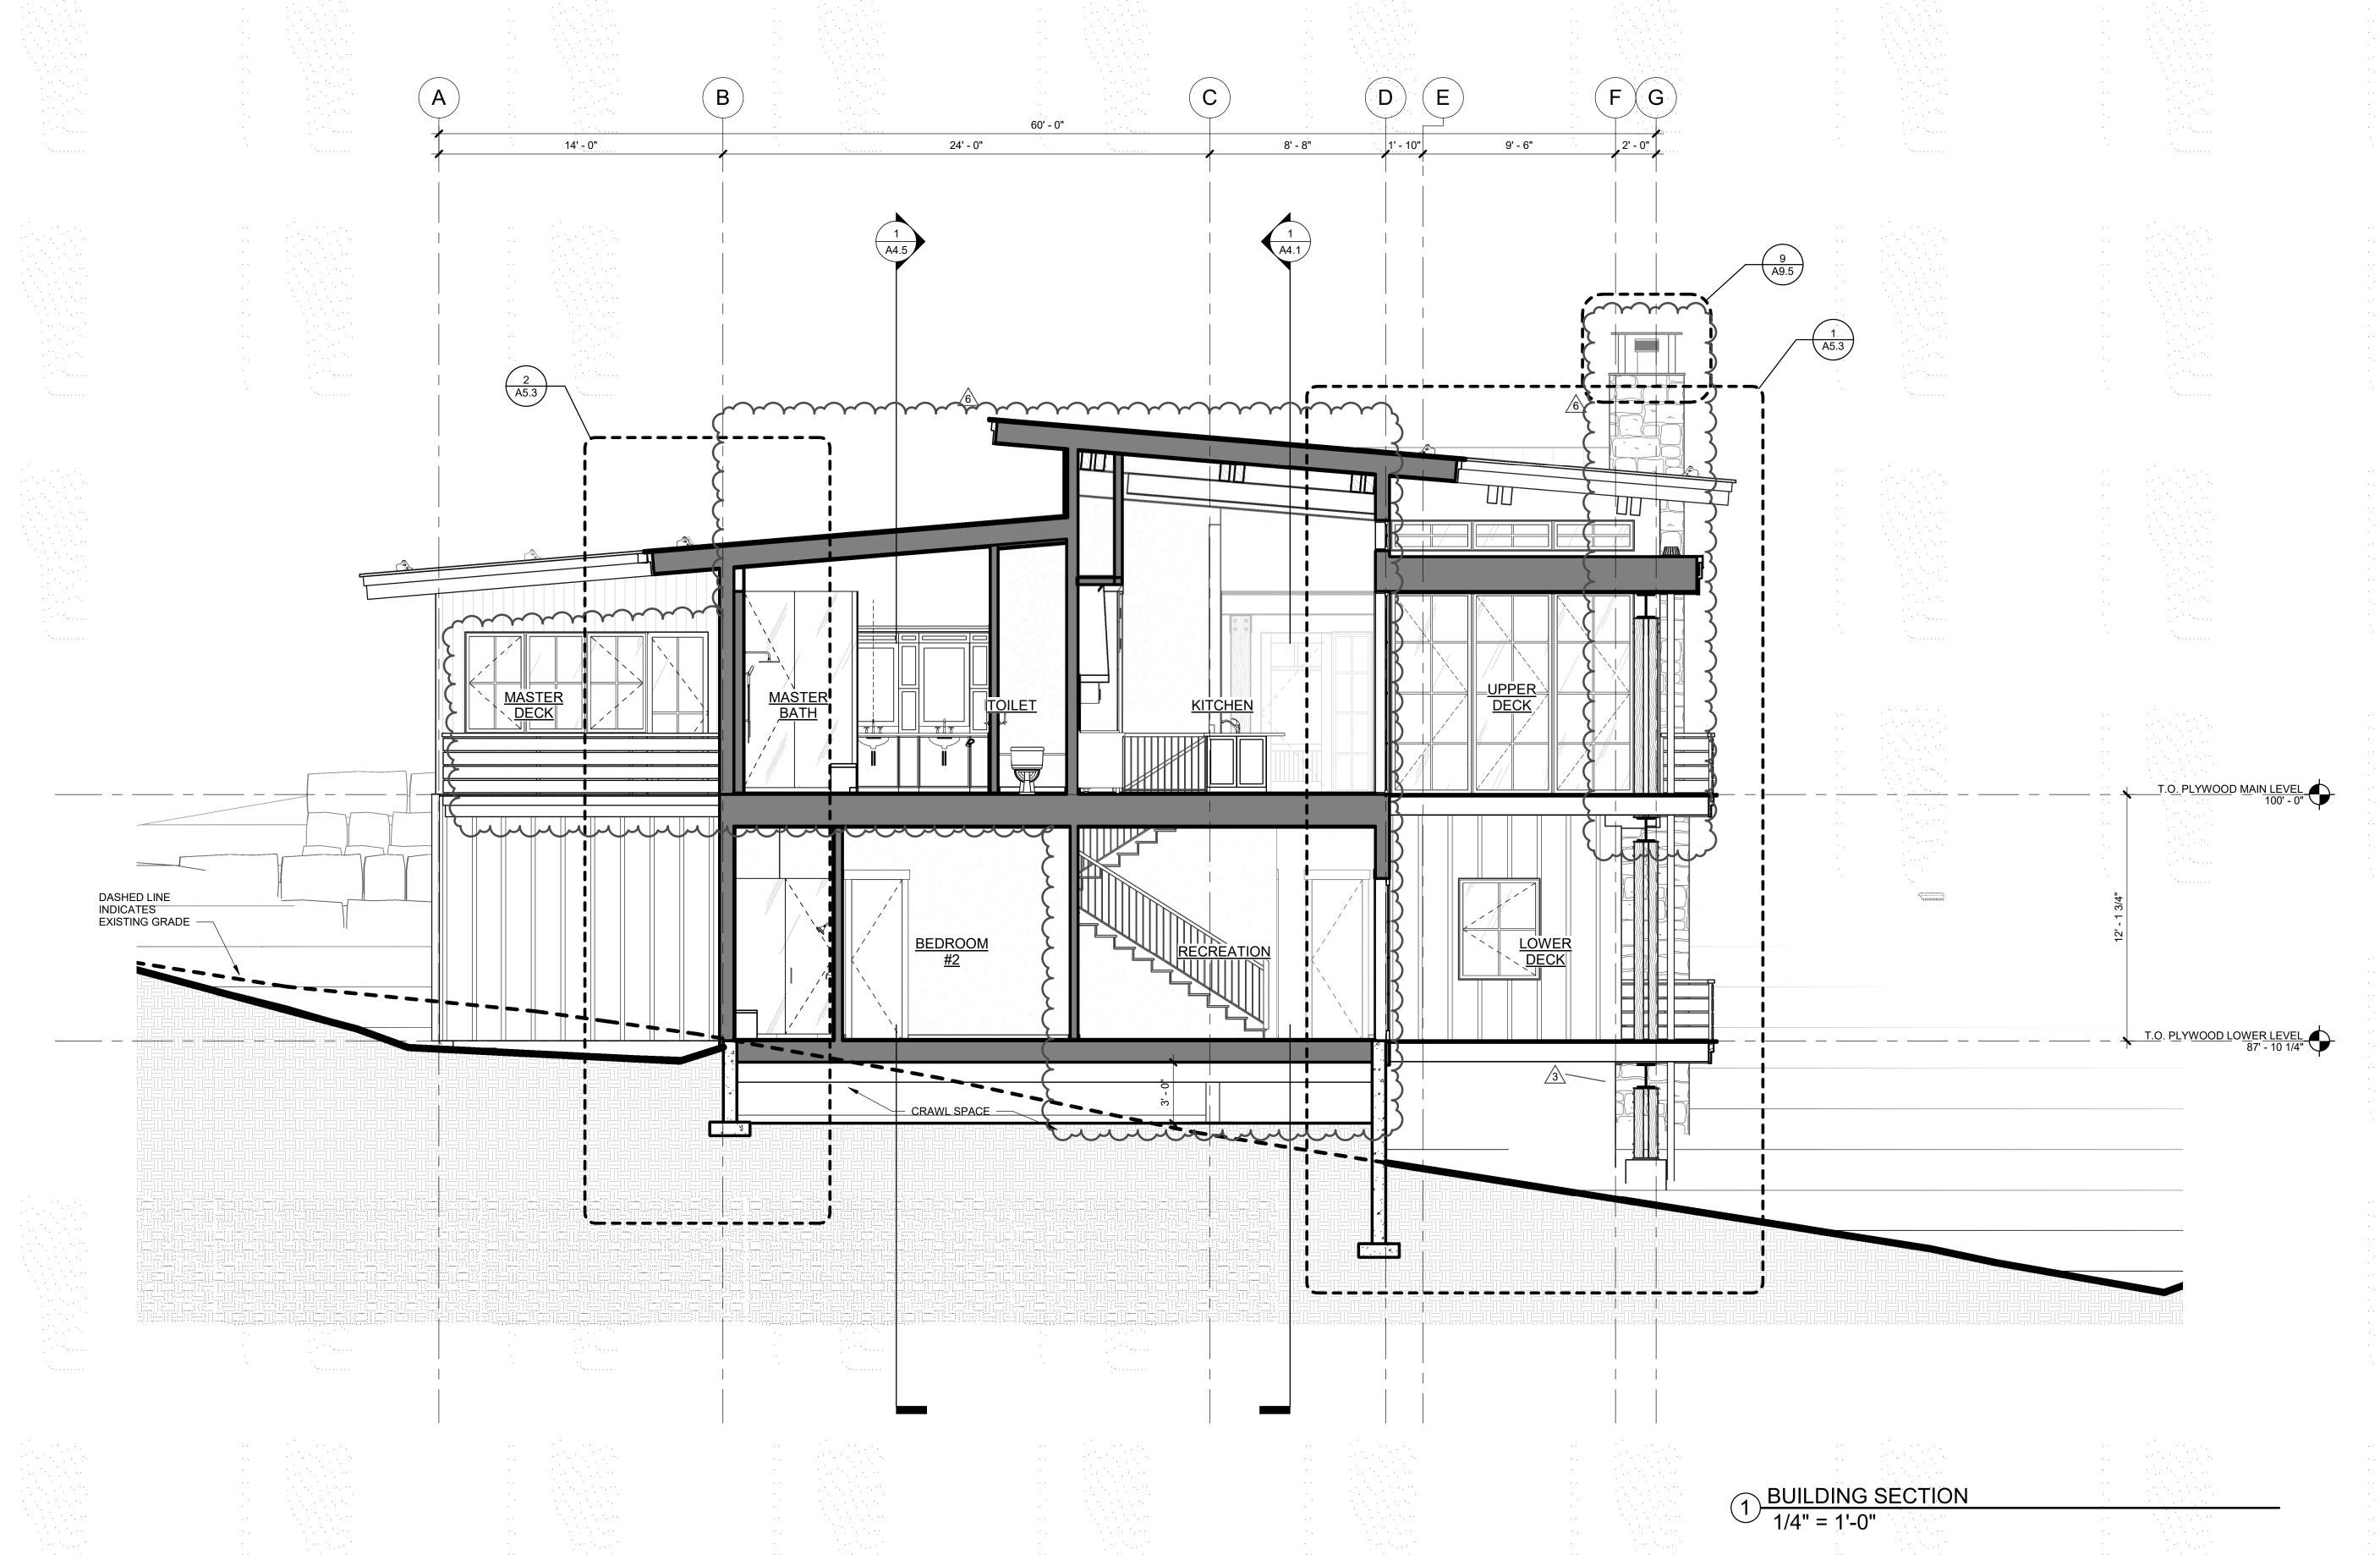
DRAWING TITLE

BUILDING SECTIONS

SHEET NO.


CAMPBELL RESIDENCE
LOT #5 - EAGLES VISTA
STEAMBOAT SPRINGS, CO




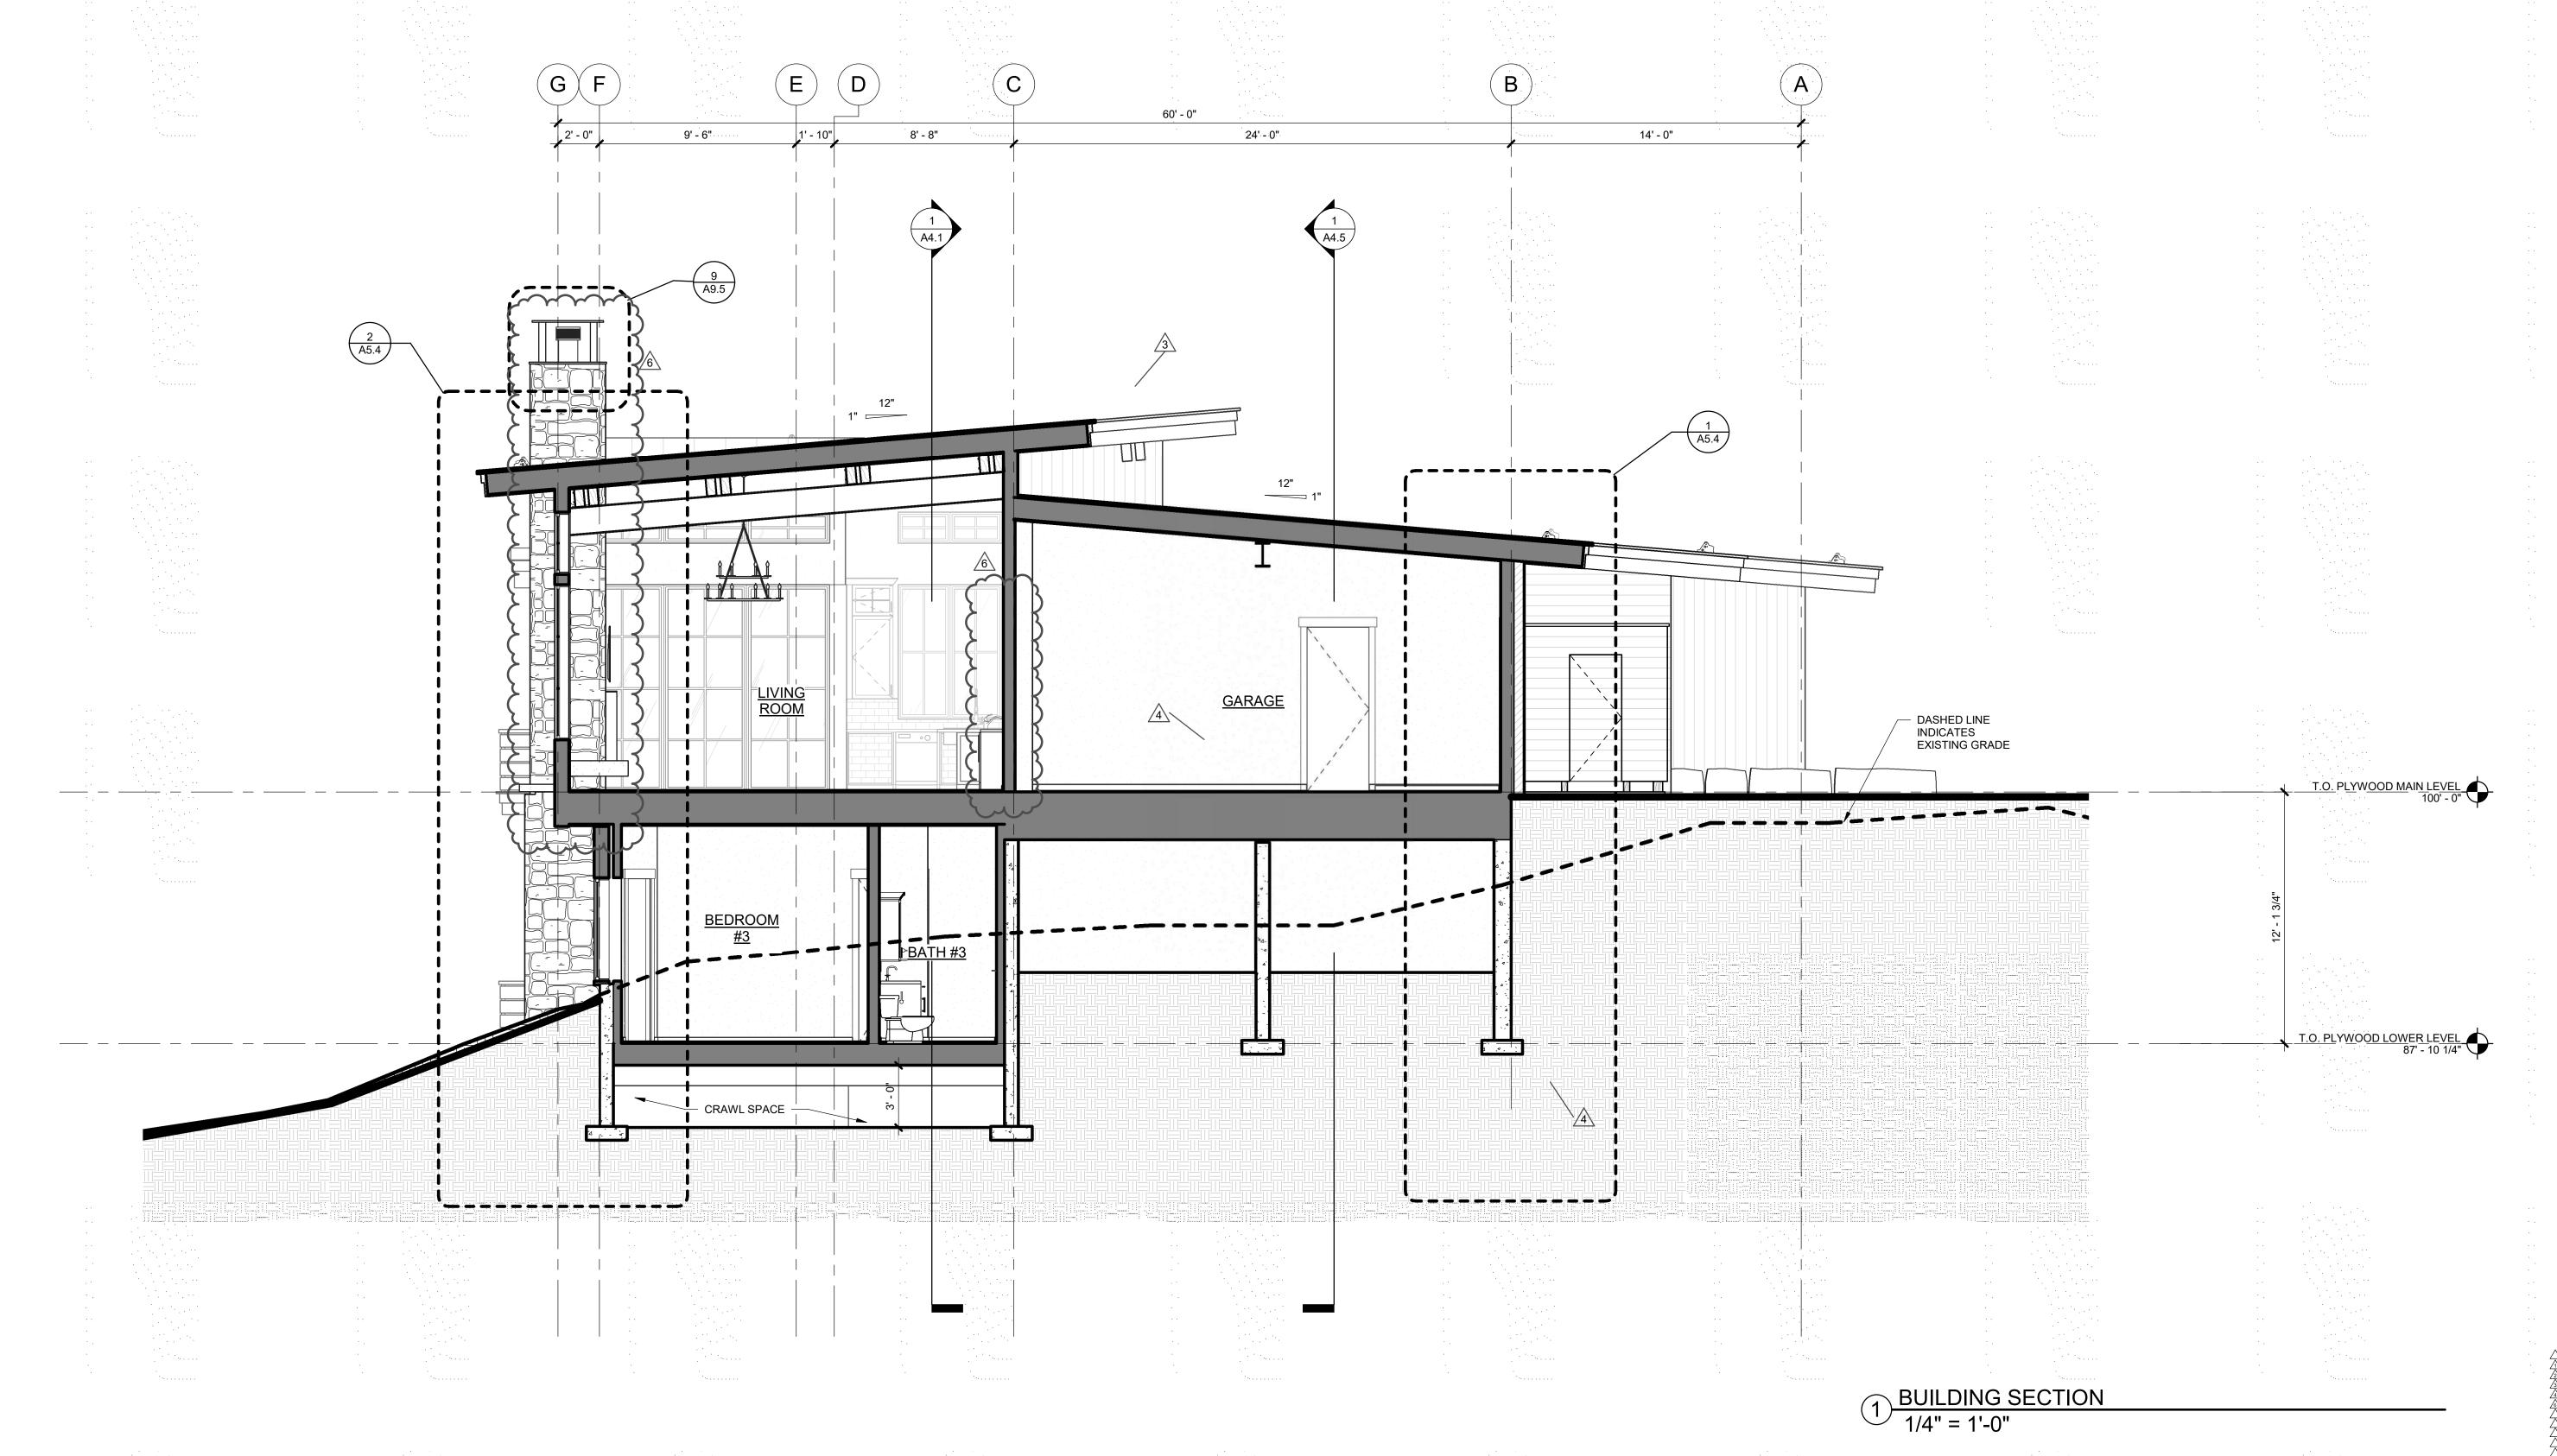

LOT #5 - EA( STEAMBOAT ( **AMPBELL** 

BUILDING PERMIT
PERMIT RE-SUBMITTAL
VE REVISIONS DRAWING TITLE **BUILDING SECTIONS** 

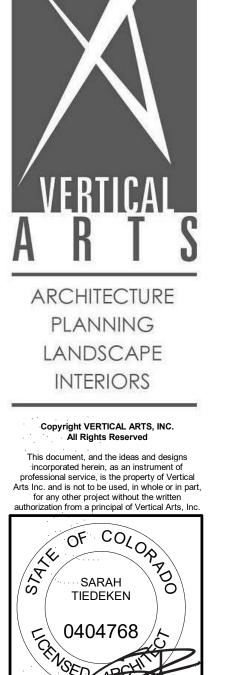

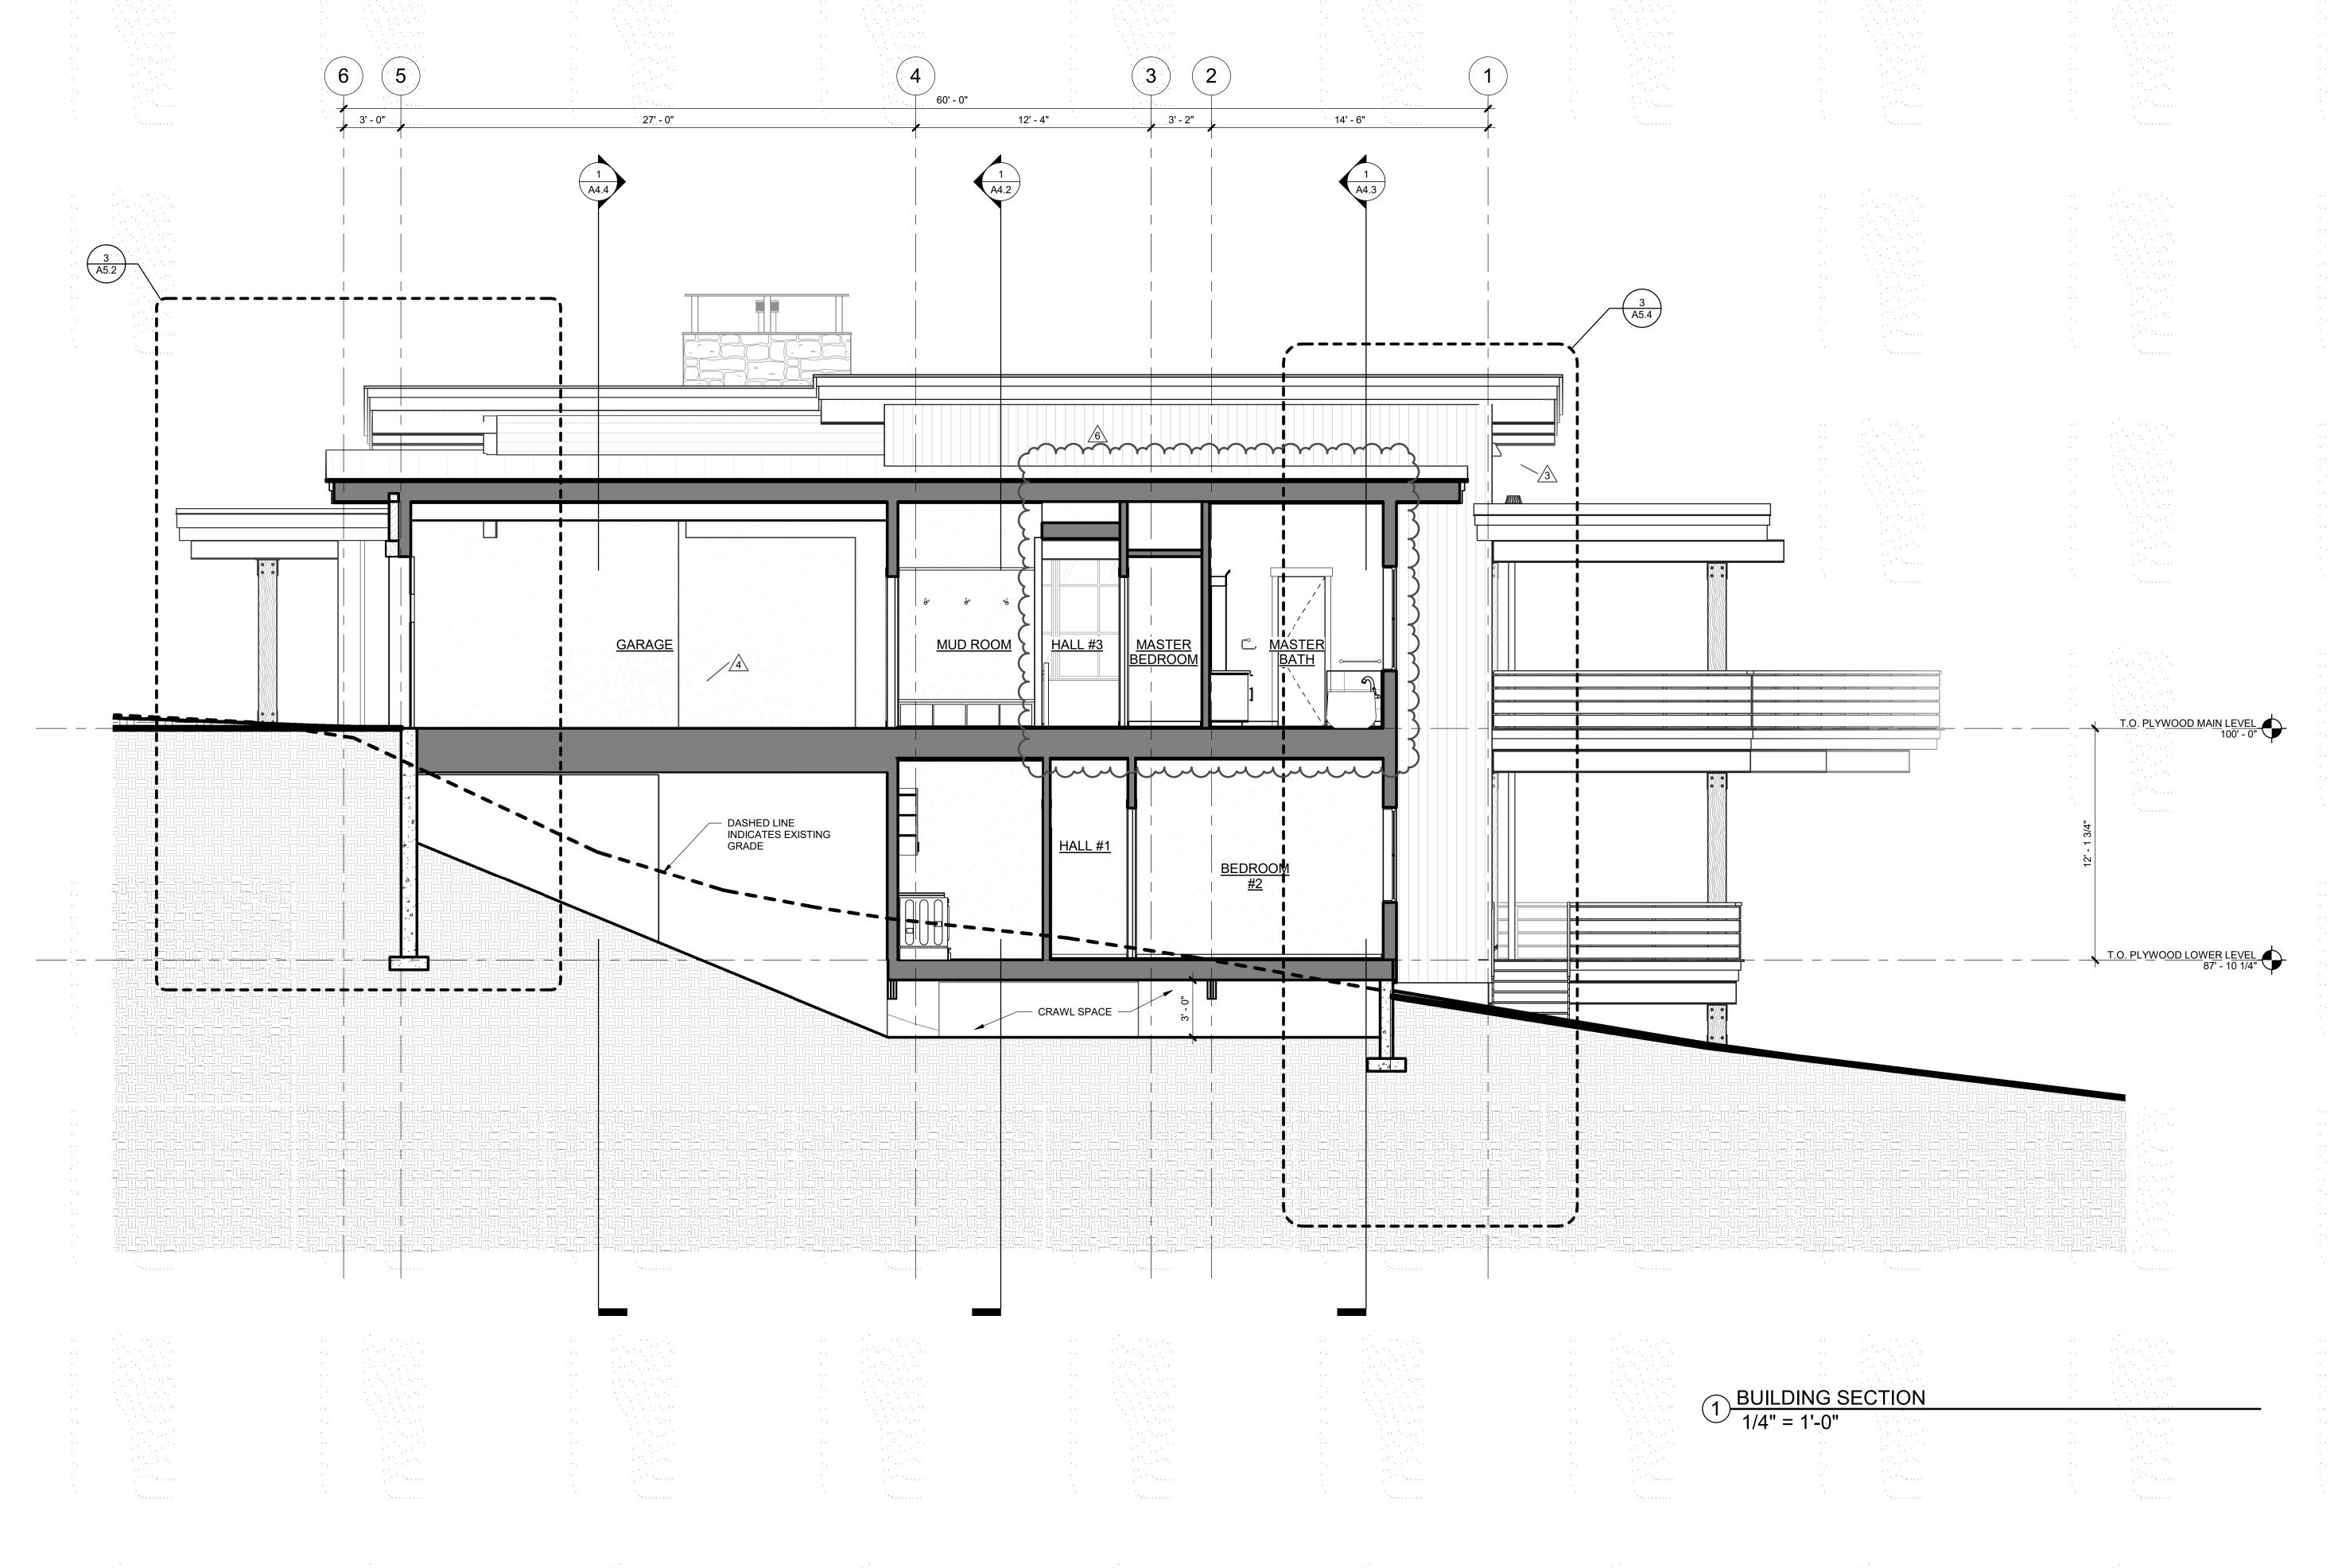

RE AGL SPI 907 LOT #5 - EA( STEAMBOAT § EA **AMPBELL** TO


BUILDING PERMIT PERMIT RE-SUBMITTAL


DRAWING TITLE

SHEET NO.

**BUILDING SECTIONS** 

A4.5

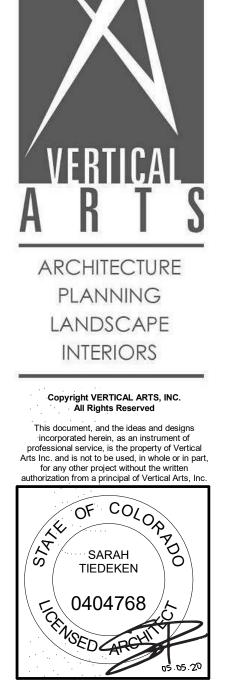

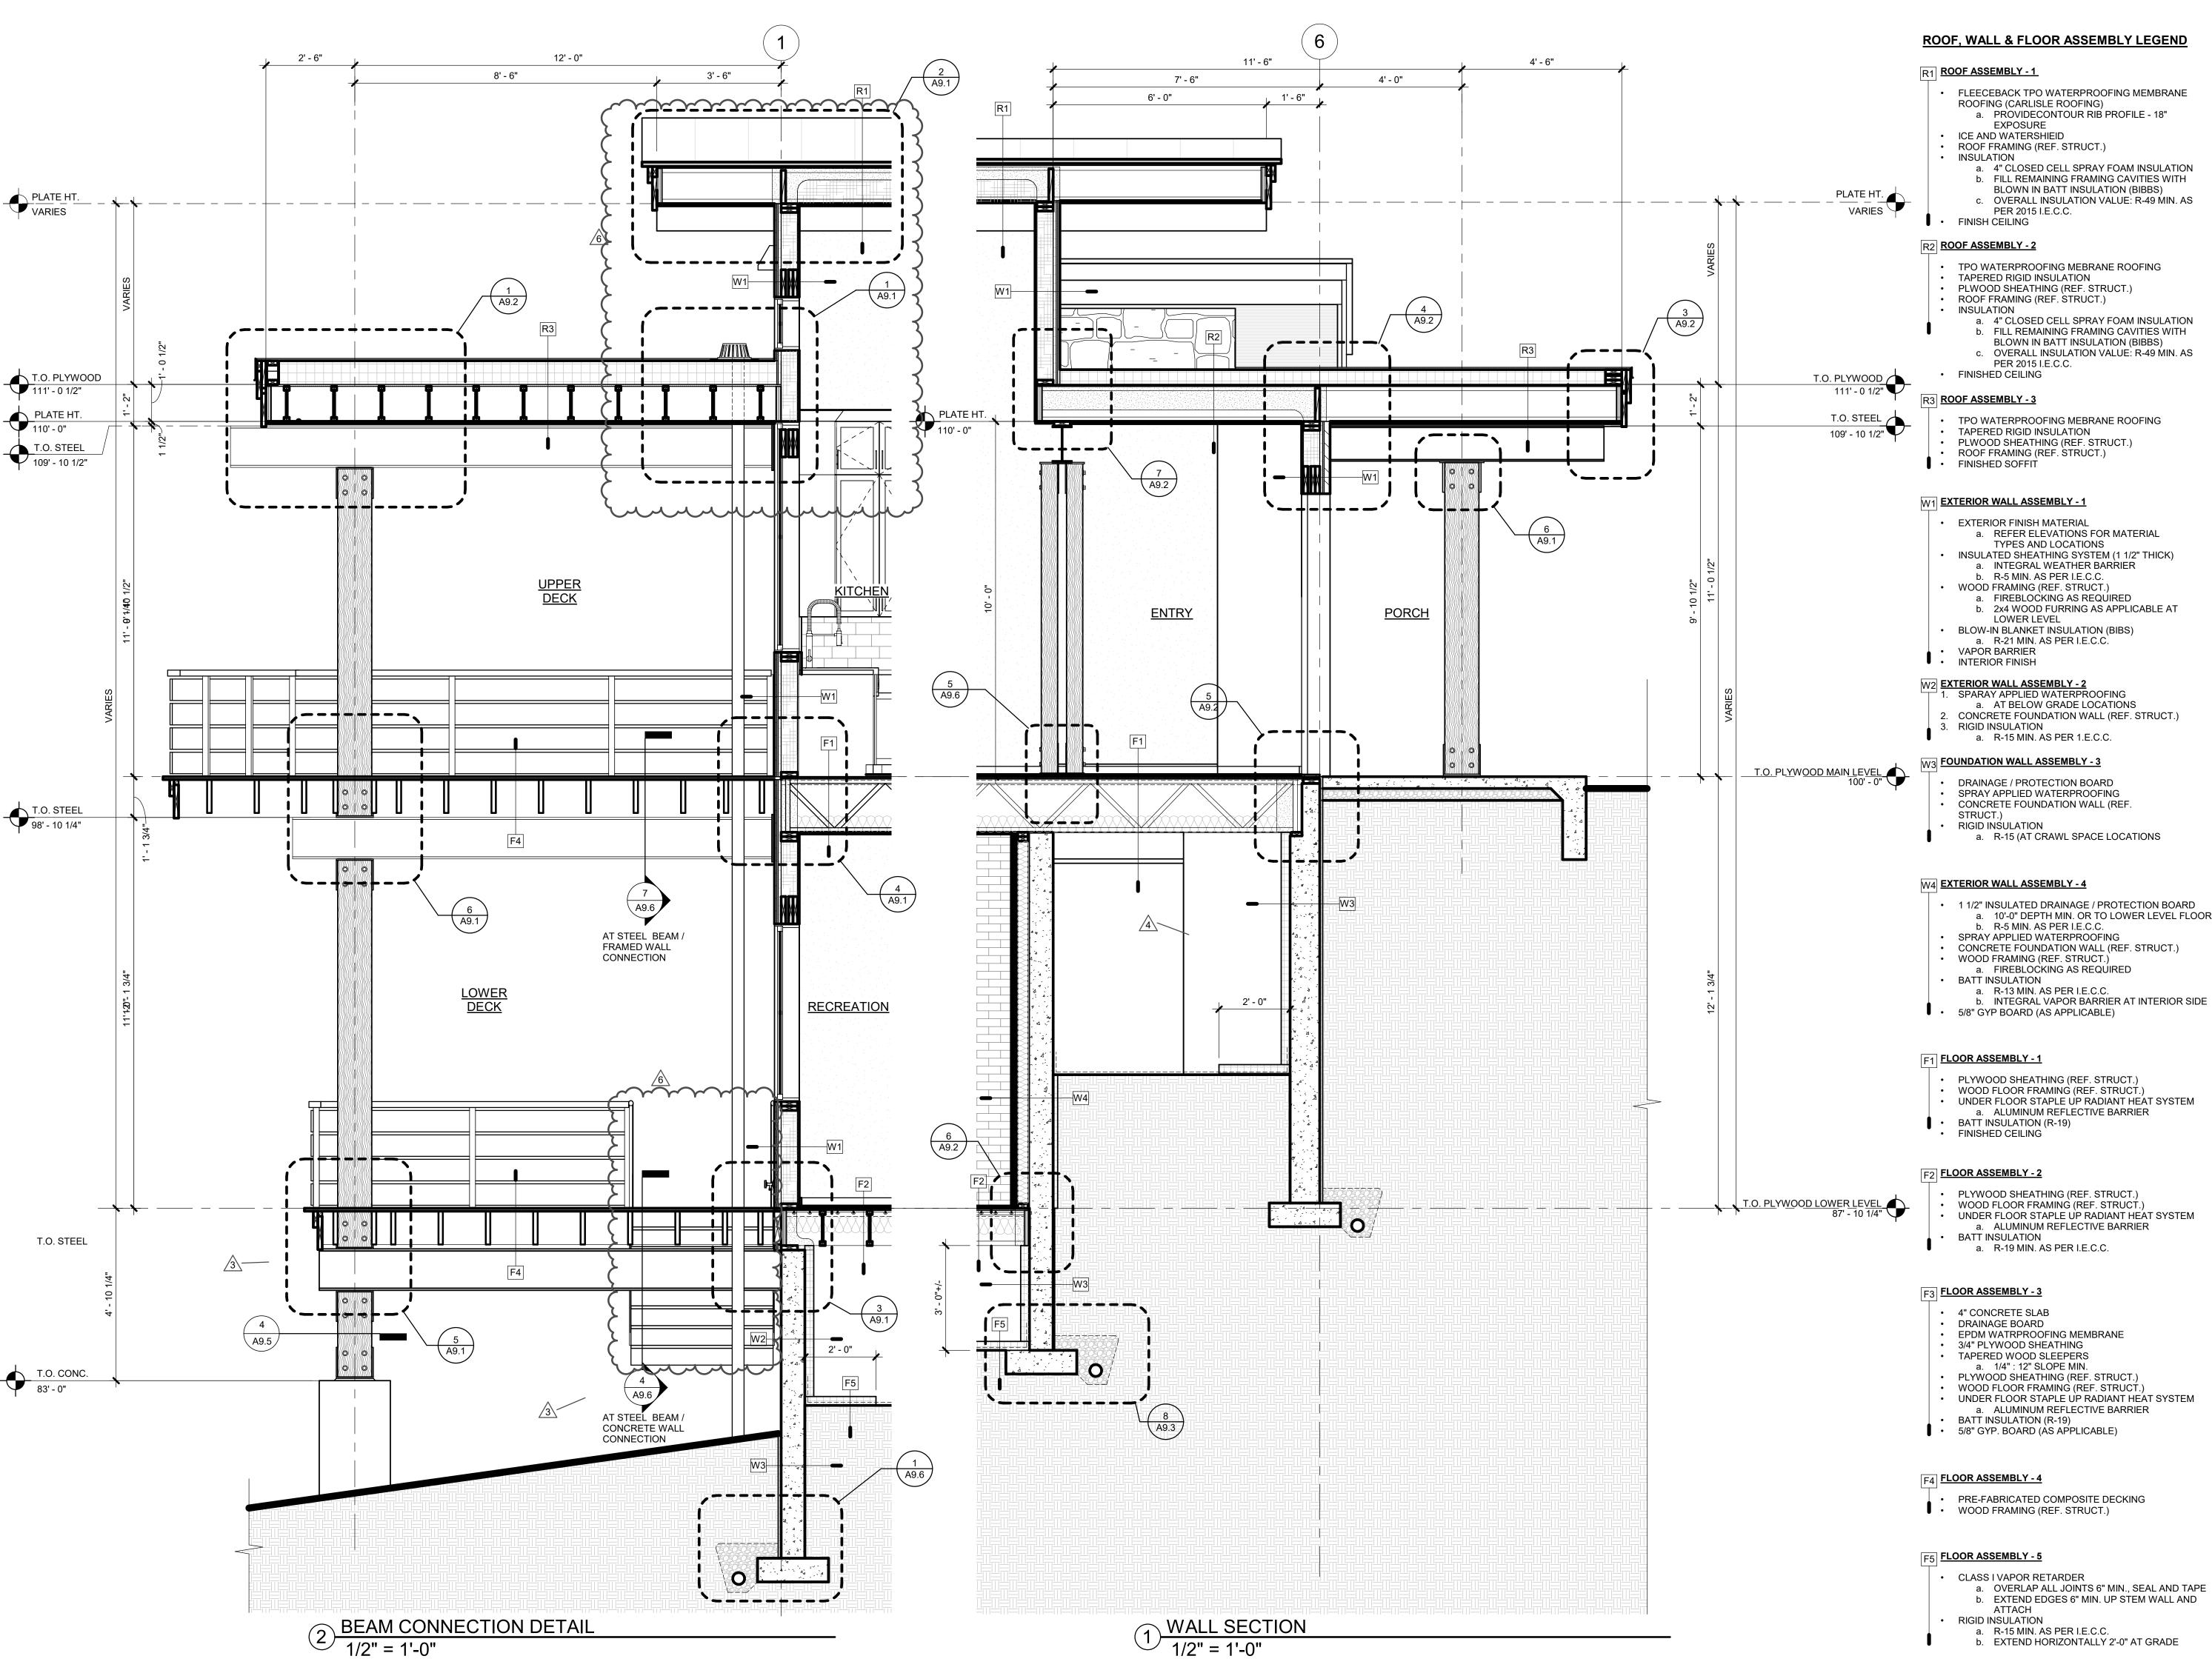



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a. AT BELOW GRADE LOCATIONS 2. CONCRETE FOUNDATION WALL (REF. STRUCT.)

- DRAINAGE / PROTECTION BOARD SPRAY APPLIED WATERPROOFING
- a. R-15 (AT CRAWL SPACE LOCATIONS

# W4 EXTERIOR WALL ASSEMBLY - 4

- 1 1/2" INSULATED DRAINAGE / PROTECTION BOARD a. 10'-0" DEPTH MIN. OR TO LOWER LEVEL FLOOR
- CONCRETE FOUNDATION WALL (REF. STRUCT.)
- a. FIREBLOCKING AS REQUIRED
- PLYWOOD SHEATHING (REF. STRUCT.) WOOD FLOOR FRAMING (REF. STRUCT.) UNDER FLOOR STAPLE UP RADIANT HEAT SYSTEM
- PLYWOOD SHEATHING (REF. STRUCT.)
- UNDER FLOOR STAPLE UP RADIANT HEAT SYSTEM a. ALUMINUM REFLECTIVE BARRIER

- EPDM WATRPROOFING MEMBRANE
- PLYWOOD SHEATHING (REF. STRUCT.) WOOD FLOOR FRAMING (REF. STRUCT.)
- BATT INSULATION (R-19)


PRE-FABRICATED COMPOSITE DECKING

- CLASS I VAPOR RETARDER a. OVERLAP ALL JOINTS 6" MIN., SEAL AND TAPE b. EXTEND EDGES 6" MIN. UP STEM WALL AND

  - a. R-15 MIN. AS PER I.E.C.C.b. EXTEND HORIZONTALLY 2'-0" AT GRADE

SSUE NAME | DATE BUILDING PERMIT 08.23.2019
PERMIT RE-SUBMITTAL 09.25.2019 DRAWING TITLE WALL SECTIONS

SHEET NO.

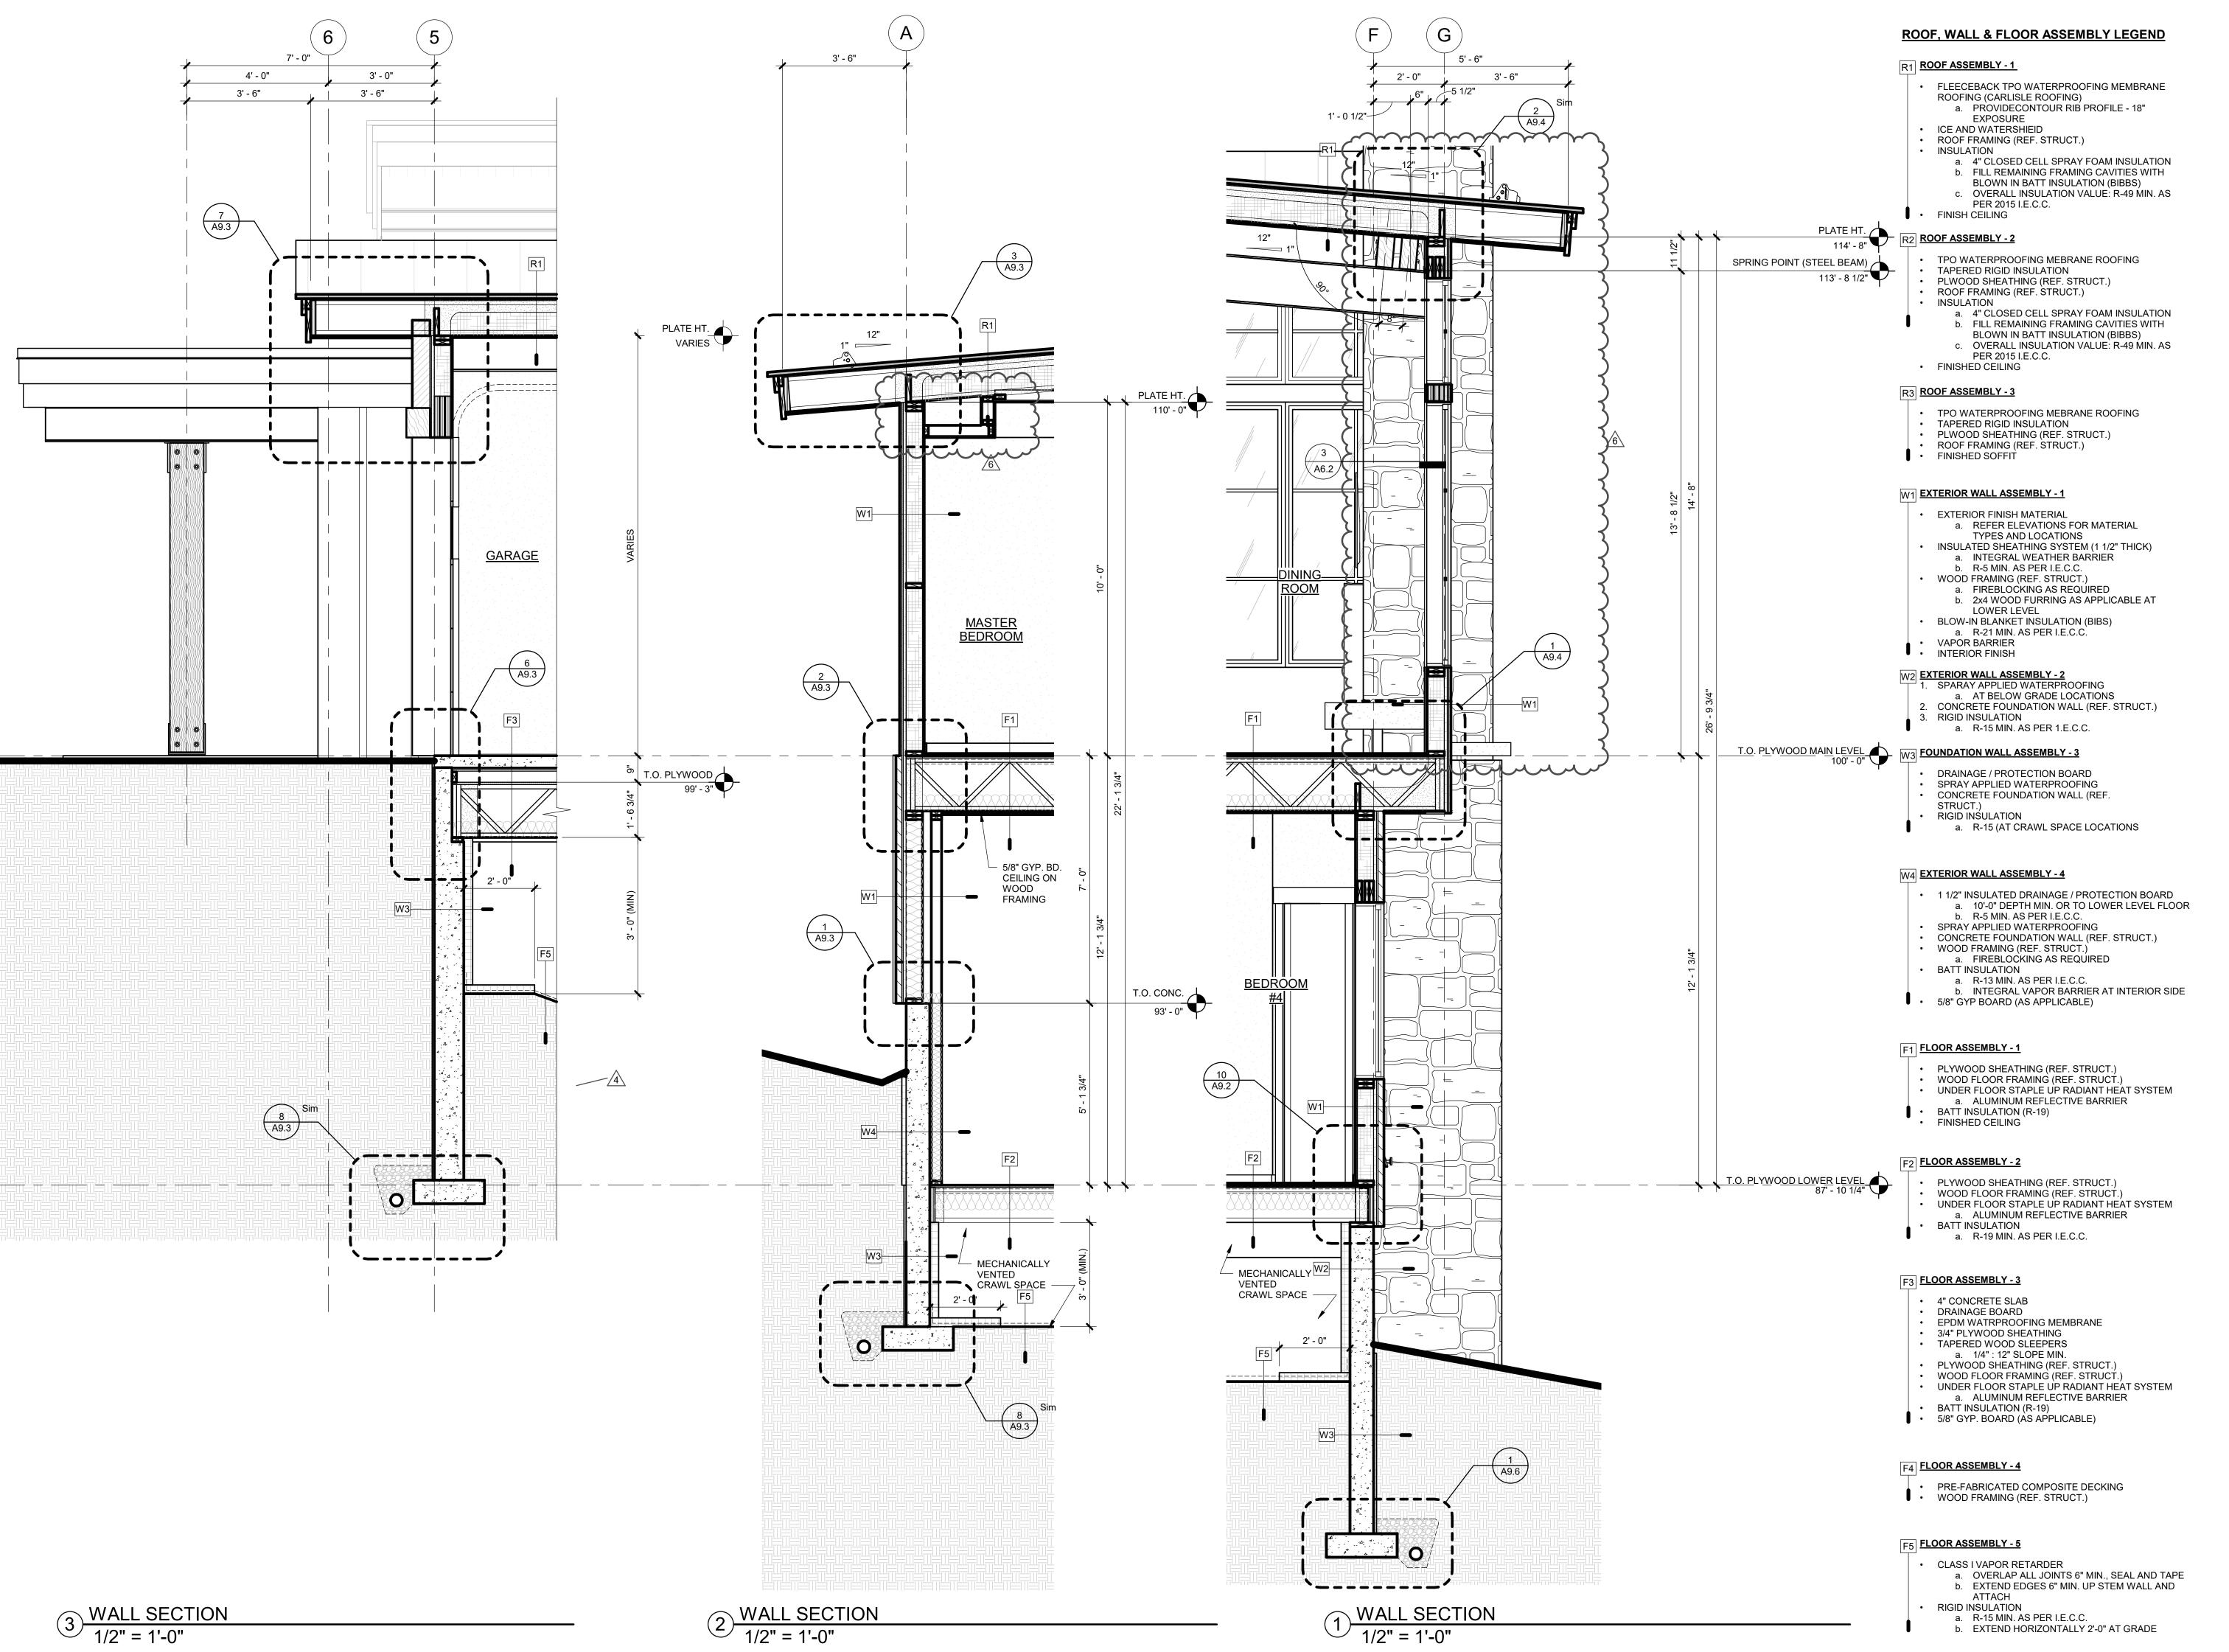

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**AMPBE** 


ISSUE NAME | DATE

BUILDING PERMIT 08.23.2019
PERMIT RE-SUBMITTAL 09.25.2019

DRAWING TITLE

WALL SECTIONS


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SS

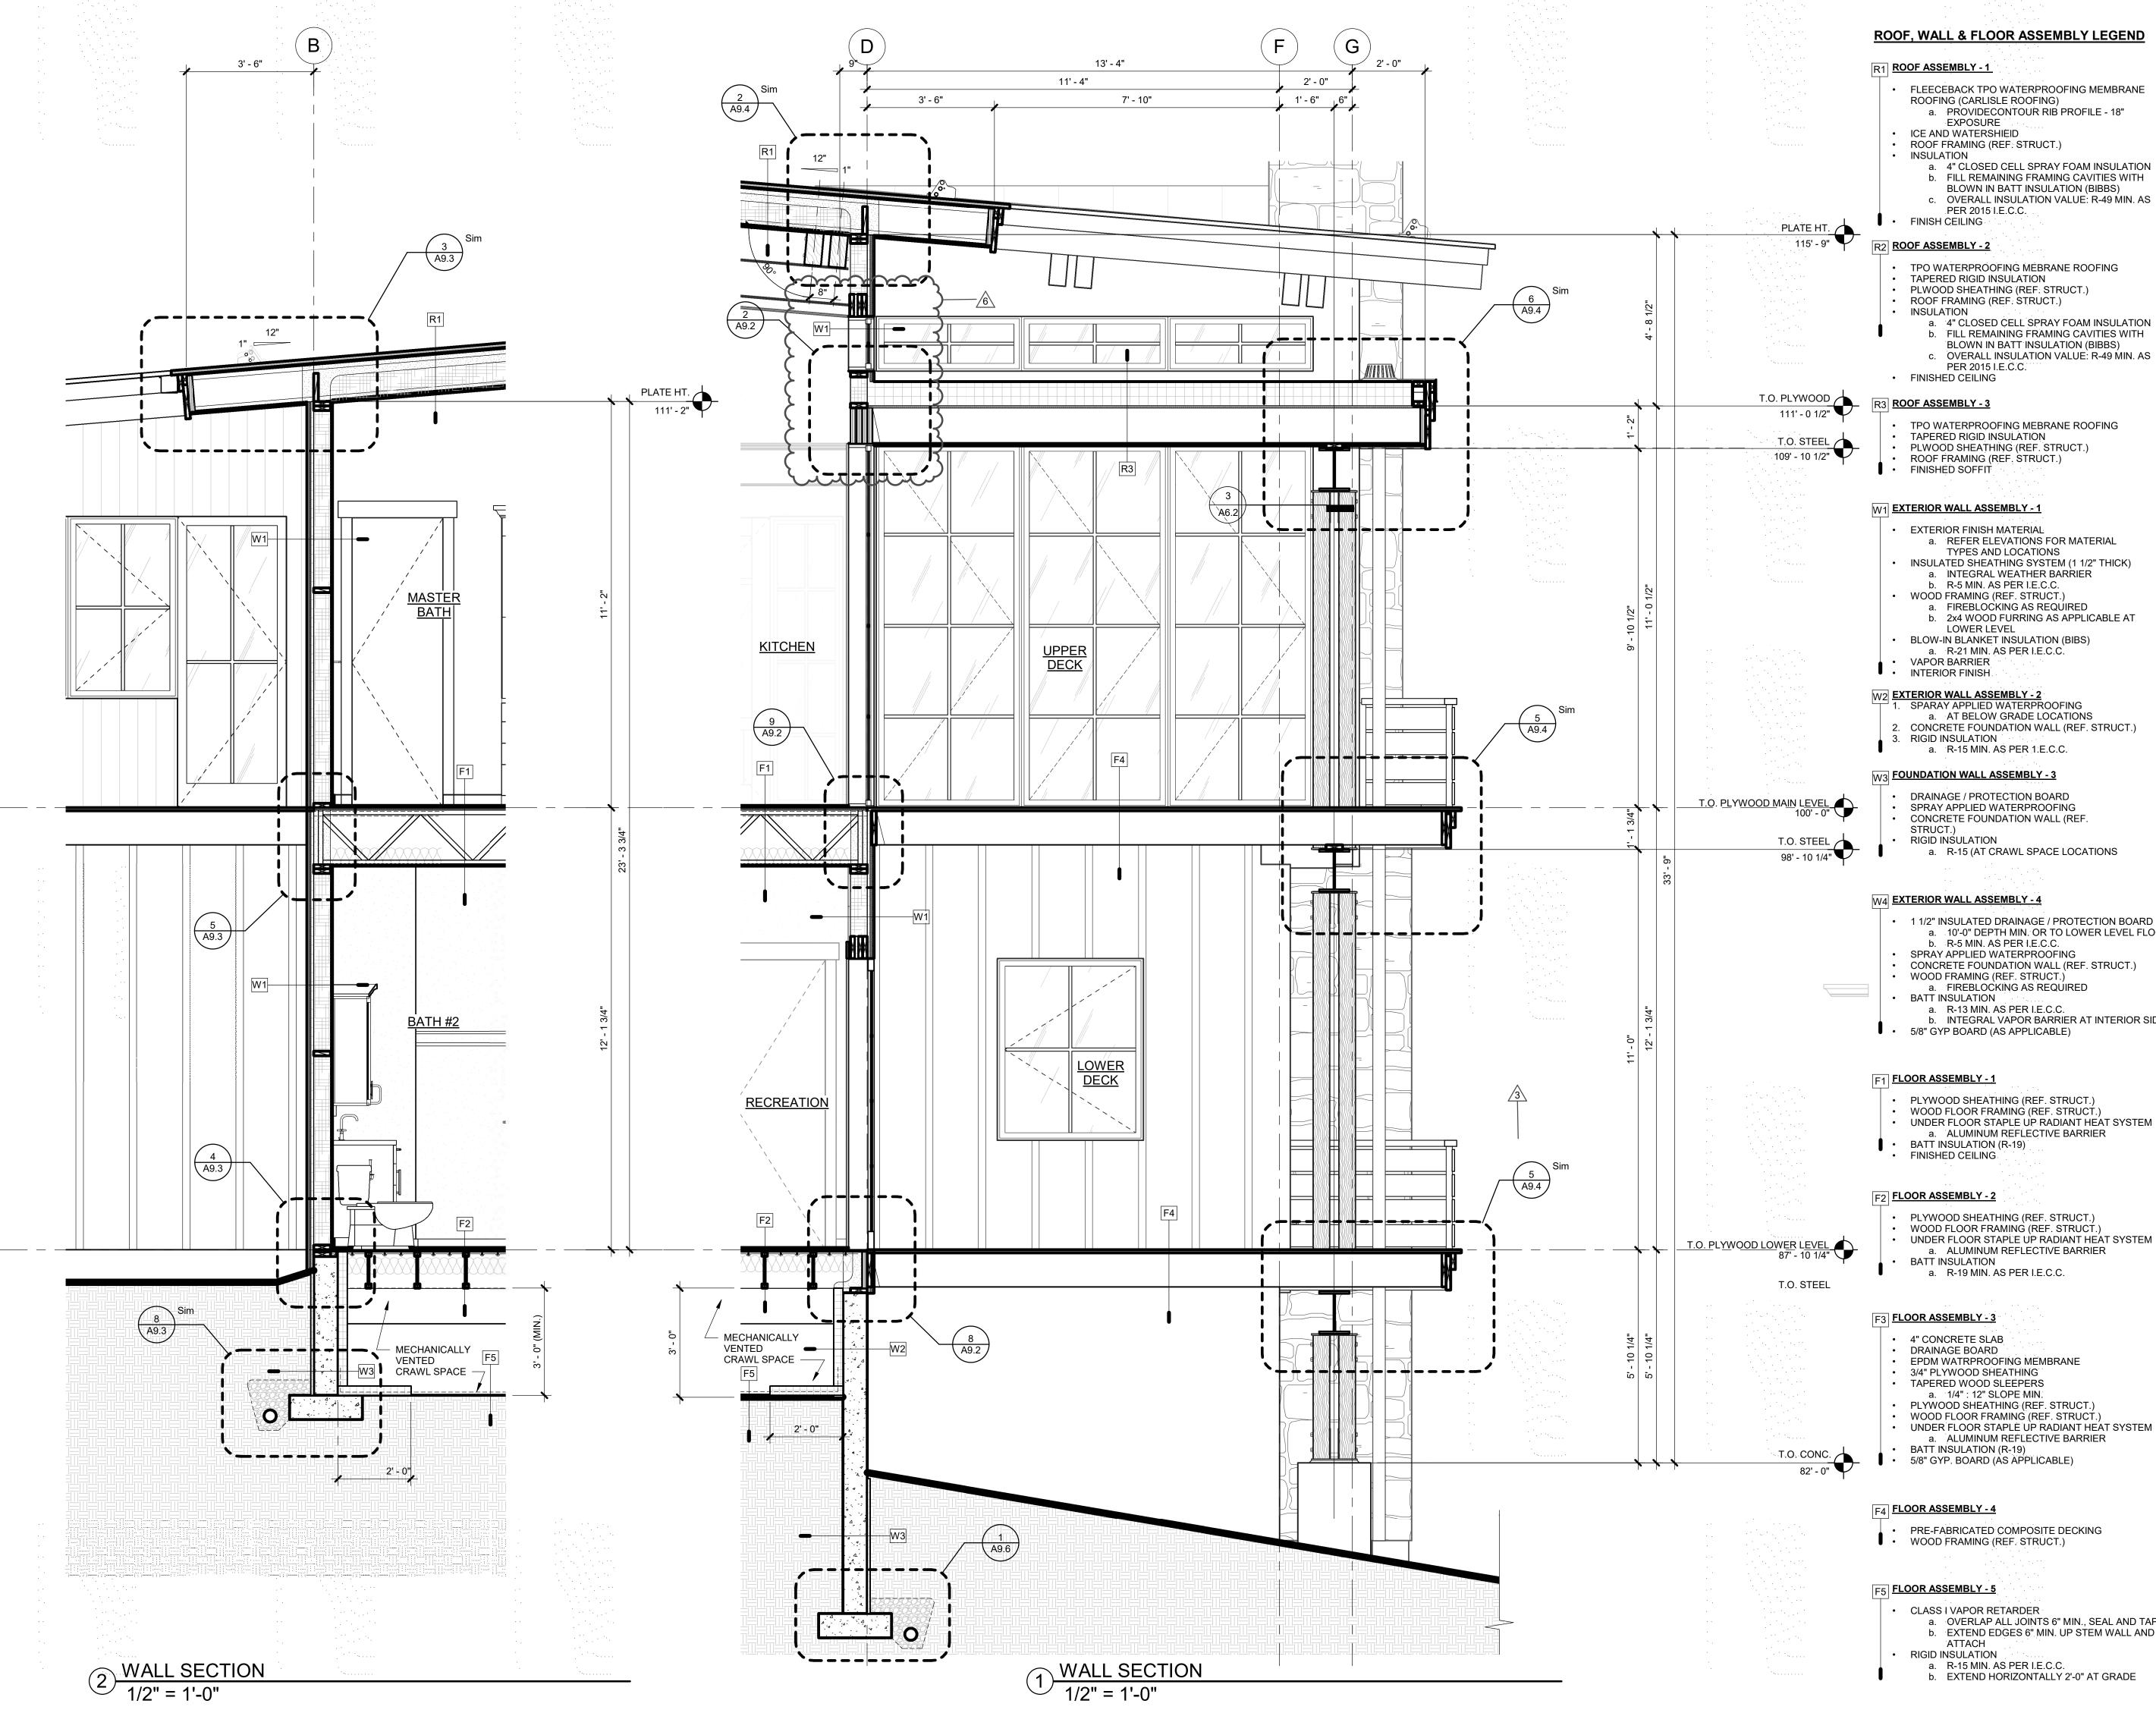**AMPBE** 

2. CONCRETE FOUNDATION WALL (REF. STRUCT.) RIGID INSULATION a. R-15 MIN. AS PER 1.E.C.C.

## W3 FOUNDATION WALL ASSEMBLY - 3

- DRAINAGE / PROTECTION BOARD SPRAY APPLIED WATERPROOFING CONCRETE FOUNDATION WALL (REF.
- RIGID INSULATION a. R-15 (AT CRAWL SPACE LOCATIONS

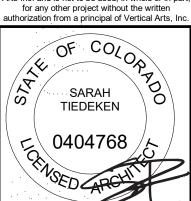- 1 1/2" INSULATED DRAINAGE / PROTECTION BOARD
   a. 10'-0" DEPTH MIN. OR TO LOWER LEVEL FLOOR b. R-5 MIN. AS PER I.E.C.C. SPRAY APPLIED WATERPROOFINGCONCRETE FOUNDATION WALL (REF. STRUCT.)
- WOOD FRAMING (REF. STRUCT.) a. FIREBLOCKING AS REQUIRED
- a. R-13 MIN. AS PER I.E.C.C.b. INTEGRAL VAPOR BARRIER AT INTERIOR SIDE • 5/8" GYP BOARD (AS APPLICABLE)

 PLYWOOD SHEATHING (REF. STRUCT.) WOOD FLOOR FRAMING (REF. STRUCT.) UNDER FLOOR STAPLE UP RADIANT HEAT SYSTEM a. ALUMINUM REFLECTIVE BARRIER

• PLYWOOD SHEATHING (REF. STRUCT.) WOOD FLOOR FRAMING (REF. STRUCT.) UNDER FLOOR STAPLE UP RADIANT HEAT SYSTEM
 a. ALUMINUM REFLECTIVE BARRIER


- EPDM WATRPROOFING MEMBRANE3/4" PLYWOOD SHEATHING
- a. 1/4" : 12" SLOPE MIN. PLYWOOD SHEATHING (REF. STRUCT.) WOOD FLOOR FRAMING (REF. STRUCT.) UNDER FLOOR STAPLE UP RADIANT HEAT SYSTEM

- - a. OVERLAP ALL JOINTS 6" MIN., SEAL AND TAPE b. EXTEND EDGES 6" MIN. UP STEM WALL AND
- a. R-15 MIN. AS PER I.E.C.C.

DRAWING TITLE WALL SECTIONS SHEET NO. A5.3

ISSUE NAME │ DATE

VE REVISIONS

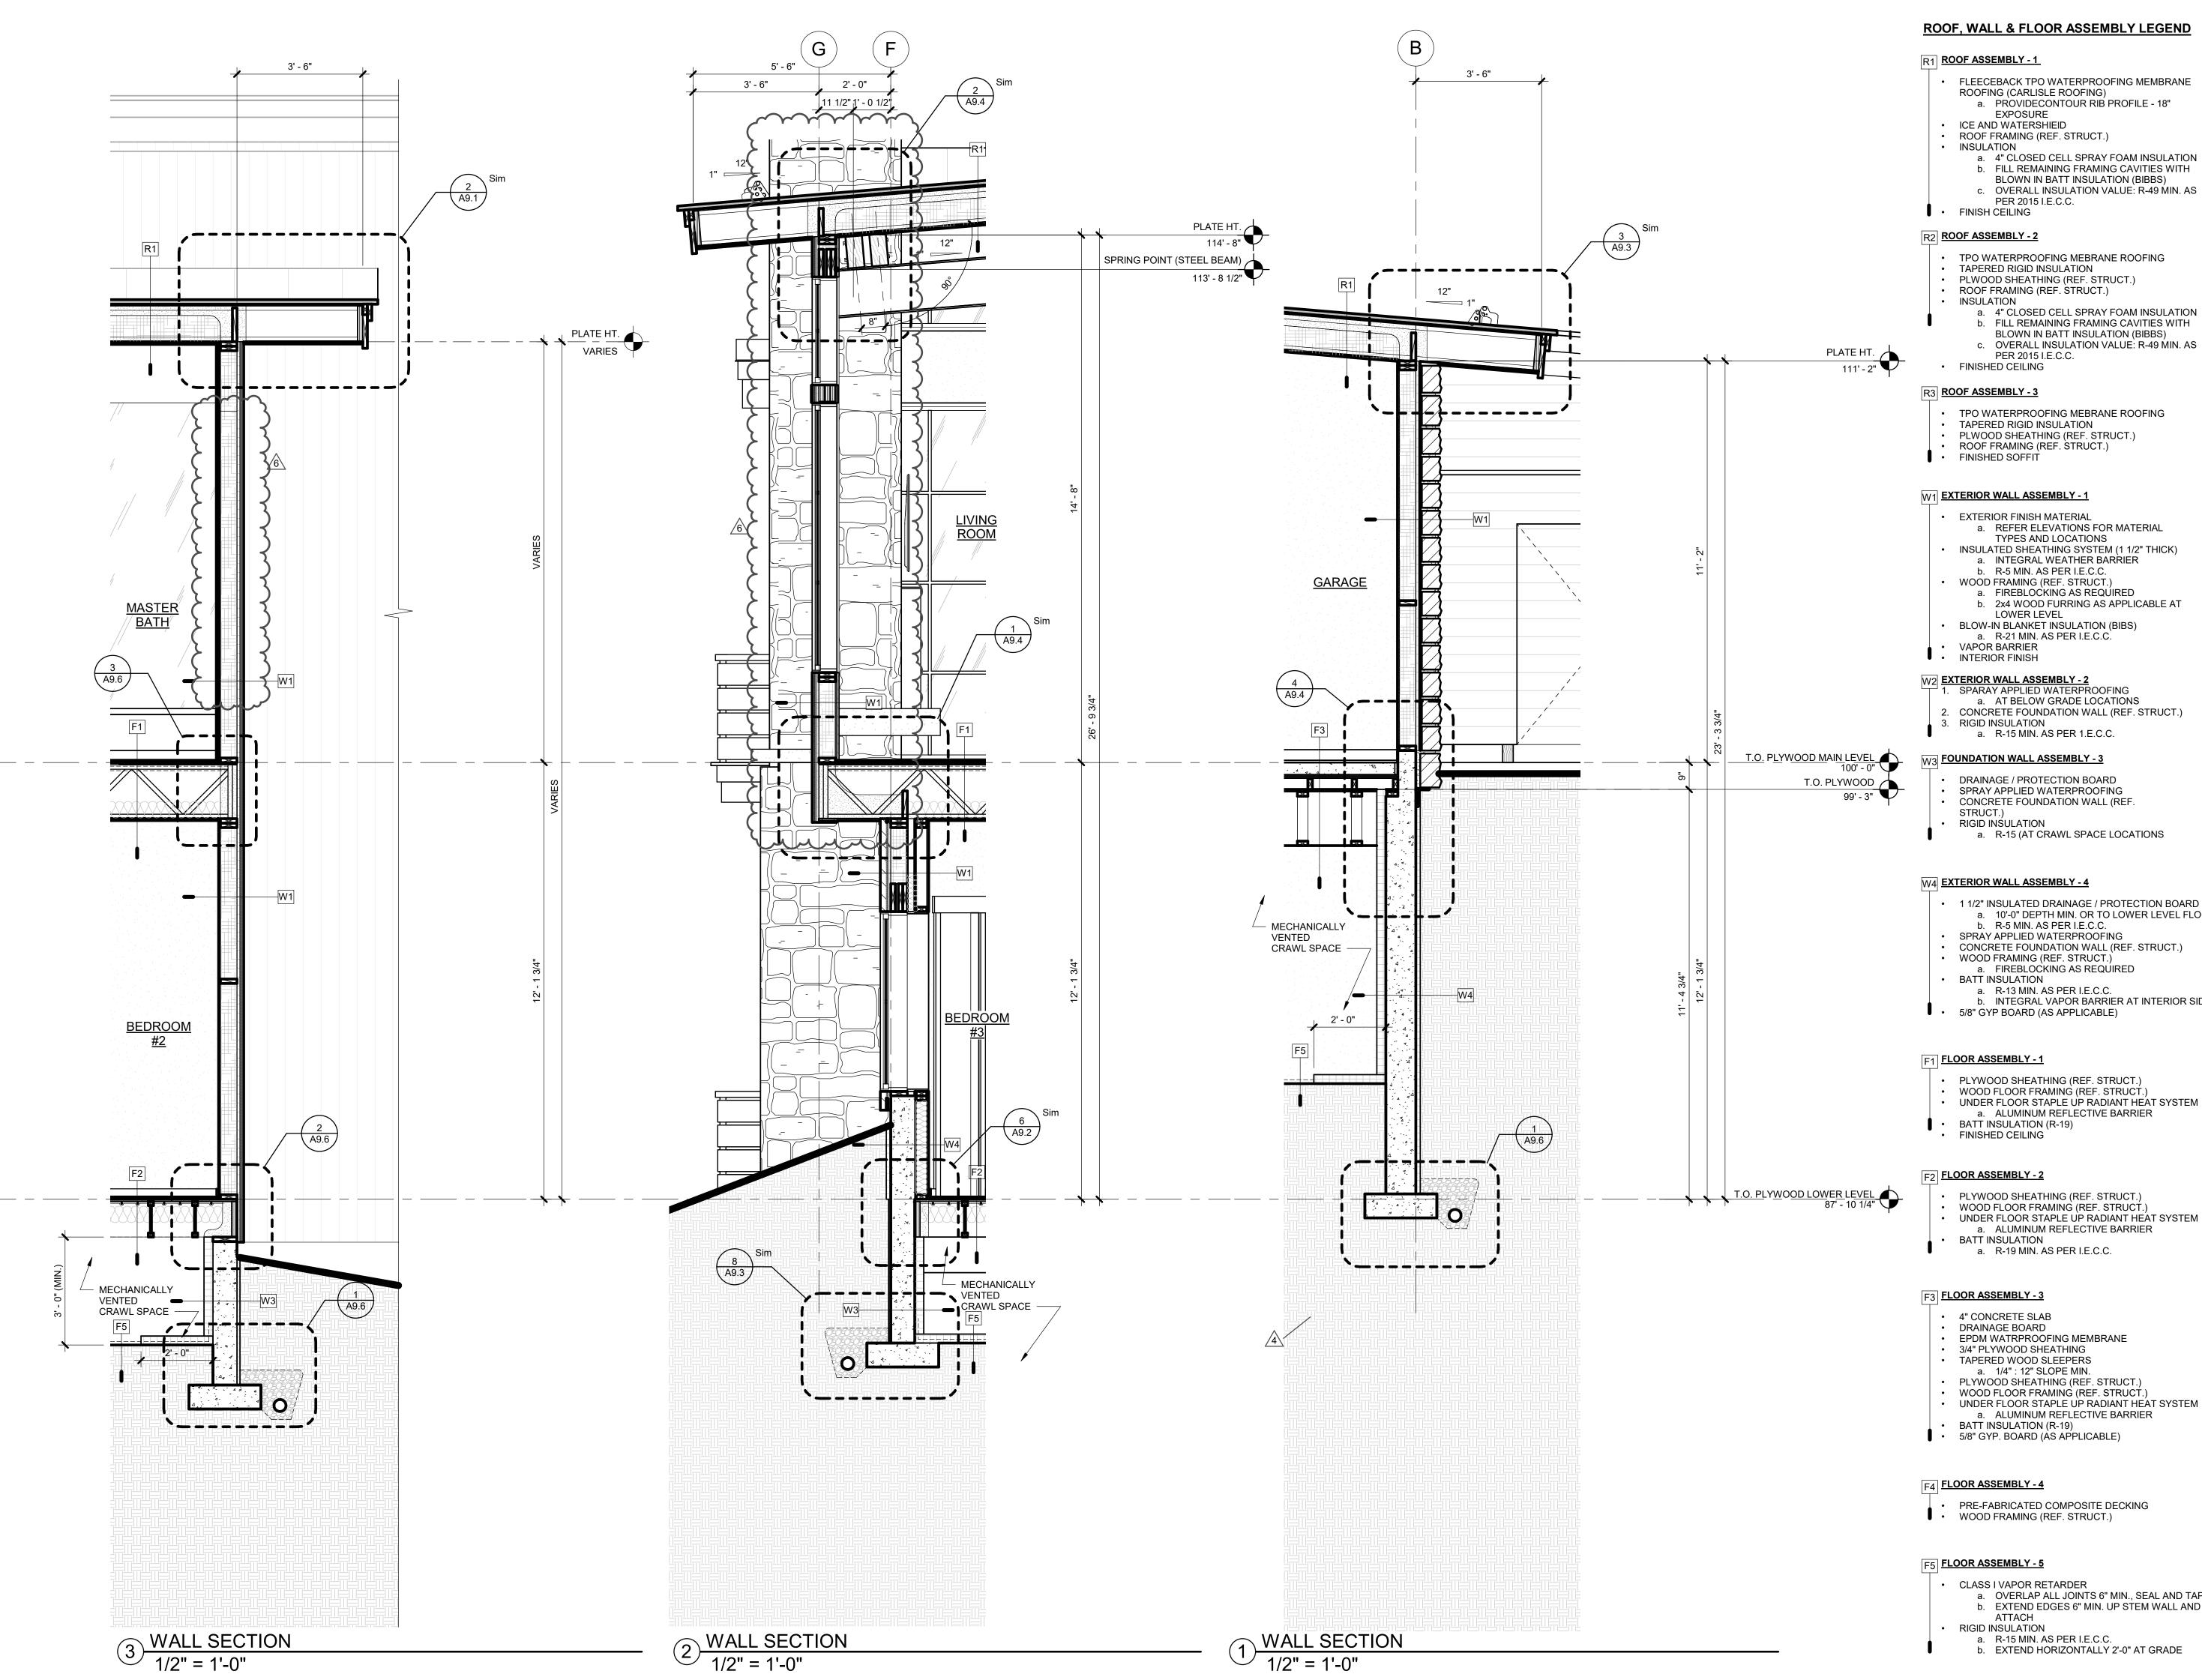



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a. R-15 MIN. AS PER 1.E.C.C.

# W3 FOUNDATION WALL ASSEMBLY - 3

DRAINAGE / PROTECTION BOARD SPRAY APPLIED WATERPROOFING CONCRETE FOUNDATION WALL (REF.

RIGID INSULATION a. R-15 (AT CRAWL SPACE LOCATIONS

• 1 1/2" INSULATED DRAINAGE / PROTECTION BOARD a. 10'-0" DEPTH MIN. OR TO LOWER LEVEL FLOOR

b. R-5 MIN. AS PER I.E.C.C. SPRAY APPLIED WATERPROOFING • CONCRETE FOUNDATION WALL (REF. STRUCT.) WOOD FRAMING (REF. STRUCT.) a. FIREBLOCKING AS REQUIRED

a. R-13 MIN. AS PER I.E.C.C.b. INTEGRAL VAPOR BARRIER AT INTERIOR SIDE

 PLYWOOD SHEATHING (REF. STRUCT.) WOOD FLOOR FRAMING (REF. STRUCT.) a. ALUMINUM REFLECTIVE BARRIER

 UNDER FLOOR STAPLE UP RADIANT HEAT SYSTEM BATT INSULATION (R-19)

- PLYWOOD SHEATHING (REF. STRUCT.) WOOD FLOOR FRAMING (REF. STRUCT.) UNDER FLOOR STAPLE UP RADIANT HEAT SYSTEM a. ALUMINUM REFLECTIVE BARRIER
- BATT INSULATION
- 4" CONCRETE SLABDRAINAGE BOARD EPDM WATRPROOFING MEMBRANE
- 3/4" PLYWOOD SHEATHING TAPERED WOOD SLEEPERS a. 1/4": 12" SLOPE MIN.
- PLYWOOD SHEATHING (REF. STRUCT.) WOOD FLOOR FRAMING (REF. STRUCT.) UNDER FLOOR STAPLE UP RADIANT HEAT SYSTEM a. ALUMINUM REFLECTIVE BARRIER
- BATT INSULATION (R-19) 5/8" GYP. BOARD (ÀS APPLICABLE)

PRE-FABRICATED COMPOSITE DECKING


 CLASS I VAPOR RETARDER a. OVERLAP ALL JOINTS 6" MIN., SEAL AND TAPE b. EXTEND EDGES 6" MIN. UP STEM WALL AND


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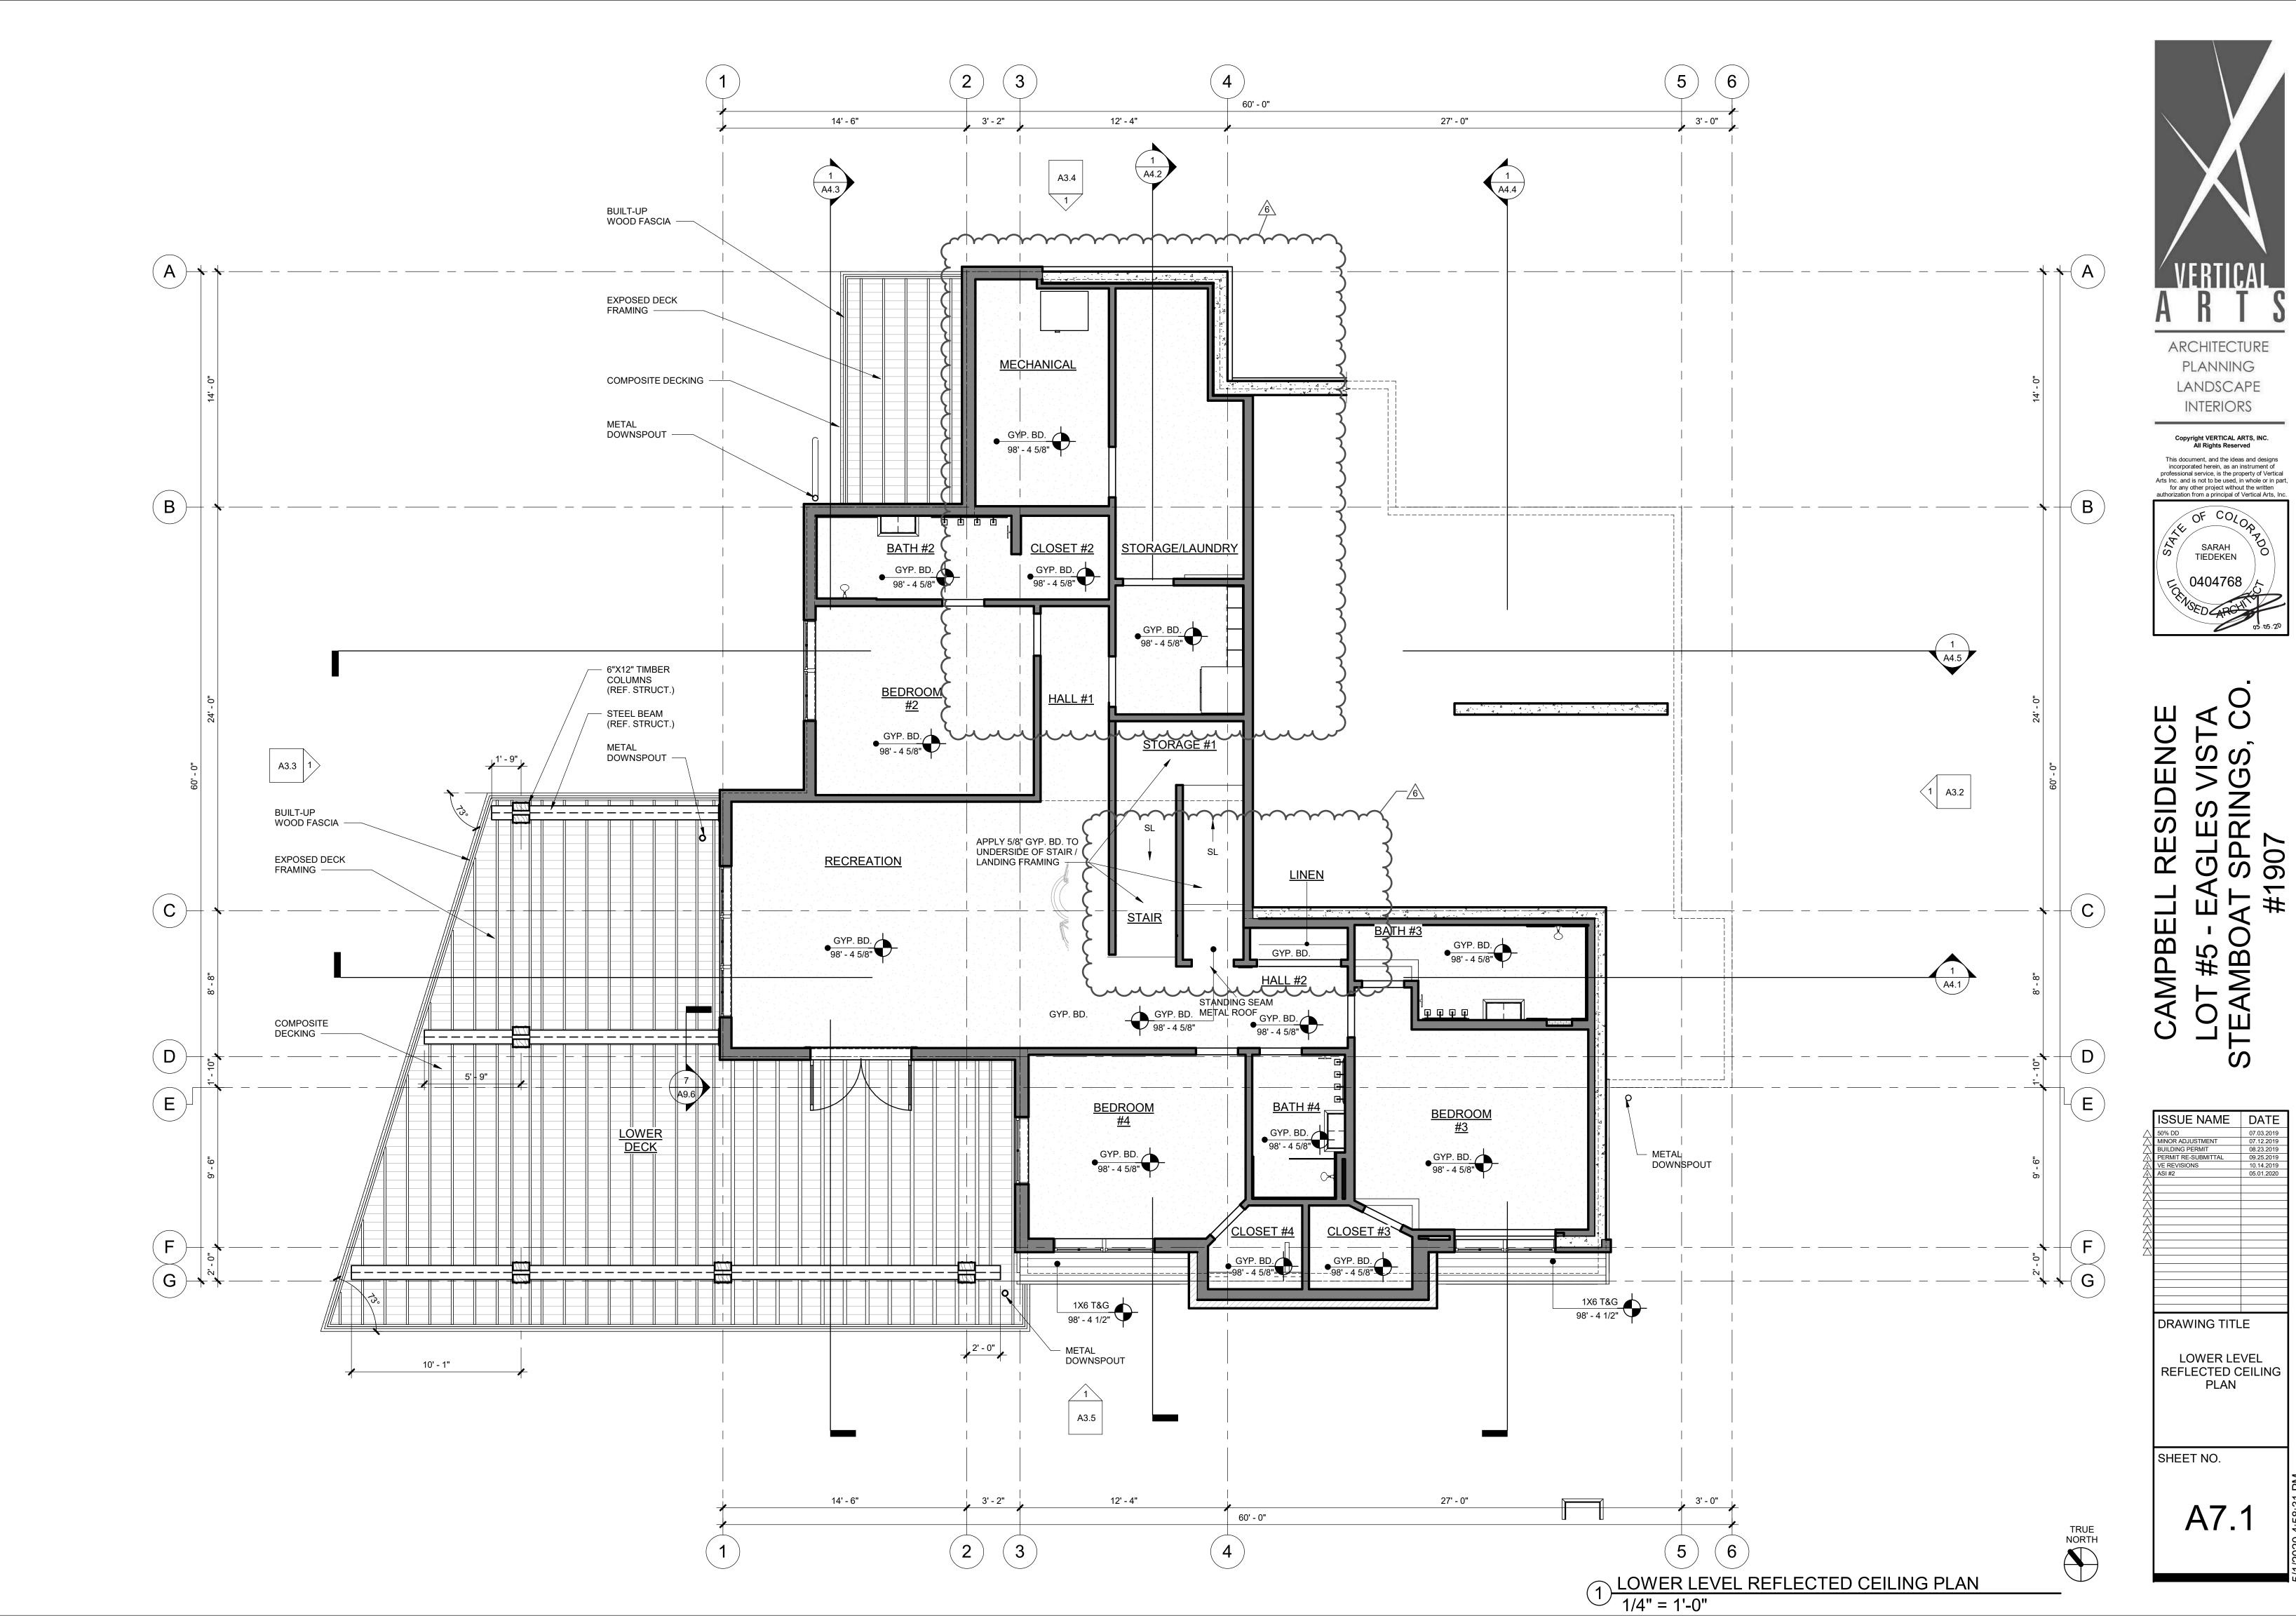
DRAWING TITLE WALL SECTIONS SHEET NO.


SSUE NAME | DATE


BUILDING PERMIT PERMIT RE-SUBMITTAL



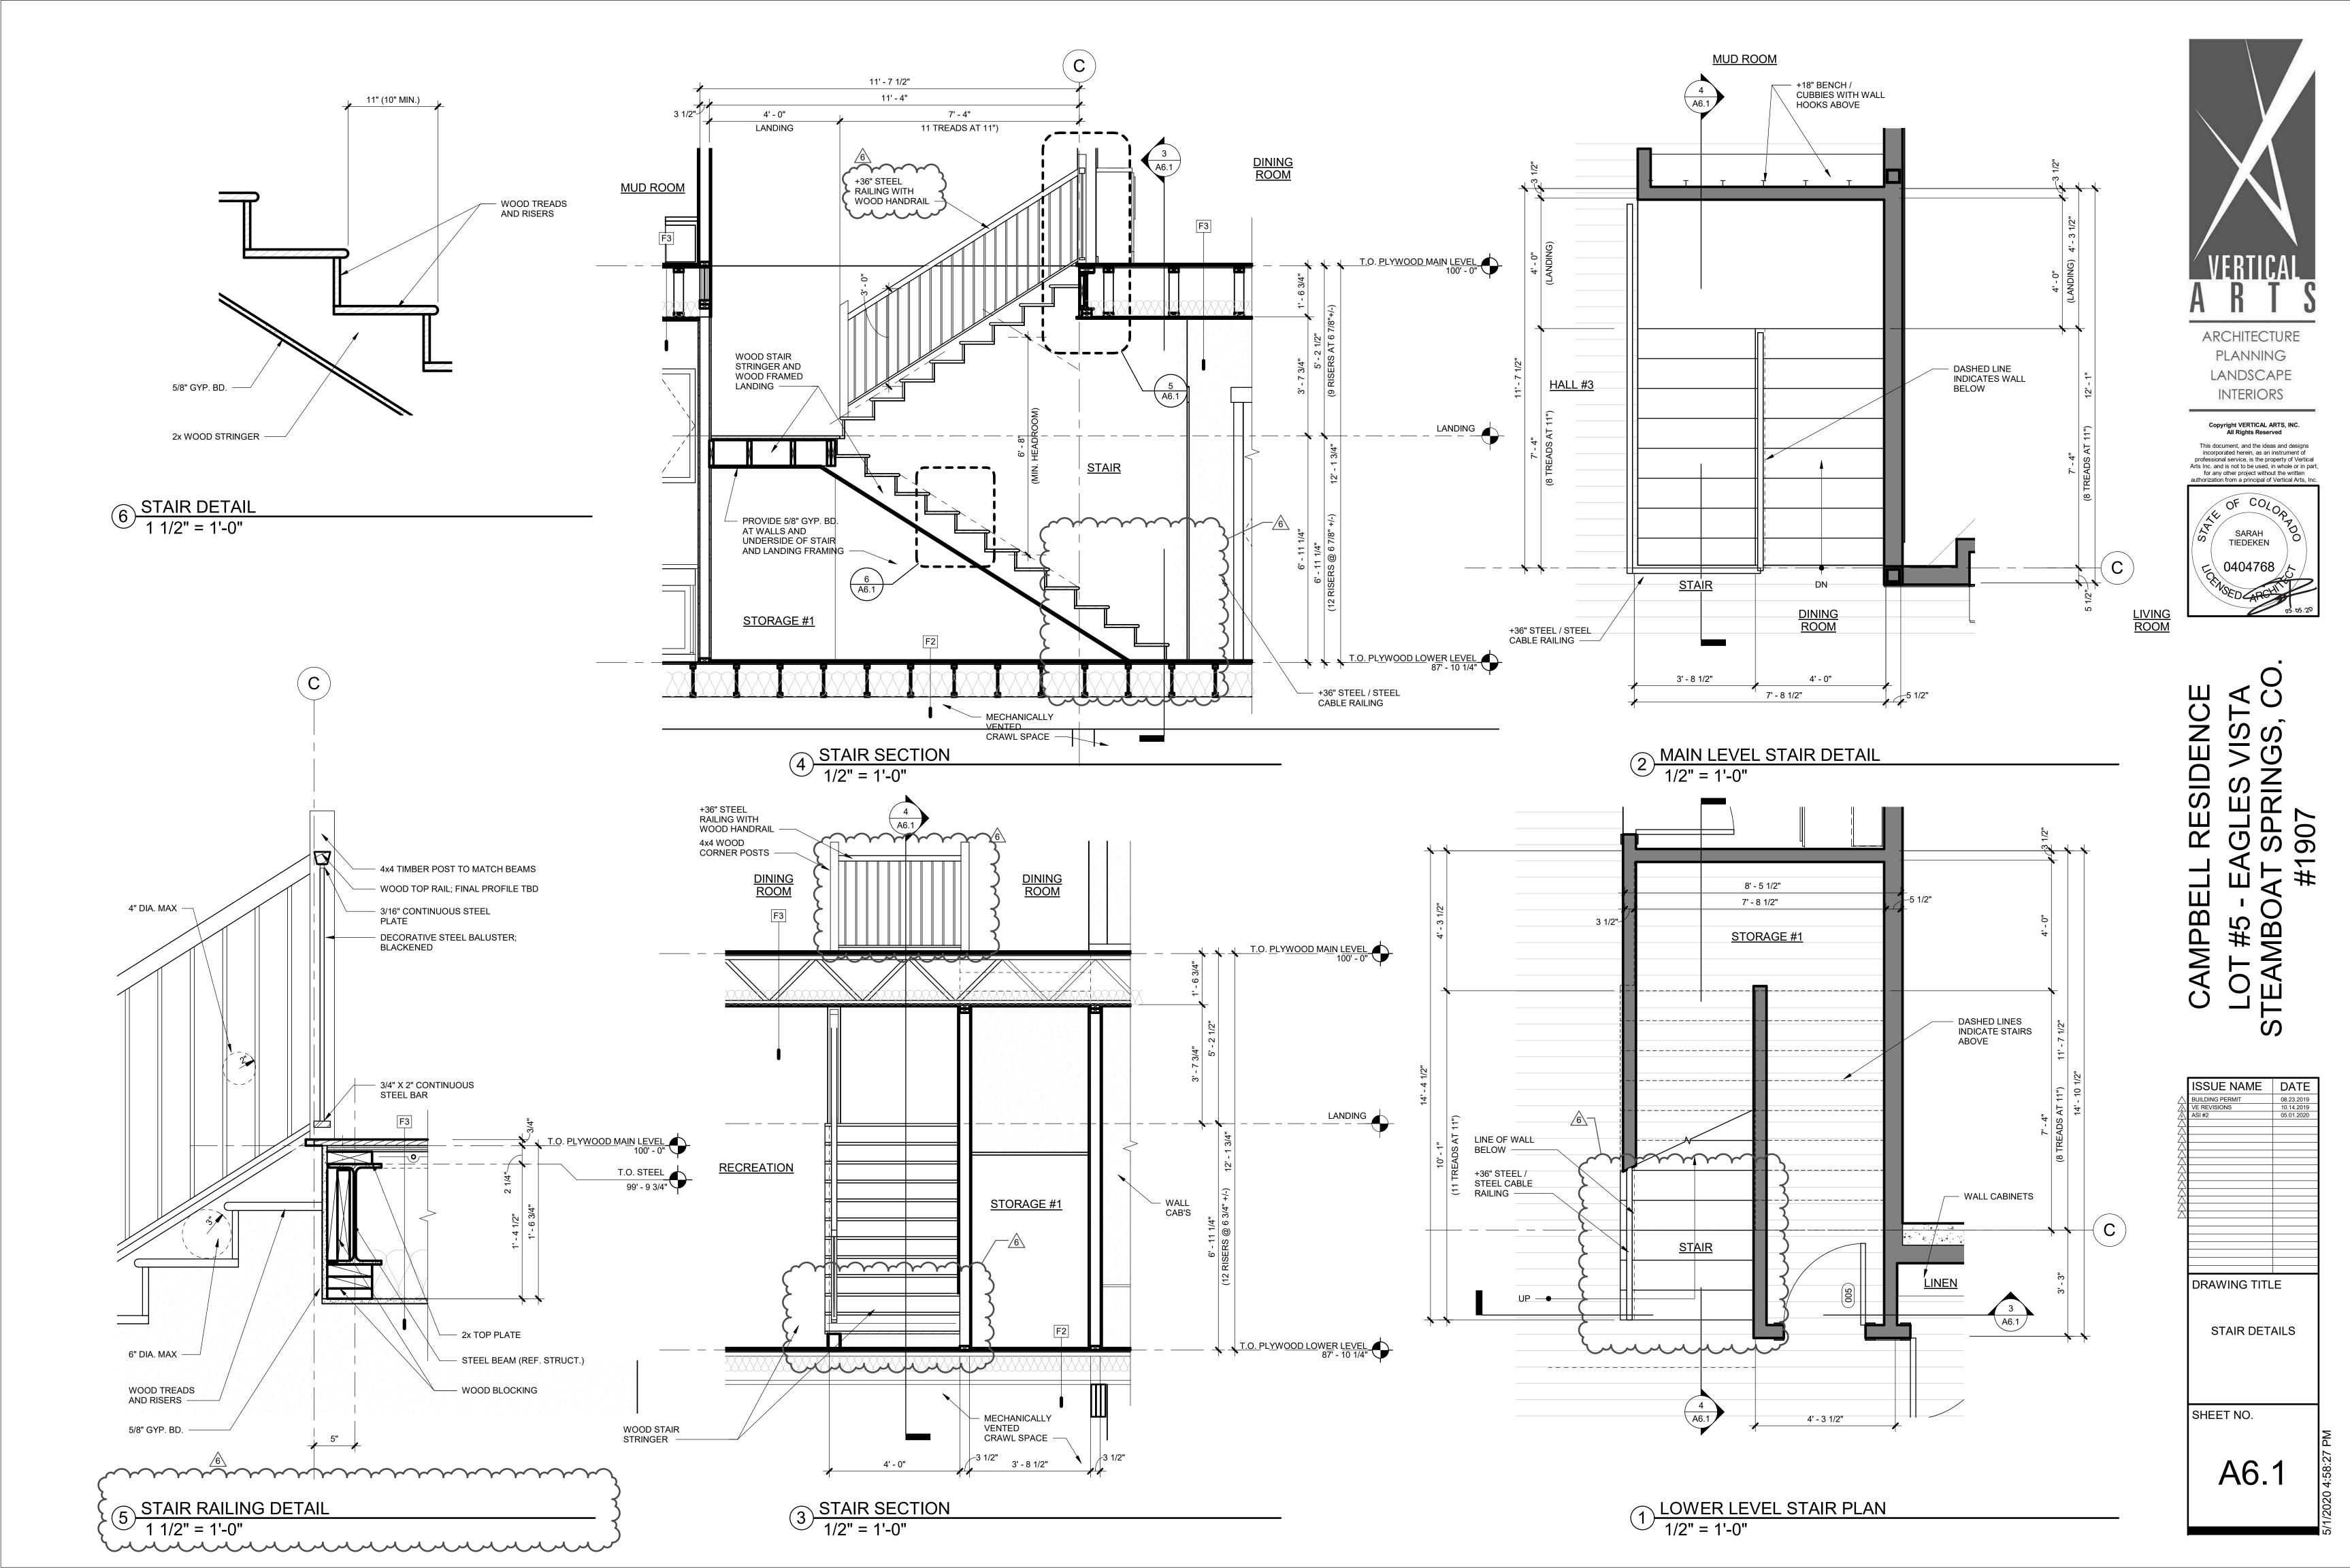

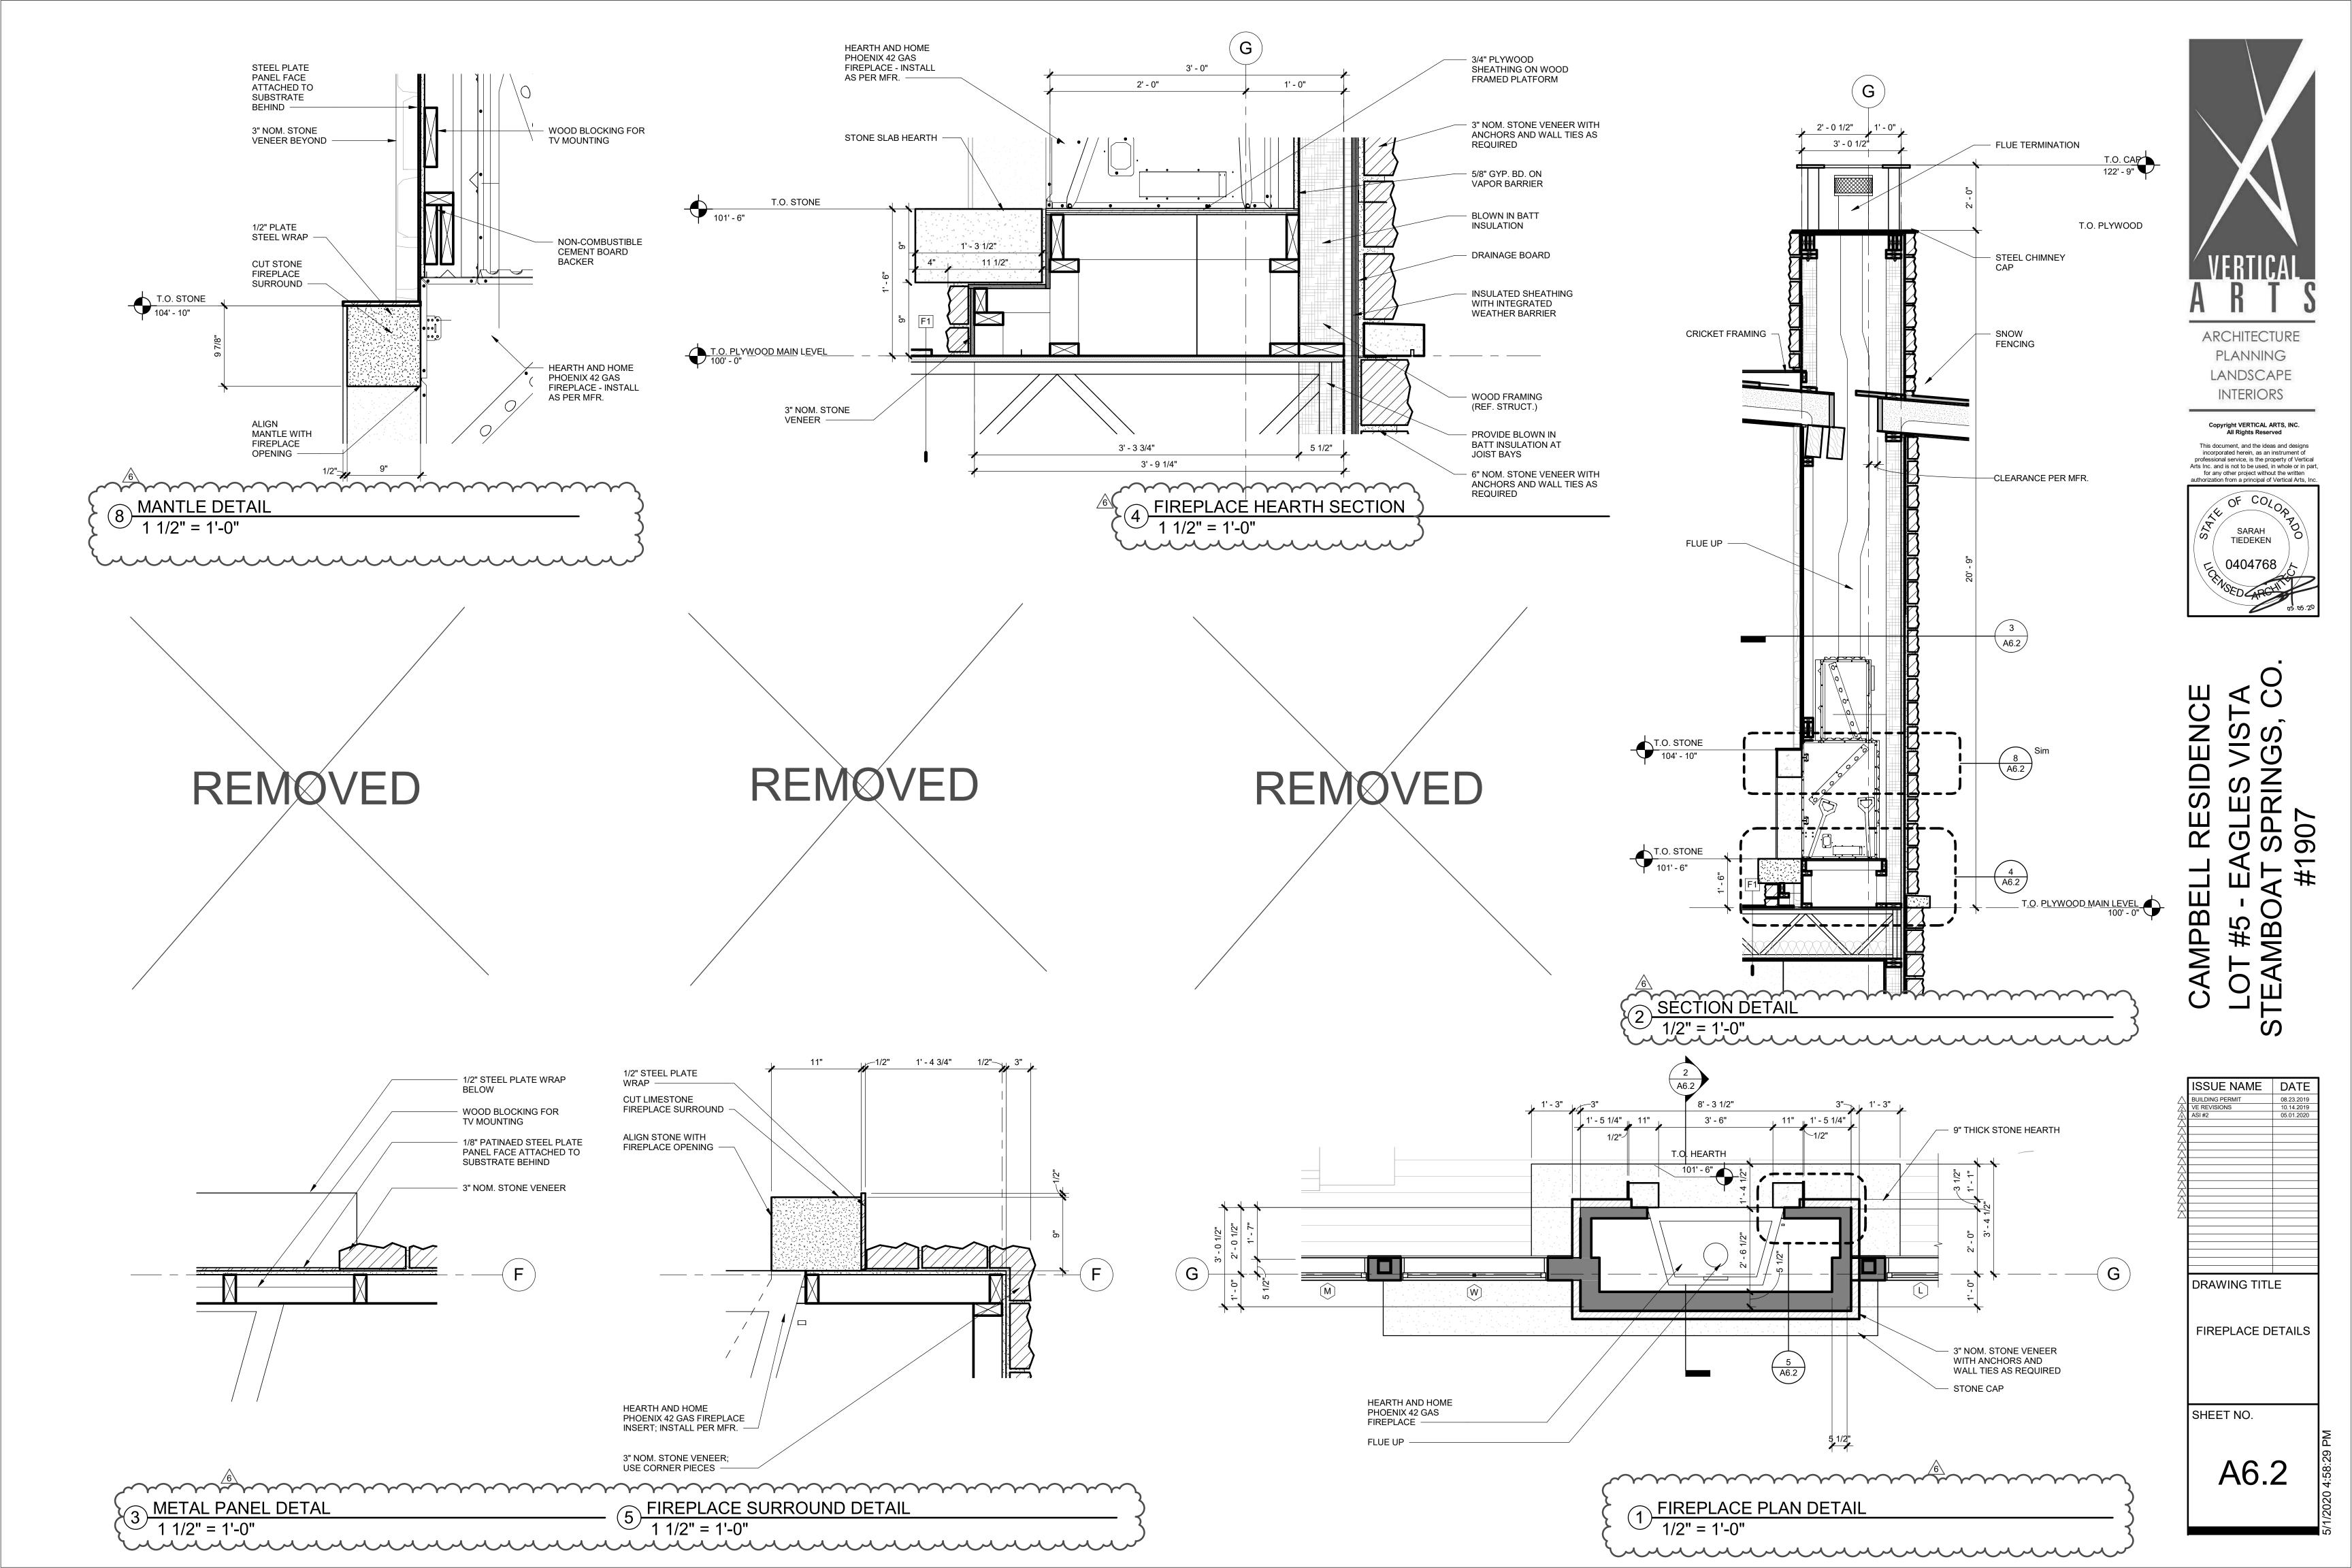

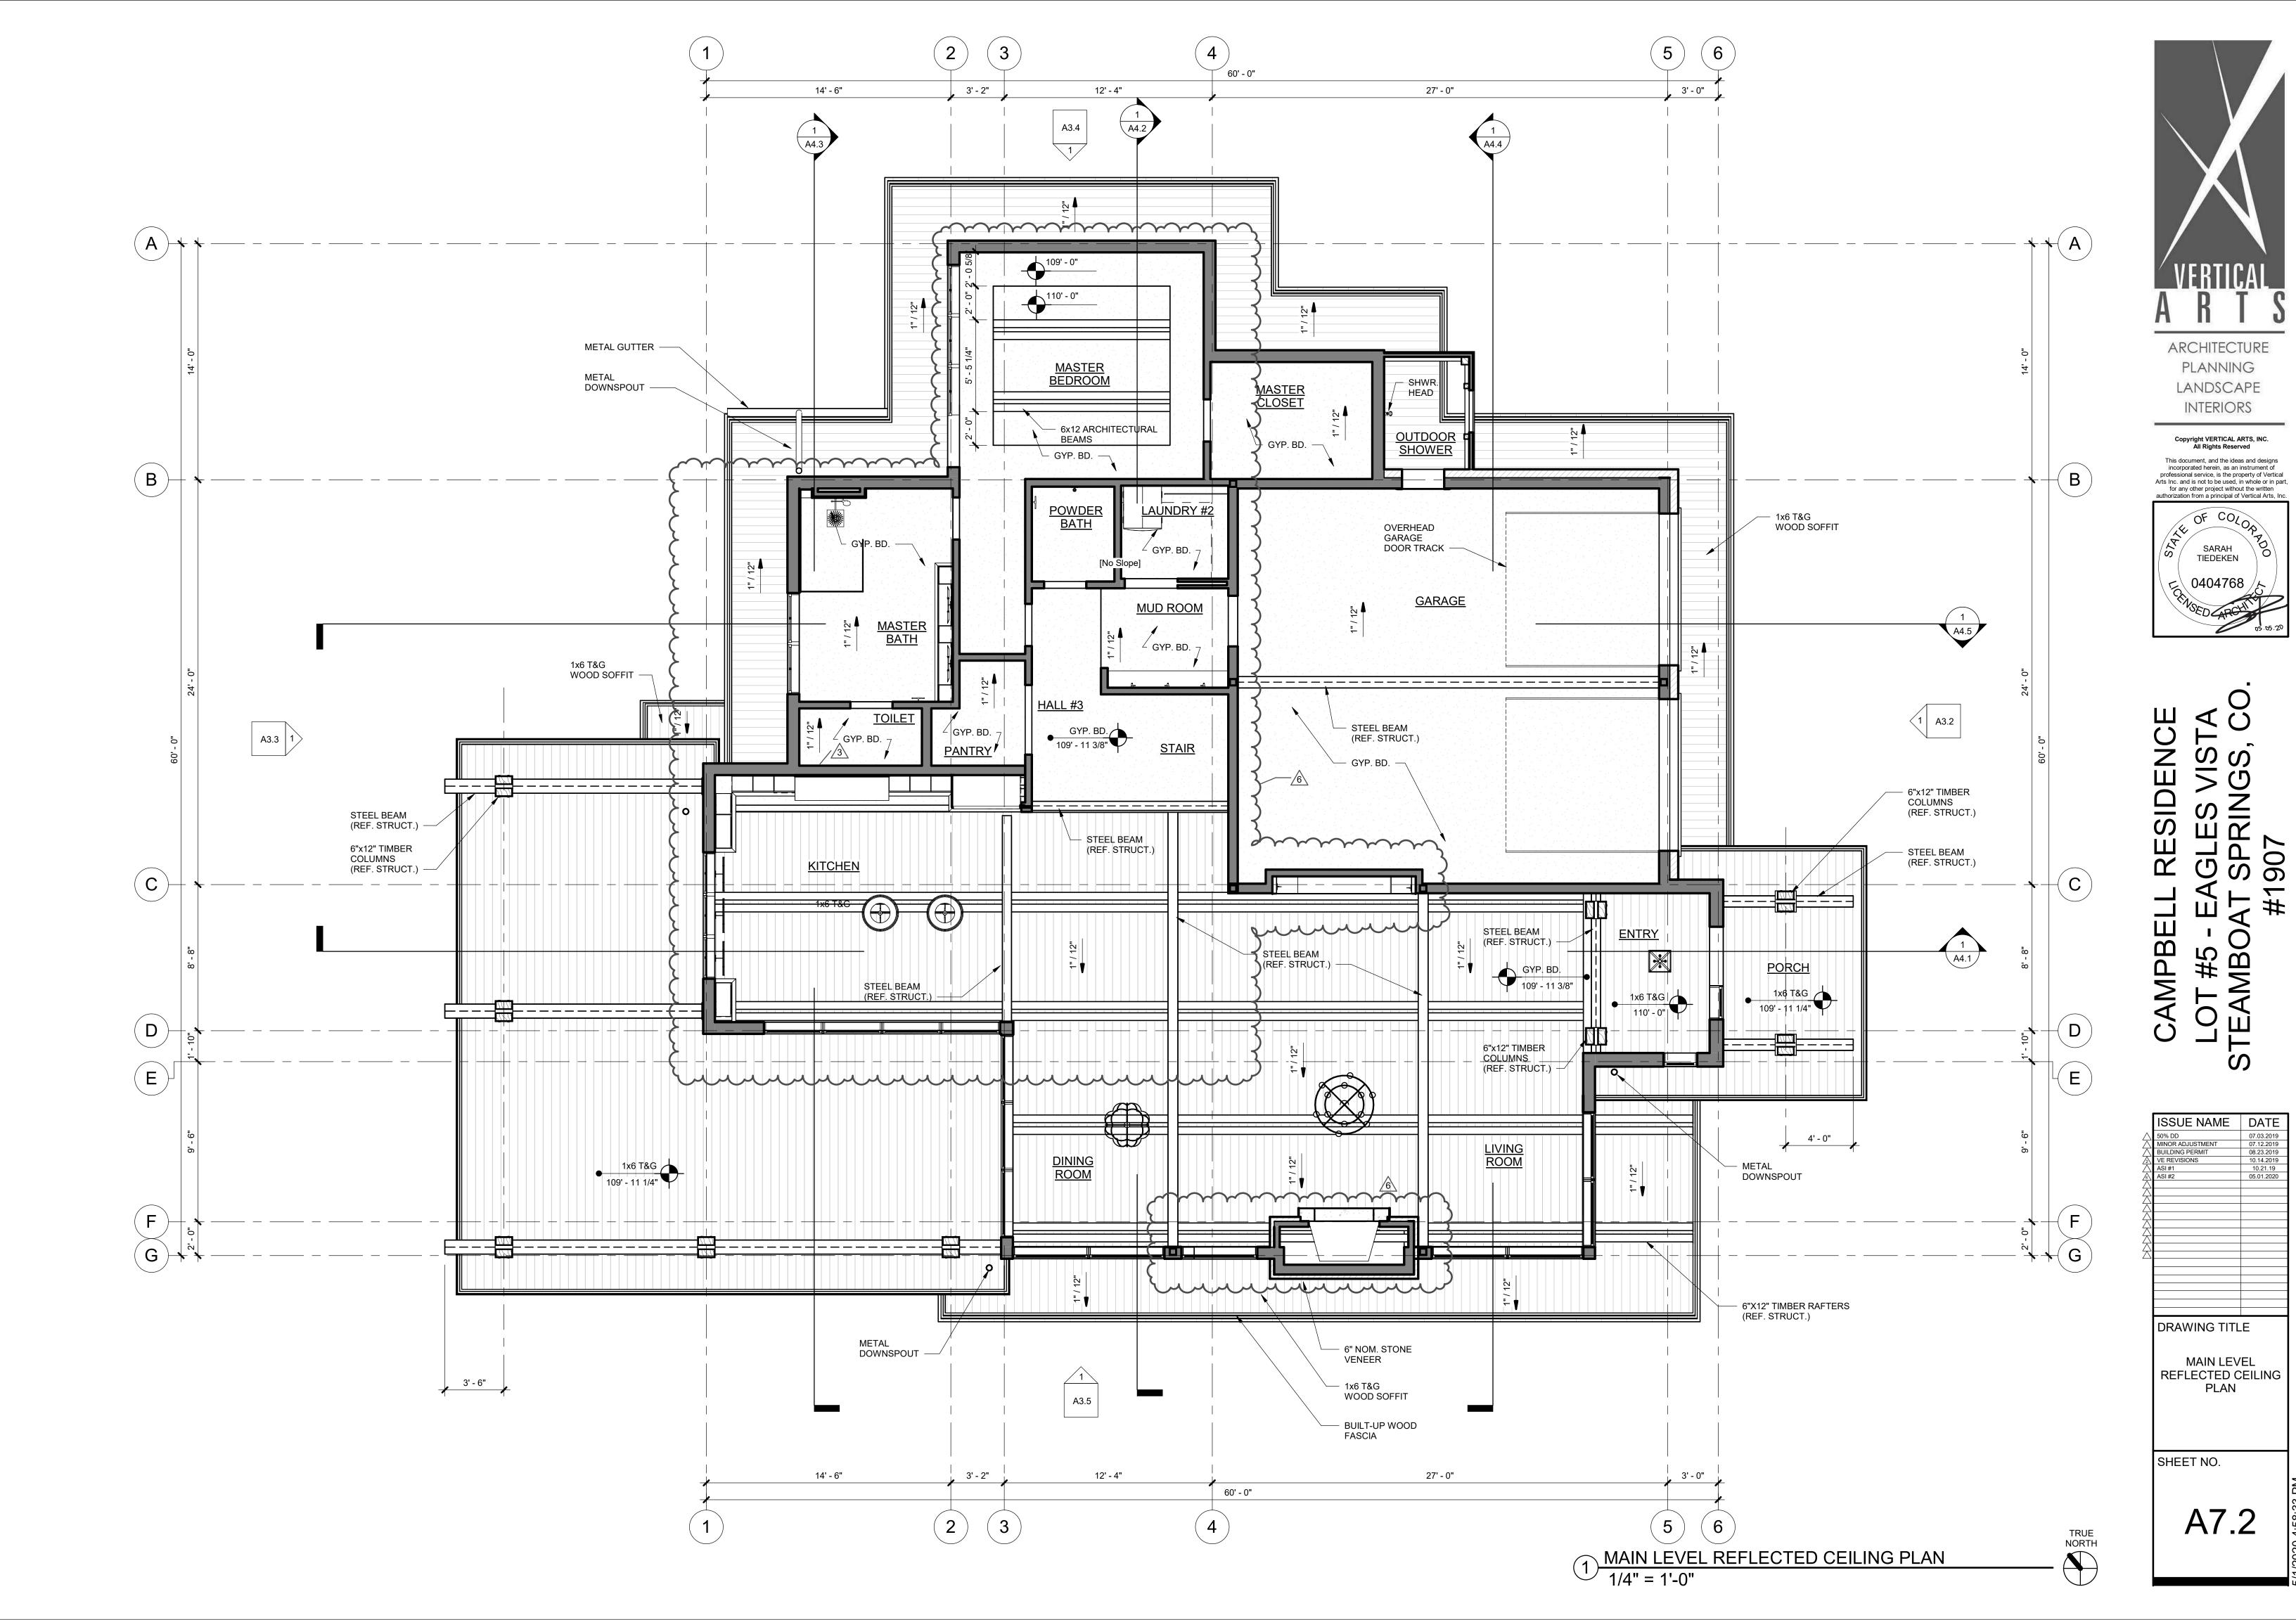

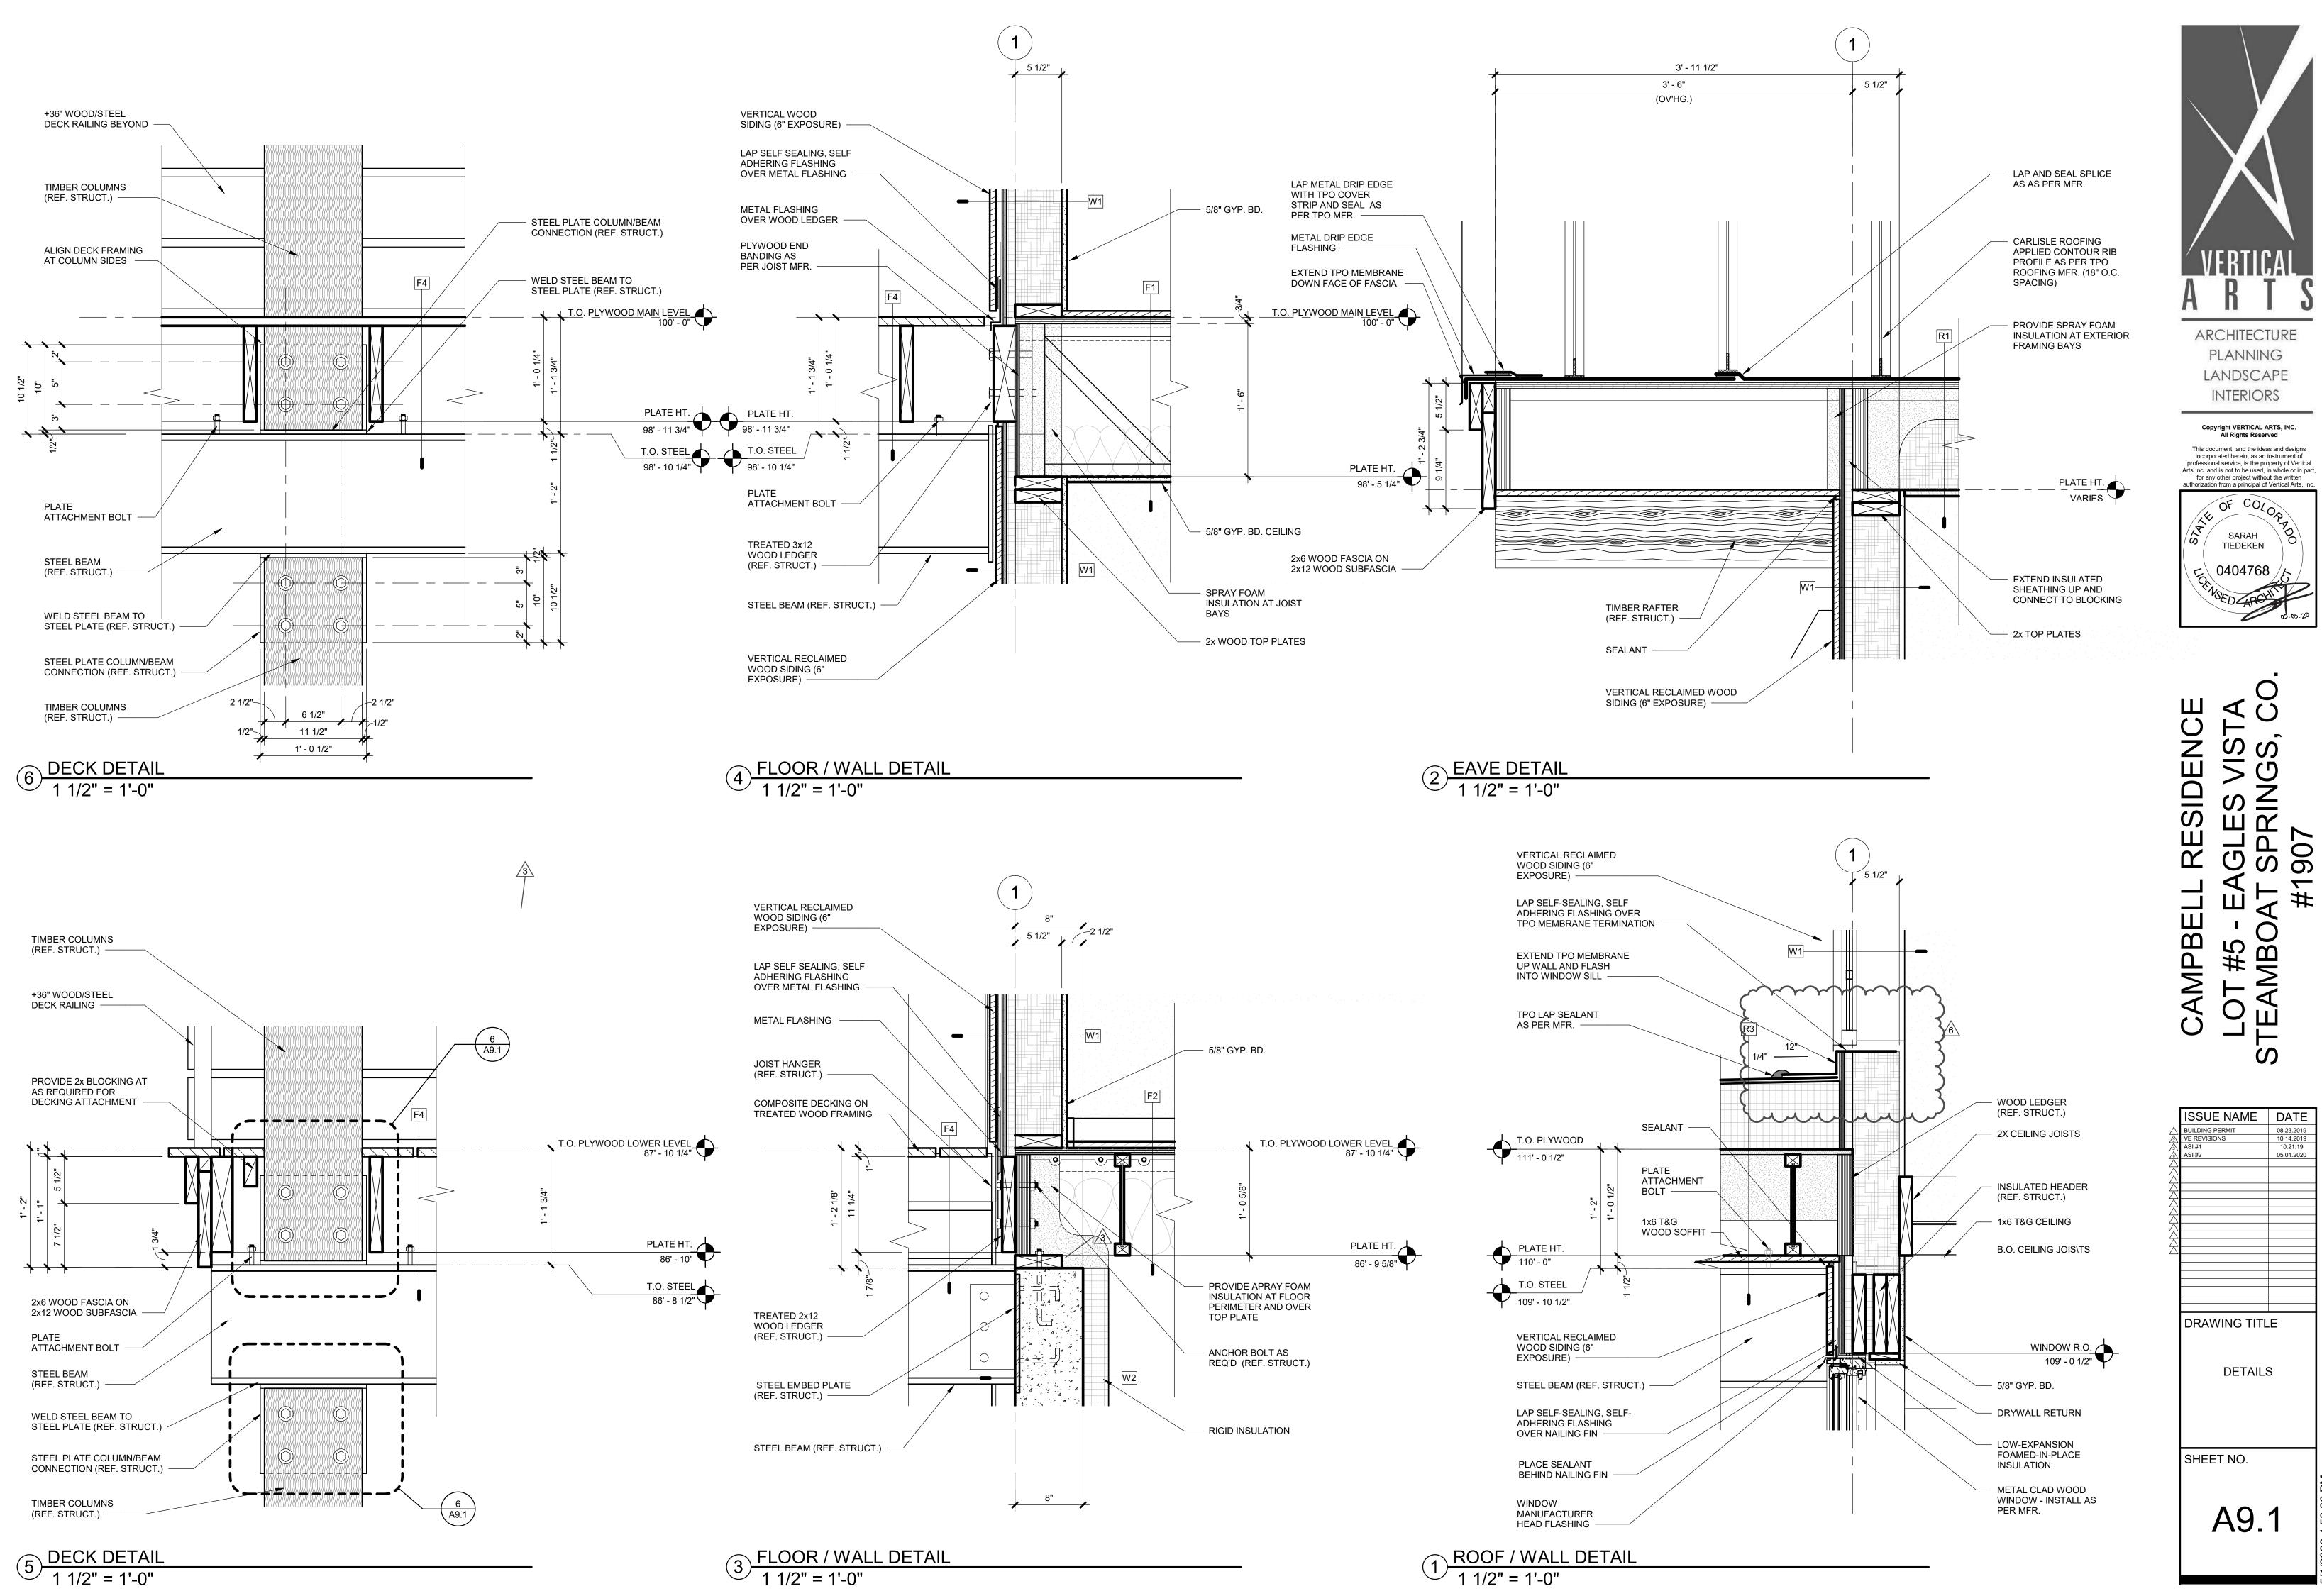

**AMPBEL** 

ARCHITECTURE

**PLANNING** 

LANDSCAPE

INTERIORS

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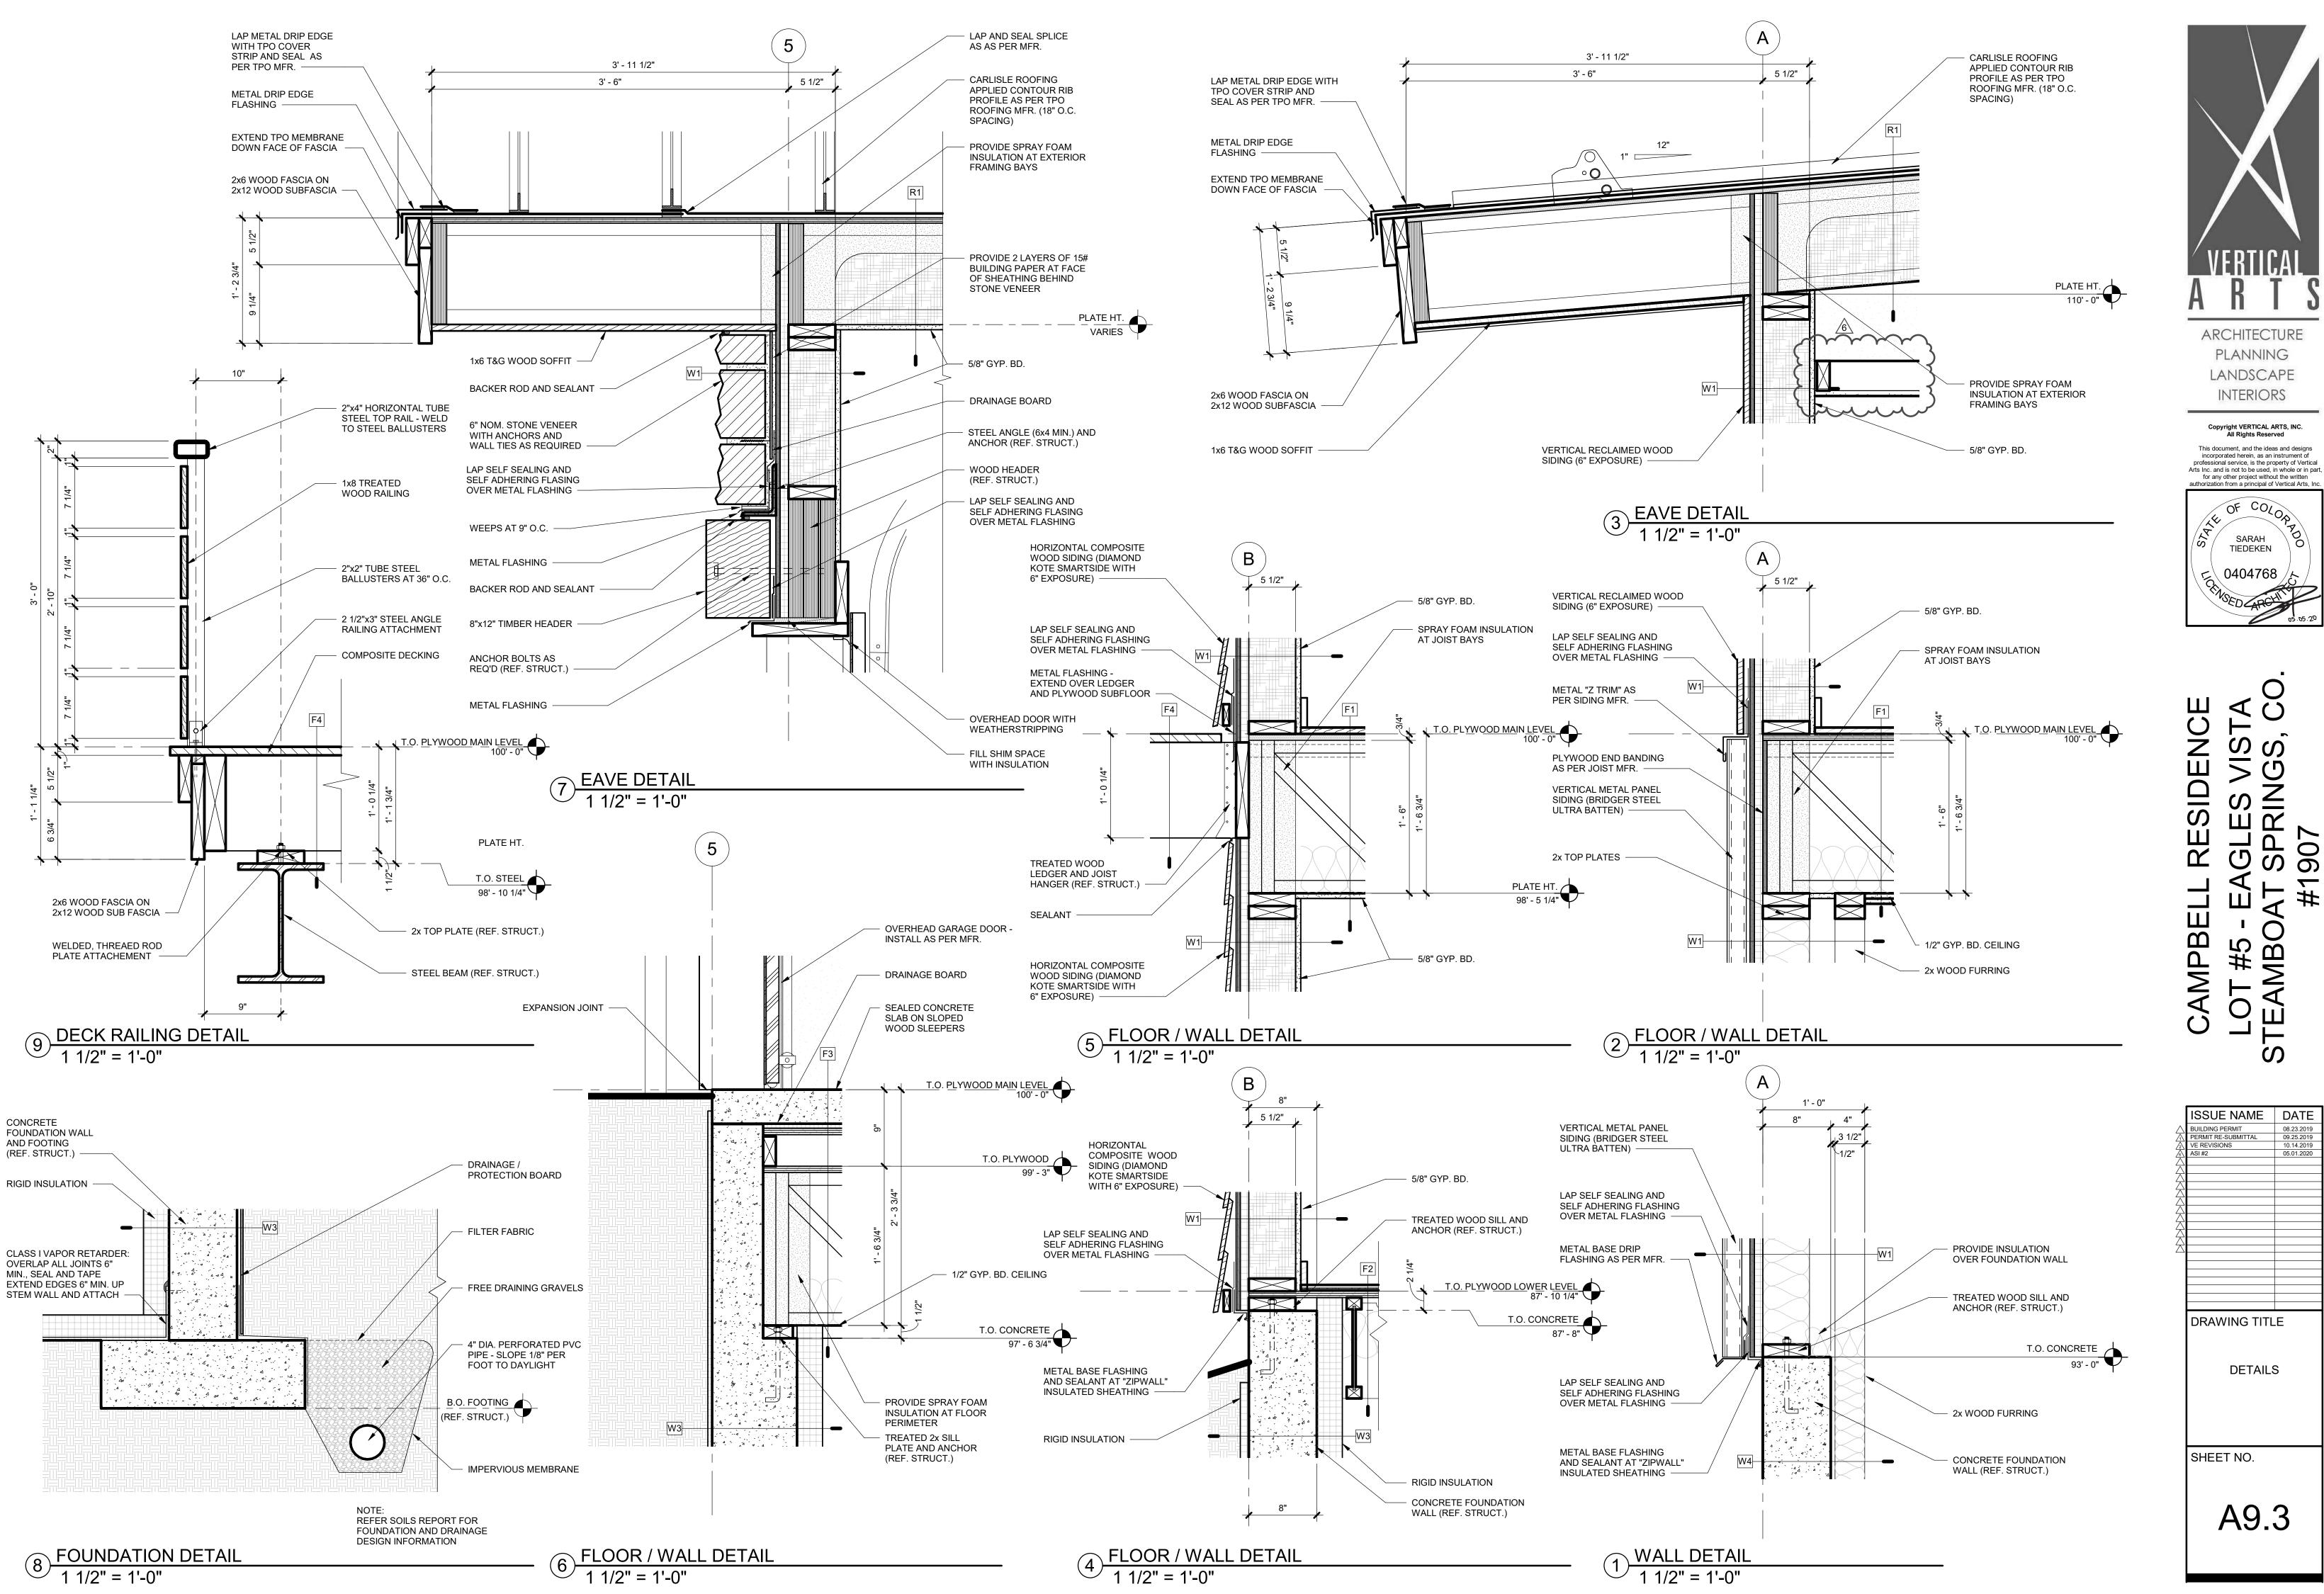
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SARAH

TIEDEKEN

0404768

ISSUE NAME | DATE VE REVISIONS DRAWING TITLE DETAILS SHEET NO. A9.1



INTERIORS

OF COLOS


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TIEDEKEN

0404768

**DETAILS** 

A9.3



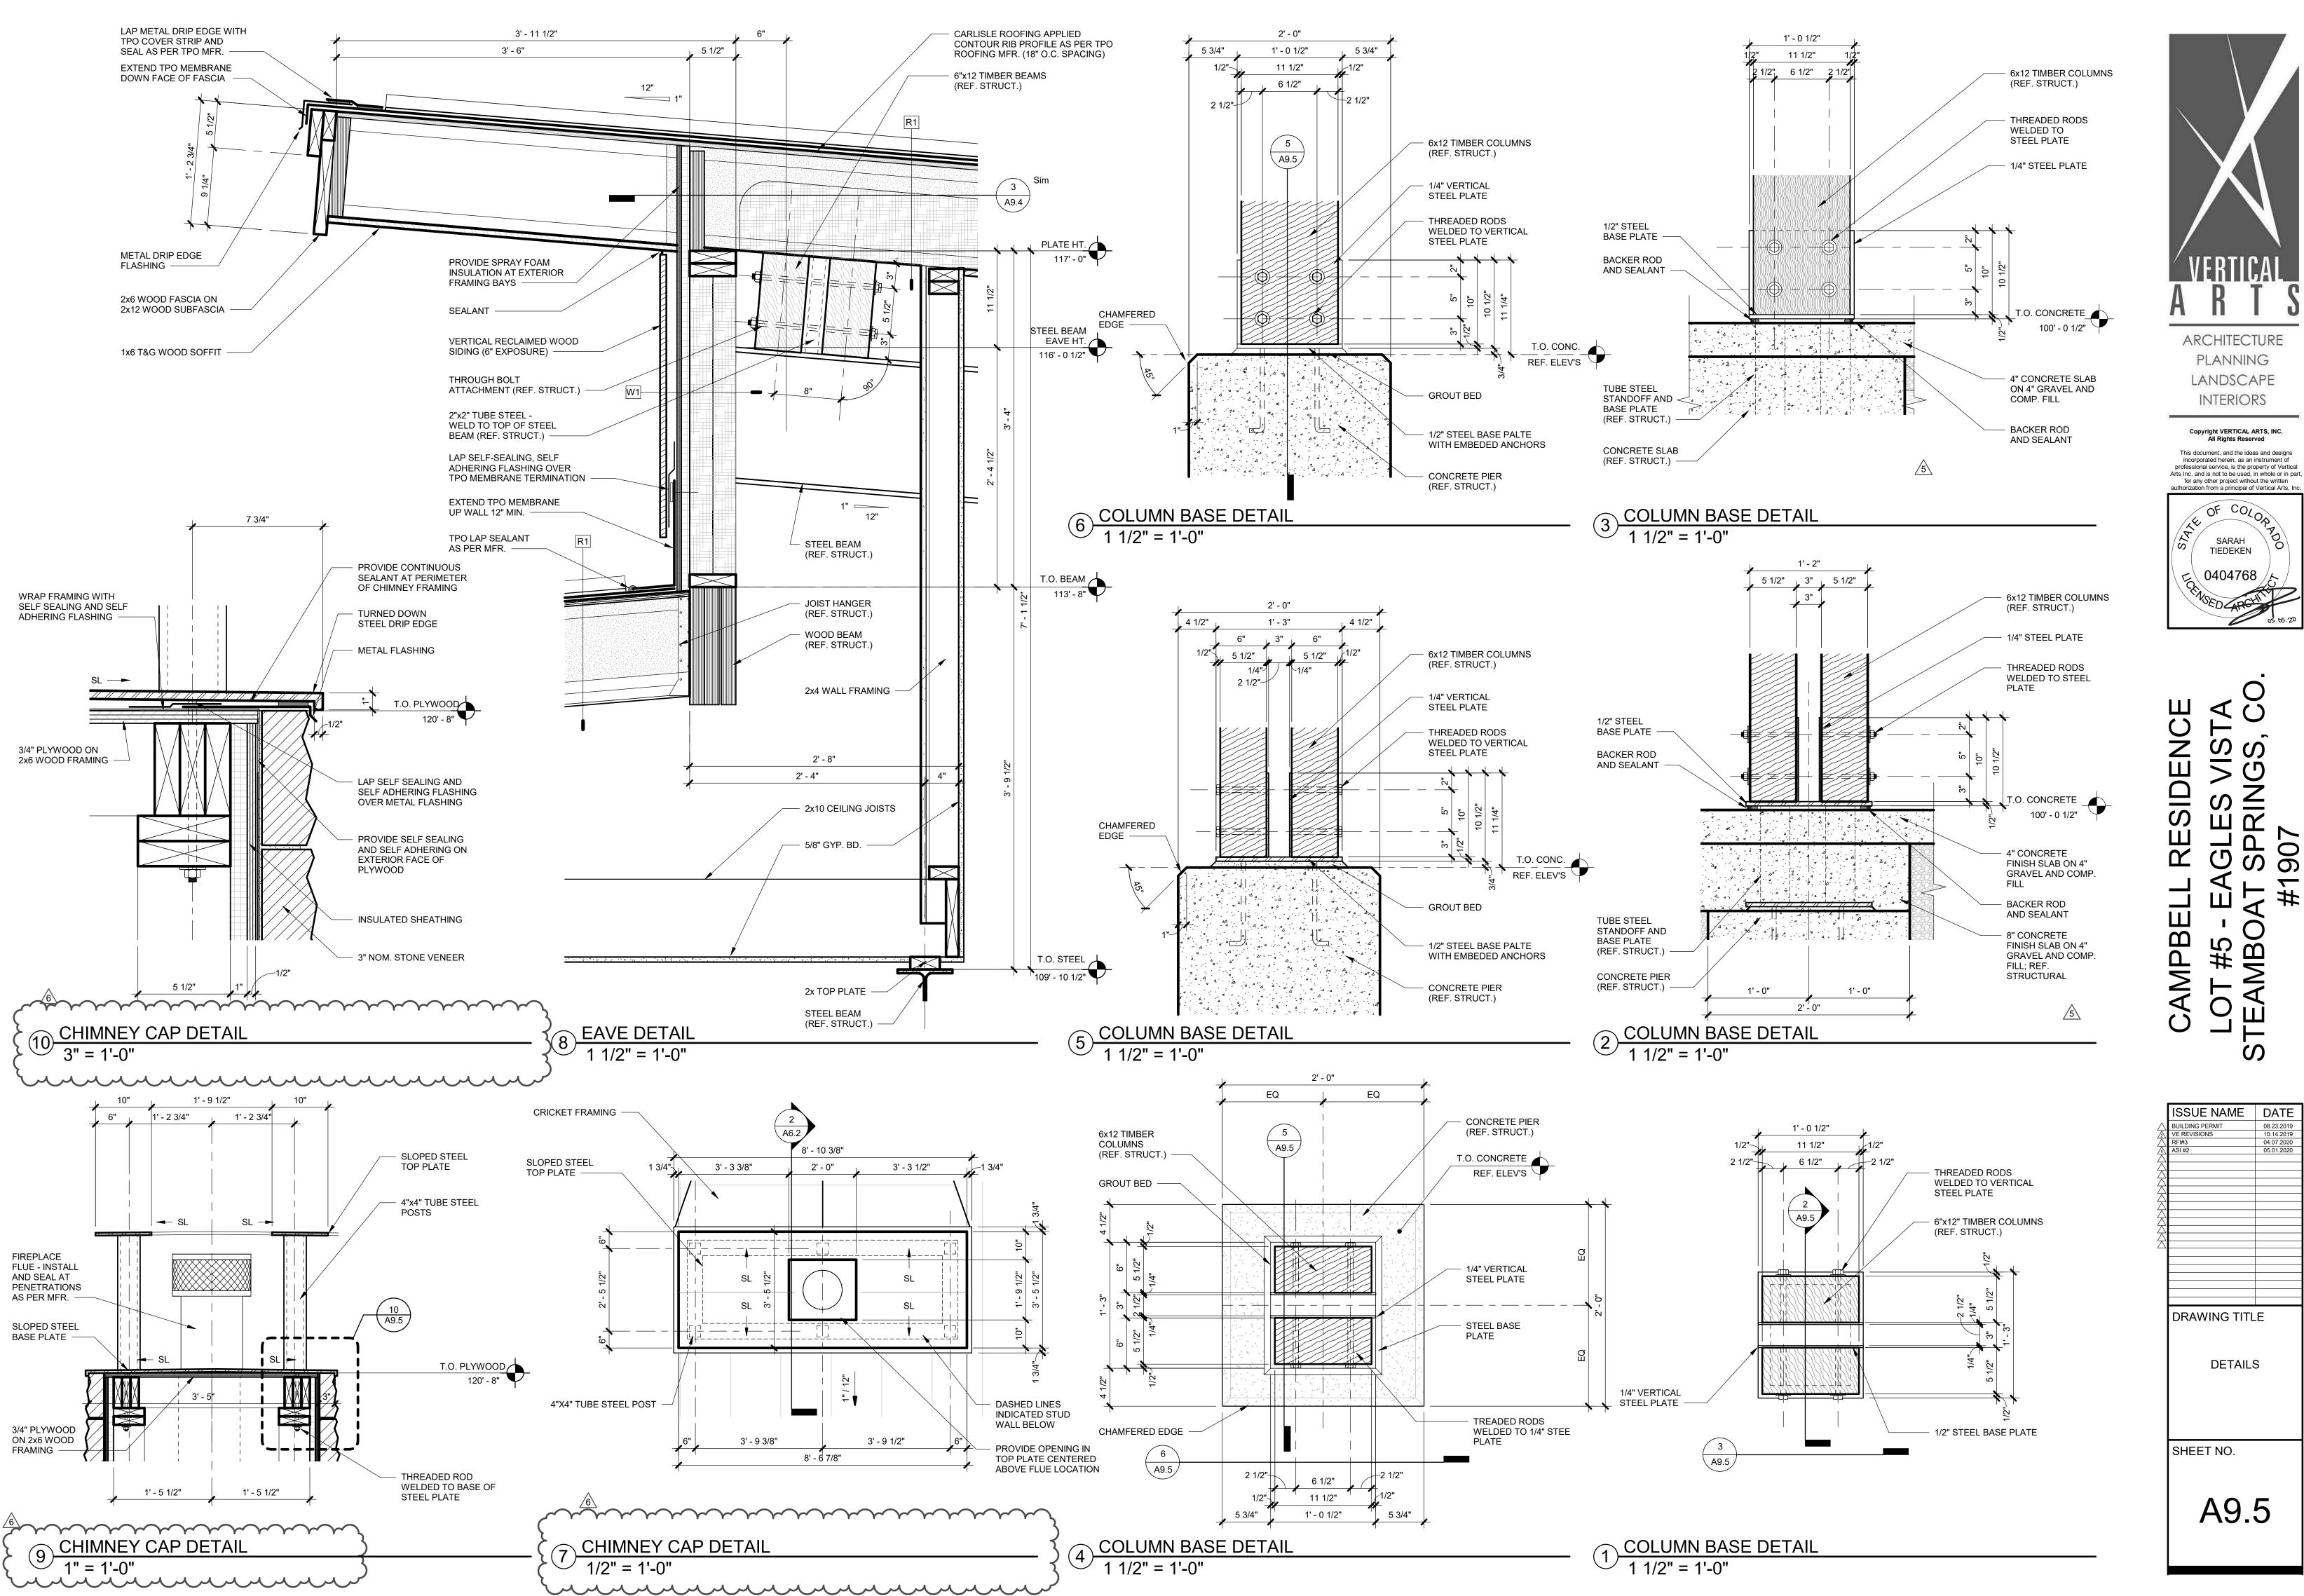


**DETAILS** 

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OF COLOR

SARAH
TIEDEKEN

0404768

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S VISTA INGS, CO.

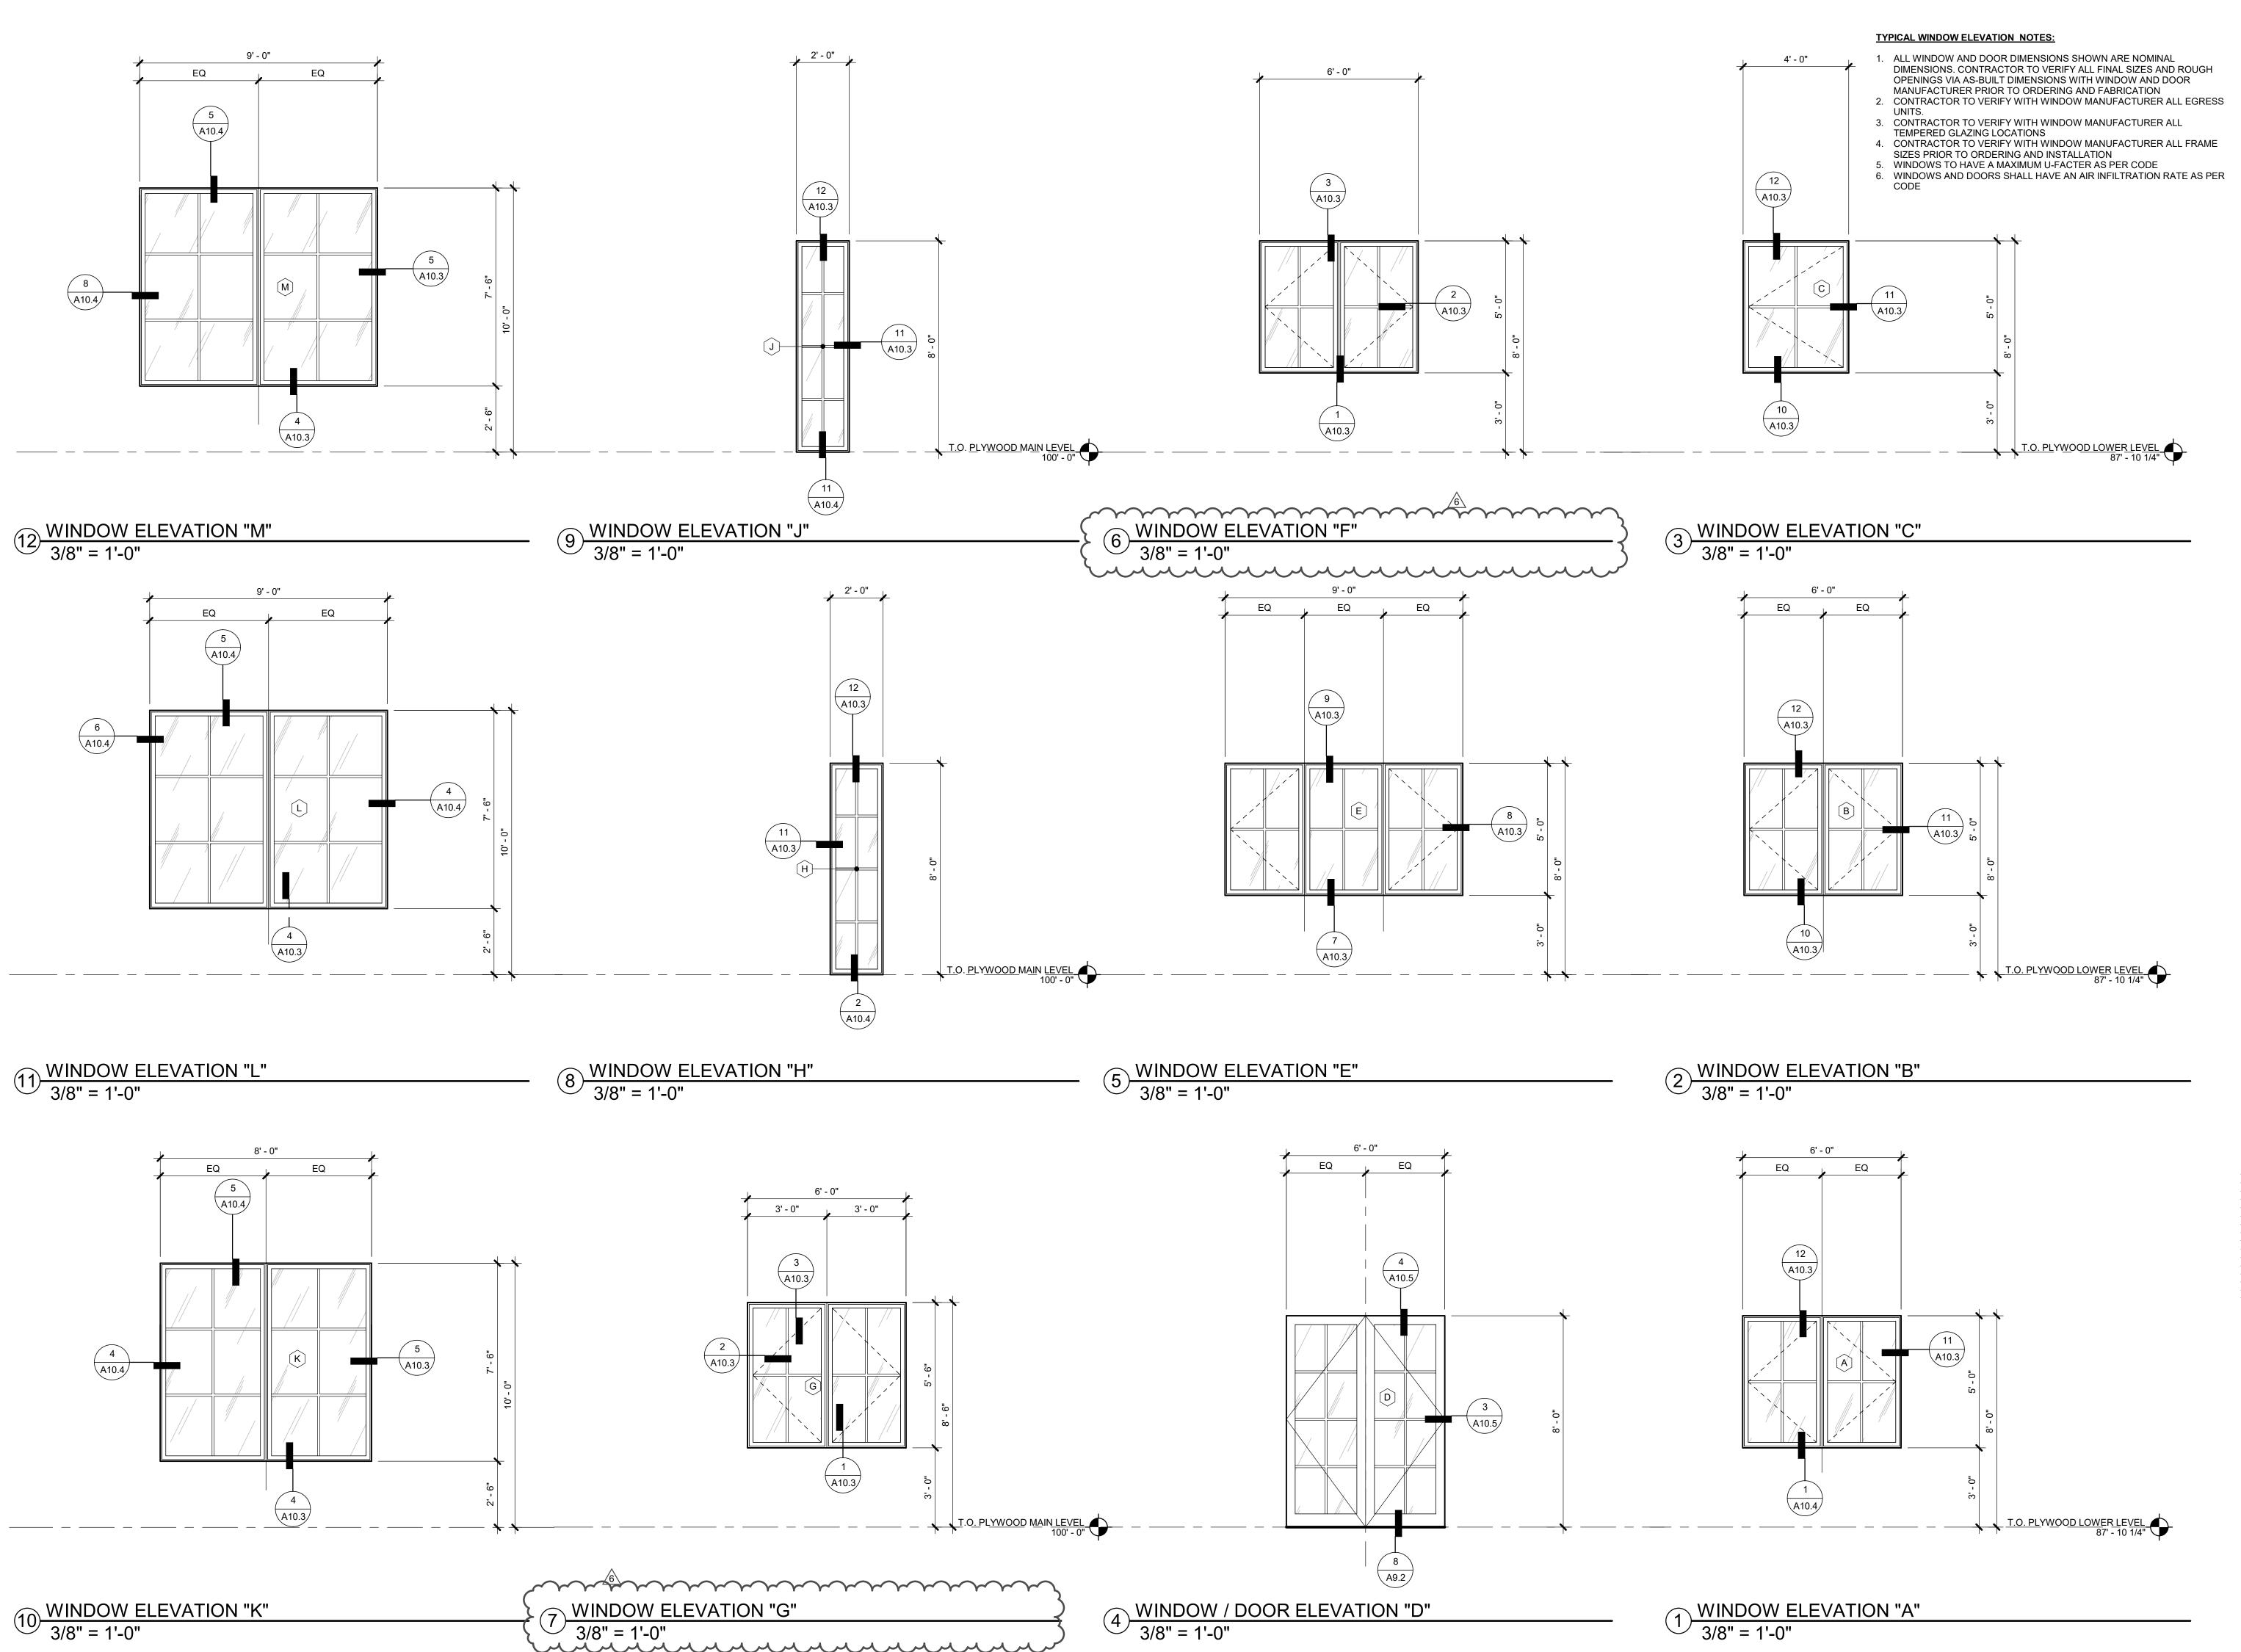CAMPBELL RESIDENCI LOT #5 - EAGLES VISTA STEAMBOAT SPRINGS, 0 #1907


ISSUE NAME
BUILDING PERMIT
VE REVISIONS
10.14.2019
ASI #2


DRAWING TITLE

WINDOW
ELEVATIONS

SHEET NO.

A10.1

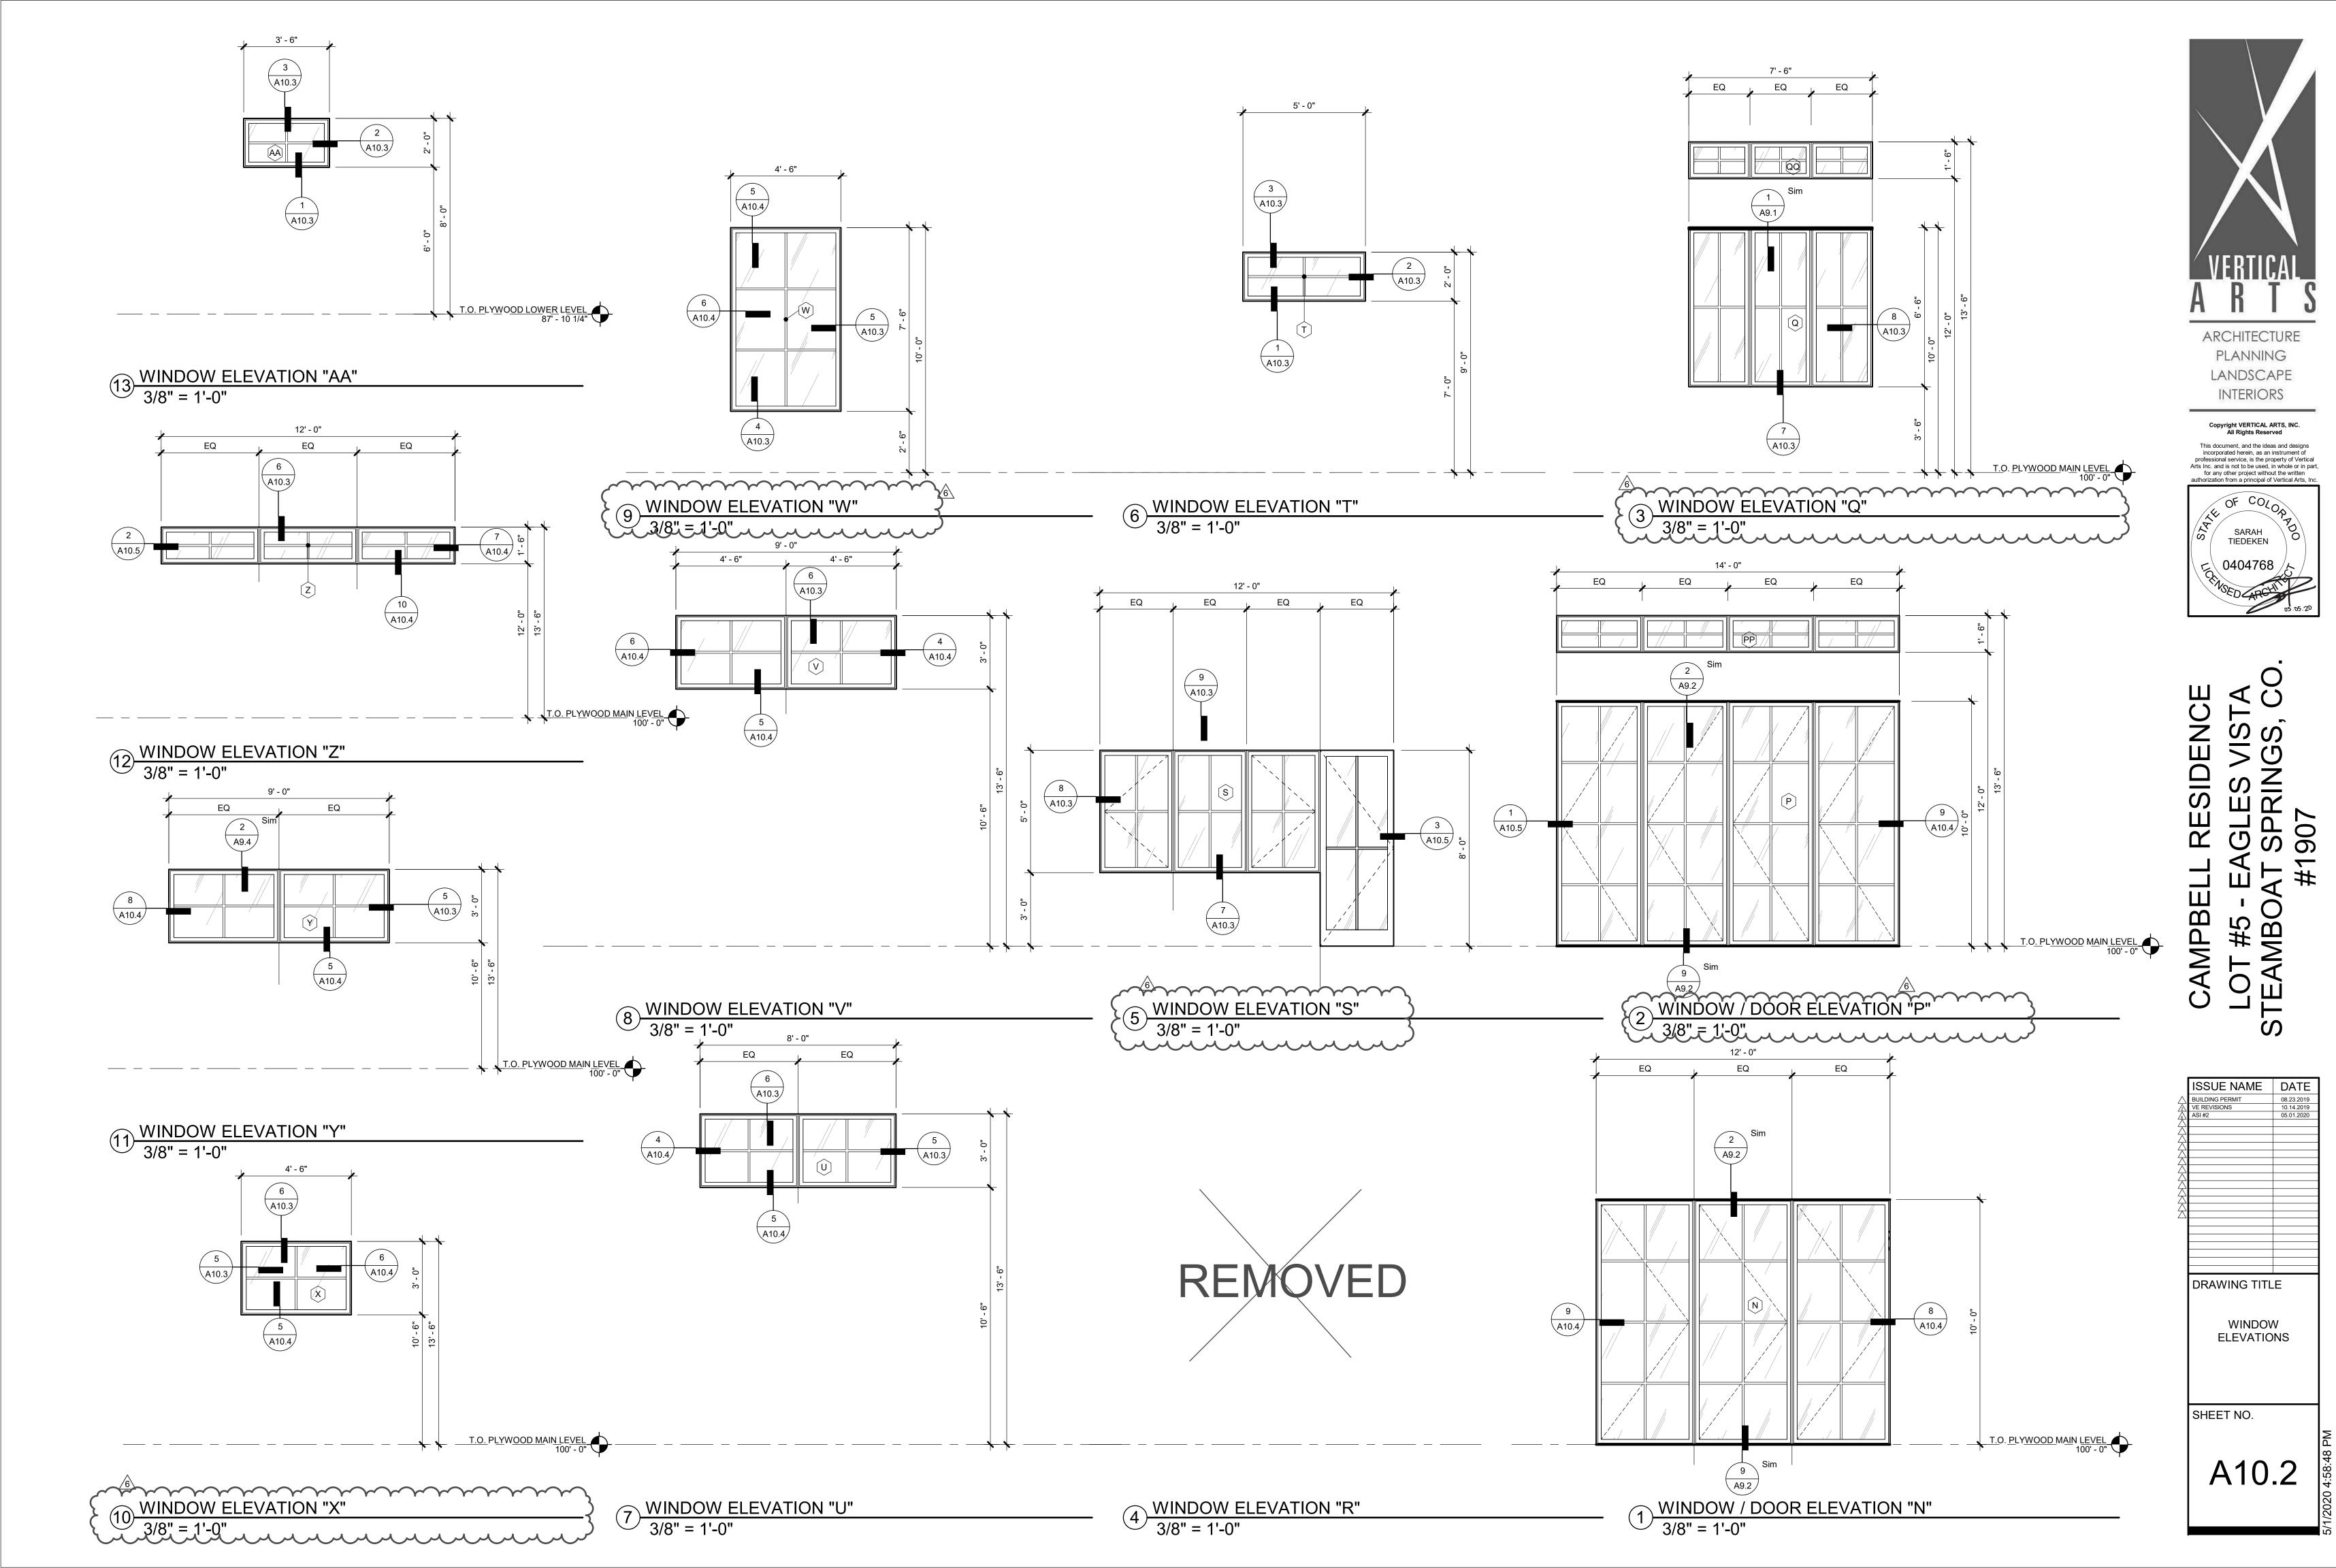

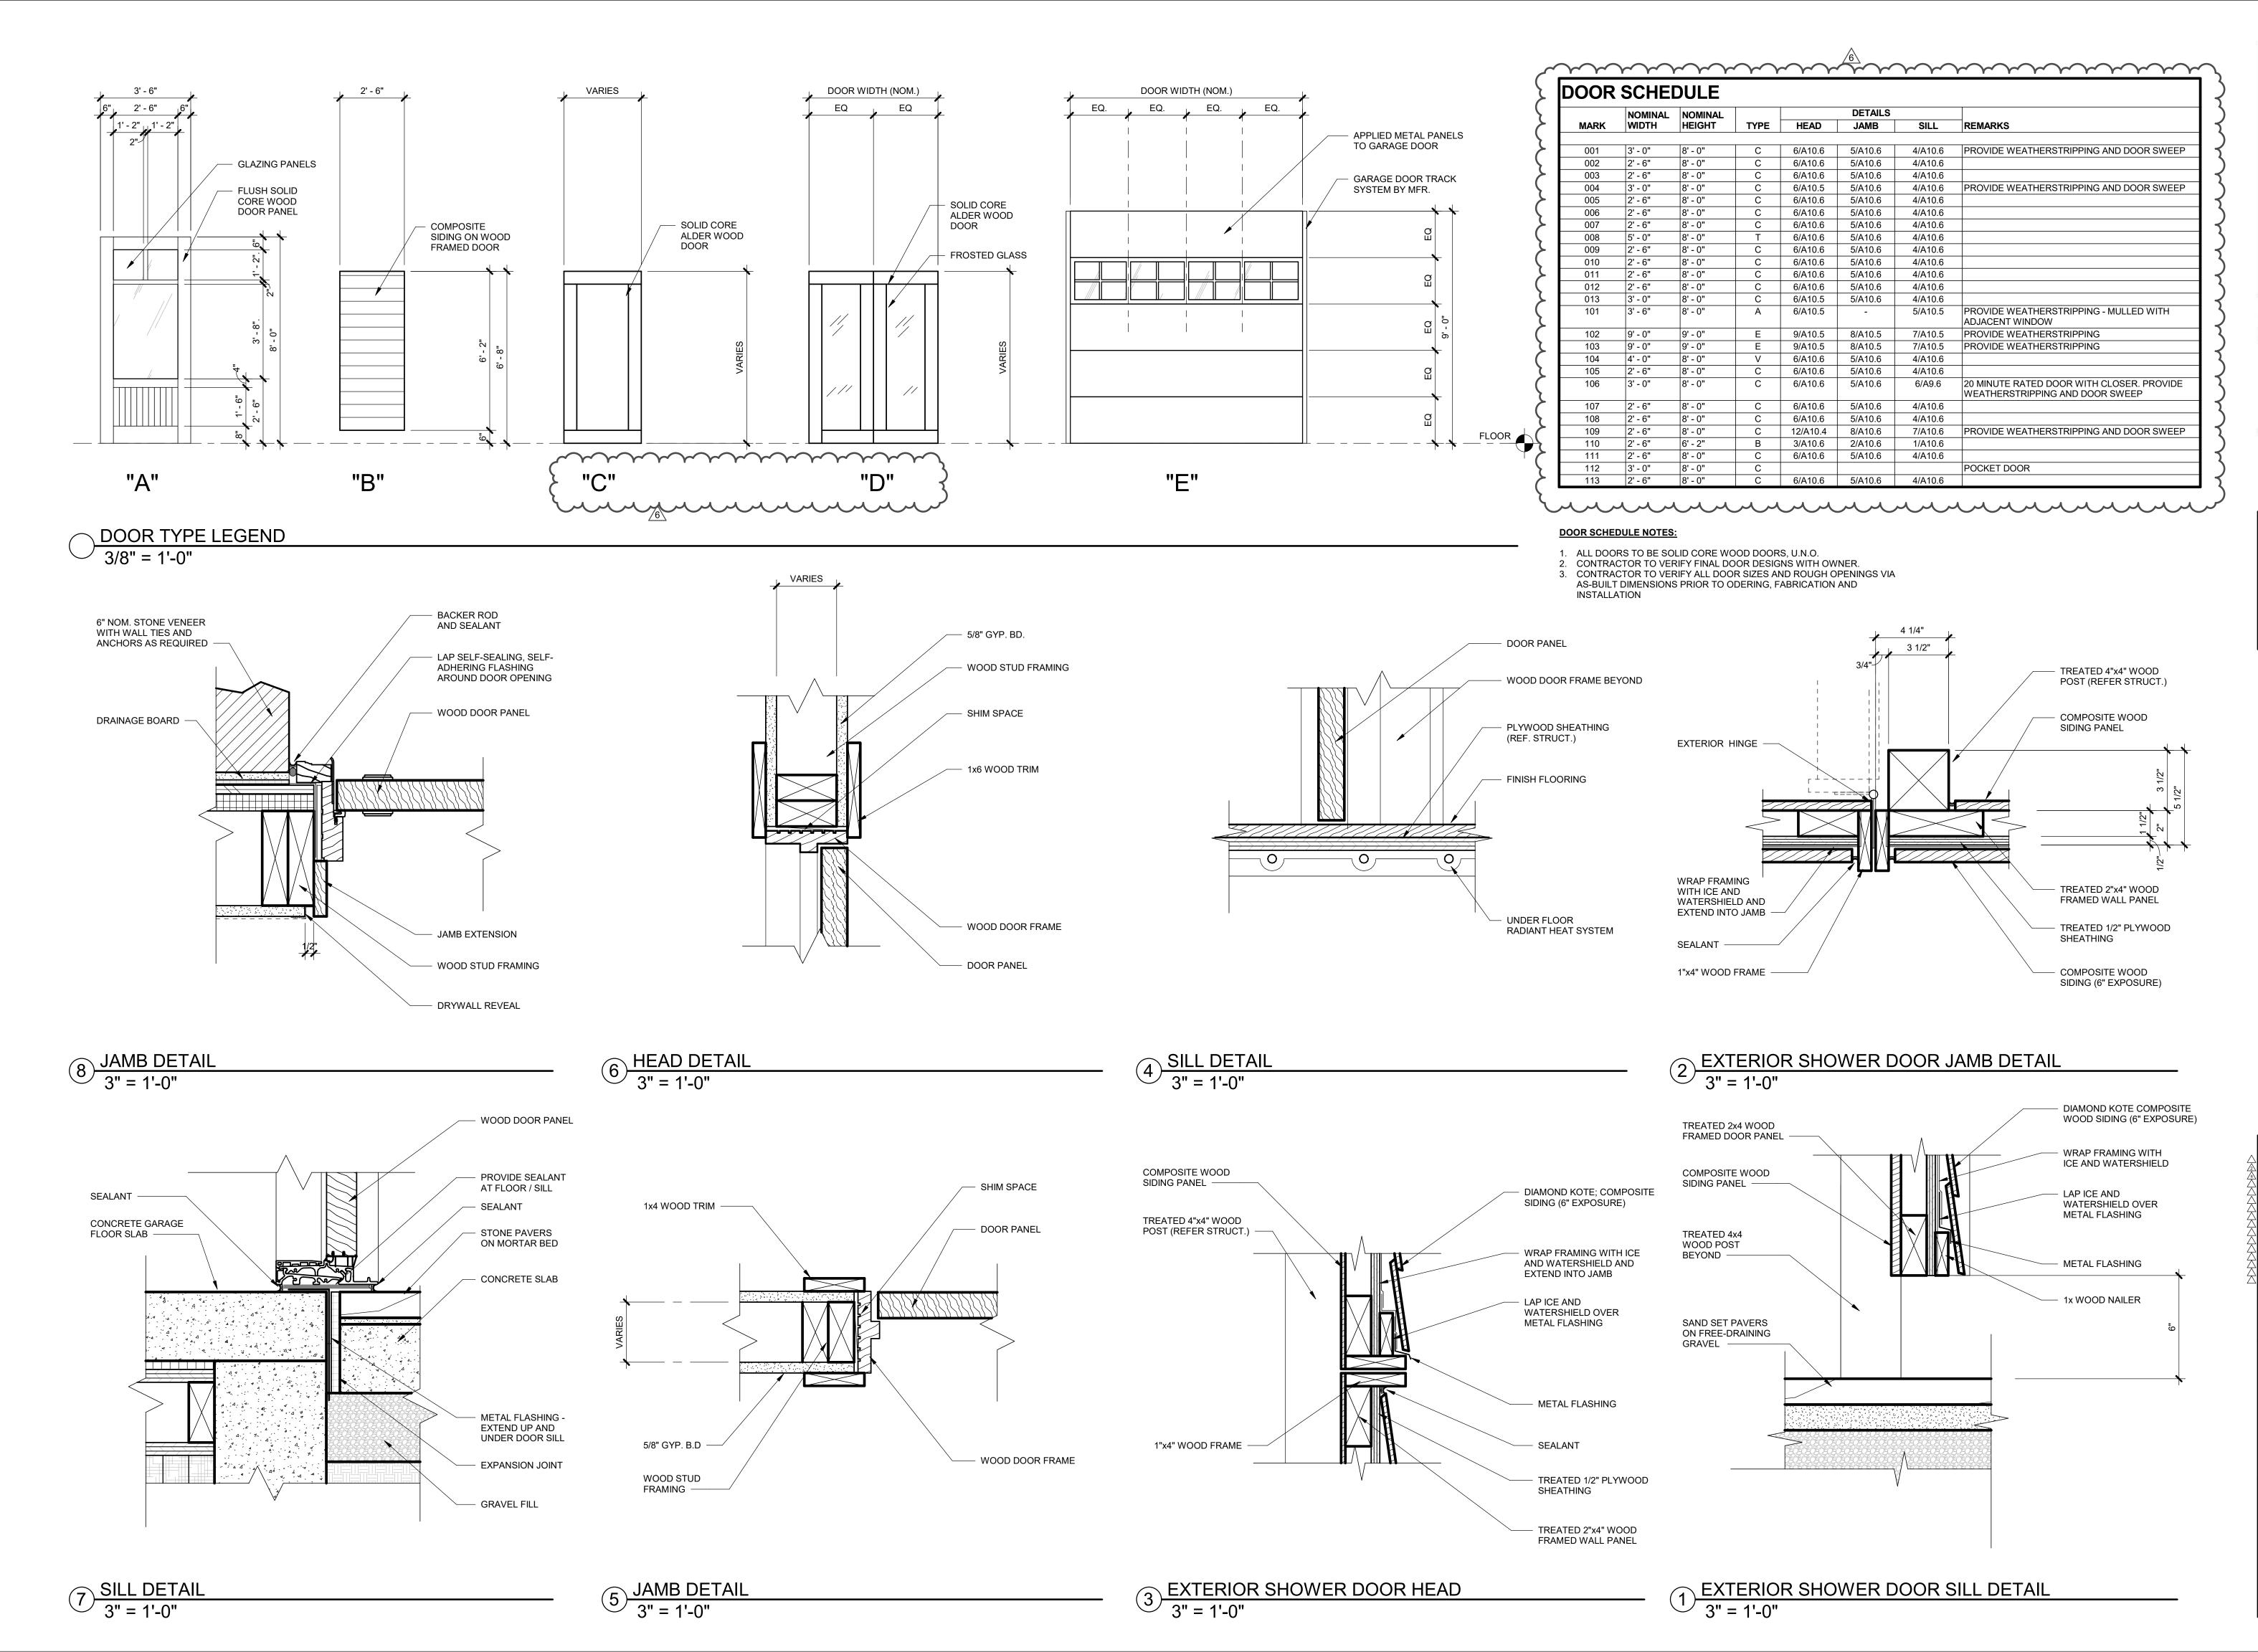


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# ES VI RING SP 907

ISSUE NAME	DATE	
BUILDING PERMIT	08.23.2019	
VE REVISIONS	10.14.2019	
ASI#2	05.01.2020	
DRAWING TITL	E.	
DOOR SCHEDULE		
SHEET NO.		M
A10.6		




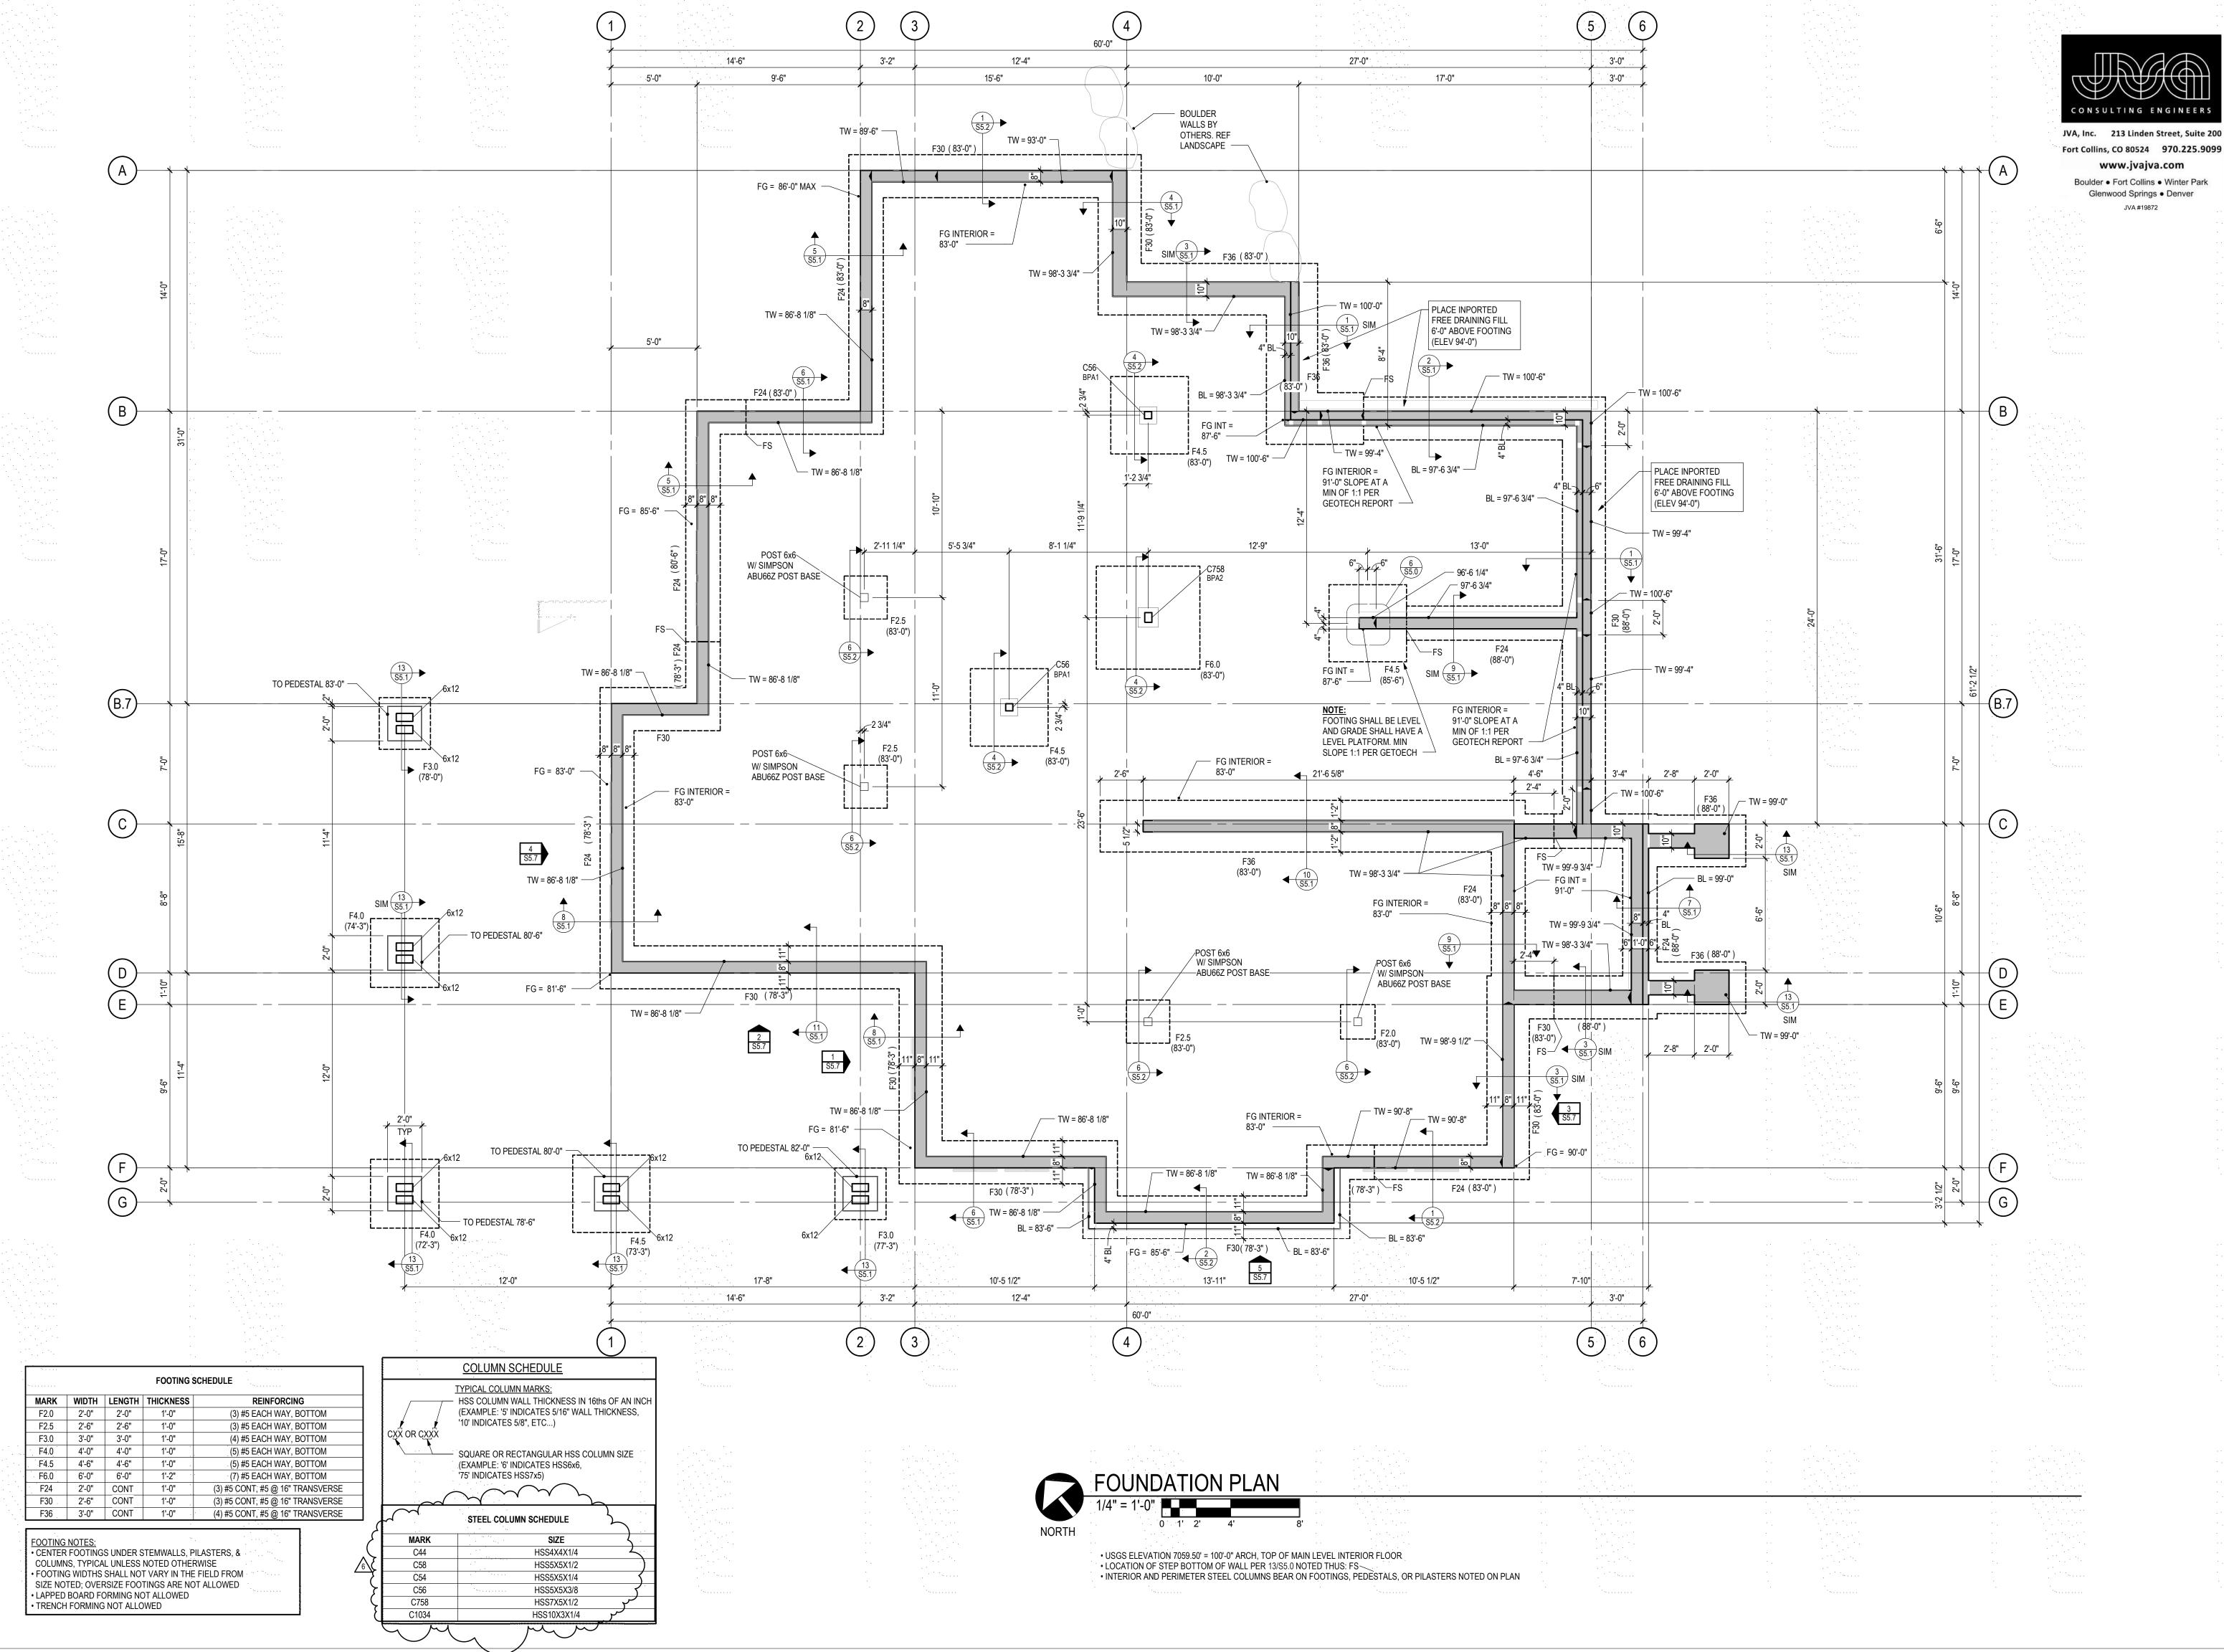

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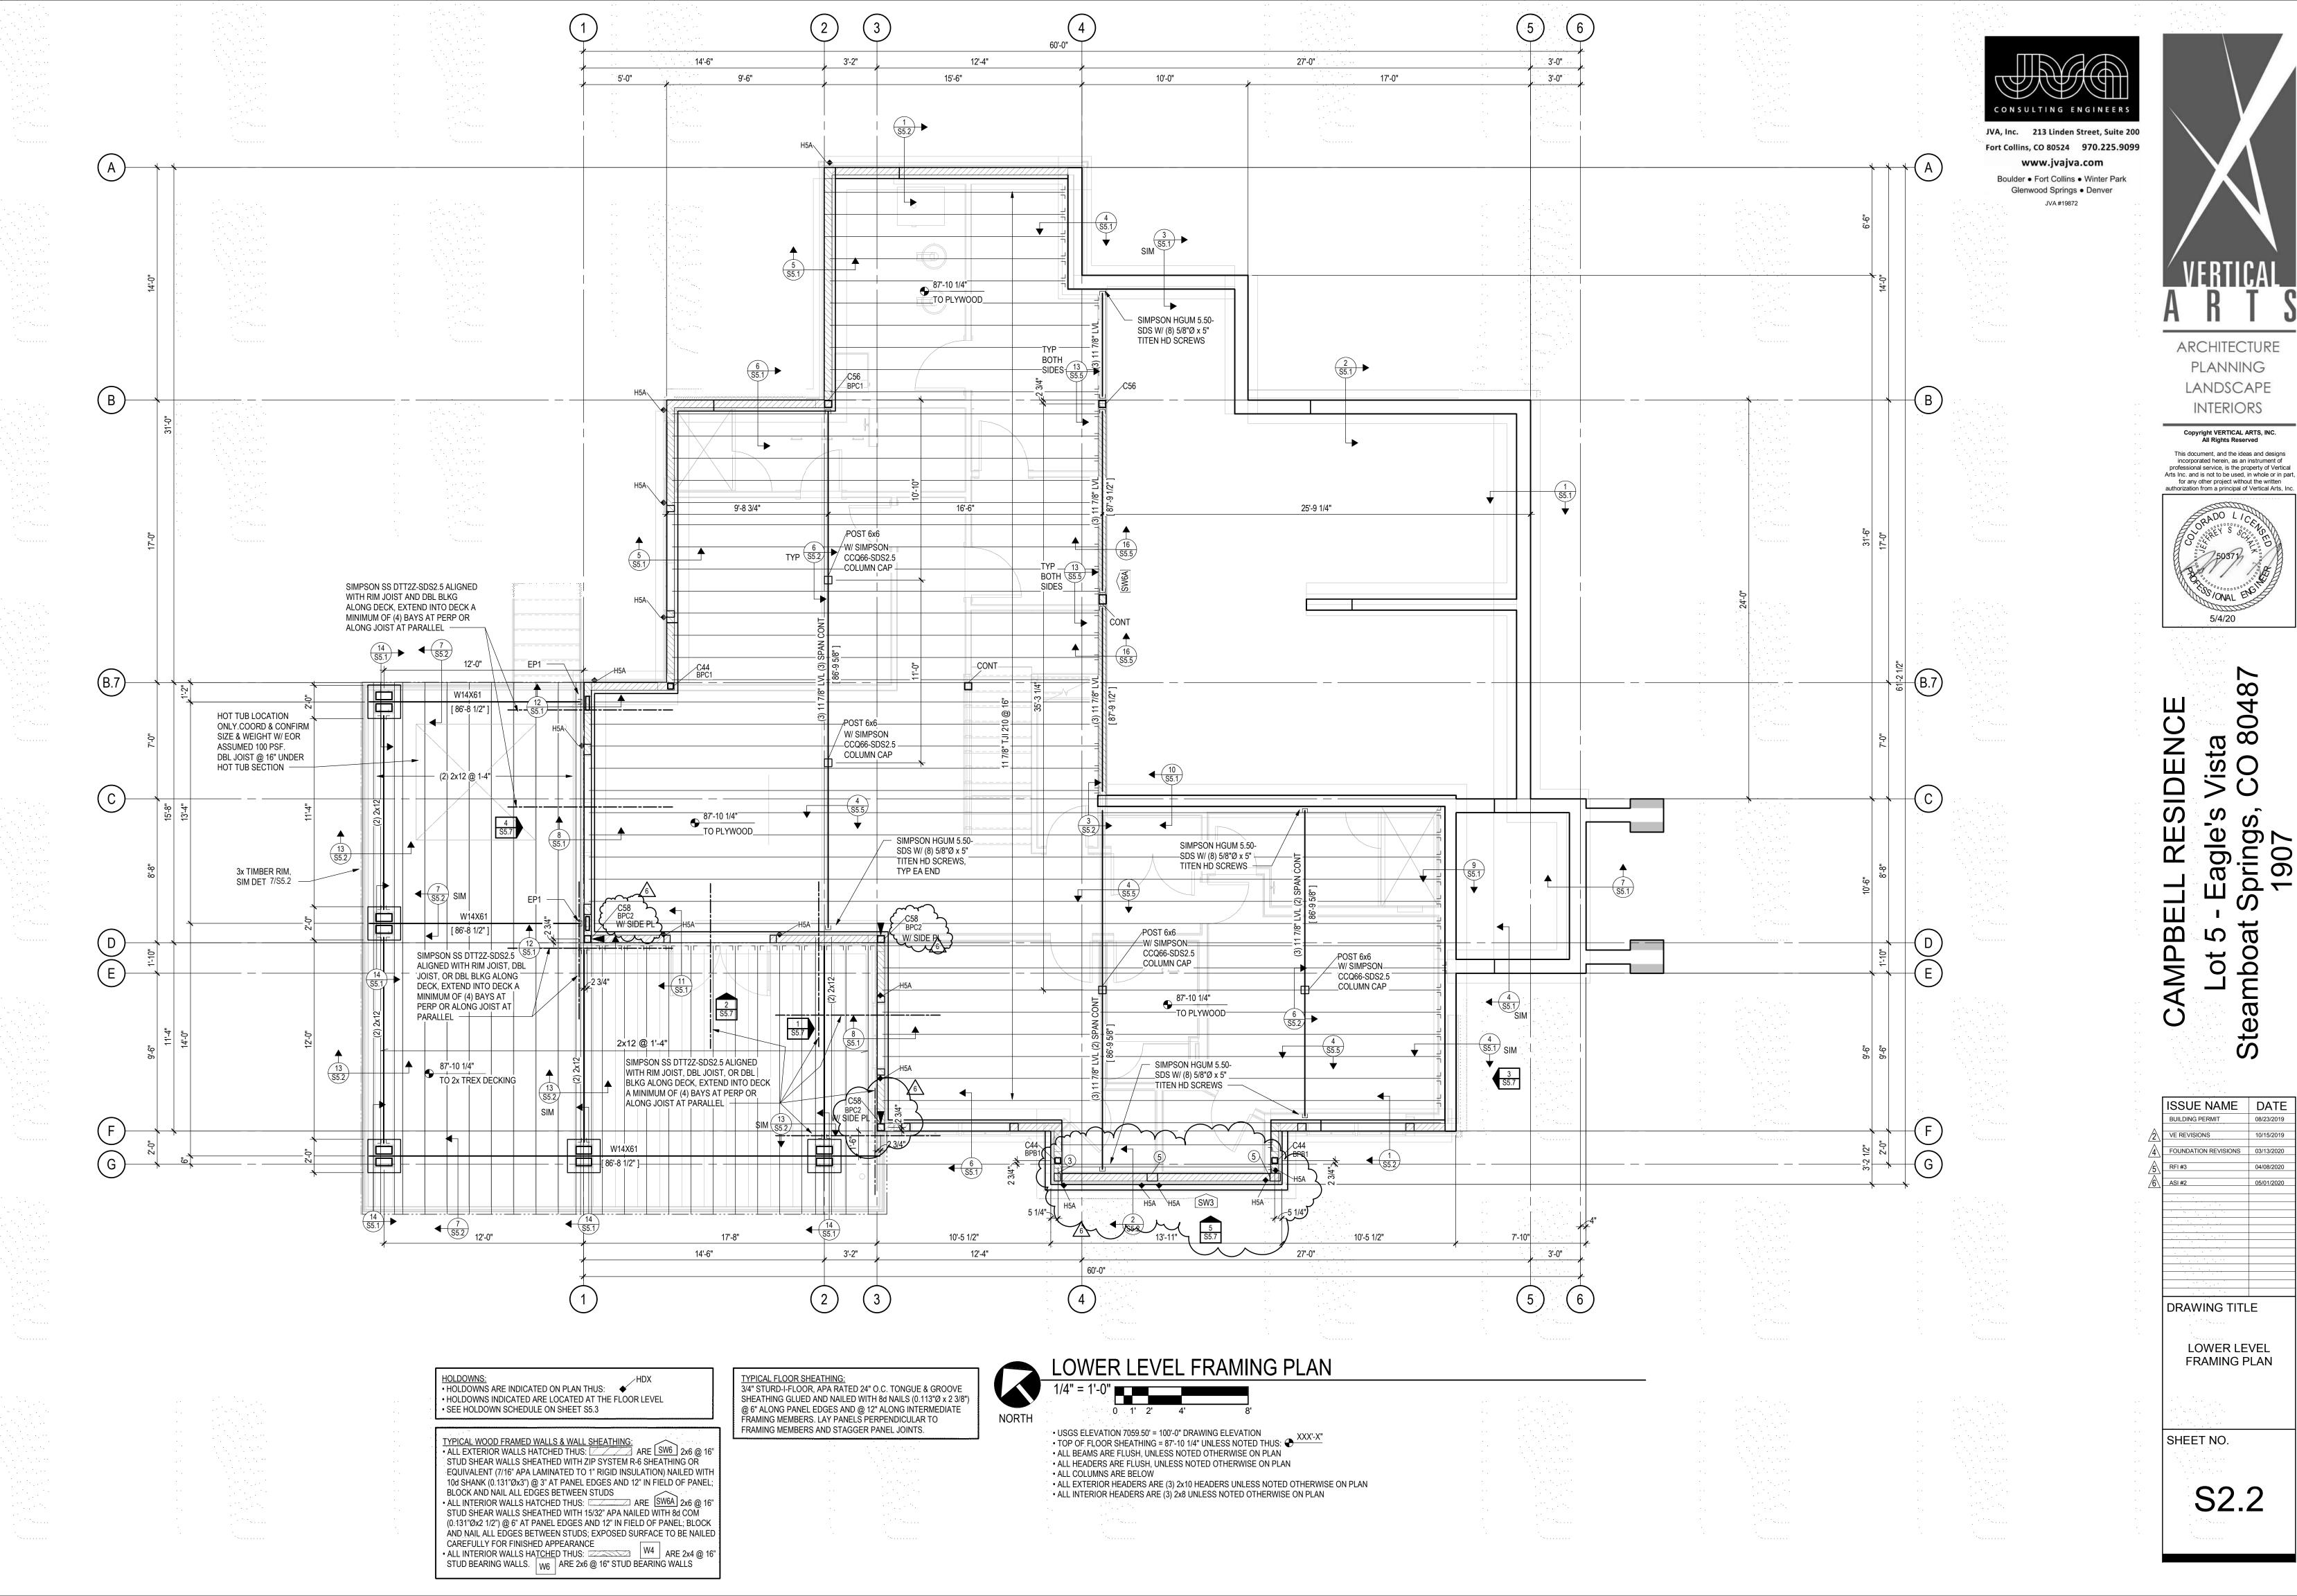


CAMPBELL RESIDEN
Lot 5 - Eagle's Vista
Steamboat Springs, CO 8
1907

	ISSUE NAME	DATE
	BUILDING PERMIT	08/23/2019
/1\	PERMIT RE-SUBMITTAL	10/2/19
2	VE REVISIONS	10/15/2019
4	FOUNDATION REVISIONS	03/13/2020
<u></u>	RFI #3	04/08/2020
<u>6</u>	ASI #2	05/01/2020
	The April 1	
	DRAWING TITL	.E
	FOUNDATION	I PLAN

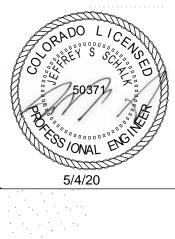SHEET NO.

S2.1



ARCHITECTURE

**PLANNING** 

LANDSCAPE

INTERIORS

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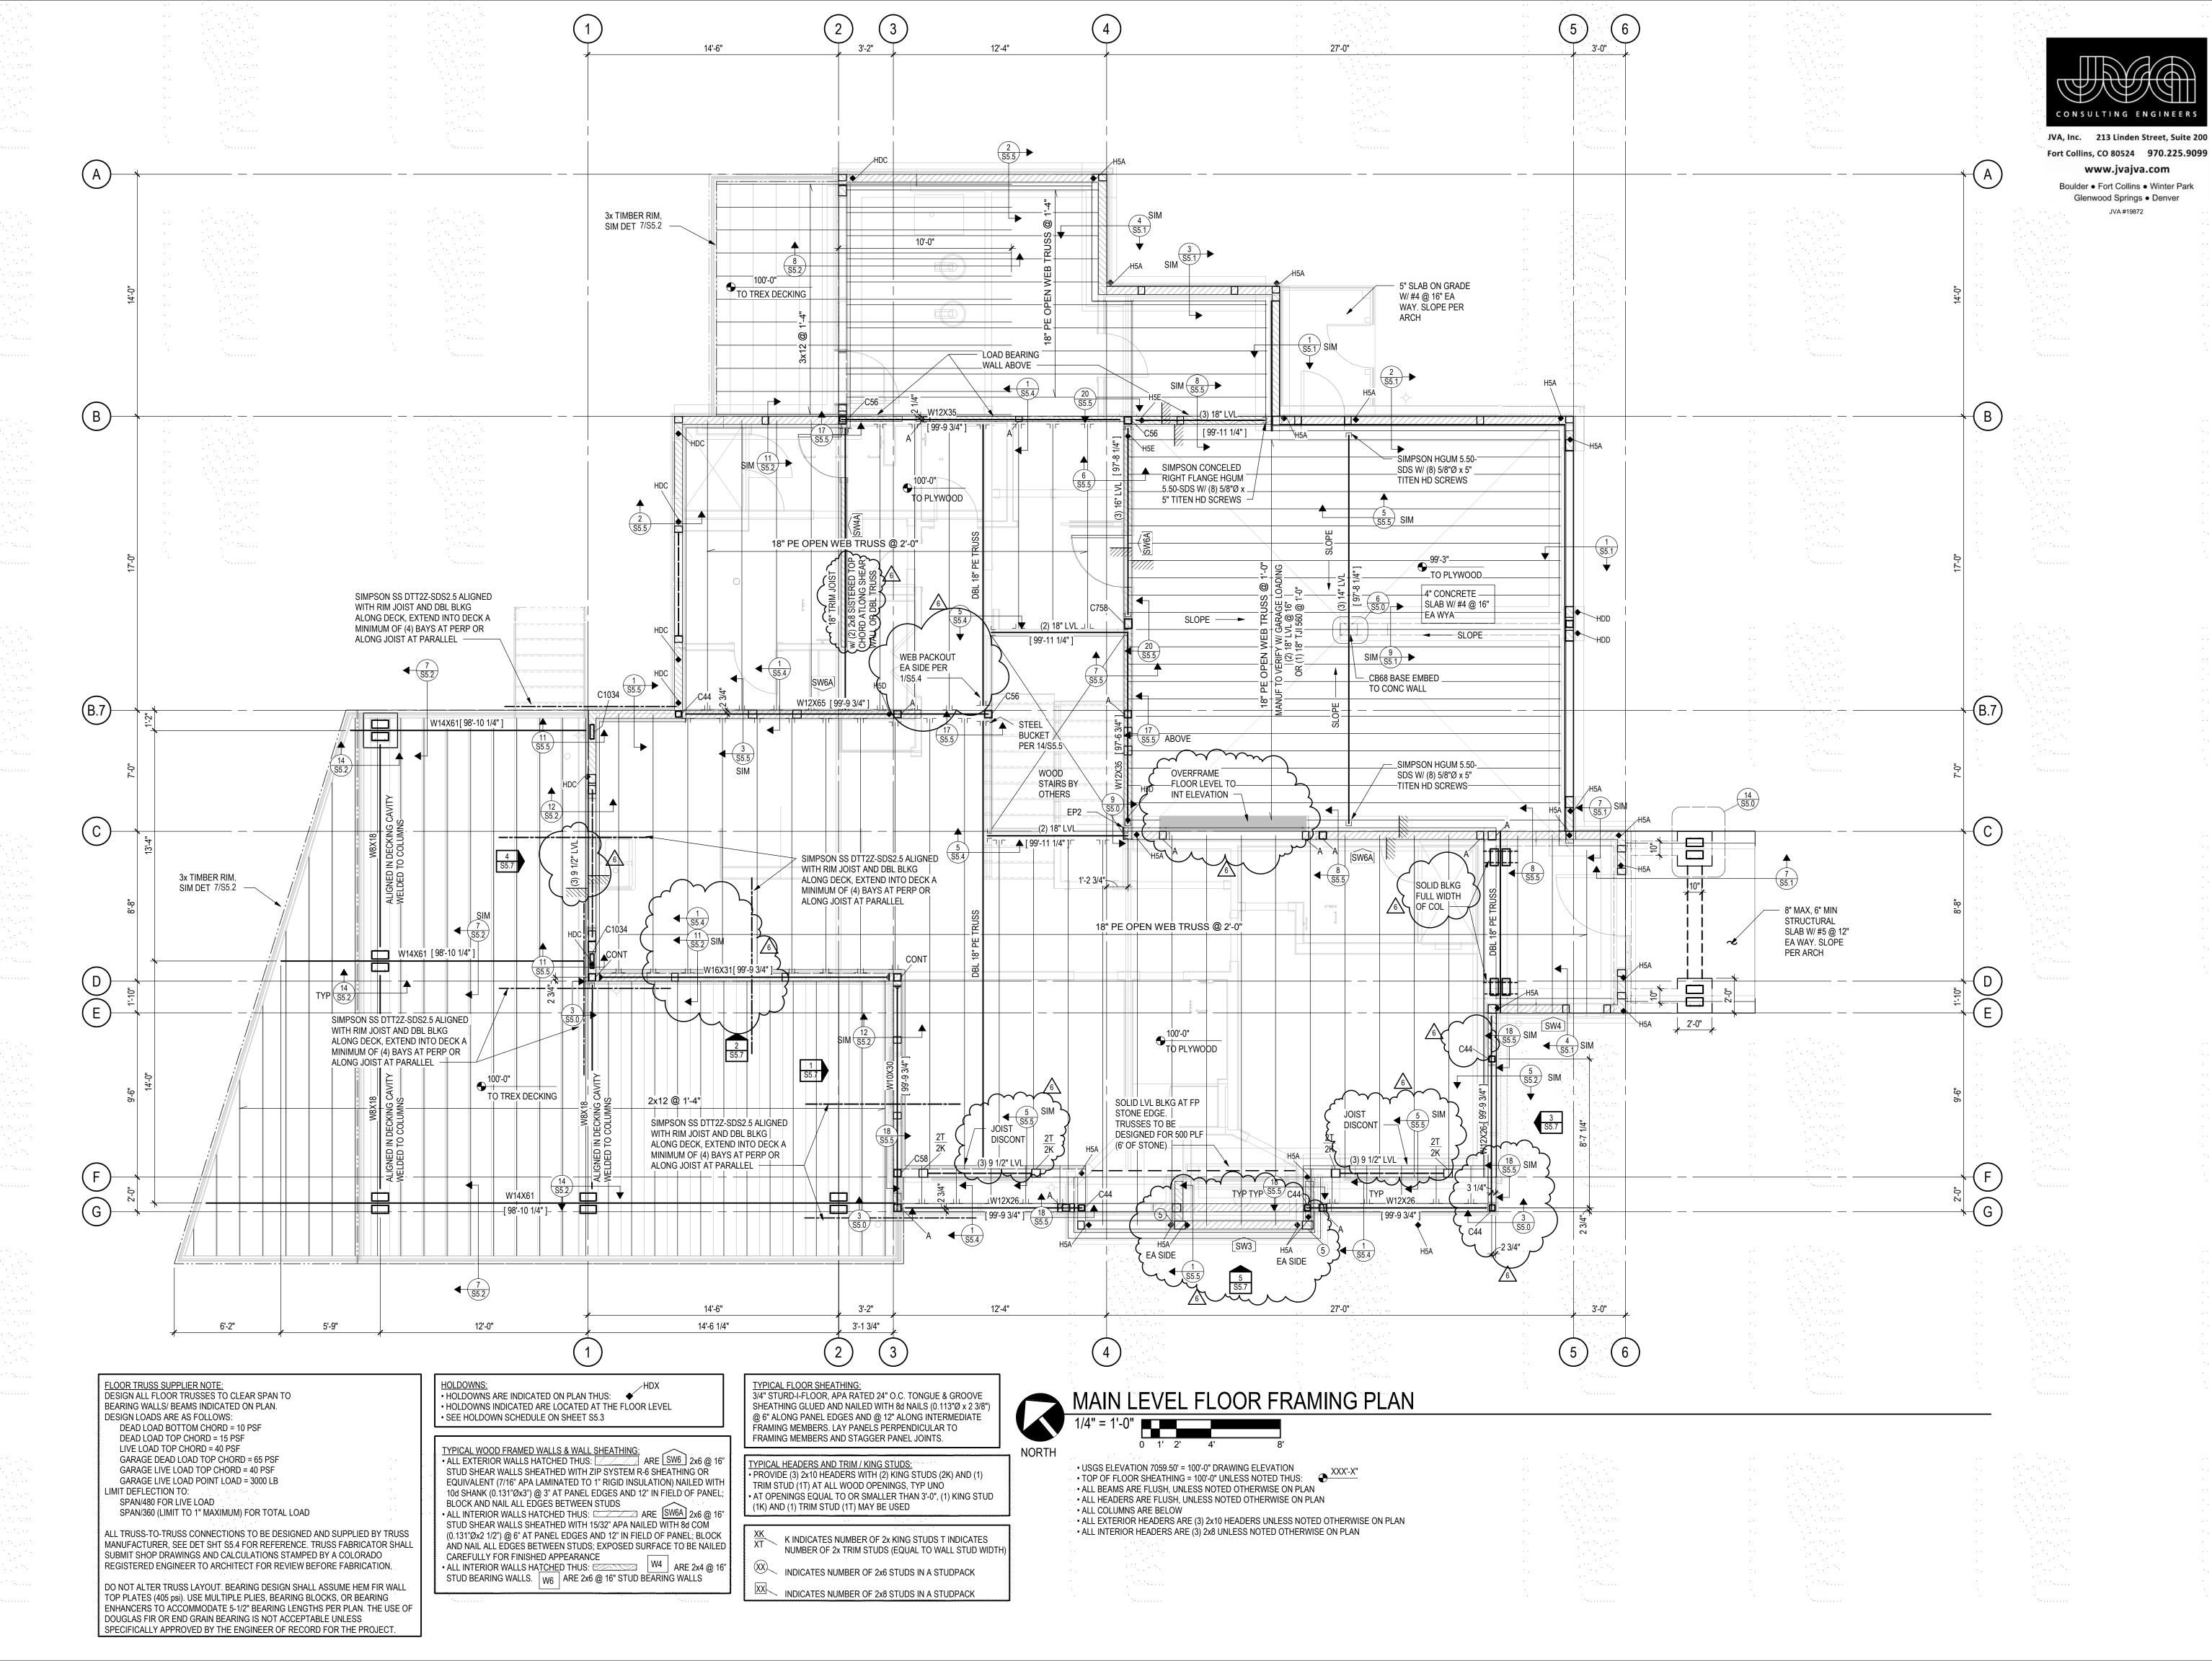
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agle's rings 907 Lot ( Steambo

ISSUE NAME DATE VE REVISIONS FOUNDATION REVISIONS 03/13/2020 DRAWING TITLE

LOWER LEVEL FRAMING PLAN

SHEET NO.



VERTICAL A R T S

ARCHITECTURE
PLANNING
LANDSCAPE
INTERIORS

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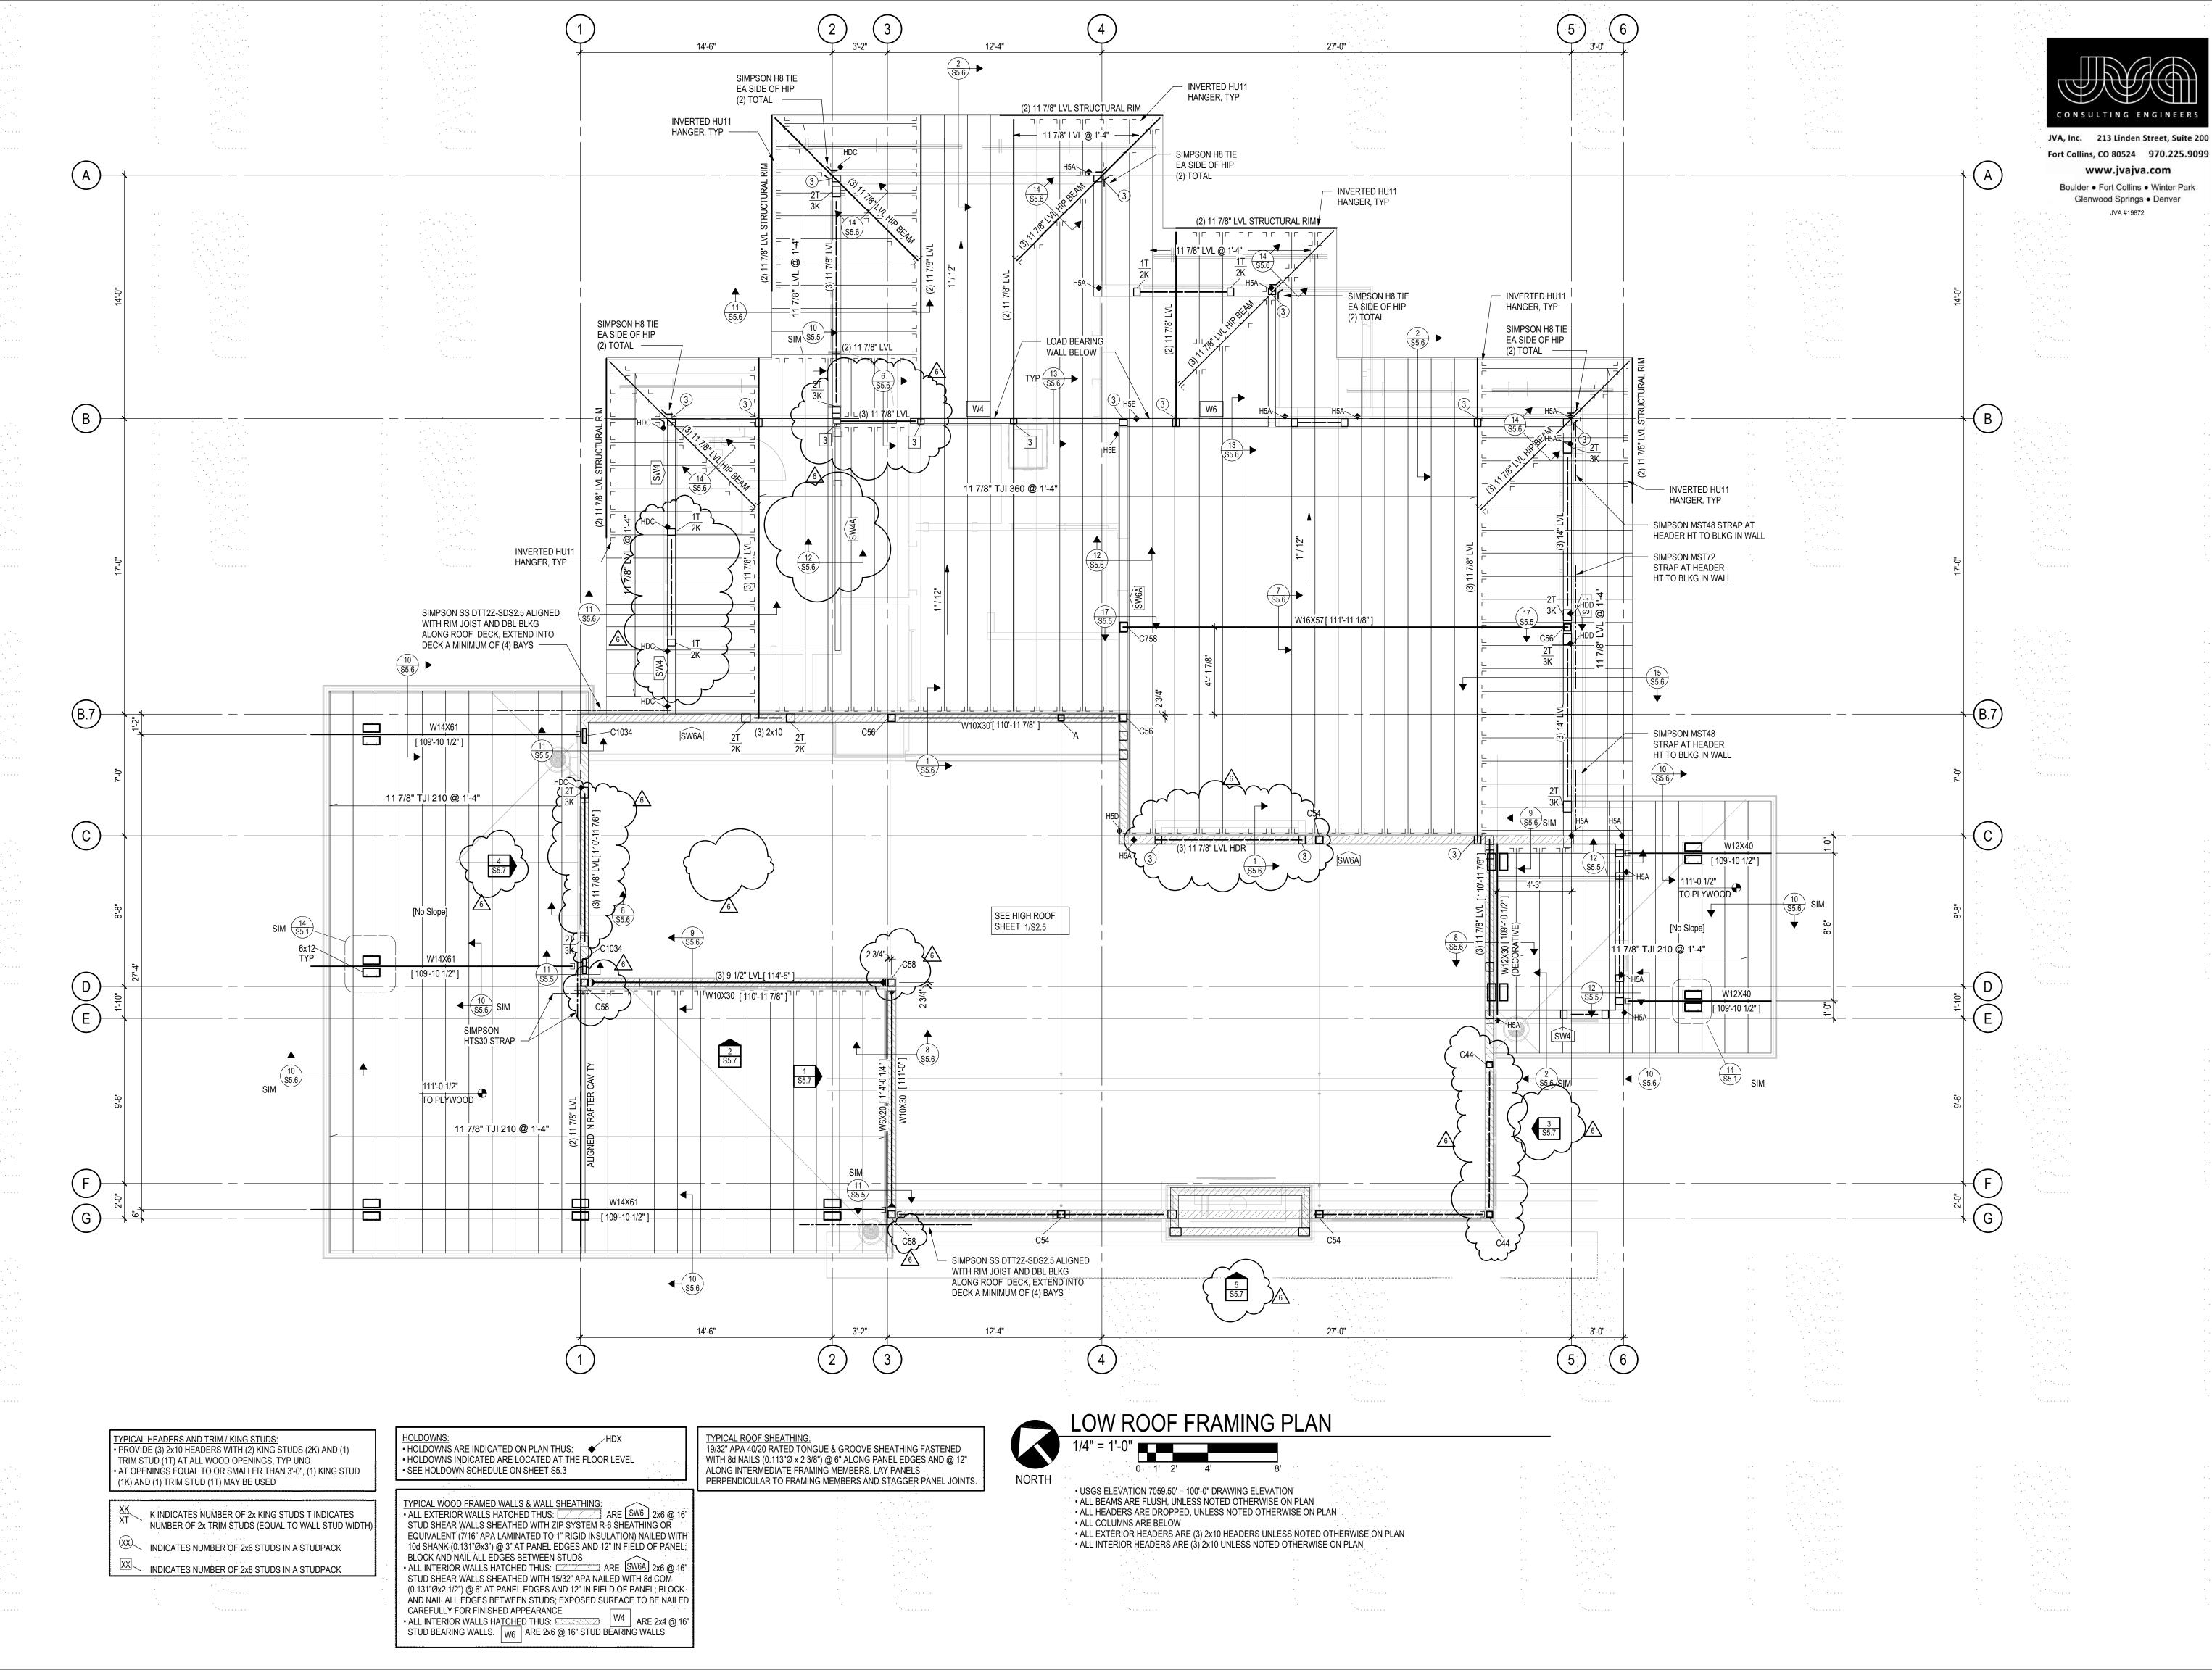
CAMPBELL RESIDENCE
Lot 5 - Eagle's Vista
Steamboat Springs, CO 804
1907

DRAWING TITLE

MAIN LEVEL FLOOR FRAMING PLAN

SHEET NO.

S2 3



ARCHITECTURE
PLANNING
LANDSCAPE
INTERIORS

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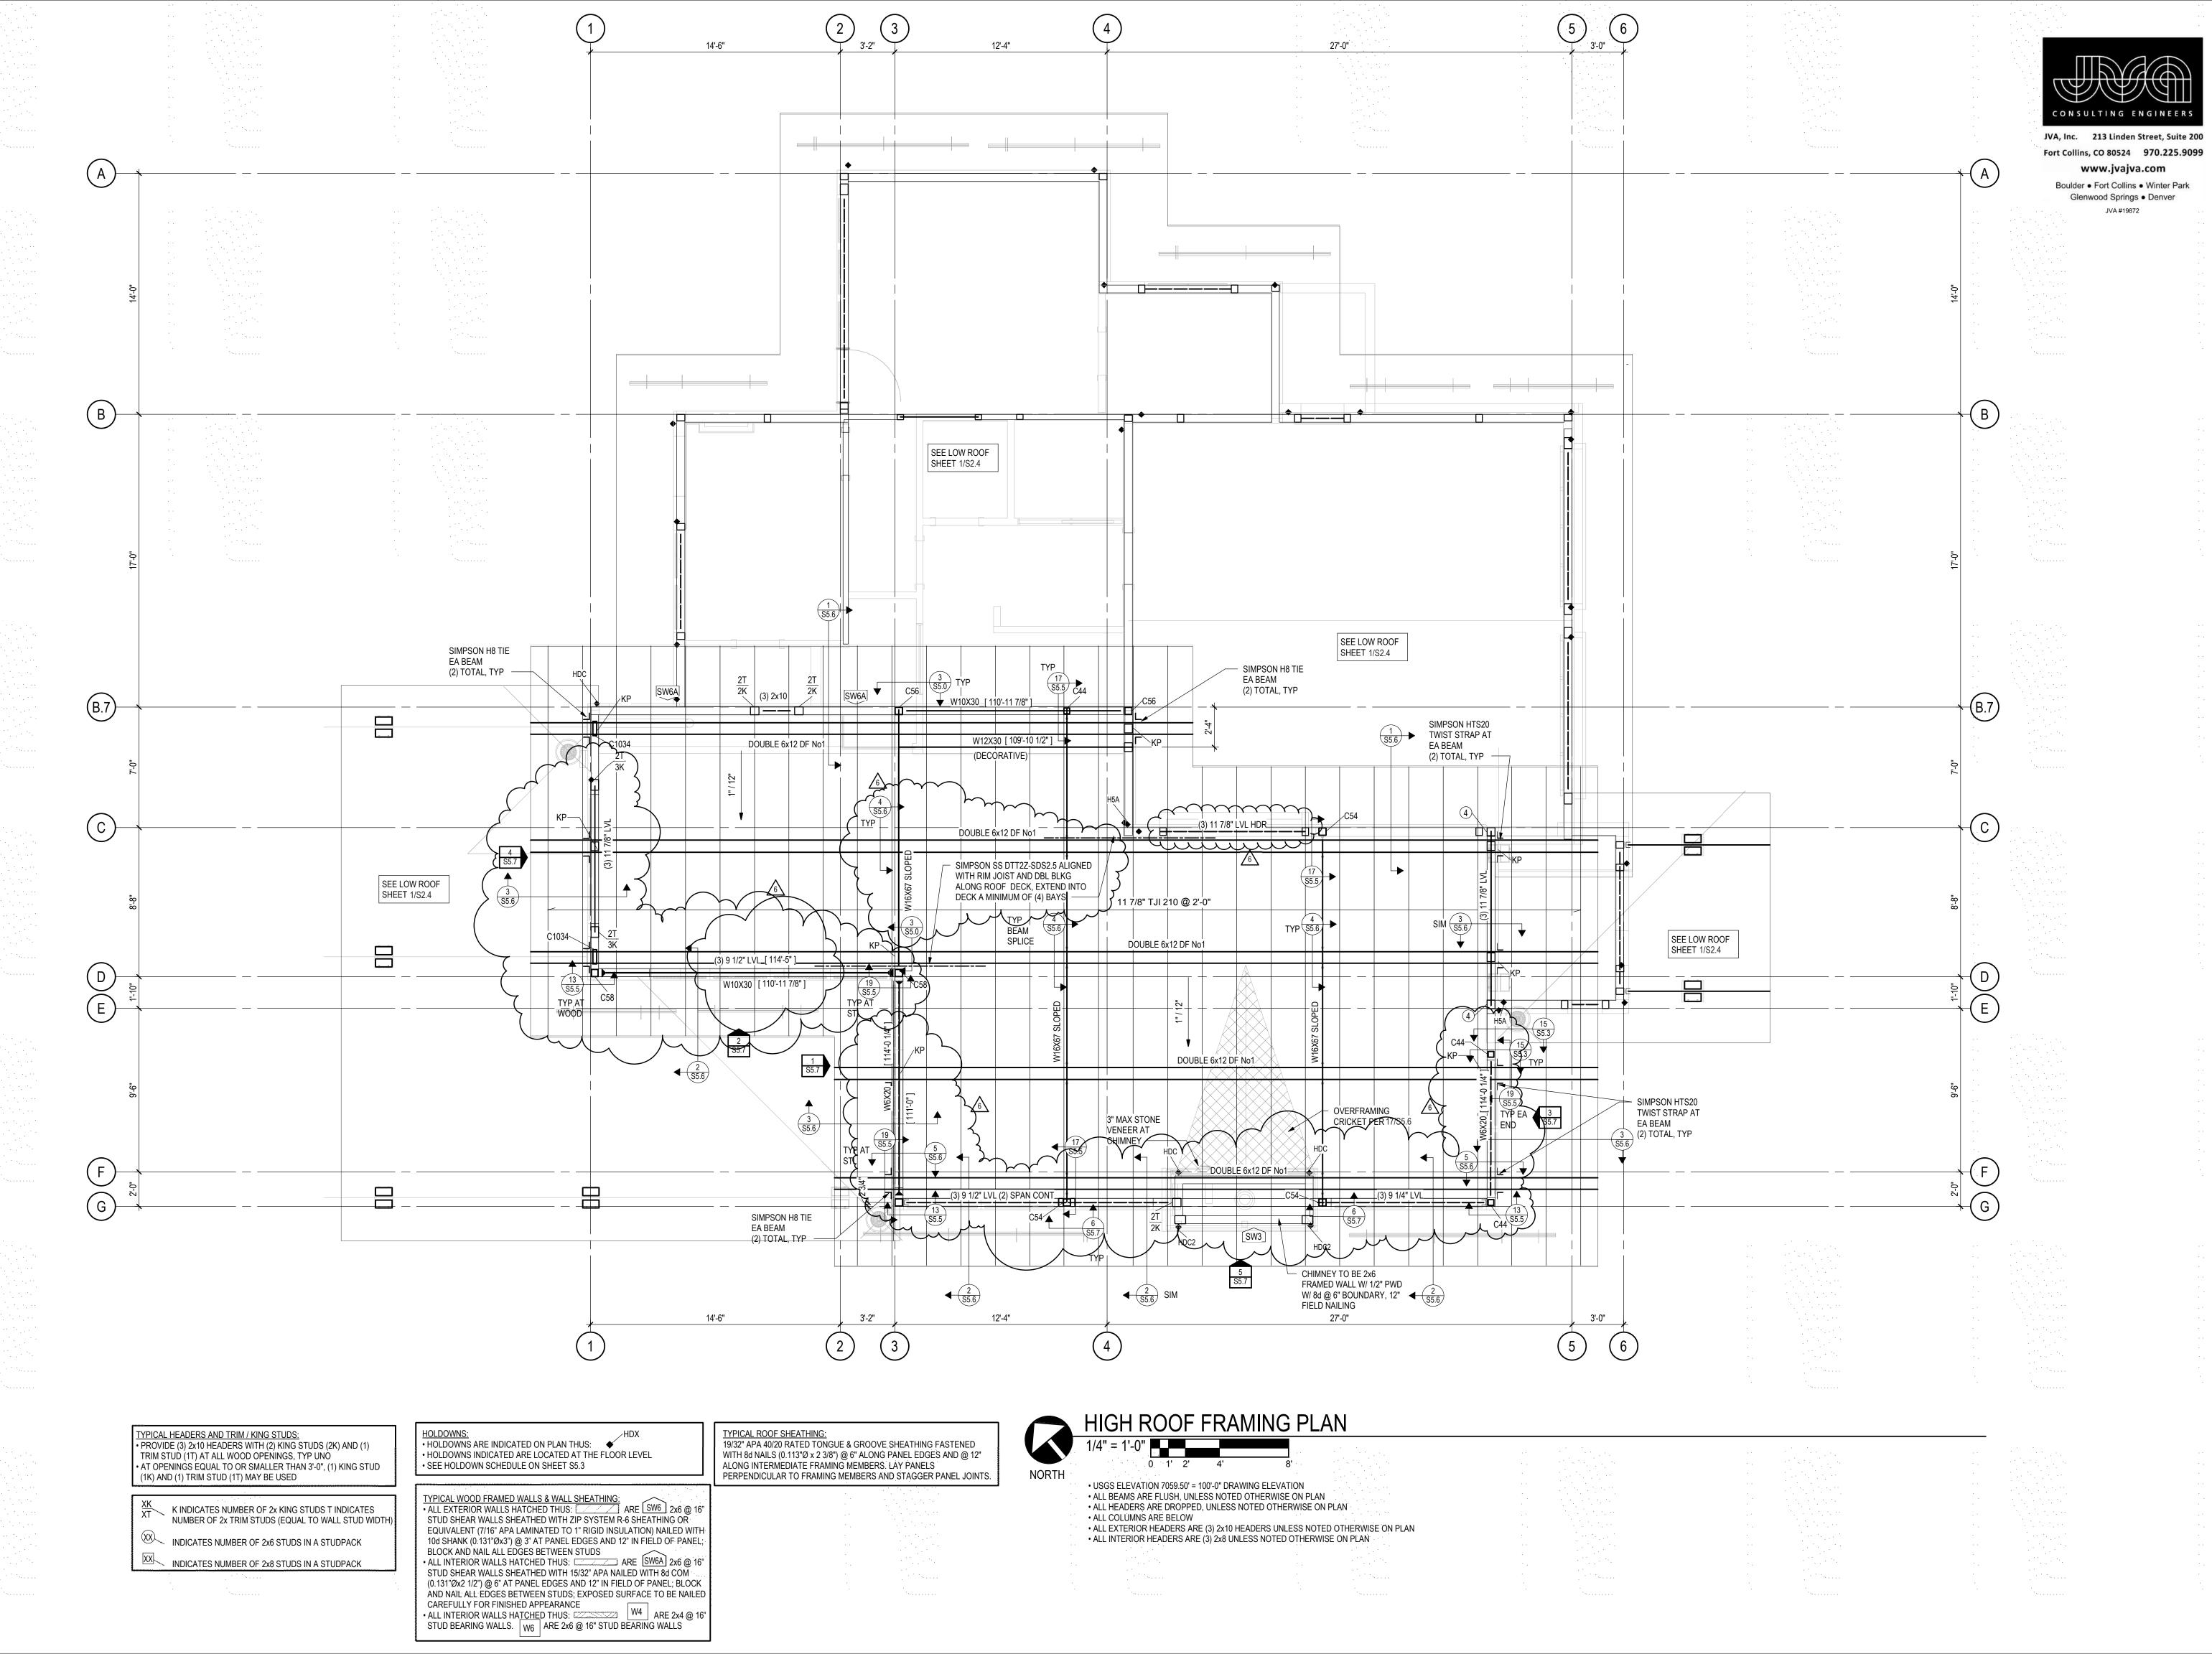
CAMPBELL RESIDENCE Lot 5 - Eagle's Vista Steamboat Springs, CO 8048 1907

DRAWING TITLE

LOW ROOF FRAMING PLAN

SHEET NO.

S2.4



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ARCHITECTURE

**PLANNING** 


CAMPBELL RESIDENCE Lot 5 - Eagle's Vista Steamboat Springs, CO 804 1907


DRAWING TITLE

HIGH ROOF FRAMING PLAN

SHEET NO.

52.5

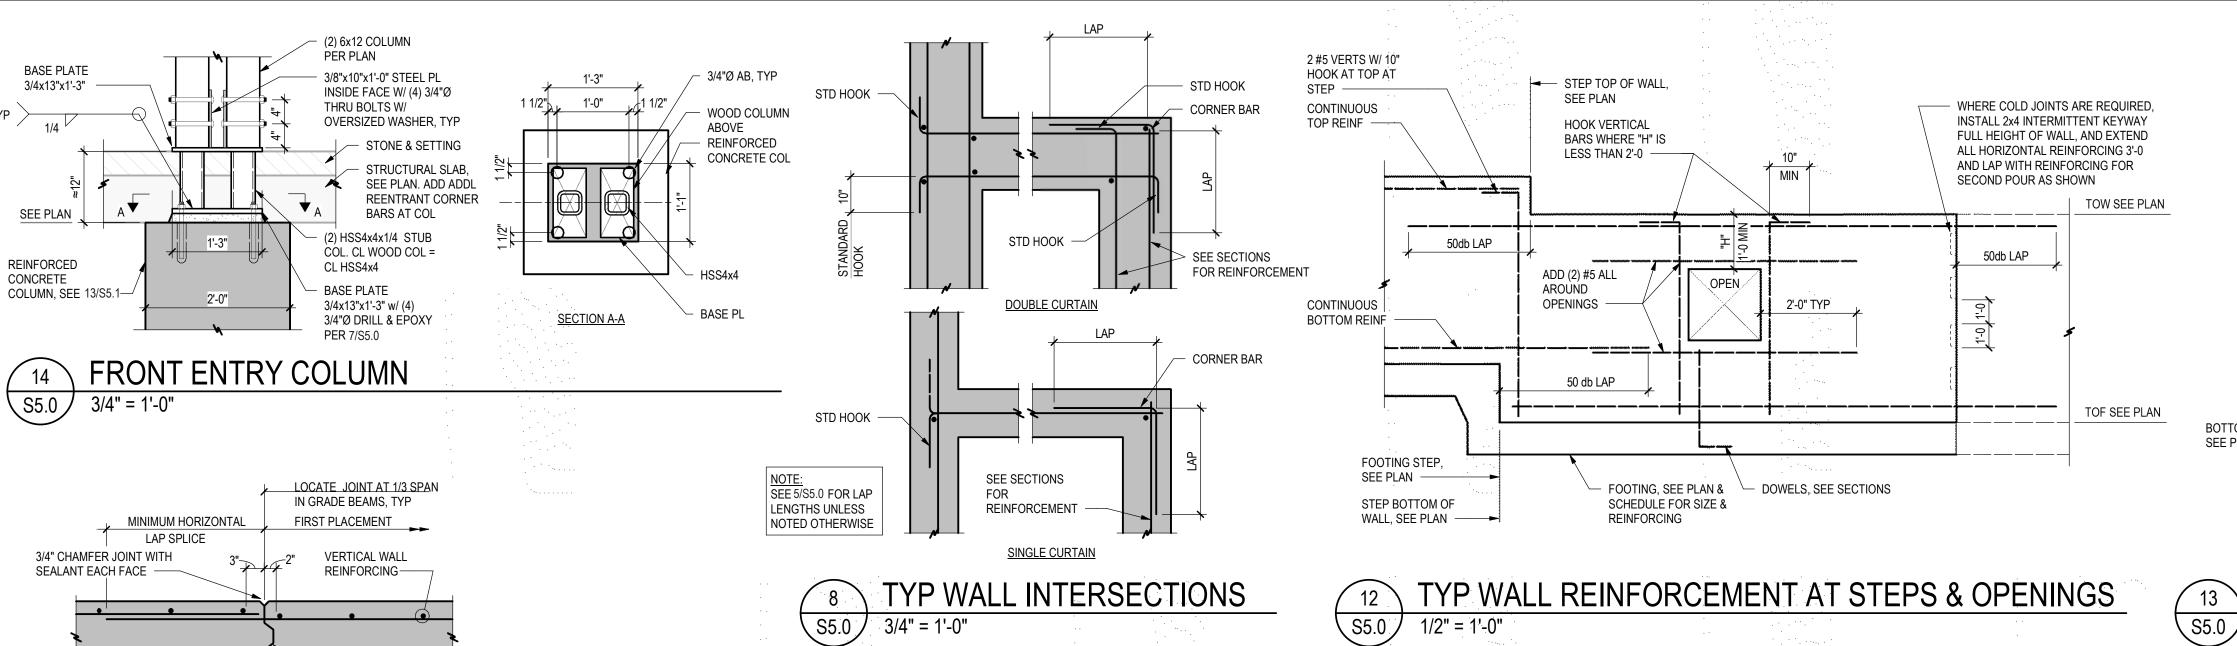

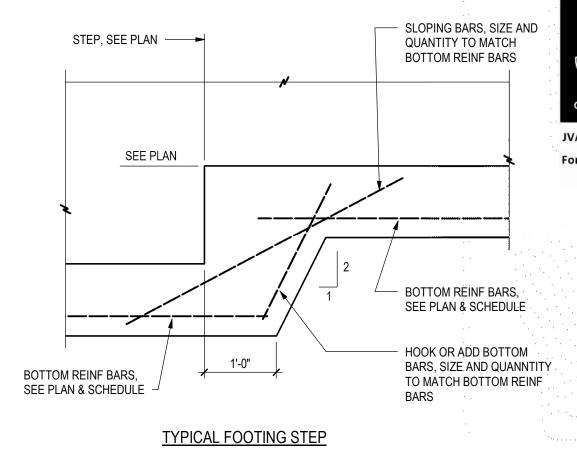

TYP FOOTING STEP DETAIL

POSITION AS REGULAR REINFORCING

EXTRA BARS EQUAL IN TOTAL AREA TO REGULAR

REINFORCING CUT BY OPENING. PLACE ONE HALF TOTAL AREA

TO EACH SIDE OF OPENING AND IN THE SAME TRANSVERSE

#5x(D+12")EACH


**REINF MAT** 



**ARCHITECTURE PLANNING** LANDSCAPE INTERIORS

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8048

MPB

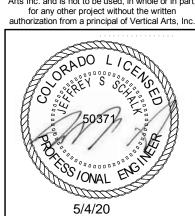INSTALL

TORQUE

(FT-LB)

100

TORQUE

(FT-LB)

ot

ISSUE NAME | DATE

FOUNDATION REVISIONS 03/13/2020

DRAWING TITLE

SHEET NO.

SCHEDULES &

TYPICAL DETAILS

**S5.0** 

VE REVISIONS

ing 07

FOR CIRCULAR OPENINGS

MIN LAP

TYPICAL ADDED REINFORCING AT OPENINGS TRIM REINFORCING DETAIL

3/4" = 1'-0"

SCREW ANCHOR IN 2500 PSI MIN & 21 DAY AGE MIN DRY CONCRETE MINIMUM MINIMUM MINIMUM CONCRETE ANCHOR.

EMBEDMENT |

3 1/4"

AND PILOT

HOLE DIA

1/2"ø

5/8"ø

EDGE OF CONC AS OCCURS —

3/4"ø 5 1/2" 150 3/8"ø KH-EZ 1/2"ø 1 3/4" 4 3/4" 10 45 (ICC-ESR 5/8"ø 3 1/4" 1 3/4" 10 3027) 1 3/4" 20 3/4"ø 6" ANCHORS PER PLAN & TOP OF DETAILS CONC -PL HOLE SHALL BE 1/8" LARGER THAN ANCHOR DIA

1 3/4"

EDGE DIST | SPACING

SIMPSON

TITEN HD (ICC-

ESR 2713)

1. INSTALL SCREW ANCHORS PER MANUFACTURER'S INFORMATION AND ICC REPORT INSTRUCTIONS. SPECIAL INSPECTION IS REQUIRED PER SECTION 1705 OF THE IBC AND THE REQUIREMENTS OF THE ICC REPORTS. INSTALLED ANCHORS SHALL BRING CONNECTED PLIES INTO FIRM CONTACT, MEETING THE INSTALL TORQUE BUT NOT EXCEEDING THE MAXIMUM INSTALL TORQUE.

2. CONTRACTOR TO VERIFY MINIMUM EDGE DISTANCES, SPACING AND THICKNESS ARE IN ACCORDANCE WITH SCHEDULE PRIOR TO INSTALLING ANCHOR.

3. HOLES TO BE DRILLED WITH ROTARY DRILL ONLY. WHEN INSTALLING DRILLED-IN ANCHORS IN EXISTING REINFORCED CONCRETE, USE CARE AND CAUTION TO AVOID CUTTING OR DAMAGING THE EXISTING REINFORCING BARS. MAINTAIN A REASONABLE CLEARANCE BETWEEN REINFORCEMENT AND

4. THE SPECIAL INSPECTOR MUST BE ON THE JOBSITE PERIODICALLY DURING ANCHOR INSTALLATION TO VERIFY ANCHOR TYPE, ANCHOR DIMENSIONS, HOLE CLEANLINESS, EMBEDMENT DEPTH, CONCRETE TYPE, CONCRETE COMPRESSIVE STRENGTH, DRILL BIT DIAMETER, HOLE DEPTH, EDGE DISTANCE(S). ANCHOR SPACING(S), CONCRETE THICKNESS, AND TIGHTENING TORQUE.

THE DRILLED-IN ANCHOR. FILL ABANDONED HOLES WITH HIGH STRENGTH GROUT.





EMBED PL ~SET T/ EMBED PL @ TOP OF BEAM EMBED PL (SEE PLANS

& SCHEDULE ~TAB, SEE 3/S5.0 **EMBEDDED PLATE SCHEDULE** 

**HEADED ANCHOR STUDS** LENGTH WIDTH THICKNESS NUMBER DIAMETER LENGTH COLUMN ROW

\* ALL EMBEDDED PLATES SHALL BE PLACED WITH EXPOSED FACE FLUSH TO EXPOSED FACE OF CONCRETE WALL

SCHEDULE

 $\sqrt{55.0} / 3/4" = 1'-0"$ 

ADHESIVE ANCHOR IN 2500 PSI MIN & 21 DAY AGE MIN CONCRETE ANCHOR MIN EDGE **ADHESIVE** TYPE HOLE DISTANCE | SPACING THICKNESS THRD UNO ROD 6 1/2" SET-XP 8 1/4" (ICC-ESR 3/4"ø 9 1/4" 2508) 4 1/4" RE 500-SD (ICC-ESR 3/4"ø 7 1/2" 2322) 7/8"ø TOP OF ANCHORS PER CONC PLAN & . DETAILS.

CONTRACTOR TO VERIFY MINIMUM EDGE DISTANCES. SPACING AND THICKNESS ARE IN ACCORDANCE WITH SCHEDULE PRIOR TO INSTALLING ANCHOR.

HOLES TO BE DRILLED WITH ROTARY DRILL ONLY. WHEN DRILLING HOLES IN EXISTING CONCRETE, USE CARE AND CAUTION TO AVOID CUTTING OR DAMAGING THE EXISTING REINFORCING BARS. MAINTAIN A REASONABLE CLEARANCE BETWEEN REINFORCEMENT AND THE DRILLED-IN ANCHOR. FILL ABANDONED HOLES WITH HIGH STRENGTH GROUT.

4. SPECIAL INSPECTION IS REQUIRED PER IBC SECTION 1705 AND THE REQUIREMENTS OF THE ICC REPORTS. THE SPECIAL INSPECTOR MUST BE ON THE JOB SITE PERIODICALLY DURING ANCHOR INSTALLATION TO VERIFY ANCHOR TYPE, ANCHOR DIMENSIONS, HOLE CLEANLINESS, EMBEDMENT DEPTH, CONCRETE TYPE, CONCRETE COMPRESSIVE STRENGTH, DRILL BIT DIAMETER, HOLE DEPTH, EDGE DISTANCE(S), ANCHOR SPACING(S), CONCRETE THICKNESS, AND ADHESIVE INJECTION.

ADHESIVE ANCHORS

EDGE OF CONC E S

AS OCCURS —

S5.0

S5.0

## MINIMUM LAP SPLICE LENGTH AND STANDARD HOOK MINIMUM LAP SPLICE 90° DEGREE **BAR SIZE HOOK DIMENSION** LENGTH 4 2'-8" 9" 12" 5 3'-4" 4'-0" 14" 6 7 5'-10" 16" 8 6'-8" 18" 7'-6" 9 23" 8'-6" 26"

2x4 BEVELED KEY 8"

STEP TOP OF WALL

LVL GIRDER W/ CB

CONT HORIZ TO END

- #5 @ 12" EA WAY

BASE, SEE PLAN

TYPICAL VERTICAL CONSTRUCTION JOINT IN WALL

PLAN DETAIL AT GIRDER OVER WALL END

PLAN DETAIL AT CONC WALL END

COUNTERFORT WALL END

WALL CONSTRUCTION JOINT

LONG @ 8" CLR SPACING

LAP SCHEDULE

HORIZONTAL WALL

REINFORCING -


(6) #5 VERT


#3 TIES @ 8" -

FOOTING SCHEDULE				
MARK	WIDTH	LENGTH	THICKNESS	REINFORCING
F2.0	2'-0"	2'-0"	1'-0"	(3) #5 EACH WAY, BOTTOM
F2.5	2'-6"	2'-6"	1'-0"	(3) #5 EACH WAY, BOTTOM
F3.0	3'-0"	3'-0"	····· 1'-0"	(4) #5 EACH WAY, BOTTOM
F4.0	4'-0"	4'-0"	1'-0"	(5) #5 EACH WAY, BOTTOM
F4.5	4'-6"	4'-6"	1'-0"	(5) #5 EACH WAY, BOTTOM
F6.0	6'-0"	6'-0"	1'-2"	(7) #5 EACH WAY, BOTTOM
F24	2'-0"	CONT	1'-0"	(3) #5 CONT, #5 @ 16" TRANSVERSE
F30	2'-6"	CONT	1'-0"	(3) #5 CONT, #5 @ 16" TRANSVERSE
F36	3'-0"	CONT	1'-0"	(4) #5 CONT, #5 @ 16" TRANSVERSE

CENTER FOOTINGS UNDER STEMWALLS, PILASTERS, & COLUMNS, TYPICAL UNLESS NOTED OTHERWISE • FOOTING WIDTHS SHALL NOT VARY IN THE FIELD FROM SIZE NOTED; OVERSIZE FOOTINGS ARE NOT ALLOWED • LAPPED BOARD FORMING NOT ALLOWED • TRENCH FORMING NOT ALLOWED

FOOTING SCHEDULE

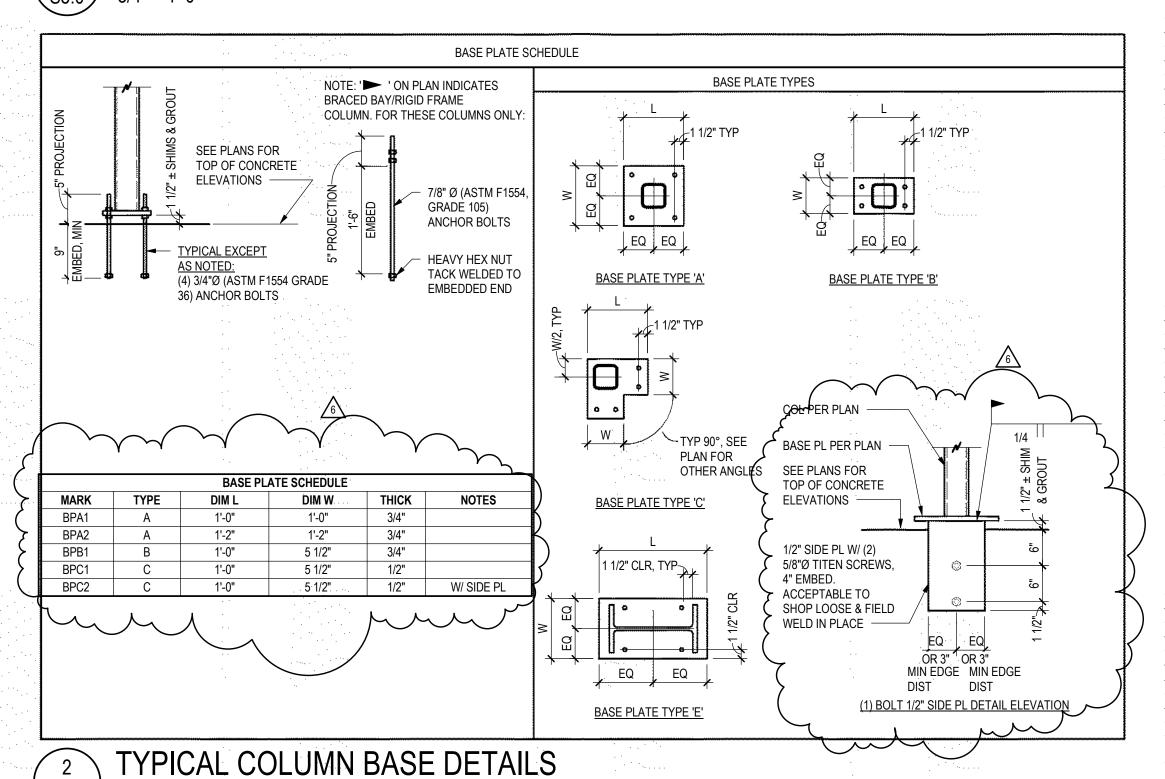

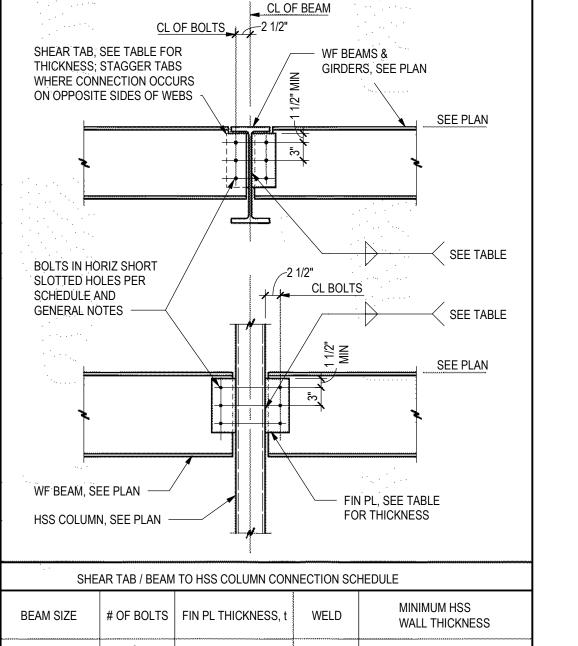

FOR RECTANGULAR OPENINGS

 $\sqrt{S5.0} / 3/4" = 1'-0"$ 

#5x4'-0 EACH


**REINF MAT** 

SHEAR TAB / BEAM TO HSS COLUMN CONNECTION SCHEDULE					
BEAM SIZE	# OF BOLTS	FIN PL THICKNESS, t	WELD	MINIMUM HSS WALL THICKNESS	
W8, W10	2	3/8"	1/4"	3/16"	
W12, W14	3	3/8"	1/4"	3/16"	
W16	4	3/8"	1/4"	3/16"	
W18	5	3/8"	1/4"	3/16"	
W21	6	3/8"	1/4"	1/4"	

I. FLEXIBLE SUPPORT USING A325-N BOLTS IN SHORT SLOTTED HOLES 2. BOLTS ARE TO BE 3/4"Ø EXCEPT WHERE NOTED ON PLAN THAT 1"Ø BOLTS ARE REQUIRED 3. b/t < 37.3 FOR 46ksi TUBE STEEL 4. E70XX WELD ELECTRODES

5. Fy = 36 ksi FOR FIN PLATES 6. BLOCK SHEAR AND BENDING CAPACITY OF COPED MEMBERS MAY GOVERN CAPACITY AND IS CHECKED SEPARATELY 7. MINIMUM WEB THICKNESS, tw, FOR WIDE FLANGE BEAMS IS 3/16" 8. FIN PL THICKNESS IN SCHEDULE SHALL NOT BE INCREASED FOR CONVENIENCE OF FABRICATOR

SCHEDULE S5.0

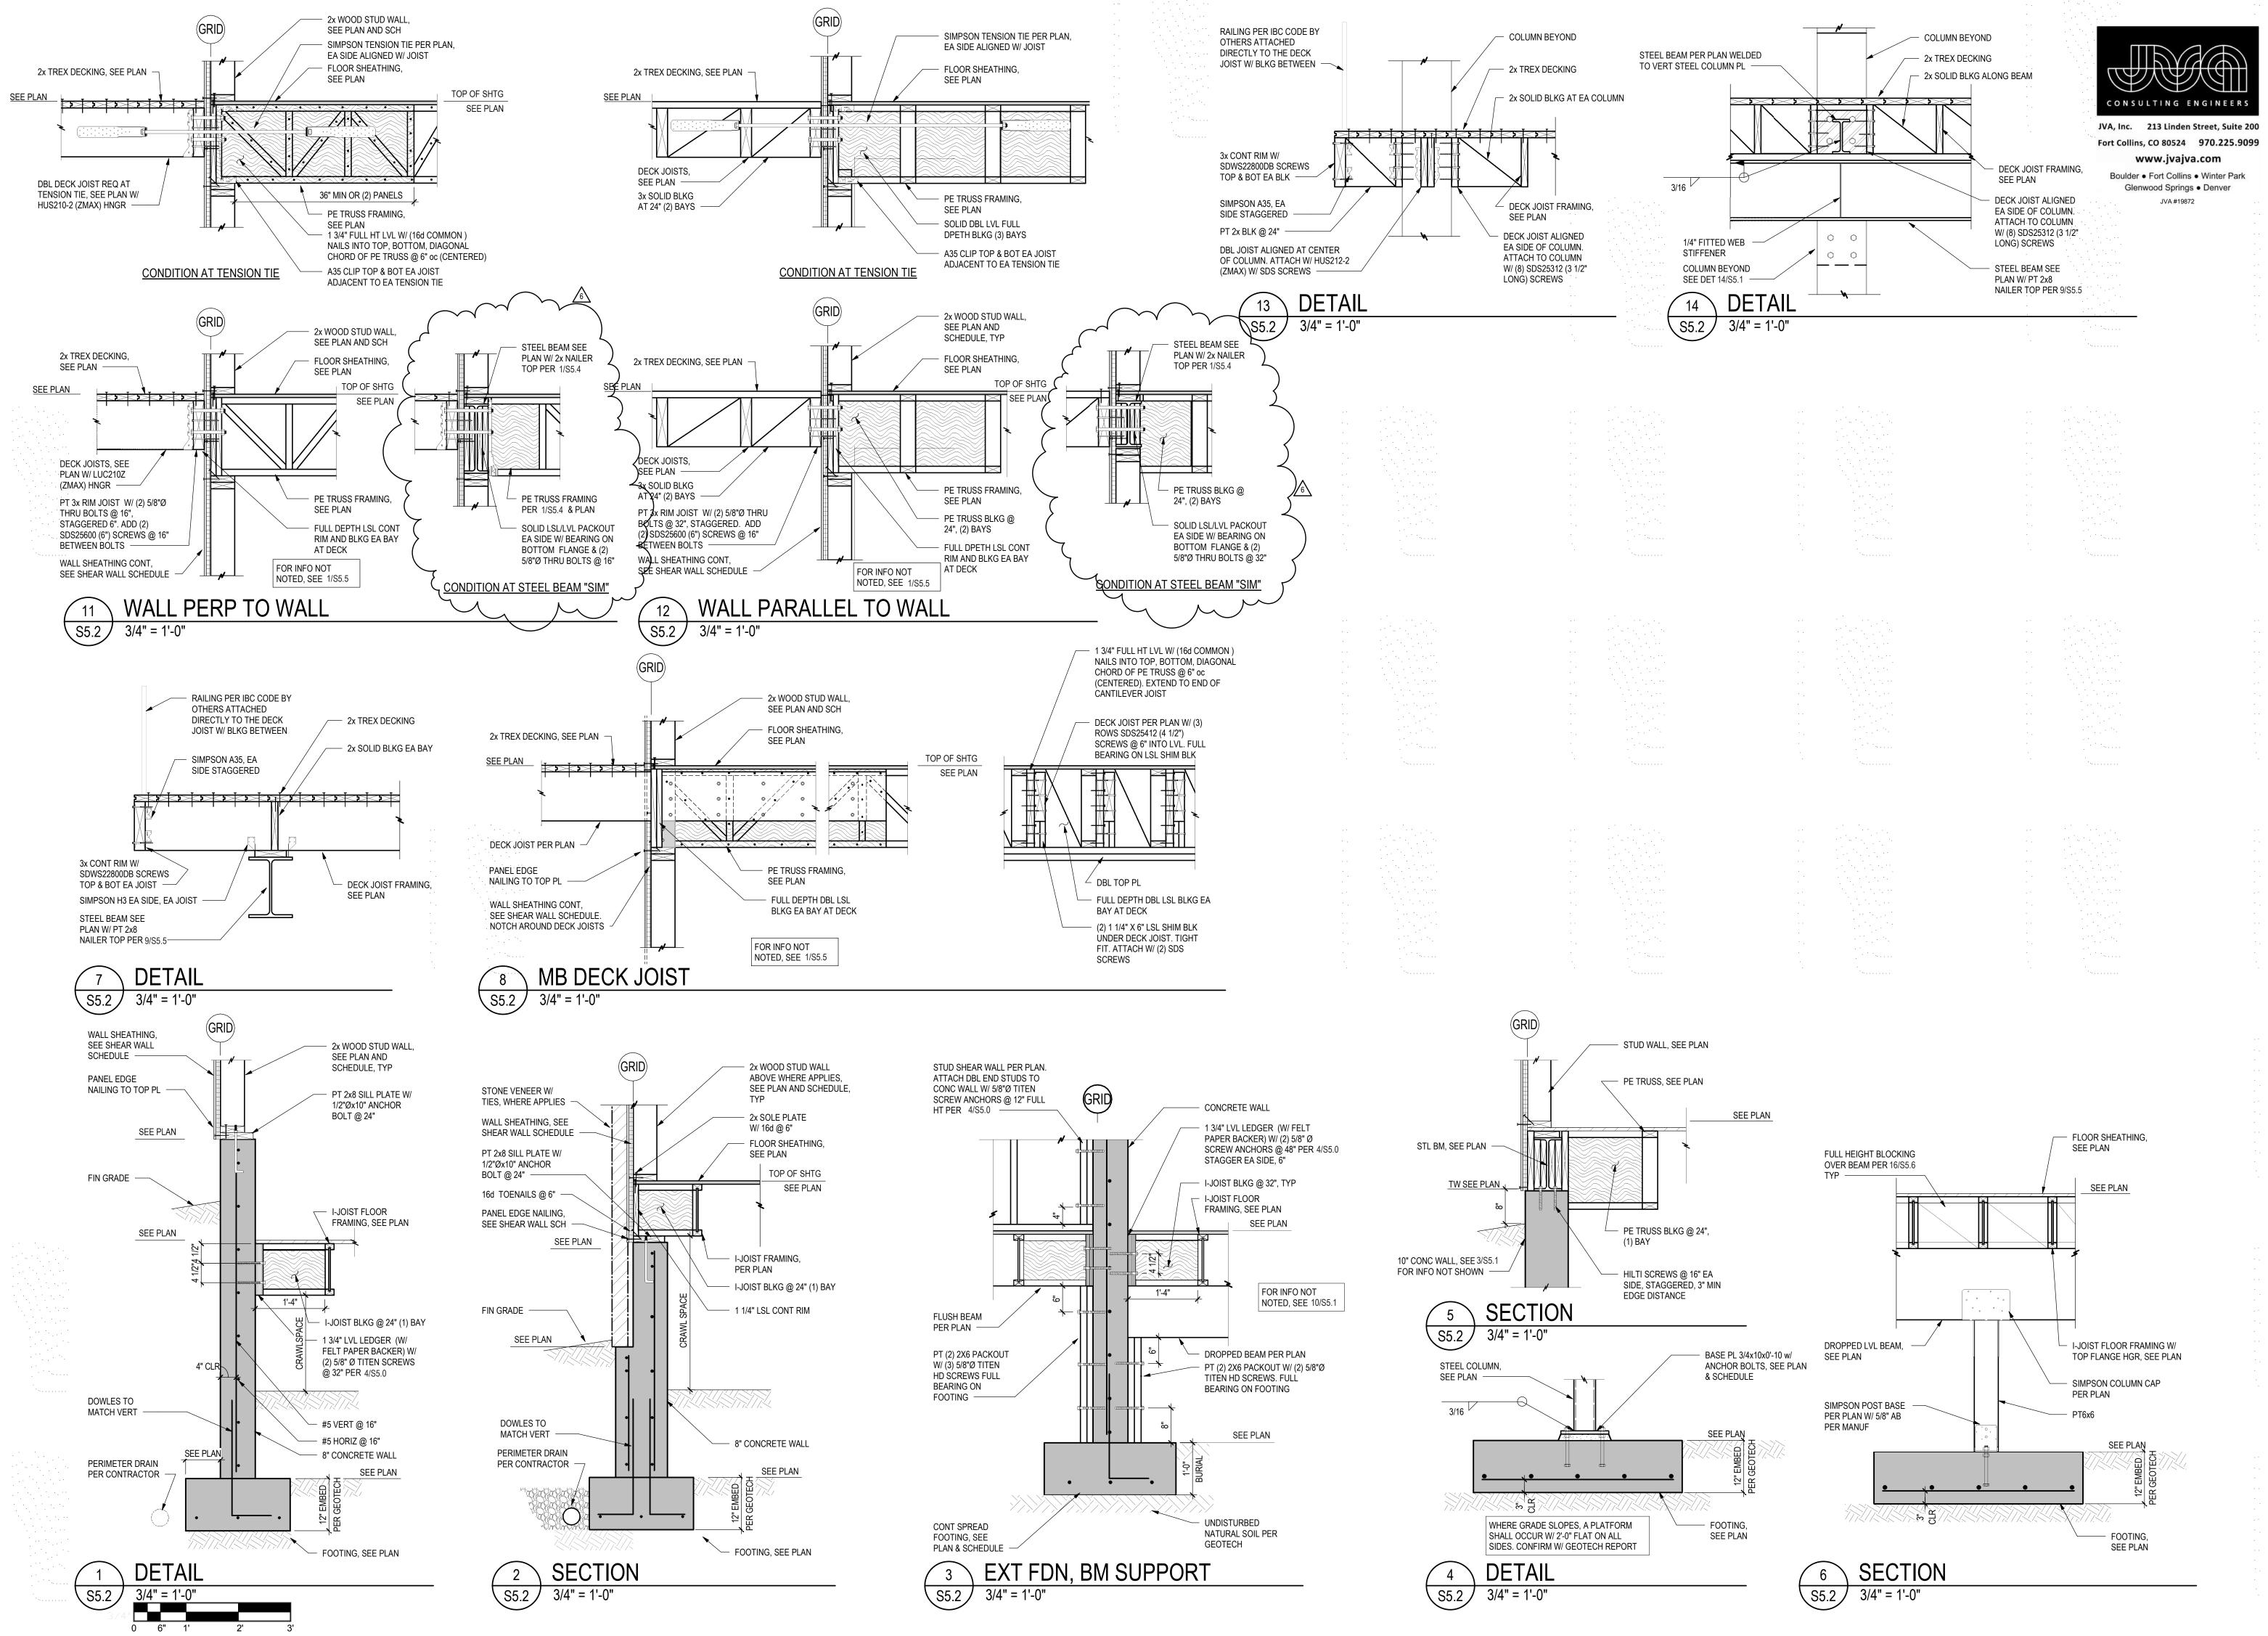




**PLANNING** LANDSCAPE INTERIORS


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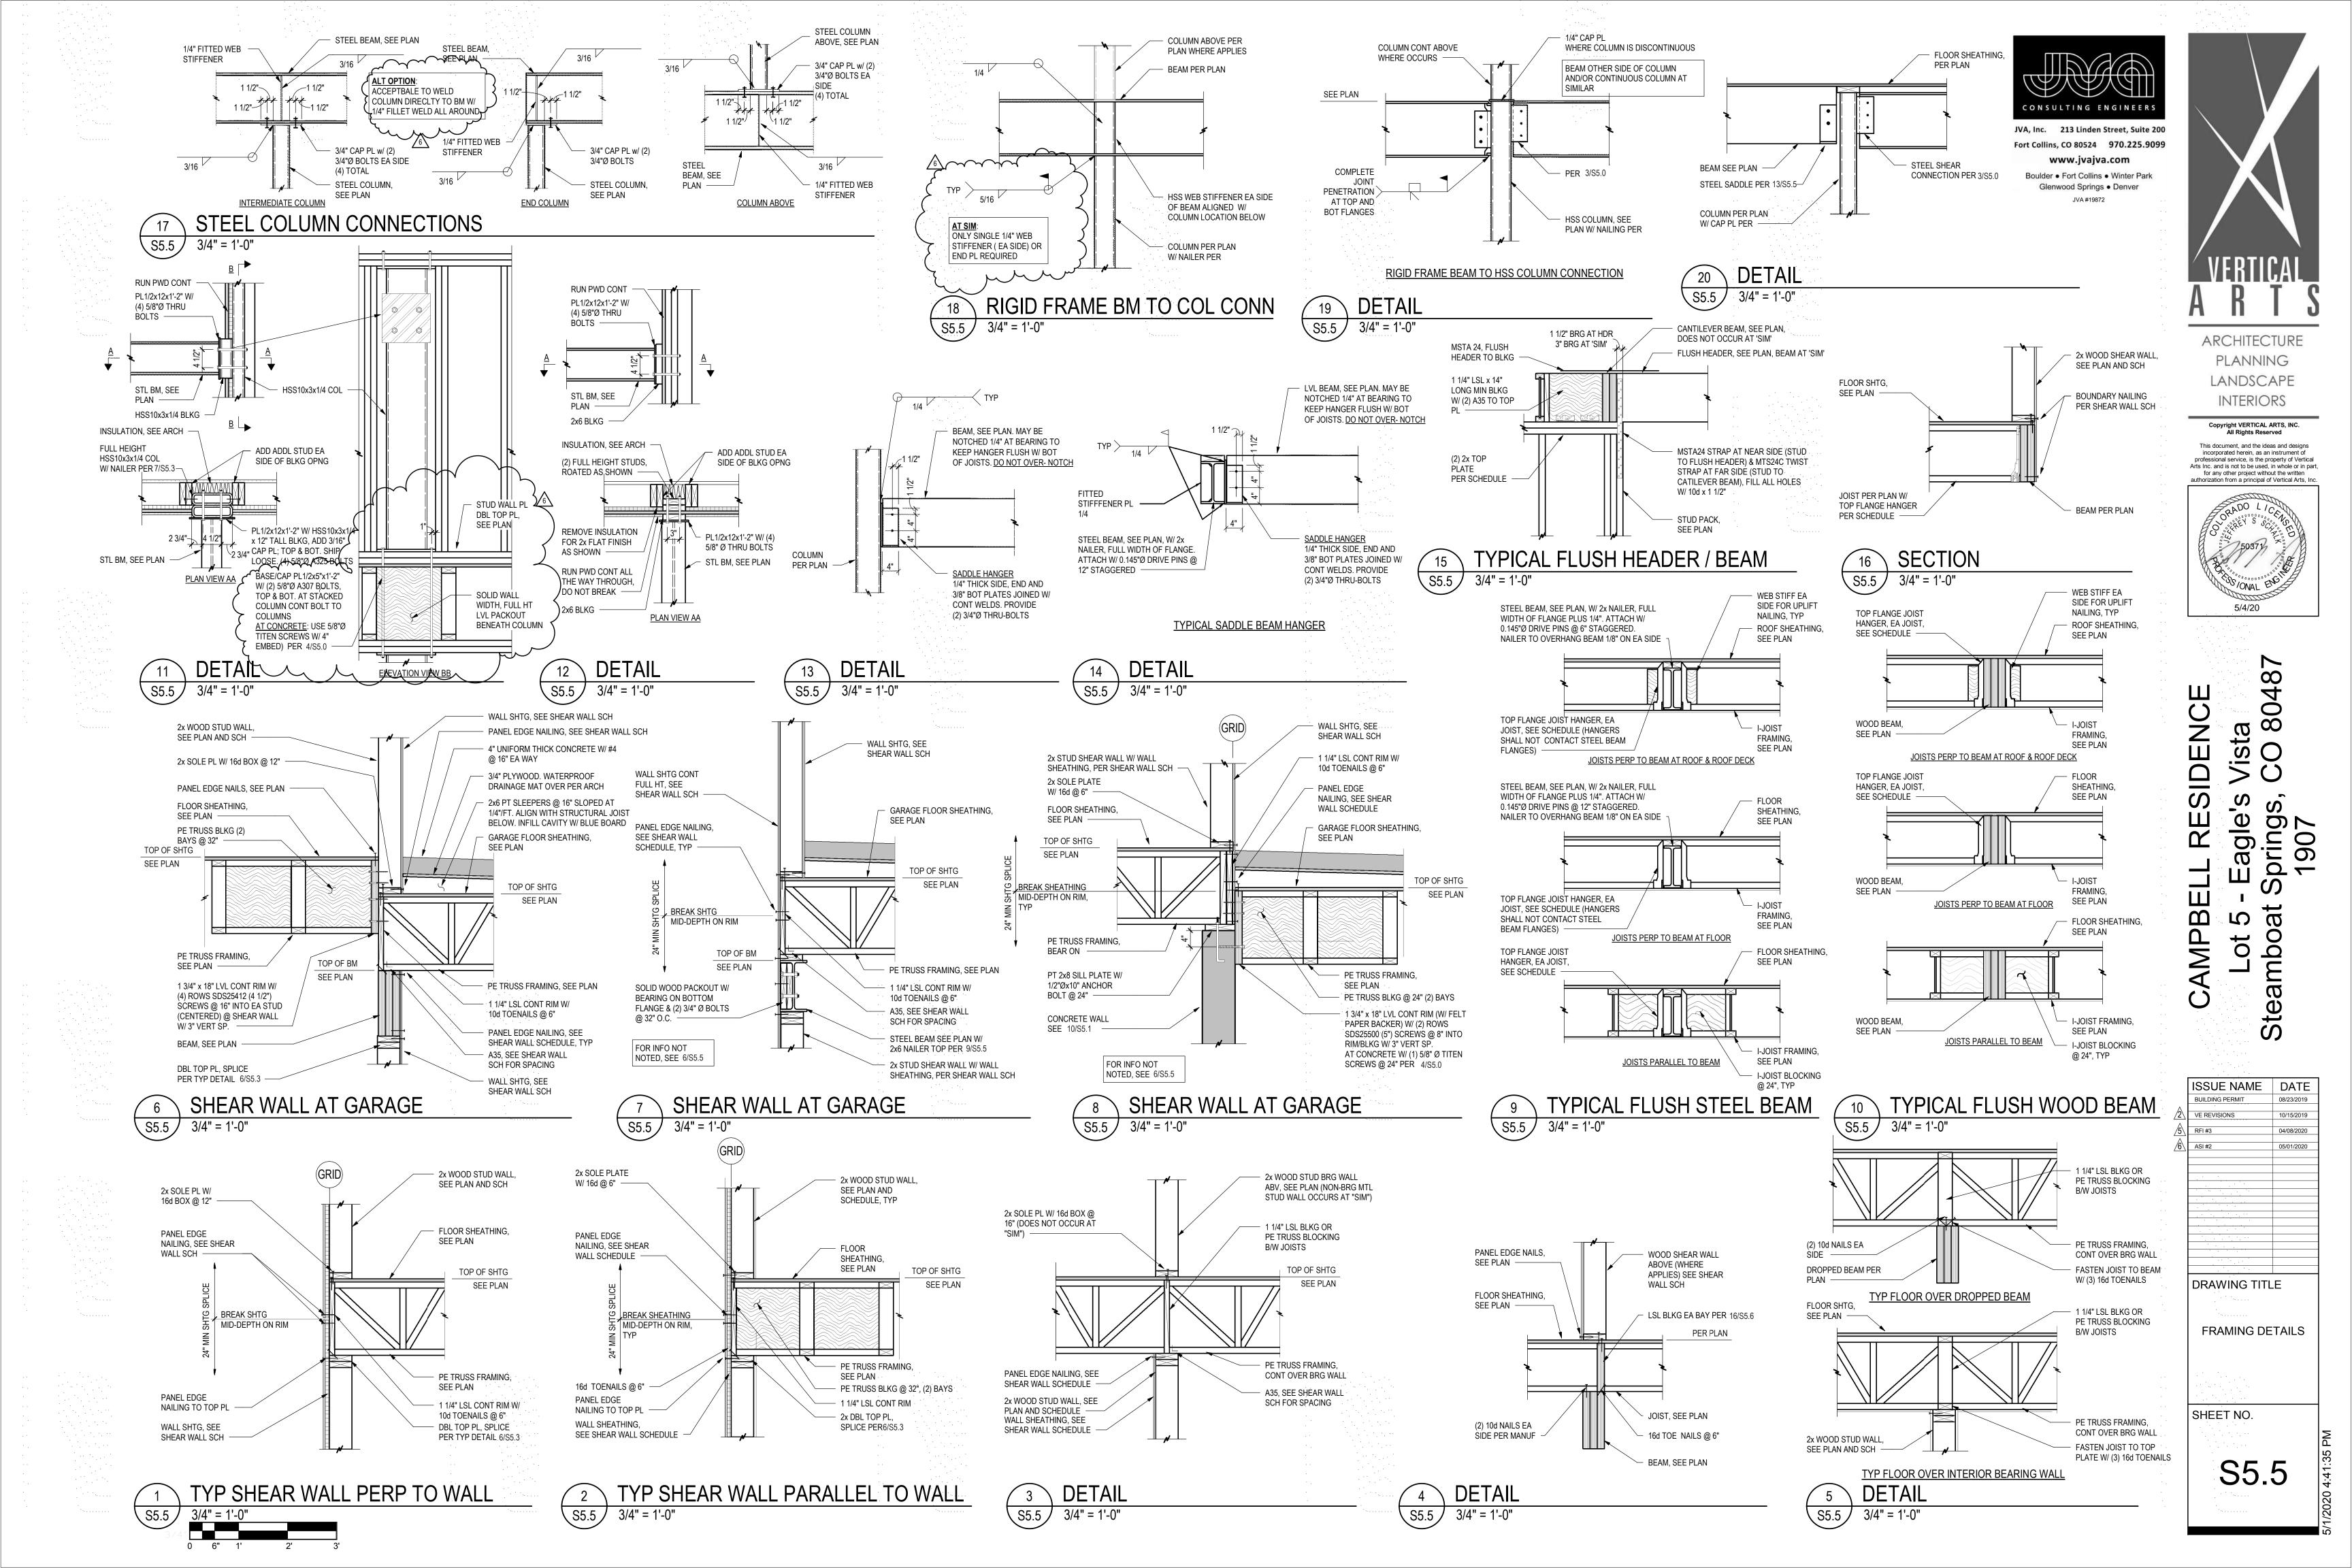
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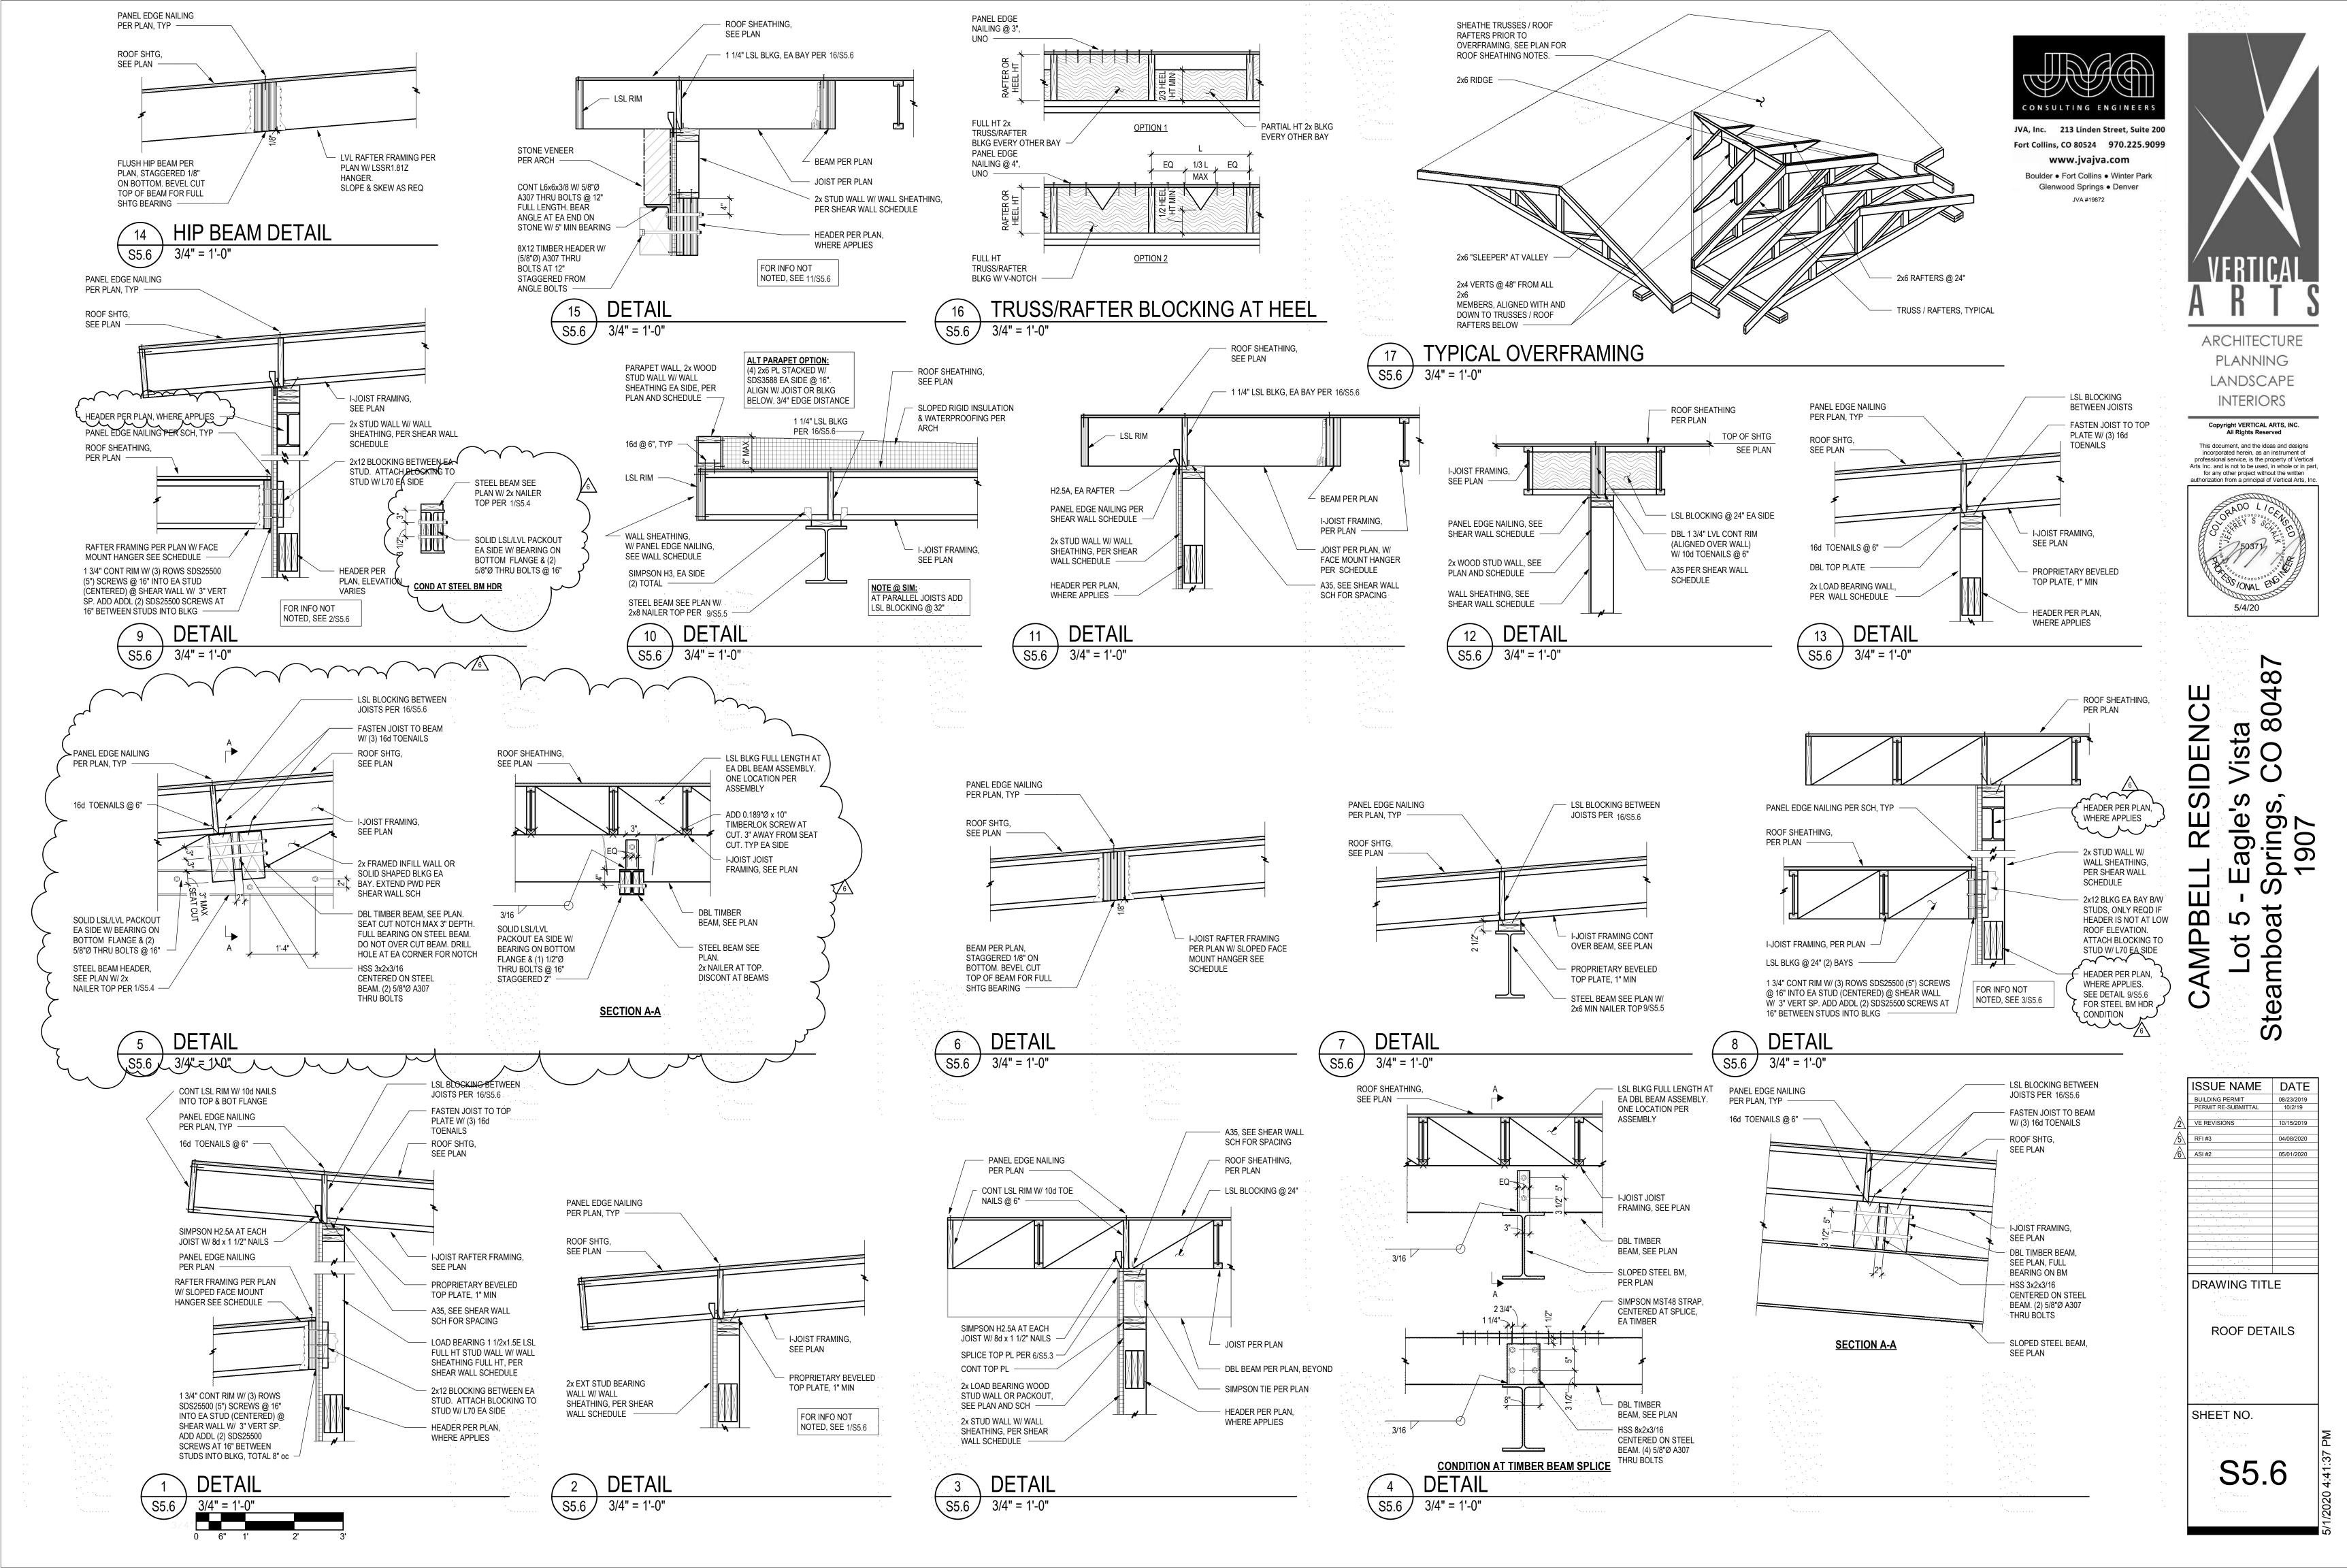



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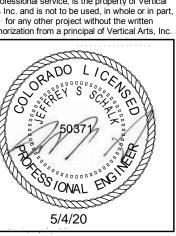


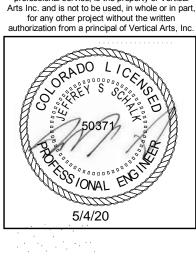



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Vista CO 80487 - Eagle's Springs 1907

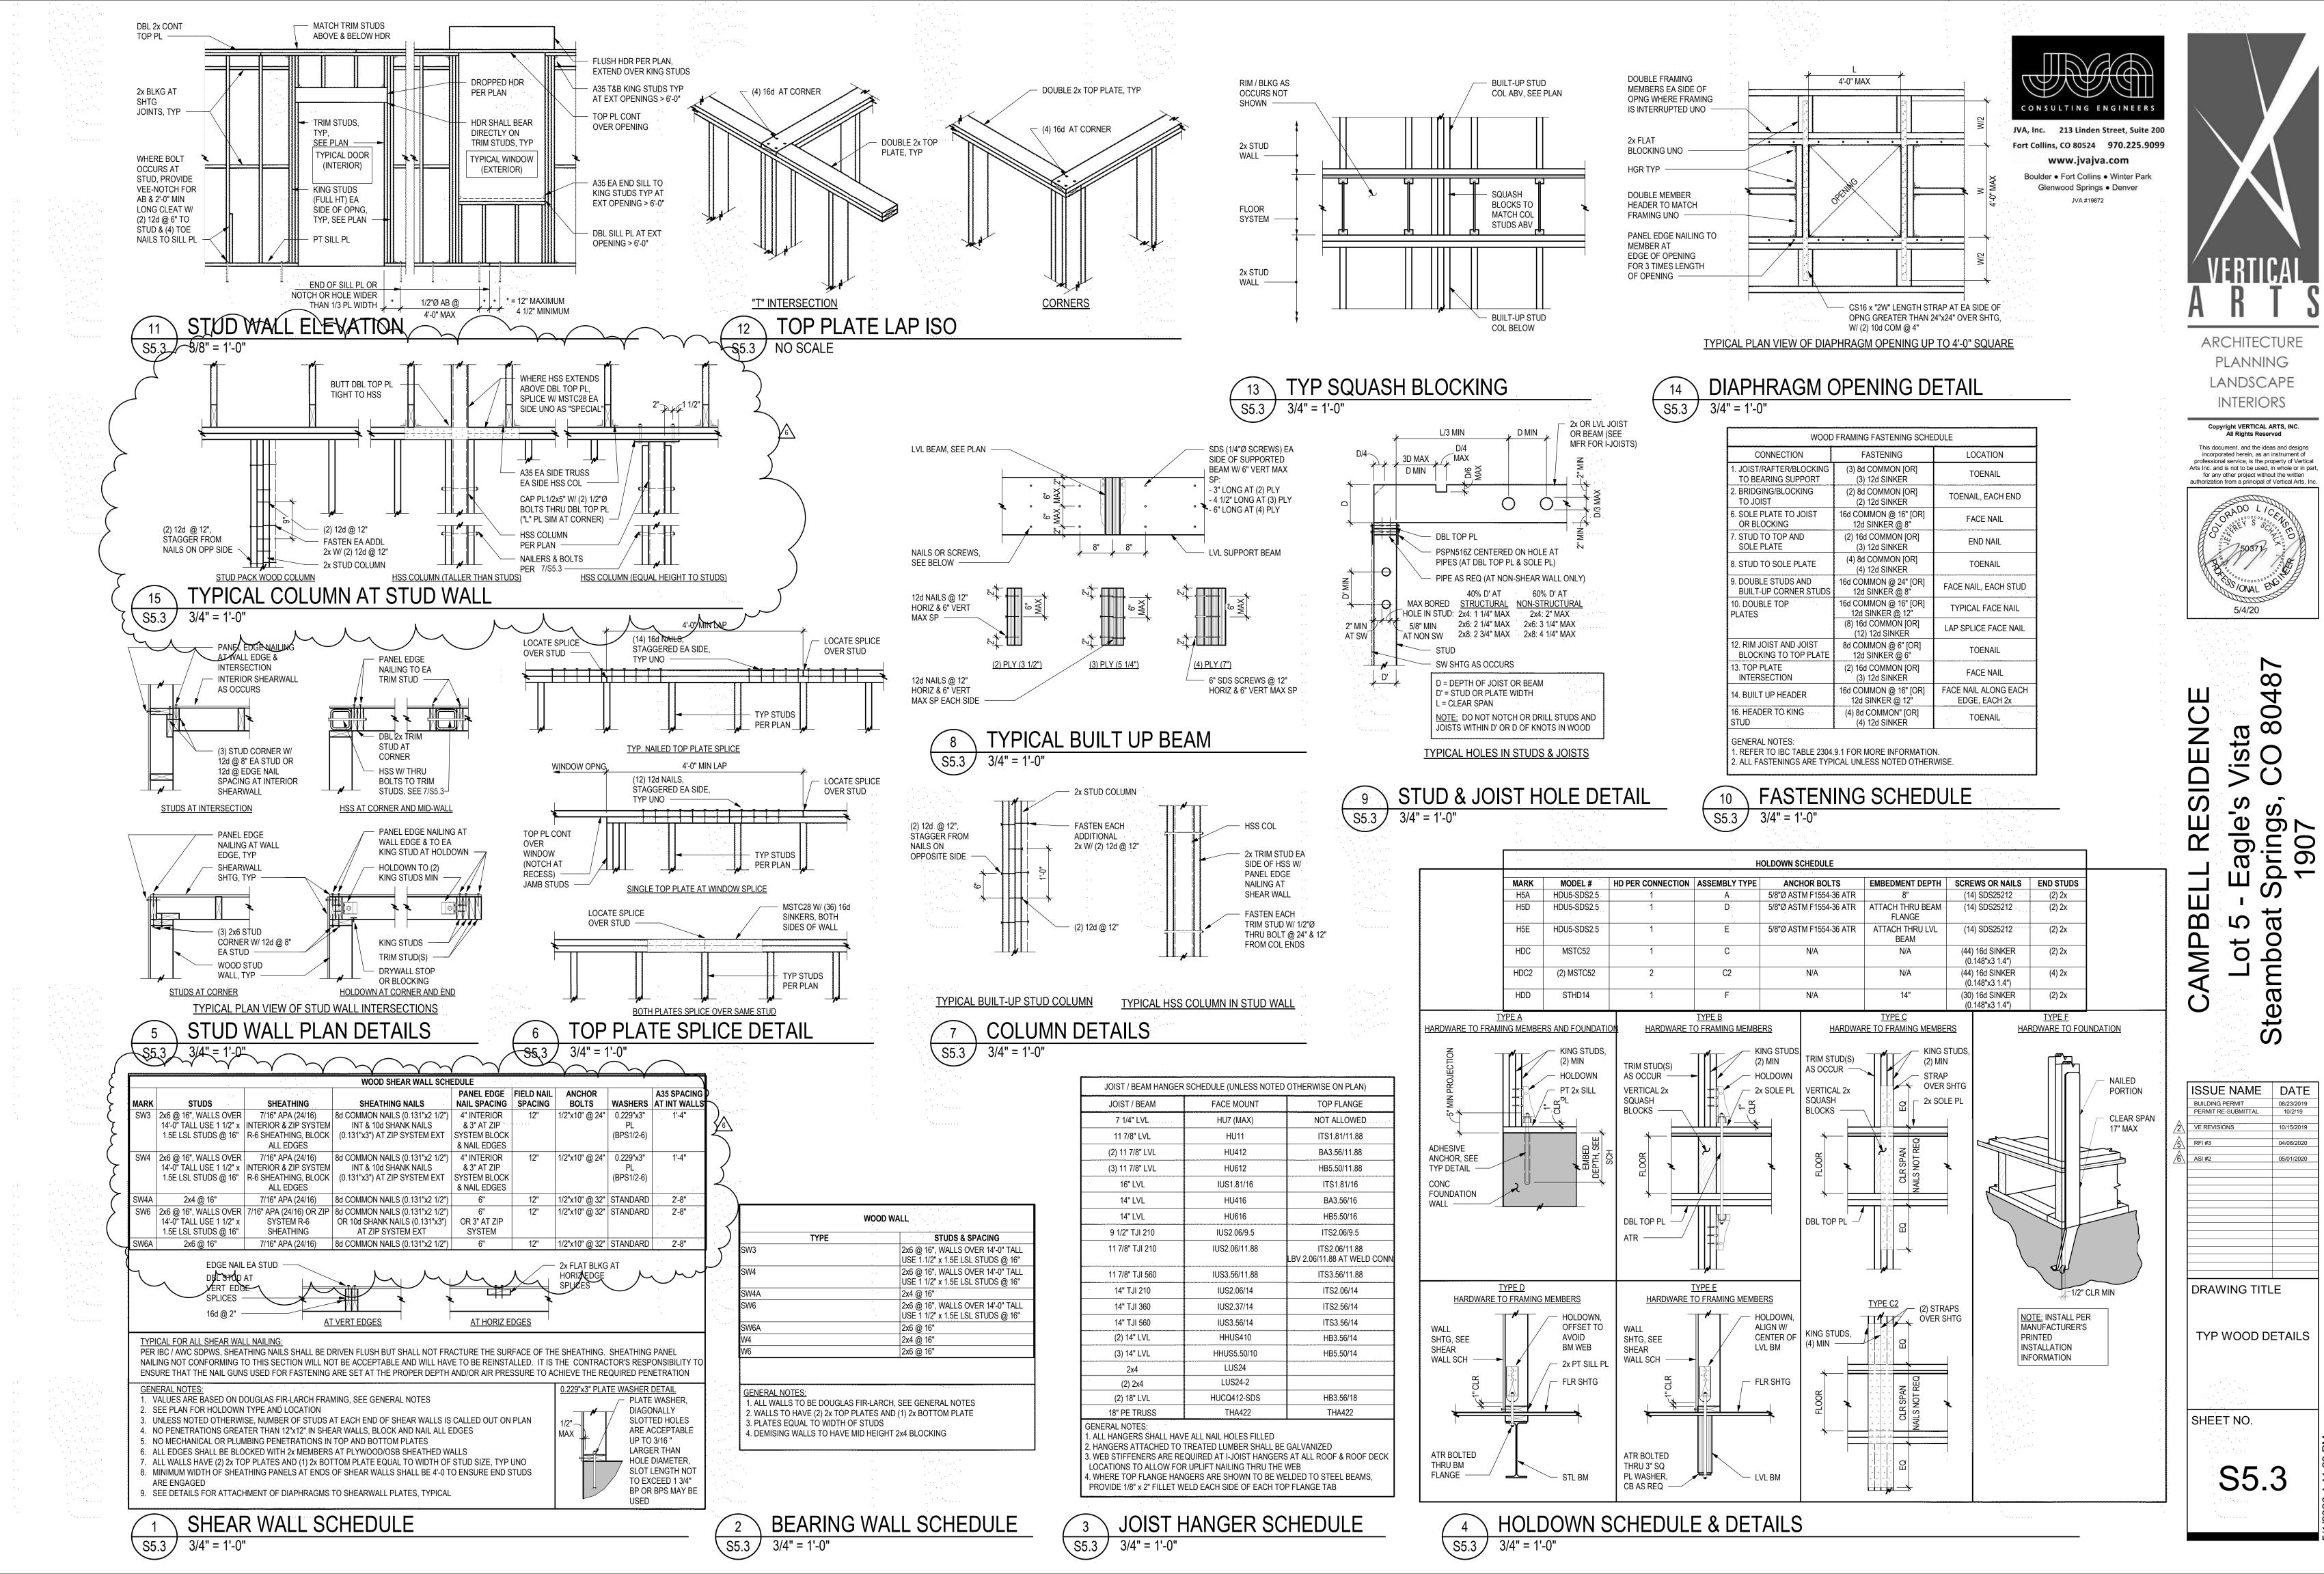Lot 5 -Steamboat
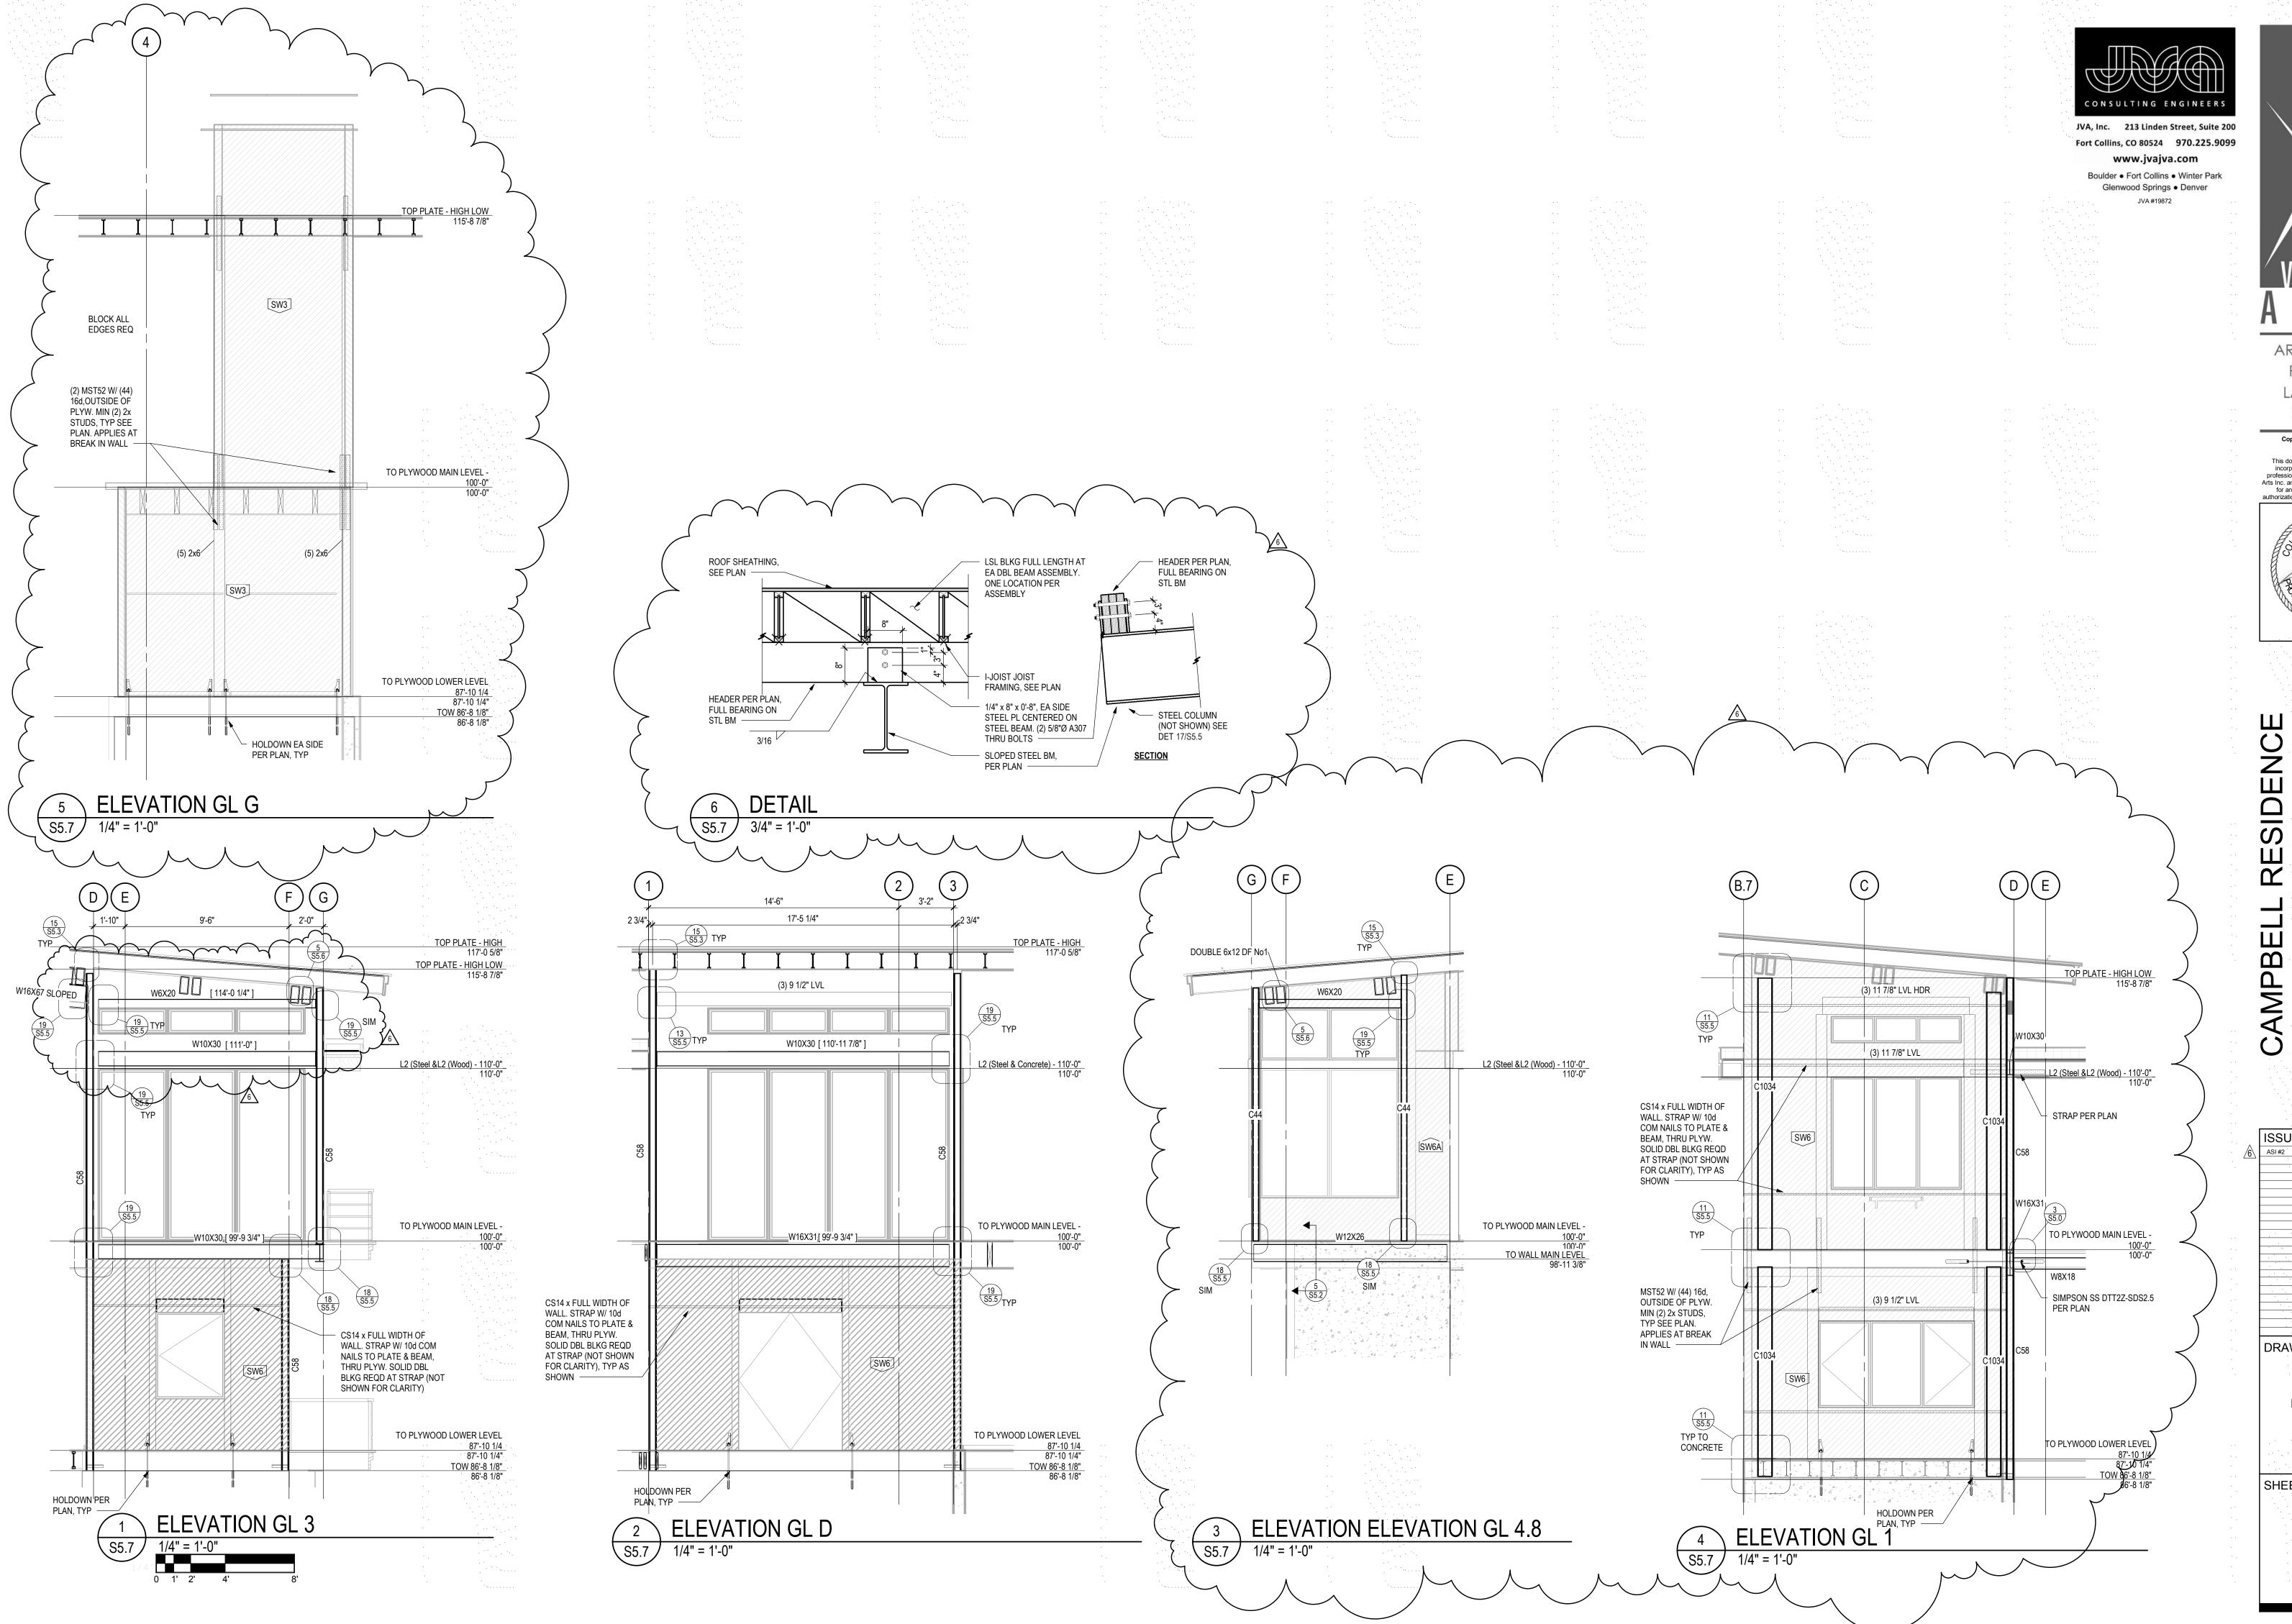
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