

OWNER REVISIONS 06/09/25

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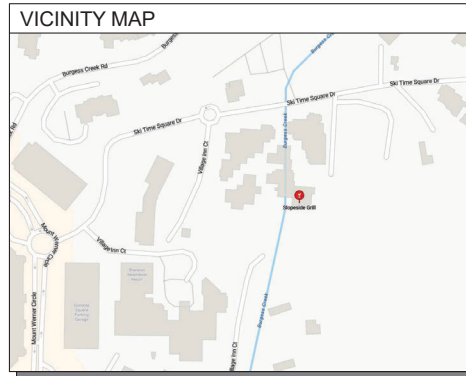
Slopeside Remodel
1855 Ski Time Square Drive
Steamboat Springs, CO 80487
2325

A ISSUE NAME		DATE
1	ISSUE 01	10/08/24
2	ISSUE 02	10/08/24
3	ISSUE 03	10/08/24
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DRAWING TITLE		
GENERAL INFORMATION SHEET		
SHEET NO.		
A0.1		

ABBREVIATIONS		
SYMBOLS		
Z	AND	K
2	ANGLE	KFL
1	CENTER LINE	KIT
		KB
A		KC
AC	AIR CONDITIONING	KO
AB	ANCHOR BOLT	
ABV	ABOVE	
ACP	ACOUSTICAL PANEL	
ACT	ACOUSTICAL CEILING TILE	
AD	AREA DRAIN	
ADMIN	ADMINISTRATION	
ADJ	ADJACENT	
A.F.F.	ABOVE FINISH FLOOR	
AL	ALTERNATE	
ALUM	ALUMINUM	
AP	ACCESS PANEL	
APPROX	APPROXIMATE	
ARCH	ARCHITECT/ARCHITECTURE	
B		
BD	BOARD	
BLDG	BUILDING	
BLK	BLOCK	
BLW	BELOW	
BM	BEAM	
B.O.	BOTTOM OF	
BR	BRONZE	
C		
C	CASEMENT	
CABT	CABINET	
CLNG	CEILING	
CJ	CONTROL JOINT	
CLR	CLEAR	
CMU	CONCRETE MASONRY UNIT	
CO	CLEANOUT	
COL	COLUMN	
CONT	CONTINUOUS	
CONC	CONCRETE	
CONV	CONVEYER	
CPT	CARPET	
CT	CERAMIC TILE	
CU	CONDENSING UNIT	
D		
DTL	DETAIL	
D.F.	DRINKING FOUNTAIN	
DH	DOUBLE HUNG	
DA	DAMPER	
DM	DIMENSION	
DO	DOUBLE WALL OVENS	
DR	DOOR DRAWING	
DW	DISHWASHER	
DWG	DRAWING	
E		
EA	EACH	
EF	EXHAUST FAN	
ELEV	ELEVATION	
ELEC	ELECTRIC	
ENCL	ENCLOSURE	
ENT	ENTRANCE	
EQ	EQUAL	
EQPT	EQUIPMENT	
EXT	EXISTING	
F		
FD	FLOOR DRAIN	
FDN	FOUNDATION	
FE	FIRE EXTINGUISHER	
FIN	FINISH	
FLR	FLOOR	
F.O.W.	FACE OF WALL (STUD, ETC.)	
F.R.S.C.	FIRE RESISTANT SELF CLOSING	
FR	FRAME	
FS	FLOOR SINK	
FTG	FOOTING	
G		
GA	GAUGE	
GALV	GALVANIZED	
GC	GENERAL CONTRACTOR	
GL	GLASS/GLAZING	
GWB	GYPSSUM WALL BOARD	
H		
HB	HOSE BIBB	
HDCP	HANDICAPPED	
HGT	HEIGHT	
HM	HOLLOW METAL	
H.P.	HIGH POINT	
HR	HOUR	
HV	HEATING & VENTILATION	
HVAC	HEATING, VENTILATION & AIR CONDITIONING	
I		
ID.	INSIDE DIAMETER	
INFO	INFORMATION	
INSUL	INSULATION	
J		
JC	JANITOR CLOSET	
JT	JOINT	
K		
K	KITCHEN	
KFL	KITCHEN	
KIT	KITCHEN	
KB	KITCHEN CABINET	
KC	KITCHEN CABINET	
KO	KNOCKOUT	
L		
L	LOW POINT	
L.P.	LIGHT	
M		
MTL	METAL	
MAT	MATERIAL	
MAX	MAXIMUM	
MECH	MECHANICAL	
MIN	MINIMUM	
M.O.	MASONRY OPENING	
MTD	MOUNTED	
N		
NEC	NECESSARY	
N.C.	NOT IN CONTRACT	
NO	NUMBER	
N.T.S.	NOT TO SCALE	
O		
O.C.	ON CENTER	
O.D.	OUTSIDE DIAMETER	
O.H.	OPPOSITE HAND	
OPNG	OPENING	
OPP	OPPOSITE	
P		
PART	PARTITION	
PRN	PURIN BEARING ROOF	
PLB	PLUMBING & DRAINAGE	
P&D	PRE-ENGINEERED TRUSS	
PE TRUSS	PROPERTY LINE	
PL	PLASTIC LAMINATE	
PLMB	PLYWOOD	
PLYWD	PAINT	
PR	PAINTED	
PT		
PTD		
R		
R	RADIUS/RISER	
RAD	RADIATOR	
RCR	REFLECTED CEILING PLAN	
RCP	ROOF DRAIN	
R.O.D.	RECESS	
REC	REFLECT	
REFR	REFRIGERATOR	
REQ	REQUIRED	
REVA	REHEAT	
RM	ROOM	
R.O.	ROUGH OPENING	
S		
S	SINK	
SAD	SADDLE	
SF	SQUARE FEET	
SHT	SHEET	
SIM	SIMILAR	
SINT	SPECIFIED	
SPEC'D	SPECIFICATION	
SPEC	SLAB ON GRADE	
S.O.G.	STANDARD	
STL	STAINLESS STEEL	
STL	STORAGE	
STF	STAFF	
T		
T	TREAD	
T.B.S.	TO BE SELECTED	
T.O.D.	TOP OF DRAIN	
THK	THICK	
TEL	TELEPHONE	
T&G	TONGUE AND GROOVE	
T.O.	TOP OF	
T.O.D.	TOP OF DECKING	
T.O.S.	TOP OF SLAB	
T.O.W.	TOP OF WALL	
TYP.	TYPICAL	
U		
U	UNLESS NOTED OTHERWISE	
U.N.O.	UNFINISHED	
UNF	UNFINISHED	
U.V.	UNIT VENTILATION	
V		
V	VARIABLE	
VCT	VINYL COMPOSITE TILE	
VENT.	VENTILATOR	
V.I.F.	VERIFY IN FIELD	
VP	VENT PIPE	
W		
W	WASHER	
WIT	WITHOUT	
WO	WATER CLOSET	
WC	WASHER/DRYER	
WD	WOOD	
WH	WATER HEATER	
W.P.	WATERPROOF/WATERPROOFING	
WT	WEIGHT	

GENERAL NOTES:	
1. ALL CONSTRUCTION AND MATERIALS SHALL BE AS SPECIFIED AND IN ACCORDANCE WITH ALL APPLICABLE CODES, ORDINANCES, LAWS, PERMITS AND THE CONTRACT DOCUMENTS.	
2. THE CONTRACTOR SHALL BE RESPONSIBLE FOR THE ACCURATE PLACEMENT OF ALL NEW CONSTRUCTION ON THE SITE. ALL MATERIALS AND COMPONENTS SHALL BE INSTALLED PER MANUFACTURER'S INSTRUCTIONS AND SPECIFICATIONS WITH FULL WARRANTIES.	
3. THE CONTRACTOR SHALL VERIFY ALL DIMENSIONS AND SITE CONDITIONS BEFORE STARTING WORK. SHOULD A DISCREPANCY ARISE IN THE CONTRACT DOCUMENTS, THE CONTRACTOR SHALL IMMEDIATELY NOTIFY THE ARCHITECT AT ONCE FOR INSTRUCTION ON HOW TO PROCEED.	
4. CHANGES FROM THE PLANS MADE WITHOUT CONSENT OF THE ARCHITECT ARE UNAUTHORIZED AND SHALL RELIEVE THE ARCHITECT OF RESPONSIBILITY FOR ALL CONSEQUENCES ARISING OUT OF SUCH CHANGES.	
5. SHOULD A CONFLICT OCCUR IN OR BETWEEN DRAWINGS AND SPECIFICATIONS, THE SPECIFICATIONS SHALL TAKE PRECEDENCE UNLESS A WRITTEN DECISION FROM THE ARCHITECT HAS BEEN OBTAINED WHICH DESCRIBES A CLARIFICATION OR ALTERNATE METHOD AND/OR MATERIALS.	
6. THE CONTRACTOR SHALL CONFINE HISHER OPERATIONS ON THE SITE TO AREAS PERMITTED BY THE OWNER.	
7. THE JOB SITE SHALL BE MAINTAINED IN A CLEAN, ORDERLY CONDITION, FREE OF DEBRIS AND LITTER AND SHALL NOT BE UNREASONABLY ENCUMBERED WITH ANY MATERIALS OR EQUIPMENT. EACH SUB-CONTRACTOR IMMEDIATELY UPON COMPLETION OF EACH PHASE OF HISHER WORK SHALL REMOVE ALL TRASH AND DEBRIS AS OF RESULT OF HISHER OPERATION.	
8. ALL MATERIALS STORED ON THE SITE SHALL BE PROPERLY STACKED AND PROTECTED TO PREVENT DAMAGE AND DETERIORATION. FAILURE TO PROTECT MATERIALS MAY BE CAUSE FOR REJECTION OF WORK.	
9. THE CONTRACTOR SHALL DO ALL CUTTING, FITTING OR PATCHING OF HISHER WORK THAT MAY BE REQUIRED TO MAKE ITS SEVERAL PARTS FIT TOGETHER PROPERLY AND SHALL NOT ENDANGER ANY OTHER WORK BY CUTTING, CAVENATING OR OTHERWISE ALTERING THE TOTAL WORK OR ANY OTHER PART OF IT. ALL PATCHING, REPAIRING AND REPLACING OF MATERIALS AND SURFACES CUT OR DAMAGED IN EXECUTION OF WORK SHALL BE DONE WITH APPLICABLE MATERIALS SO THAT SURFACES REPLACED WILL, UPON COMPLETION, MATCH SURROUNDING SIMILAR SURFACES.	
10. NO PORTION OF THE WORK REQUIRING A SHOP DRAWING OR SAMPLE SUBMISSION SHALL BE COMMENCED UNTIL THE SUBMISSION HAS BEEN REVIEWED BY THE ARCHITECT. ALL SUCH PORTIONS OF THE WORK SHALL BE IN ACCORDANCE WITH REVIEWED SHOP DRAWINGS AND SAMPLES.	
11. DIMENSIONS:	
A. ALL DIMENSIONS SHALL TAKE PRECEDENCE OVER SCALE OF DRAWINGS.	
B. ALL DIMENSIONS ARE TO FACE OF STUD, FACE OF C.M.U. OR FACE OF CONCRETE U.N.O.	
C. CEILING HEIGHT DIMENSIONS ARE FROM FINISHED FLOOR TO FACE OF FINISH CEILING MATERIALS UNLESS NOTED OTHERWISE.	
12. CONTRACTOR TO PROVIDE ALL NECESSARY BLOCKING, BACKING AND FRAMING FOR LIGHT FIXTURES, ELECTRICAL UNITS, A.C. EQUIPMENT, RECESSED ITEMS AND ALL OTHER ITEMS AS REQUIRED.	
13. WHERE LARGER STUDS OR FURRING ARE REQUIRED TO COVER PIPES AND CONDUITS, THE LARGER STUD SIZE OR FURRING SHALL BE EXTENDED THE FULL SURFACE OF THE WALL WIDTH AND LENGTH WHERE THE FURRING OCCURS.	
14. PROVIDE ALL ACCESS PANELS AS REQUIRED BY GOVERNING CODES TO ALL CONCEALED SPACES, VOIDS, ATTICS, ETC. VERIFY TYPE REQUIRED WITH ARCHITECT PRIOR TO INSTALLATION.	
15. PROVIDE ACCESS AND MINIMUM VENTILATION REQUIREMENTS TO ALL CRAWL SPACES AS REQUIRED BY GOVERNING CODES.	
16. INSTALL TEMPERED GLASS AS REQUIRED BY GOVERNING CODES.	
17. STRUCTURAL AND FIRE RESISTIVE INTEGRITY SHALL BE MAINTAINED AS REQUIRED BY GOVERNING CODES.	
18. FIREBLOCKS AND DRAFT STOPS SHALL BE PROVIDED AS REQUIRED BY GOVERNING CODES.	
19. THE BUILDING THERMAL ENVELOPE SHALL BE CONSTRUCTED TO LIMIT AIR LEAKAGE PER IECC R402.4.	
20. RECESSED LIGHT IN BUILDING THERMAL ENVELOPE SHALL BE SEALED PER IECC 402.4.1.1.	

GENERAL DEMOLITION NOTES:	
1. CONTRACTOR SHALL COORDINATE ALL DEMOLITION WITH THE NEW CONSTRUCTION TO DETERMINE DIMENSIONS AND SCOPE OF WORK AND TO ENSURE THAT NO ITEMS OR SERVICES TO REMAIN ARE DISTURBED OR DAMAGED.	
2. PROVIDE AND PLACE BRACING AND SHORING AS REQUIRED. TAKE NECESSARY PRECAUTIONS TO PROPERLY INSTALL TEMPORARY SUPPORT STRUCTURES TO REMAIN TO PREVENT DAMAGE OR UNACCEPTABLE DEFLECTION.	
3. WHERE REMOVALS ARE MADE CONTRACTOR SHALL PATCH ALL CONSTRUCTION TO PROVIDE SMOOTH AS NEW CONDITION.	
4. CONTRACTOR SHALL PATCH AND/OR LEVEL ALL EXISTING SURFACES RECEIVING NEW FINISHES.	
5. PROTECT ALL ITEMS TO REMAIN AND ALL EXISTING CONSTRUCTION NOT SCHEDULED TO BE DEMOLISHED. IMMEDIATELY REPAIR OR REPLACE DAMAGED ITEMS.	
6. OWNER TO REMOVE ALL FURNITURE, EQUIPMENT, AND OTHER FURNISHINGS FROM CONSTRUCTION AREA PRIOR TO PROJECT START.	
7. CONTRACTOR TO COORDINATE DEMOLITION WITH ENGINEERING DOCUMENTS.	
8. SEAL ALL OPENINGS UNCOVERED DURING DEMOLITION OF FURRED WALLS, RELOCATION OF DUCT SHAFTS OR PIPE CHASES, OR REMOVAL OF PARTITIONS OR FIXTURES.	
9. ALL DAMAGED EXISTING WORK MUST BE REPAIRED AND PREPARED TO RECEIVE NEW FINISHES. THE CONTRACTOR SHALL INCLUDE ON THE BASE PRICE ALL REPAIR OR REPLACEMENT WORK REQUIRED FOR NEW CONSTRUCTION.	
10. RESTORE THE INTEGRITY OF EXISTING FIRE RATED PARTITIONS, FIREPROOFING AND STRUCTURE DAMAGED DURING DEMOLITION. GC TO FIRE STOP RATED PENETRATIONS AT THE END OF EACH DAY.	
11. DUST PROOF PARTITIONS & RELATED PROTECTIONS ERRECTED DURING DEMOLITION OPERATIONS SHALL REMAIN IN PLACE FOR THE DURATION OF THE CONSTRUCTION PERIOD UNLESS OTHERWISE INSTRUCTED BY THE TENANT OR ARCHITECT.	
12. VERIFY ALL EXISTING POWER/OTAGAS DEVICES, REMOVE ALL DEAD AND NON-STANDARD DEVICES	
13. REMOVE EXISTING CEILING TILES, MAINTAIN GRID IN ALL AREAS WHERE CEILING IS SHOWN TO REMAIN. REMOVE AND REPLACE ANY DEFECTIVE PORTIONS OF GRID AND PREPARE FOR NEW CEILING TILES	




DRAWING SYMBOLS	
100'-0"	FLOOR OR SPOT ELEVATION
100'	DOOR TAG
100'	WINDOW TAG
R1	ROOF TAG
W1	WALL TAG
F1	FLOOR TAG
CRPT, CRPT	FLOOR FINISH
---	PROPOSED CONTOUR
- - - -	EXISTING CONTOUR
△	REVISION SYMBOL
INTERIOR ELEVATION NUMBER	
SHEET NUMBER	
DETAIL NUMBER	
SHEET NUMBER	
SECTION NUMBER	
SHEET NUMBER	
ELEVATION NUMBER	
SHEET NUMBER	

GRAPHIC KEY TO MATERIALS	
EARTH	INSULATION
COMPACTED FILL	BATT
POROUS FILL	RIGID
CONCRETE	WOOD
CAST	FINISH
GROUT LIGHTWEIGHT	ROUGH
MASONRY	BLOCKING
CMU BLOCK	GLU-LAM
BRICK	PLYWOOD
STONE	METAL
	STEEL

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A0.1	GENERAL INFORMATION SHEET
A0.2	ACCESSIBILITY GUIDELINES
A0.3	CODE ANALYSIS
D0.2	MAIN LEVEL DEMOLITION PLAN
D0.3	MAIN LEVEL ROP DEMOLITION PLAN
A2.1	MAIN LEVEL FLOOR PLAN
A6.1	POZZA OVER DETAILS
A7.1	MAIN LEVEL REFLECTED CEILING PLAN
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MP0D-2	MECHANICAL DEMOLITION PLAN
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E0-1	ELECTRICAL GENERAL NOTES
E0D-2	ELECTRICAL DEMOLITION PLAN
E0-2	ELECTRICAL PLAN

PROJECT TEAM	
OWNER	574.536.7800
WILLIAM BANKS	
1019 STEAMBOAT BLVD	
STEAMBOAT SPRINGS, CO 80487	
ARCHITECT	970.871.0056
VERTICAL ARTS, INC.	
690 MARKETPLACE PLAZA	
SUITE 1	
STEAMBOAT SPRINGS, CO 80487	
CONTACT: CHANDLER DEMOND	
MEP ENGINEER	970.241.8709
BIG HORN CONSULTING ENGINEERS	
386 INDIAN ROAD	
GRAND JUNCTION, CO 81501	
CONTACT: BLAINE BUCK	

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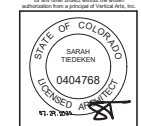
① NEW - T.O.SLAB MAIN LEVEL
1/4" = 1'-0"

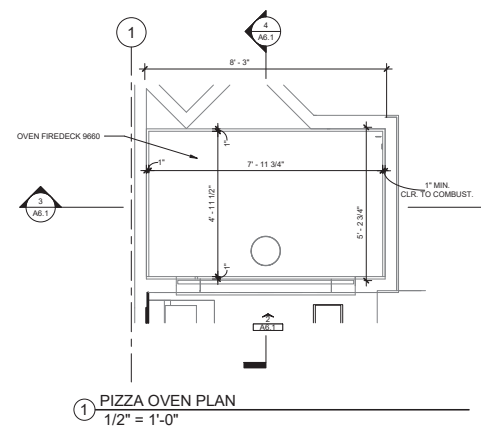

ARCHITECTURE
PLANNING
LANDSCAPE
INTERIORS

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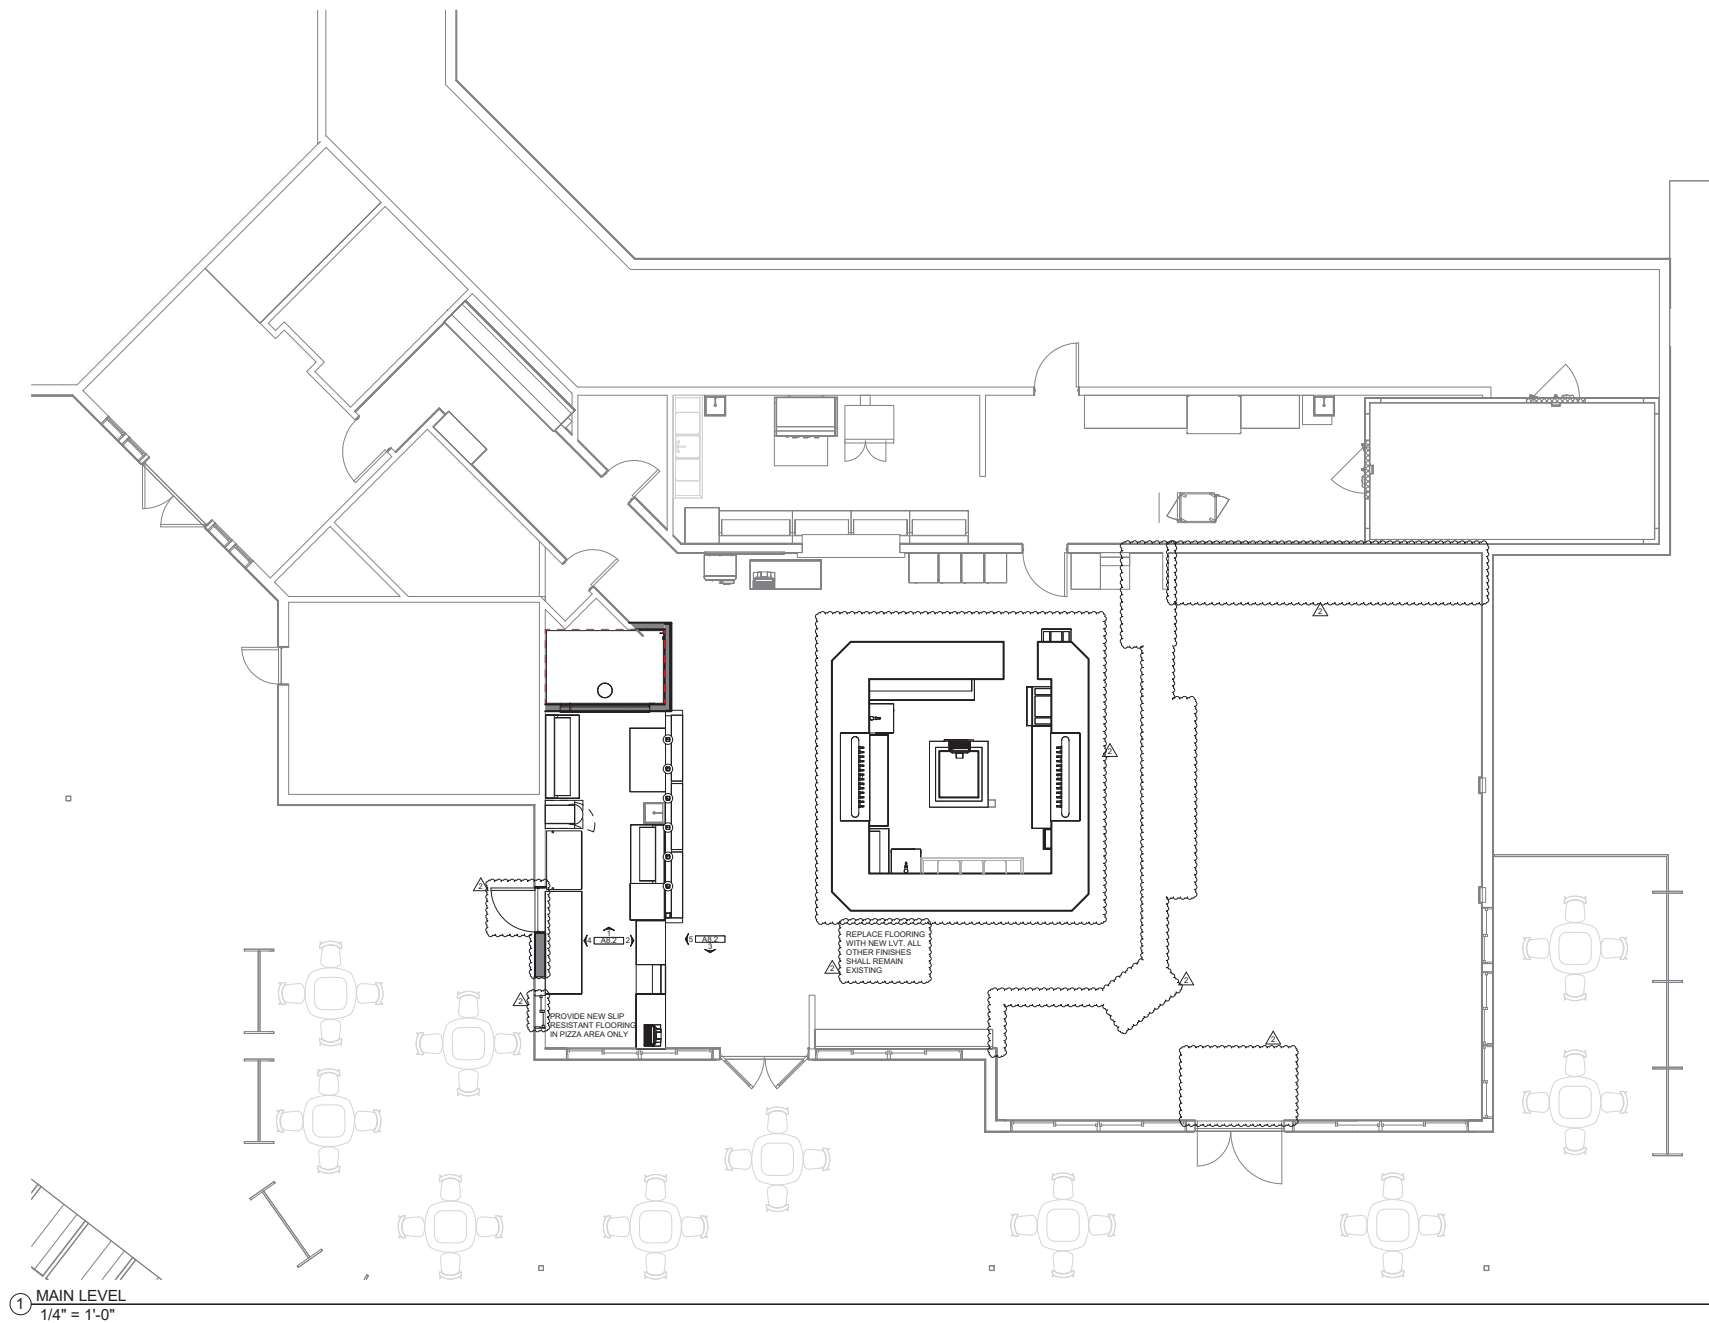
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MAIN LEVEL FINISH
PLAN

SHEET NO.

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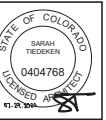
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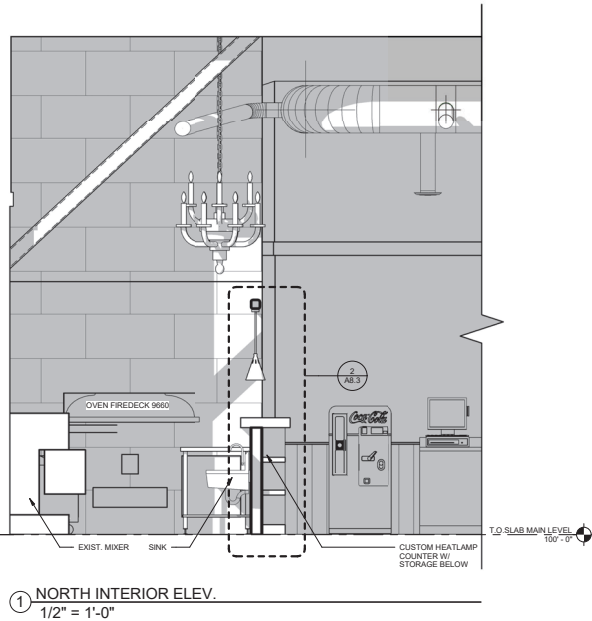
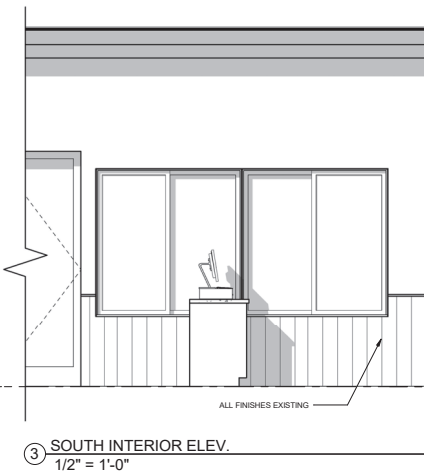
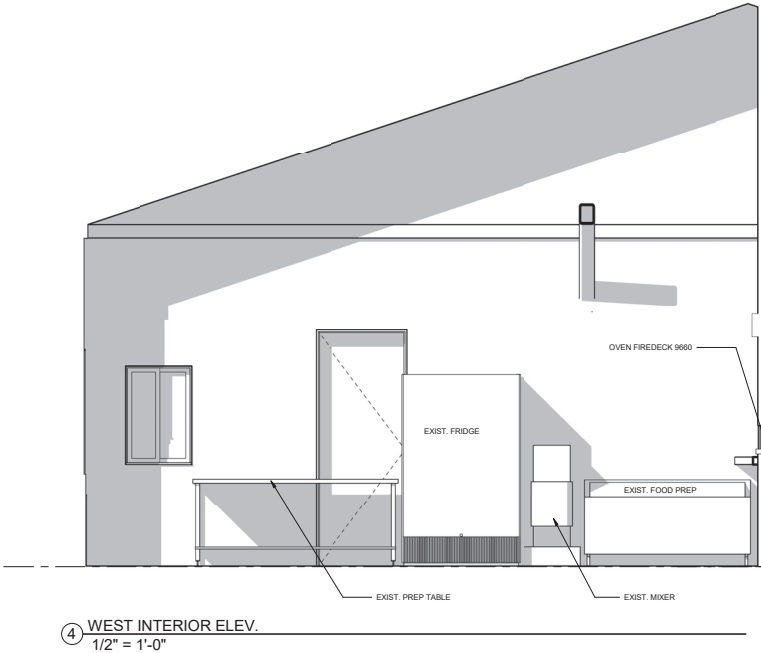
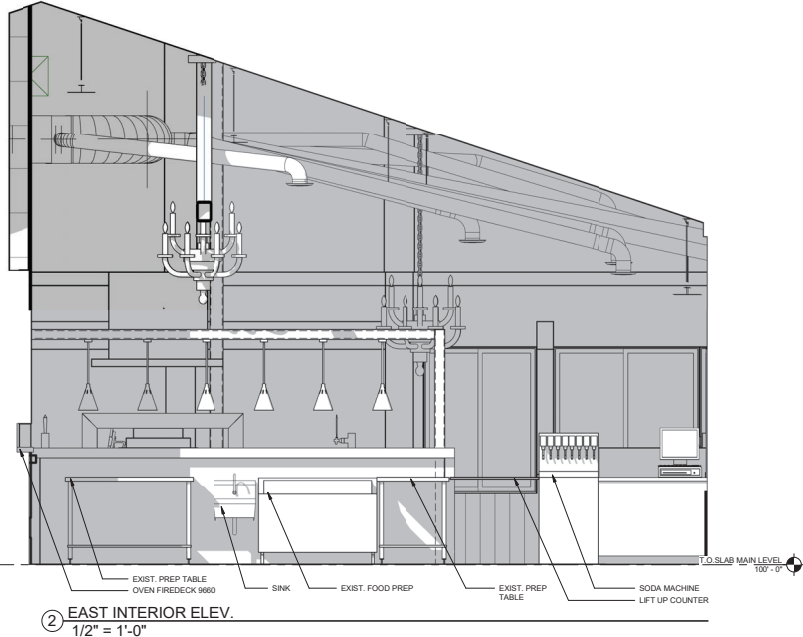
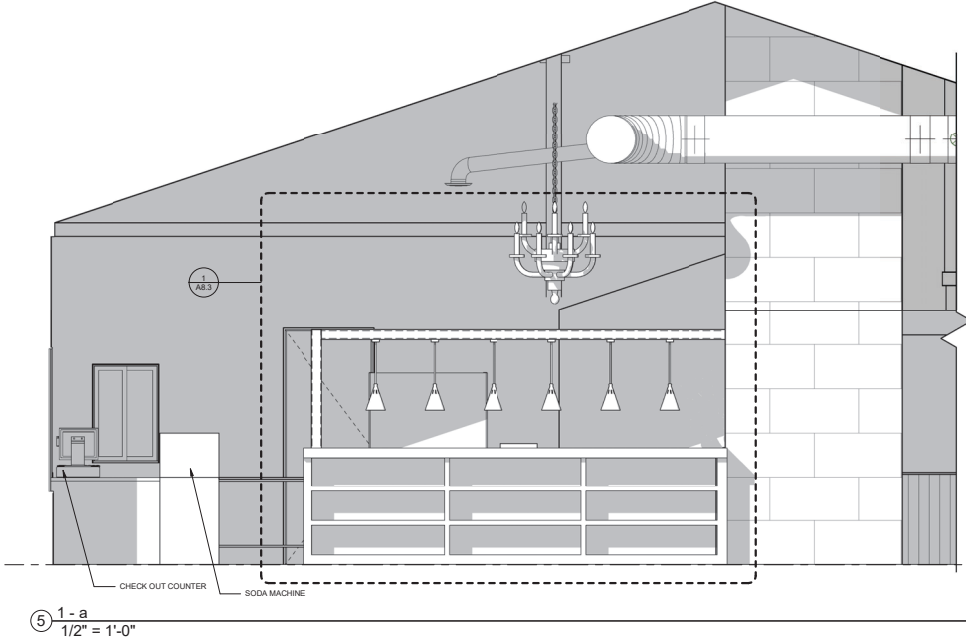
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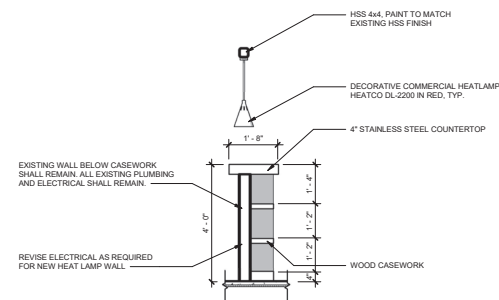
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INTERIOR ELEVATIONS

SHEET NO.


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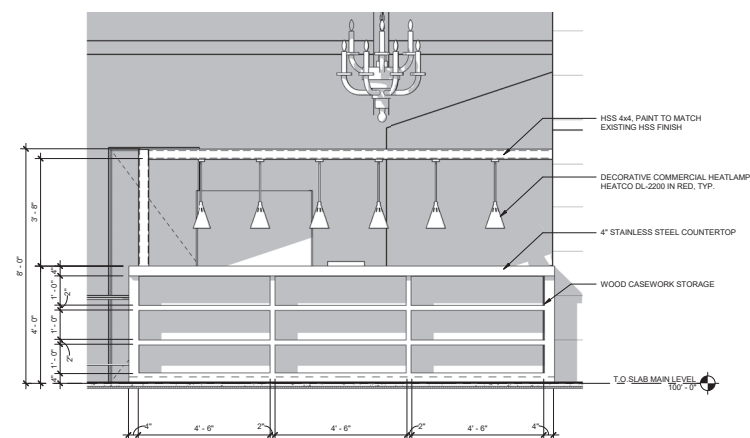




② PIZZA COUNTER SECTION
1/2" = 1'-0"



③ PIZZA COUNTER PLAN
1/2" = 1'-0"

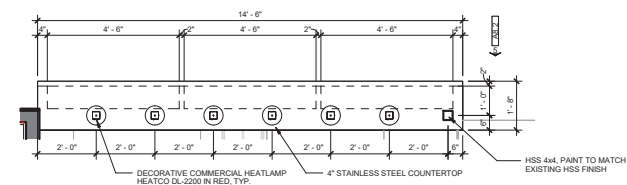

① PIZZA COUNTER ELEV.
1/2" = 1'-0"

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INTERIOR DETAILS

SHEET NO.

A8.3