All work must comply with state and local codes, based on the City of Steamboat Springs Community Development Code the 2021 International Building Code, the 2021 International Plumbing Code, the 2021 International Mechanical Code, the 2021 Energy Conservation Code and the 2023 National Electric code. The contractor shall comply with all laws, ordinances, rules and regulations of any public authority bearing on the performance of the work, including O.S.H.A.

Location of the utilities (electrical, telephone, cable TV, gas, water, sewer) shall be verified before construction begins.

All on site construction safety and construction means and methods are the responsibility of the contractor. There is no implication of the construction safety requirements or building methods contained in these drawings.

Actual site conditions may require that some of the components of the work should be done differently than shown on these drawings. All dimensions and conditions to be verified by the contractor prior to construction. Verify changes with the designer and engineer.

These drawings represent a simplified builder's set of plans. Additional detailing may be required of the engineer during construction

Any variation which requires a physical change from these plans must be brought to the attention of the designer and engineer in order to maintain the design intent of the project.

All work connected with this project by any trade involved shall be of the highest quality attainable in accordance with the professional practice of the trade.

DIMENSIONS

All interior and exterior dimensions are to face of stud or face of concrete. U.N.O.

All exterior walls are nominal 2x6 stud construction, U.N.O. All interior walls are nominal 2x4 stud construction, U.N.O.

Do not scale drawings

The water closet stool shall be located in a clear space of not less than 30" in width. The clear space in front of the water closet stool shall be not less than 21"

Crawl space access shall be provided w/ min. 18"x24" through the floor \$ min. 16"x24" through the wall.

Minimum clear ceiling height is 7'-6'' for habitable space \$ hallways \$ 6'-8'' for bathrooms, laundry rooms \$ stairs. Exceptions apply for sloped ceilings and basements per IBC 1003.2

If any discrepancies are found in these drawings notify engineer and/or designer immediately.

Exterior roofs, flashing, ledges, concrete \sharp other surfaces shall slope min. $\frac{1}{2}$:12 to prevent water ponding. Landings shall also slope max. 1/4:12 to prevent slipping. Covered garages or carports floor surface shall slope min. 1/8:12 to provide positive drainage to drain, unless surfaced with asphalt.

STAIRWAYS:

Stairs shall have a minimum 44" clear width or min. 36" if serving an occupant load less than 50. The surface of stairs shall be slip resistant. Minimum vertical headroom is 6'-8" from the nosing. Maximum riser height is 7", and minimum tread depth is 11".

Landings shall be provided at the top and bottom of each stairway with a length no less than the width of the stairway served. Landings are not required at the top of interior stairs provided that a door does not swing over the stairs.

Handrails shall be provided on at least one side of each continuous stair flight with four or more risers, and shall be 34"-38" tall, measured vertically from the sloped plane of the tread nosings. Handrails shall comply with section IBC Section 1014

Open sides of stairways, landings, ramps, balconies and porches which are more than 30" above grade shall be protected by a guardrail. All guardrails must be 36" above finished floor and shall allow no more than a 4" diameter sphere to pass through any portion of the railing per IBC Sec. 1012.10.2

Walls and ceilings of enclosed usable space under stairs requires 1/2" gypsum wallboard. The door to access such spaces need not be rated.

Habitable spaces within dwelling units shall have natural light provided by exterior openings equal to 8% of the floor area. Natural ventilation shall be provided by means of operable exterior openings equal to 4% of the floor area.

Safety glazing shall be provided in the following hazardous locations:

- 1) In doors where glazed opening is greater than $3^{"}\phi$ 2) Within 24" adjacent to doors if less than 60" above the walking surface
- 3) Single panes where all following conditions exist: greater than 9 sq.ft., less than 18" above the floor, top edge
- higher than 36" above the floor and within 36" horizontal distance of walking surface. 4) Glazing in guards and railings
- 5) Glazing containing wet surfaces of bathtubs, showers, pools, etc. if less than 60" to walking surface.
- 6) Adjacent to the bottom stair landing w/in 60" arc length if less than 36" above landing
- 7) Site-built Windows
- 8) Skylights and glazing sloped more than 15°

Sleeping rooms and basements w/ habitable space shall have min. one operable emergency escape w/ min 5.7 s.f. openable area, min. 20" clear width or min. 24" clear hat. \$ max 44" sill height.

ROOF ASSEMBLIES

Attic access shall be provided if attic is more than 30" tall (measured from top of ceiling framing to underside of roof framing members for more than 30 sq. ft. Access shall have a rough-framed opening of min. 22"x30" with min. 30" clear headroom.

MECHANICAL/ENERGY SYSTEMS:

Appliances located in garages and having an ignition source shall be elevated such that the source of ignition less than 18" above the floor.

Dryer exhaust systems shall be independent of all other systems, shall transport the moisture to the outdoors and shall terminate on the outside of the building in accordance with IMC section M501 and M502.

Dishwashers shall be connected to a separate stand pipe or approved air gap prior to connection to sanitary drainage

Heating and Cooling equipment appliances shall be installed per manufacturers instructions and in accordance with the IBC Chapter 28.

Meter location must be approved by an Atmos Energy Corporation employee during a mandatory site visit to be scheduled after foundation is in place. Meters will not be allowed under a shedding roofline or where overhanging snow is a danger to the meter set.

The building or dwelling unit shall be tested and verified in accordance with the IECC.

Heating load calculations and equipment sizing shall be submitted for review and approval when applying for a mechanical permit. Do not install or inspect mechanical equipment or HVAC until submitted to RCRBD and approved.

Lighting shall be provided per IBC section 1204 and ventilation shall be provided per IBC section 1202.5

AREA CALCULATIONS

				Square	Load	Occupan
Unit	tevel	CDC Use	#BC Use	Footage	Factor	Load
Unit 8	tevel1	Garage 8A	U (8A)	473	200	
	tevell	Dwelling Unit 8A	R-2 (8A)	592	200	
	t evel 2	Garage 8A	U (8A)	75	20 0	
	level Z	Dwelling Unit 8A	R-2 (8A)	404	200	
	tevel3	Dwelling Unit 8B	R-2 (8B)	941	20 0	
	Level 1	Garage 9A	U (9A)	372	200	
9 9	Level 1	Dwelling Unit 9A	R-2 (9A)	671	20 0	
Units	Level 2	Garage 9A	U (9A)	54	200	
٠,	Level 2	Dwelling Unit 9A	R-2 (9A)	592	200	
	tevel 3	Dwelling Unit 9B	R-2 (9B)	898	2 0 0	
	Levell	Garage 10A	U (10A)	491	209	
10	Levell	Dwelling Unit 10A	R-2 (10A)	567	200	
Juit 10	Level 2	Garage 10A	U (10A)	48	209	
ā	Level 2	Dwelling Unit 10A	R-2 (10A)	434	200	
	Level 3	Dwelling Unit 10B	R-2 (10B)	907	200	
	tevel1	Garage 11A	U (11A)	479	20 9	
=======================================	tevel 1	Dwelling Unit 11A	R-2 (11A)	741	20 8	2
Juit 11	tevel 2	Garage 11A	U (11A)	74	20 0	
ž	ievel 2	Dwelling Unit 11A	R-2 (11A)	554	209	
	Level3	Dwelling Unit 11B	R-2 (11B)	1004	200	
	tevell	Garage 12A	U (12A)	304	20 0	
<u>rs</u>	tevel1	Dwelling Unit 12A	R-2 (12A)	886	200	
Unit I	Level 2	Garage 12A	U (12A)	62	200	
ā	Level 2	Dwelling Unit 12A		509	2 0 0	
	Level 3	Dwelling Unit 12B		975	208	l e
Unit 13	tevel 1	Garage 13A	U (13A)	355	200	
	t eve ll	Dwelling Unit 13A		713	200	
	tevel 2	Garage 13A	U (13A)	137	200	
	tevel 2	Dwelling Unit 13A		252	200	
	tevel 2	Garage 13B	U (13B)	158	20 0	
	tevel3	Dwelling Unit 13B		903	200	
	level1	Garage 14B	S-2 (14B)	670	200	
寸	Level1	Dwelling Unit 14A		504	200	
Unit 1.4	level 2	Garage 14B	S-2 (14B)	416	200	
5	Level 2	Dwelling Unit 14A		518	200	
	Level 3	Dwelling Unit 14B		975	200	

									- 1
									- /
									/
A A A	A A A		^ ^	^ ^	A A A	A A A	A A A	\sim	
	_ / \ _ / \ _ / `	$\mathcal{I} \mathcal{I} \mathcal{I} \mathcal{I} \mathcal{I} \mathcal{I} \mathcal{I} \mathcal{I} $		/ \ / \			~ \		_

ACCESSIBLE TYPE B DWELLING UNITS IN OVERALL BUILDING

Unit Numb e r	Type B Required (y/n)	Commentary
Unit 8A	No	Multi story unit exempt per 11087.7.2
Unit 8B	No	Existing original unit not part of this scope
Unit 9A	No	Multi story unit exempt per 11087.7.2
Unit 9B	No	Existing original unit not part of this scope
Unit 10A	No	Multi story unit exempt per 11087.7.2
Unit 10B	No	Existing original unit not part of this scope
Unit 11A	No	Multi story unit exempt per 11087.7.2
Unit 11B	No	Existing original unit not part of this scope
Unit 12A	No	Multi story unit exempt per 11087.7.2
Unit 12B	No	Existing original unit not part of this scope
Unit 13A	No	Multi story unit exempt per 11087.7.2
Unit 13B	No	Existing original unit not part of this scope
Unit 14A	No	Multi story unit exempt per 11087.7.2
Unit 14B	No	Existing original structure not part of this scope

	SHEET SCHEDULE
SHEET	CONTENTS
A-0	ARCHITECTURAL NOTES & CODE STUDY
A-0.1	PUBLIC ADA SPECIFICATIONS & STANDARDS
A-0.2	1-hr RATED ASSEMBLY OPTIONS
A-1	PLANNING DEPARTMENT USE PLANS
A-2	LEVEL ONE \$ TWO USE/FIRE SEPARATION PLAN
A-3	LEVEL ONE \$ TWO DIMENSIONED FLOOR PLAN
A-4	LEVEL ONE \$ TWO WORK KEY
S-0	STRUCTURAL NOTES
S-0.1	GENERAL FRAMING SECTIONS
S-1	LEVEL TWO FRAMING PLAN

2021 IBC CODE STUDY

Re: 2021 INTERNATIONAL BUILDING CODE \$ 2021 INTERNATIONAL EXISTING BUILDING CODE

USE & OCCUPANCY CLASSIFICATION (CH.3)

- Level 1 occupancies:

Max Building Area per Story (IBC508.4.2)

40500

21000

16500

664

4680

2474

5344

427

3263

708

3690

6603

Ratio

0.016

0.223

0.150

0.239

0.013

0.155

0.043

0.166

0.314

Use Allowable Area (s.f.)

Use Actual Area (s.f.)

Level 1

Total

Level 2

Total

Level 3

- & U (utility) private garages less than 1,000 ₱
- Level 3: R-2 (no changes to original construction)

means of egress (stairwells) - per IBC 1004.4 - means of egress have been included in area calculations for more stringent of all occupancies served.

TYPE OF CONSTRUCTION / ALLOWABLE AREAS \$ HEIGHTS (CH. 5 \$ 6)

CONSTRUCTION TYPE: V-B

NFPA 13 SPRINKLERED SYSTEM (IBC 903.3.1.1) - (required for 1-hr fire resistance rated separation per IBC tbl. 508.4) SEPARATED OCCUPANCIES (IBC 508.4)

ALLOWABLE BUILDING HEIGHTS PER IBC TABLE 504.3 S-2, $U \notin R-2$: 60'-0'' max. (40' existing)

ALLOWABLE NUMBER OF STORIES PER IBC TABLE 504.4 $S-2 \notin R-2$: 3 stories max. - (3 existing) U: 2 stories max. abv. grade plane - (2 existing)

ALLOWABLE BUILDING AREA PER IBC TABLE 506.2:

R-2: 21,000 MAX. S-2: 40,500 MAX. U: 16.500 MAX.

(see building area calculations - sum of actual building area/allowable area ratios for each occupancy = less than 1 for ea. story)

OCCUPIED ROOFS PER IBC 503.1.4

- number of stories complies w/ tbl 504.4 for occupancy immediately below occupied roof - occupied roof area shall not be included in the building area or number of stories

SPACES w/ (1) EXIT (TABLE 1006.2.1)

<u>S-2:</u> Max. occupant load shall not exceed (29) max travel distance shall not exceed 100ft.* R-2: Max. occupant load shall not exceed (20) max travel distance shall not exceed 125ft.* U: Max. occupant load shall not exceed (49), max travel distance shall not exceed 75ft.*

*NOTE: "max travel distance" refers to the IBC "Common path of egress travel distance" which is measured to a point where 2 exits or exit access doorways are available

FIRE RESISTANCE REQUIREMENTS (CH.4,5,7,10)

FIRE BARRIERS & HORIZONTAL ASSEMBLY BETWEEN USES

Per IBC table 508.4 - 1-hr fire separation required between all mixed uses as fire barriers (per IBC sect. 707) \$/or horizontal assemblies (per IBC sect. 711). Supporting construction shall also be 1-hr fire resistance rated (per IBC sect. 711.2.3).

FIRE SEPARATION BETWEEN PRIVATE GARAGES & DWELLINGS

Ducts that penetrate walls or ceiling separating the dwelling unit from the garage shall be min. .019" sheet steel \$ shall not have openings in garage (per IBC, sect. 406.3.1)

Private garages (U) beneath habitable rooms shall be separated from habitable rooms abv. by min. 3/8 Type X gypsum board or equivalent. Door openings between a private garage and dwelling unit shall have min. 20-min. fire protection rating and be self-closing and self-latching. (Per IBC sect. 406.3.2.1 & Tbl. 508.4, footnote c)

FIRE PARTITIONS BETWEEN DWELLING UNITS

Walls separating dwelling units shall be "fire partitions" (per IBC sect. 420.2) \$ shall be min. 为 hour fire resistance rating w/ NFPA 13 automatic sprinkler system (per IBC sect. 708.3). exception 2 or min. 1-hr w/ NFPA 13R system. Fire partitions shall extend from the top of the floor/ceiling assembly and be securely attached to the underside of the roof sheathing or the underside the roof/ceiling w/ a fire resistance rating not less than the fire partition.

INTERIOR EXIT STIARWELLS & EXIT PASSAGEWAYS

Per (IBC section 1023.2), "interior exit stairwells" require min. 1-hr fire rating \$ shall extend to the exterior of the building with an "exit passageway" w/ min. 1-hr fire rating (per IBC 1024.2) w/ min. 36" unobstructed width \$ max. occupant load of 50

OPENING PROTECTIVES

Min 1-hr fire doors in 1-hr rated fire barrier walls

Smoke alarms shall be provided in accordance w/ IBC Sect. 907.2.11.2 for group R-2

ACCESSIBILITY (CH.11)

ACCESSIBLE ROUTE Not required for:

- Upper stories or mezzanines or occupied roofs (per IBC 1104.4, exception 2). for stories that do not contain accessible elements as determined by sect. 1108
- 2nd stories in 2-story facilities w/ occupant load of 5 or less \$ no public space (per IBC 1104.4, exception 4)
- Group R-2 complying w/ section 1108.6.2.2.1 (Per IBC sect. 1108.4, exception 3) -- Type B units exempted by sect. 1108.7 (per IBC sect. 1108.4, exception 7) (see blw).

ACCESSIBLE R-2 DWELLING UNITS (IBC 1108.6.2.2 \$ 1108.7)

- Type A: 1108.6.2.2.1 Exception 2 Existing structures on a site shall not contribute to the total number of units on a site. There are (14) existing dwelling units and (9) proposed dwelling units. There are (9) proposed dwelling units, therefore Type A units
- not required In Group R-2 Occupancies containing less than (20) dwelling units.


 Type B: 1108.6.2.2.2 Exception The number of Type B units is permitted to be reduced in accordance with Section 1108.7.
- Buildings 3 and 4 qualify for the following Exceptions: -- IBC sect. 1108.7.1.1 - w/ Type B units provided on all ground level units of a
- structure w/o elevator service, other levels are not required to be Type B. -- IBC sect. 1108.7.2. - Multistory units w/o elevator service \$ dwelling area on both levels is not required to be Type B.

Please refer to the "Accessible type B Dwelling Units in Overall Building" table for units and aualifyina exceptions

ACCESSIBLE S-2 OCCUPANCY UNITS

- Garages shall be fully accessible on ground level

- 2nd level storage areas located within garages that have less than 5 occupants and no public space are not required to be accessible (Per IBC sect. 1104.4, Exception 4)

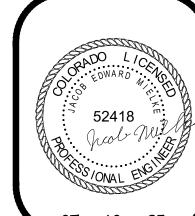


Code Compliance


以 了


ISSUE DATES 10 . 18 . 24 PERMIT 05 . 01 . 25 REVISION A


07 . 10 . 25 REVISION A

DRAWN BY: JEM REVIEWED BY: CWM PROJECT # 24051 ARCHITECTURAL NOTES & CODE

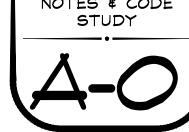

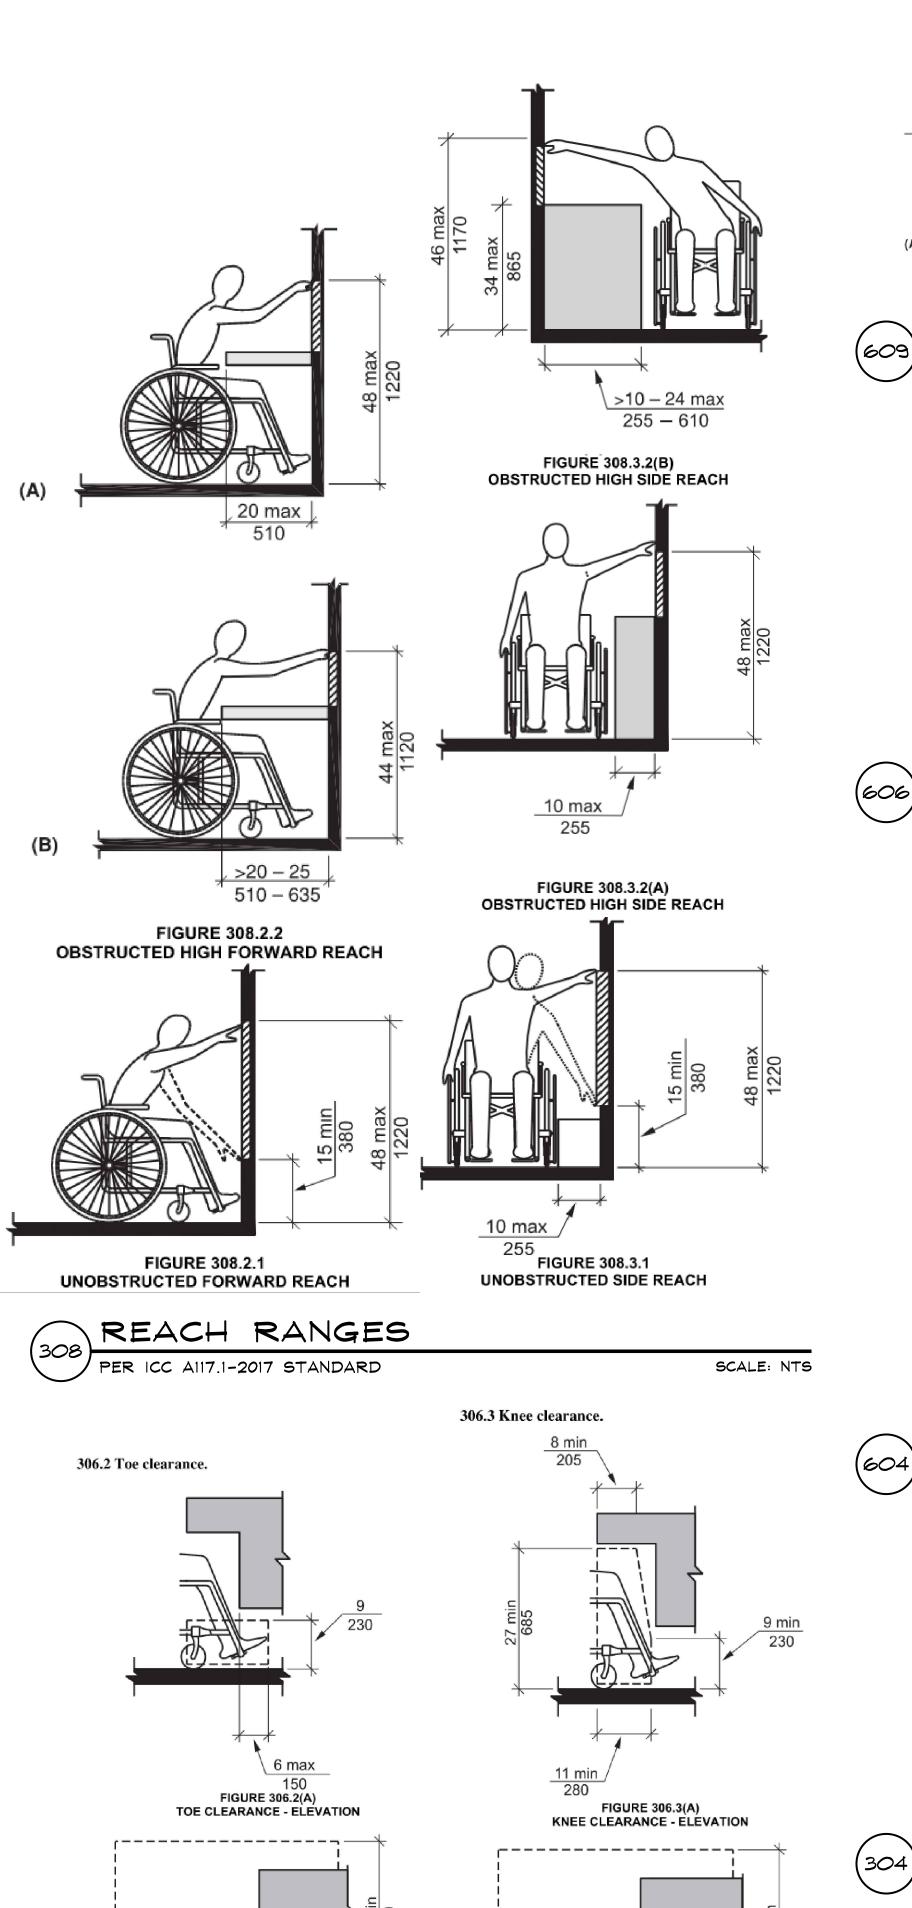

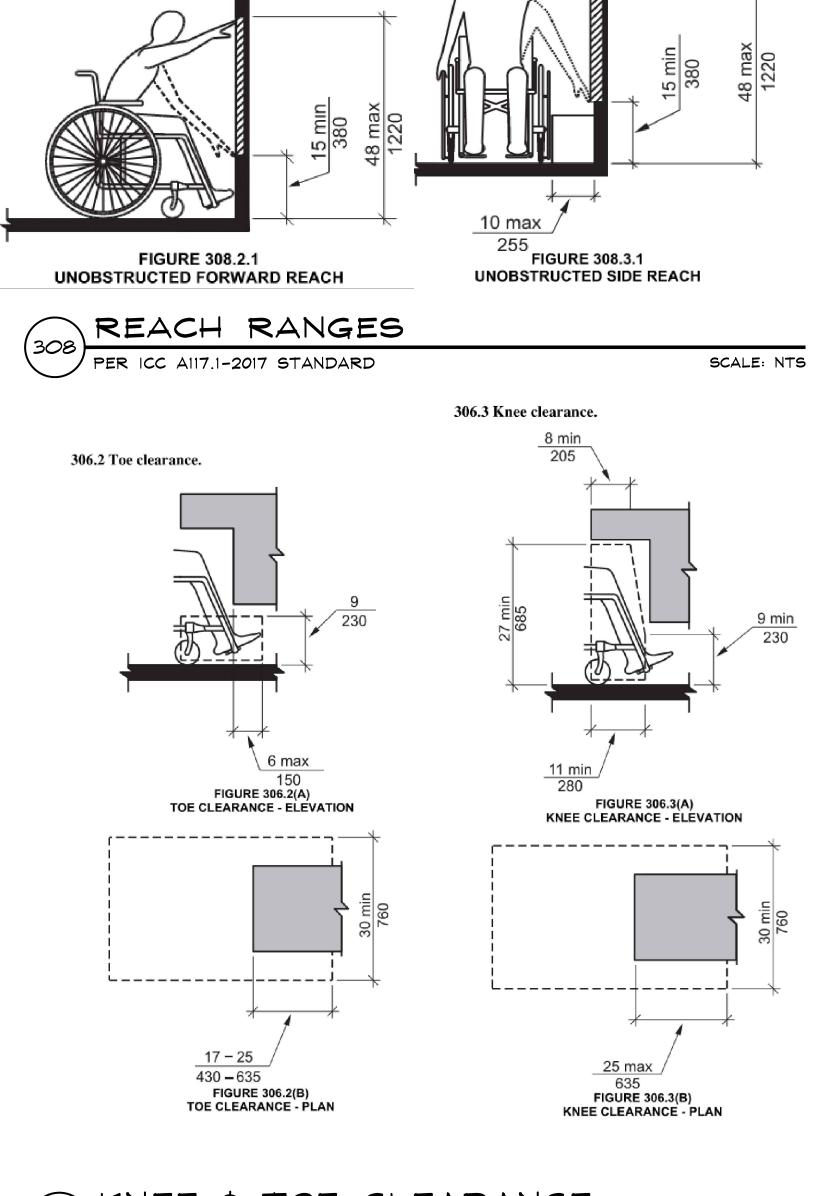

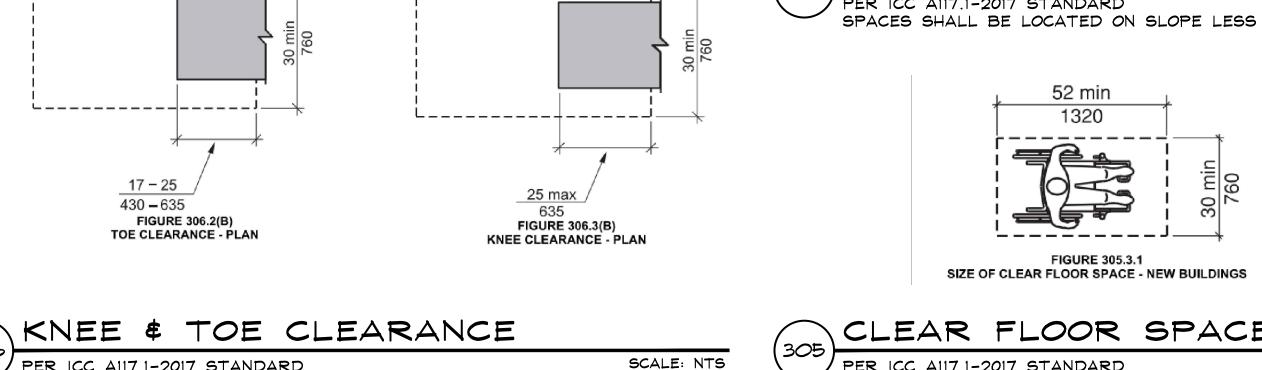





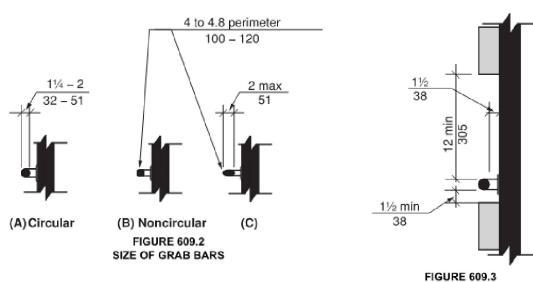



FIGURE 609.3 SPACING OF GRAB BARS GRAB BARS SCALE: NTS PER ICC A117.1-2017 STANDARD

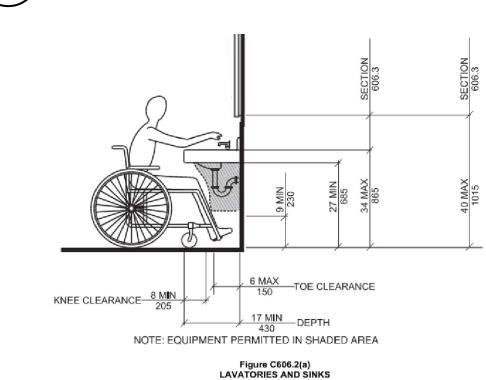

PUBLIC LAVATORY PER ICC A117.1-2017 STANDARD SCALE: NTS REFER TO CLEAR FLOOR SPACE STANDARDS

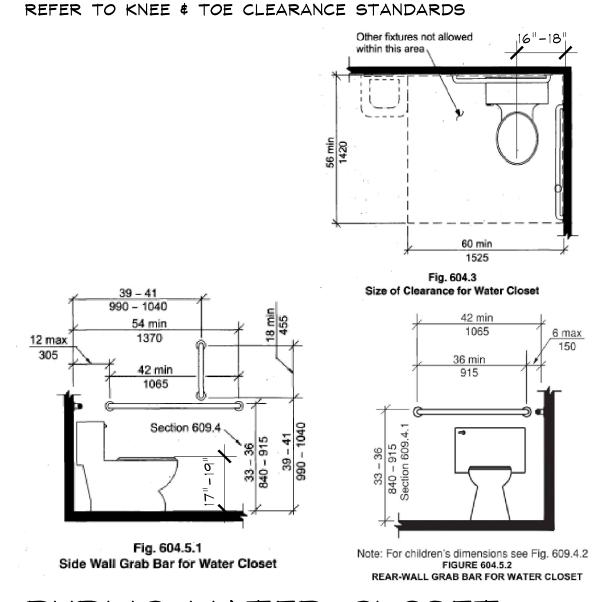

CLOSET PUBLIC WATER SCALE: NTS PER ICC A117.1-2017 STANDARD

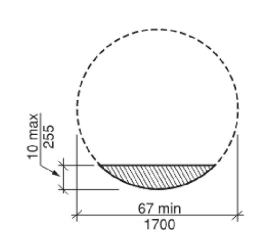

Overlap of knee and toe clearance FIGURE 304.3.1.1 **CIRCULAR TURNING SPACE - NEW BUILDINGS** SIZE AND OVERLAP

CIRCULAR TURNING SPACE PER ICC A117.1-2017 STANDARD SCALE: NTS SPACES SHALL BE LOCATED ON SLOPE LESS THAN 1:48

CLEAR FLOOR SPACE

PER ICC A117.1-2017 STANDARD SCALE: NTS SPACES SHALL BE LOCATED ON SLOPE LESS THAN 1:48


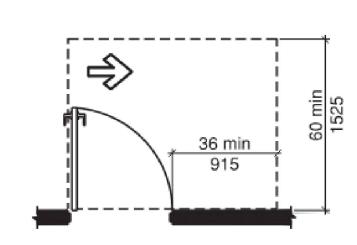



FIGURE 404.2.3.2(D) MANEUVERING CLEARANCE AT MANUAL SWINGING DOORS HINGE APPROACH - PULL SIDE

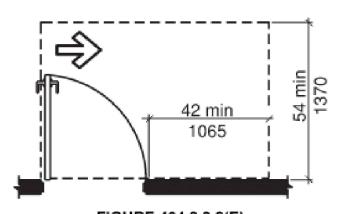

MANEUVERING CLEARANCE AT MANUAL SWINGING DOORS

LATCH APPROACH - PULL SIDE

FIGURE 404.2.3.2(E)
MANEUVERING CLEARANCE AT MANUAL SWINGING DOORS HINGE APPROACH - PULL SIDE

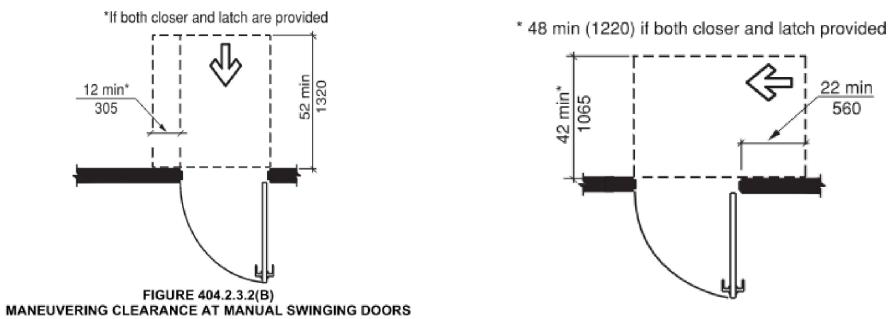

FRONT APPROACH - PUSH SIDE - NEW BUILDINGS FIGURE 404.2.3.2(F)
MANEUVERING CLEARANCE AT MANUAL SWINGING DOORS *If both closer and latch are provided

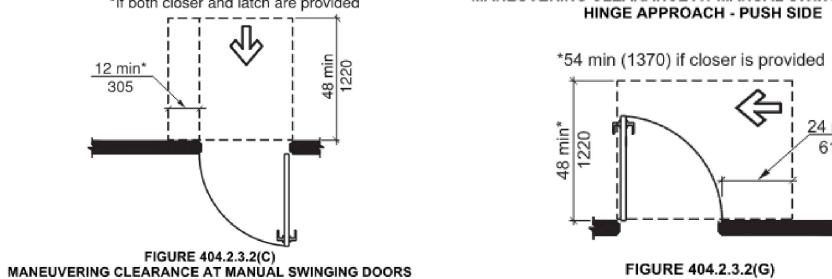




FIGURE 404.2.3.5(A)
RECESSED DOORS AND GATES - NEW BUILDINGS

PULL SIDE

FIGURE 404.2.3.5(B)

RECESSED DOORS AND GATES - NEW BUILDINGS

PUSH SIDE


FIGURE 404.2.3.5(C)

RECESSED DOORS AND GATES - NEW BUILDINGS

PUSH SIDE - DOOR PROVIDED WITH BOTH

CLOSER AND LATCH

PER ICC A117.1-2017 STANDARD MIN. CLEAR WIDTH OF DOOR OPENING IS 32" DOORS IN SERIES NEED MIN. 48" CLEAR PLUS WIDTH OF DOORS SWINGING INTO SPACE

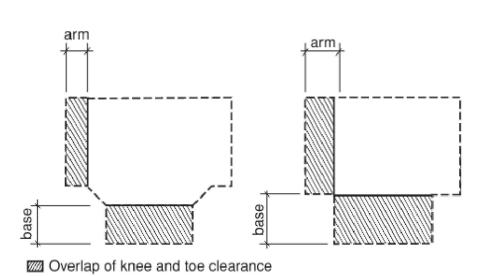


FRONT APPROACH - PUSH SIDE - EXISTING BUILDINGS

FOOTNOTE 4

FIGURE 404.2.3.2(A) MANEUVERING CLEARANCE AT MANUAL SWINGING DOORS

FRONT APPROACH - PULL SIDE

FIGURE 304.3.2.1.1 T-SHAPED TURNING SPACE **NEW BUILDINGS - OVERLAP**

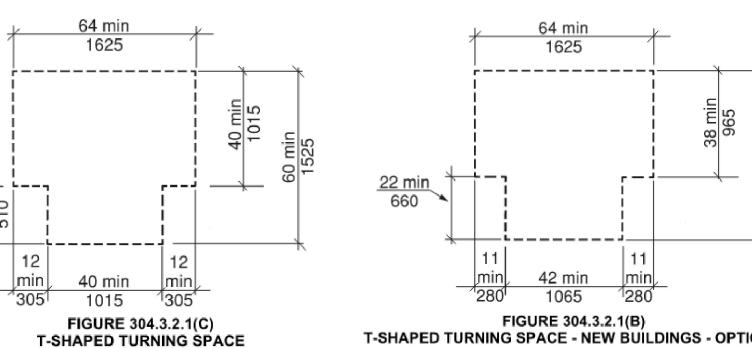

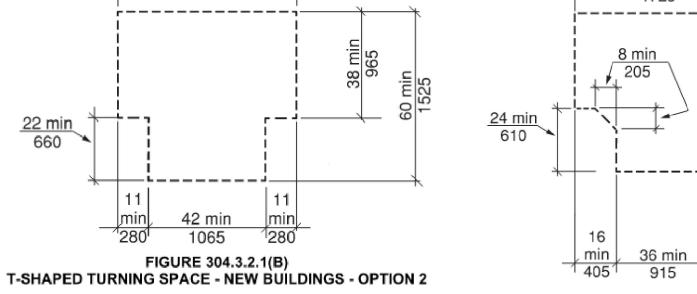


FIGURE 304.3.2.1(A) T-SHAPED TURNING SPACE - NEW BUILDINGS - OPTION 1

1725 ------

PER ICC A117.1-2017 STANDARD SPACES SHALL BE LOCATED ON SLOPE LESS THAN 1:48 DOORS ARE PERMITTED TO SWING INTO TURING SPACES, U.N.O.

-SHAPED TURNING SPACE

NEW BUILDINGS - OPTION 3

SCALE: NTS


SCALE: N.T.S.


Code Compliance

10 . 18 . 24 PERMIT 05 . 01 . 25 REVISION A 07 . 10 . 25 REVISION A

> DRAWN BY: JEM REVIEWED BY: CWM PROJECT # 24051 PUBLIC ADA SPECIFICATIONS

STANDARDS

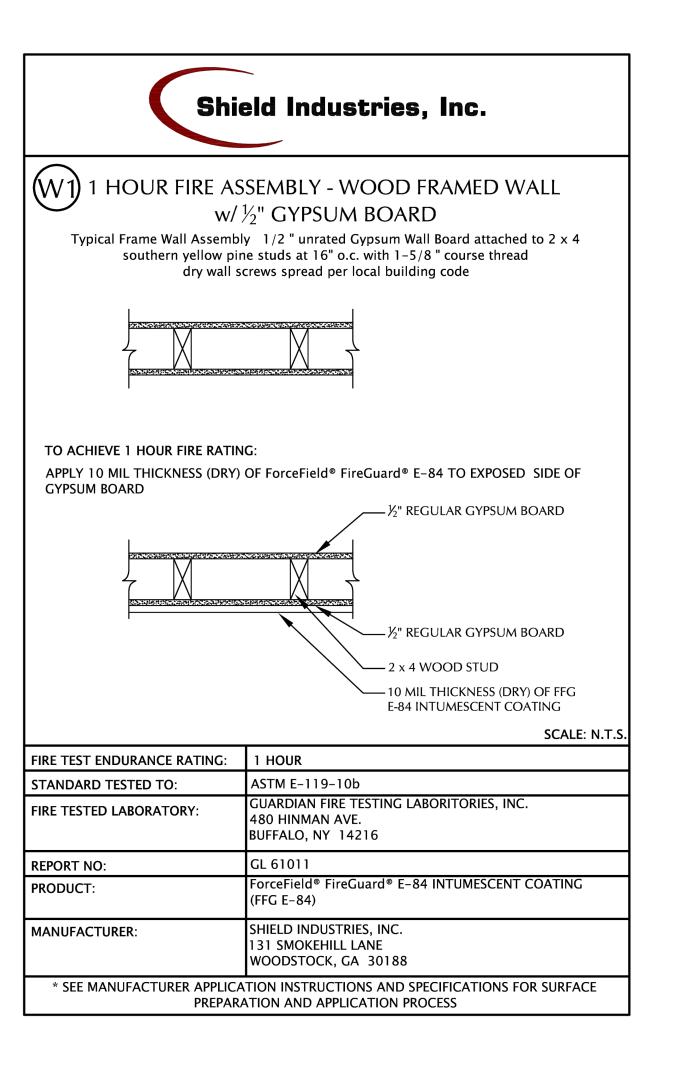

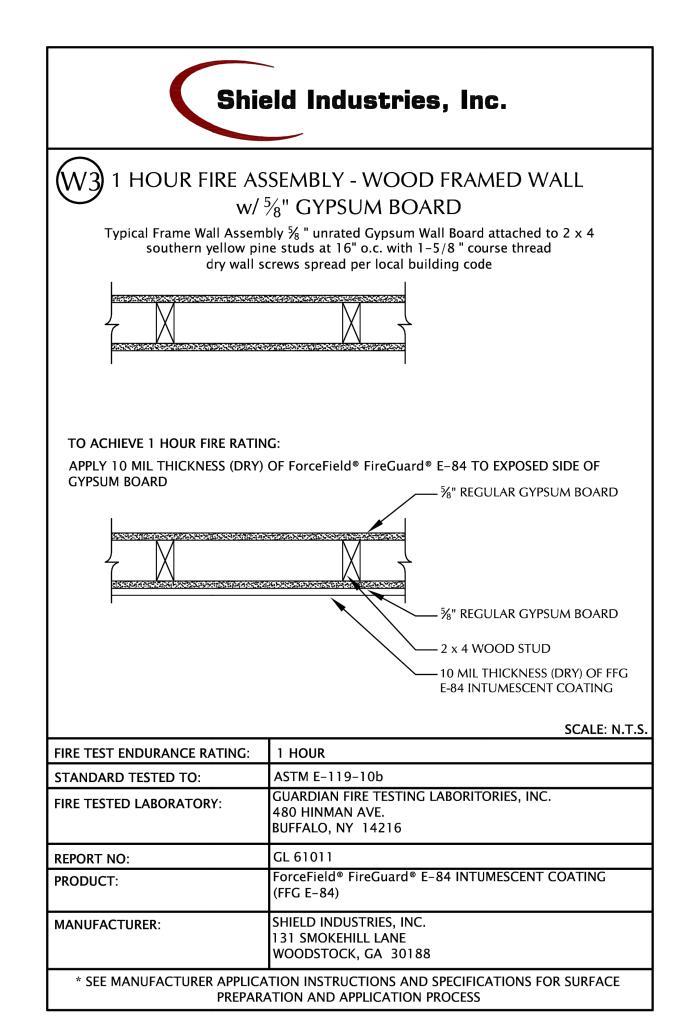

GENERIC

GENERIC

GA FILE NO. WP 3510

GA FILE NO. WP 3514

Joints staggered 16" on opposite sides. (LOAD-BEARING)


Joints staggered 24" on opposite sides. (LOAD-BEARING)


GYPSUM WALLBOARD, WOOD STUDS One layer 5/8" type X gypsum wallboard or gypsum veneer base applied parallel or at right angles to each side of 2 x 4 wood studs 24" o.c. with 6d coated nails, 1-7/8" long, 0.0915" shank, 1/4" heads, 7" o.c.


GYPSUM WALLBOARD, WOOD STUDS

One layer 5/8" type X gypsum wallboard or gypsum veneer base applied parallel or at right

angles to each side of 2 x 4 wood studs 16" o.c. with 11/4" Type W drywall screws 12

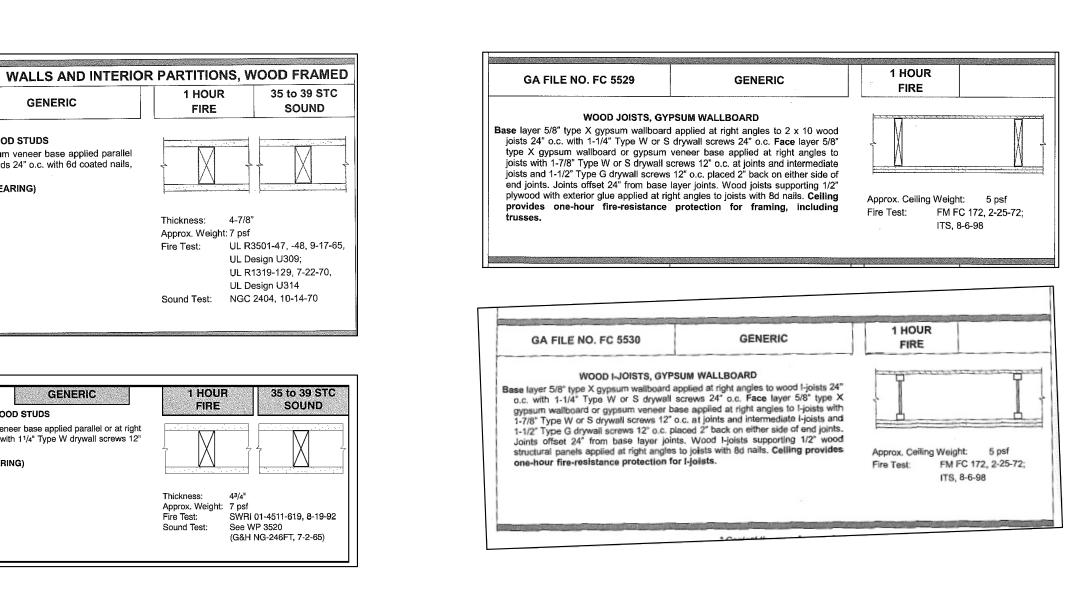

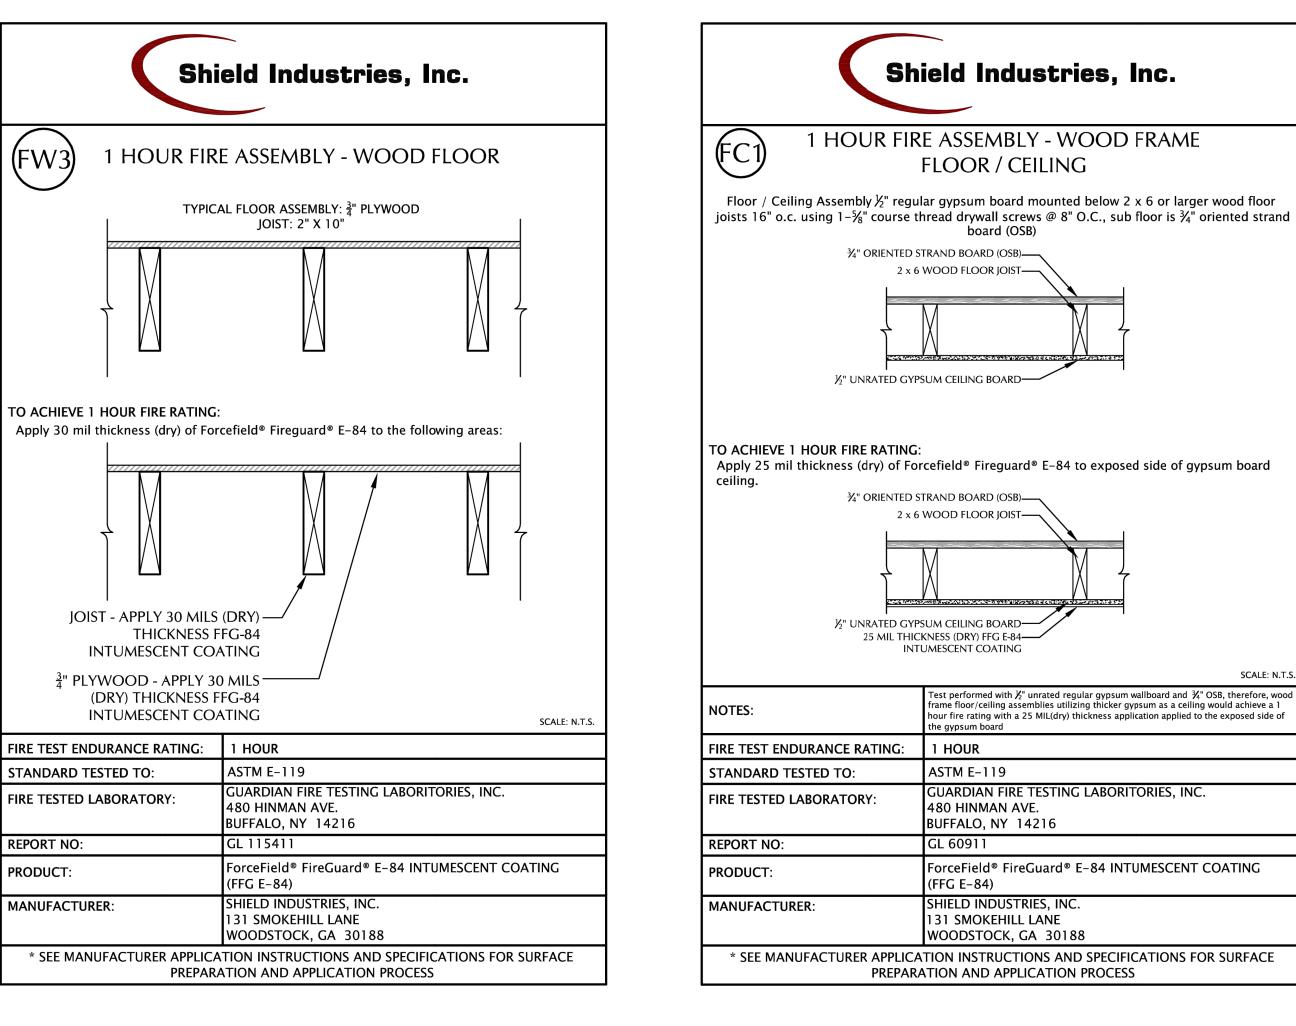


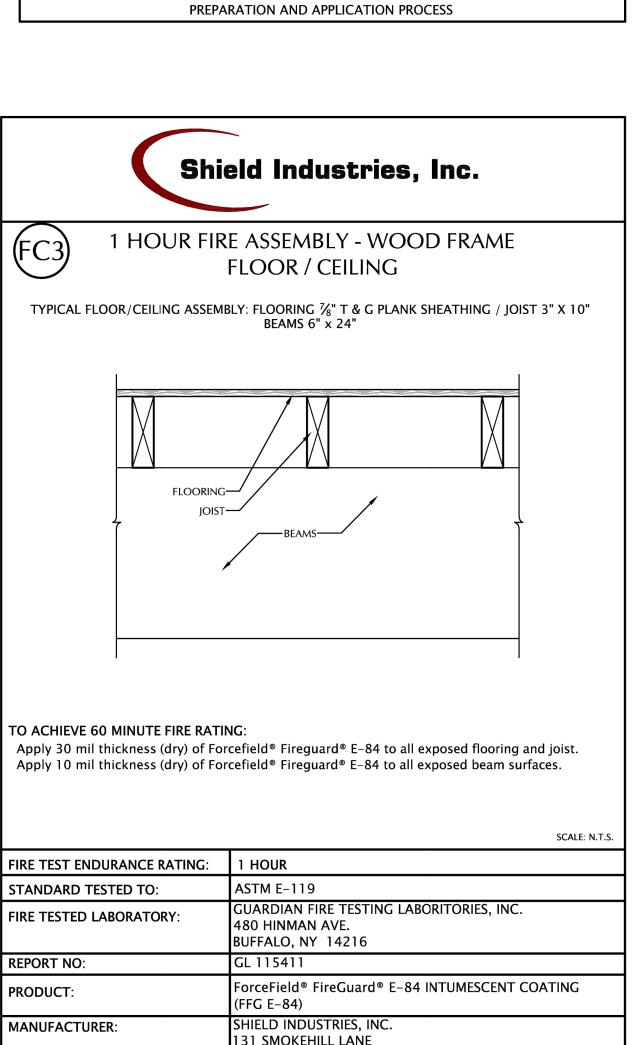

WOODSTOCK, GA 30188

* SEE MANUFACTURER APPLICATION INSTRUCTIONS AND SPECIFICATIONS FOR SURFACE

PREPARATION AND APPLICATION PROCESS

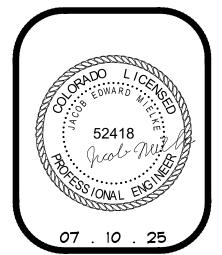

10 . 18 . 24 PERMIT 05 . 01 . 25 REVISION A

07 . 10 . 25 REVISION 🛕

REVIEWED BY: CWM PROJECT # 24051 1-hr RATED ASSEMBLY OPTIONS


DRAWN BY: JEM

PLANNING USE	
SHADING KEY	
= UTILITY (GARAGE) USE	
= DWELLING UNIT USE	
= STAIRWELL	


UNIT 13	SQUARE FOOTAG	E SUMMARY TABLE:	
tevel 1	Garage 13A	U (13A)	355
tevel 1	Dwelling Unit 13A	R-2 (13A)	713
tevet 2	Garage 13A	U (13A)	137
teve# 2	Dwelling Unit 13A	R-2 (13A)	252
tevet 2	Garage 13B	U (13B)	158
te vel 3	Dwelling Unit 13B	R-2 (13B)	903


THE SHADED USES AND AREAS LISTED THIS PLAN ARE BASED ON THE CITY OF STEAMBOAT SPRINGS PLANNING DEPARTMENT AND DEVELOPMENT CODE APPLICATION PL20240033. THESE USES WERE APPROVED THIS APPLICATION. PLEASE REFER TO THE FOLLOWING SHEETS FOR ALL IBC USES AND SQUARE FOOTAGES

UNIT 13 DWELLING	UNIT	TABLE:
Garage (13A)		592
Dwelling Unit (13A)		965
Unit 13 A Total		1557
Unit 138 Total		1061

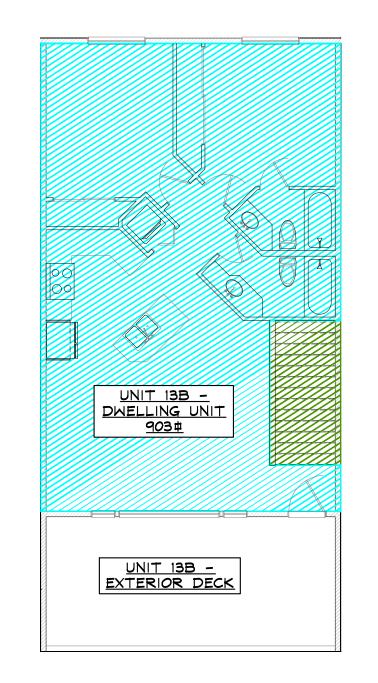

SCALE: 1/32" = 1'-0"

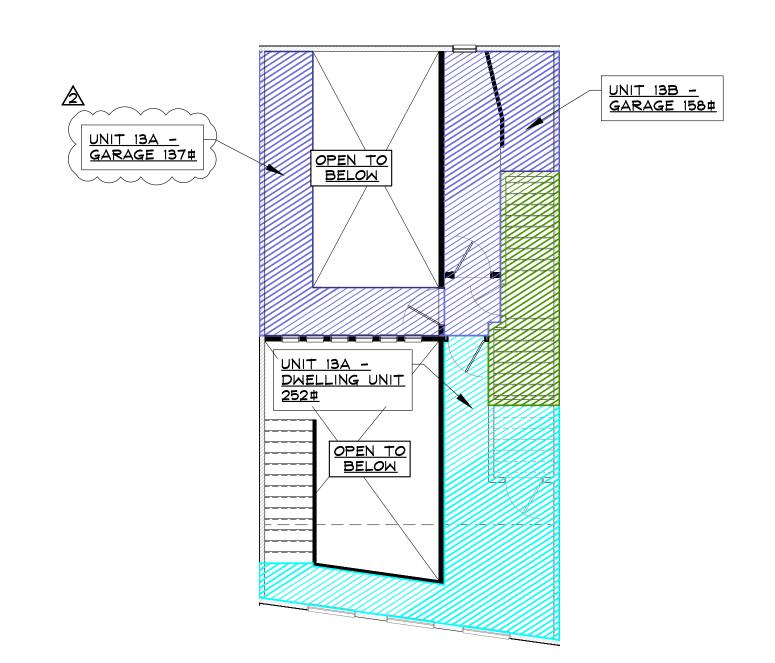


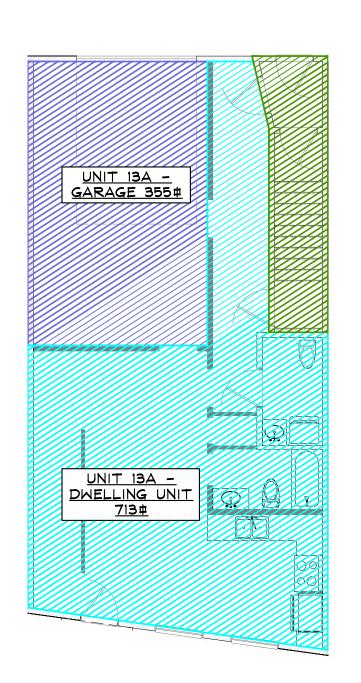

ONE FLOOR PLAN - USE SCALE: 1 = 1-0"





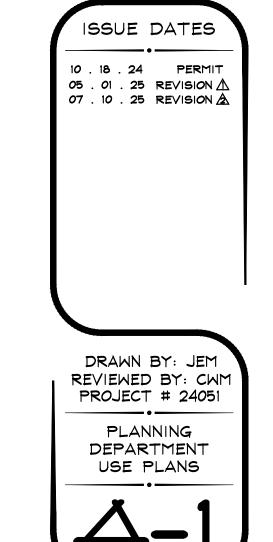

D TO SERIDGE OF

NOTES

CONTRACTOR TO PROVIDE/VERIFY EXISTING STAIRS HAVE MAX 7" RISERS & MIN 11" TREADS AT ALL STAIRS. MAX TOLERANCE BETWEEN THE LARGEST AND SMALLEST FOR STAIR RISERS AND TREADS ON ALL FLIGHTS OF STAIRS SHALL BE 3/ PER IBC SEC. 1011.5.4

- 2. PROVIDE/VERIFY GRASPABLE HANDRAILS PER IBC SEC. 1014 AT ALL STAIRS
- B. PROVIDE/VERIFY GUARDRAILS PER IBC SEC. 1015 AT ALL STAIRS
- 4. ENTRY & STAIRWELL FLOOR AREA INCLUDED IN MOST STRINGENT OCCUPANCY RATING FOR AREA SERVED PER
- 5. COMMERCIAL SPACES SHALL BE FLEXIBLE OCCUPANCIES AS ALLOWED FROM CDC TABLE 300-1

6. PER RCRBD, ANY FUTURE TENANT FINISH IMPROVEMENT PERMITS OR FUTURE CHANGE OF USE W/IN COMMERCIAL UNITS SHALL BE OBTAINED FOR EA. BUSINESS IN ADVANCE TO WORK DONE IN UNIT.

'. ALL STORAGE (S-2) AREAS ON LEVEL 2 ARE LESS THAN 250# AND LESS THAN (5) OCCUPANTS, THEREFORE CAN BE ACCESSED VIA AN ALTERNATING TREAD DEVICE PER IBC 1011.14.

8. ALL UTILITY AREAS ON LEVEL 2 ARE NOT OPEN TO THE GENERAL PUBLIC, THEREFORE PER IBC 1011.16 EXCEPTION 4 CAN BE ACCESSED VIA PERMANENT LADDER.


9. ALL BEDROOMS SHALL HAVE AN EMERGENCY ESCAPE/RESCUE OPENING PER IBC 1031.3.

10. ALL DOORS IN FIREWALL SHALL BE 1hr RATED \$ SHALL MEET THE REQUIREMENTS OF IBC TABLE 716.1(2).

SEAL ALL PENETRATIONS THROUGH FIRE-RATED SEPERATION WALLS & HORIZONTAL ASSEMBLIES w/ HILIT FS-ONE FIRESTOP TO SATISFY IBC 714.4.1.2 - INSTALL PER MANUFACTURER'S RECOMMENDATIONS.



RCRBC Comments and Approval Notes on Contractors Request to Keep these interior windows in the existing wall: Contractor may keep these windows installed in this existing wall between the garage and dwelling, however this is a 20-minute wall and it must be constructed to meet a 20-minute rating and be sealed properly on the garage side of this wall. Contractor to install a base layer of of 1/2" gypsum on garage side of this wall over the entire wall, call for an inspection once all seams are fire taped. Then Contractor to install a final layer of Type X 5/8" Gypsum staggered seams over the base layer, and fire tape this layer.

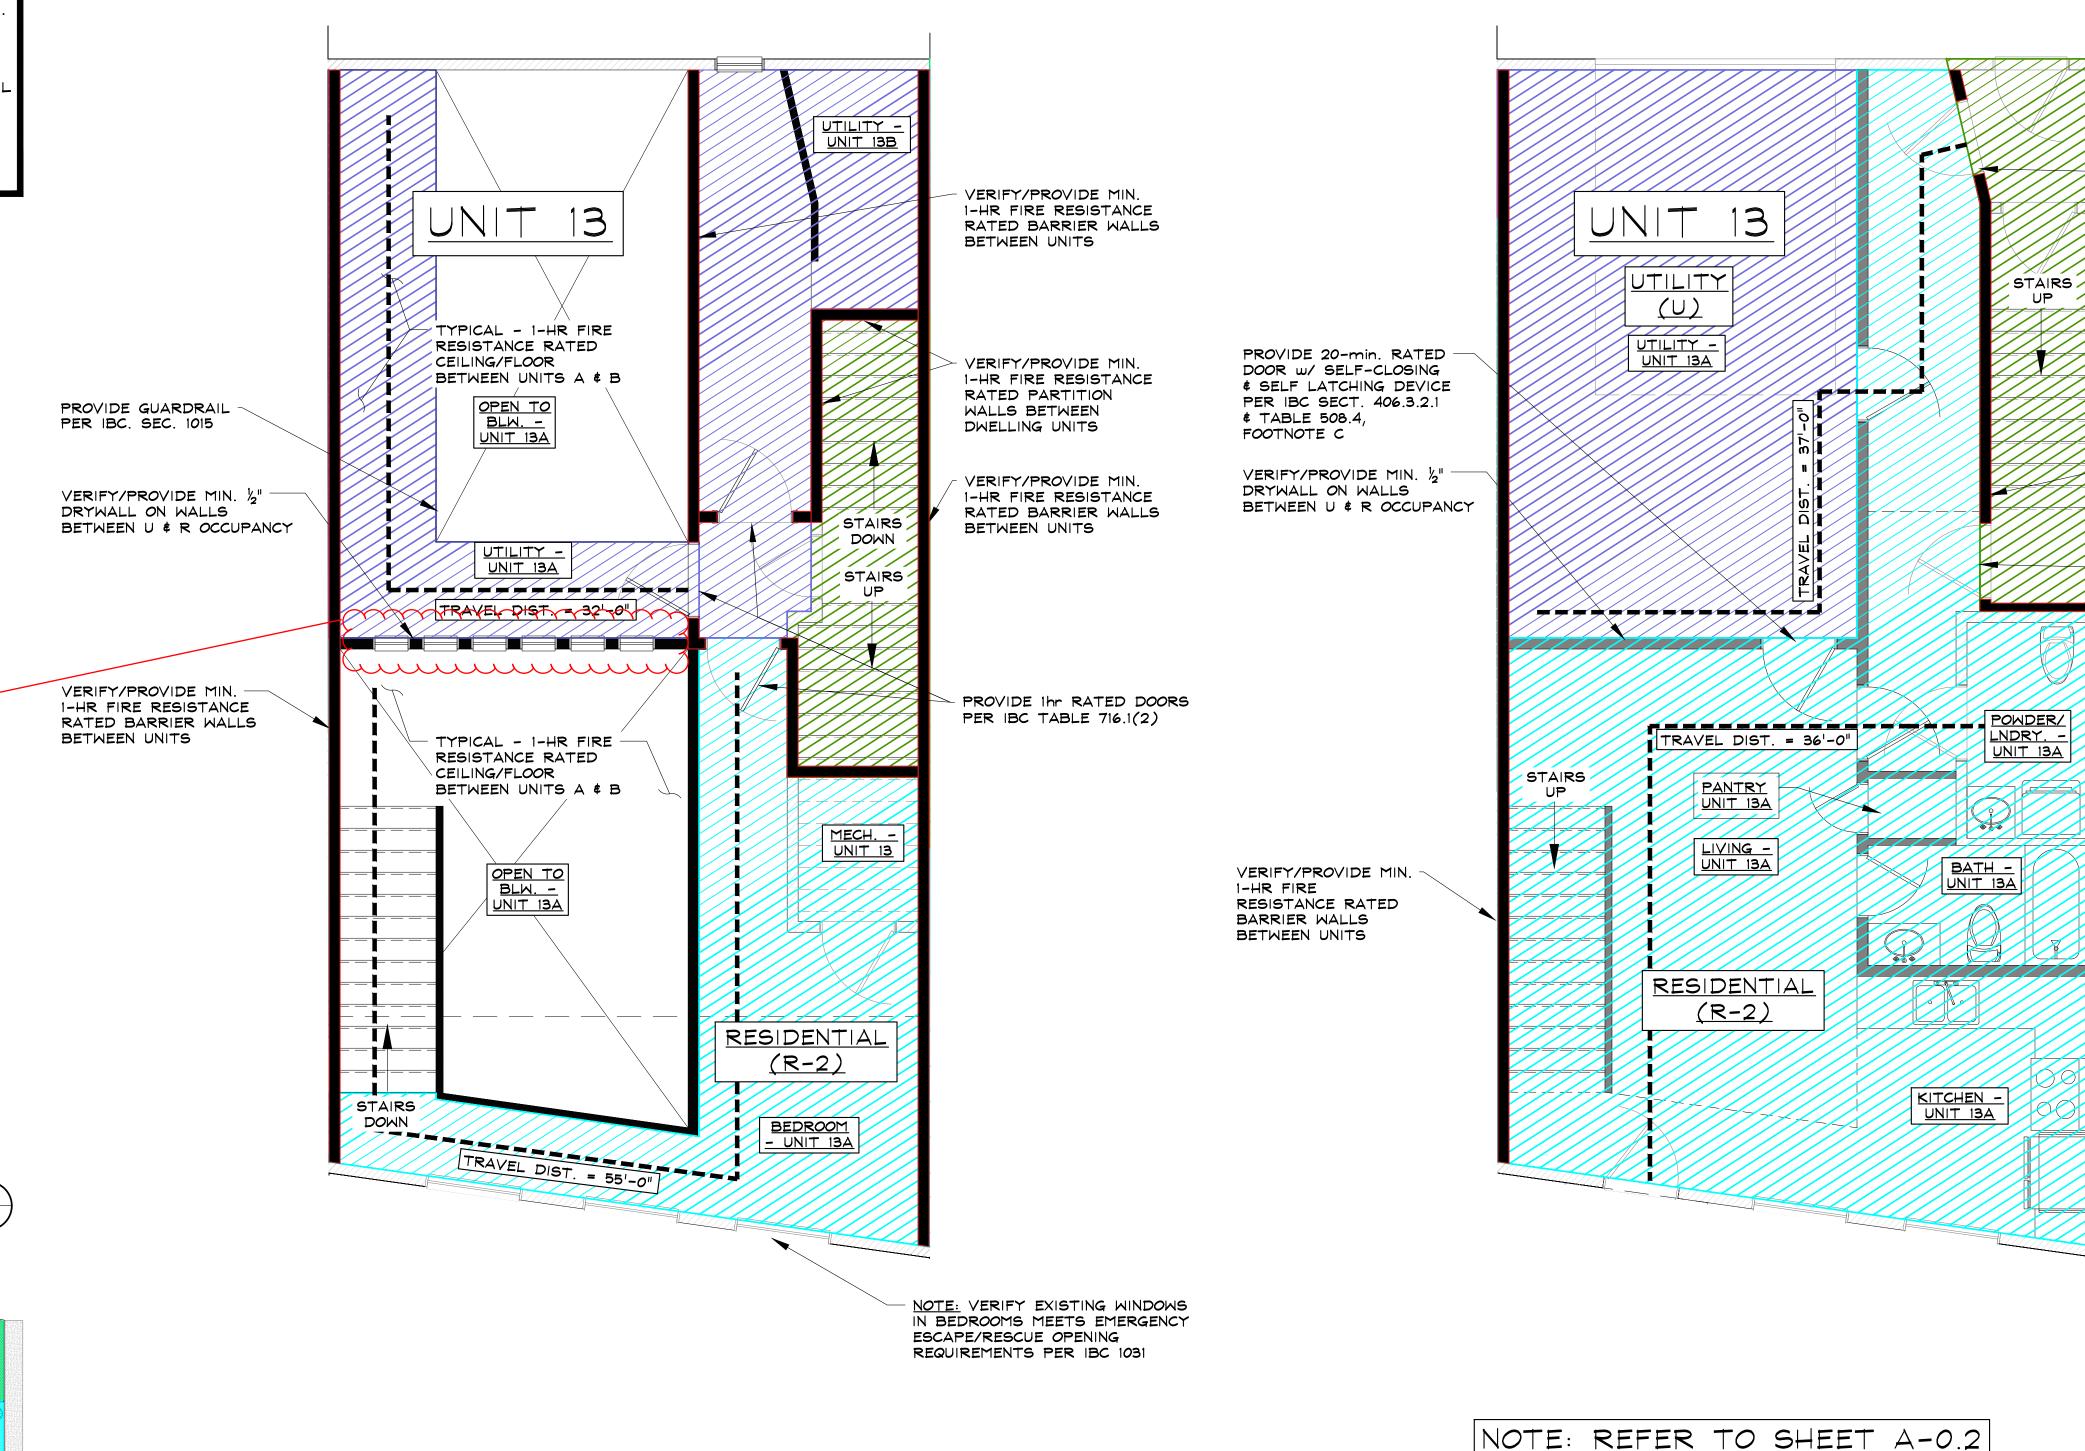



Compliance

_

(X) (T)

10 . 18 . 24 PERMIT 05 . 01 . 25 REVISION A 07 . 10 . 25 REVISION A

DRAWN BY: JEM REVIEWED BY: CWM

PROJECT # 24051 LEVEL ONE \$ TWO USE/FIRE SEPARATION PLAN

LEVEL ONE USE / FIRE SEPARATION PLAN

ASSEMBLIES

FOR FIRE RESISTANCE RATED

PLAN

PROVIDE 1hr RATED DOOR

VERIFY/PROVIDE MIN. 1-HR

FIRE RESISTANCE RATED

PROVIDE 1hr RATED DOOR

PER IBC TABLE 716.1(2)

VERIFY/PROVIDE MIN.

RESISTANCE RATED BARRIER WALLS

BETWEEN UNITS

1-HR FIRE

INTERIOR STAIRWELL \$

EXIT PASSAGE WALLS

PER IBC TABLE 716.1(2)

CONTRACTOR TO PROVIDE/VERIFY EXISTING STAIRS HAVE MAX 7" RISERS & MIN 11" TREADS AT ALL STAIRS. MAX TOLERANCE BETWEEN THE LARGEST AND SMALLEST FOR STAIR RISERS AND TREADS ON ALL FLIGHTS OF STAIRS SHALL BE 3/8" PER IBC SEC. 1011.5.4

2. PROVIDE/VERIFY GRASPABLE HANDRAILS PER IBC SEC. 1014 AT ALL STAIRS

B. PROVIDE/VERIFY GUARDRAILS PER IBC SEC. 1015 AT ALL STAIRS

4. ENTRY & STAIRWELL FLOOR AREA INCLUDED IN MOST STRINGENT OCCUPANCY RATING FOR AREA SERVED PER IBC 1004.1

5. COMMERCIAL SPACES SHALL BE FLEXIBLE OCCUPANCIES AS ALLOWED FROM CDC TABLE 300-1

6. PER RCRBD, ANY FUTURE TENANT FINISH IMPROVEMENT PERMITS OR FUTURE CHANGE OF USE W/IN COMMERCIAL UNITS SHALL BE OBTAINED FOR EA. BUSINESS IN ADVANCE TO WORK DONE IN UNIT.


7. ALL STORAGE (S-2) AREAS ON LEVEL 2 ARE LESS THAN 250# AND LESS THAN (5) OCCUPANTS, THEREFORE CAN BE ACCESSED VIA AN ALTERNATING TREAD DEVICE PER IBC 1011.14.


8. ALL UTILITY AREAS ON LEVEL 2 ARE NOT OPEN TO THE GENERAL PUBLIC, THEREFORE PER IBC 1011.16 EXCEPTION 4 CAN BE ACCESSED VIA PERMANENT LADDER.


9. ALL BEDROOMS SHALL HAVE AN EMERGENCY ESCAPE/RESCUE OPENING PER IBC 1031.3.

10. ALL DOORS IN FIREWALL SHALL BE 1hr RATED \$ SHALL MEET THE REQUIREMENTS OF IBC TABLE 716.1(2).


. SEAL ALL PENETRATIONS THROUGH FIRE-RATED SEPERATION WALLS & HORIZONTAL ASSEMBLIES W/ HILIT FS-ONE FIRESTOP TO SATISFY IBC 714.4.1.2 - INSTALL PER MANUFACTURER'S RECOMMENDATIONS.

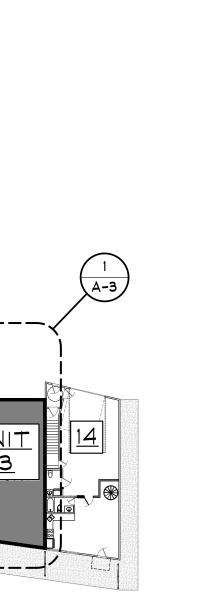

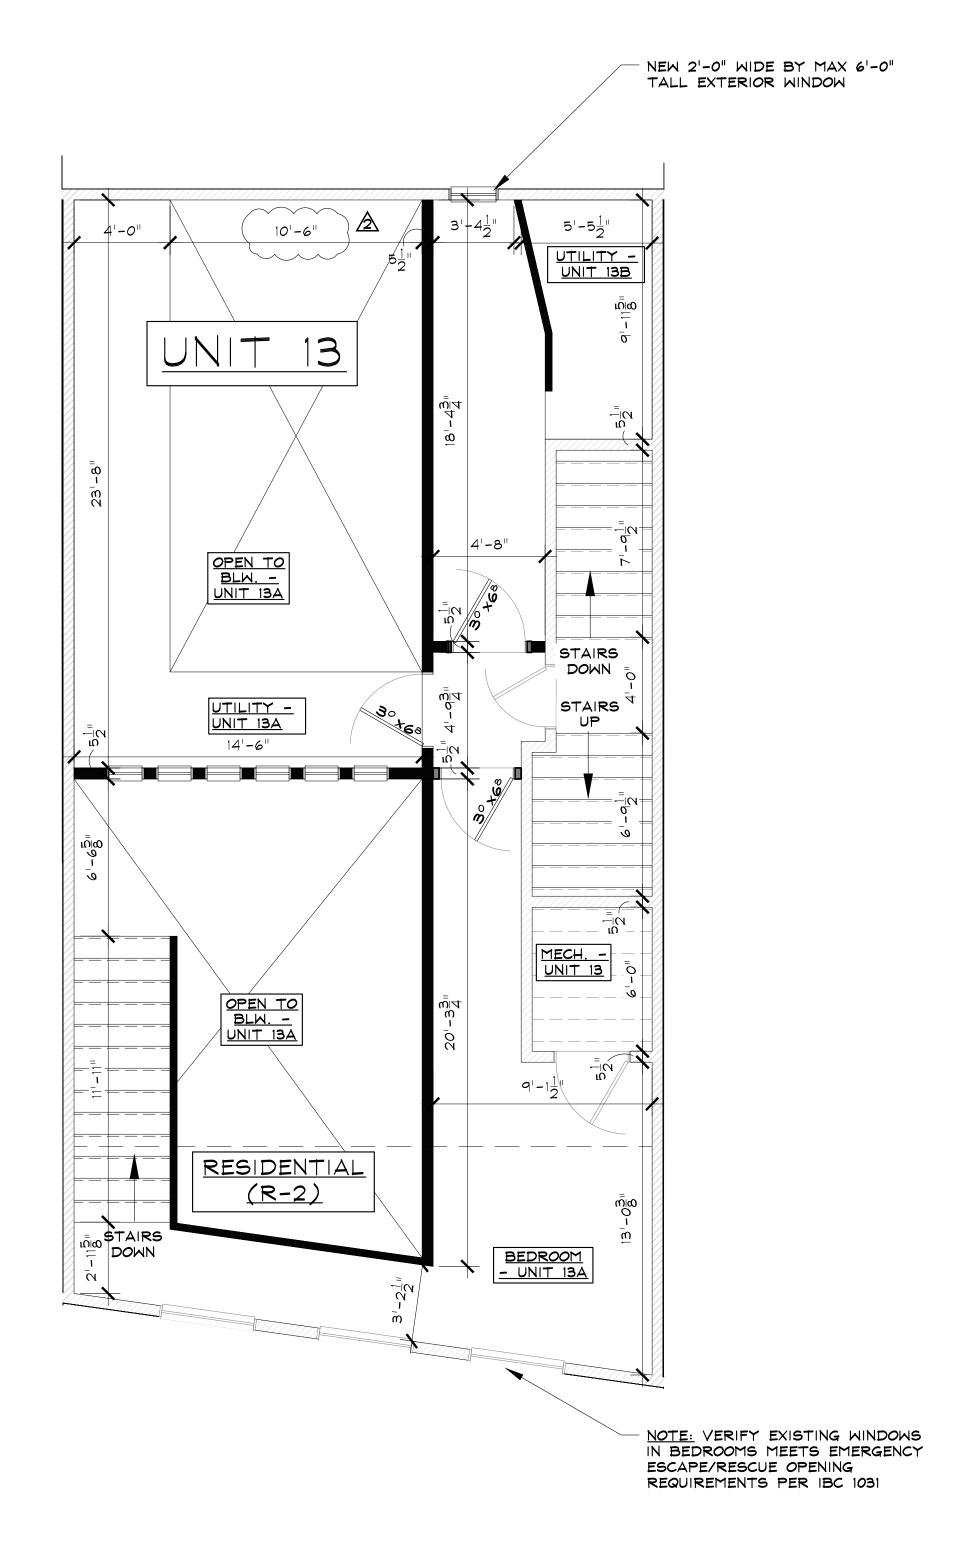


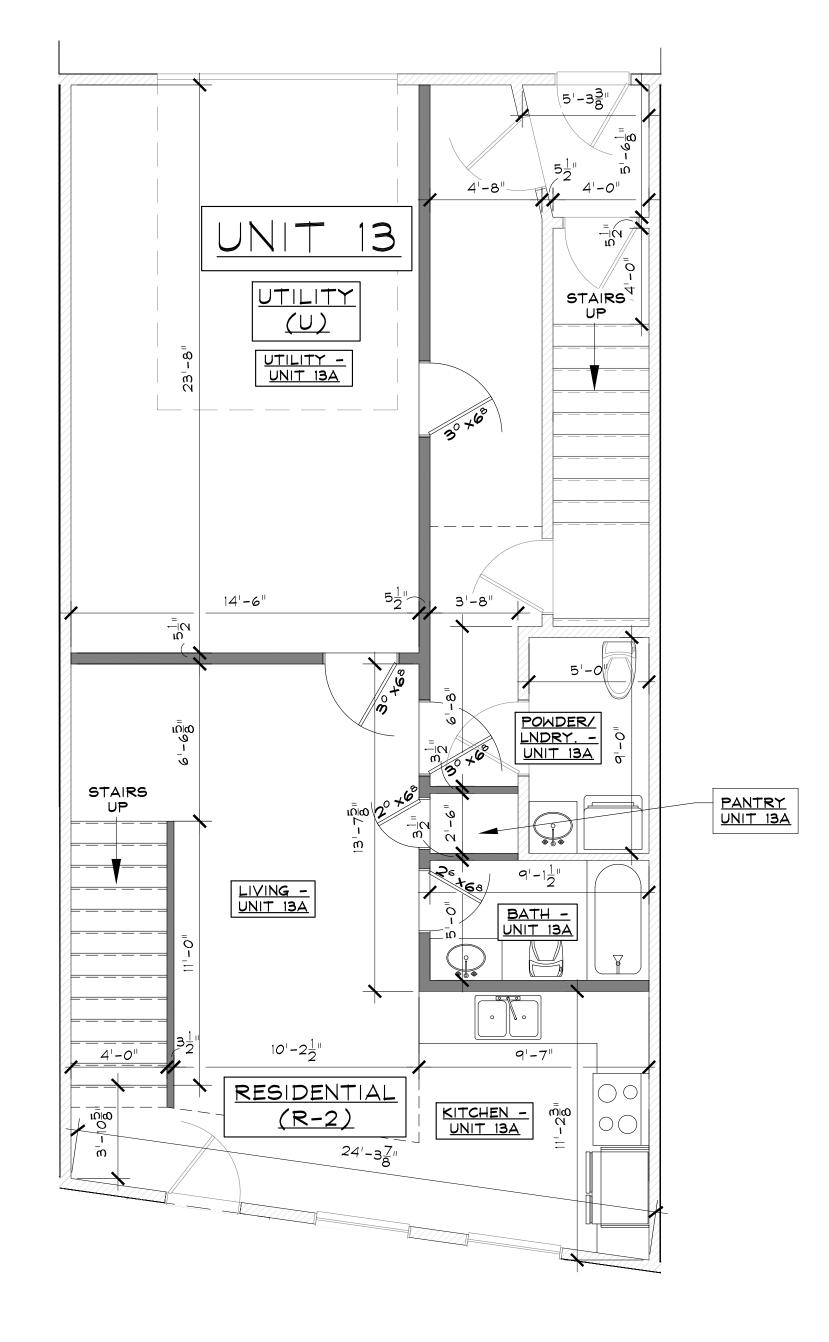

NOTE: REFER TO SHEET A-0.2 FOR FIRE RESISTANCE RATED ASSEMBLIES.

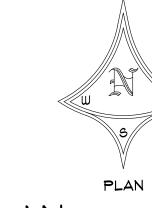

LEVEL ONE DIMENSIONED FLOOR PLAN

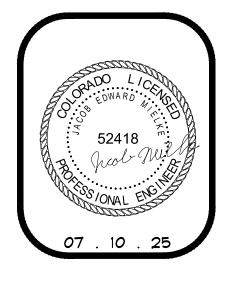

Code Compliance

RFF

10 . 18 . 24 PERMIT 05 . 01 . 25 REVISION A 07 . 10 . 25 REVISION A

DRAWN BY: JEM REVIEWED BY: CWM PROJECT # 24051 LEVEL ONE \$ TWO DIMENSIONED FLOOR PLAN

BUILDING LOCATION KEY

LEVEL TWO DIMENSIONED FLOOR PLAN

CONTRACTOR TO PROVIDE/VERIFY EXISTING STAIRS HAVE MAX 7" RISERS & MIN 11" TREADS AT ALL STAIRS. MAX TOLERANCE BETWEEN THE LARGEST AND SMALLEST FOR STAIR RISERS AND TREADS ON ALL FLIGHTS OF STAIRS SHALL BE 3/8" PER IBC SEC. 1011.5.4

- 2. PROVIDE/VERIFY GRASPABLE HANDRAILS PER IBC SEC. 1014 AT ALL STAIRS
- B. PROVIDE/VERIFY GUARDRAILS PER IBC SEC. 1015 AT ALL STAIRS
- 4. ENTRY & STAIRWELL FLOOR AREA INCLUDED IN MOST STRINGENT OCCUPANCY RATING FOR AREA SERVED PER IBC 1004.1
- 5. COMMERCIAL SPACES SHALL BE FLEXIBLE OCCUPANCIES AS ALLOWED FROM CDC TABLE 300-1

6. PER RCRBD, ANY FUTURE TENANT FINISH IMPROVEMENT PERMITS OR FUTURE CHANGE OF USE W/IN COMMERCIAL UNITS SHALL BE OBTAINED FOR EA. BUSINESS IN ADVANCE TO WORK DONE IN UNIT.

7. ALL STORAGE (S-2) AREAS ON LEVEL 2 ARE LESS THAN 250# AND LESS THAN (5) OCCUPANTS, THEREFORE CAN BE ACCESSED VIA AN ALTERNATING TREAD DEVICE PER IBC 1011.14.

8. ALL UTILITY AREAS ON LEVEL 2 ARE NOT OPEN TO THE GENERAL PUBLIC, THEREFORE PER IBC 1011.16 EXCEPTION 4 CAN BE ACCESSED VIA PERMANENT LADDER.


9. ALL BEDROOMS SHALL HAVE AN EMERGENCY ESCAPE/RESCUE OPENING PER IBC 1031.3.


10. ALL DOORS IN FIREWALL SHALL BE 1hr RATED \$ SHALL MEET THE REQUIREMENTS OF IBC TABLE 716.1(2).


. SEAL ALL PENETRATIONS THROUGH FIRE-RATED SEPERATION WALLS & HORIZONTAL ASSEMBLIES W/ HILIT FS-ONE FIRESTOP TO SATISFY IBC 714.4.1.2 - INSTALL PER MANUFACTURER'S RECOMMENDATIONS.

LEGEND

- = EXISTING WALLS TO BE REMOVED
- = EXISTING WOOD FRAMED WALLS TO REMAIN
- = PROPOSED WOOD FRAMED NON-BEARING WALLS
- = EXISTING NON-PERMITTED WALLS/DOORS/ROOMS
- = EXISTING NON-PERMITTED KITCHEN/BATHROOM

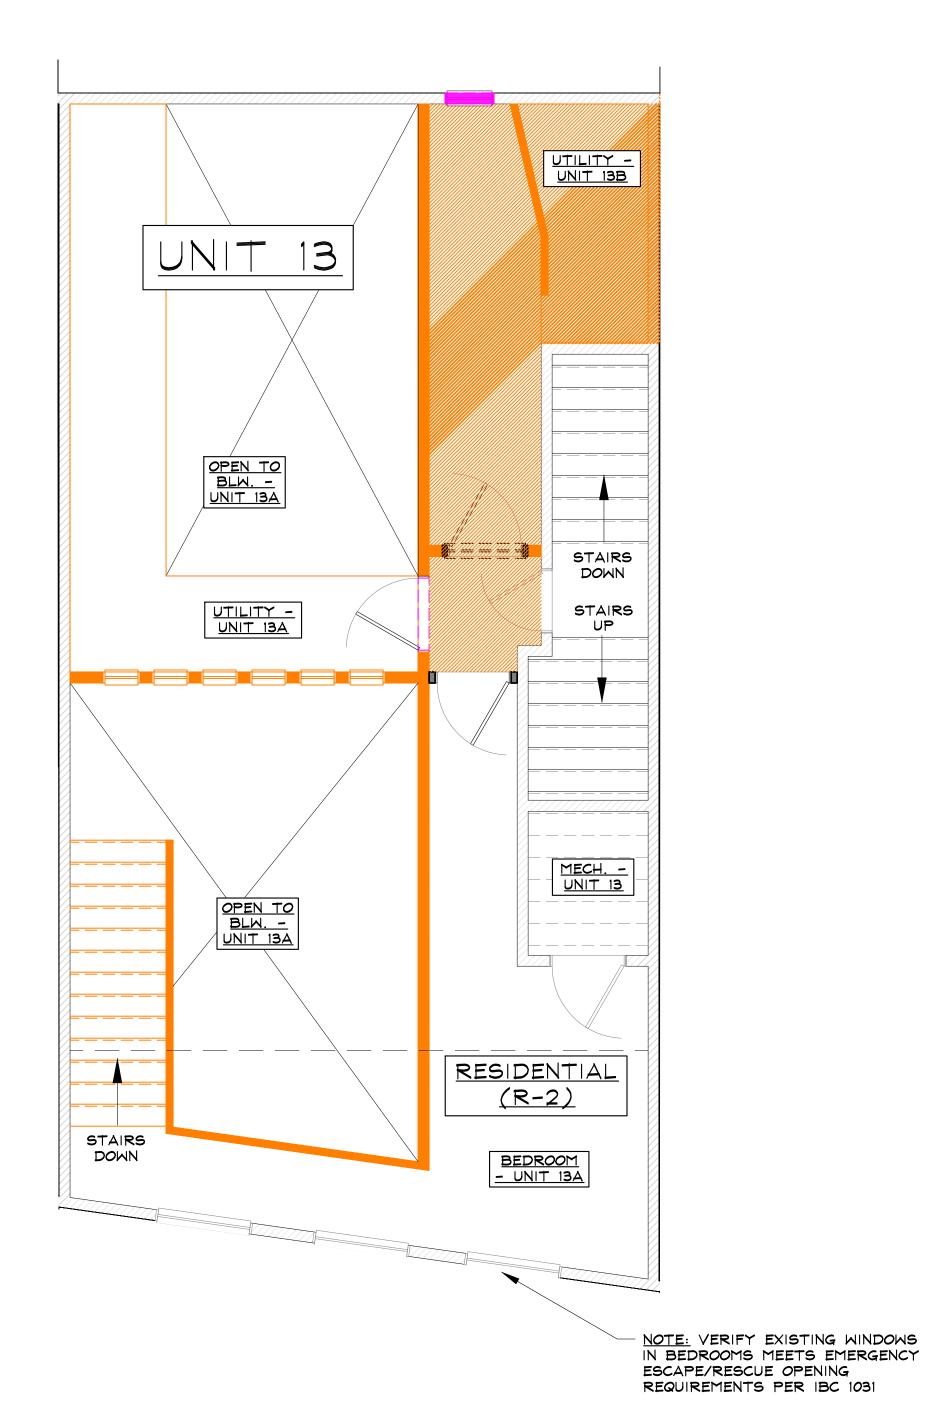

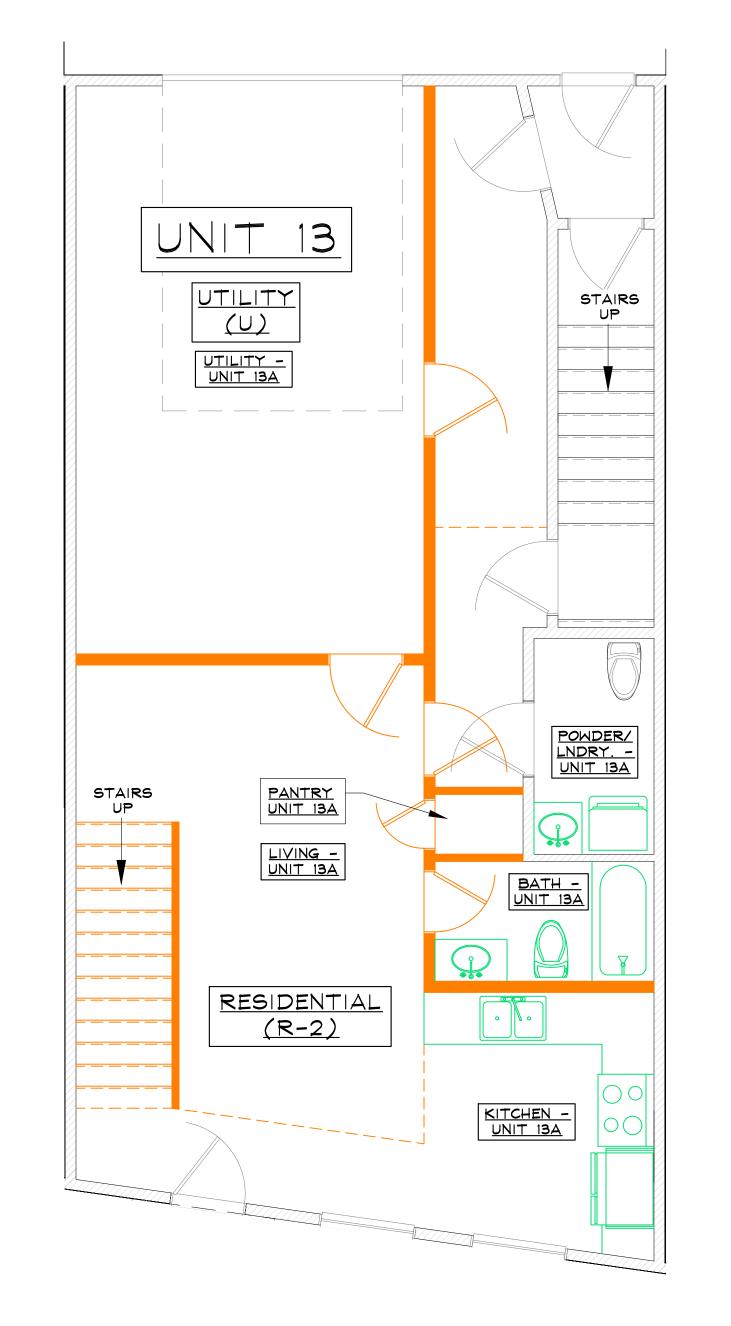

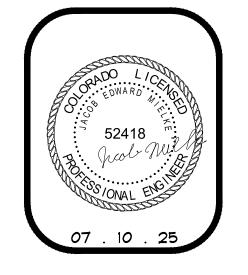

Code Compliance

(X) (T)

10 . 18 . 24 PERMIT 05 . 01 . 25 REVISION A 07 . 10 . 25 REVISION A

DRAWN BY: JEM REVIEWED BY: CWM PROJECT # 24051 LEVEL ONE \$ TWO WORK KEY

BUILDING LOCATION KEY

LEVEL TWO DEMO/PERMITTED WORK KEY

LEVEL ONE DEMO/PERMITTED WORK KEY