












Level 00 SITE ACCESSIBILITY
1/16" = 1'-0"



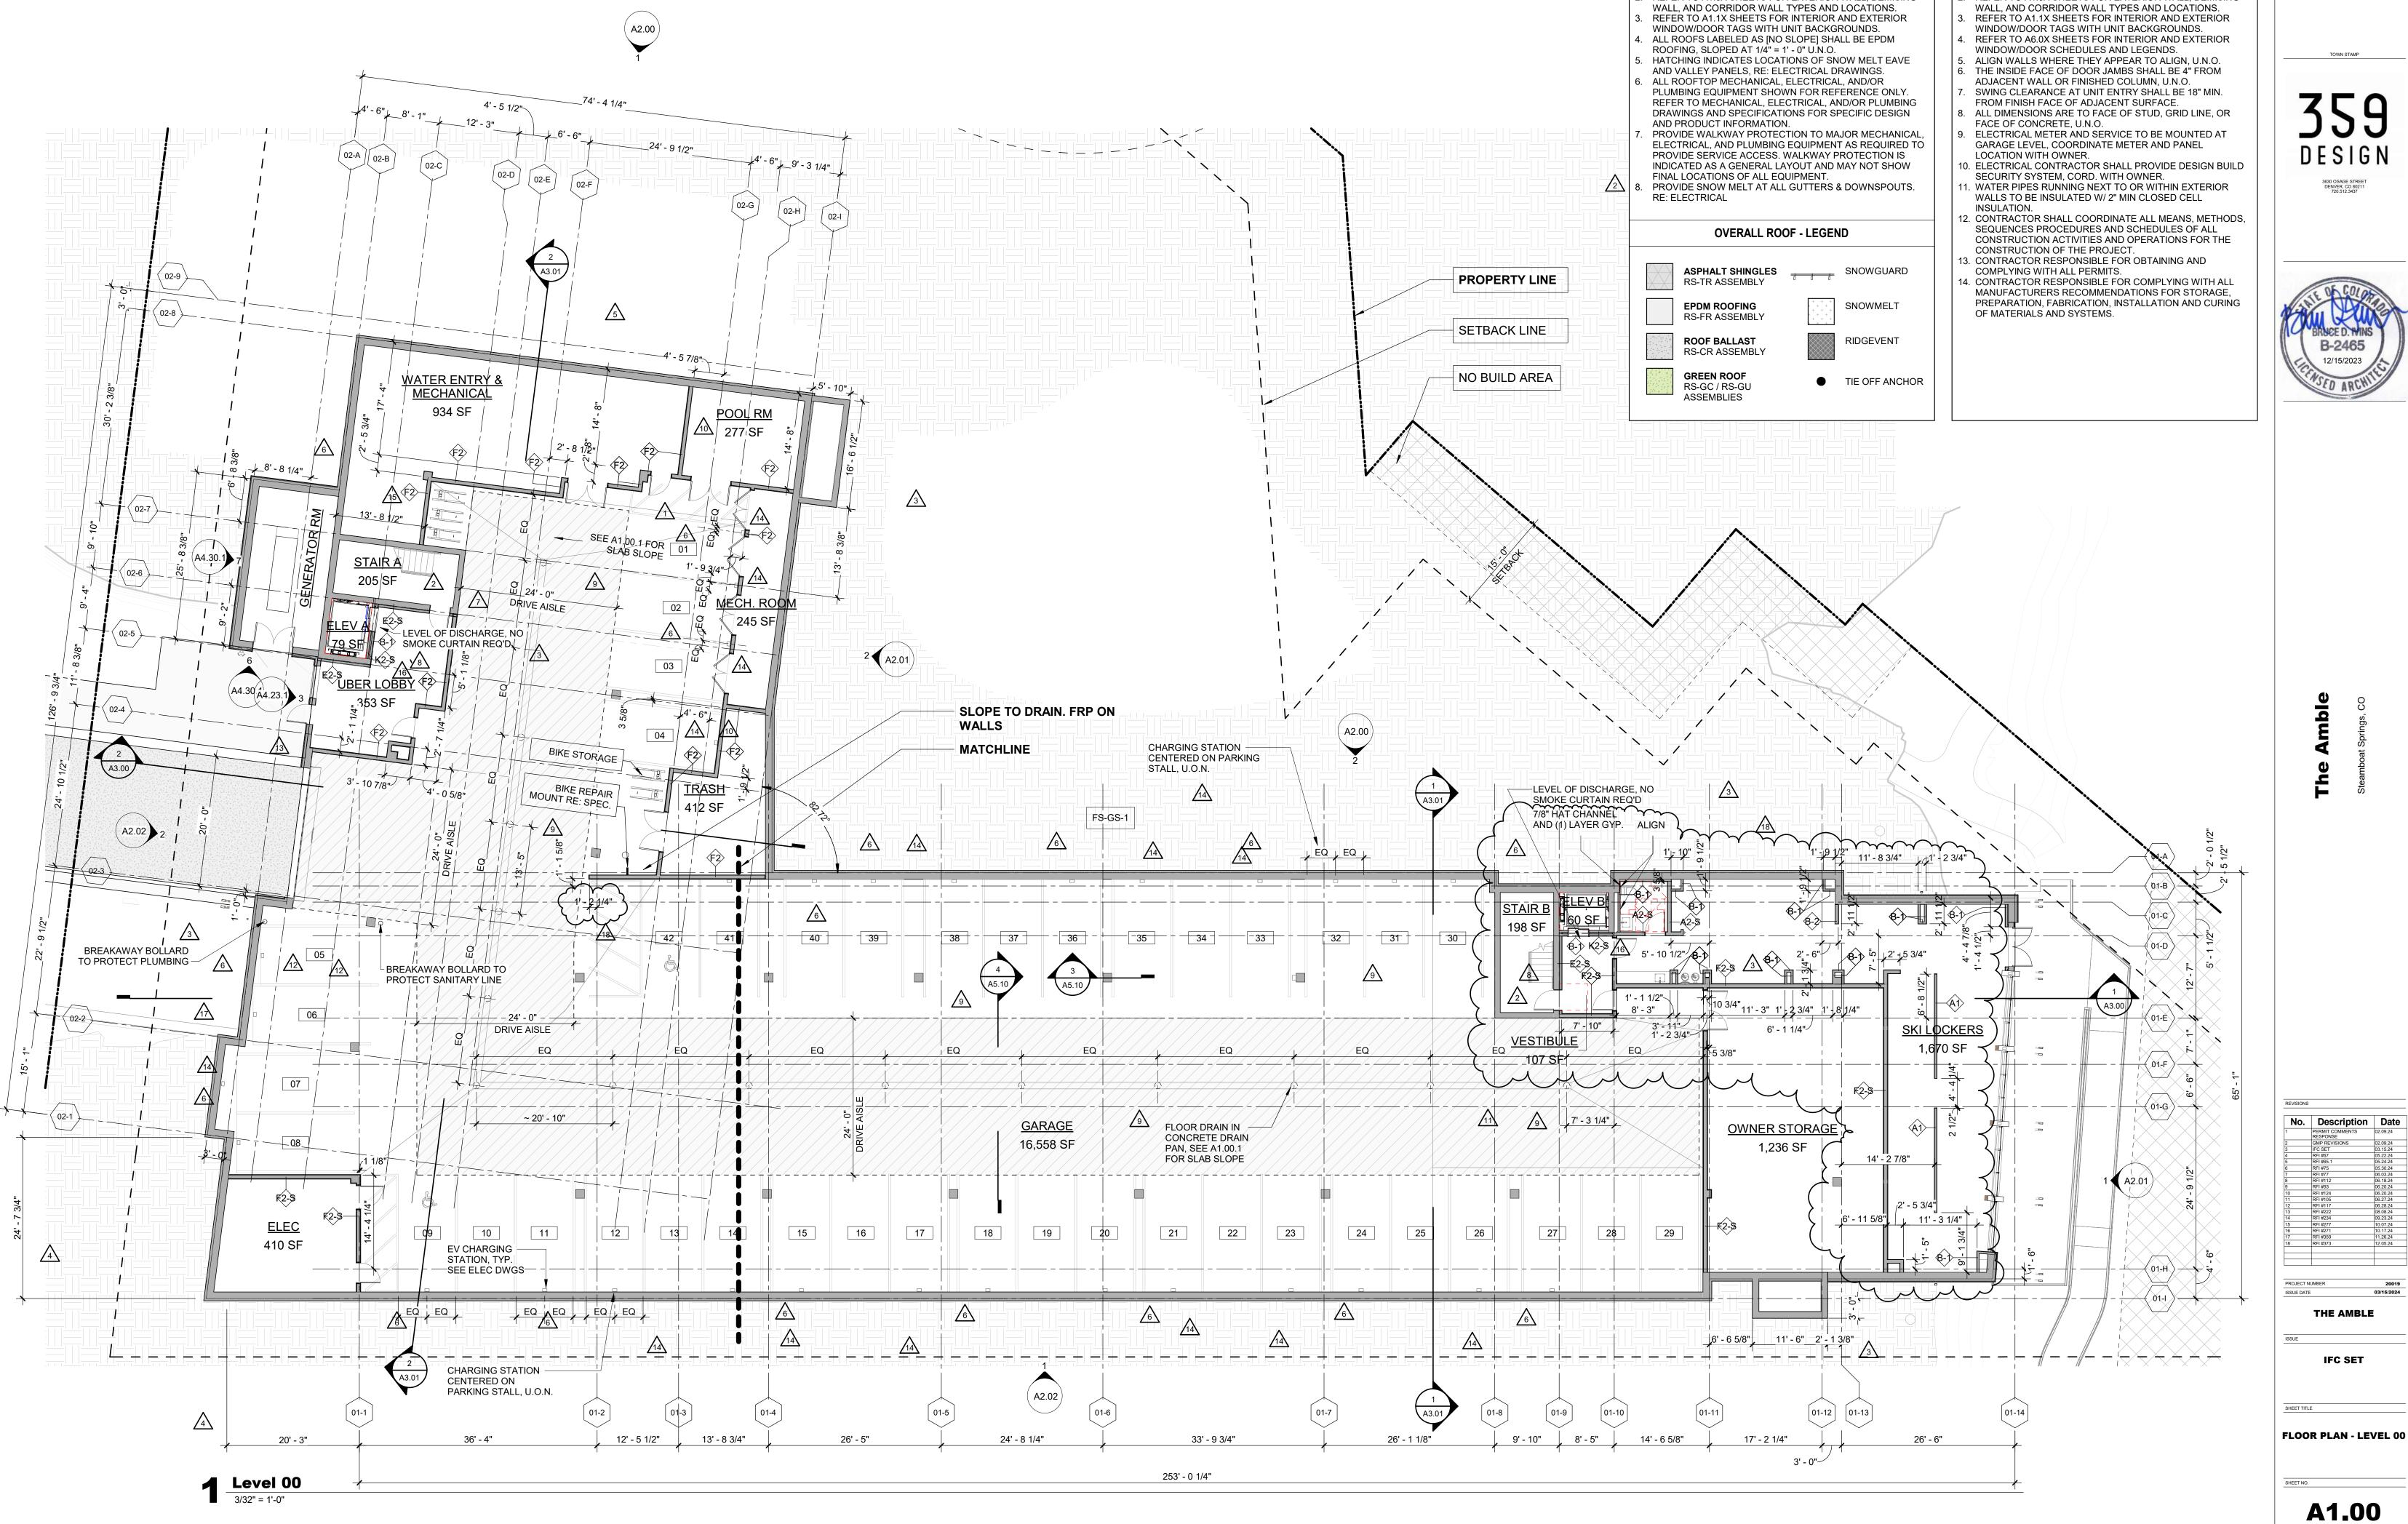


REFER TO G0.2X SHEETS FOR EXTERIOR AND INTERIOR

BUILDING ENCLOSURE ASSEMBLIES. REFER TO A1.0X SHEETS FOR EXTERIOR WALL, DEMISING

OVERALL PLAN - GENERAL NOTES

- REFER TO G0.2X SHEETS FOR EXTERIOR AND INTERIOR BUILDING ENCLOSURE ASSEMBLIES.
- REFER TO A1.0X SHEETS FOR EXTERIOR WALL, DEMISING



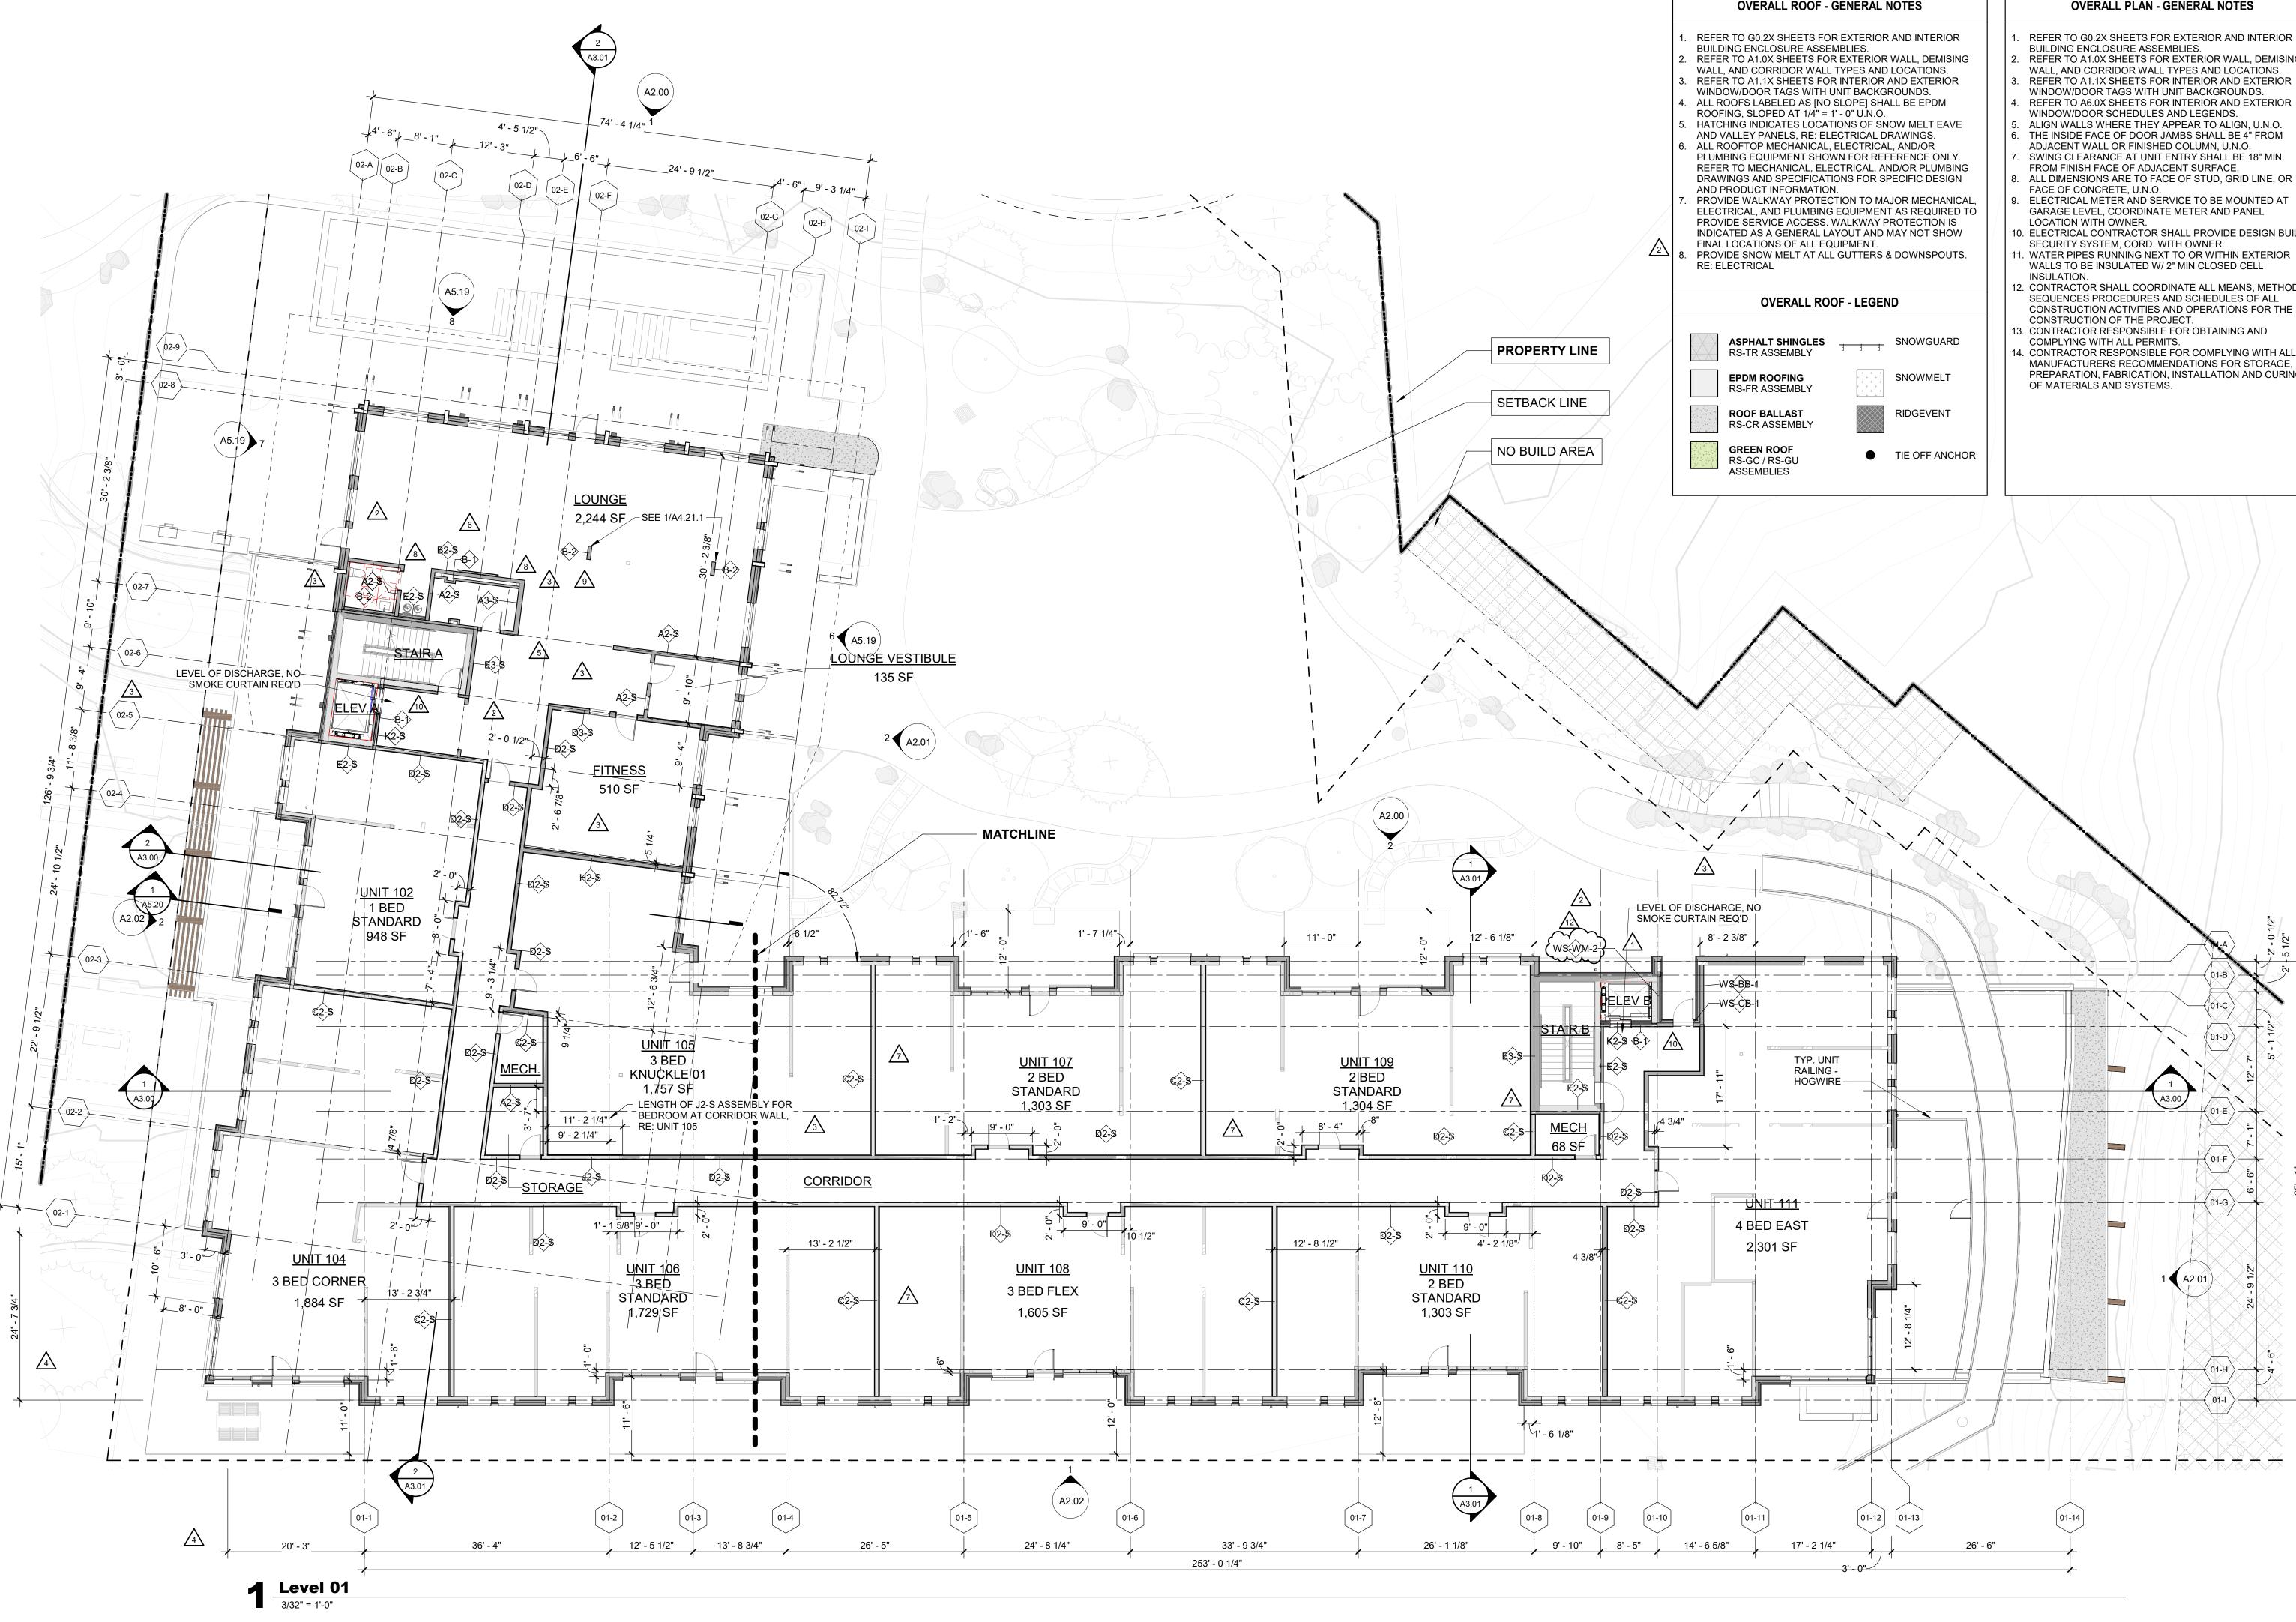

OVERALL PLAN - GENERAL NOTES

- REFER TO G0.2X SHEETS FOR EXTERIOR AND INTERIOR
- REFER TO A1.0X SHEETS FOR EXTERIOR WALL, DEMISING WALL, AND CORRIDOR WALL TYPES AND LOCATIONS.
- WINDOW/DOOR TAGS WITH UNIT BACKGROUNDS. REFER TO A6.0X SHEETS FOR INTERIOR AND EXTERIOR
- WINDOW/DOOR SCHEDULES AND LEGENDS.
- THE INSIDE FACE OF DOOR JAMBS SHALL BE 4" FROM
- SWING CLEARANCE AT UNIT ENTRY SHALL BE 18" MIN.
- ALL DIMENSIONS ARE TO FACE OF STUD, GRID LINE, OR
- ELECTRICAL METER AND SERVICE TO BE MOUNTED AT GARAGE LEVEL, COORDINATE METER AND PANEL
- 0. ELECTRICAL CONTRACTOR SHALL PROVIDE DESIGN BUILD SECURITY SYSTEM, CORD. WITH OWNER. . WATER PIPES RUNNING NEXT TO OR WITHIN EXTERIOR
- WALLS TO BE INSULATED W/ 2" MIN CLOSED CELL
- 2. CONTRACTOR SHALL COORDINATE ALL MEANS, METHODS, SEQUENCES PROCEDURES AND SCHEDULES OF ALL CONSTRUCTION ACTIVITIES AND OPERATIONS FOR THE CONSTRUCTION OF THE PROJECT.
- L CONTRACTOR RESPONSIBLE FOR COMPLYING WITH ALL MANUFACTURERS RECOMMENDATIONS FOR STORAGE,
- PREPARATION, FABRICATION, INSTALLATION AND CURING

TOWN STAMP 359 Design 3630 OSAGE STREET DENVER, CO 80211 720.512.3437 **B-2465** 12/15/2023 ED ARC _0 No. Description Date PERMIT COMMENTS RESPONSE GMP REVISIONS
 IFC SET

 RFI #67

 RFI #125

 RFI #214

 RFI #214

 RFI #214

 RFI #214

 RFI #214.1

 RFI #214.1

 RFI #214.1

 RFI #214.3

 RFI #214.1

 RFI #232

 RFI #246.3

 RFI #271

 RFI #348

 RFI #369
 PROJECT NUMBER ISSUE DATE 03/15/2024 THE AMBLE IFC SET SHEET TITLE FLOOR PLAN - LEVEL 01 SHEET NO. A1.01

-0 1/2"

<01-E >


(01-F)-

 \searrow

(01-H)-


🖌 01-I


<01-G >→

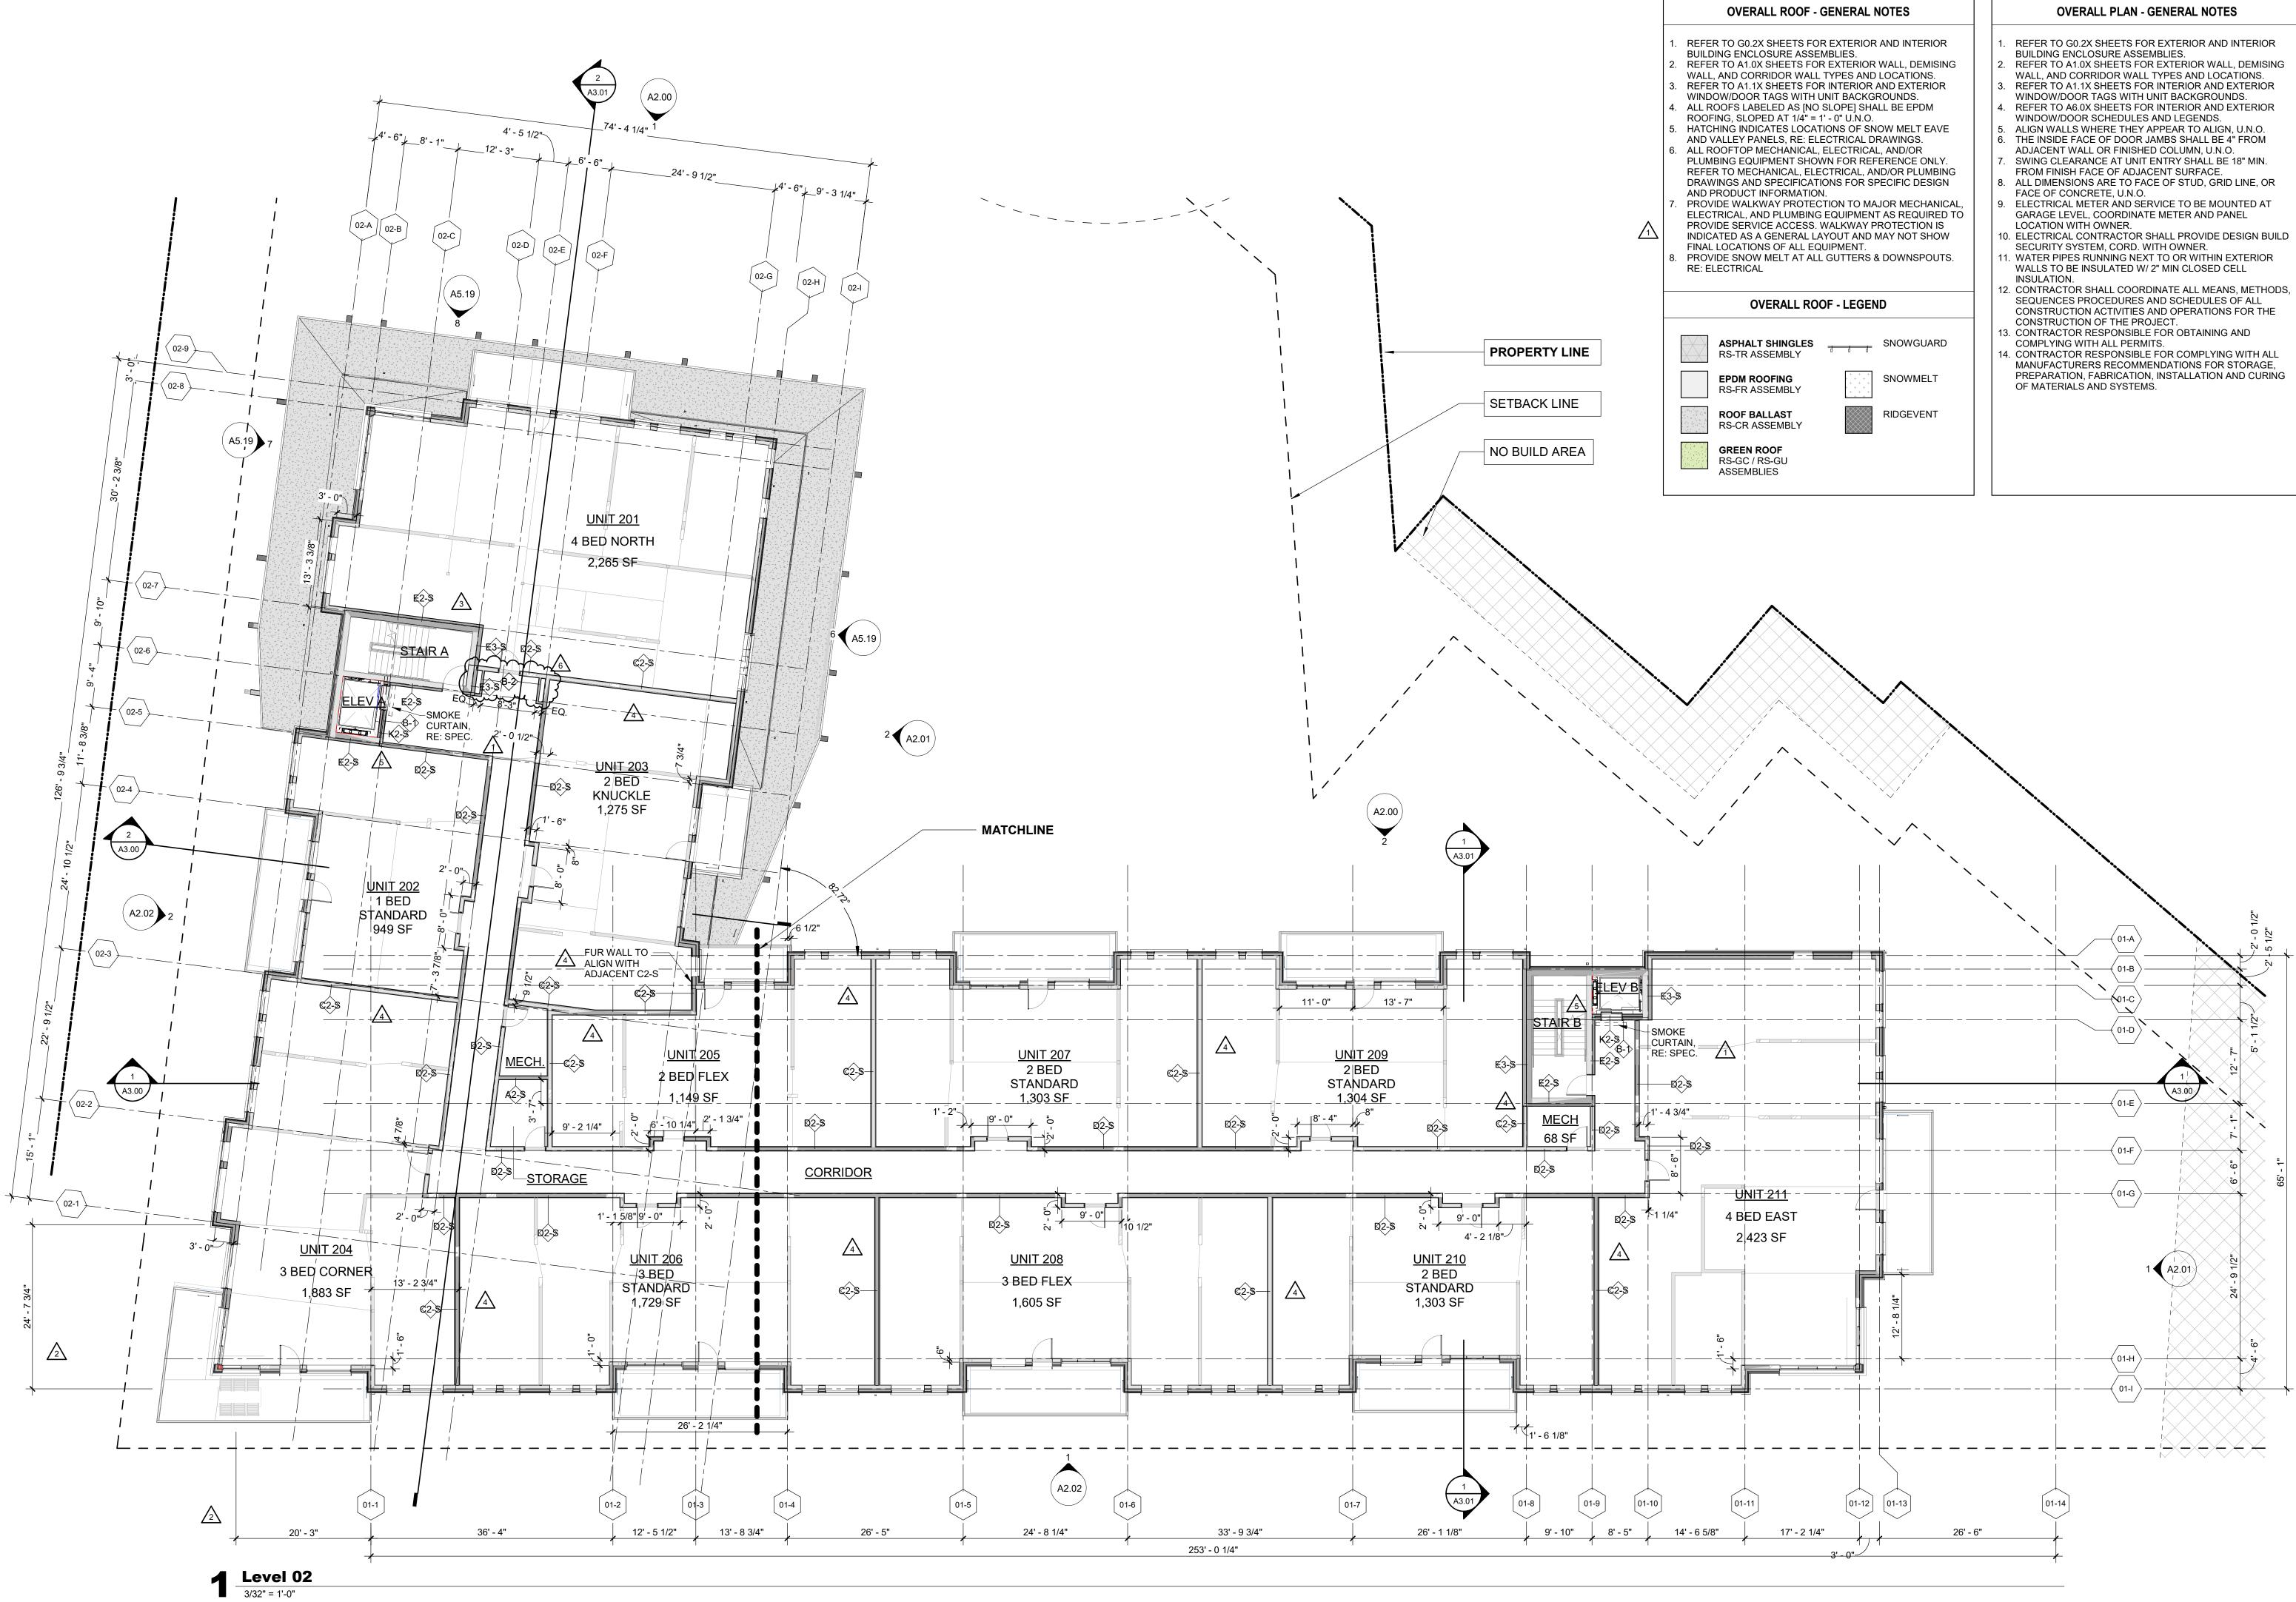

359 Design 3630 OSAGE STREET DENVER, CO 80211 720.512.3437 **B-2465** 12/15/2023

TOWN STAMP

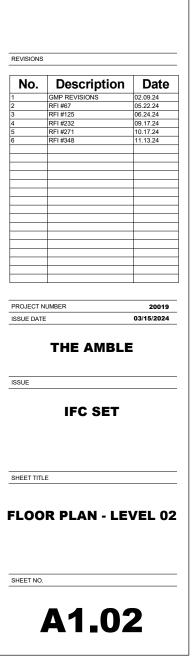


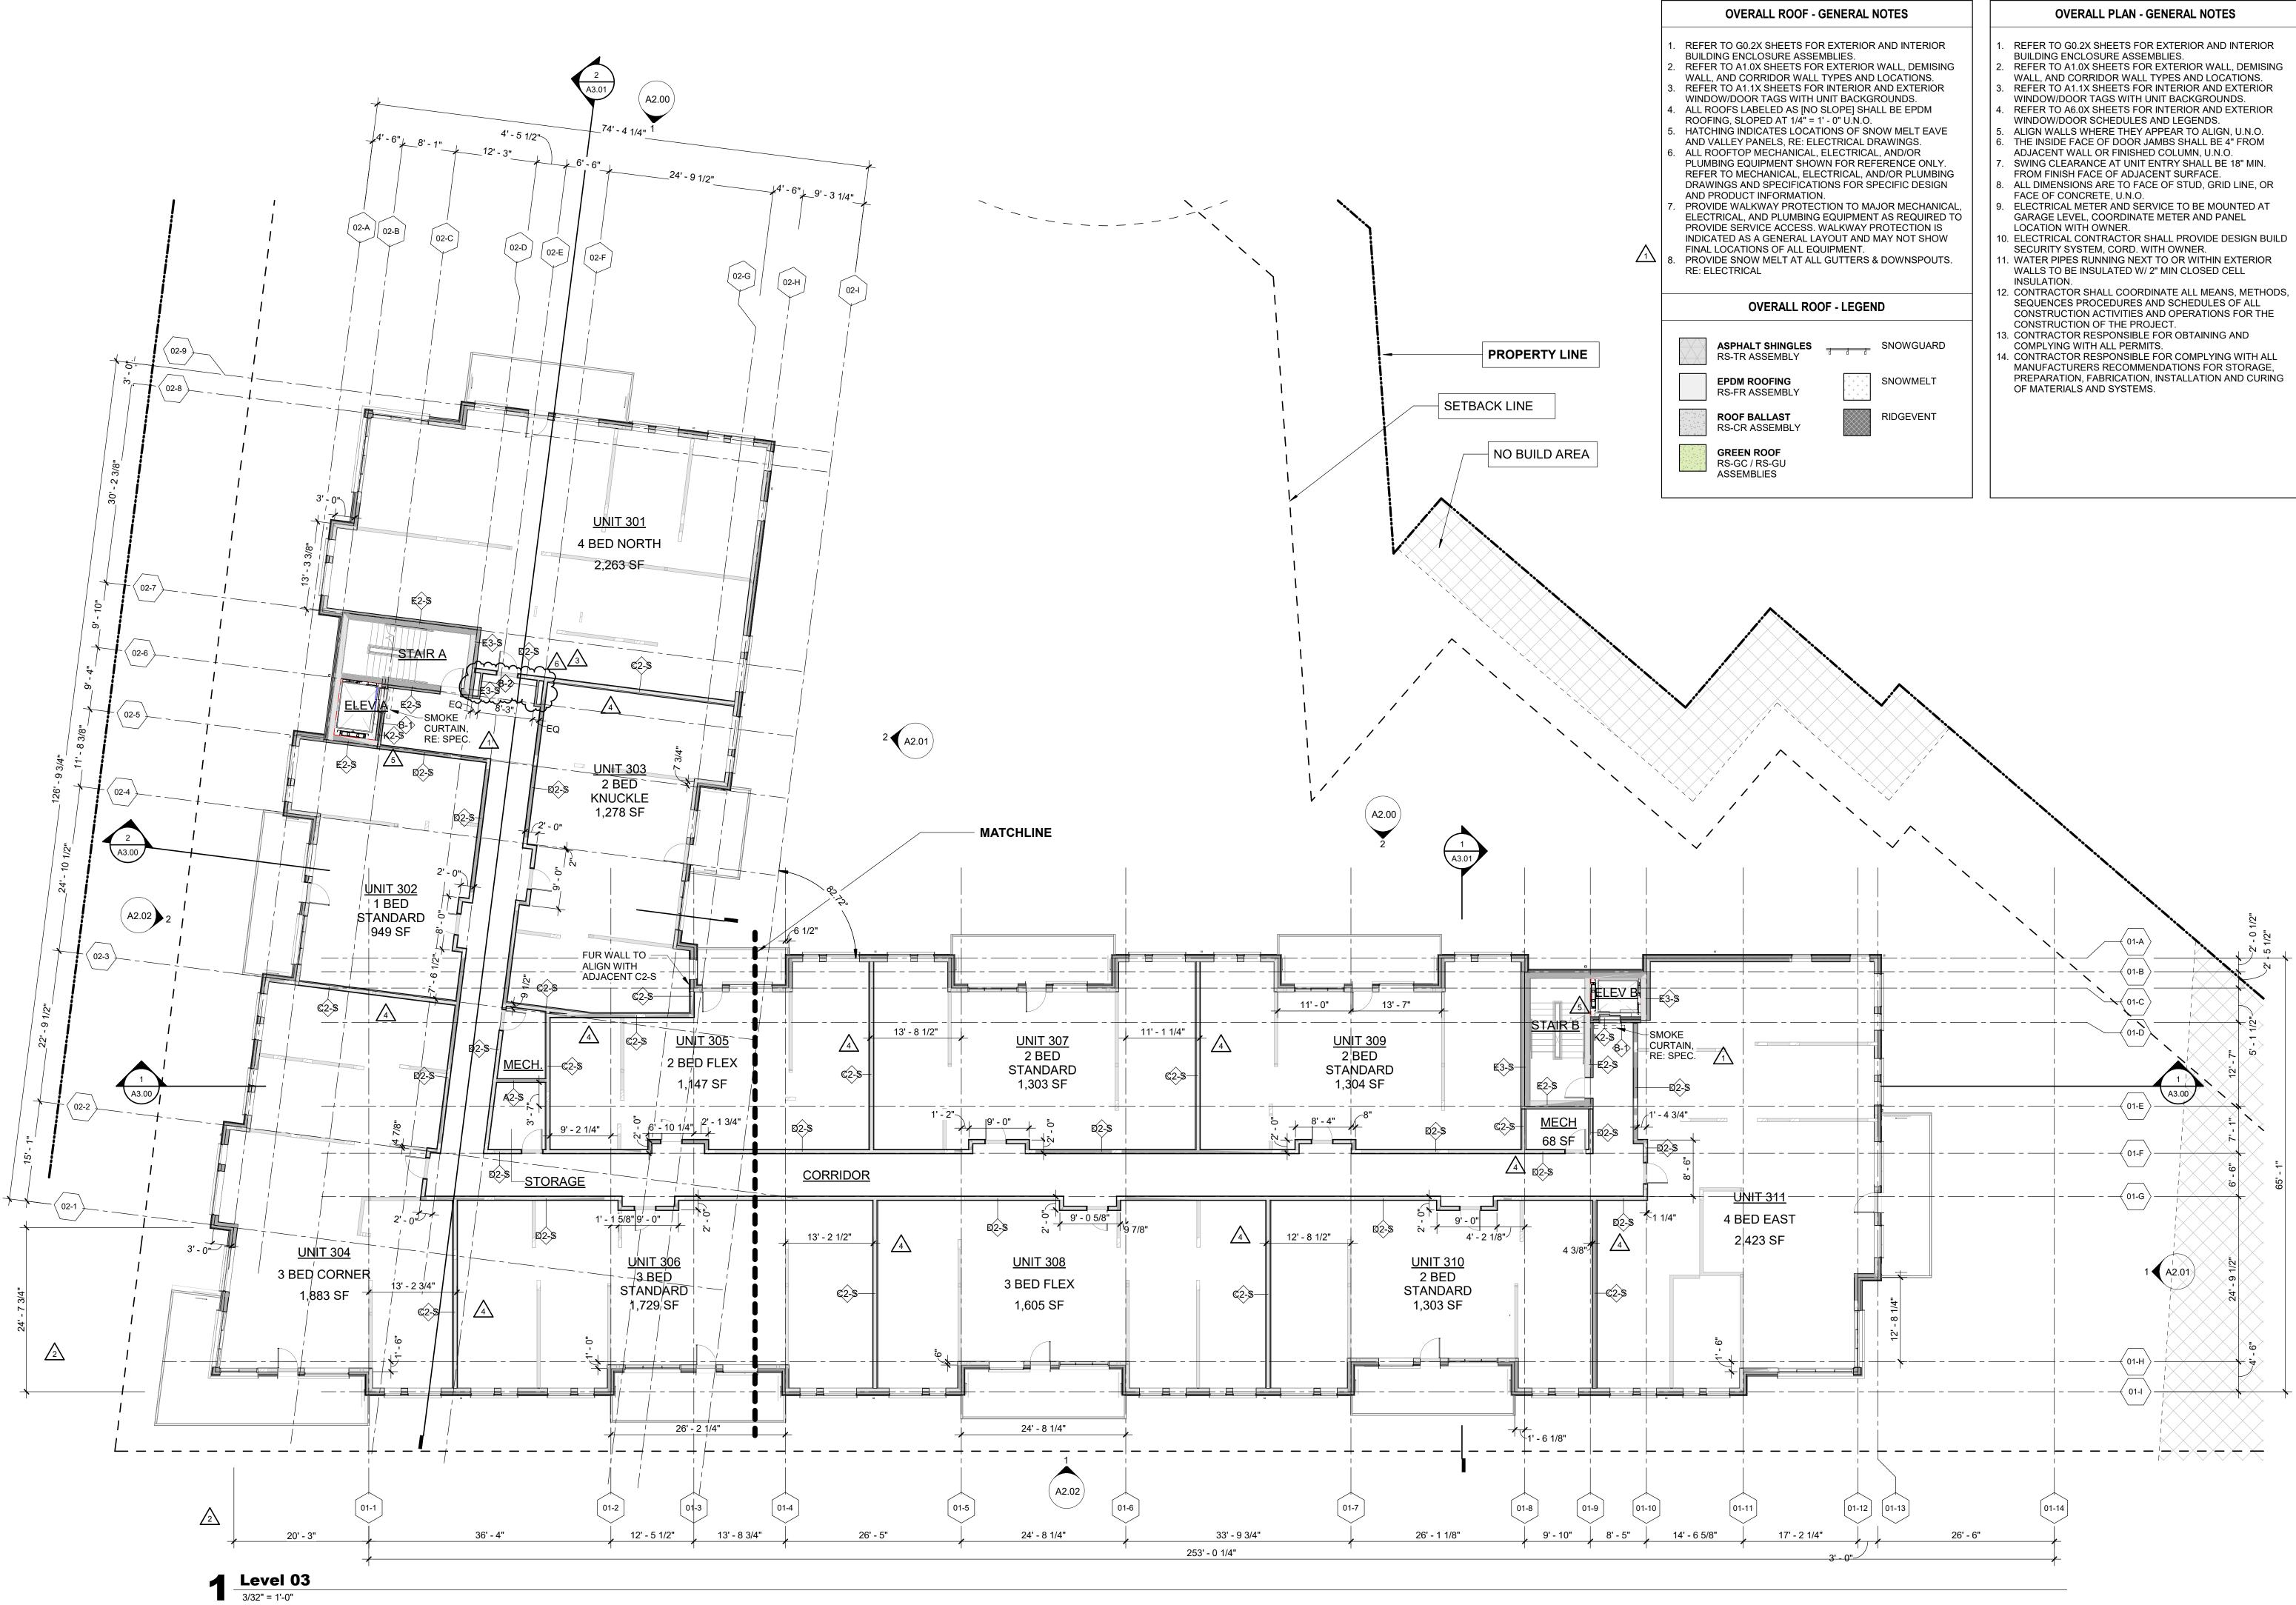






SHEET NO.

A1.03

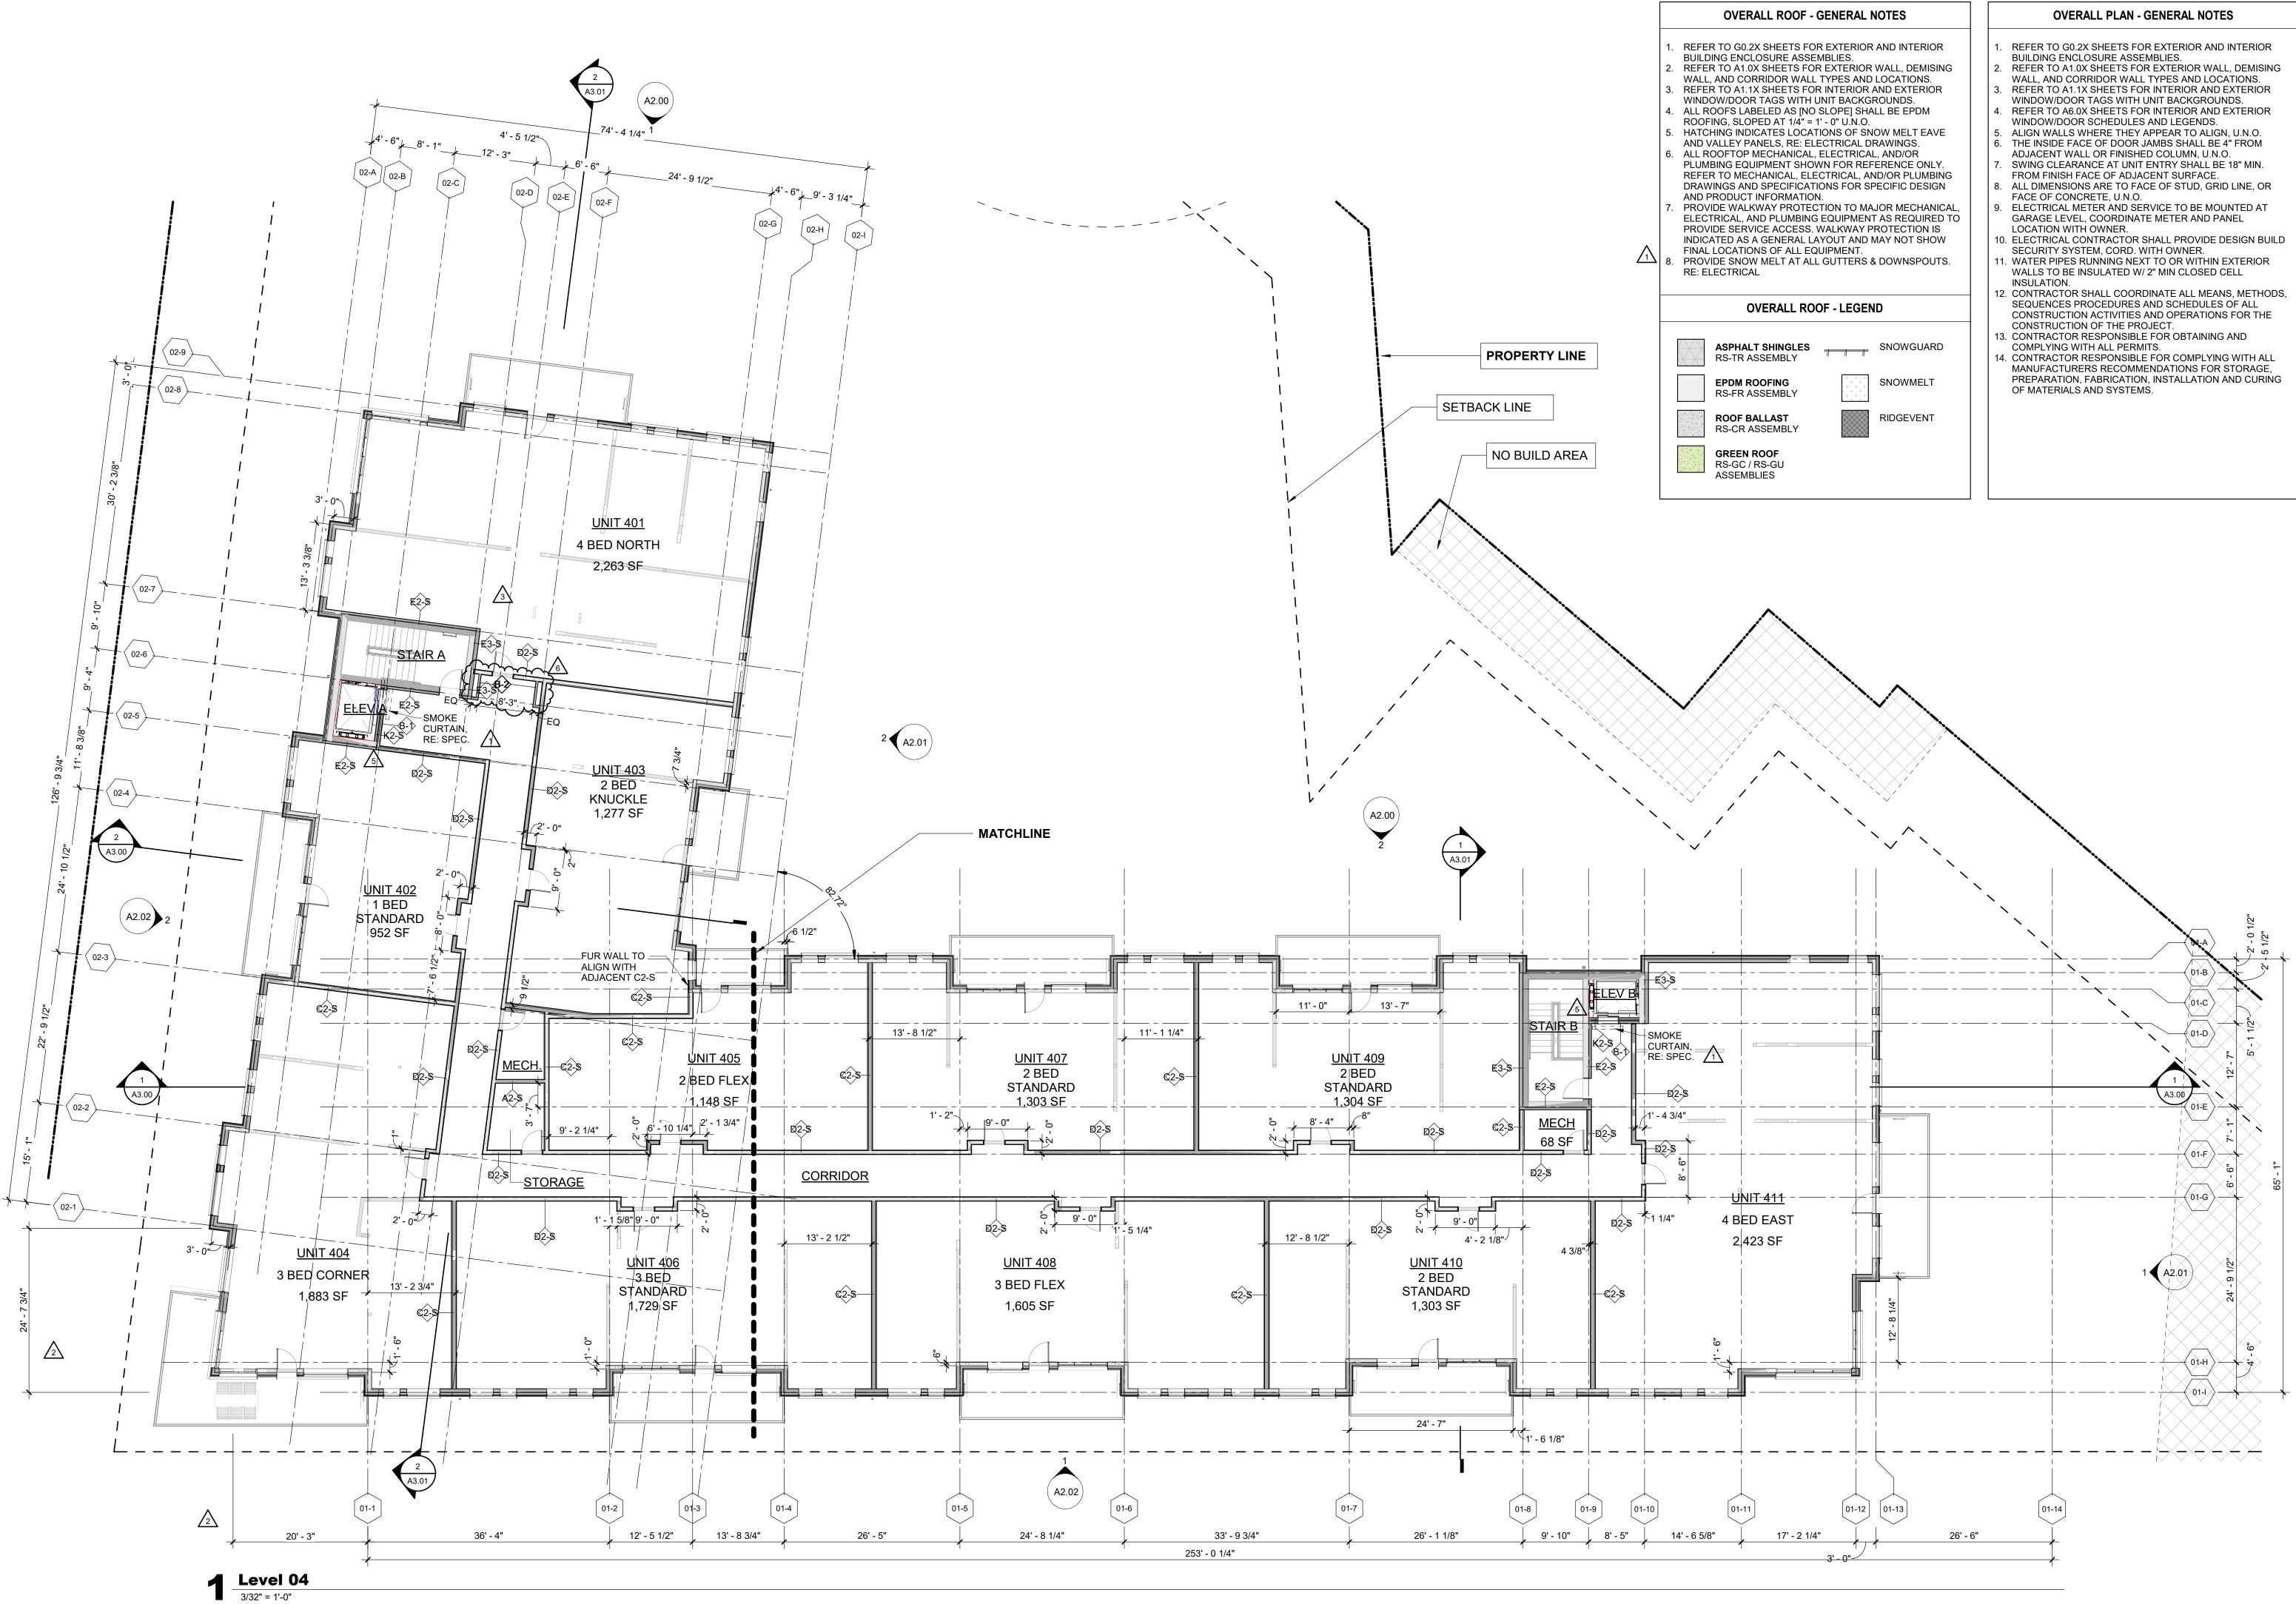

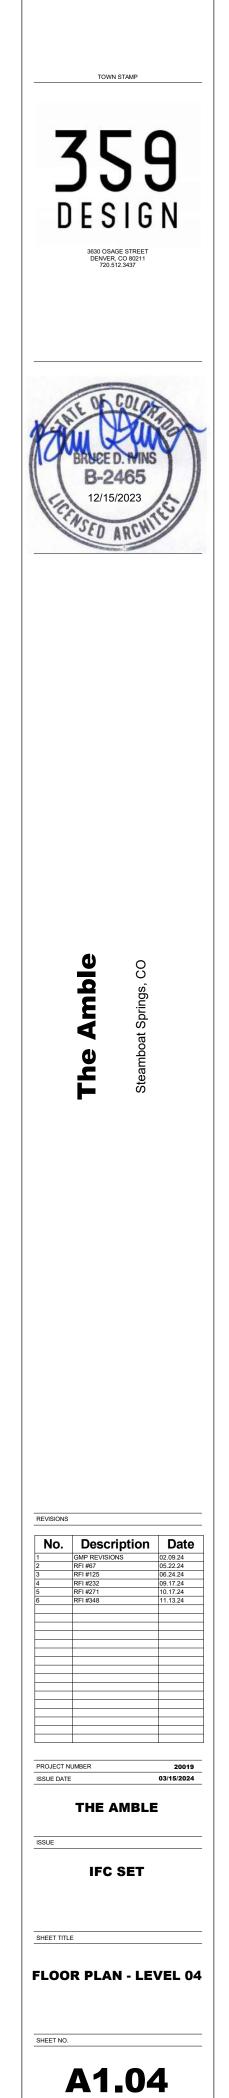

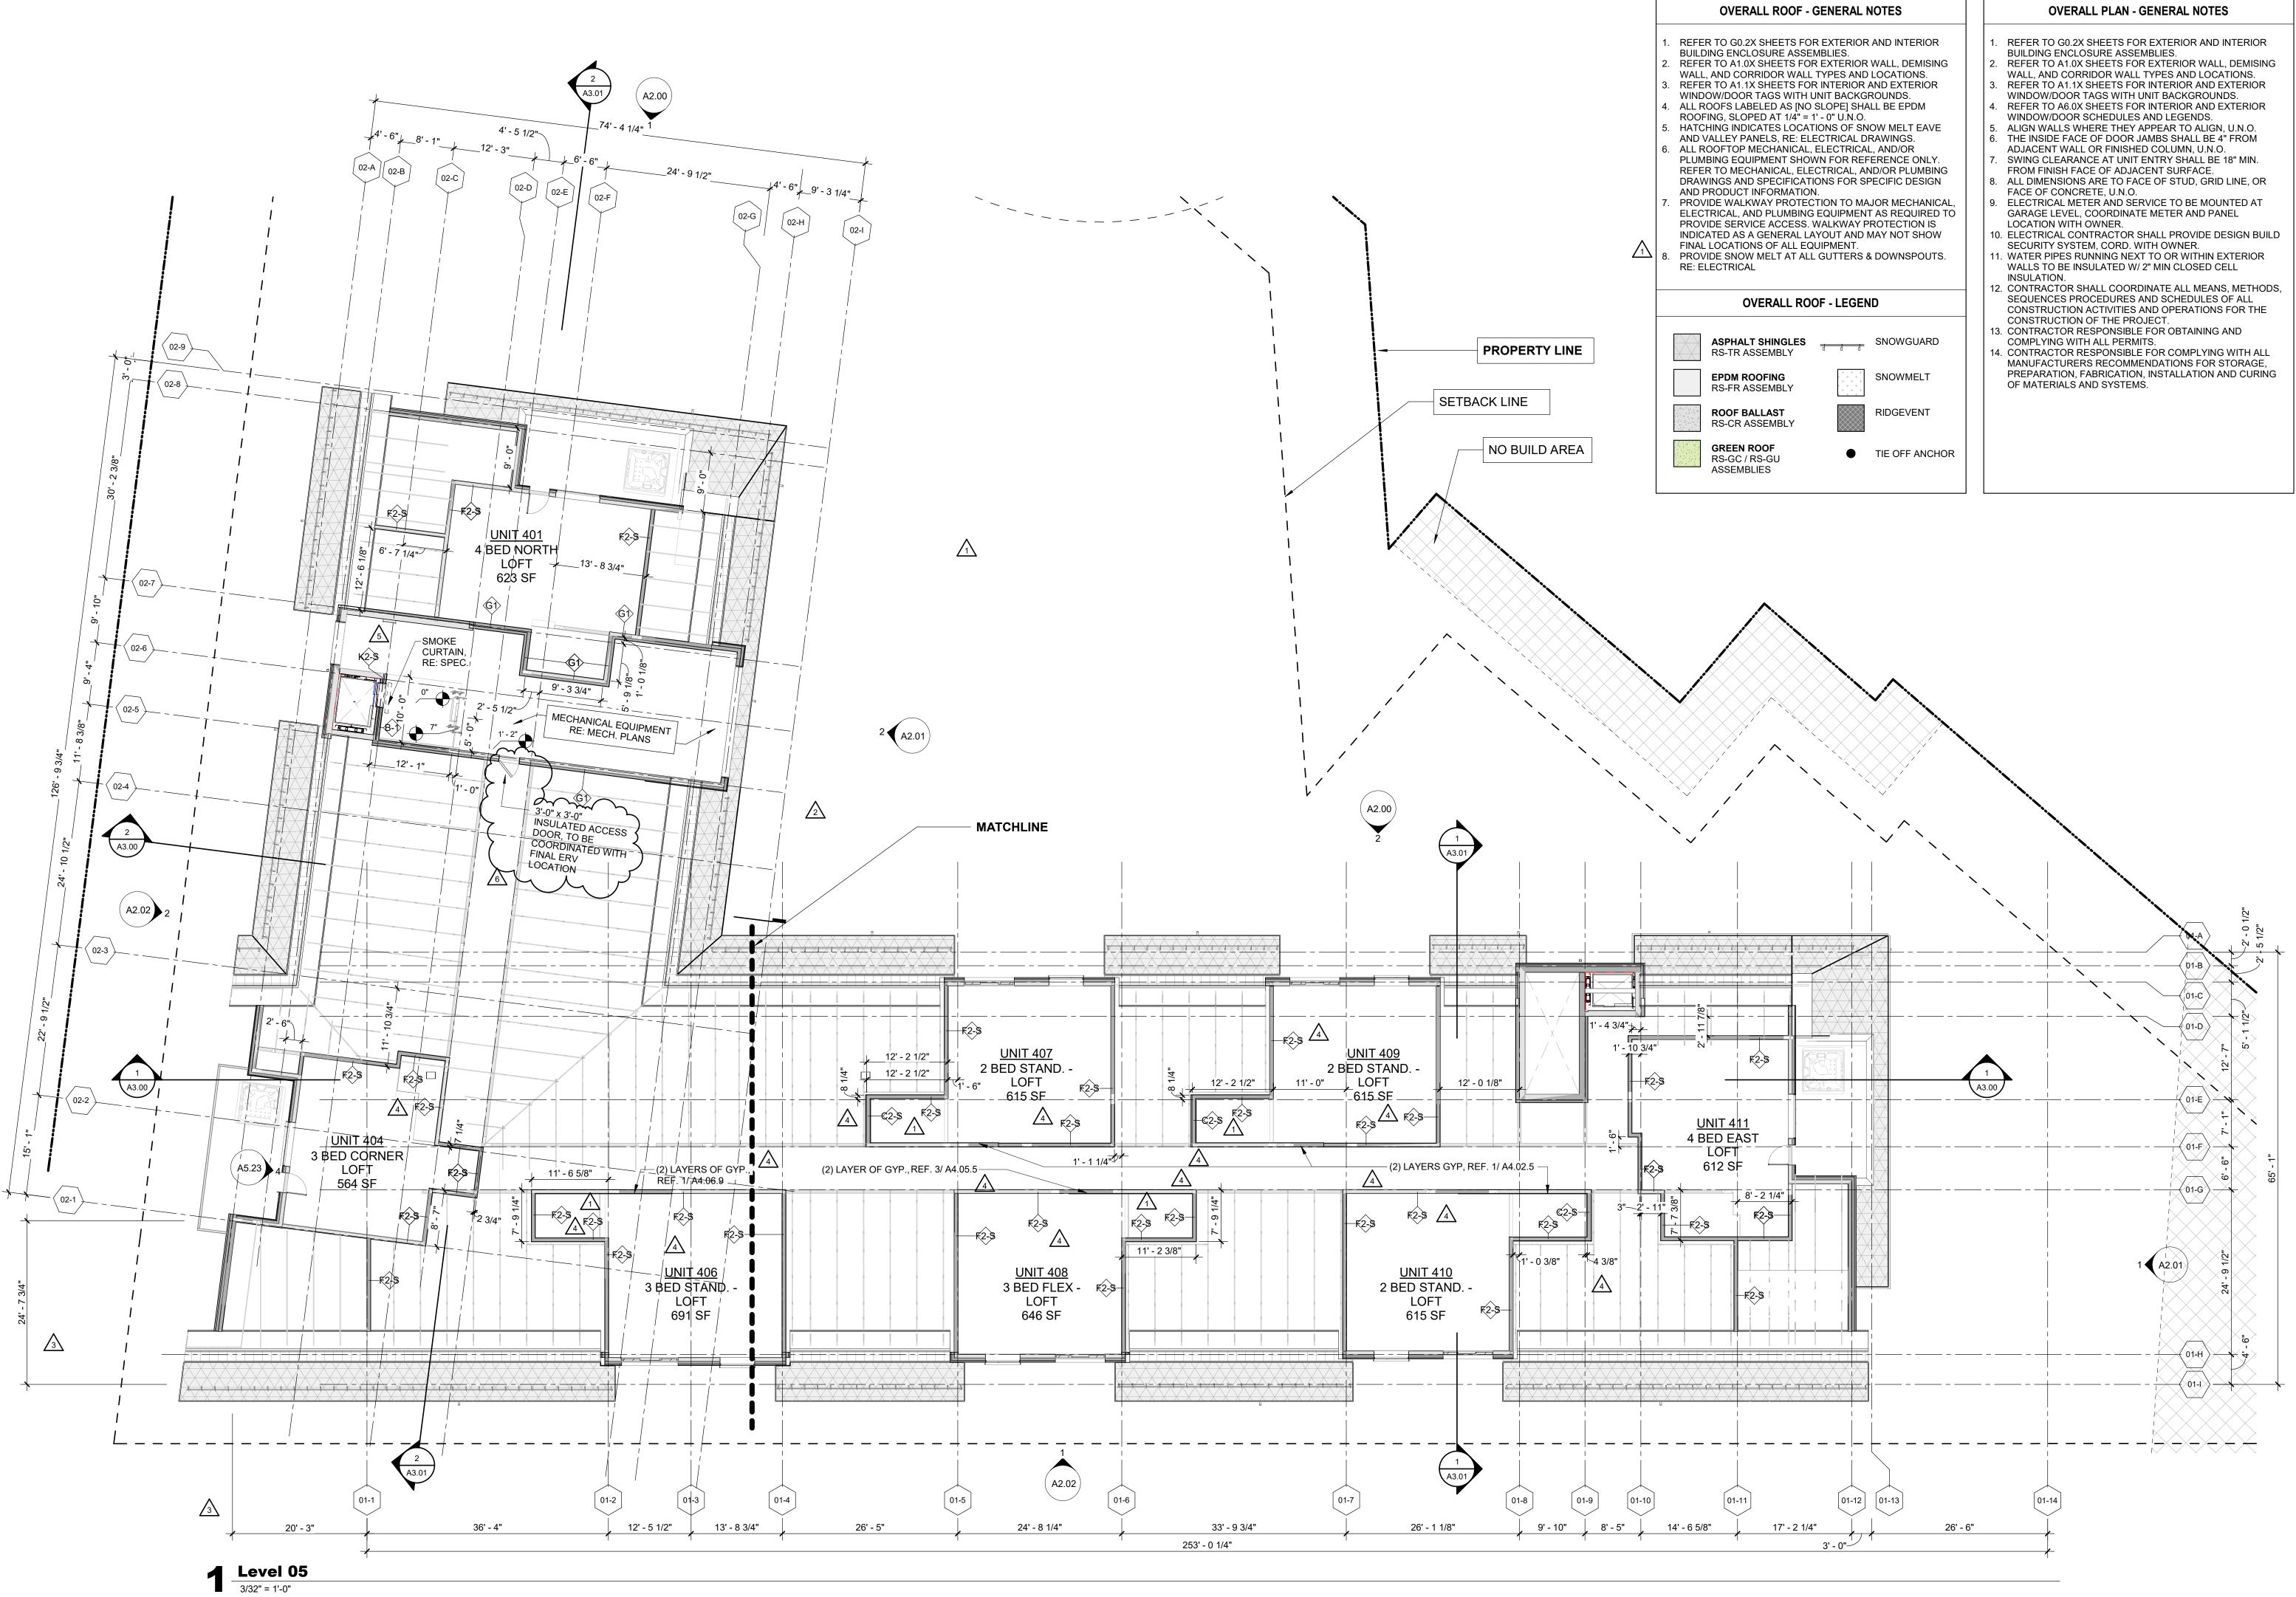

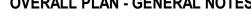



TOWN STAMP

THE AMBLE


IFC SET

SHEET TITLE

FLOOR PLAN - LEVEL 05

A1.05


SHEET NO.

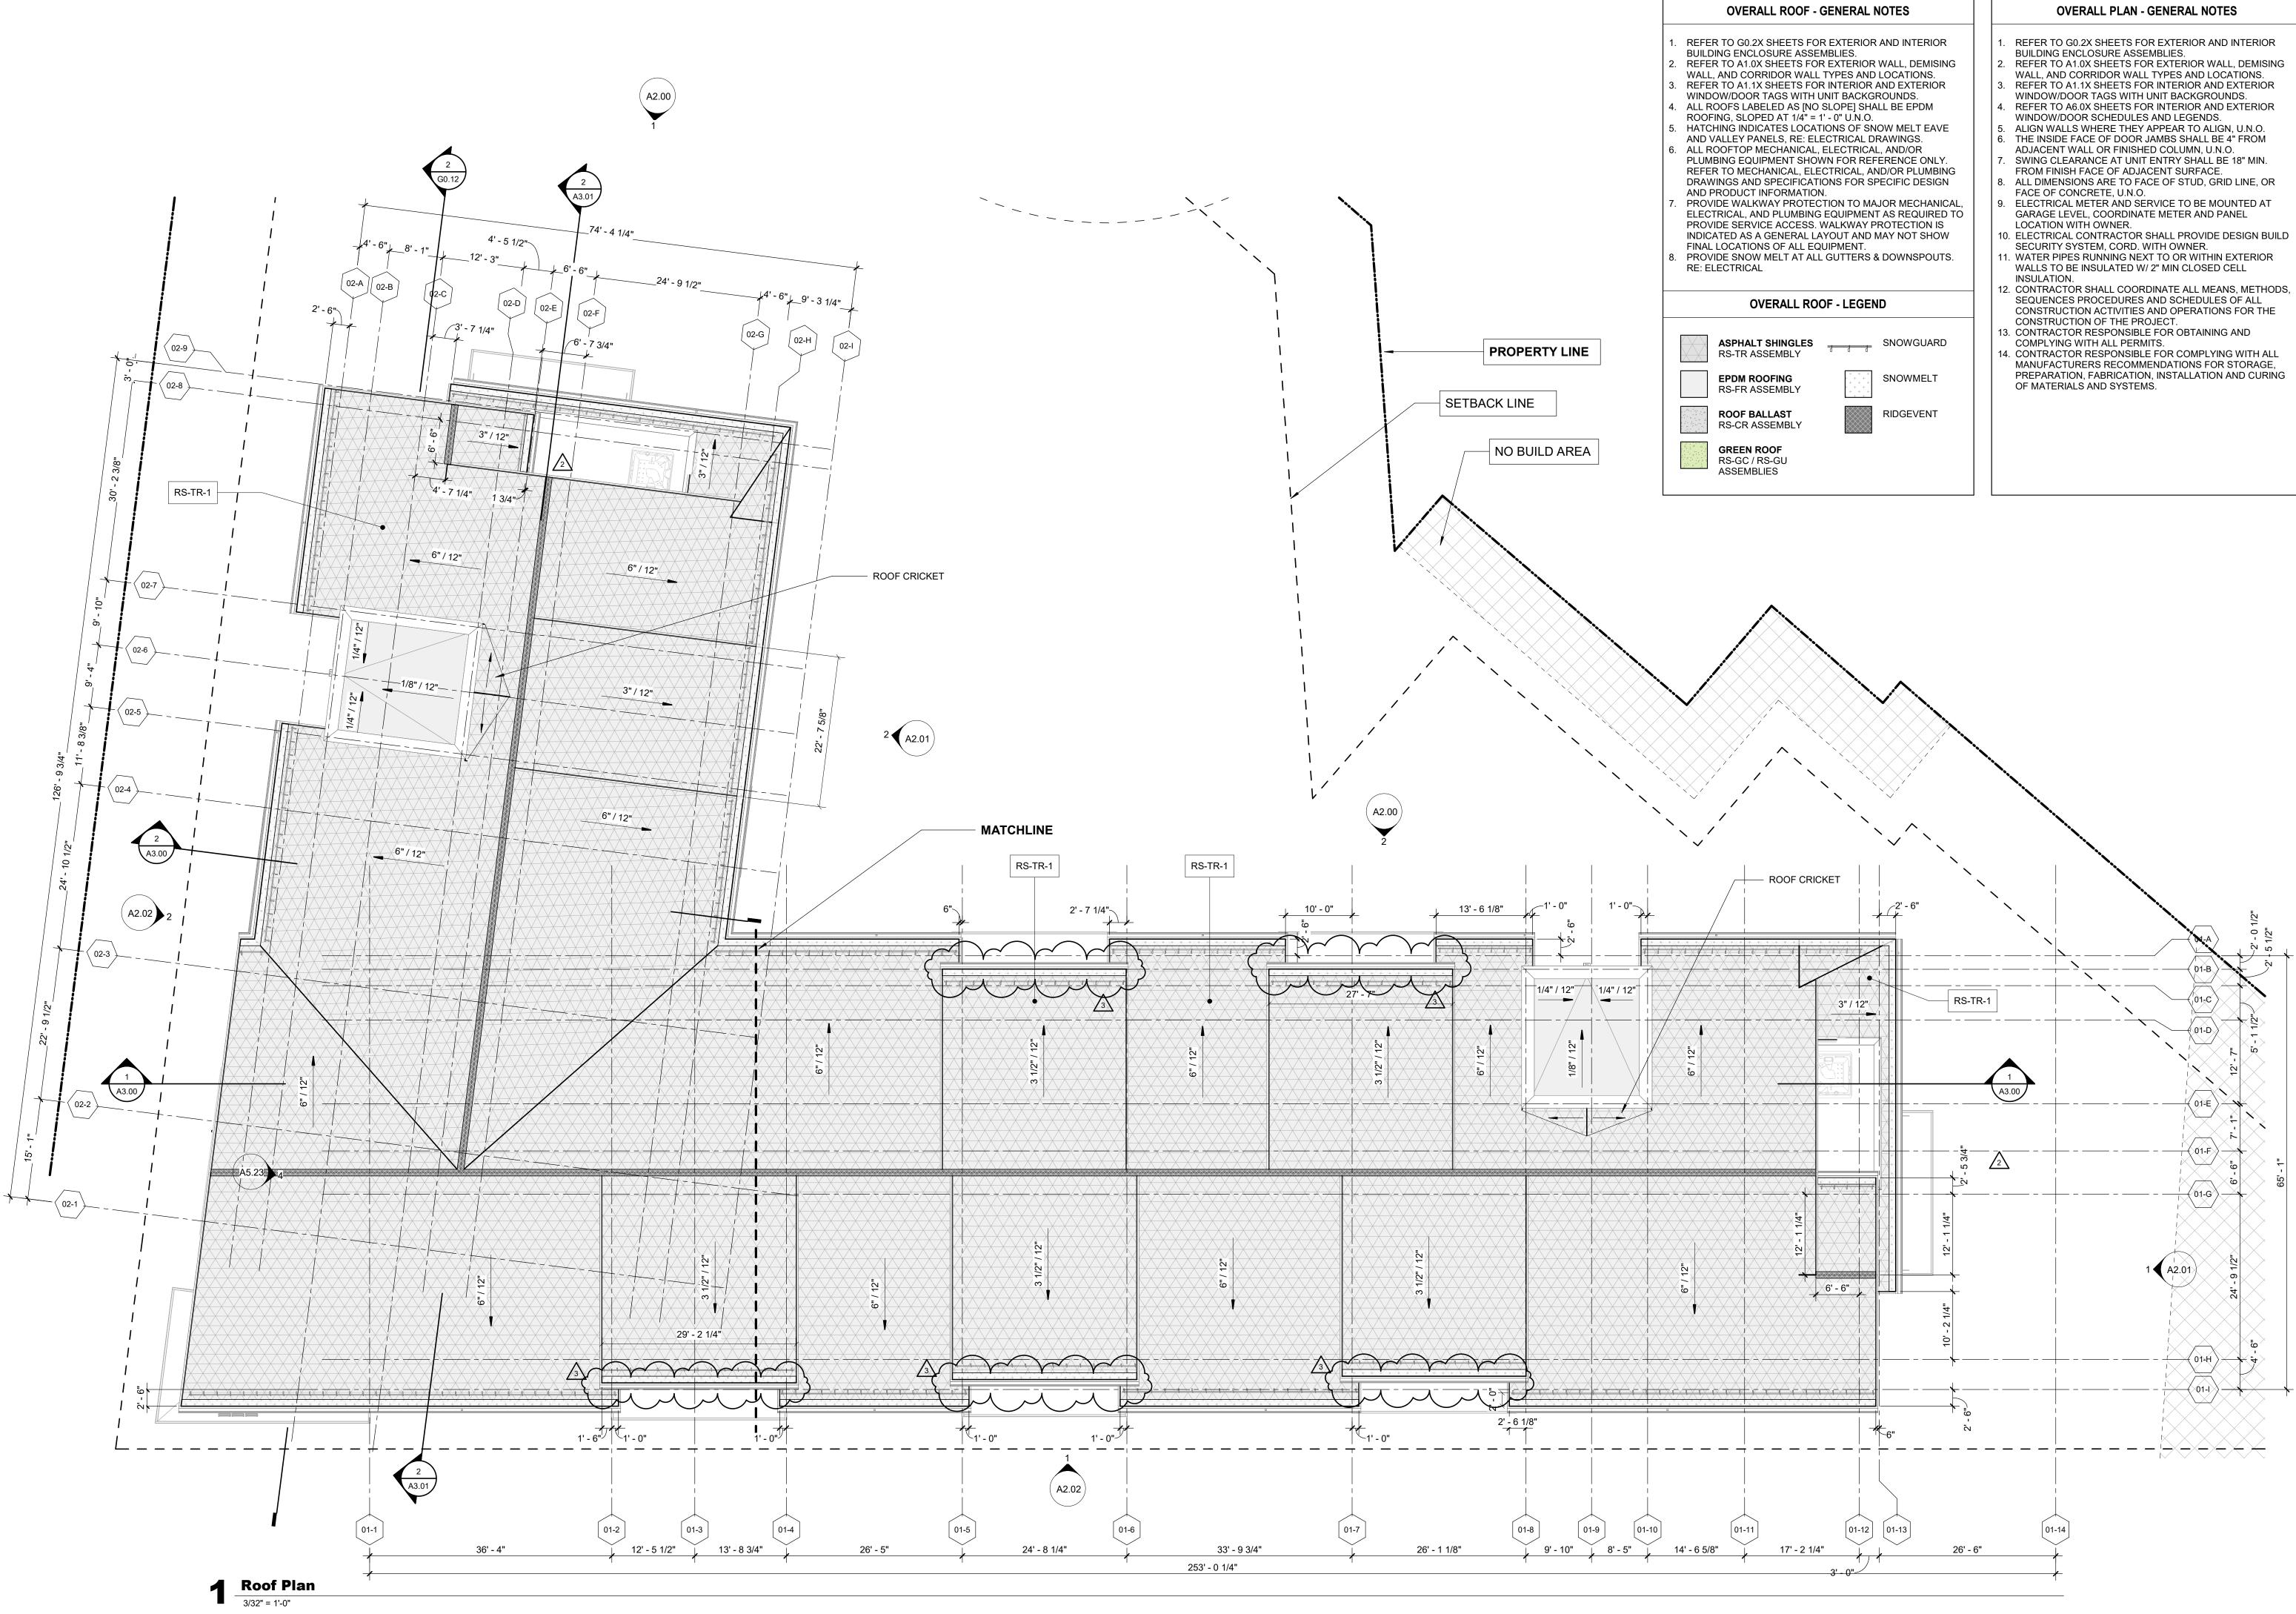



TOWN STAMP

A1.06

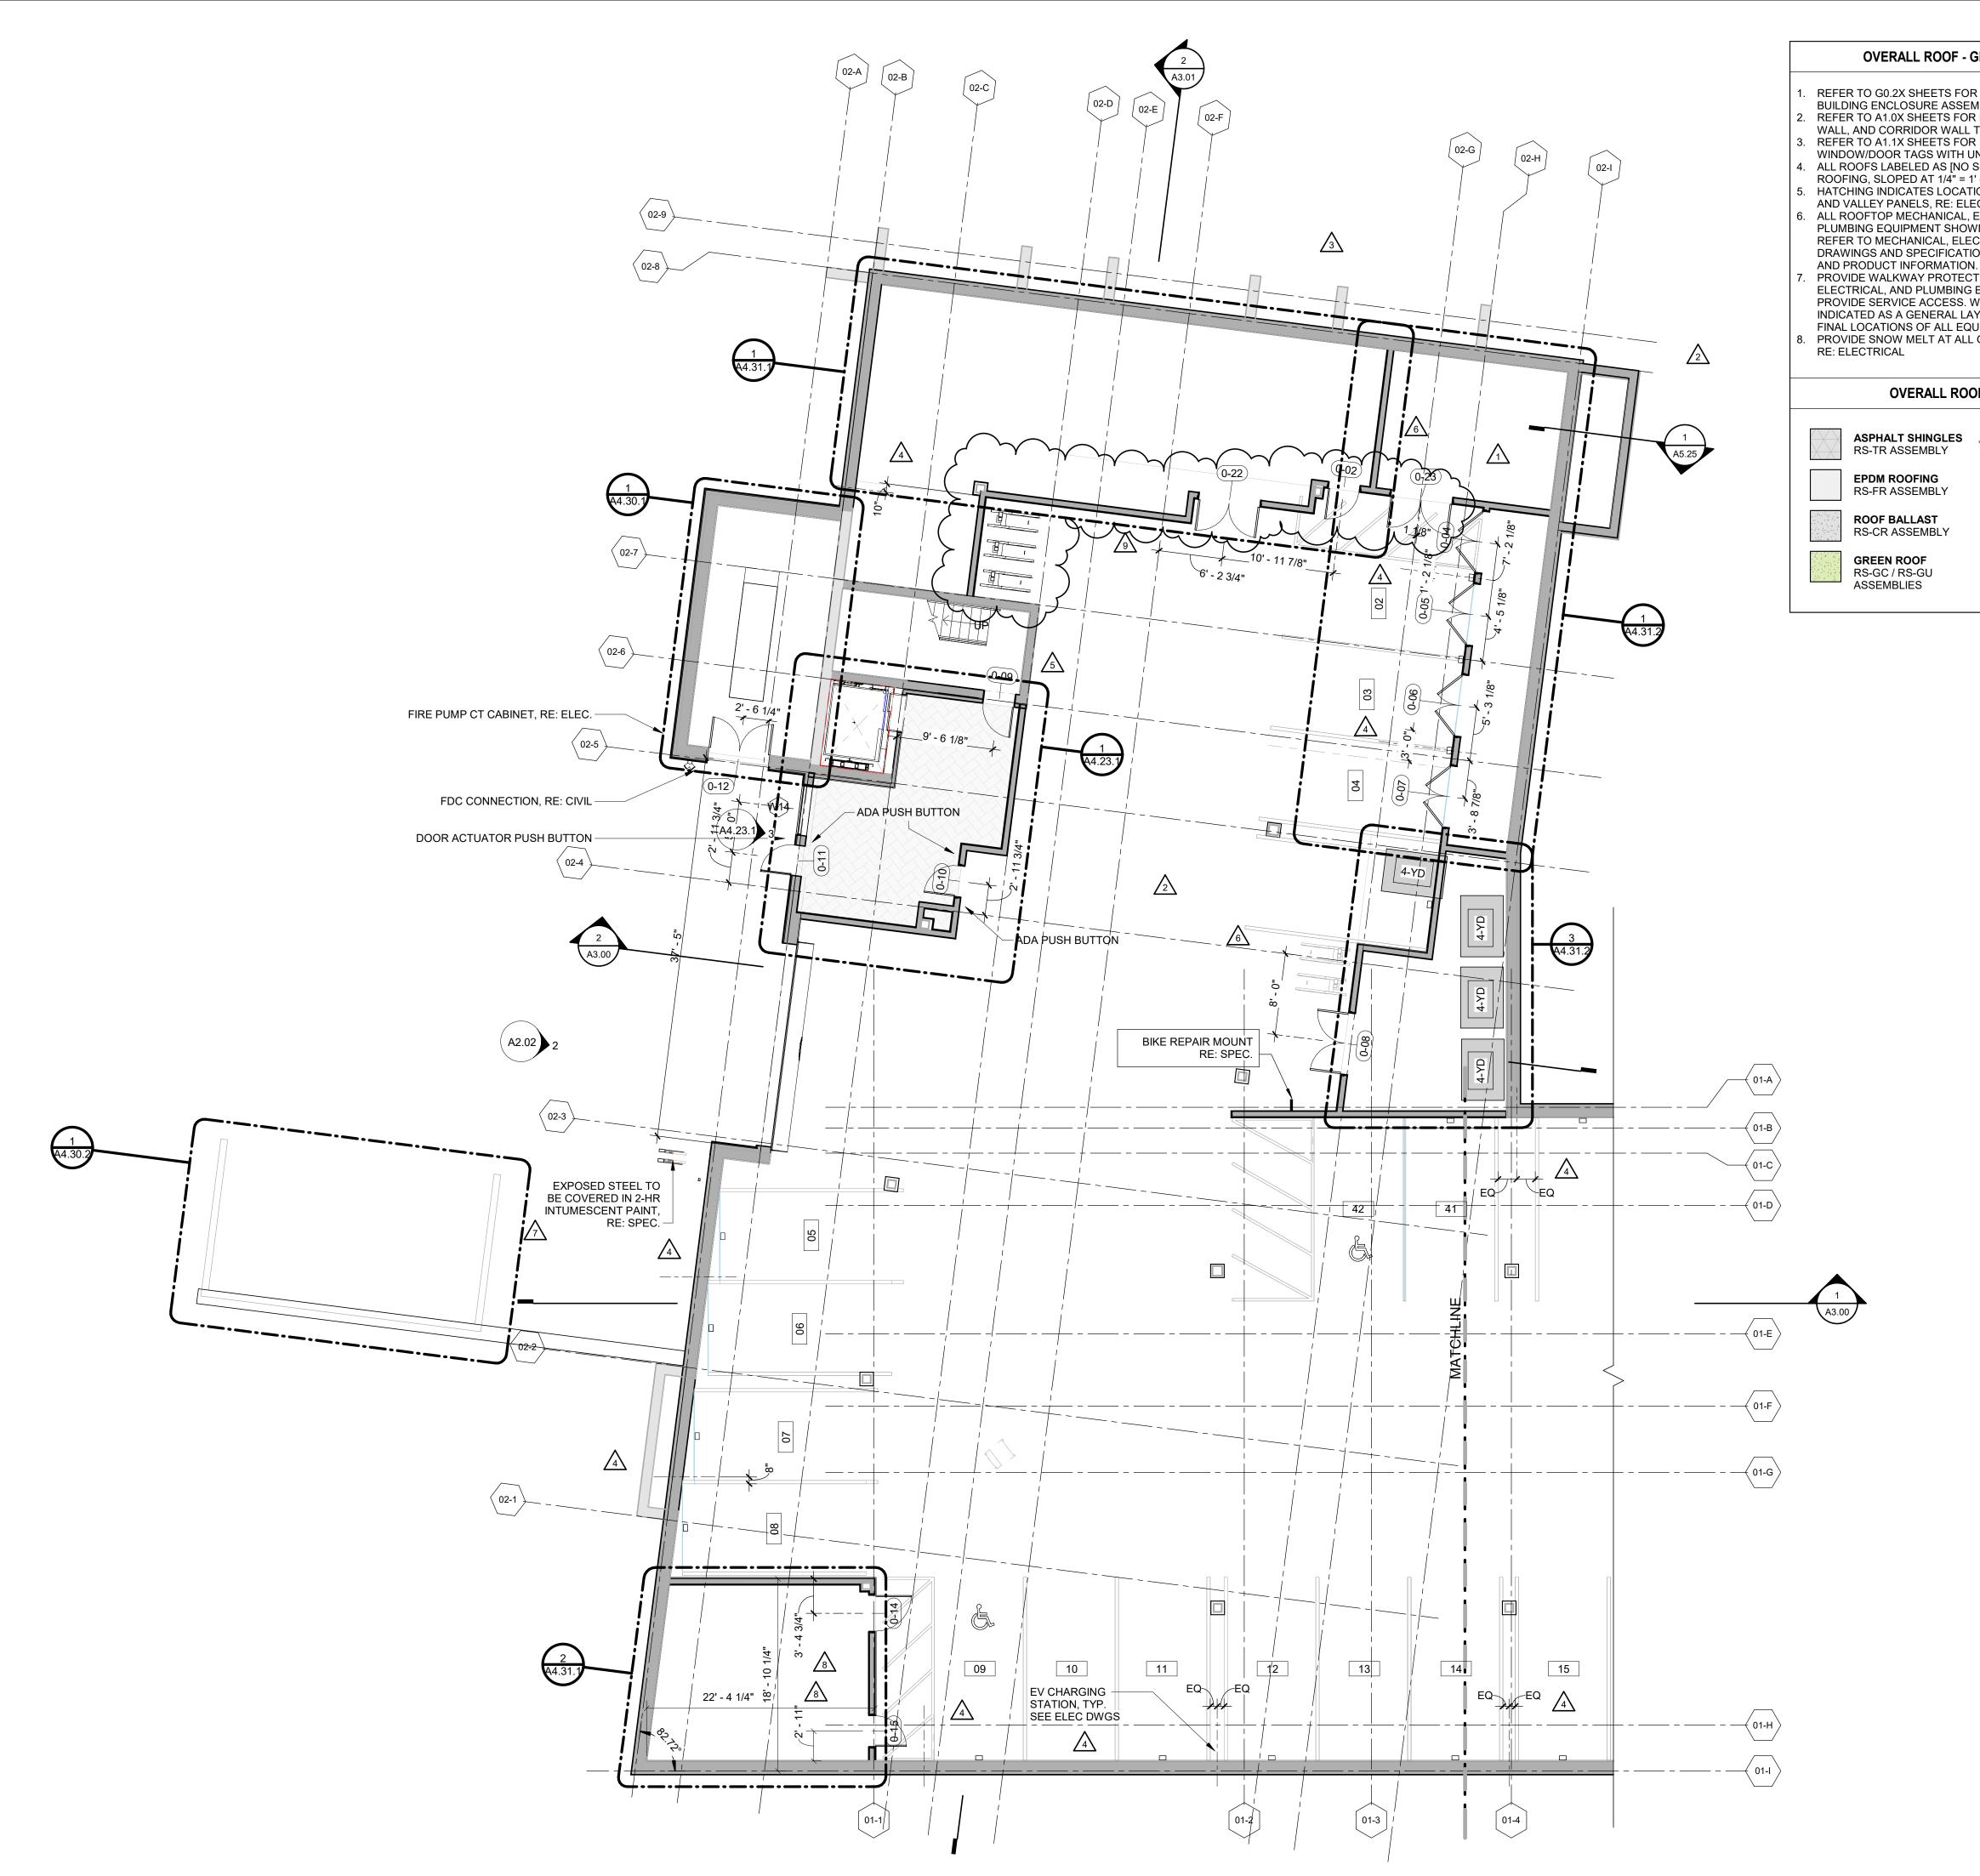


REFER TO G0.2X SHEETS FOR EXTERIOR AND INTERIOR

BUILDING ENCLOSURE ASSEMBLIES. REFER TO A1.0X SHEETS FOR EXTERIOR WALL, DEMISING WALL, AND CORRIDOR WALL TYPES AND LOCATIONS. REFER TO A1.1X SHEETS FOR INTERIOR AND EXTERIOR WINDOW/DOOR TAGS WITH UNIT BACKGROUNDS. ALL ROOFS LABELED AS [NO SLOPE] SHALL BE EPDM ROOFING, SLOPED AT 1/4" = 1' - 0" U.N.O. HATCHING INDICATES LOCATIONS OF SNOW MELT EAVE AND VALLEY PANELS, RE: ELECTRICAL DRAWINGS. ALL ROOFTOP MECHANICAL, ELECTRICAL, AND/OR PLUMBING EQUIPMENT SHOWN FOR REFERENCE ONLY. REFER TO MECHANICAL, ELECTRICAL, AND/OR PLUMBING DRAWINGS AND SPECIFICATIONS FOR SPECIFIC DESIGN

PROVIDE WALKWAY PROTECTION TO MAJOR MECHANICAL, ELECTRICAL, AND PLUMBING EQUIPMENT AS REQUIRED TO PROVIDE SERVICE ACCESS. WALKWAY PROTECTION IS INDICATED AS A GENERAL LAYOUT AND MAY NOT SHOW FINAL LOCATIONS OF ALL EQUIPMENT. PROVIDE SNOW MELT AT ALL GUTTERS & DOWNSPOUTS. RE: ELECTRICAL

OVERALL ROOF - LEGEND

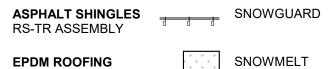

SNOWMELT

RIDGEVENT

ROOF BALLAST RS-CR ASSEMBLY

GREEN ROOF RS-GC / RS-GU ASSEMBLIES

- **OVERALL PLAN GENERAL NOTES**
- REFER TO G0.2X SHEETS FOR EXTERIOR AND INTERIOR BUILDING ENCLOSURE ASSEMBLIES.
- REFER TO A1.0X SHEETS FOR EXTERIOR WALL, DEMISING WALL, AND CORRIDOR WALL TYPES AND LOCATIONS.
- REFER TO A1.1X SHEETS FOR INTERIOR AND EXTERIOR WINDOW/DOOR TAGS WITH UNIT BACKGROUNDS. REFER TO A6.0X SHEETS FOR INTERIOR AND EXTERIOR
- WINDOW/DOOR SCHEDULES AND LEGENDS.
- ALIGN WALLS WHERE THEY APPEAR TO ALIGN, U.N.O. THE INSIDE FACE OF DOOR JAMBS SHALL BE 4" FROM
- ADJACENT WALL OR FINISHED COLUMN, U.N.O. SWING CLEARANCE AT UNIT ENTRY SHALL BE 18" MIN. FROM FINISH FACE OF ADJACENT SURFACE.
- ALL DIMENSIONS ARE TO FACE OF STUD, GRID LINE, OR FACE OF CONCRETE, U.N.O.
- ELECTRICAL METER AND SERVICE TO BE MOUNTED AT GARAGE LEVEL, COORDINATE METER AND PANEL
- LOCATION WITH OWNER. 0. ELECTRICAL CONTRACTOR SHALL PROVIDE DESIGN BUILD SECURITY SYSTEM, CORD. WITH OWNER.
- . WATER PIPES RUNNING NEXT TO OR WITHIN EXTERIOR WALLS TO BE INSULATED W/ 2" MIN CLOSED CELL INSULATION.
- 2. CONTRACTOR SHALL COORDINATE ALL MEANS, METHODS, SEQUENCES PROCEDURES AND SCHEDULES OF ALL CONSTRUCTION ACTIVITIES AND OPERATIONS FOR THE CONSTRUCTION OF THE PROJECT.
- 13. CONTRACTOR RESPONSIBLE FOR OBTAINING AND COMPLYING WITH ALL PERMITS. 4. CONTRACTOR RESPONSIBLE FOR COMPLYING WITH ALL
- MANUFACTURERS RECOMMENDATIONS FOR STORAGE, PREPARATION, FABRICATION, INSTALLATION AND CURING OF MATERIALS AND SYSTEMS.

B-2465 12/15/2023 Ω L


TOWN STAMP


359 Design

3630 OSAGE STREET DENVER, CO 80211 720.512.3437

REVISIONS	3	
No.	Description	Date
	GMP REVISIONS	02.09.24
	IFC SET	03.15.24
	RFI #65.1	05.24.24
	RFI #75	05.30.24
	RFI #77 RFI #124	06.03.24
	RFI #124	08.01.24
	RFI #272	09.25.24
	RFI #277	10.07.24
		20019 03/15/2024
SSUE DAT	E	03/15/2024
ISSUE DAT	THE AMBLE	03/15/2024
ISSUE DAT	THE AMBLE IFC SET	03/15/2024
ISSUE DAT	E THE AMBLE IFC SET	03/15/2024

FLOOR PLAN - LEVEL 00 - EAST1/8" = 1'-0"

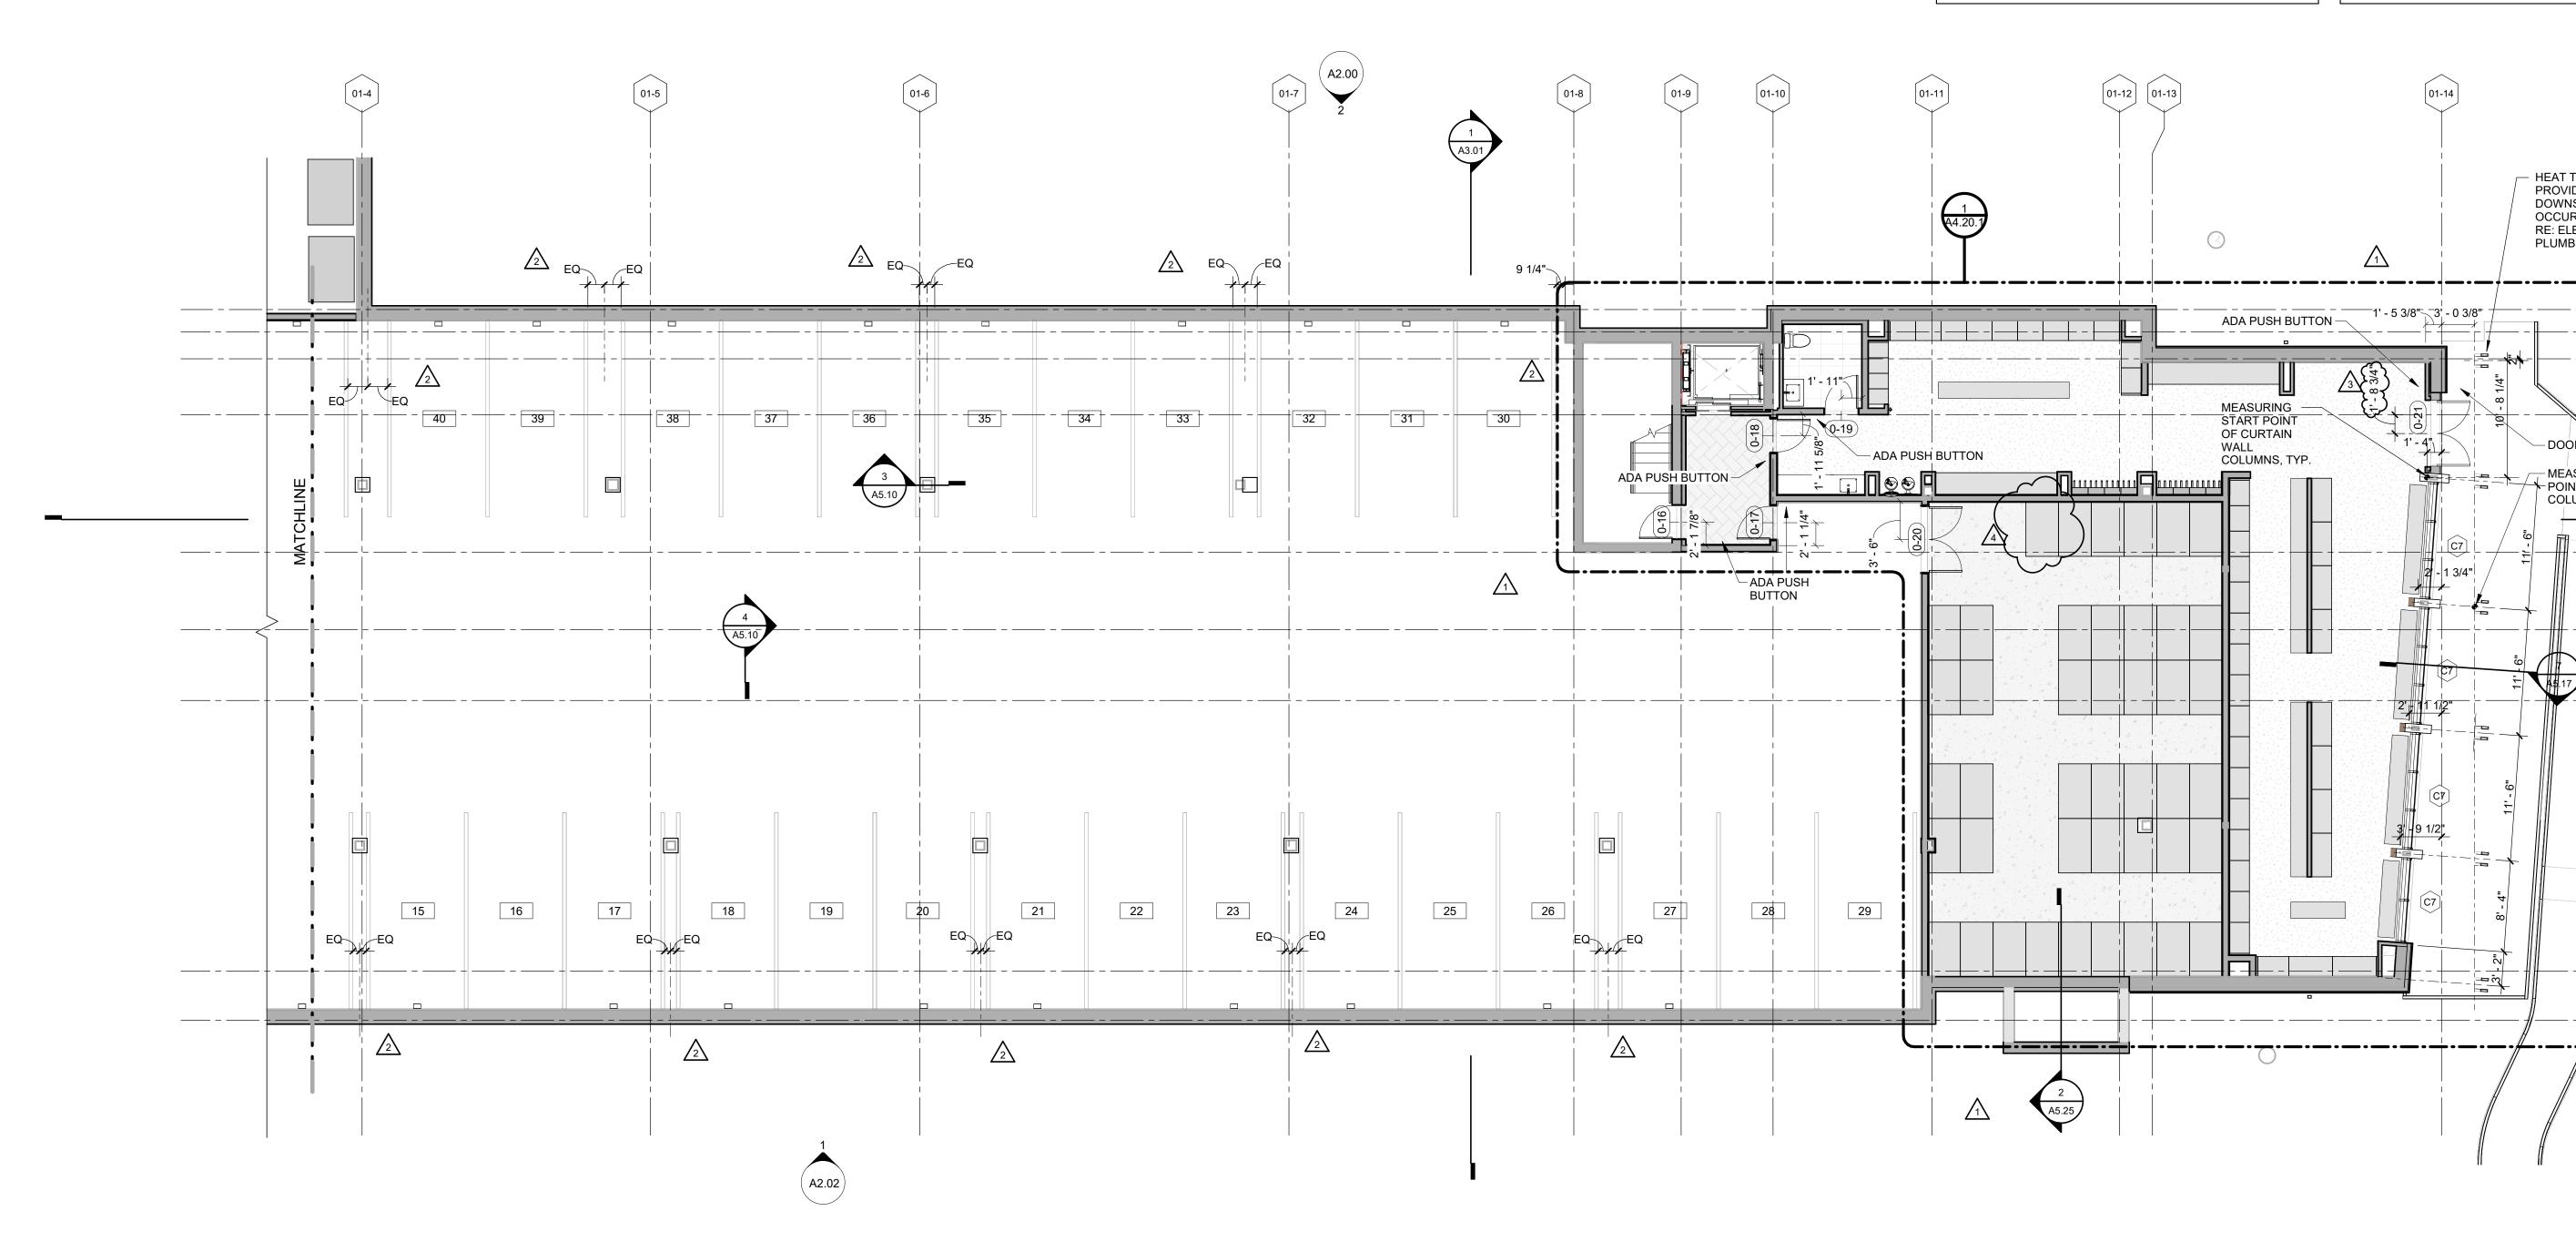


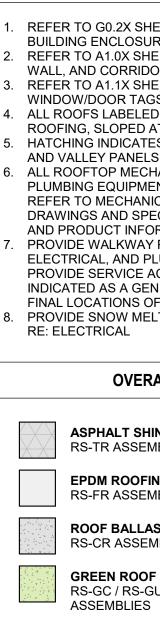



OVERALL ROOF - GENERAL NOTES

REFER TO G0.2X SHEETS FOR EXTERIOR AND INTERIOR BUILDING ENCLOSURE ASSEMBLIES.

- WALL, AND CORRIDOR WALL TYPES AND LOCATIONS. REFER TO A1.1X SHEETS FOR INTERIOR AND EXTERIOR WINDOW/DOOR TAGS WITH UNIT BACKGROUNDS.
- ALL ROOFS LABELED AS [NO SLOPE] SHALL BE EPDM ROOFING, SLOPED AT 1/4" = 1' - 0" U.N.O. HATCHING INDICATES LOCATIONS OF SNOW MELT EAVE
- AND VALLEY PANELS, RE: ELECTRICAL DRAWINGS. ALL ROOFTOP MECHANICAL, ELECTRICAL, AND/OR PLUMBING EQUIPMENT SHOWN FOR REFERENCE ONLY.
- REFER TO MECHANICAL, ELECTRICAL, AND/OR PLUMBING DRAWINGS AND SPECIFICATIONS FOR SPECIFIC DESIGN AND PRODUCT INFORMATION. PROVIDE WALKWAY PROTECTION TO MAJOR MECHANICAL
- ELECTRICAL, AND PLUMBING EQUIPMENT AS REQUIRED TO PROVIDE SERVICE ACCESS. WALKWAY PROTECTION IS INDICATED AS A GENERAL LAYOUT AND MAY NOT SHOW FINAL LOCATIONS OF ALL EQUIPMENT. PROVIDE SNOW MELT AT ALL GUTTERS & DOWNSPOUTS.
- RE: ELECTRICAL

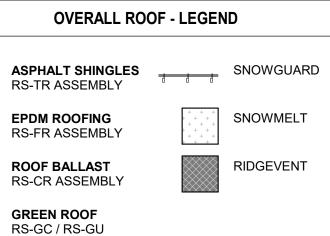

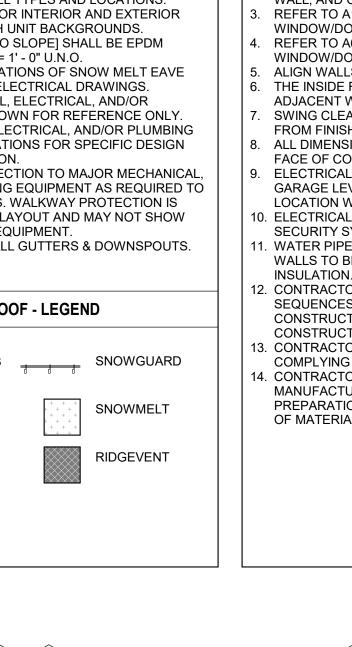

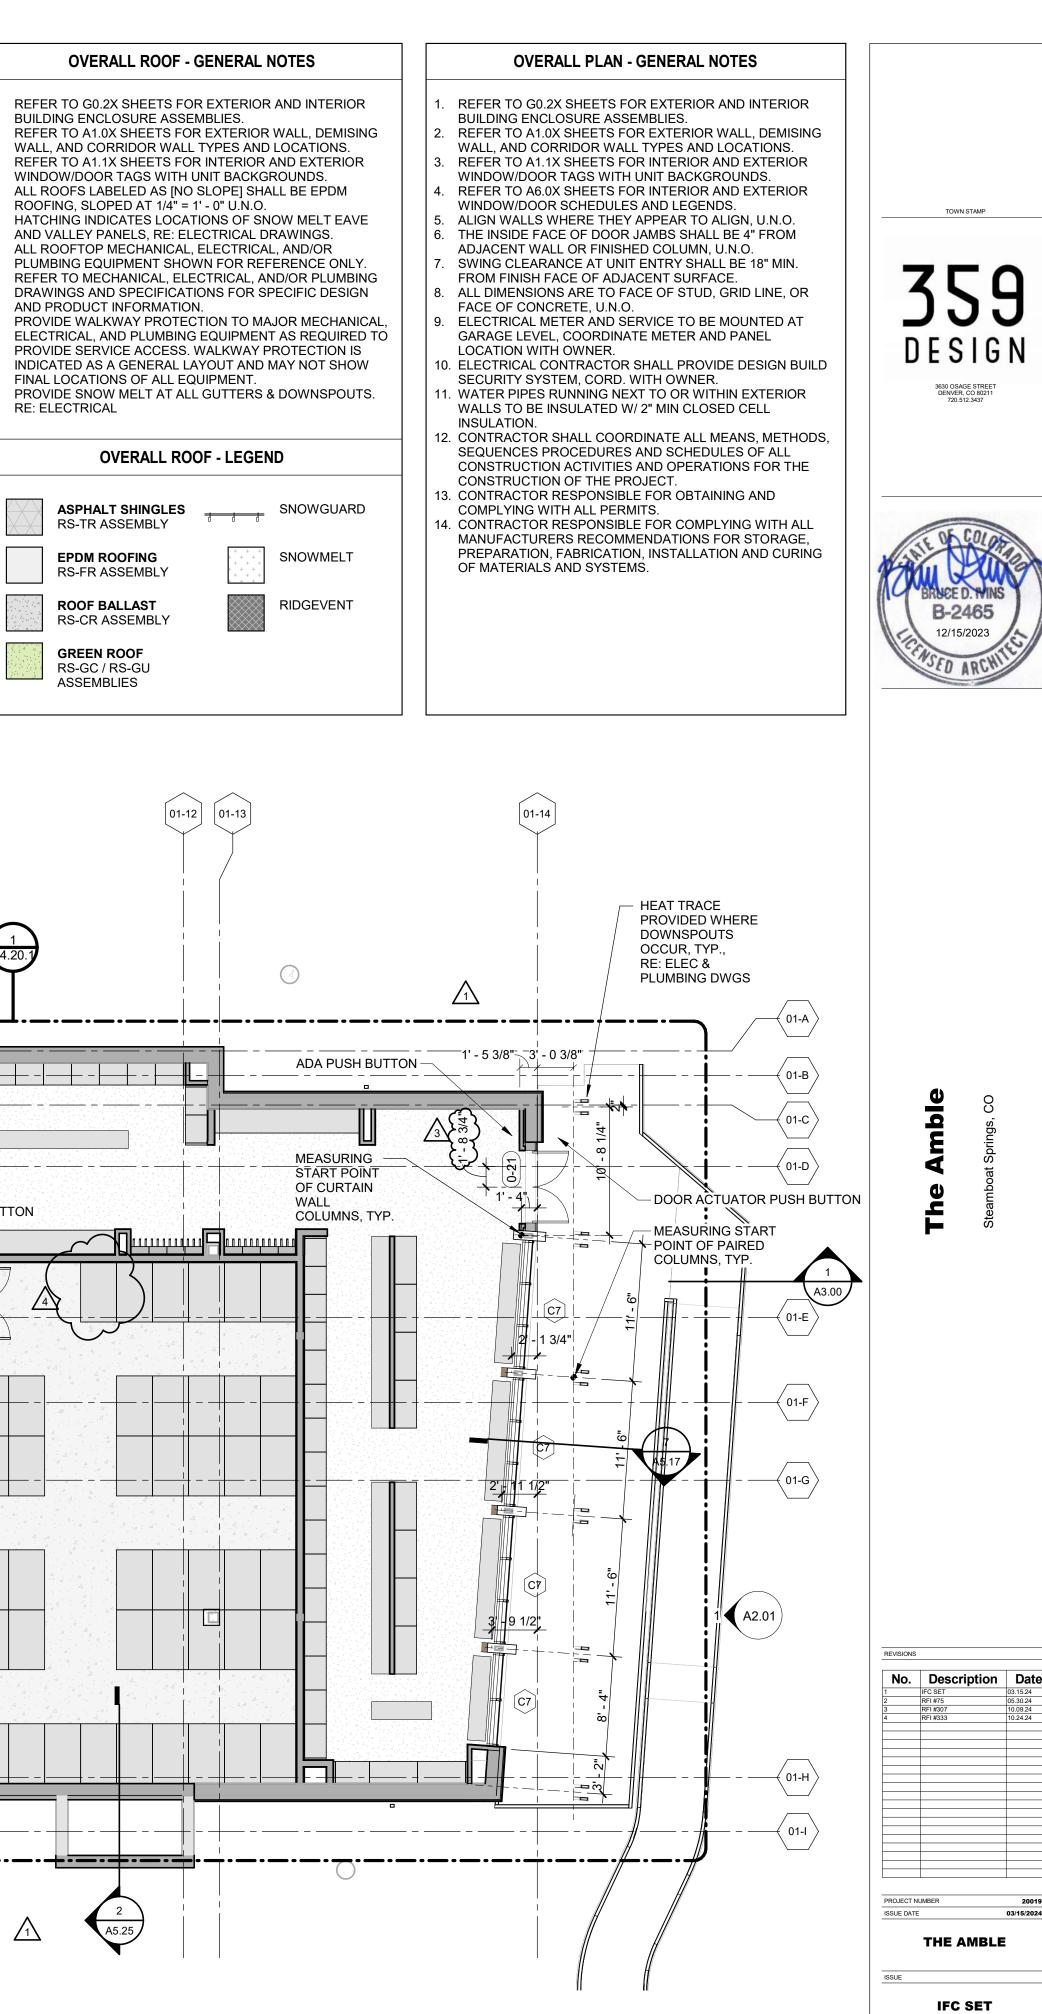

FLOOR PLAN - LEVEL 00

- EAST

SHEET NO.





02-1

OVERALL ROOF - GENERAL NOTES

REFER TO G0.2X SHEETS FOR EXTERIOR AND INTERIOR

BUILDING ENCLOSURE ASSEMBLIES. REFER TO A1.0X SHEETS FOR EXTERIOR WALL, DEMISING WALL, AND CORRIDOR WALL TYPES AND LOCATIONS. REFER TO A1.1X SHEETS FOR INTERIOR AND EXTERIOR WINDOW/DOOR TAGS WITH UNIT BACKGROUNDS. ALL ROOFS LABELED AS [NO SLOPE] SHALL BE EPDM ROOFING, SLOPED AT 1/4" = 1' - 0" U.N.O. HATCHING INDICATES LOCATIONS OF SNOW MELT EAVE AND VALLEY PANELS, RE: ELECTRICAL DRAWINGS. ALL ROOFTOP MECHANICAL, ELECTRICAL, AND/OR PLUMBING EQUIPMENT SHOWN FOR REFERENCE ONLY. REFER TO MECHANICAL, ELECTRICAL, AND/OR PLUMBING DRAWINGS AND SPECIFICATIONS FOR SPECIFIC DESIGN

AND PRODUCT INFORMATION. PROVIDE WALKWAY PROTECTION TO MAJOR MECHANICAL, ELECTRICAL, AND PLUMBING EQUIPMENT AS REQUIRED TO PROVIDE SERVICE ACCESS. WALKWAY PROTECTION IS INDICATED AS A GENERAL LAYOUT AND MAY NOT SHOW FINAL LOCATIONS OF ALL EQUIPMENT. PROVIDE SNOW MELT AT ALL GUTTERS & DOWNSPOUTS. RE: ELECTRICAL

SNOWMELT

RIDGEVENT

OVERALL ROOF - LEGEND



EPDM ROOFING RS-FR ASSEMBLY

ROOF BALLAST RS-CR ASSEMBLY

GREEN ROOF RS-GC / RS-GU ASSEMBLIES

OVERALL PLAN - GENERAL NOTES

- REFER TO G0.2X SHEETS FOR EXTERIOR AND INTERIOR BUILDING ENCLOSURE ASSEMBLIES.
- REFER TO A1.0X SHEETS FOR EXTERIOR WALL, DEMISING WALL, AND CORRIDOR WALL TYPES AND LOCATIONS.
- REFER TO A1.1X SHEETS FOR INTERIOR AND EXTERIOR WINDOW/DOOR TAGS WITH UNIT BACKGROUNDS. REFER TO A6.0X SHEETS FOR INTERIOR AND EXTERIOR
- WINDOW/DOOR SCHEDULES AND LEGENDS. ALIGN WALLS WHERE THEY APPEAR TO ALIGN, U.N.O.
- THE INSIDE FACE OF DOOR JAMBS SHALL BE 4" FROM ADJACENT WALL OR FINISHED COLUMN, U.N.O.
- SWING CLEARANCE AT UNIT ENTRY SHALL BE 18" MIN. FROM FINISH FACE OF ADJACENT SURFACE.
- ALL DIMENSIONS ARE TO FACE OF STUD, GRID LINE, OR FACE OF CONCRETE, U.N.O. ELECTRICAL METER AND SERVICE TO BE MOUNTED AT
- GARAGE LEVEL, COORDINATE METER AND PANEL LOCATION WITH OWNER. 0. ELECTRICAL CONTRACTOR SHALL PROVIDE DESIGN BUILD
- SECURITY SYSTEM, CORD. WITH OWNER. . WATER PIPES RUNNING NEXT TO OR WITHIN EXTERIOR WALLS TO BE INSULATED W/ 2" MIN CLOSED CELL
- INSULATION. 2. CONTRACTOR SHALL COORDINATE ALL MEANS, METHODS, SEQUENCES PROCEDURES AND SCHEDULES OF ALL CONSTRUCTION ACTIVITIES AND OPERATIONS FOR THE CONSTRUCTION OF THE PROJECT.
- 13. CONTRACTOR RESPONSIBLE FOR OBTAINING AND COMPLYING WITH ALL PERMITS. 4. CONTRACTOR RESPONSIBLE FOR COMPLYING WITH ALL
- MANUFACTURERS RECOMMENDATIONS FOR STORAGE. PREPARATION, FABRICATION, INSTALLATION AND CURING OF MATERIALS AND SYSTEMS.


B-2465 12/15/2023 LO ARC 2

TOWN STAMP


359 Design

3630 OSAGE STREET DENVER, CO 80211 720.512.3437

No.	Description	Date
1	GMP REVISIONS	02.09.24
2	IFC SET	02.09.24
3	RFI #21	03.15.24 04.16.24
4	RFI #129	06.27.24
5	RFI #214	08.21.24
3	RFI #214.1	09.18.24
7 B	RFI #252 RFI #318	10.01.24
9	RFI #332	10.13.24
0	RFI #348	11.13.24
	THE AMBLE	•
ISSUE	IFC SET	
SHEET TITL	E	
	R PLAN - LE	VEL O

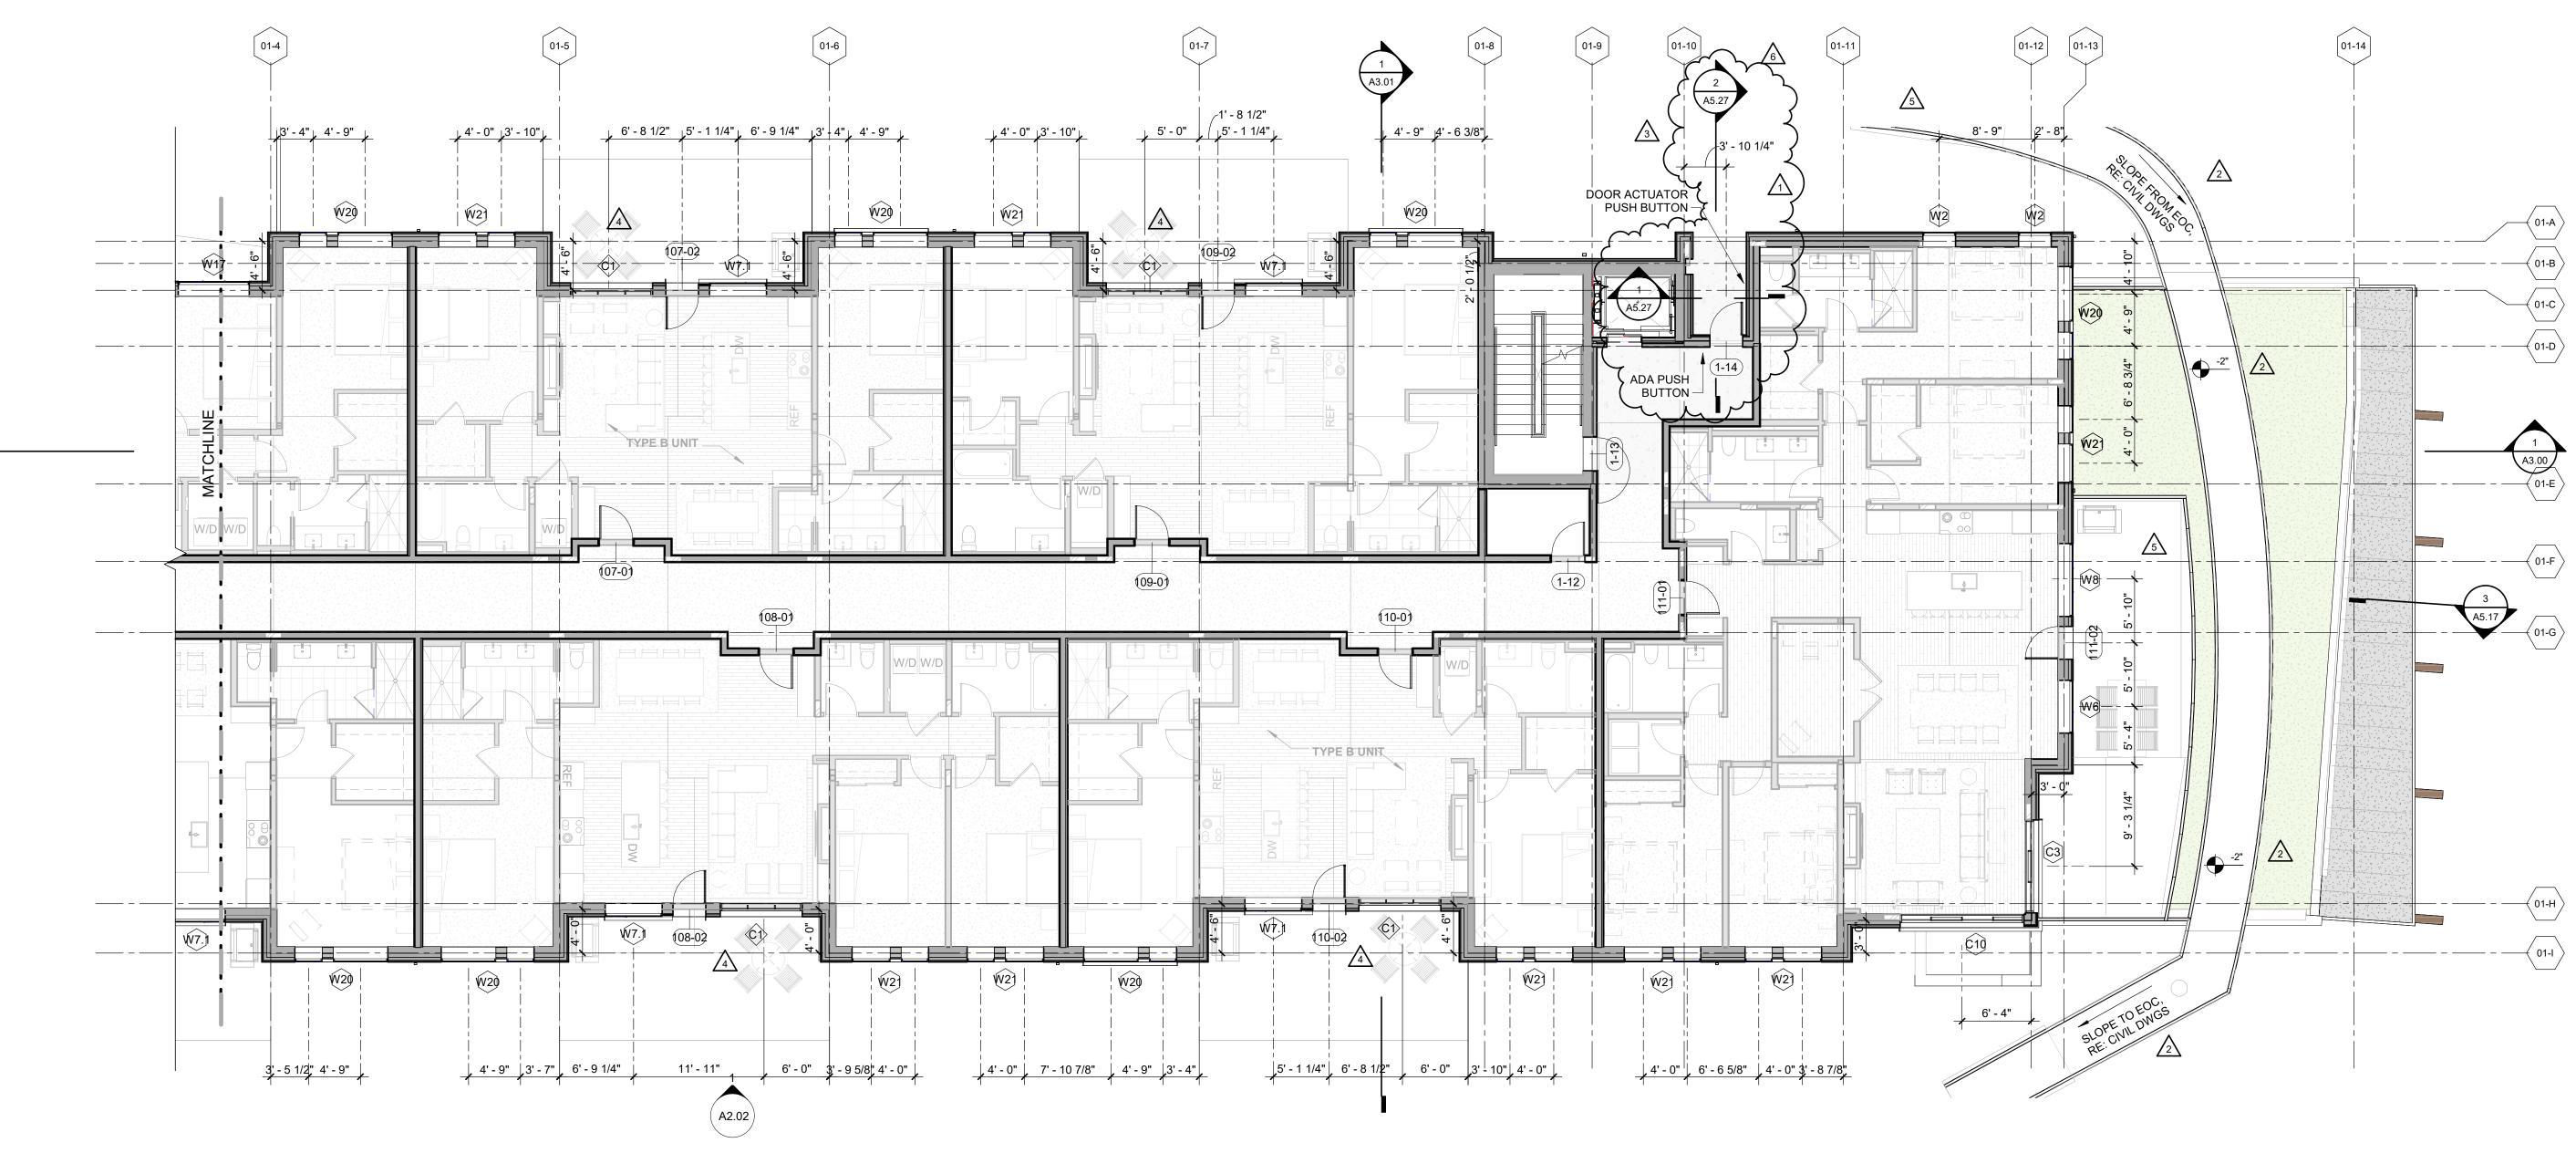

FLOOR PLAN - LEVEL 01 - EAST 1/8" = 1'-0"

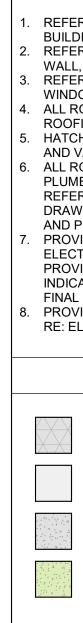


OVERALL ROOF - GENERAL NOTES

REFER TO G0.2X SHEETS FOR EXTERIOR AND INTERIOR

BUILDING ENCLOSURE ASSEMBLIES.
REFER TO A1.0X SHEETS FOR EXTERIOR WALL, DEMISING WALL, AND CORRIDOR WALL TYPES AND LOCATIONS.
REFER TO A1.1X SHEETS FOR INTERIOR AND EXTERIOR WINDOW/DOOR TAGS WITH UNIT BACKGROUNDS.
ALL ROOFS LABELED AS [NO SLOPE] SHALL BE EPDM ROOFING, SLOPED AT 1/4" = 1' - 0" U.N.O.
HATCHING INDICATES LOCATIONS OF SNOW MELT EAVE AND VALLEY PANELS, RE: ELECTRICAL DRAWINGS.
ALL ROOFTOP MECHANICAL, ELECTRICAL, AND/OR PLUMBING EQUIPMENT SHOWN FOR REFERENCE ONLY. REFER TO MECHANICAL, ELECTRICAL, AND/OR PLUMBING DRAWINGS AND SPECIFICATIONS FOR SPECIFIC DESIGN AND PRODUCT INFORMATION.

 PROVIDE WALKWAY PROTECTION TO MAJOR MECHANICAL, ELECTRICAL, AND PLUMBING EQUIPMENT AS REQUIRED TO PROVIDE SERVICE ACCESS. WALKWAY PROTECTION IS INDICATED AS A GENERAL LAYOUT AND MAY NOT SHOW FINAL LOCATIONS OF ALL EQUIPMENT.
 PROVIDE SNOW MELT AT ALL GUTTERS & DOWNSPOUTS. RE: ELECTRICAL

OVERALL ROOF - LEGEND

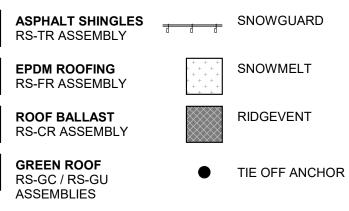

OVERALL PLAN - GENERAL NOTES

- 1. REFER TO G0.2X SHEETS FOR EXTERIOR AND INTERIOR BUILDING ENCLOSURE ASSEMBLIES.
- REFER TO A1.0X SHEETS FOR EXTERIOR WALL, DEMISING WALL, AND CORRIDOR WALL TYPES AND LOCATIONS.
 REFER TO A1.1X SHEETS FOR INTERIOR AND EXTERIOR
- WINDOW/DOOR TAGS WITH UNIT BACKGROUNDS. 4. REFER TO A6.0X SHEETS FOR INTERIOR AND EXTERIOR
- WINDOW/DOOR SCHEDULES AND LEGENDS. 5. ALIGN WALLS WHERE THEY APPEAR TO ALIGN, U.N.O.
- THE INSIDE FACE OF DOOR JAMBS SHALL BE 4" FROM
- ADJACENT WALL OR FINISHED COLUMN, U.N.O. SWING CLEARANCE AT UNIT ENTRY SHALL BE 18" MIN. FROM FINISH FACE OF ADJACENT SURFACE.
- ALL DIMENSIONS ARE TO FACE OF STUD, GRID LINE, OR FACE OF CONCRETE, U.N.O.
- ELECTRICAL METER AND SERVICE TO BE MOUNTED AT GARAGE LEVEL, COORDINATE METER AND PANEL
- LOCATION WITH OWNER. 0. ELECTRICAL CONTRACTOR SHALL PROVIDE DESIGN BUILD SECURITY SYSTEM, CORD. WITH OWNER.
- 11. WATER PIPES RUNNING NEXT TO OR WITHIN EXTERIOR WALLS TO BE INSULATED W/ 2" MIN CLOSED CELL INSULATION.
- CONTRACTOR SHALL COORDINATE ALL MEANS, METHODS, SEQUENCES PROCEDURES AND SCHEDULES OF ALL CONSTRUCTION ACTIVITIES AND OPERATIONS FOR THE CONSTRUCTION OF THE PROJECT.
 CONTRACTOR RESPONSIBLE FOR OBTAINING AND
- COMPLYING WITH ALL PERMITS. 14. CONTRACTOR RESPONSIBLE FOR COMPLYING WITH ALL
- MANUFACTURERS RECOMMENDATIONS FOR STORAGE, PREPARATION, FABRICATION, INSTALLATION AND CURING OF MATERIALS AND SYSTEMS.


TOWN STAMP **359** Design 3630 OSAGE STREET DENVER, CO 80211 720.512.3437 B-2465 12/15/2023 ED ARC' U q No. Description Date PROJECT NUMBER ISSUE DATE THE AMBLE

IFC SET


SHEET TITLE FLOOR PLAN - LEVEL 01 - EAST

A1.11.2

SHEET NO.

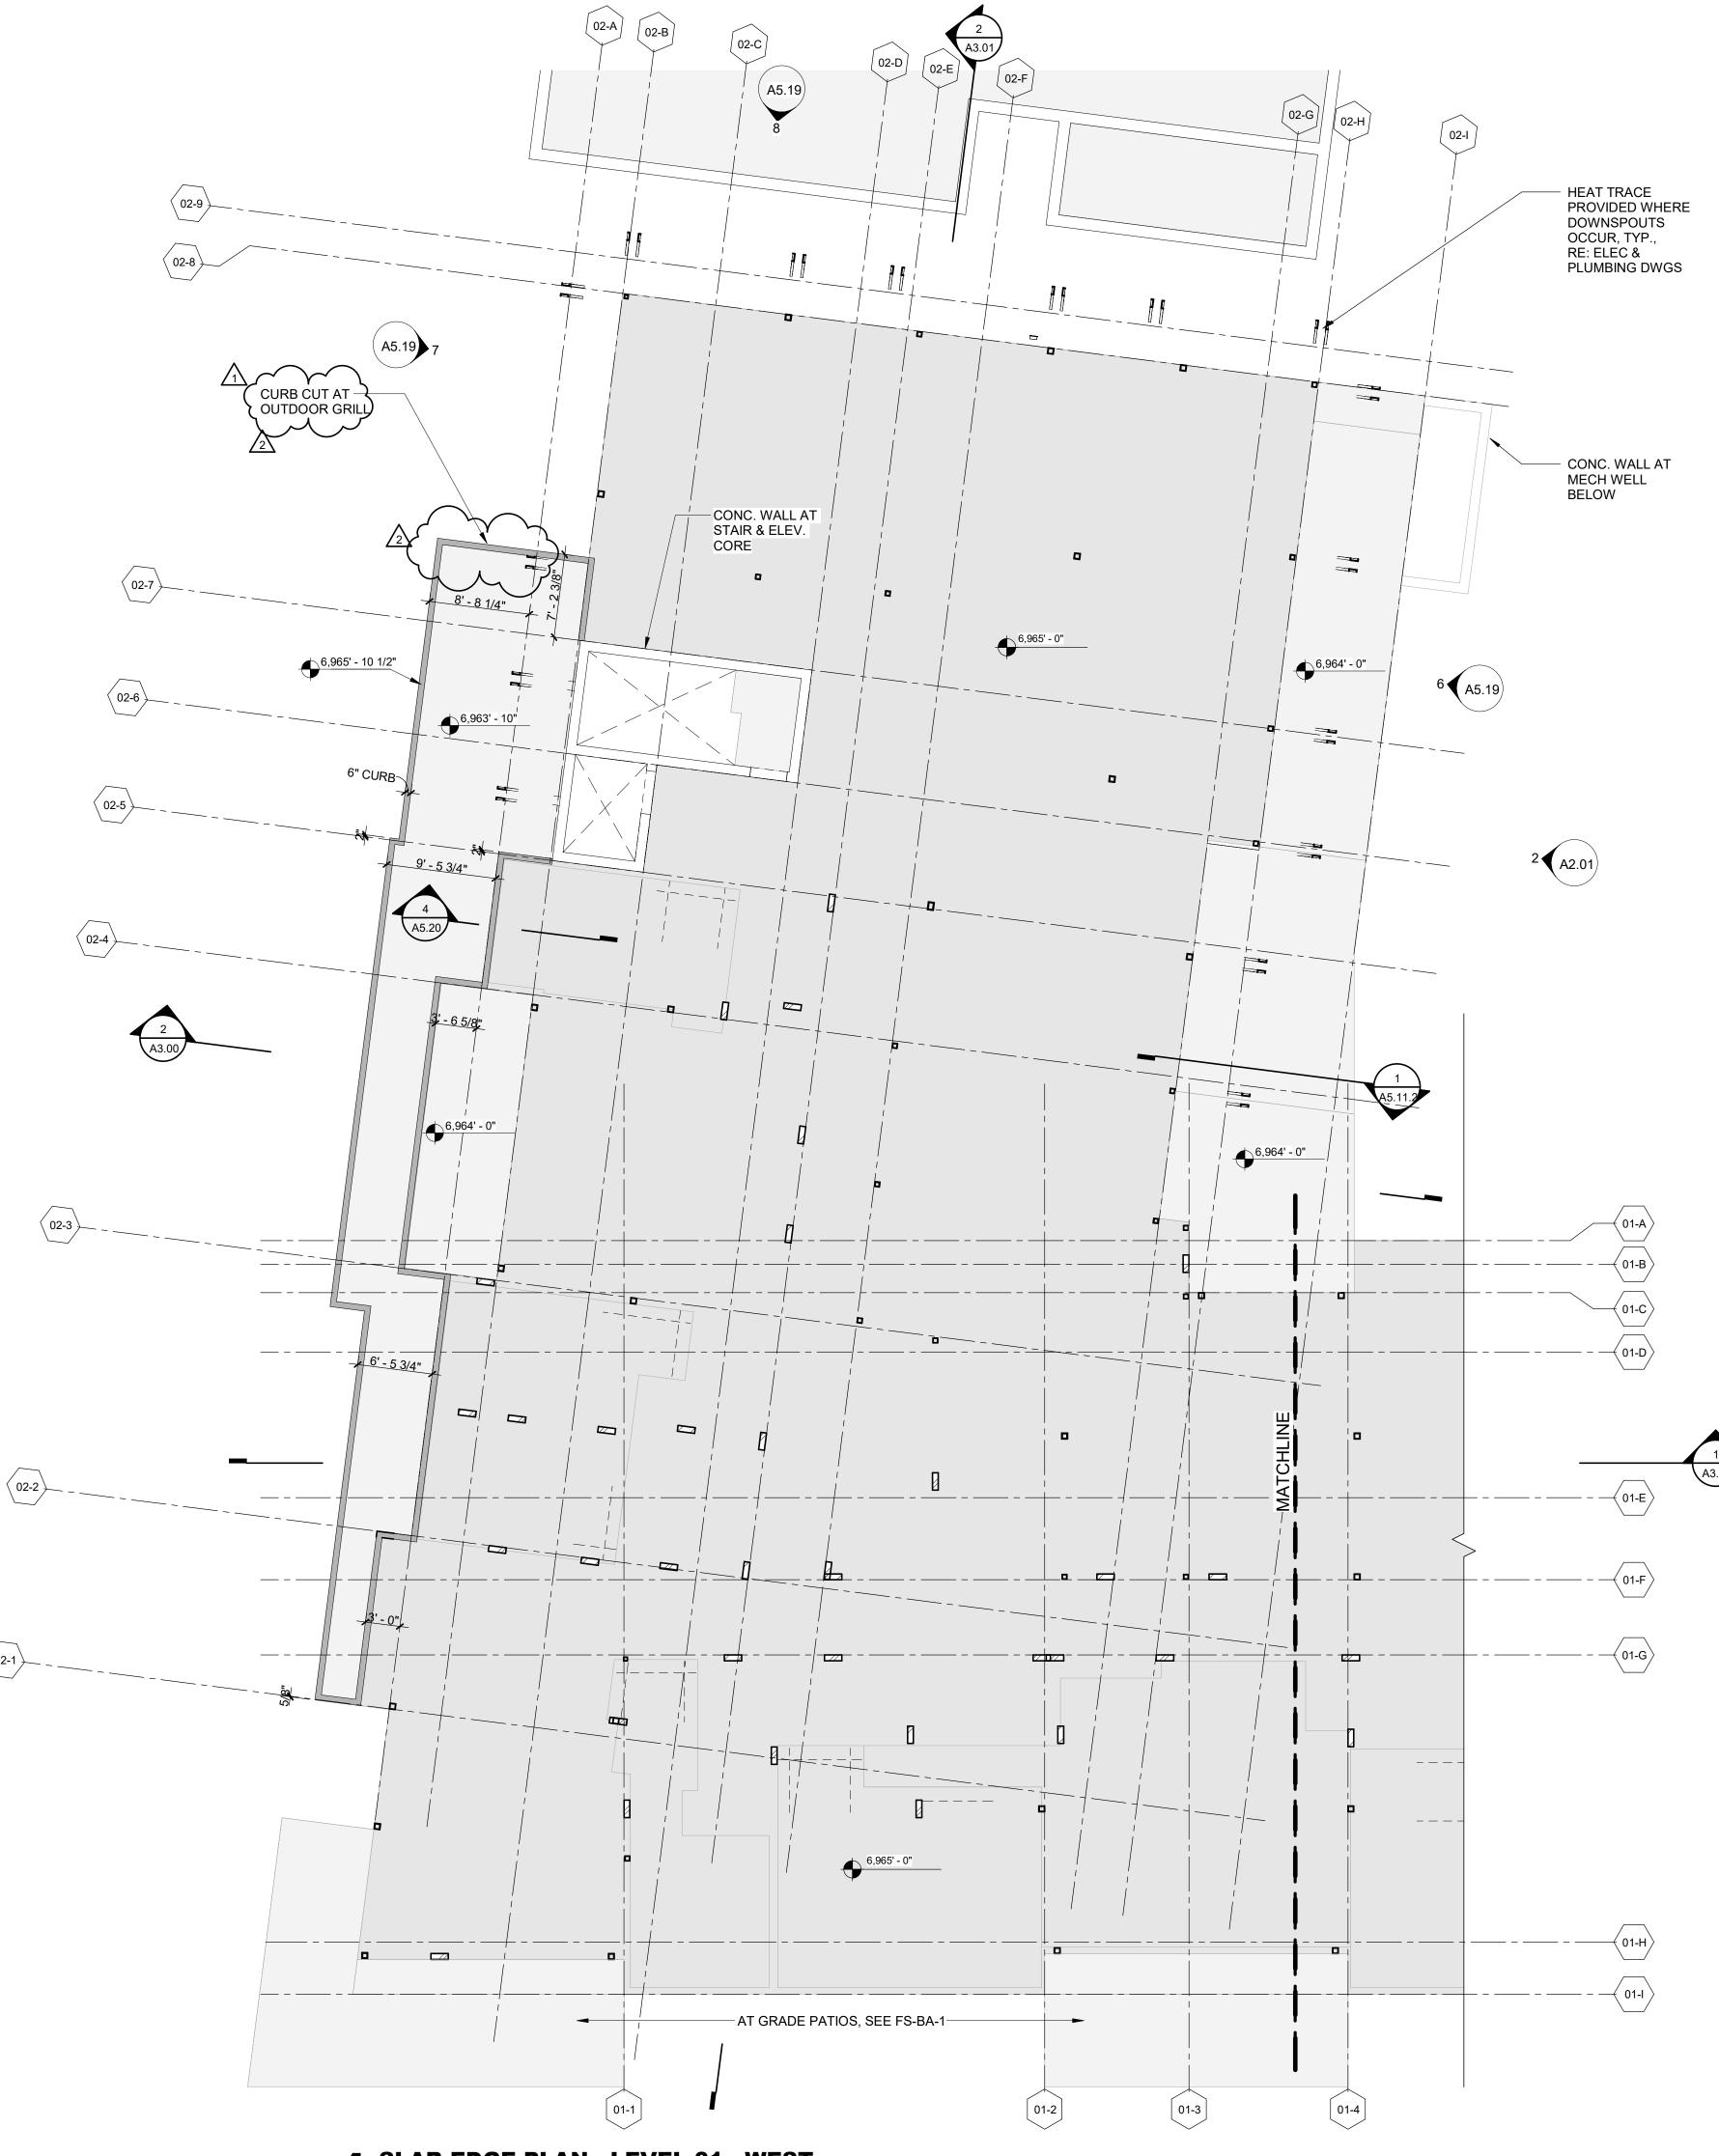

⟨ 02-1 ⟩

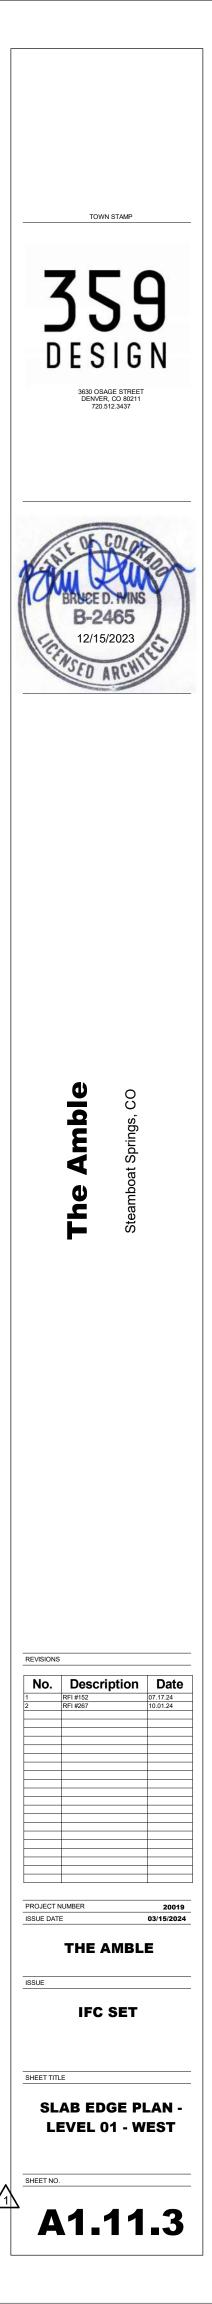





RIOR AND INTERIOR		1. REFER TO G0.2X SHEETS FOR EXTERIOR AND INTERIOR BUILDING ENCLOSURE ASSEMBLIES.	
RIOR WALL, DEMISING		2. REFER TO A1.0X SHEETS FOR EXTERIOR WALL, DEMISING	
AND LOCATIONS.		WALL, AND CORRIDOR WALL TYPES AND LOCATIONS.	
RIOR AND EXTERIOR		3. REFER TO A1.1X SHEETS FOR INTERIOR AND EXTERIOR	
CKGROUNDS.		WINDOW/DOOR TAGS WITH UNIT BACKGROUNDS.	
] SHALL BE EPDM	4	4. REFER TO A6.0X SHEETS FOR INTERIOR AND EXTERIOR	
N.O.		WINDOW/DOOR SCHEDULES AND LEGENDS.	TOWN STAMP
OF SNOW MELT EAVE	5	5. ALIGN WALLS WHERE THEY APPEAR TO ALIGN, U.N.O.	
AL DRAWINGS.	6	5. THE INSIDE FACE OF DOOR JAMBS SHALL BE 4" FROM	
RICAL, AND/OR		ADJACENT WALL OR FINISHED COLUMN, U.N.O.	
R REFERENCE ONLY.		7. SWING CLEARANCE AT UNIT ENTRY SHALL BE 18" MIN.	
AL, AND/OR PLUMBING		FROM FINISH FACE OF ADJACENT SURFACE.	
OR SPECIFIC DESIGN	8	3. ALL DIMENSIONS ARE TO FACE OF STUD, GRID LINE, OR	359
		FACE OF CONCRETE, U.N.O.	
O MAJOR MECHANICAL,	9	9. ELECTRICAL METER AND SERVICE TO BE MOUNTED AT	
MENT AS REQUIRED TO		GARAGE LEVEL, COORDINATE METER AND PANEL	DECION
AY PROTECTION IS		LOCATION WITH OWNER.	DESIGN
AND MAY NOT SHOW	-	10. ELECTRICAL CONTRACTOR SHALL PROVIDE DESIGN BUILD	DEGIGI
NT.		SECURITY SYSTEM, CORD. WITH OWNER.	3630 OSAGE STREET
ERS & DOWNSPOUTS.	-	11. WATER PIPES RUNNING NEXT TO OR WITHIN EXTERIOR	DENVER, CO 80211 720.512.3437
		WALLS TO BE INSULATED W/ 2" MIN CLOSED CELL	
		INSULATION.	
		12. CONTRACTOR SHALL COORDINATE ALL MEANS, METHODS,	
EGEND		SEQUENCES PROCEDURES AND SCHEDULES OF ALL	
		CONSTRUCTION ACTIVITIES AND OPERATIONS FOR THE	
		CONSTRUCTION OF THE PROJECT.	
	· ·	13. CONTRACTOR RESPONSIBLE FOR OBTAINING AND	
SNOWGUARD		COMPLYING WITH ALL PERMITS.	
U	-	14. CONTRACTOR RESPONSIBLE FOR COMPLYING WITH ALL	25 60.
		MANUFACTURERS RECOMMENDATIONS FOR STORAGE,	14 0 60100
		PREPARATION, FABRICATION, INSTALLATION AND CURING	
+ + + + + + + + + + + + + + + + + + +		OF MATERIALS AND SYSTEMS.	The Durg
+ +			A POLICE D MING
RIDGEVENT			DROCE D. MINS
			B-2465
			12/15/2023
			1.21
			IH20+ 032
			CU ANU
			Contraction -

OVERALL PLAN - GENERAL NOTES




8

VISIONS		
No.	Description	Date
	RFI #129	06.27.24
	RFI #154	07.03.24
OJECT	NUMBER	20019
SUE DAT	E	03/15/2024
	THE AMBLE	E
SUE		
	IFC SET	
FET TITI	F	


FLOOR PLAN - LEVEL 02 - WEST

A1.12.1

IEET	NO.	

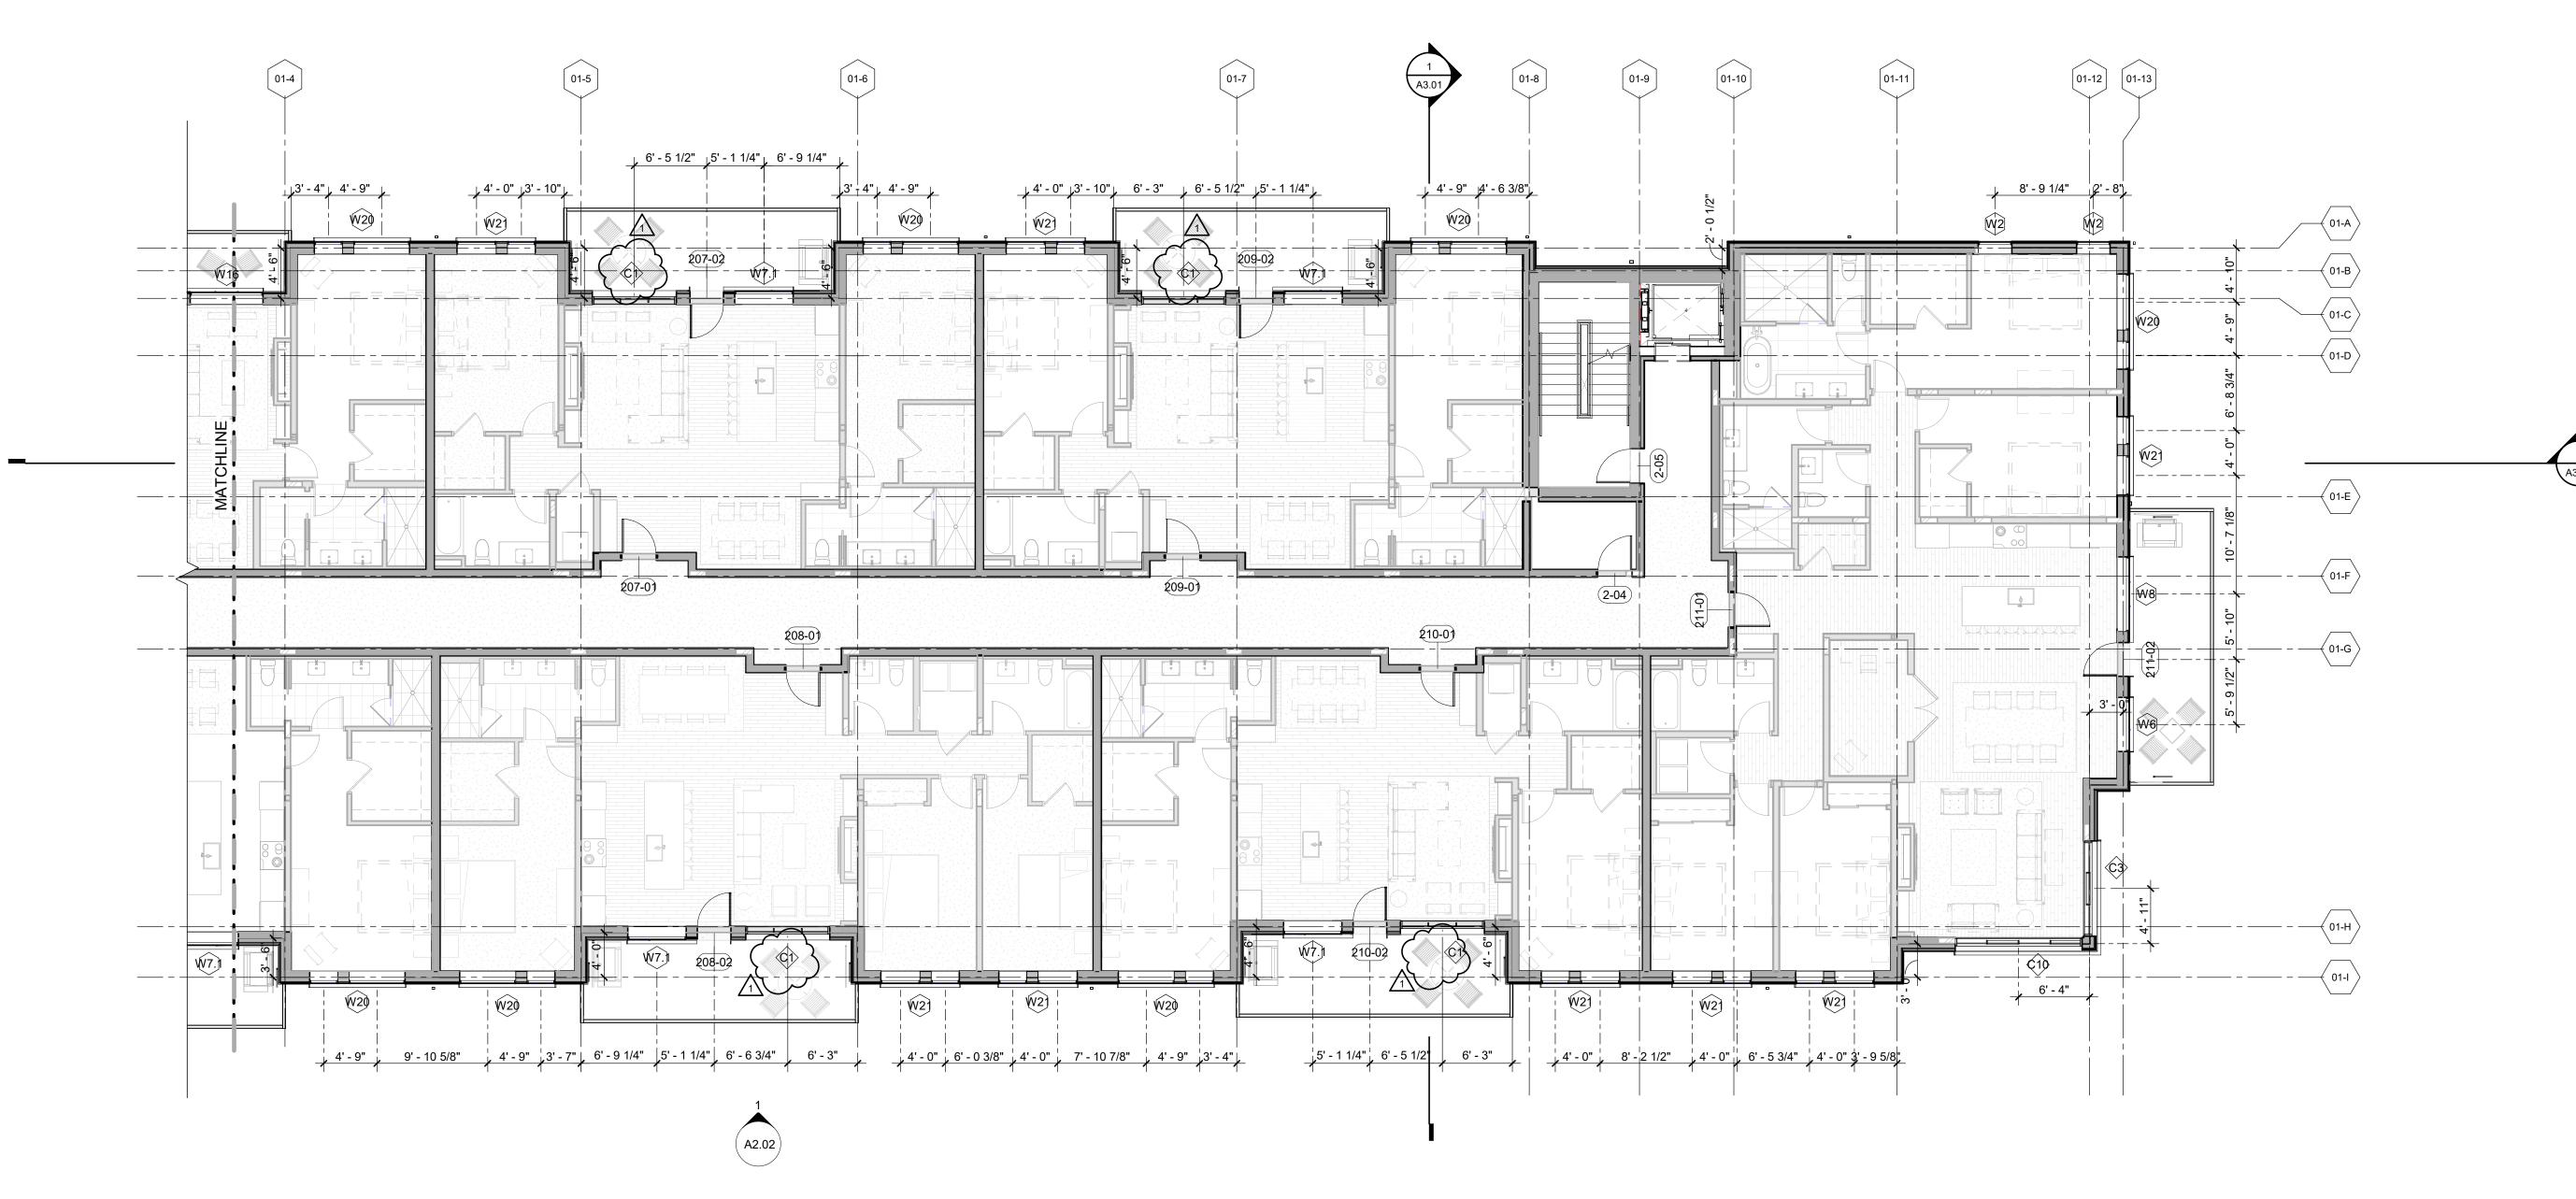

FLOOR PLAN - LEVEL 02 - EAST 1/8" = 1'-0"

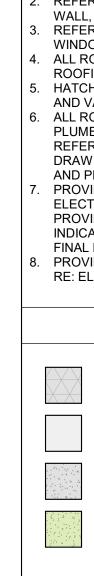


OVERALL ROOF - GENERAL NOTES

REFER TO G0.2X SHEETS FOR EXTERIOR AND INTERIOR

BUILDING ENCLOSURE ASSEMBLIES.
REFER TO A1.0X SHEETS FOR EXTERIOR WALL, DEMISING WALL, AND CORRIDOR WALL TYPES AND LOCATIONS.
REFER TO A1.1X SHEETS FOR INTERIOR AND EXTERIOR WINDOW/DOOR TAGS WITH UNIT BACKGROUNDS.
ALL ROOFS LABELED AS [NO SLOPE] SHALL BE EPDM ROOFING, SLOPED AT 1/4" = 1' - 0" U.N.O.
HATCHING INDICATES LOCATIONS OF SNOW MELT EAVE AND VALLEY PANELS, RE: ELECTRICAL DRAWINGS.
ALL ROOFTOP MECHANICAL, ELECTRICAL, AND/OR PLUMBING EQUIPMENT SHOWN FOR REFERENCE ONLY. REFER TO MECHANICAL, ELECTRICAL, AND/OR PLUMBING DRAWINGS AND SPECIFICATIONS FOR SPECIFIC DESIGN AND PRODUCT INFORMATION.

 PROVIDE WALKWAY PROTECTION TO MAJOR MECHANICAL, ELECTRICAL, AND PLUMBING EQUIPMENT AS REQUIRED TO PROVIDE SERVICE ACCESS. WALKWAY PROTECTION IS INDICATED AS A GENERAL LAYOUT AND MAY NOT SHOW FINAL LOCATIONS OF ALL EQUIPMENT.
 PROVIDE SNOW MELT AT ALL GUTTERS & DOWNSPOUTS. RE: ELECTRICAL

OVERALL ROOF - LEGEND

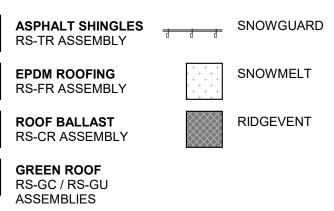

OVERALL PLAN - GENERAL NOTES

- 1. REFER TO G0.2X SHEETS FOR EXTERIOR AND INTERIOR BUILDING ENCLOSURE ASSEMBLIES.
- REFER TO A1.0X SHEETS FOR EXTERIOR WALL, DEMISING WALL, AND CORRIDOR WALL TYPES AND LOCATIONS.
 REFER TO A1.1X SHEETS FOR INTERIOR AND EXTERIOR
- WINDOW/DOOR TAGS WITH UNIT BACKGROUNDS. 4. REFER TO A6.0X SHEETS FOR INTERIOR AND EXTERIOR
- WINDOW/DOOR SCHEDULES AND LEGENDS. 5. ALIGN WALLS WHERE THEY APPEAR TO ALIGN, U.N.O.
- THE INSIDE FACE OF DOOR JAMBS SHALL BE 4" FROM ADJACENT WALL OR FINISHED COLUMN, U.N.O.
- SWING CLEARANCE AT UNIT ENTRY SHALL BE 18" MIN.
 FROM FINISH FACE OF ADJACENT SURFACE.
- 3. ALL DIMENSIONS ARE TO FACE OF STUD, GRID LINE, OR FACE OF CONCRETE, U.N.O.
- 9. ELECTRICAL METER AND SERVICE TO BE MOUNTED AT GARAGE LEVEL, COORDINATE METER AND PANEL
- LOCATION WITH OWNER. 0. ELECTRICAL CONTRACTOR SHALL PROVIDE DESIGN BUILD SECURITY SYSTEM, CORD. WITH OWNER.
- 11. WATER PIPES RUNNING NEXT TO OR WITHIN EXTERIOR WALLS TO BE INSULATED W/ 2" MIN CLOSED CELL INSULATION.
- CONTRACTOR SHALL COORDINATE ALL MEANS, METHODS, SEQUENCES PROCEDURES AND SCHEDULES OF ALL CONSTRUCTION ACTIVITIES AND OPERATIONS FOR THE CONSTRUCTION OF THE PROJECT.
 CONTRACTOR RESPONSIBLE FOR OBTAINING AND
- COMPLYING WITH ALL PERMITS. 14. CONTRACTOR RESPONSIBLE FOR COMPLYING WITH ALL MANUFACTURERS RECOMMENDATIONS FOR STORAGE,
- MANUFACTURERS RECOMMENDATIONS FOR STORAGE, PREPARATION, FABRICATION, INSTALLATION AND CURING OF MATERIALS AND SYSTEMS.



TOWN STAMP

1 RFI #129 06.27.24 1 RFI #129 06.27.24 1 1 1 1 <td< th=""><th>No.</th><th>Description</th><th>Date</th></td<>	No.	Description	Date
ISSUE DATE 03/15/2024 THE AMBLE ISSUE IFC SET SHEET TITLE FLOOR PLAN - LEVEL 02 - EAST	1	RFI #129	06.27.24
ISSUE DATE 03/15/2024 THE AMBLE ISSUE IFC SET SHEET TITLE FLOOR PLAN - LEVEL 02 - EAST			
ISSUE DATE 03/15/2024 THE AMBLE ISSUE IFC SET SHEET TITLE FLOOR PLAN - LEVEL 02 - EAST			
THE AMBLE ISSUE IFC SET SHEET TITLE FLOOR PLAN - LEVEL 02 - EAST	PROJECT N	UMBER	20019
IFC SET SHEET TITLE FLOOR PLAN - LEVEL 02 - EAST	ISSUE DATE		03/15/2024
IFC SET SHEET TITLE FLOOR PLAN - LEVEL 02 - EAST	ISSUE		
SHEET TITLE FLOOR PLAN - LEVEL 02 - EAST	1330E		
FLOOR PLAN - LEVEL 02 - EAST		II C SET	
- EAST	SHEET TITLI	=	
- EAST			
-	LOO	R PLAN - LE	VEL 02
-		- FAST	
SHEET NO.		- LAUI	
SHEET NO.			
SHEET NO.			
SHEET NO.			
	SHEET NO.		

A1.12.2






REFER TO G0.2X SHEETS FOR EXTERIOR AND INTERIOR

BUILDING ENCLOSURE ASSEMBLIES. REFER TO A1.0X SHEETS FOR EXTERIOR WALL, DEMISING WALL, AND CORRIDOR WALL TYPES AND LOCATIONS. REFER TO A1.1X SHEETS FOR INTERIOR AND EXTERIOR WINDOW/DOOR TAGS WITH UNIT BACKGROUNDS. ALL ROOFS LABELED AS [NO SLOPE] SHALL BE EPDM ROOFING, SLOPED AT 1/4" = 1' - 0" U.N.O. HATCHING INDICATES LOCATIONS OF SNOW MELT EAVE AND VALLEY PANELS, RE: ELECTRICAL DRAWINGS. ALL ROOFTOP MECHANICAL, ELECTRICAL, AND/OR PLUMBING EQUIPMENT SHOWN FOR REFERENCE ONLY. REFER TO MECHANICAL, ELECTRICAL, AND/OR PLUMBING DRAWINGS AND SPECIFICATIONS FOR SPECIFIC DESIGN

AND PRODUCT INFORMATION. PROVIDE WALKWAY PROTECTION TO MAJOR MECHANICAL, ELECTRICAL, AND PLUMBING EQUIPMENT AS REQUIRED TO PROVIDE SERVICE ACCESS. WALKWAY PROTECTION IS INDICATED AS A GENERAL LAYOUT AND MAY NOT SHOW FINAL LOCATIONS OF ALL EQUIPMENT. PROVIDE SNOW MELT AT ALL GUTTERS & DOWNSPOUTS. RE: ELECTRICAL

OVERALL ROOF - LEGEND

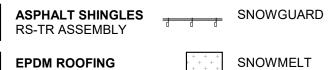

SNOWMELT

RIDGEVENT

ROOF BALLAST RS-CR ASSEMBLY

RS-FR ASSEMBLY

GREEN ROOF RS-GC / RS-GU ASSEMBLIES

- **OVERALL PLAN GENERAL NOTES**
- REFER TO G0.2X SHEETS FOR EXTERIOR AND INTERIOR BUILDING ENCLOSURE ASSEMBLIES.
- REFER TO A1.0X SHEETS FOR EXTERIOR WALL, DEMISING WALL, AND CORRIDOR WALL TYPES AND LOCATIONS.
- REFER TO A1.1X SHEETS FOR INTERIOR AND EXTERIOR WINDOW/DOOR TAGS WITH UNIT BACKGROUNDS. REFER TO A6.0X SHEETS FOR INTERIOR AND EXTERIOR
- WINDOW/DOOR SCHEDULES AND LEGENDS.
- ALIGN WALLS WHERE THEY APPEAR TO ALIGN, U.N.O. THE INSIDE FACE OF DOOR JAMBS SHALL BE 4" FROM
- ADJACENT WALL OR FINISHED COLUMN, U.N.O. SWING CLEARANCE AT UNIT ENTRY SHALL BE 18" MIN. FROM FINISH FACE OF ADJACENT SURFACE.
- ALL DIMENSIONS ARE TO FACE OF STUD, GRID LINE, OR FACE OF CONCRETE, U.N.O. ELECTRICAL METER AND SERVICE TO BE MOUNTED AT
- GARAGE LEVEL, COORDINATE METER AND PANEL LOCATION WITH OWNER. 0. ELECTRICAL CONTRACTOR SHALL PROVIDE DESIGN BUILD
- SECURITY SYSTEM, CORD. WITH OWNER. . WATER PIPES RUNNING NEXT TO OR WITHIN EXTERIOR WALLS TO BE INSULATED W/ 2" MIN CLOSED CELL
- INSULATION. 2. CONTRACTOR SHALL COORDINATE ALL MEANS, METHODS, SEQUENCES PROCEDURES AND SCHEDULES OF ALL CONSTRUCTION ACTIVITIES AND OPERATIONS FOR THE CONSTRUCTION OF THE PROJECT.
- 13. CONTRACTOR RESPONSIBLE FOR OBTAINING AND COMPLYING WITH ALL PERMITS. 4. CONTRACTOR RESPONSIBLE FOR COMPLYING WITH ALL
- MANUFACTURERS RECOMMENDATIONS FOR STORAGE, PREPARATION, FABRICATION, INSTALLATION AND CURING OF MATERIALS AND SYSTEMS.


TOWN STAMP **359** Design 3630 OSAGE STREET DENVER, CO 80211 720.512.3437 B-2465 12/15/2023 ED ARC Ð q L No. Description Date PROJECT NUMBER ISSUE DATE THE AMBLE IFC SET

FLOOR PLAN - LEVEL 03 - WEST

SHEET NO.

A1.13.1

SHEET TITLE

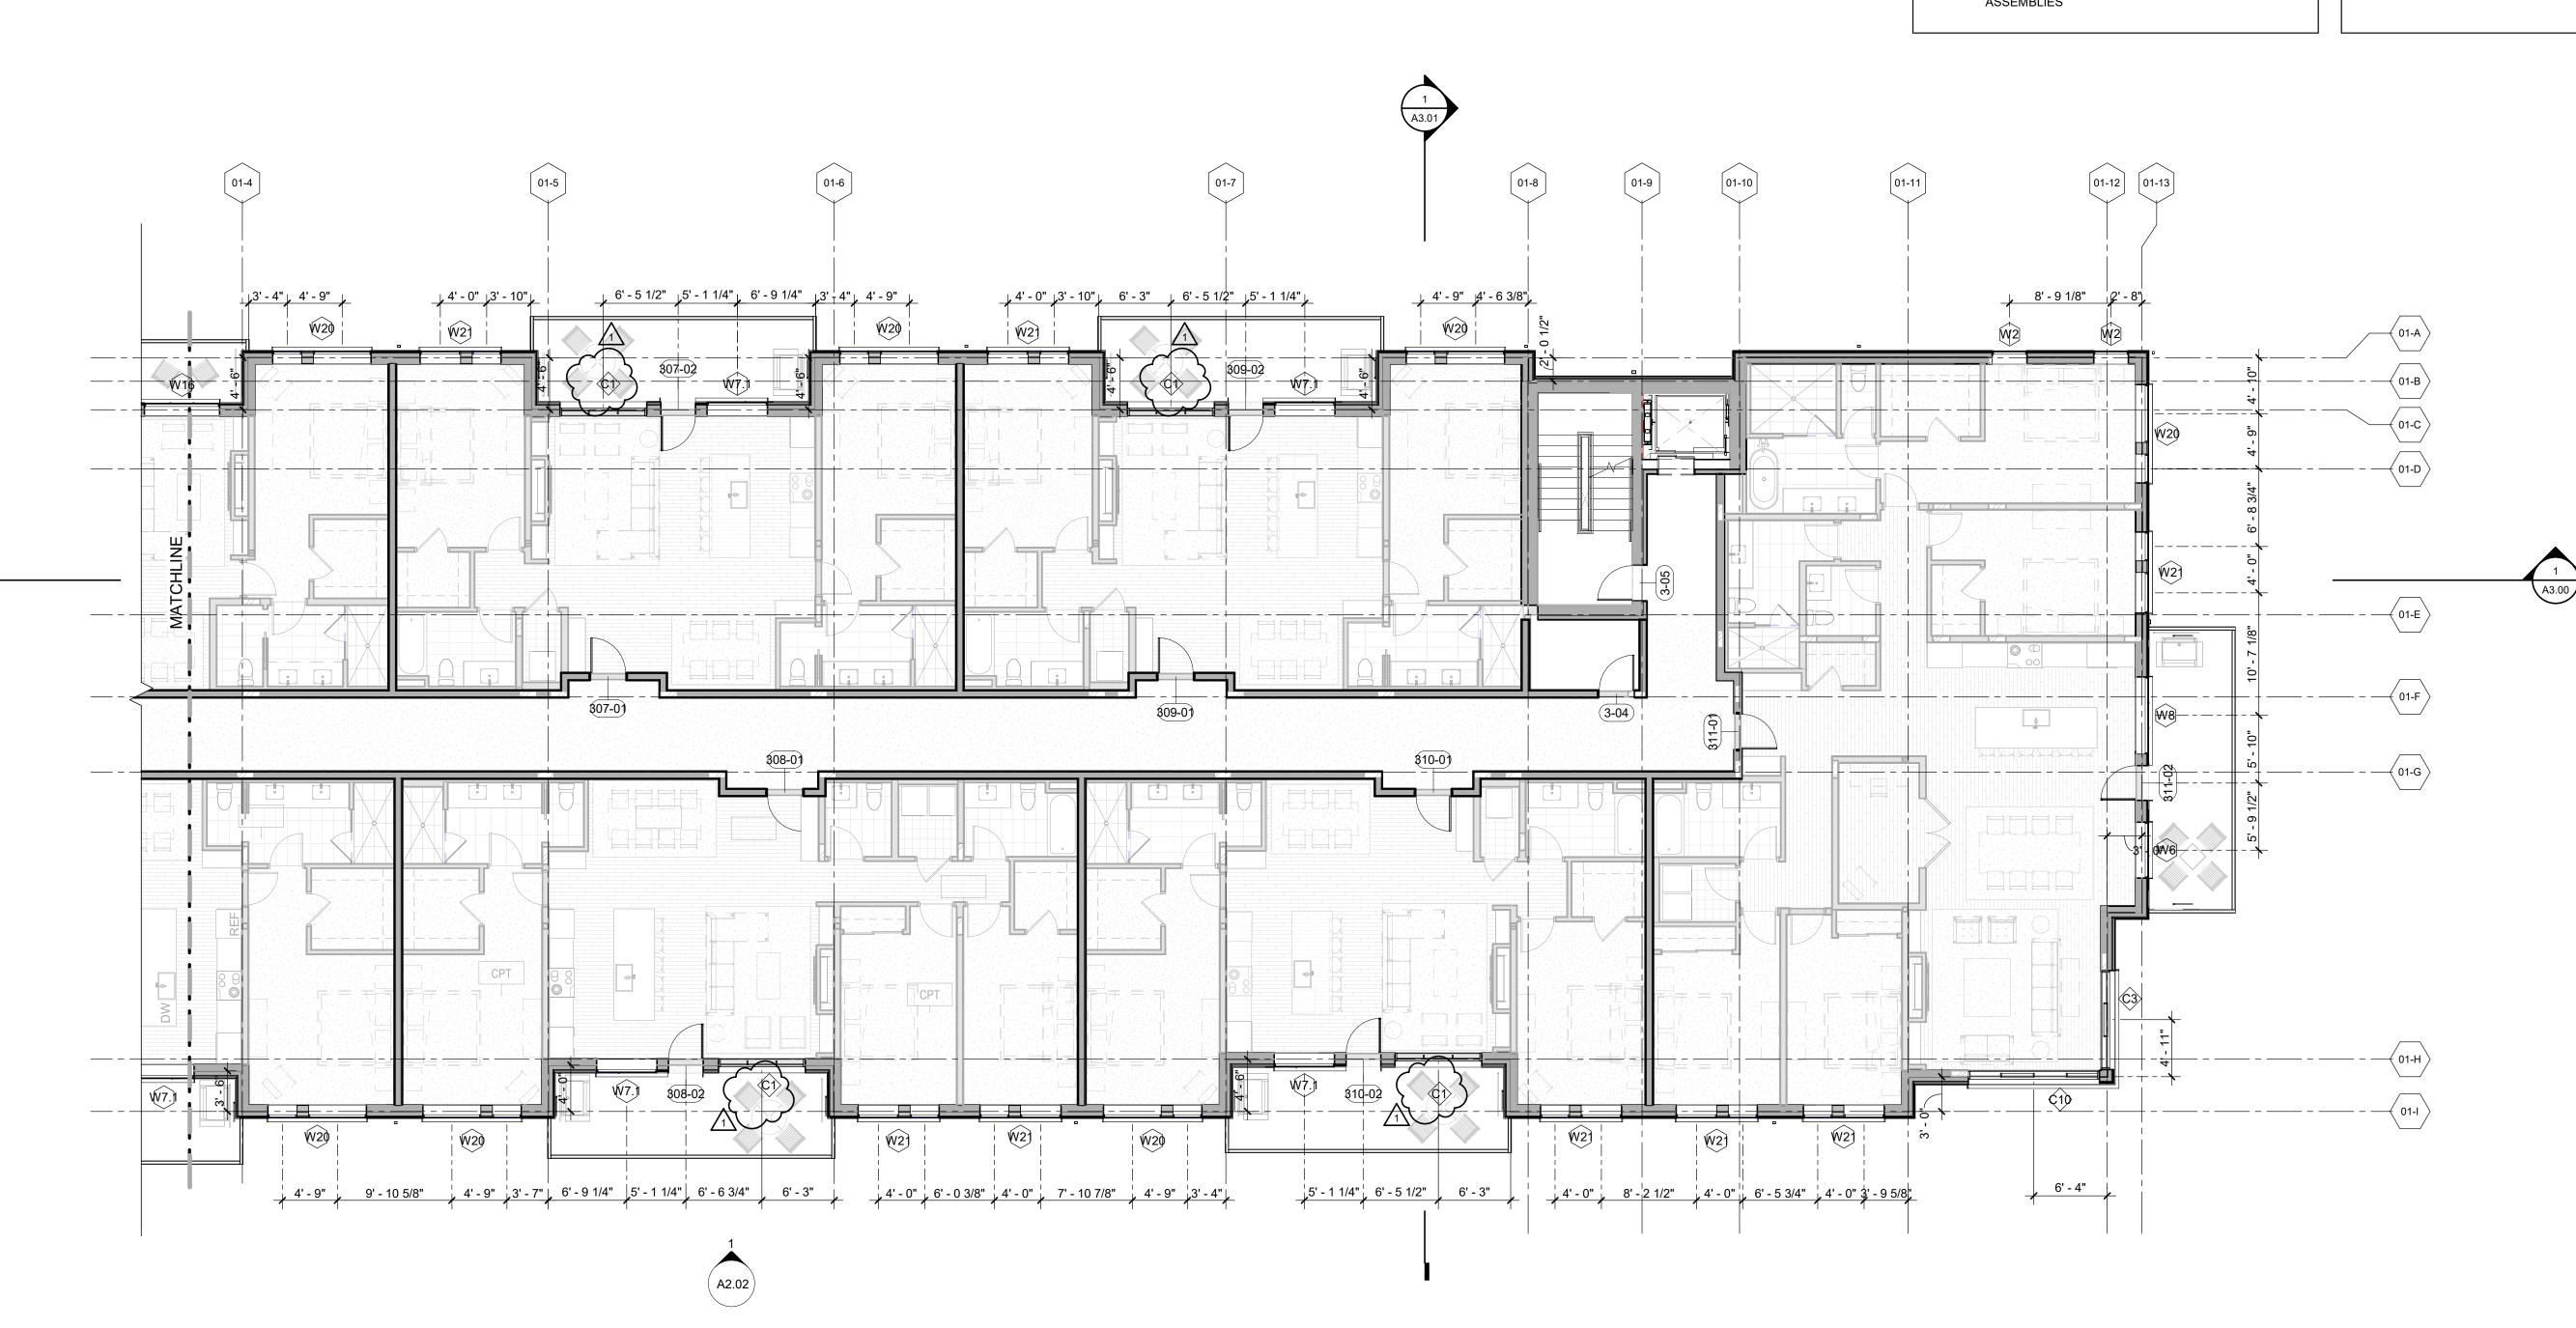

1 FLOOR PLAN - LEVEL 03 - EAST


OVERALL ROOF - GENERAL NOTES

REFER TO G0.2X SHEETS FOR EXTERIOR AND INTERIOR

BUILDING ENCLOSURE ASSEMBLIES.
REFER TO A1.0X SHEETS FOR EXTERIOR WALL, DEMISING WALL, AND CORRIDOR WALL TYPES AND LOCATIONS.
REFER TO A1.1X SHEETS FOR INTERIOR AND EXTERIOR WINDOW/DOOR TAGS WITH UNIT BACKGROUNDS.
ALL ROOFS LABELED AS [NO SLOPE] SHALL BE EPDM ROOFING, SLOPED AT 1/4" = 1' - 0" U.N.O.
HATCHING INDICATES LOCATIONS OF SNOW MELT EAVE AND VALLEY PANELS, RE: ELECTRICAL DRAWINGS.
ALL ROOFTOP MECHANICAL, ELECTRICAL, AND/OR PLUMBING EQUIPMENT SHOWN FOR REFERENCE ONLY. REFER TO MECHANICAL, ELECTRICAL, AND/OR PLUMBING DRAWINGS AND SPECIFICATIONS FOR SPECIFIC DESIGN AND PRODUCT INFORMATION.

 PROVIDE WALKWAY PROTECTION TO MAJOR MECHANICAL, ELECTRICAL, AND PLUMBING EQUIPMENT AS REQUIRED TO PROVIDE SERVICE ACCESS. WALKWAY PROTECTION IS INDICATED AS A GENERAL LAYOUT AND MAY NOT SHOW FINAL LOCATIONS OF ALL EQUIPMENT.
 PROVIDE SNOW MELT AT ALL GUTTERS & DOWNSPOUTS. RE: ELECTRICAL

OVERALL ROOF - LEGEND

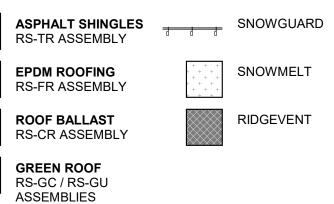

OVERALL PLAN - GENERAL NOTES

- 1. REFER TO G0.2X SHEETS FOR EXTERIOR AND INTERIOR BUILDING ENCLOSURE ASSEMBLIES.
- 2. REFER TO A1.0X SHEETS FOR EXTERIOR WALL, DEMISING WALL, AND CORRIDOR WALL TYPES AND LOCATIONS.
- REFER TO A1.1X SHEETS FOR INTERIOR AND EXTERIOR WINDOW/DOOR TAGS WITH UNIT BACKGROUNDS.
 REFER TO A6.0X SHEETS FOR INTERIOR AND EXTERIOR
- WINDOW/DOOR SCHEDULES AND LEGENDS. 5. ALIGN WALLS WHERE THEY APPEAR TO ALIGN, U.N.O.
- THE INSIDE FACE OF DOOR JAMBS SHALL BE 4" FROM ADJACENT WALL OR FINISHED COLUMN, U.N.O.
- 7. SWING CLEARANCE AT UNIT ENTRY SHALL BE 18" MIN. FROM FINISH FACE OF ADJACENT SURFACE.
- ALL DIMENSIONS ARE TO FACE OF STUD, GRID LINE, OR FACE OF CONCRETE, U.N.O.
 ELECTRICAL METER AND SERVICE TO BE MOUNTED AT
- GARAGE LEVEL, COORDINATE METER AND PANEL LOCATION WITH OWNER. 0. ELECTRICAL CONTRACTOR SHALL PROVIDE DESIGN BUILD
- SECURITY SYSTEM, CORD. WITH OWNER. 11. WATER PIPES RUNNING NEXT TO OR WITHIN EXTERIOR WALLS TO BE INSULATED W/ 2" MIN CLOSED CELL
- INSULATION. 12. CONTRACTOR SHALL COORDINATE ALL MEANS, METHODS, SEQUENCES PROCEDURES AND SCHEDULES OF ALL CONSTRUCTION ACTIVITIES AND OPERATIONS FOR THE CONSTRUCTION OF THE PROJECT.
- CONTRACTOR RESPONSIBLE FOR OBTAINING AND COMPLYING WITH ALL PERMITS.
 CONTRACTOR RESPONSIBLE FOR COMPLYING WITH ALL
- MANUFACTURERS RECOMMENDATIONS FOR STORAGE, PREPARATION, FABRICATION, INSTALLATION AND CURING OF MATERIALS AND SYSTEMS.

Creamboat Springs, CO

TOWN STAMP

359

DESIGN

3630 OSAGE STREET DENVER, CO 80211 720.512.3437

 No.
 Description
 Date

 1
 RFI#129
 06.27.24

 1
 06.27.24

 1
 01.000

 1
 02.01

 1
 02.01

 1
 02.01

 1
 02.01

 1
 02.01

 1
 03.15/2024

 1
 03.15/2024

 1
 IFC SET


 1
 IFC SET

 1
 IFC SET

 1
 SHEET TITLE

SHEET NO.

A1.13.2

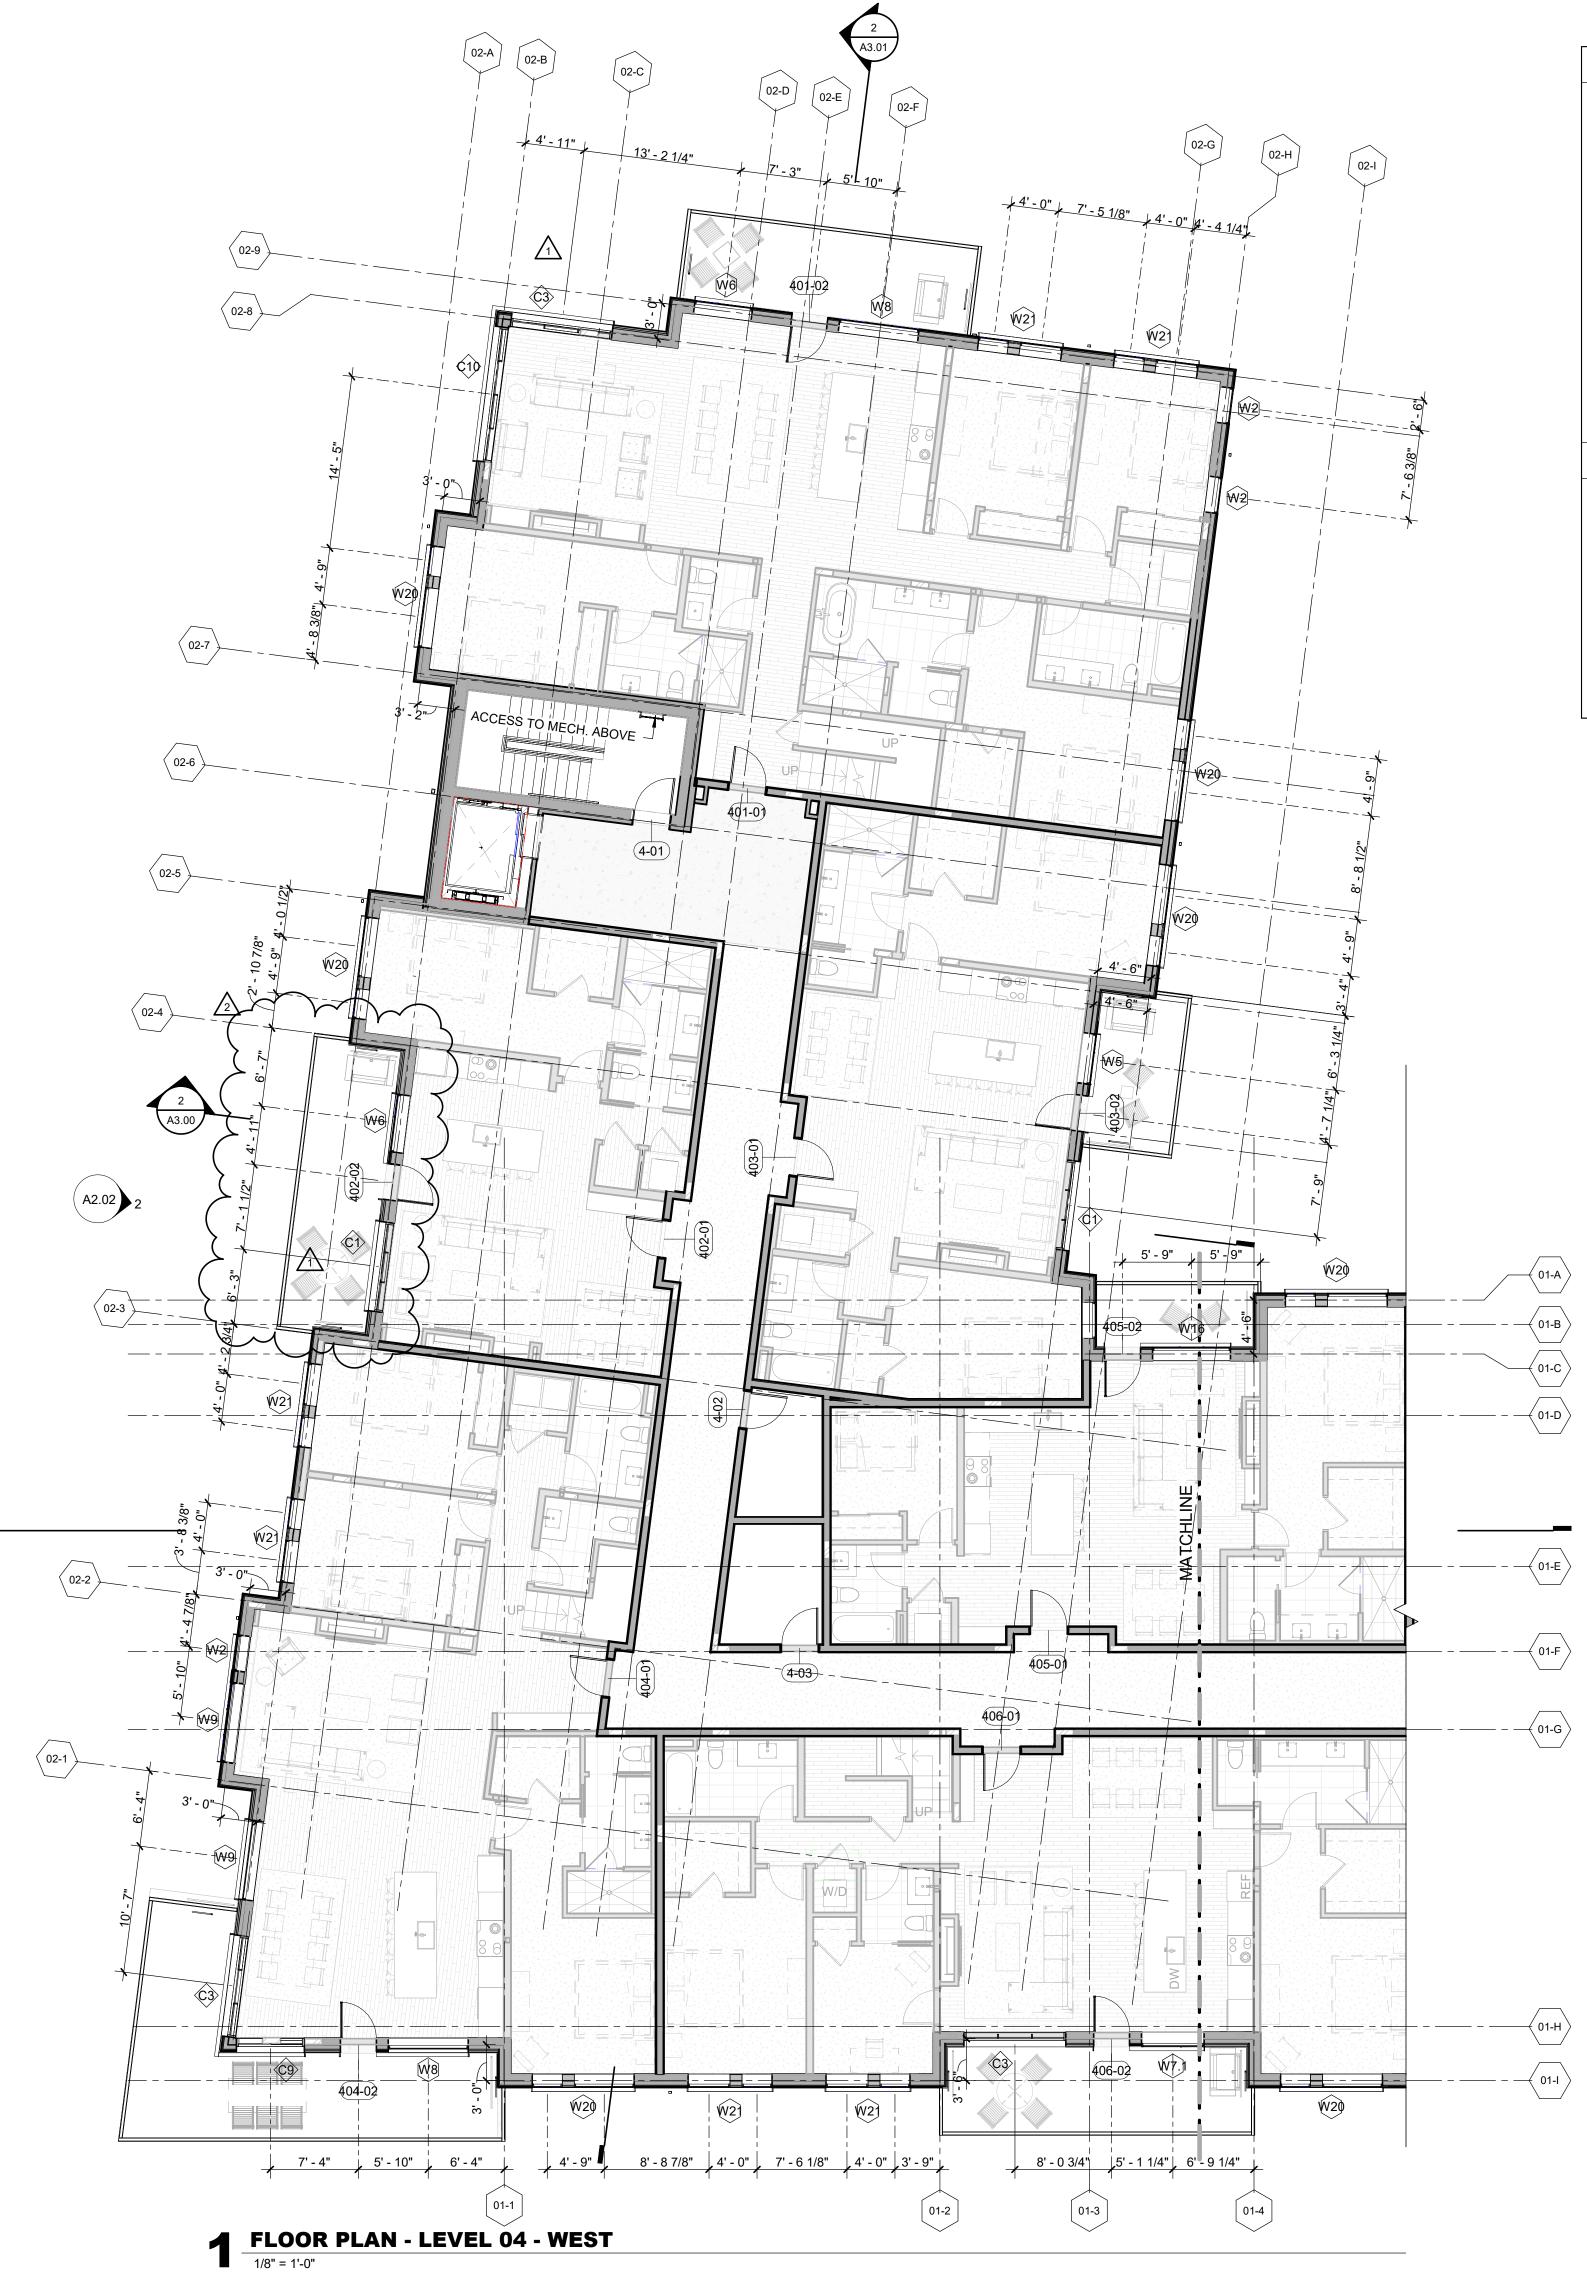

A3.00

OVERALL ROOF - GENERAL NOTES

REFER TO G0.2X SHEETS FOR EXTERIOR AND INTERIOR

BUILDING ENCLOSURE ASSEMBLIES. REFER TO A1.0X SHEETS FOR EXTERIOR WALL, DEMISING WALL, AND CORRIDOR WALL TYPES AND LOCATIONS. REFER TO A1.1X SHEETS FOR INTERIOR AND EXTERIOR WINDOW/DOOR TAGS WITH UNIT BACKGROUNDS. ALL ROOFS LABELED AS [NO SLOPE] SHALL BE EPDM ROOFING, SLOPED AT 1/4" = 1' - 0" U.N.O. HATCHING INDICATES LOCATIONS OF SNOW MELT EAVE AND VALLEY PANELS, RE: ELECTRICAL DRAWINGS. ALL ROOFTOP MECHANICAL, ELECTRICAL, AND/OR PLUMBING EQUIPMENT SHOWN FOR REFERENCE ONLY. REFER TO MECHANICAL, ELECTRICAL, AND/OR PLUMBING DRAWINGS AND SPECIFICATIONS FOR SPECIFIC DESIGN

AND PRODUCT INFORMATION. PROVIDE WALKWAY PROTECTION TO MAJOR MECHANICAL, ELECTRICAL, AND PLUMBING EQUIPMENT AS REQUIRED TO PROVIDE SERVICE ACCESS. WALKWAY PROTECTION IS INDICATED AS A GENERAL LAYOUT AND MAY NOT SHOW FINAL LOCATIONS OF ALL EQUIPMENT. PROVIDE SNOW MELT AT ALL GUTTERS & DOWNSPOUTS. RE: ELECTRICAL

SNOWMELT

RIDGEVENT

OVERALL ROOF - LEGEND

- ASPHALT SHINGLES SNOWGUARD RS-TR ASSEMBLY
- EPDM ROOFING RS-FR ASSEMBLY
- ROOF BALLAST

RS-CR ASSEMBLY

GREEN ROOF RS-GC / RS-GU ASSEMBLIES

- **OVERALL PLAN GENERAL NOTES**
- REFER TO G0.2X SHEETS FOR EXTERIOR AND INTERIOR BUILDING ENCLOSURE ASSEMBLIES.
- REFER TO A1.0X SHEETS FOR EXTERIOR WALL, DEMISING WALL, AND CORRIDOR WALL TYPES AND LOCATIONS.
- REFER TO A1.1X SHEETS FOR INTERIOR AND EXTERIOR WINDOW/DOOR TAGS WITH UNIT BACKGROUNDS. REFER TO A6.0X SHEETS FOR INTERIOR AND EXTERIOR
- WINDOW/DOOR SCHEDULES AND LEGENDS.
- ALIGN WALLS WHERE THEY APPEAR TO ALIGN, U.N.O. THE INSIDE FACE OF DOOR JAMBS SHALL BE 4" FROM
- ADJACENT WALL OR FINISHED COLUMN, U.N.O. SWING CLEARANCE AT UNIT ENTRY SHALL BE 18" MIN. FROM FINISH FACE OF ADJACENT SURFACE.
- ALL DIMENSIONS ARE TO FACE OF STUD, GRID LINE, OR FACE OF CONCRETE, U.N.O.
- ELECTRICAL METER AND SERVICE TO BE MOUNTED AT GARAGE LEVEL, COORDINATE METER AND PANEL
- LOCATION WITH OWNER. 0. ELECTRICAL CONTRACTOR SHALL PROVIDE DESIGN BUILD SECURITY SYSTEM, CORD. WITH OWNER.
- 1. WATER PIPES RUNNING NEXT TO OR WITHIN EXTERIOR WALLS TO BE INSULATED W/ 2" MIN CLOSED CELL INSULATION.
- 2. CONTRACTOR SHALL COORDINATE ALL MEANS, METHODS, SEQUENCES PROCEDURES AND SCHEDULES OF ALL CONSTRUCTION ACTIVITIES AND OPERATIONS FOR THE CONSTRUCTION OF THE PROJECT.
- 13. CONTRACTOR RESPONSIBLE FOR OBTAINING AND COMPLYING WITH ALL PERMITS. 4. CONTRACTOR RESPONSIBLE FOR COMPLYING WITH ALL
- MANUFACTURERS RECOMMENDATIONS FOR STORAGE, PREPARATION, FABRICATION, INSTALLATION AND CURING OF MATERIALS AND SYSTEMS.

0 q

TOWN STAMP

359 Design


3630 OSAGE STREET DENVER, CO 80211 720.512.3437

B-2465


12/15/2023

SED ARCT

N	Decembration	Data
No.	Description	06.27.24
	RFI #154	07.03.24
ROJECT		20019
SUE DAT	E	03/15/2024
SUE		
SUE	IFC SET	
SSUE SHEET TITI		VEL 0
SHEET TITI	E	VEL 0

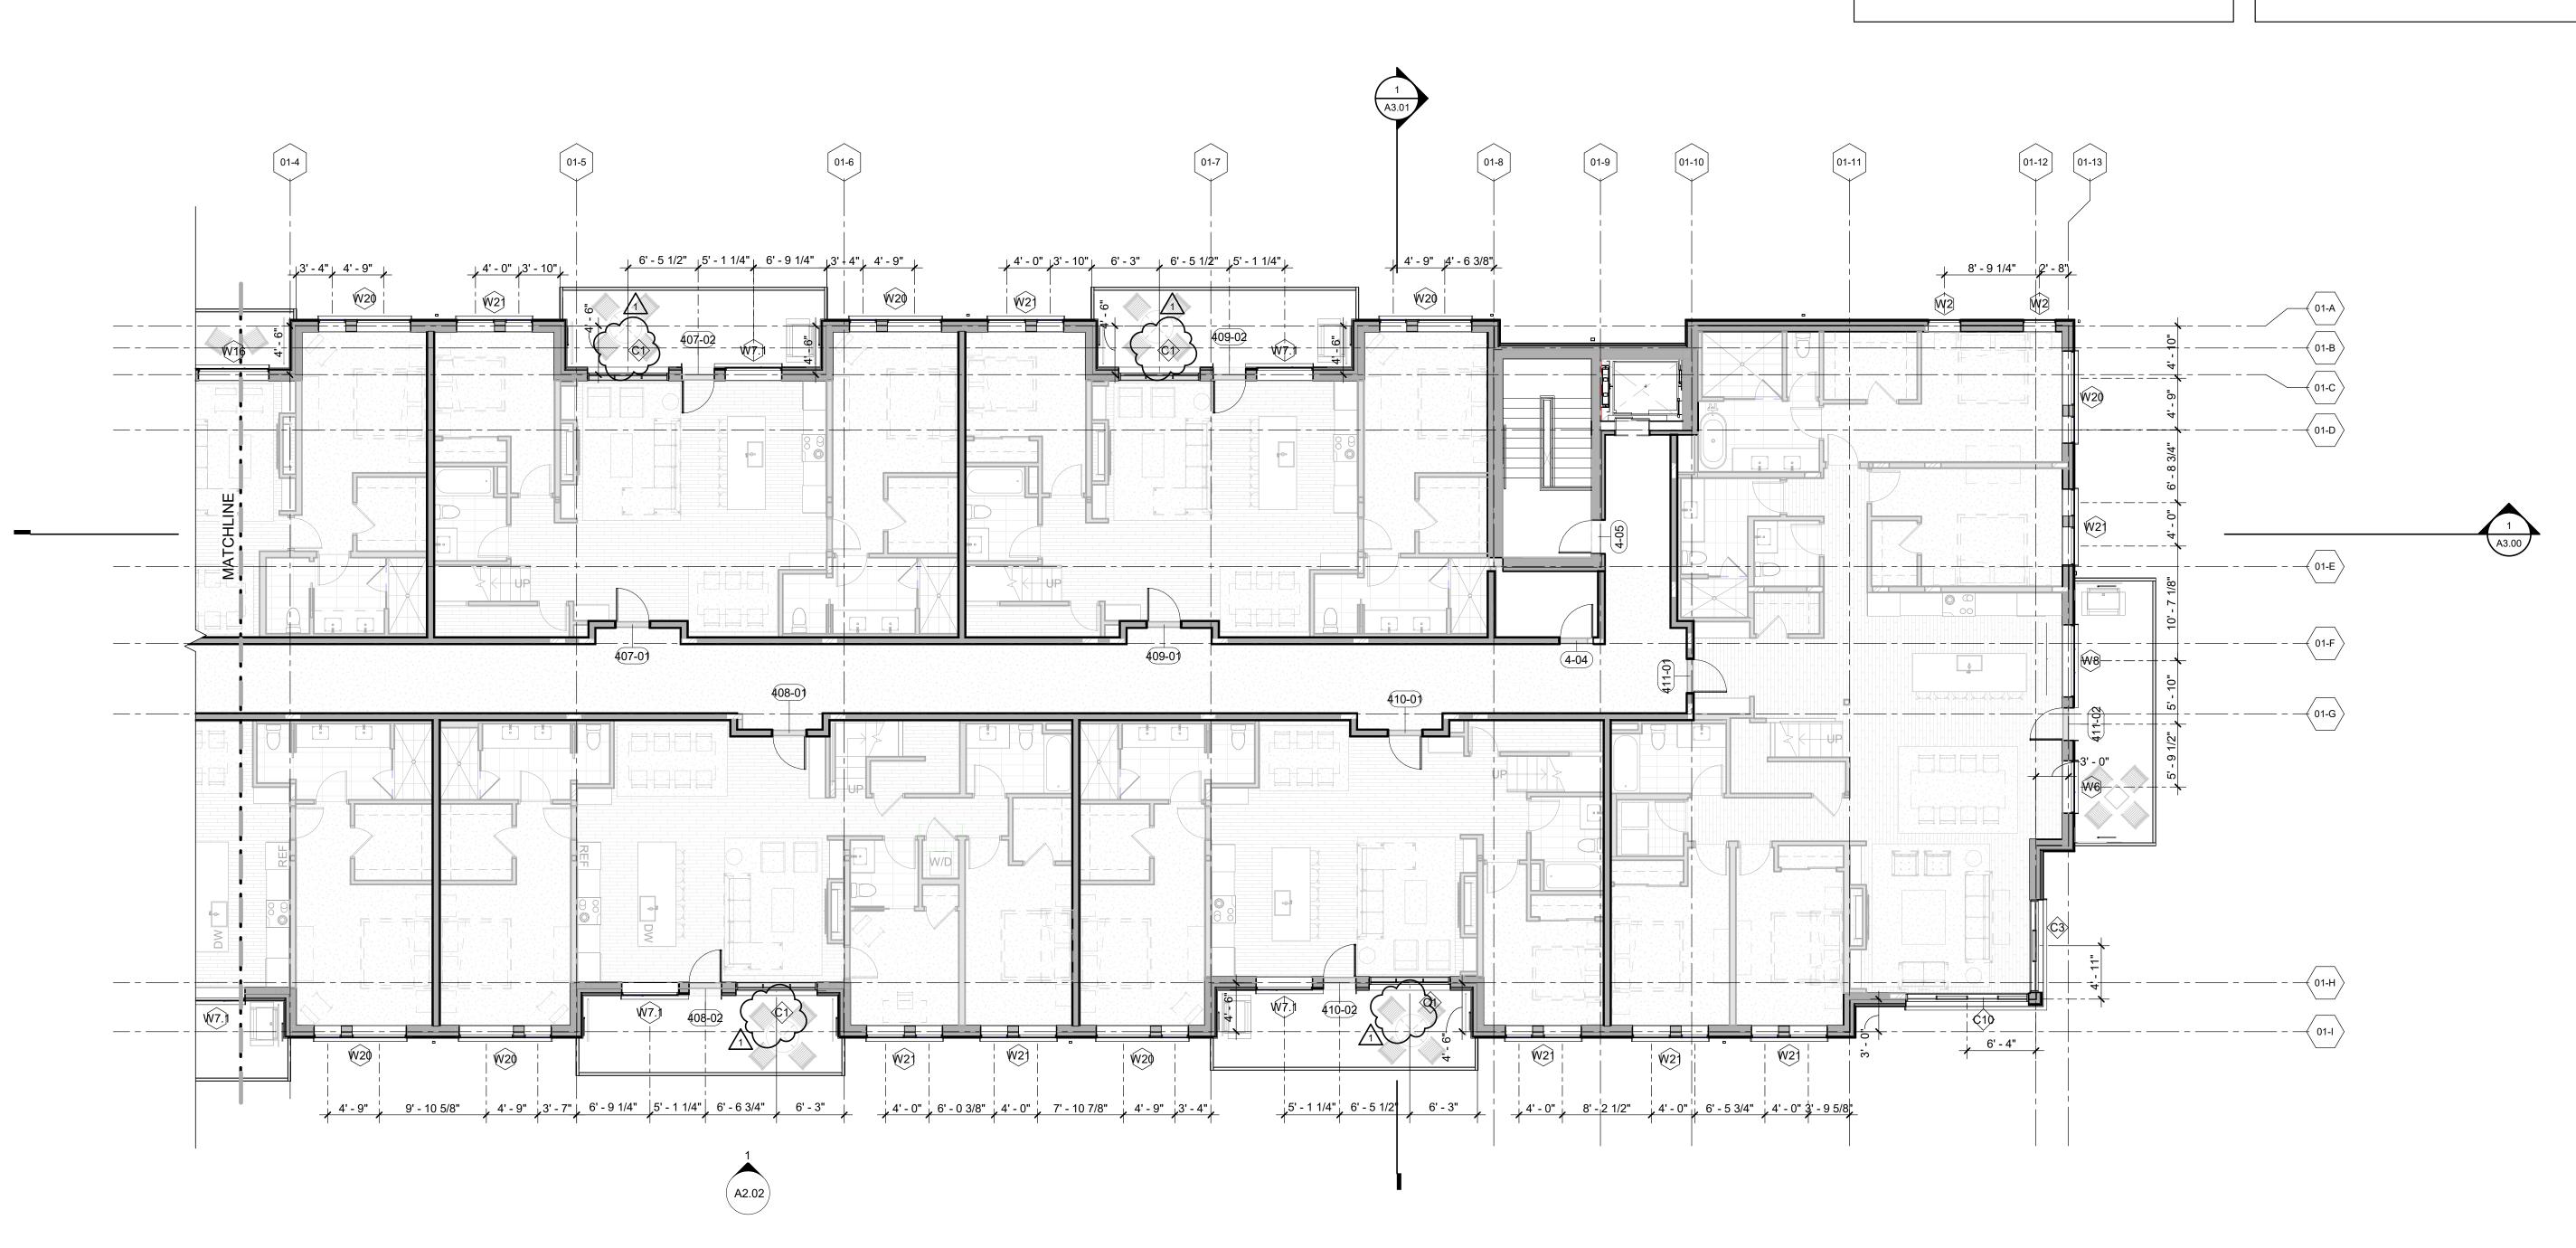

FLOOR PLAN - LEVEL 04 - EAST 1/8" = 1'-0"

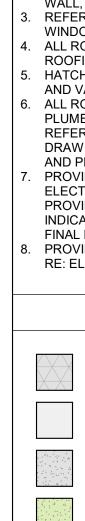


OVERALL ROOF - GENERAL NOTES

REFER TO G0.2X SHEETS FOR EXTERIOR AND INTERIOR

BUILDING ENCLOSURE ASSEMBLIES.
REFER TO A1.0X SHEETS FOR EXTERIOR WALL, DEMISING WALL, AND CORRIDOR WALL TYPES AND LOCATIONS.
REFER TO A1.1X SHEETS FOR INTERIOR AND EXTERIOR WINDOW/DOOR TAGS WITH UNIT BACKGROUNDS.
ALL ROOFS LABELED AS [NO SLOPE] SHALL BE EPDM ROOFING, SLOPED AT 1/4" = 1' - 0" U.N.O.
HATCHING INDICATES LOCATIONS OF SNOW MELT EAVE AND VALLEY PANELS, RE: ELECTRICAL DRAWINGS.
ALL ROOFTOP MECHANICAL, ELECTRICAL, AND/OR PLUMBING EQUIPMENT SHOWN FOR REFERENCE ONLY. REFER TO MECHANICAL, ELECTRICAL, AND/OR PLUMBING DRAWINGS AND SPECIFICATIONS FOR SPECIFIC DESIGN AND PRODUCT INFORMATION.


 PROVIDE WALKWAY PROTECTION TO MAJOR MECHANICAL, ELECTRICAL, AND PLUMBING EQUIPMENT AS REQUIRED TO PROVIDE SERVICE ACCESS. WALKWAY PROTECTION IS INDICATED AS A GENERAL LAYOUT AND MAY NOT SHOW FINAL LOCATIONS OF ALL EQUIPMENT.
 PROVIDE SNOW MELT AT ALL GUTTERS & DOWNSPOUTS. RE: ELECTRICAL


OVERALL ROOF - LEGEND

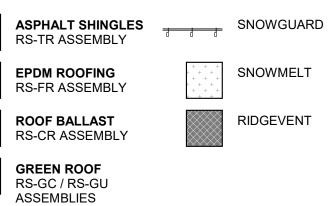

OVERALL PLAN - GENERAL NOTES

- 1. REFER TO G0.2X SHEETS FOR EXTERIOR AND INTERIOR BUILDING ENCLOSURE ASSEMBLIES.
- 2. REFER TO A1.0X SHEETS FOR EXTERIOR WALL, DEMISING WALL, AND CORRIDOR WALL TYPES AND LOCATIONS.
- REFER TO A1.1X SHEETS FOR INTERIOR AND EXTERIOR WINDOW/DOOR TAGS WITH UNIT BACKGROUNDS.
 REFER TO A6.0X SHEETS FOR INTERIOR AND EXTERIOR
- WINDOW/DOOR SCHEDULES AND LEGENDS. 5. ALIGN WALLS WHERE THEY APPEAR TO ALIGN, U.N.O.
- 6. THE INSIDE FACE OF DOOR JAMBS SHALL BE 4" FROM
- ADJACENT WALL OR FINISHED COLUMN, U.N.O. SWING CLEARANCE AT UNIT ENTRY SHALL BE 18" MIN. FROM FINISH FACE OF ADJACENT SURFACE.
- 3. ALL DIMENSIONS ARE TO FACE OF STUD, GRID LINE, OR FACE OF CONCRETE, U.N.O.
- ELECTRICAL METER AND SERVICE TO BE MOUNTED AT GARAGE LEVEL, COORDINATE METER AND PANEL
- LOCATION WITH OWNER. 0. ELECTRICAL CONTRACTOR SHALL PROVIDE DESIGN BUILD SECURITY SYSTEM, CORD. WITH OWNER.
- 11. WATER PIPES RUNNING NEXT TO OR WITHIN EXTERIOR WALLS TO BE INSULATED W/ 2" MIN CLOSED CELL INSULATION.
- CONTRACTOR SHALL COORDINATE ALL MEANS, METHODS, SEQUENCES PROCEDURES AND SCHEDULES OF ALL CONSTRUCTION ACTIVITIES AND OPERATIONS FOR THE CONSTRUCTION OF THE PROJECT.
 CONTRACTOR RESPONSIBLE FOR OBTAINING AND
- COMPLYING WITH ALL PERMITS. 14. CONTRACTOR RESPONSIBLE FOR COMPLYING WITH ALL MANUFACTURERS RECOMMENDATIONS FOR STORAGE,
- PREPARATION, FABRICATION, INSTALLATION AND CURING OF MATERIALS AND SYSTEMS.

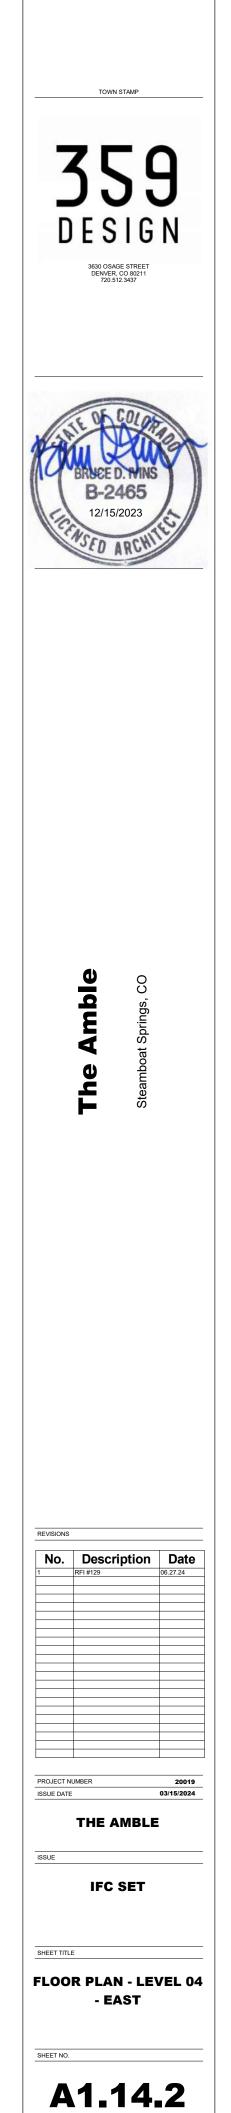

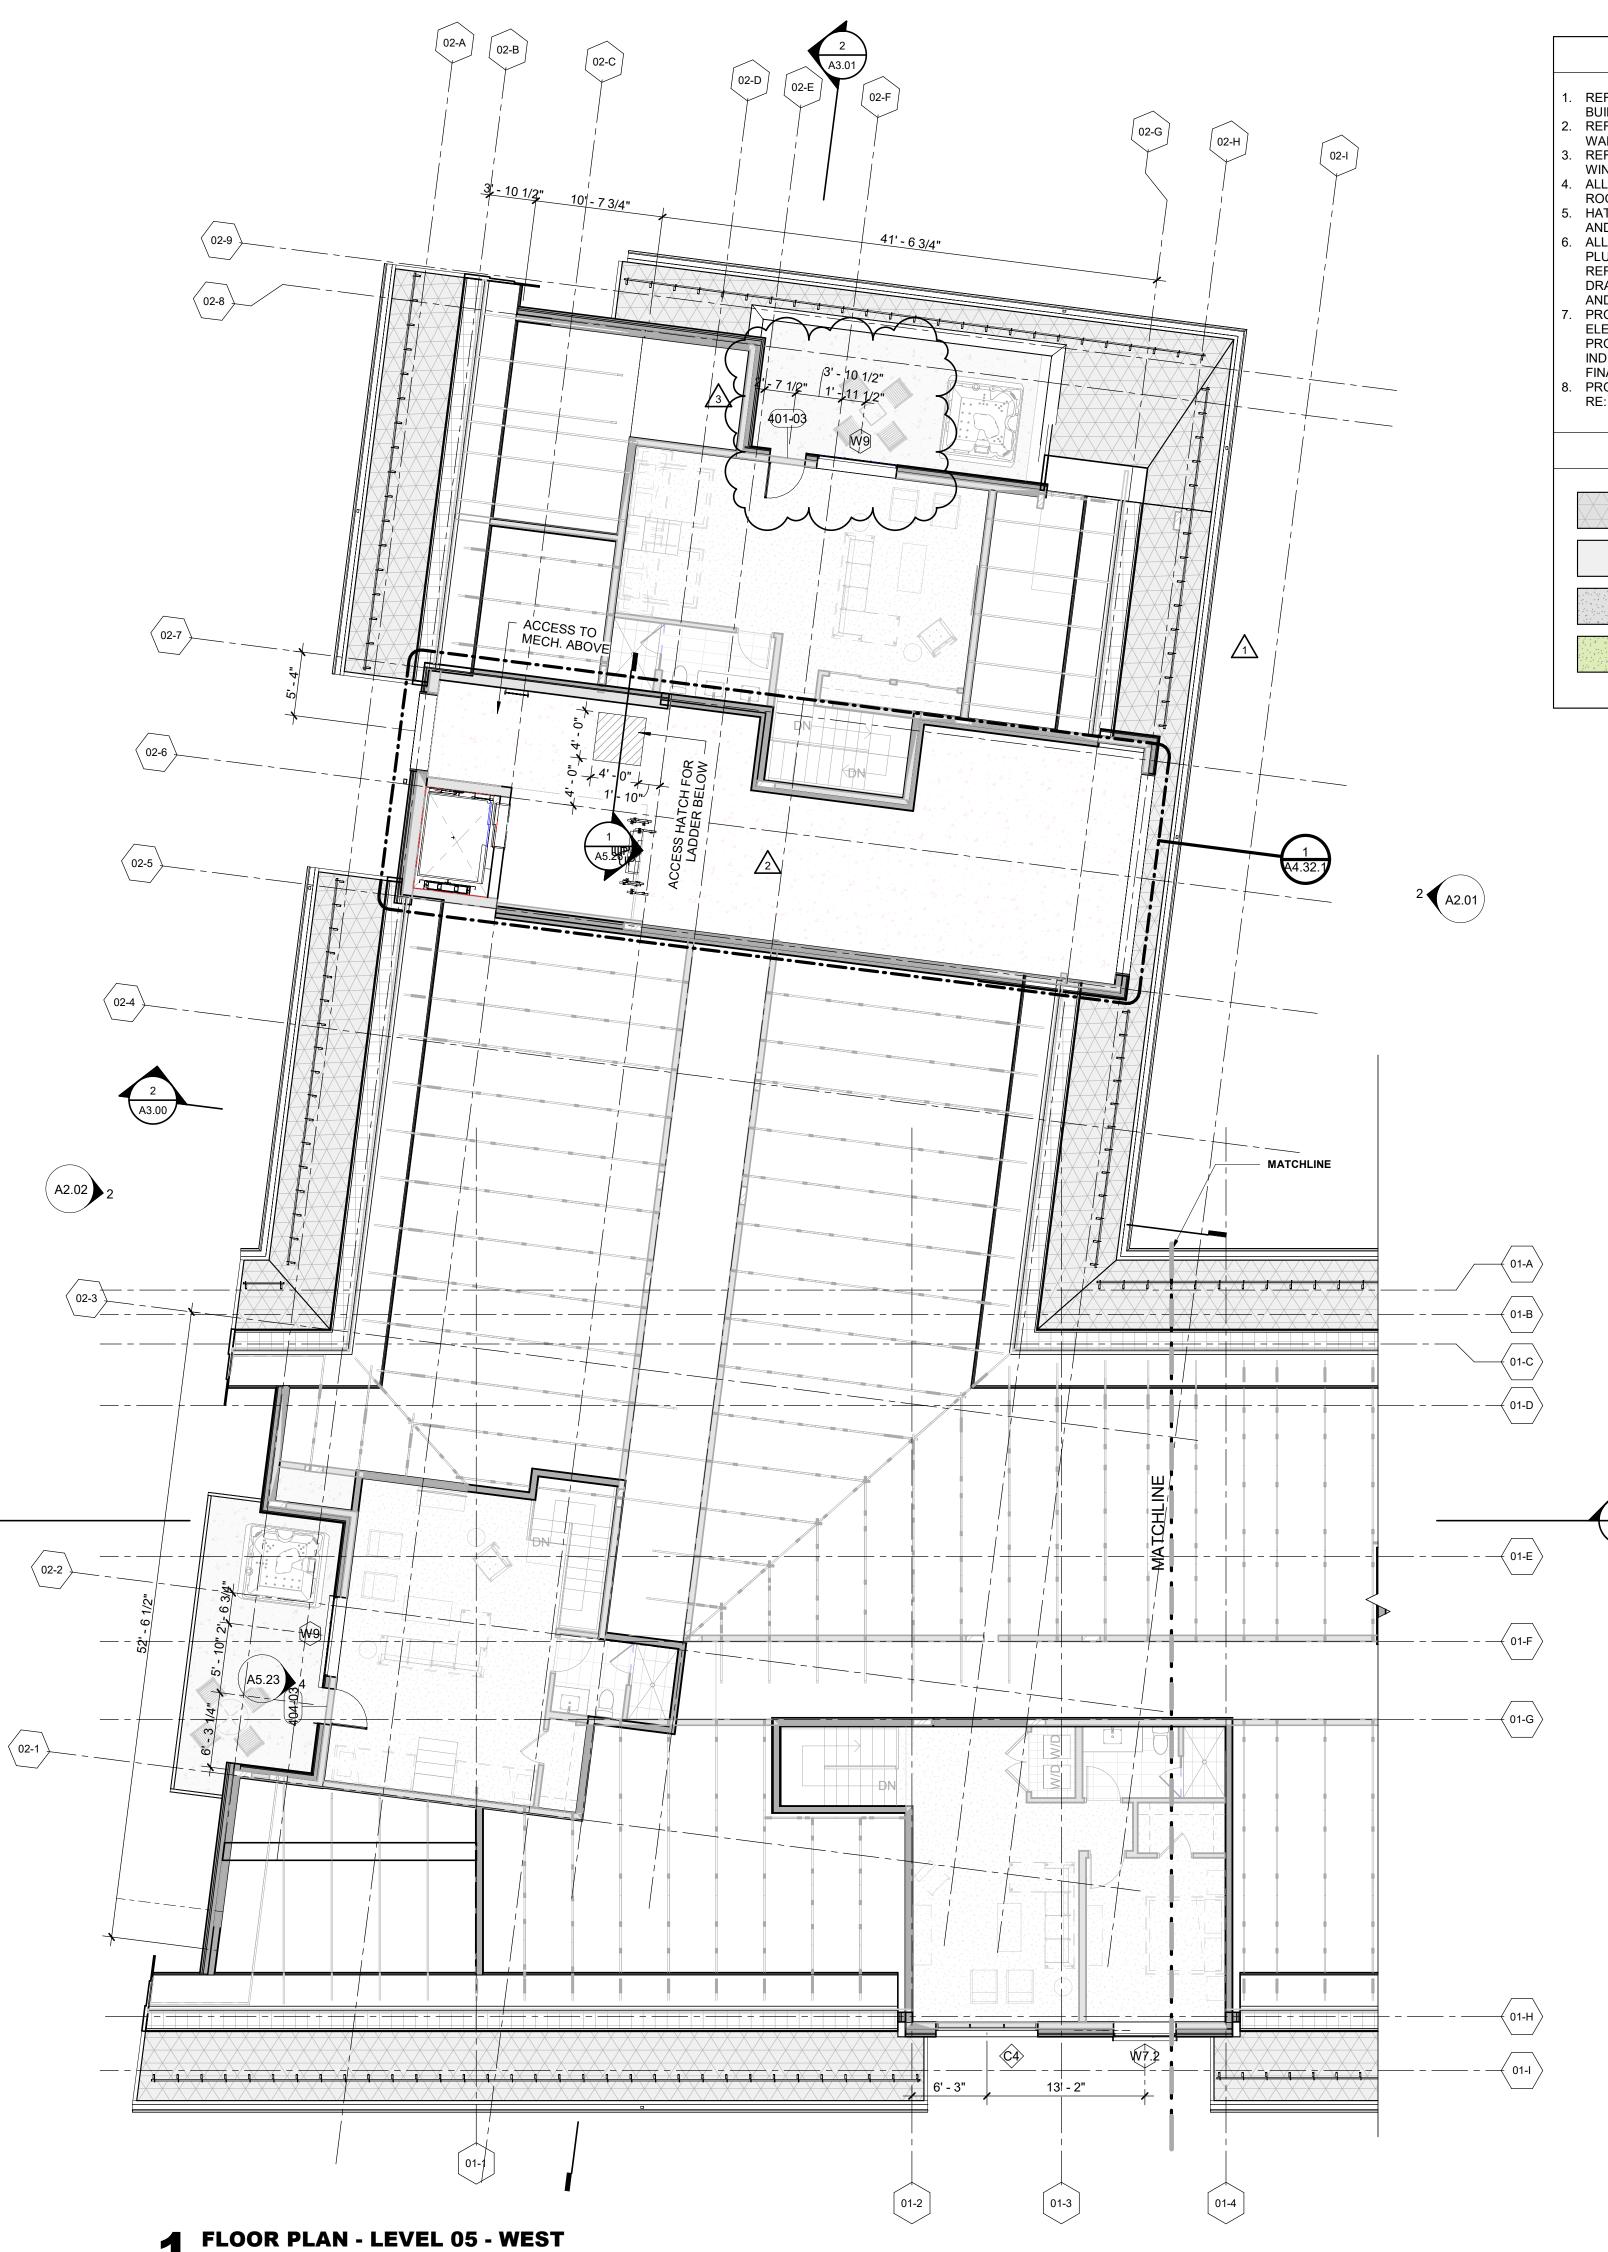




REFER TO G0.2X SHEETS FOR EXTERIOR AND INTERIOR

BUILDING ENCLOSURE ASSEMBLIES. REFER TO A1.0X SHEETS FOR EXTERIOR WALL, DEMISING WALL, AND CORRIDOR WALL TYPES AND LOCATIONS. REFER TO A1.1X SHEETS FOR INTERIOR AND EXTERIOR WINDOW/DOOR TAGS WITH UNIT BACKGROUNDS. ALL ROOFS LABELED AS [NO SLOPE] SHALL BE EPDM ROOFING, SLOPED AT 1/4" = 1' - 0" U.N.O. HATCHING INDICATES LOCATIONS OF SNOW MELT EAVE AND VALLEY PANELS, RE: ELECTRICAL DRAWINGS. ALL ROOFTOP MECHANICAL, ELECTRICAL, AND/OR PLUMBING EQUIPMENT SHOWN FOR REFERENCE ONLY. REFER TO MECHANICAL, ELECTRICAL, AND/OR PLUMBING DRAWINGS AND SPECIFICATIONS FOR SPECIFIC DESIGN AND PRODUCT INFORMATION.

PROVIDE WALKWAY PROTECTION TO MAJOR MECHANICAL, ELECTRICAL, AND PLUMBING EQUIPMENT AS REQUIRED TO PROVIDE SERVICE ACCESS. WALKWAY PROTECTION IS INDICATED AS A GENERAL LAYOUT AND MAY NOT SHOW FINAL LOCATIONS OF ALL EQUIPMENT. PROVIDE SNOW MELT AT ALL GUTTERS & DOWNSPOUTS. RE: ELECTRICAL

OVERALL ROOF - LEGEND

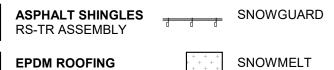

SNOWMELT

RIDGEVENT

ROOF BALLAST RS-CR ASSEMBLY

RS-FR ASSEMBLY

GREEN ROOF RS-GC / RS-GU ASSEMBLIES

- **OVERALL PLAN GENERAL NOTES**
- REFER TO G0.2X SHEETS FOR EXTERIOR AND INTERIOR BUILDING ENCLOSURE ASSEMBLIES.
- REFER TO A1.0X SHEETS FOR EXTERIOR WALL, DEMISING WALL, AND CORRIDOR WALL TYPES AND LOCATIONS.
- REFER TO A1.1X SHEETS FOR INTERIOR AND EXTERIOR WINDOW/DOOR TAGS WITH UNIT BACKGROUNDS. REFER TO A6.0X SHEETS FOR INTERIOR AND EXTERIOR
- WINDOW/DOOR SCHEDULES AND LEGENDS. ALIGN WALLS WHERE THEY APPEAR TO ALIGN, U.N.O.
- THE INSIDE FACE OF DOOR JAMBS SHALL BE 4" FROM ADJACENT WALL OR FINISHED COLUMN, U.N.O.
- SWING CLEARANCE AT UNIT ENTRY SHALL BE 18" MIN. FROM FINISH FACE OF ADJACENT SURFACE.
- ALL DIMENSIONS ARE TO FACE OF STUD, GRID LINE, OR FACE OF CONCRETE, U.N.O. ELECTRICAL METER AND SERVICE TO BE MOUNTED AT
- GARAGE LEVEL, COORDINATE METER AND PANEL LOCATION WITH OWNER. 0. ELECTRICAL CONTRACTOR SHALL PROVIDE DESIGN BUILD
- SECURITY SYSTEM, CORD. WITH OWNER. 1. WATER PIPES RUNNING NEXT TO OR WITHIN EXTERIOR WALLS TO BE INSULATED W/ 2" MIN CLOSED CELL INSULATION.
- 2. CONTRACTOR SHALL COORDINATE ALL MEANS, METHODS, SEQUENCES PROCEDURES AND SCHEDULES OF ALL CONSTRUCTION ACTIVITIES AND OPERATIONS FOR THE CONSTRUCTION OF THE PROJECT.
- 13. CONTRACTOR RESPONSIBLE FOR OBTAINING AND COMPLYING WITH ALL PERMITS. 4. CONTRACTOR RESPONSIBLE FOR COMPLYING WITH ALL
- MANUFACTURERS RECOMMENDATIONS FOR STORAGE, PREPARATION, FABRICATION, INSTALLATION AND CURING OF MATERIALS AND SYSTEMS.

ble

TOWN STAMP

359 Design


3630 OSAGE STREET DENVER, CO 80211 720.512.3437

B-2465

12/15/2023

SED ARC

No.	Description	Date
	GMP REVISIONS IFC SET	02.09.24 03.15.24
	ASI 002	07.29.24
	+	
	1	
		-
		-
	L	
	+	
	1	
	+	
	1	1
ROJECT		20019
SUE DAT	=	03/15/2024
SUE	THE AMBLE	-

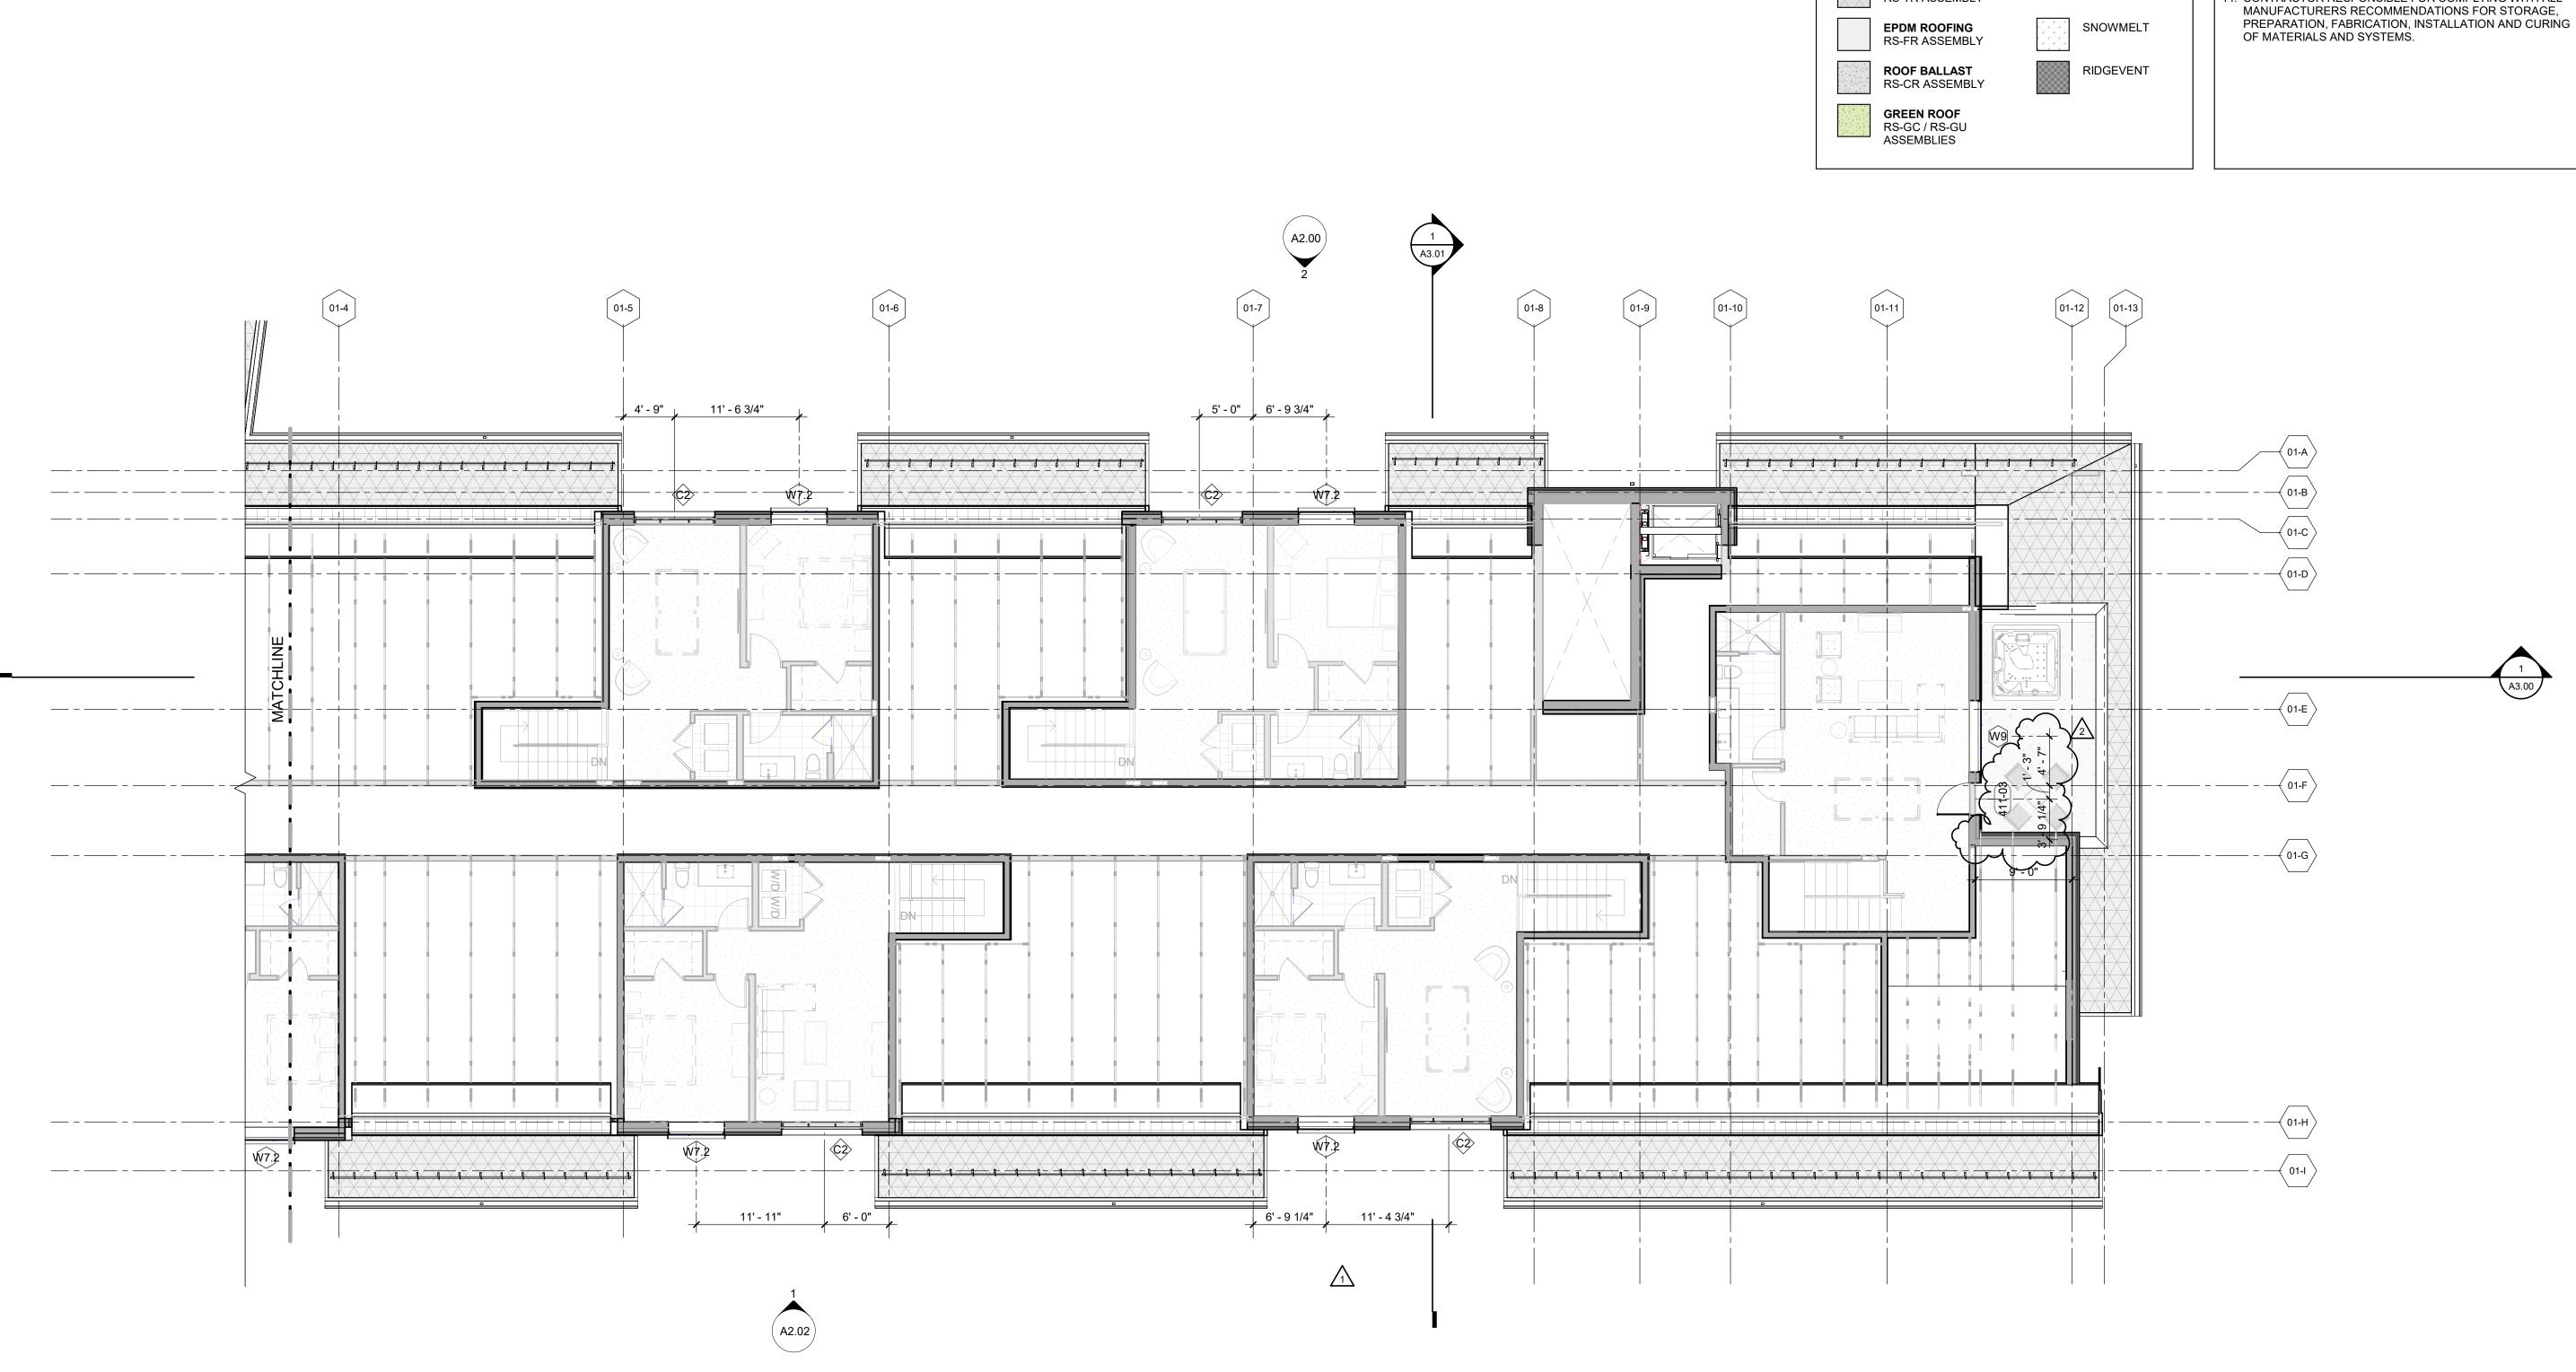

FLOOR PLAN - LEVEL 05 - EAST 1/8" = 1'-0"


OVERALL ROOF - GENERAL NOTES

REFER TO G0.2X SHEETS FOR EXTERIOR AND INTERIOR

BUILDING ENCLOSURE ASSEMBLIES. . REFER TO A1.0X SHEETS FOR EXTERIOR WALL, DEMISING WALL, AND CORRIDOR WALL TYPES AND LOCATIONS. REFER TO A1.1X SHEETS FOR INTERIOR AND EXTERIOR WINDOW/DOOR TAGS WITH UNIT BACKGROUNDS. ALL ROOFS LABELED AS [NO SLOPE] SHALL BE EPDM ROOFING, SLOPED AT 1/4" = 1' - 0" U.N.O. HATCHING INDICATES LOCATIONS OF SNOW MELT EAVE AND VALLEY PANELS, RE: ELECTRICAL DRAWINGS. ALL ROOFTOP MECHANICAL, ELECTRICAL, AND/OR PLUMBING EQUIPMENT SHOWN FOR REFERENCE ONLY. REFER TO MECHANICAL, ELECTRICAL, AND/OR PLUMBING DRAWINGS AND SPECIFICATIONS FOR SPECIFIC DESIGN AND PRODUCT INFORMATION.

PROVIDE WALKWAY PROTECTION TO MAJOR MECHANICAL, ELECTRICAL, AND PLUMBING EQUIPMENT AS REQUIRED TO PROVIDE SERVICE ACCESS. WALKWAY PROTECTION IS INDICATED AS A GENERAL LAYOUT AND MAY NOT SHOW FINAL LOCATIONS OF ALL EQUIPMENT. PROVIDE SNOW MELT AT ALL GUTTERS & DOWNSPOUTS. RE: ELECTRICAL

OVERALL ROOF - LEGEND

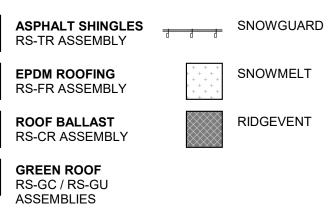

OVERALL PLAN - GENERAL NOTES

- REFER TO G0.2X SHEETS FOR EXTERIOR AND INTERIOR BUILDING ENCLOSURE ASSEMBLIES.
- REFER TO A1.0X SHEETS FOR EXTERIOR WALL, DEMISING WALL, AND CORRIDOR WALL TYPES AND LOCATIONS.
- REFER TO A1.1X SHEETS FOR INTERIOR AND EXTERIOR WINDOW/DOOR TAGS WITH UNIT BACKGROUNDS. REFER TO A6.0X SHEETS FOR INTERIOR AND EXTERIOR
- WINDOW/DOOR SCHEDULES AND LEGENDS. ALIGN WALLS WHERE THEY APPEAR TO ALIGN, U.N.O.
- THE INSIDE FACE OF DOOR JAMBS SHALL BE 4" FROM
- ADJACENT WALL OR FINISHED COLUMN, U.N.O. SWING CLEARANCE AT UNIT ENTRY SHALL BE 18" MIN. FROM FINISH FACE OF ADJACENT SURFACE.
- ALL DIMENSIONS ARE TO FACE OF STUD, GRID LINE, OR FACE OF CONCRETE, U.N.O.
- ELECTRICAL METER AND SERVICE TO BE MOUNTED AT GARAGE LEVEL, COORDINATE METER AND PANEL
- LOCATION WITH OWNER. 0. ELECTRICAL CONTRACTOR SHALL PROVIDE DESIGN BUILD SECURITY SYSTEM, CORD. WITH OWNER.
- 1. WATER PIPES RUNNING NEXT TO OR WITHIN EXTERIOR WALLS TO BE INSULATED W/ 2" MIN CLOSED CELL INSULATION.
- 2. CONTRACTOR SHALL COORDINATE ALL MEANS, METHODS, SEQUENCES PROCEDURES AND SCHEDULES OF ALL CONSTRUCTION ACTIVITIES AND OPERATIONS FOR THE CONSTRUCTION OF THE PROJECT. 13. CONTRACTOR RESPONSIBLE FOR OBTAINING AND
- COMPLYING WITH ALL PERMITS. 4. CONTRACTOR RESPONSIBLE FOR COMPLYING WITH ALL

TOWN STAMP **359** Design 3630 OSAGE STREET DENVER, CO 80211 720.512.3437 B-2465 12/15/2023 LO ARC mble No. Description Date PROJECT NUMBE ISSUE DATE THE AMBLE

IFC SET

SHEET TITLE FLOOR PLAN - LEVEL 05 - EAST

A1.15.2





REFER TO G0.2X SHEETS FOR EXTERIOR AND INTERIOR

BUILDING ENCLOSURE ASSEMBLIES. REFER TO A1.0X SHEETS FOR EXTERIOR WALL, DEMISING WALL, AND CORRIDOR WALL TYPES AND LOCATIONS. REFER TO A1.1X SHEETS FOR INTERIOR AND EXTERIOR WINDOW/DOOR TAGS WITH UNIT BACKGROUNDS. ALL ROOFS LABELED AS [NO SLOPE] SHALL BE EPDM ROOFING, SLOPED AT 1/4" = 1' - 0" U.N.O. HATCHING INDICATES LOCATIONS OF SNOW MELT EAVE AND VALLEY PANELS, RE: ELECTRICAL DRAWINGS. ALL ROOFTOP MECHANICAL, ELECTRICAL, AND/OR PLUMBING EQUIPMENT SHOWN FOR REFERENCE ONLY. REFER TO MECHANICAL, ELECTRICAL, AND/OR PLUMBING DRAWINGS AND SPECIFICATIONS FOR SPECIFIC DESIGN

AND PRODUCT INFORMATION. PROVIDE WALKWAY PROTECTION TO MAJOR MECHANICAL, ELECTRICAL, AND PLUMBING EQUIPMENT AS REQUIRED TO PROVIDE SERVICE ACCESS. WALKWAY PROTECTION IS INDICATED AS A GENERAL LAYOUT AND MAY NOT SHOW FINAL LOCATIONS OF ALL EQUIPMENT. PROVIDE SNOW MELT AT ALL GUTTERS & DOWNSPOUTS. RE: ELECTRICAL

SNOWMELT

RIDGEVENT

OVERALL ROOF - LEGEND

- ASPHALT SHINGLES SNOWGUARD RS-TR ASSEMBLY
- EPDM ROOFING

RS-FR ASSEMBLY ROOF BALLAST

RS-CR ASSEMBLY


GREEN ROOF RS-GC / RS-GU ASSEMBLIES

- **OVERALL PLAN GENERAL NOTES**
- REFER TO G0.2X SHEETS FOR EXTERIOR AND INTERIOR BUILDING ENCLOSURE ASSEMBLIES.
- REFER TO A1.0X SHEETS FOR EXTERIOR WALL, DEMISING WALL, AND CORRIDOR WALL TYPES AND LOCATIONS.
- REFER TO A1.1X SHEETS FOR INTERIOR AND EXTERIOR WINDOW/DOOR TAGS WITH UNIT BACKGROUNDS. REFER TO A6.0X SHEETS FOR INTERIOR AND EXTERIOR
- WINDOW/DOOR SCHEDULES AND LEGENDS. ALIGN WALLS WHERE THEY APPEAR TO ALIGN, U.N.O.
- THE INSIDE FACE OF DOOR JAMBS SHALL BE 4" FROM ADJACENT WALL OR FINISHED COLUMN, U.N.O.
- SWING CLEARANCE AT UNIT ENTRY SHALL BE 18" MIN. FROM FINISH FACE OF ADJACENT SURFACE.
- ALL DIMENSIONS ARE TO FACE OF STUD, GRID LINE, OR FACE OF CONCRETE, U.N.O. ELECTRICAL METER AND SERVICE TO BE MOUNTED AT
- GARAGE LEVEL, COORDINATE METER AND PANEL LOCATION WITH OWNER. 0. ELECTRICAL CONTRACTOR SHALL PROVIDE DESIGN BUILD
- SECURITY SYSTEM, CORD. WITH OWNER. . WATER PIPES RUNNING NEXT TO OR WITHIN EXTERIOR WALLS TO BE INSULATED W/ 2" MIN CLOSED CELL
- INSULATION. 2. CONTRACTOR SHALL COORDINATE ALL MEANS, METHODS, SEQUENCES PROCEDURES AND SCHEDULES OF ALL CONSTRUCTION ACTIVITIES AND OPERATIONS FOR THE CONSTRUCTION OF THE PROJECT.
- 13. CONTRACTOR RESPONSIBLE FOR OBTAINING AND COMPLYING WITH ALL PERMITS. 4. CONTRACTOR RESPONSIBLE FOR COMPLYING WITH ALL
- MANUFACTURERS RECOMMENDATIONS FOR STORAGE, PREPARATION, FABRICATION, INSTALLATION AND CURING OF MATERIALS AND SYSTEMS.


359 Design 3630 OSAGE STREET DENVER, CO 80211 720.512.3437 B-2465 12/15/2023 CD ARG Ω

TOWN STAMP

No.	Description	Date
	IFC SET RFI #76	03.15.24 05.31.24
	1	1
	UMBER	20019
JE DATE		03/15/2024
JE		
	IFC SET	
	⊧ OF PLAN - W	EST

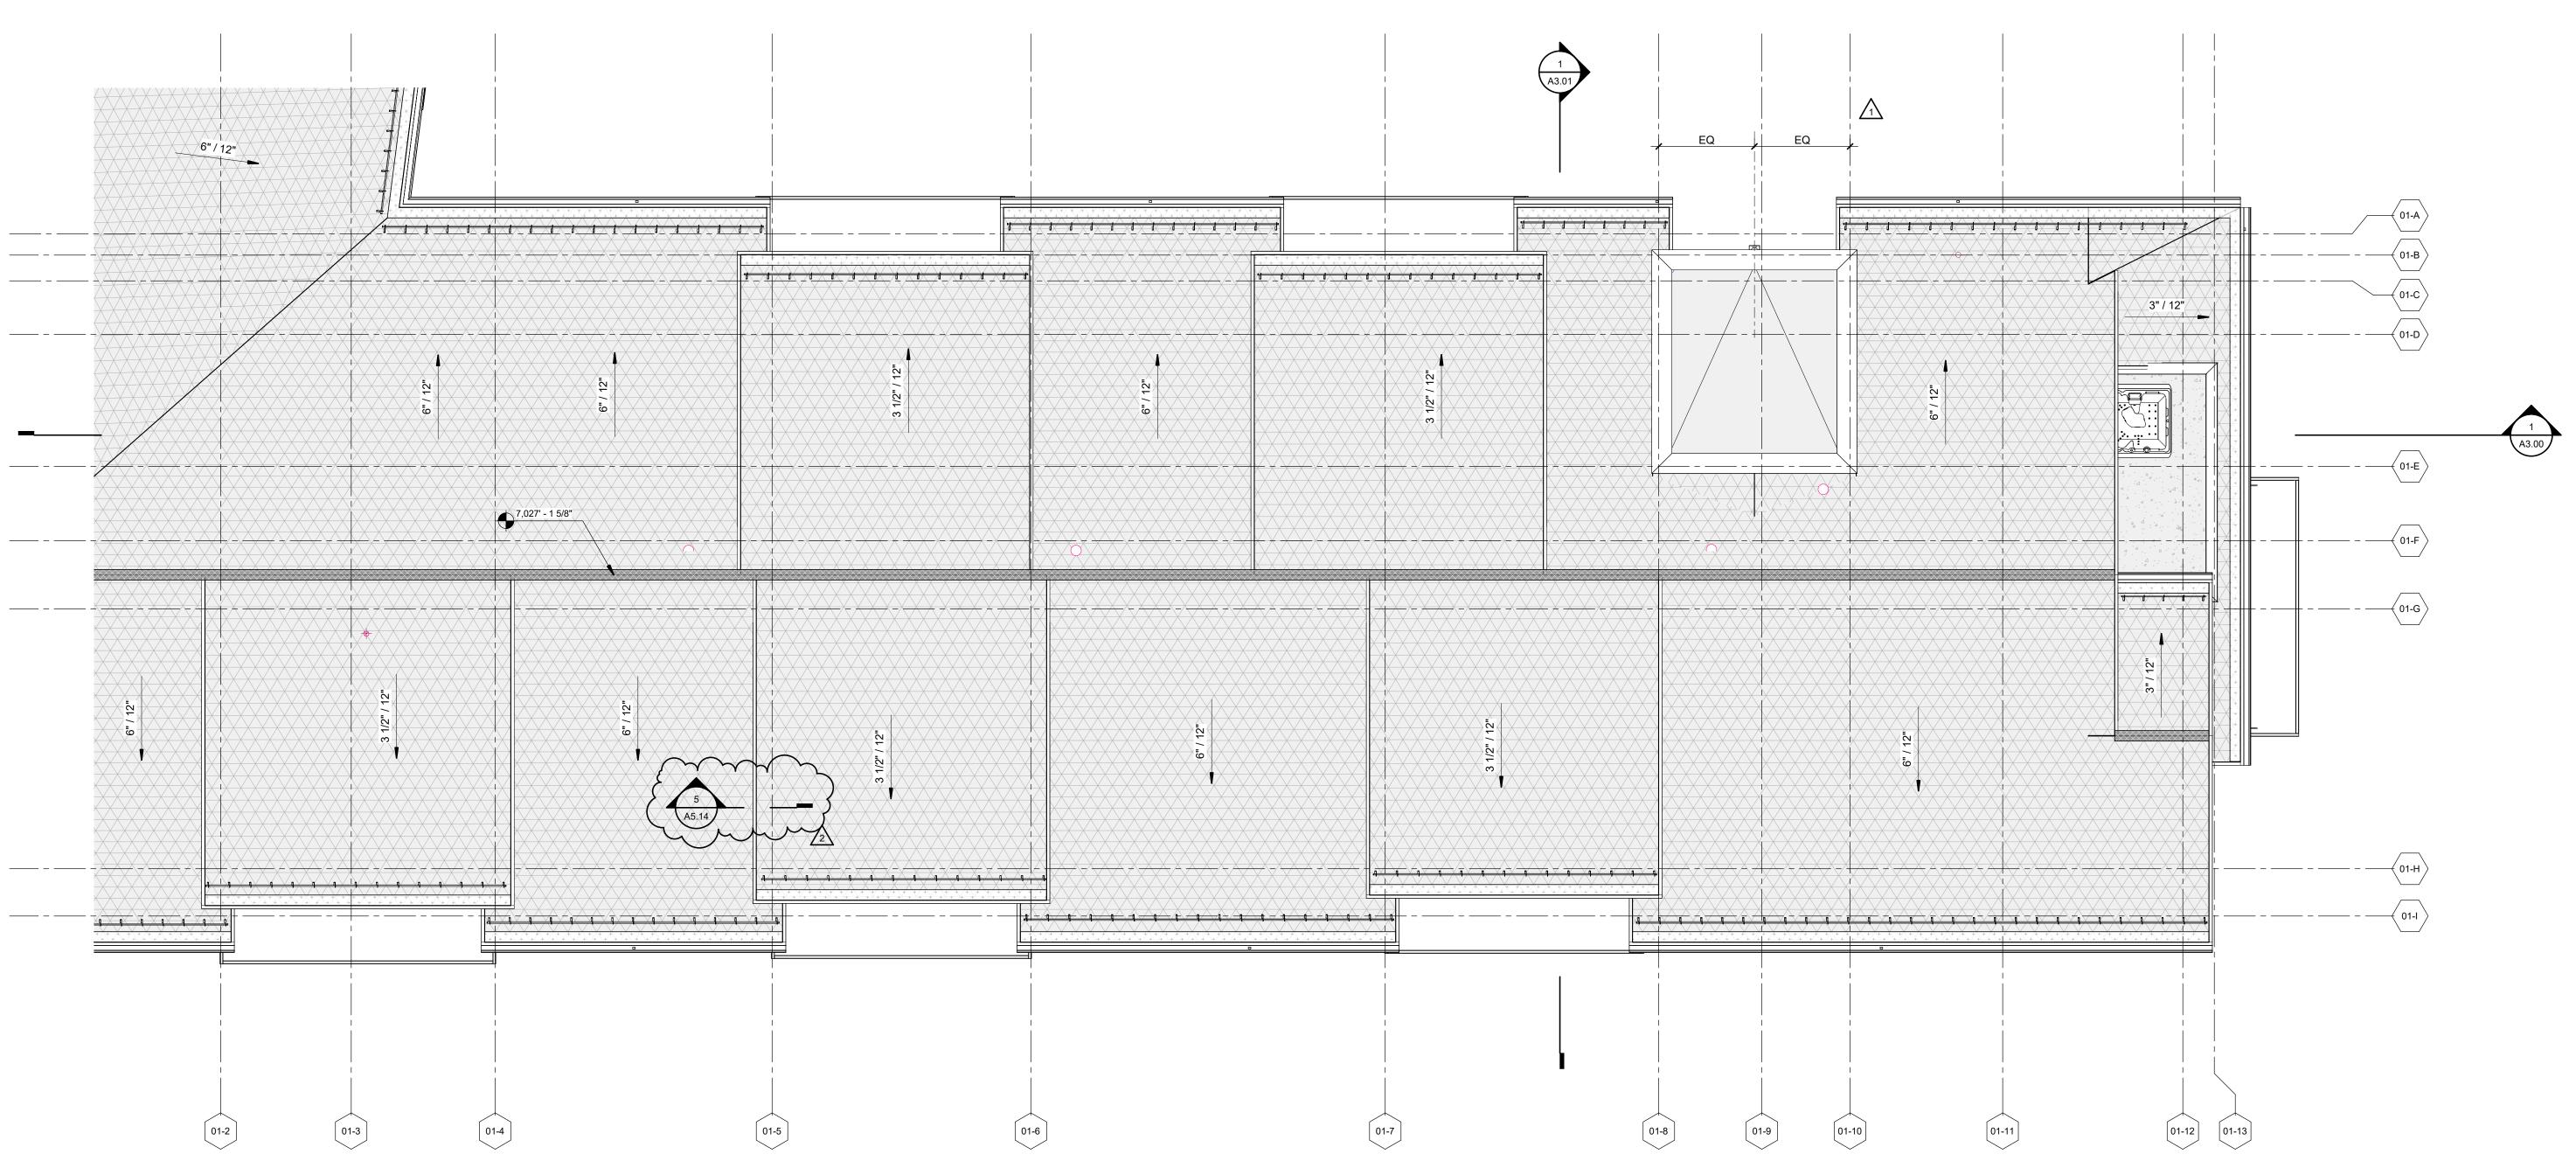

ROOF PLAN EAST 1/8" = 1'-0"

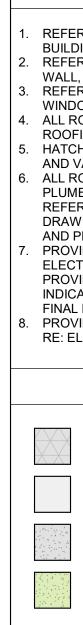


OVERALL ROOF - GENERAL NOTES

REFER TO G0.2X SHEETS FOR EXTERIOR AND INTERIOR

BUILDING ENCLOSURE ASSEMBLIES.
REFER TO A1.0X SHEETS FOR EXTERIOR WALL, DEMISING WALL, AND CORRIDOR WALL TYPES AND LOCATIONS.
REFER TO A1.1X SHEETS FOR INTERIOR AND EXTERIOR WINDOW/DOOR TAGS WITH UNIT BACKGROUNDS.
ALL ROOFS LABELED AS [NO SLOPE] SHALL BE EPDM ROOFING, SLOPED AT 1/4" = 1' - 0" U.N.O.
HATCHING INDICATES LOCATIONS OF SNOW MELT EAVE AND VALLEY PANELS, RE: ELECTRICAL DRAWINGS.
ALL ROOFTOP MECHANICAL, ELECTRICAL, AND/OR PLUMBING EQUIPMENT SHOWN FOR REFERENCE ONLY. REFER TO MECHANICAL, ELECTRICAL, AND/OR PLUMBING DRAWINGS AND SPECIFICATIONS FOR SPECIFIC DESIGN AND PRODUCT INFORMATION.

PROVIDE WALKWAY PROTECTION TO MAJOR MECHANICAL, ELECTRICAL, AND PLUMBING EQUIPMENT AS REQUIRED TO PROVIDE SERVICE ACCESS. WALKWAY PROTECTION IS INDICATED AS A GENERAL LAYOUT AND MAY NOT SHOW FINAL LOCATIONS OF ALL EQUIPMENT. PROVIDE SNOW MELT AT ALL GUTTERS & DOWNSPOUTS. RE: ELECTRICAL

OVERALL ROOF - LEGEND

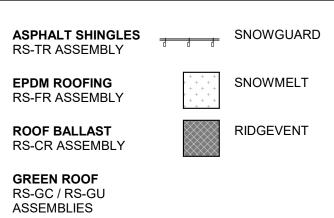

OVERALL PLAN - GENERAL NOTES

- 1. REFER TO G0.2X SHEETS FOR EXTERIOR AND INTERIOR BUILDING ENCLOSURE ASSEMBLIES.
- 2. REFER TO A1.0X SHEETS FOR EXTERIOR WALL, DEMISING WALL, AND CORRIDOR WALL TYPES AND LOCATIONS.
- REFER TO A1.1X SHEETS FOR INTERIOR AND EXTERIOR WINDOW/DOOR TAGS WITH UNIT BACKGROUNDS.
 REFER TO A6.0X SHEETS FOR INTERIOR AND EXTERIOR
- WINDOW/DOOR SCHEDULES AND LEGENDS. 5. ALIGN WALLS WHERE THEY APPEAR TO ALIGN, U.N.O.
- . THE INSIDE FACE OF DOOR JAMBS SHALL BE 4" FROM ADJACENT WALL OR FINISHED COLUMN, U.N.O.
- SWING CLEARANCE AT UNIT ENTRY SHALL BE 18" MIN. FROM FINISH FACE OF ADJACENT SURFACE.
- B. ALL DIMENSIONS ARE TO FACE OF STUD, GRID LINE, OR FACE OF CONCRETE, U.N.O.
- ELECTRICAL METER AND SERVICE TO BE MOUNTED AT GARAGE LEVEL, COORDINATE METER AND PANEL
- LOCATION WITH OWNER. 0. ELECTRICAL CONTRACTOR SHALL PROVIDE DESIGN BUILD SECURITY SYSTEM, CORD. WITH OWNER.
- 11. WATER PIPES RUNNING NEXT TO OR WITHIN EXTERIOR WALLS TO BE INSULATED W/ 2" MIN CLOSED CELL INSULATION.
- CONTRACTOR SHALL COORDINATE ALL MEANS, METHODS, SEQUENCES PROCEDURES AND SCHEDULES OF ALL CONSTRUCTION ACTIVITIES AND OPERATIONS FOR THE CONSTRUCTION OF THE PROJECT.
 CONTRACTOR RESPONSIBLE FOR OBTAINING AND
- COMPLYING WITH ALL PERMITS. 14. CONTRACTOR RESPONSIBLE FOR COMPLYING WITH ALL MANUFACTURERS RECOMMENDATIONS FOR STORAGE,
- PREPARATION, FABRICATION, INSTALLATION AND CURING OF MATERIALS AND SYSTEMS.

TOWN STAMP 359 Design 3630 OSAGE STREET DENVER, CO 80211 720.512.3437 B-2465 12/15/2023 ED ARC ble Am No. Description Date

THE AMBLE

PROJECT NUMBE


IFC SET

SHEET TITLE

ROOF PLAN - EAST


A1.16.2

	Keynote Legend
07.01	EXTERIOR SLATE CLADDING, SEE MATERIAL LEGEND
07.02	EXTERIOR WOOD SIDING, SEE MATERIAL LEGEND
07.03	EXTERIOR ALUMINUM SIDING, SEE MATERIAL LEGEND
07.05	METAL PANEL SIDING, SEE MATERIAL LEGEND
07.06	ASPHALT SHINGLE ROOFING, SEE MATERIAL LEGEND
07.08	FIBER CEMENT STEPPED FACIA, EP-01
07.09	SCUPPER AND DOWNSPOUT W/ HEAT TRACE, RE: ELEC.
07.11	SNOW GUARD
∆ ^{07.13}	FIBER CEMENT BEAM & COLUMN WRAPS, EP-02
D27	
D28	
D29	

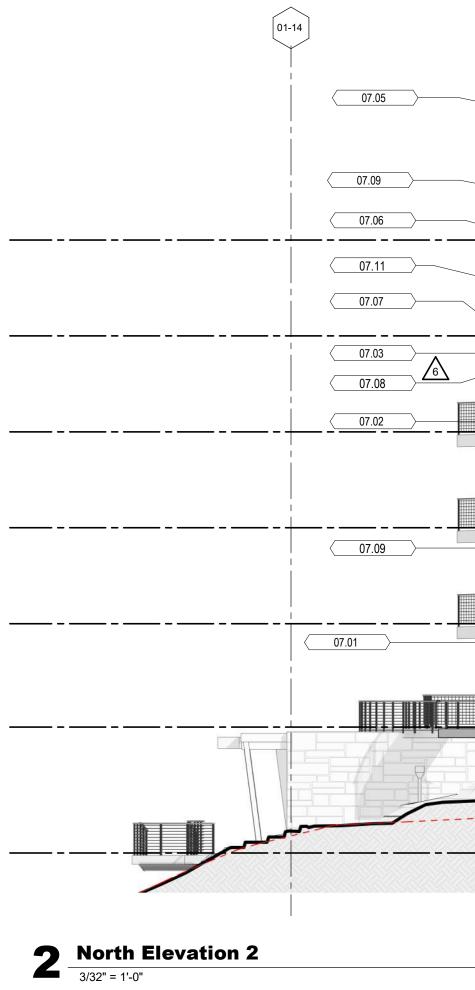




01-13 01-12	01-11	01-9 01-8 1 A3.01	01-7	0	1-6
				07.03	
					W7.2
	10'-8"				
	2' -2" 8' - 6"	¥V20		W21 W20	V(7,) D-14
	2 - 2" 8 - 6"	ýv20	W7.1 D-14 C1	<u>(v21</u> <u>(v2</u>)	W7.1 D-14
		W20	W7.1 D-14) C1	(vi21) (vi20)	W(7.) D-12
	<u>D-16</u>		W(7.) D-14C1	W21 W20	W7.1 D-14
	EXISTING TOPOGRAPHY				

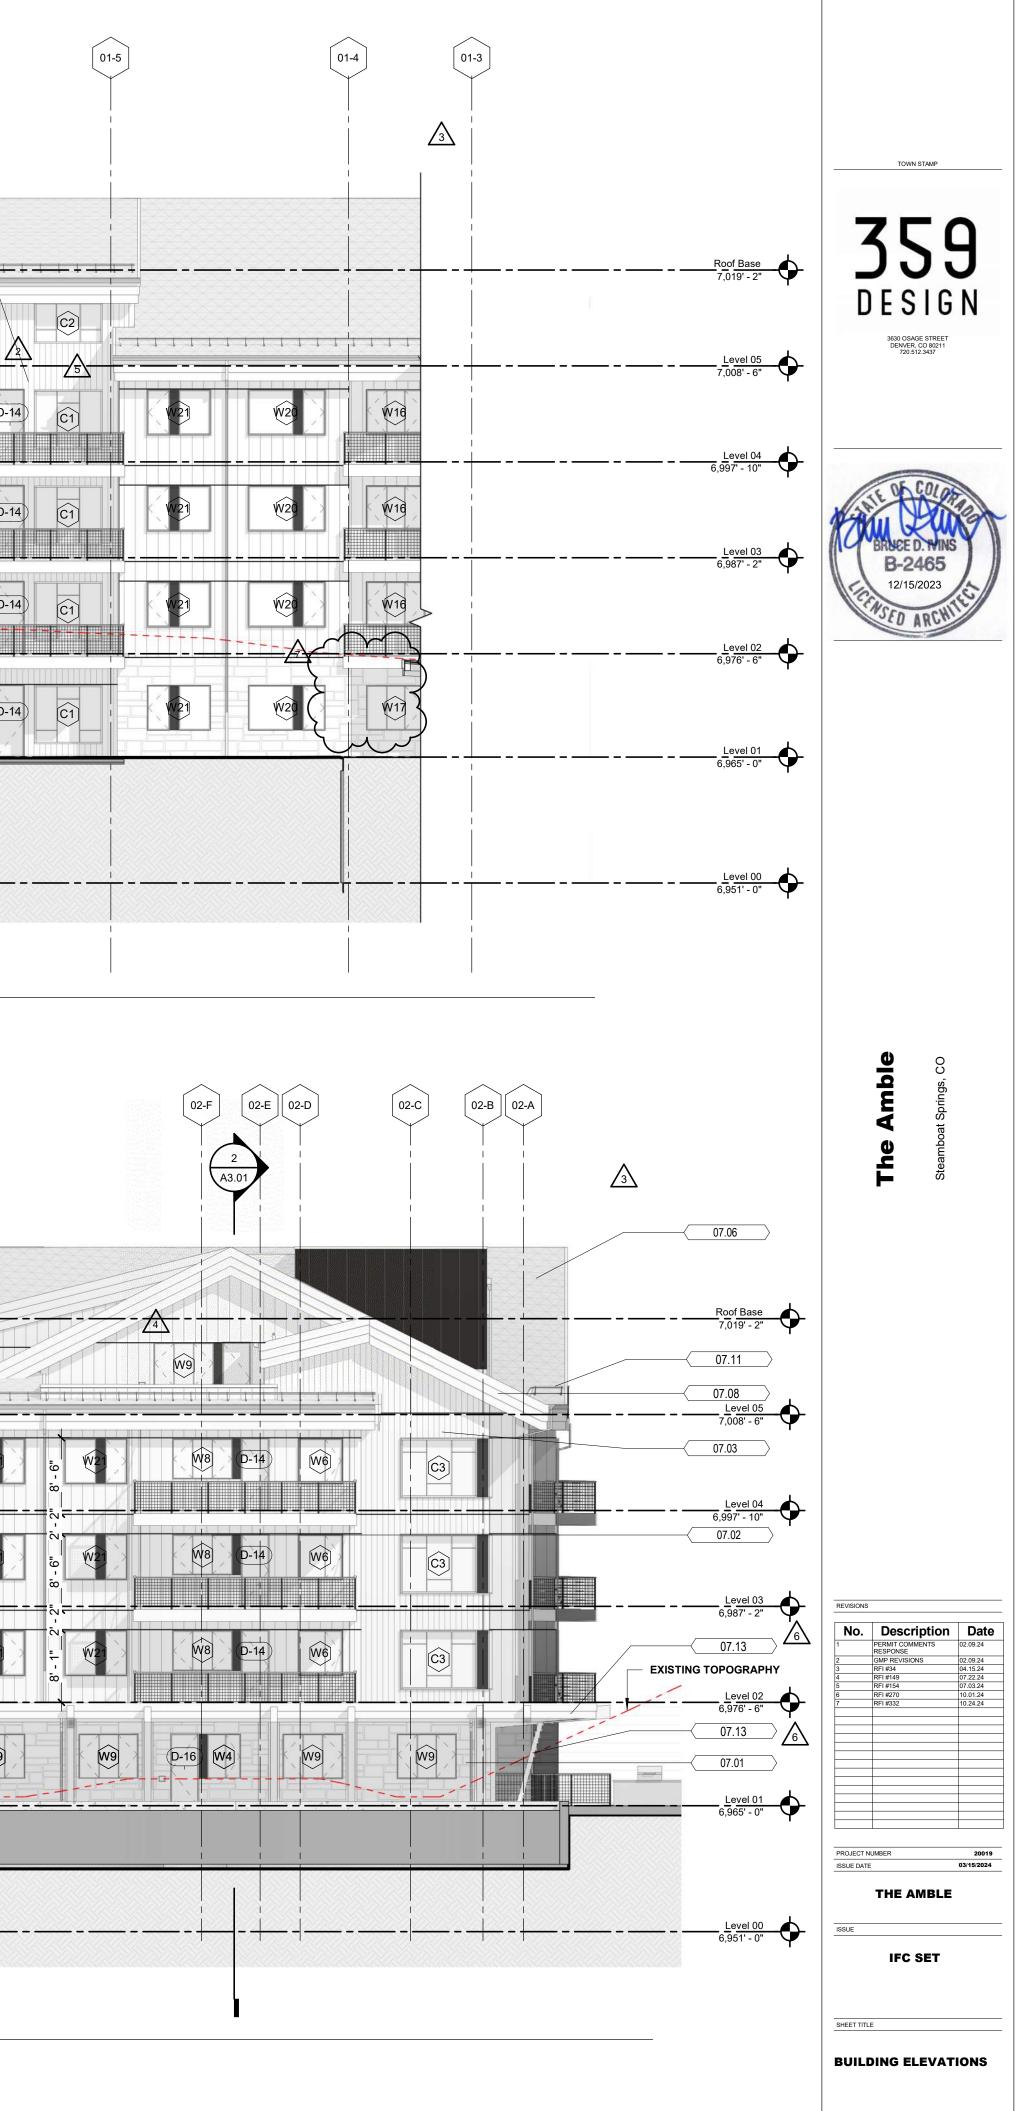





SHEET NO.

	Keynote Legend
07.01	EXTERIOR SLATE CLADDING, SEE MATERIAL LEGEND
07.02	EXTERIOR WOOD SIDING, SEE MATERIAL LEGEND
07.03	EXTERIOR ALUMINUM SIDING, SE MATERIAL LEGEND
07.05	METAL PANEL SIDING, SEE MATERIAL LEGEND
07.06	ASPHALT SHINGLE ROOFING, SEE MATERIAL LEGEND
07.08 Z	FIBER CEMENT STEPPED FACIA,
07.09	SCUPPER AND DOWNSPOUT W/ HEAT TRACE, RE: ELEC.
07.11	SNOW GUARD
07.13	FIBER CEMENT BEAM & COLUMN

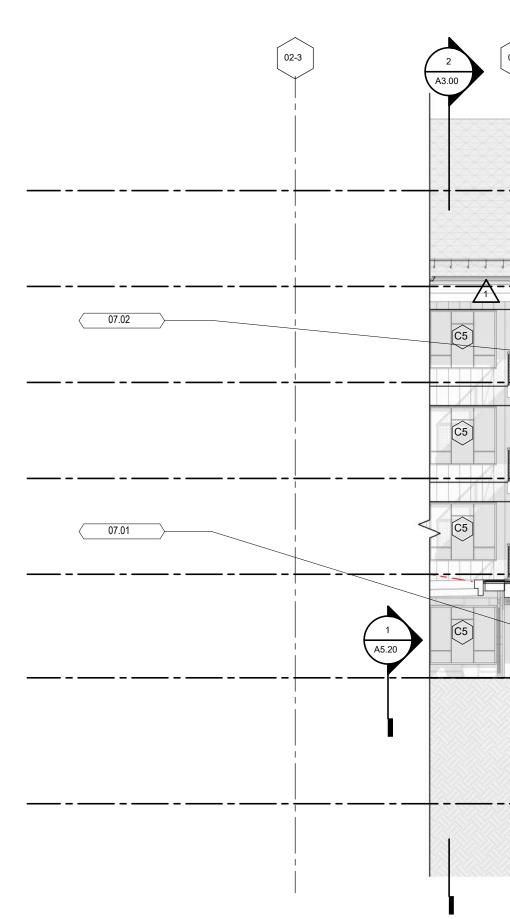



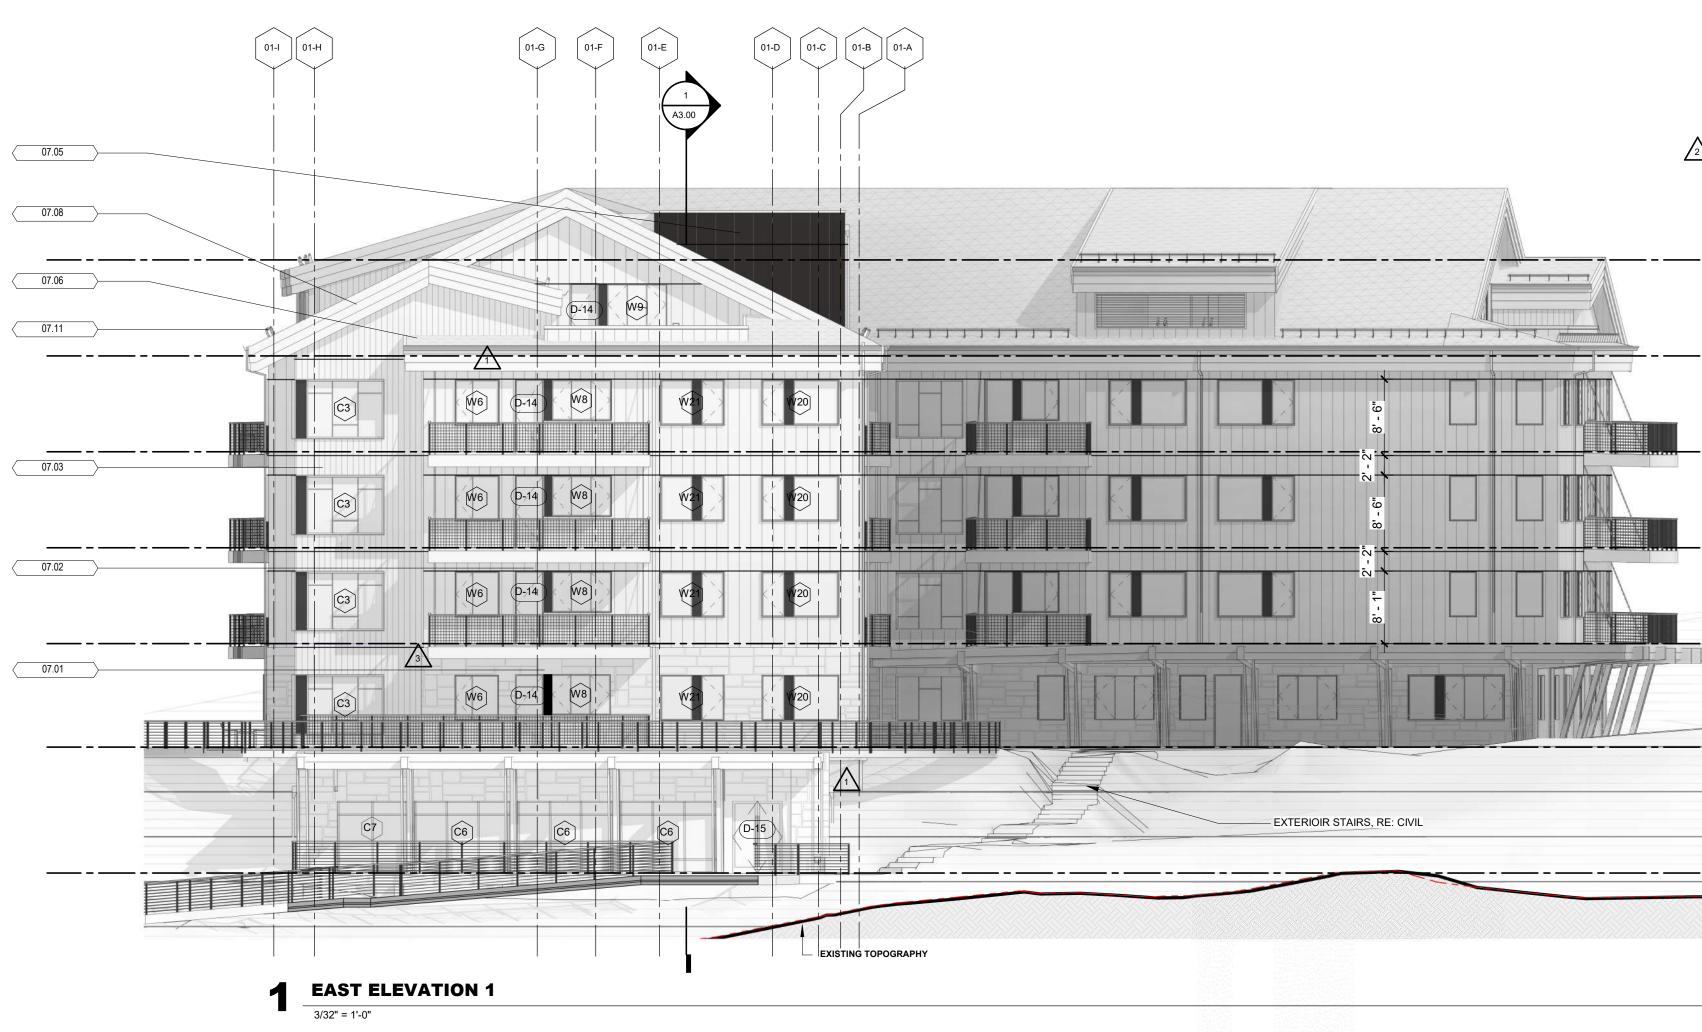


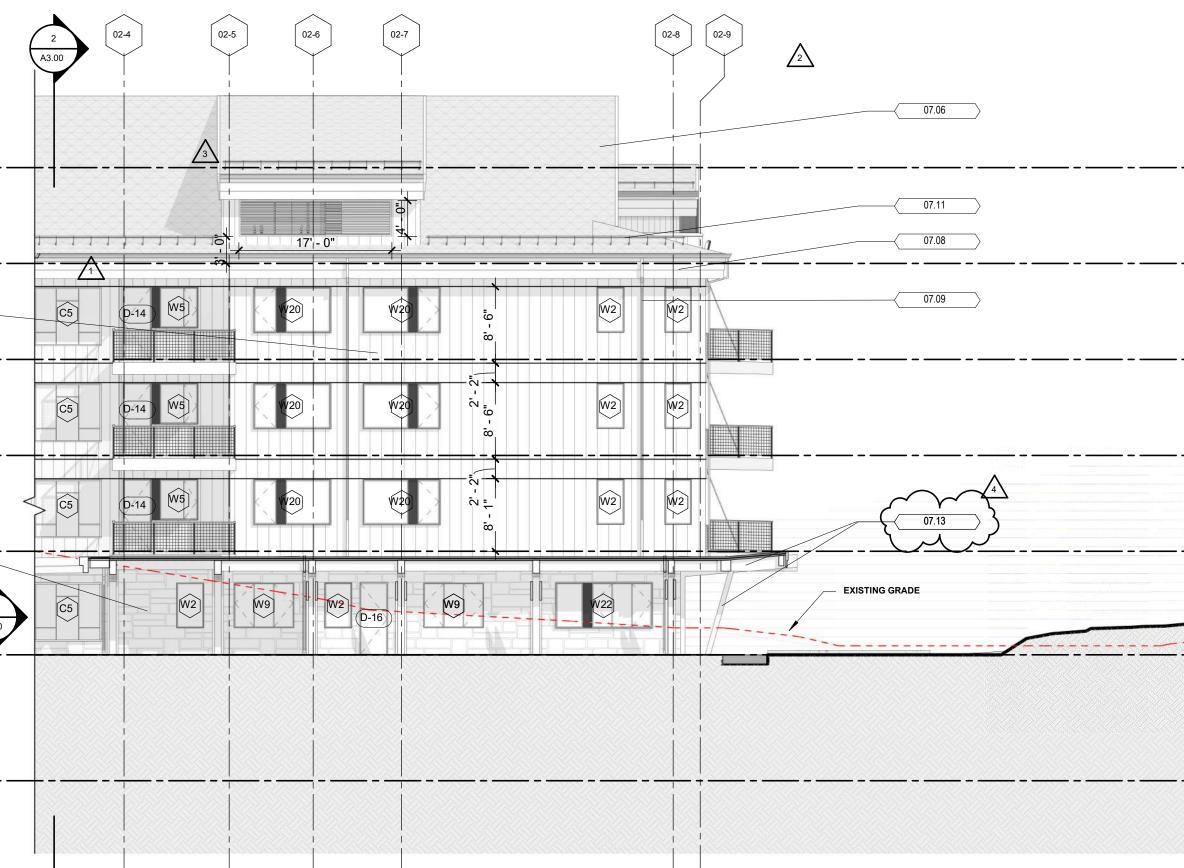

 — – <u>Roof Base</u> 7,019' - 2"		TOWN STAMP 355 DESIGN
 Level 05 7,008' - 6"		DESIGI 3630 OSAGE STREET DENVER, CO 80211 720.512.3437
 Level 04 6,997" - 10"		OF COL
Level 03 6,987' - 2"		BRSCE D. WINS B-2465 12/15/2023
		TERINSED ARCHITE
		Ble Br co
		The Amble Steamboat Springs, CO
 ——————————————————————————————————————		
 Level 04 6,997' - 10"		
 <u>Level 03</u> 6,987' - 2"		No. Description 1 GMP REVISIONS 0 2 RFI #34 0 3 RFI #154 0 4 RFI #270 1
Level 02 6,976' - 6"		
Level 01 6,965' - 0"		PROJECT NUMBER ISSUE DATE 02
Level 00 6,951' - 0"		IFC SET
		BUILDING ELEVATIONS
		SHEET NO.





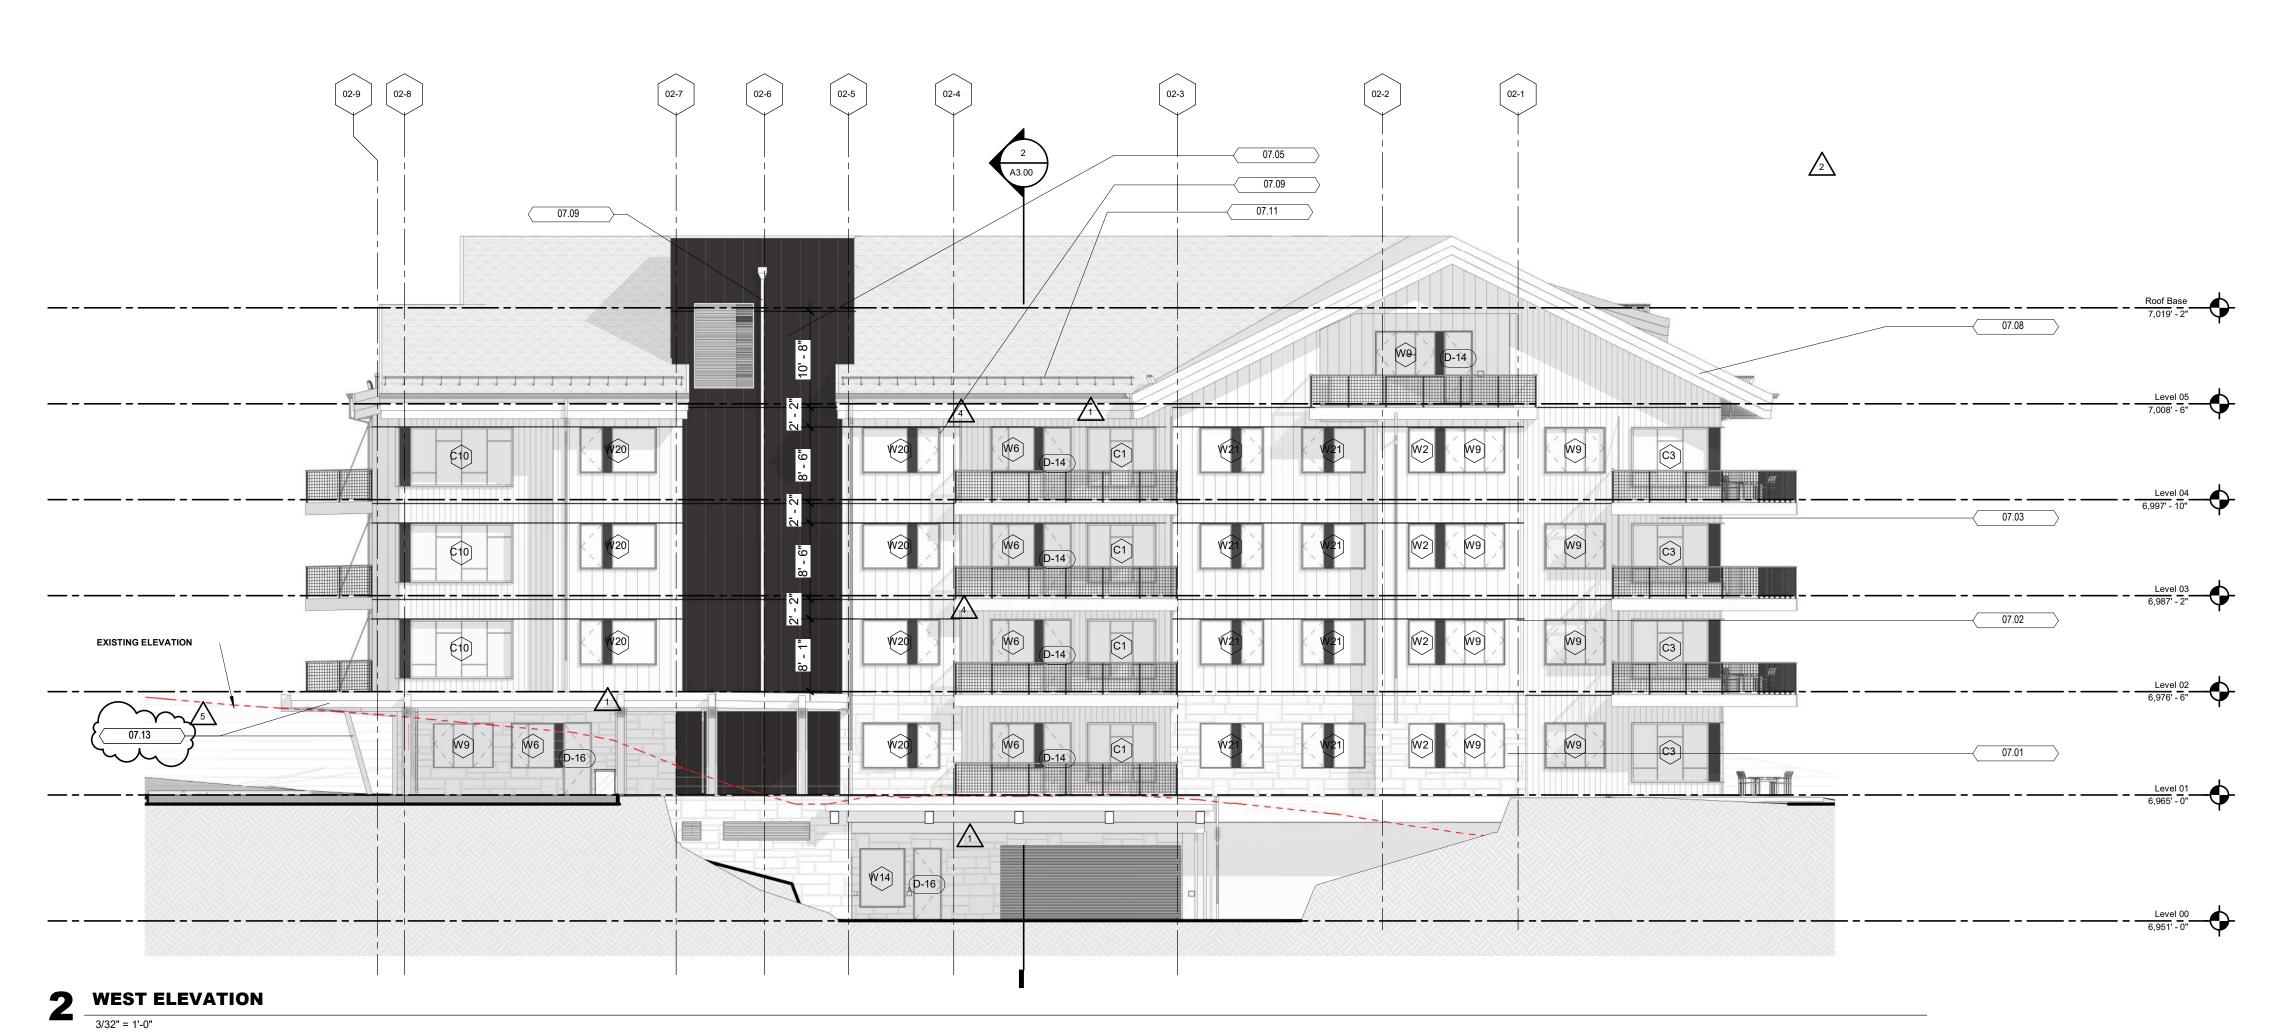

	Keynote Legend
[
07.01	EXTERIOR SLATE CLADDING, SEE MATERIAL LEGEND
07.02	EXTERIOR WOOD SIDING, SEE MATERIAL LEGEND
07.03	EXTERIOR ALUMINUM SIDING, SEE MATERIAL LEGEND
07.05	METAL PANEL SIDING, SEE MATERIAL LEGEND
07.06	ASPHALT SHINGLE ROOFING, SEE MATERIAL LEGEND
07.08	FIBER CEMENT STEPPED FACIA,
07.09	SCUPPER AND DOWNSPOUT W/ HEAT TRACE, RE: ELEC.
07.11	SNOW GUARD
	FIBER CEMENT BEAM & COLUMN WRAPS, EP-02









1






EAST MATERIAL ELEVATION 1 3/32" = 1'-0"

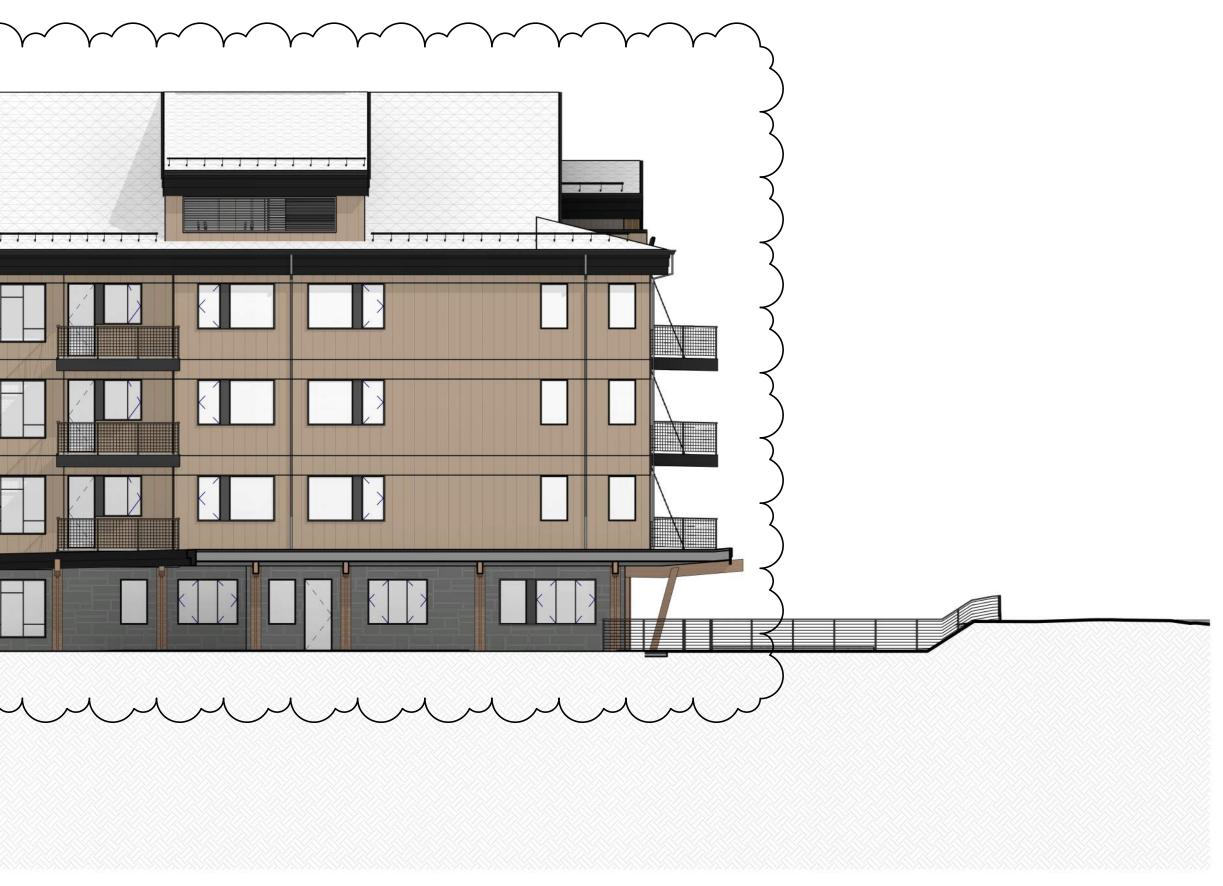

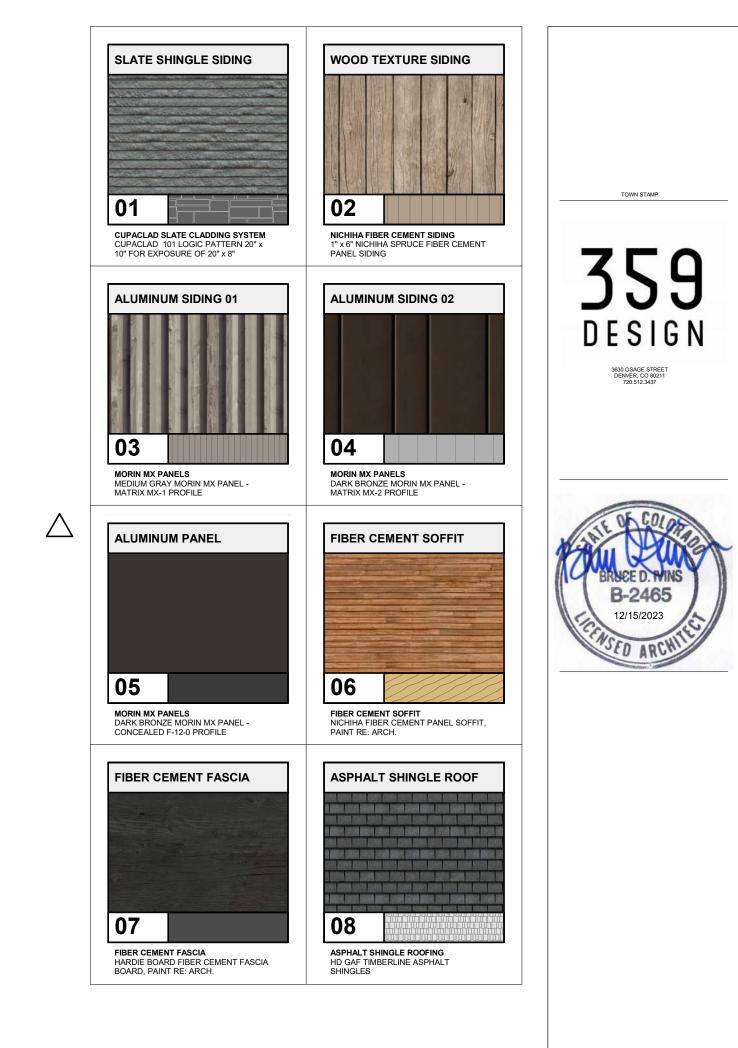

The Amble

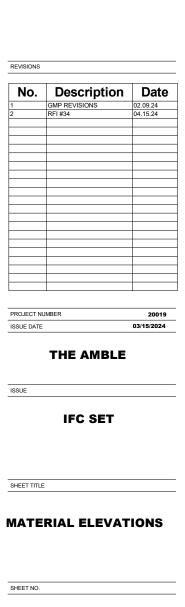

A2.11







A2.'	12
------	----

SHEET NO.


Keynote Legend		
05.01	METAL HOG WIRE RAILING	
07.01	EXTERIOR SLATE CLADDING, SEE MATERIAL LEGEND	
07.02	EXTERIOR WOOD SIDING, SEE MATERIAL LEGEND	
07.03	EXTERIOR ALUMINUM SIDING, SEE MATERIAL LEGEND	
07.05	METAL PANEL SIDING, SEE MATERIAL LEGEND	
07.06	ASPHALT SHINGLE ROOFING, SEE MATERIAL LEGEND	
07.08	FIBER CEMENT STEPPED FACIA	
07.09	SCUPPER AND DOWNSPOUT W/ HEAT TRACE, RE: ELEC.	
07.11	SNOW GUARD	
D27	<varies></varies>	
D28		
D29		

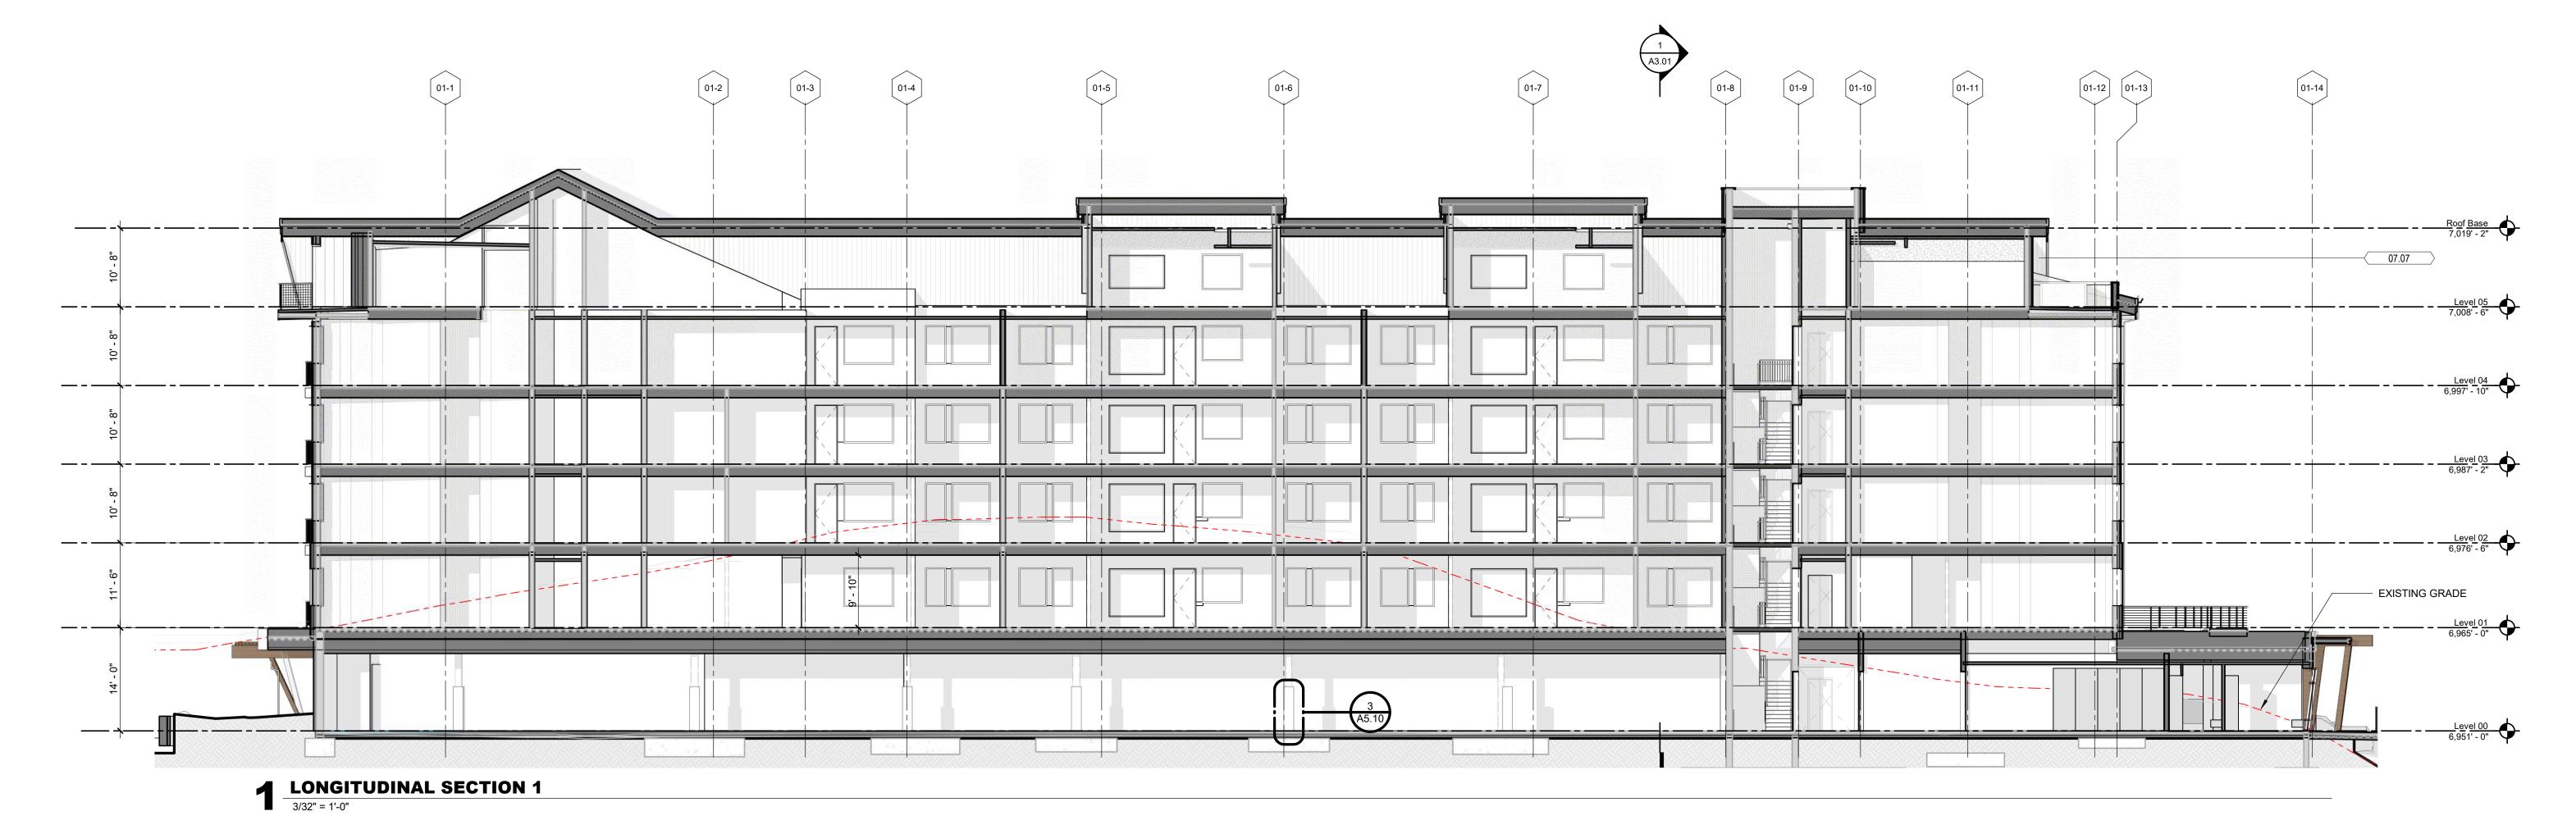


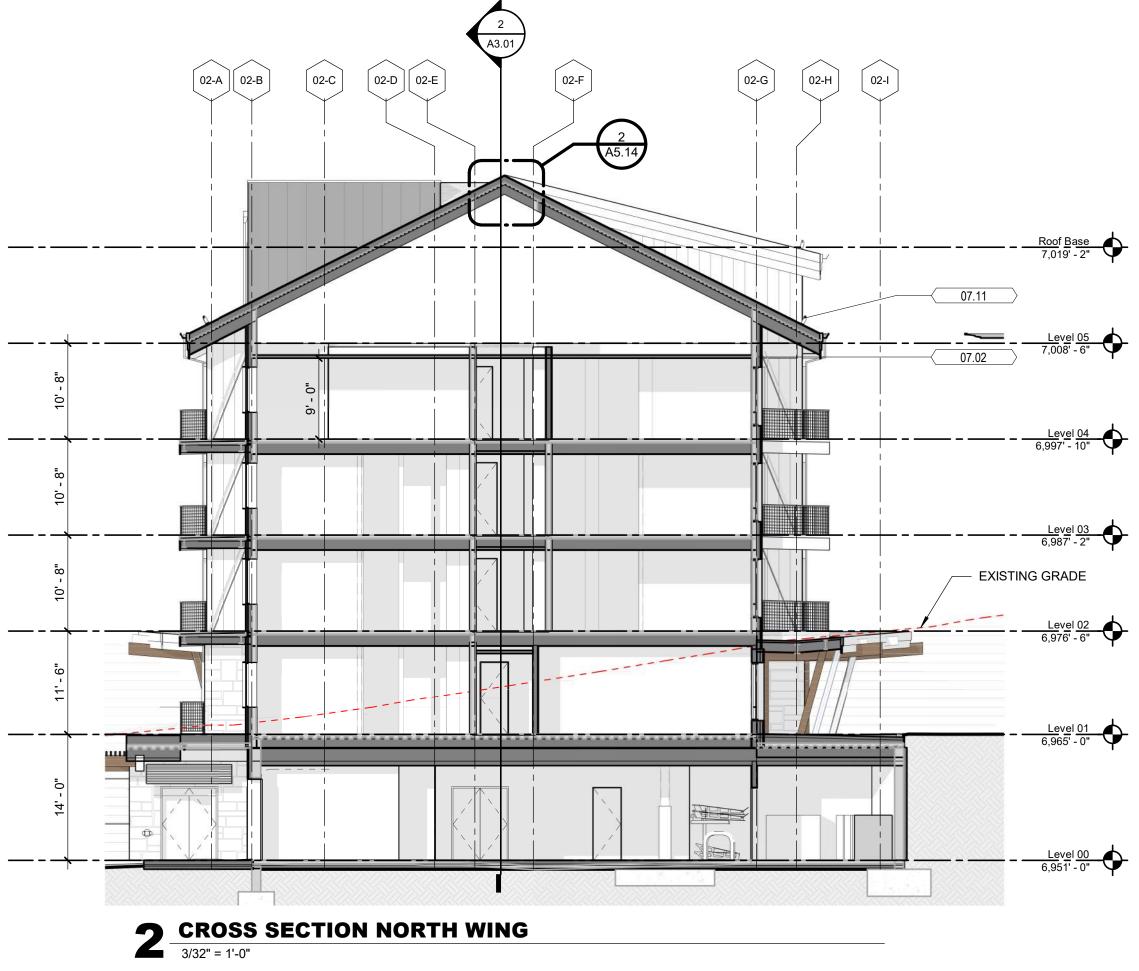





Keynote Legend			
05.01	METAL HOG WIRE RAILING		
07.01	EXTERIOR SLATE CLADDING, SEE MATERIAL LEGEND		
07.02	EXTERIOR WOOD SIDING, SEE MATERIAL LEGEND		
07.03	EXTERIOR ALUMINUM SIDING, SEE MATERIAL LEGEND		
07.05	METAL PANEL SIDING, SEE MATERIAL LEGEND		
07.06	ASPHALT SHINGLE ROOFING, SEE MATERIAL LEGEND		
07.08	FIBER CEMENT STEPPED FACIA		
07.09	SCUPPER AND DOWNSPOUT W/ HEAT TRACE, RE: ELEC.		
07.11	SNOW GUARD		
D27	<varies></varies>		
D28			
D29			

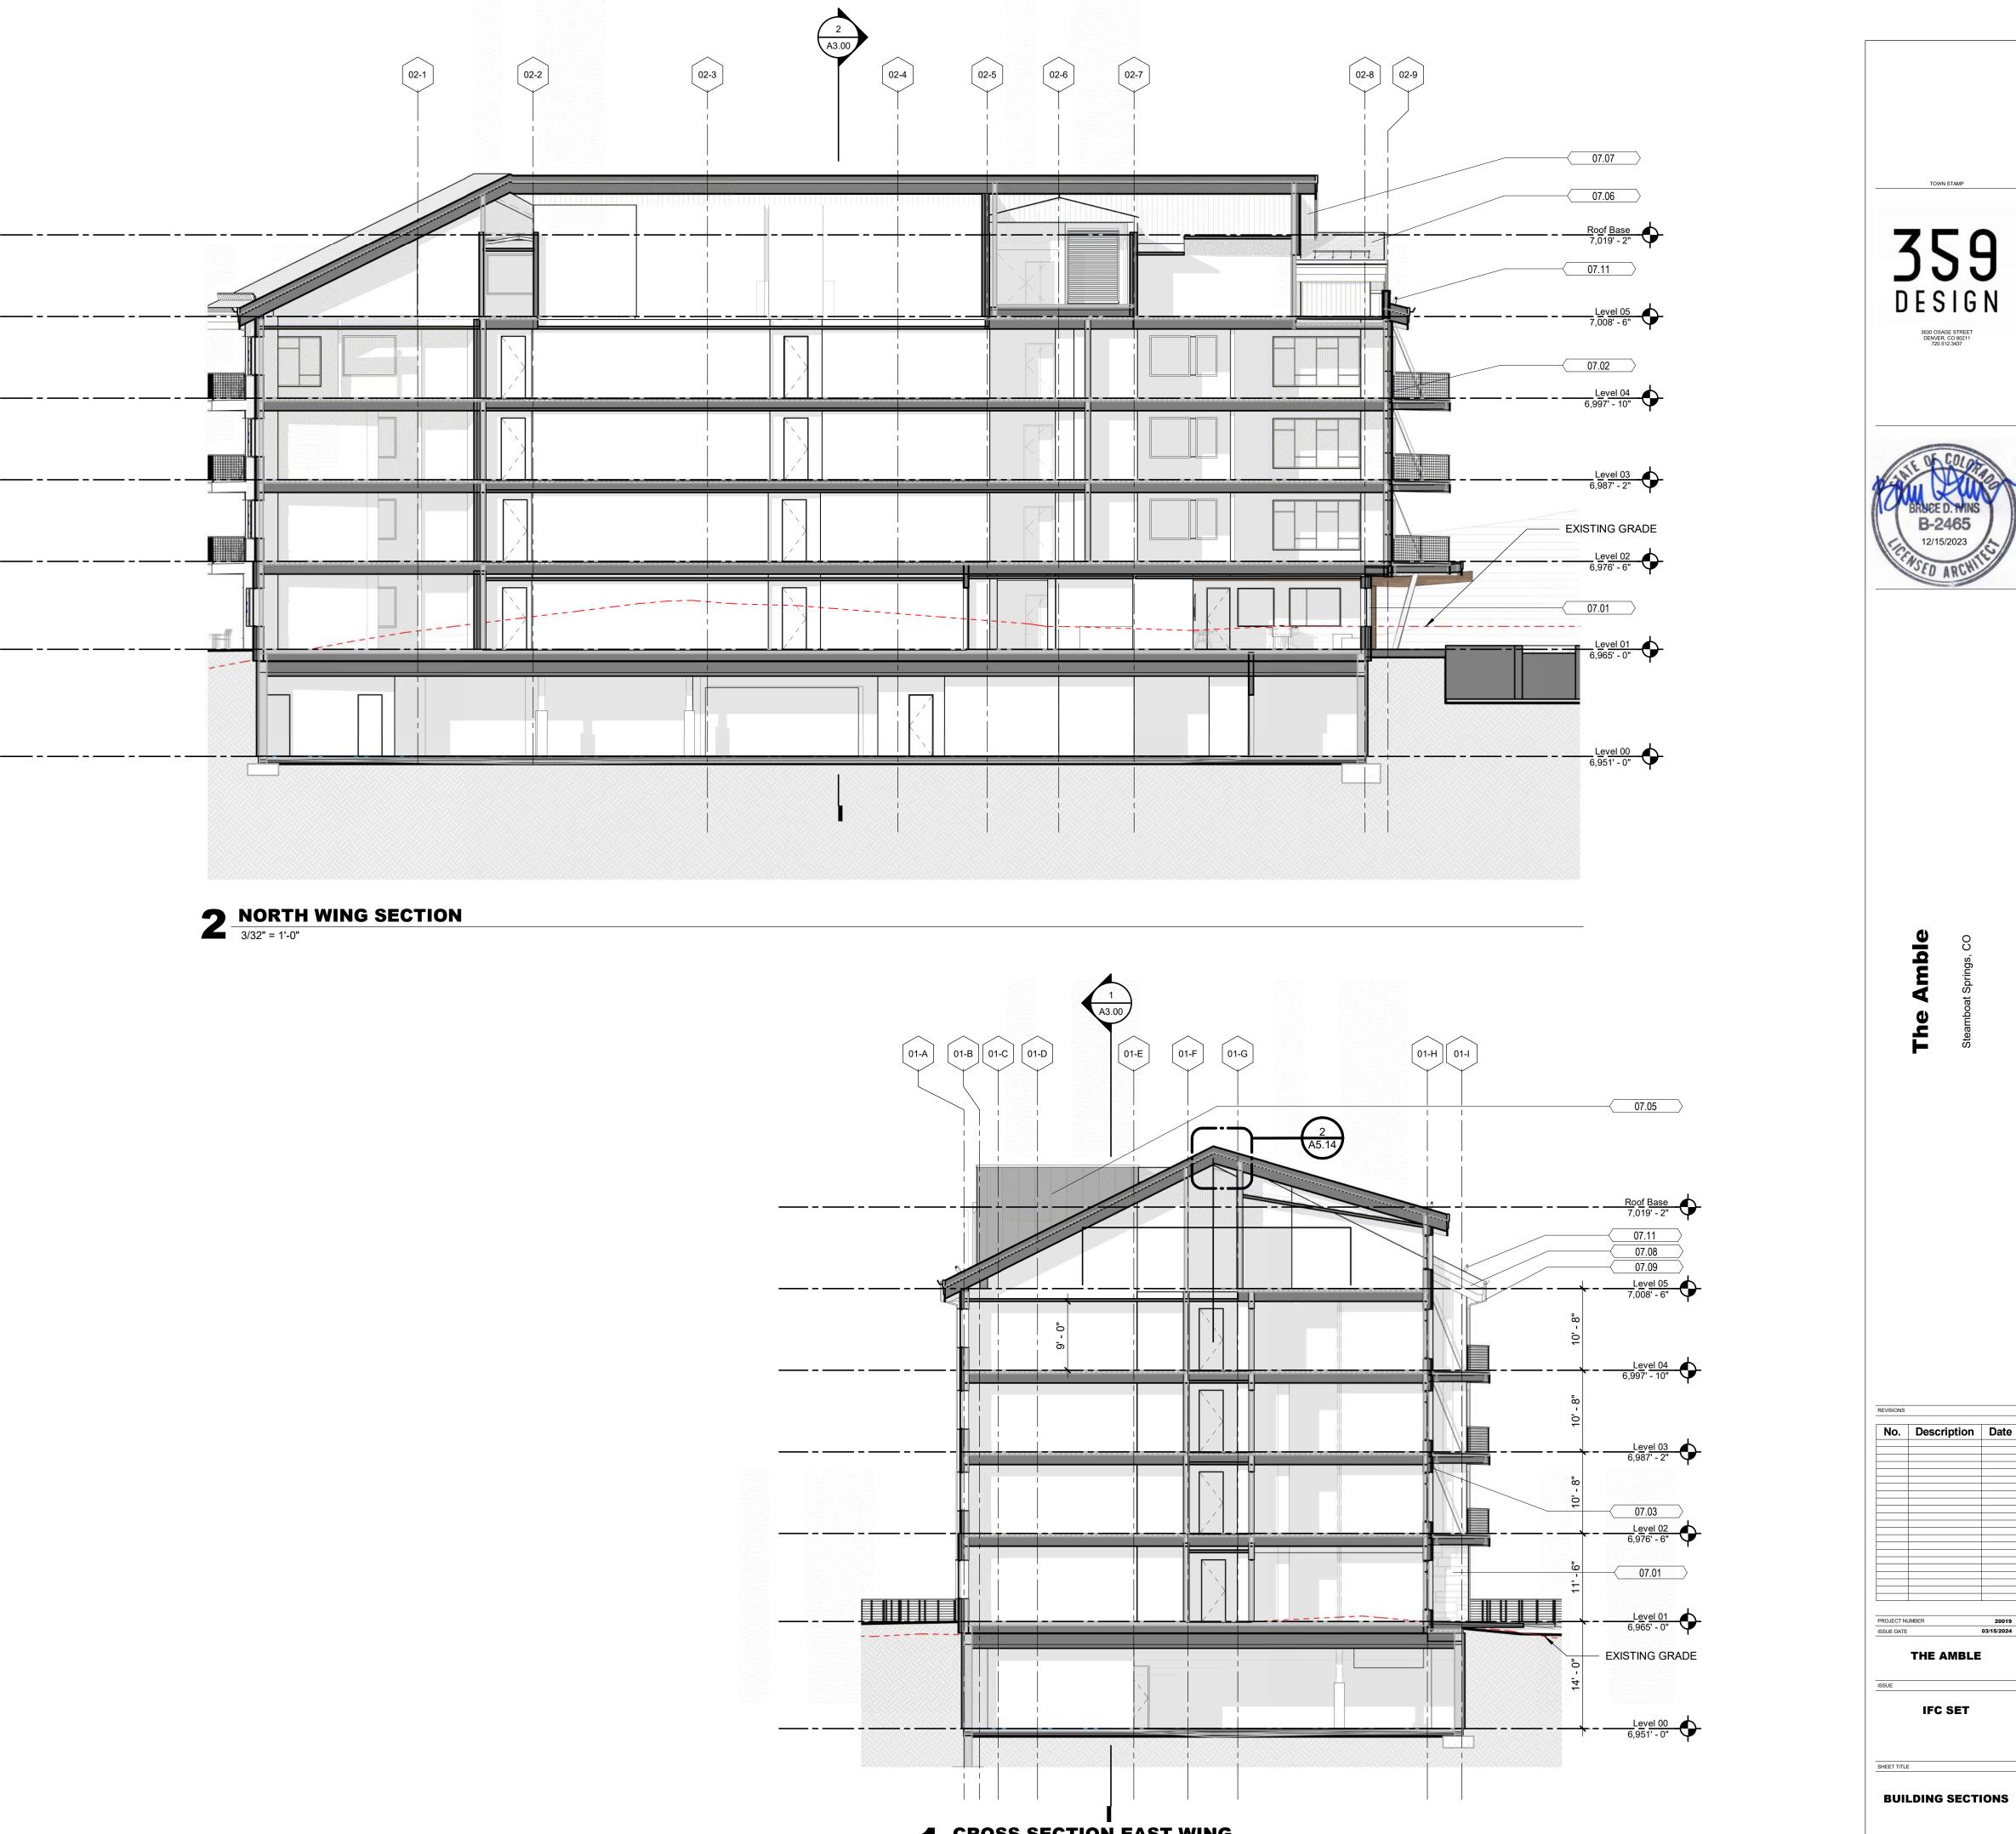


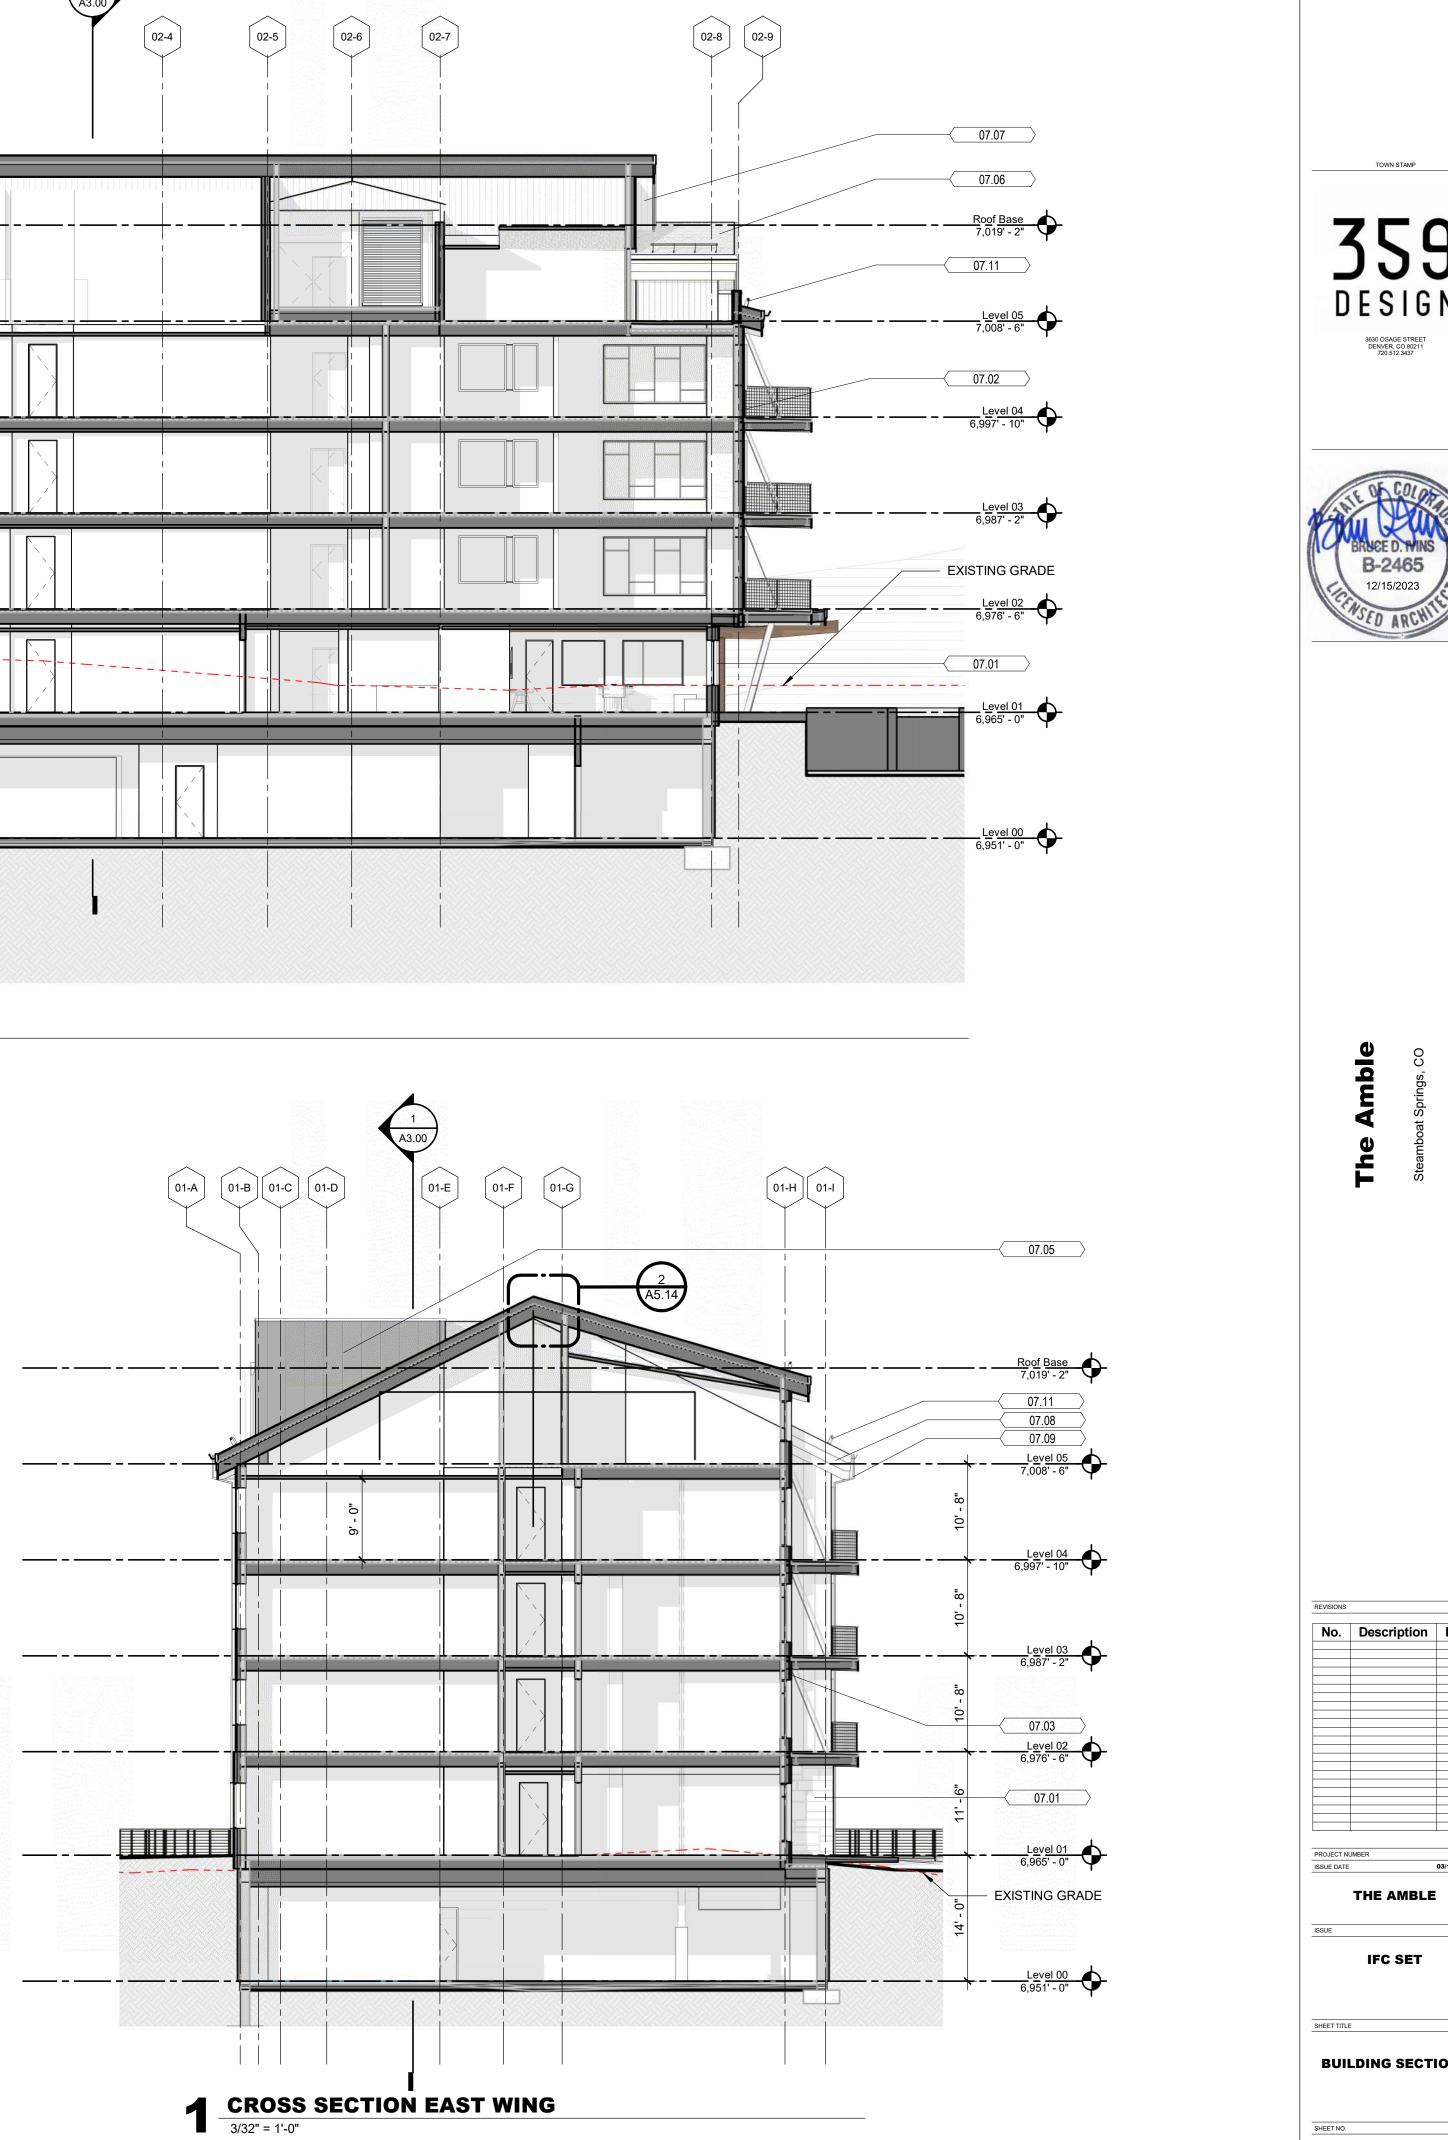

A3.01

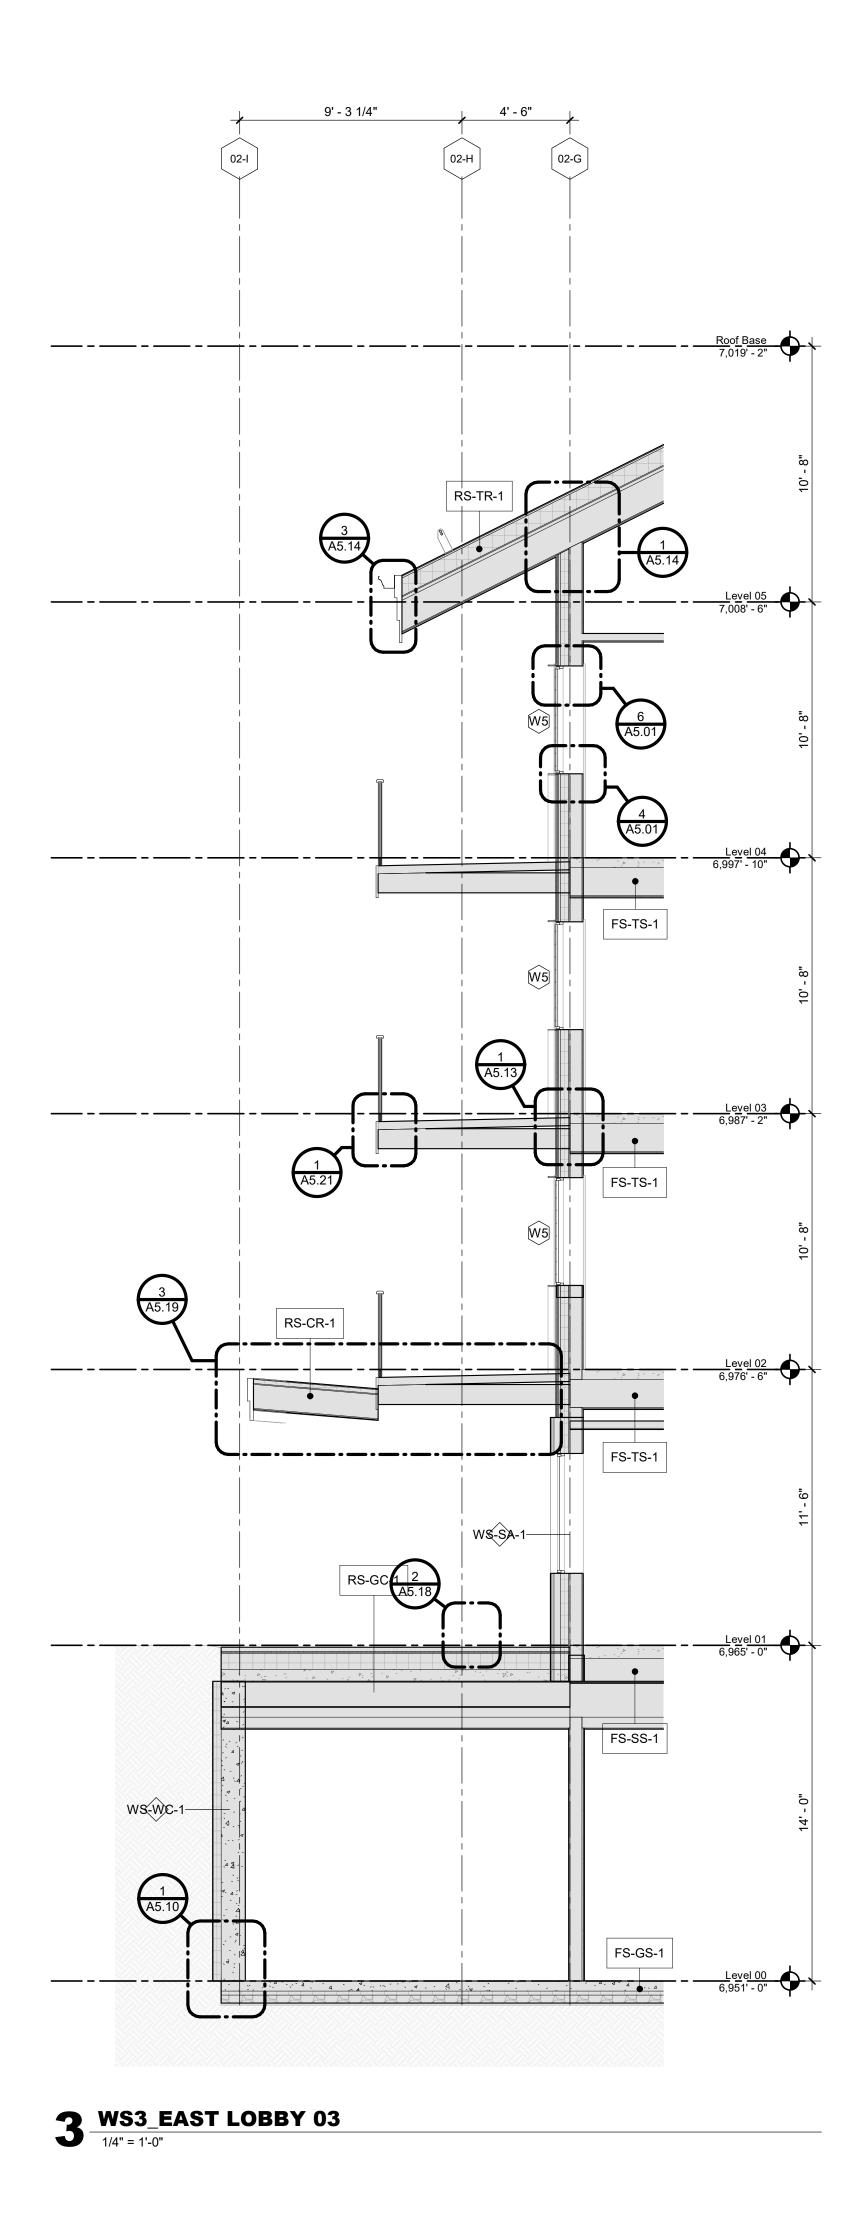

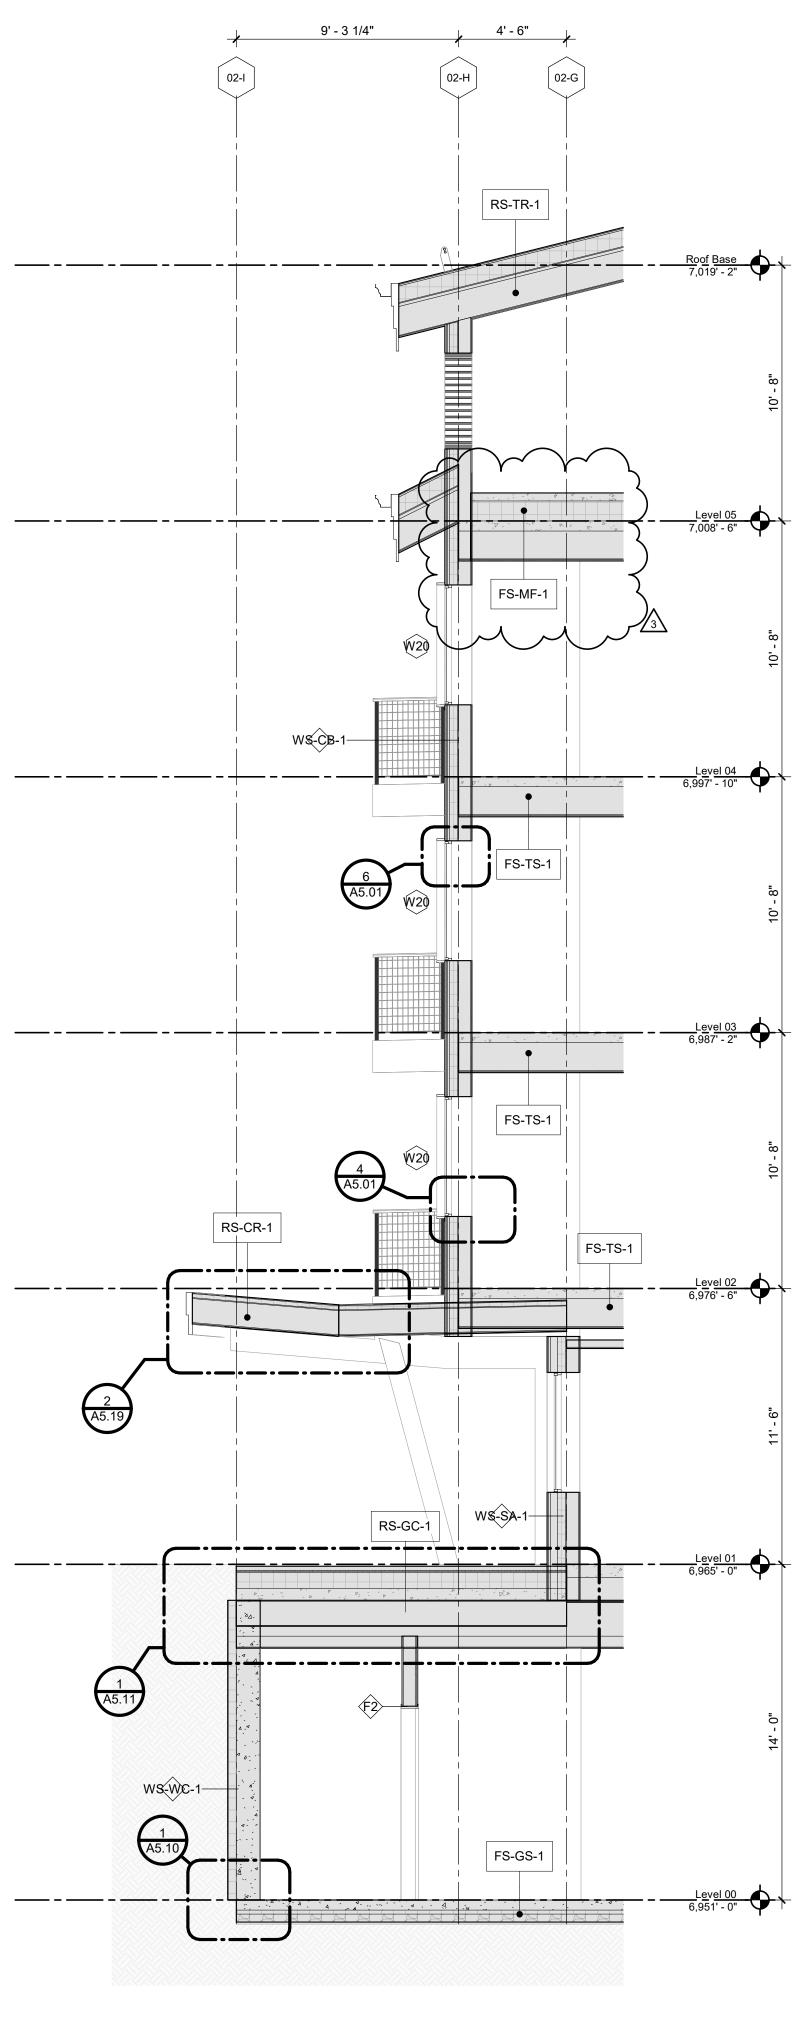

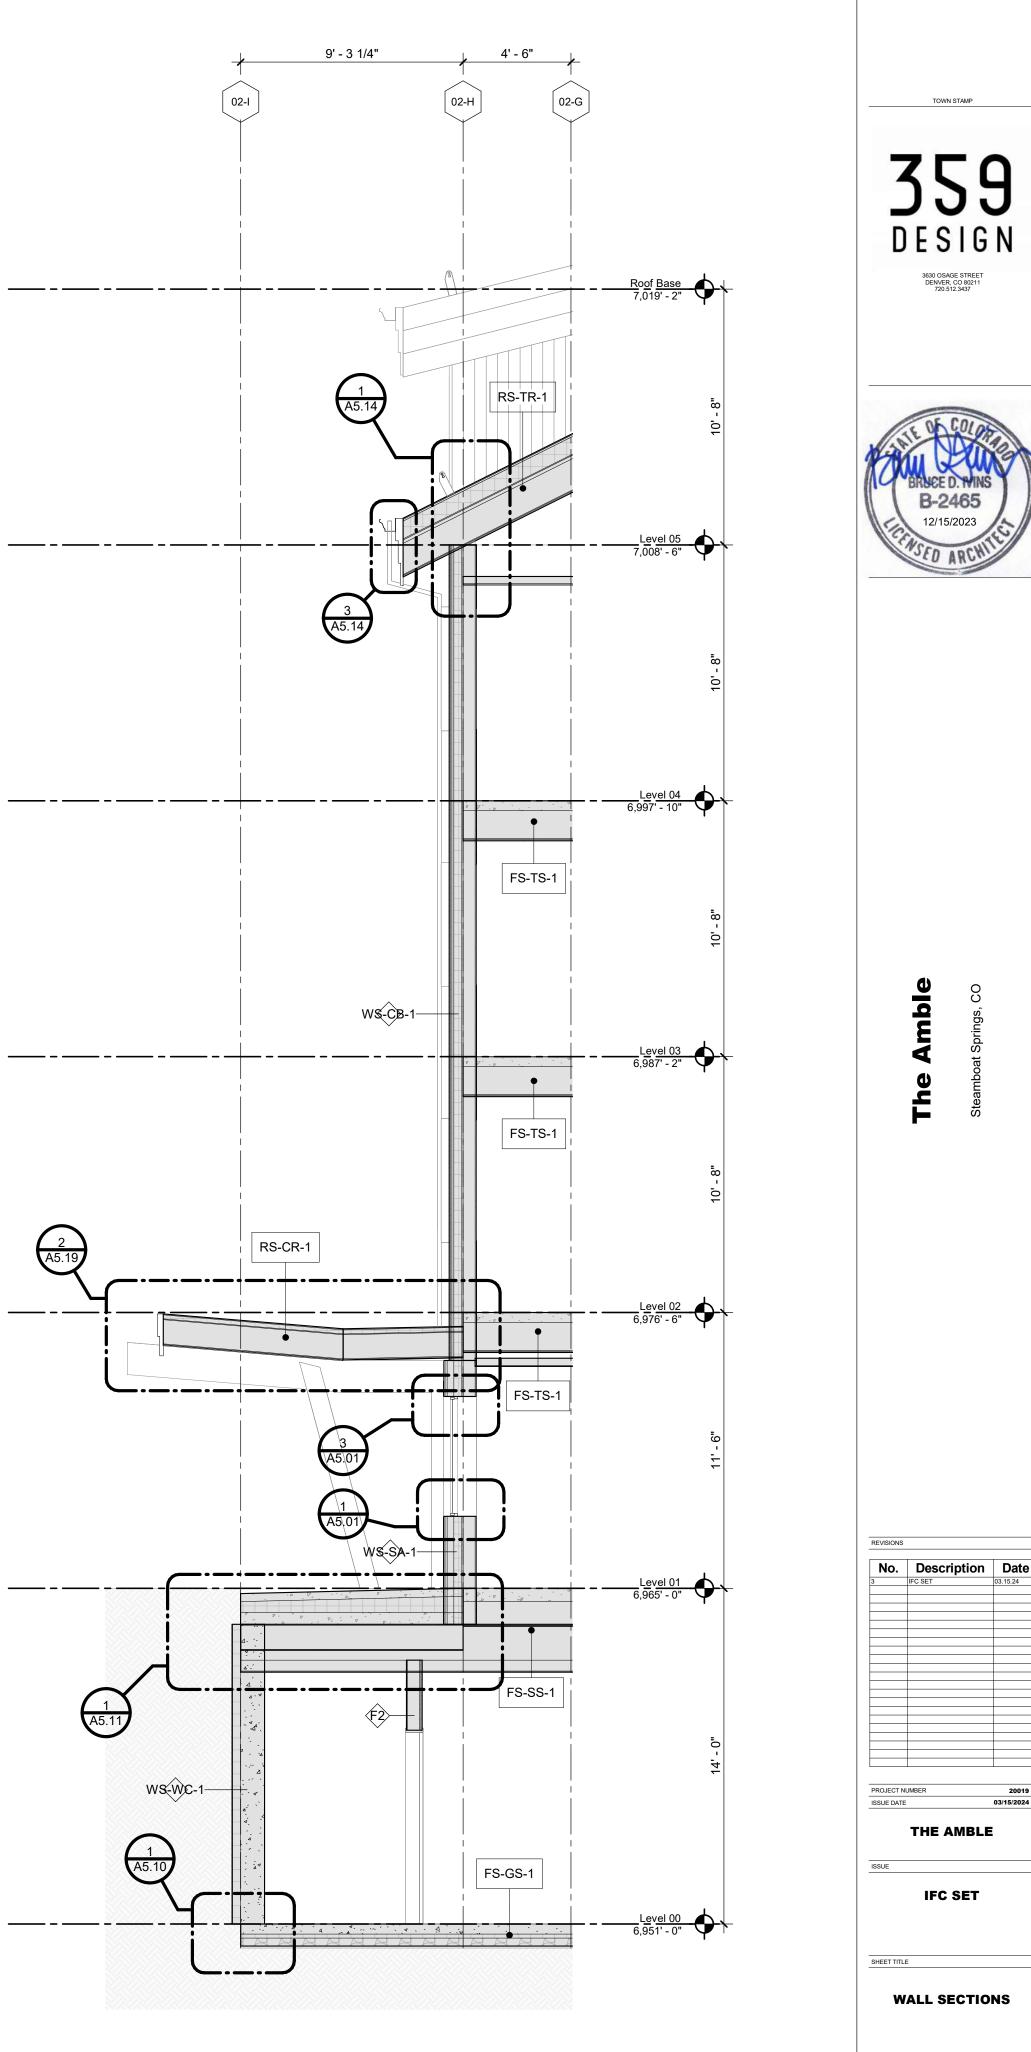

TOWN STAMP

3630 OSAGE STREET DENVER, CO 80211 720.512.3437

20019


03/15/2024

IFC SET

A3.10

SHEET NO.

WS1_EAST LOBBY 01 1/4" = 1'-0"

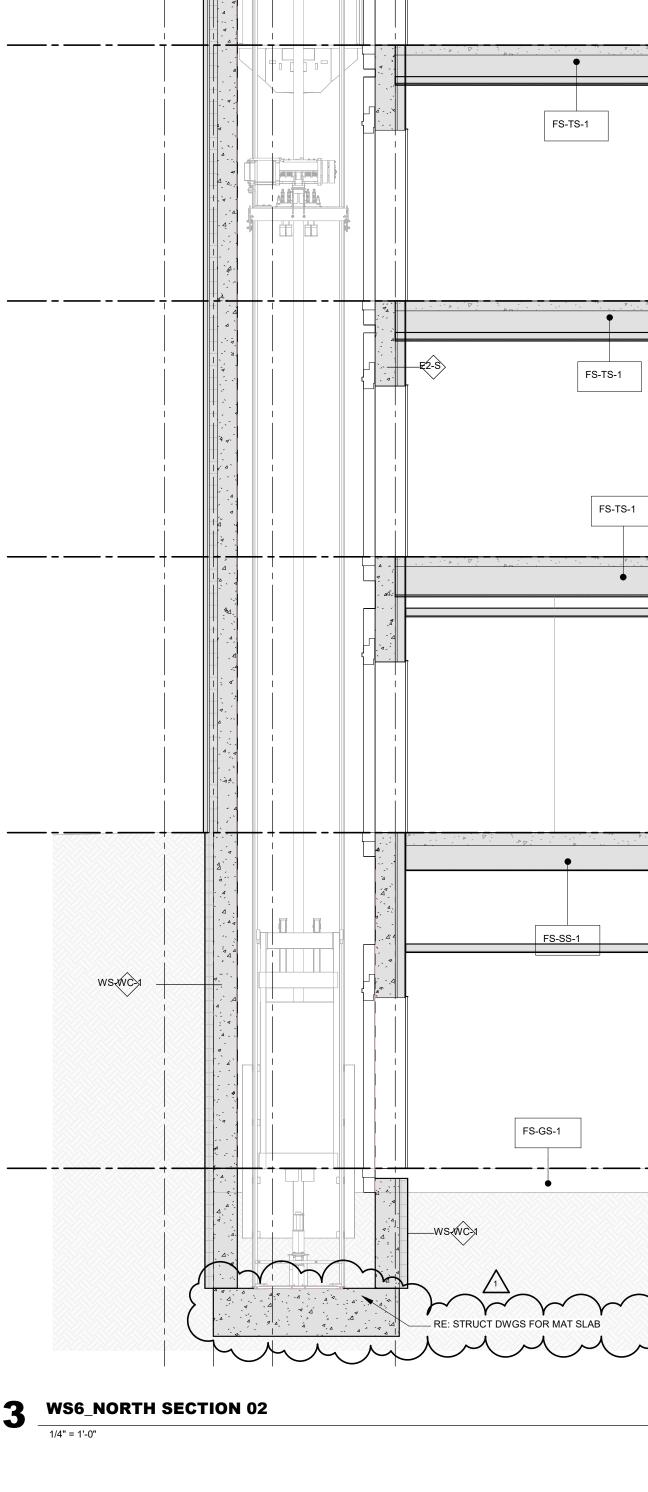

2' - 0 1/2"

01-A

WS-WM-

01-B

2' - 5 1/2" 5' - 1 1/2"

01-D

12' - 7"

RS-FL-1

•


2 A5.24

•

•


—₹2-\$

3

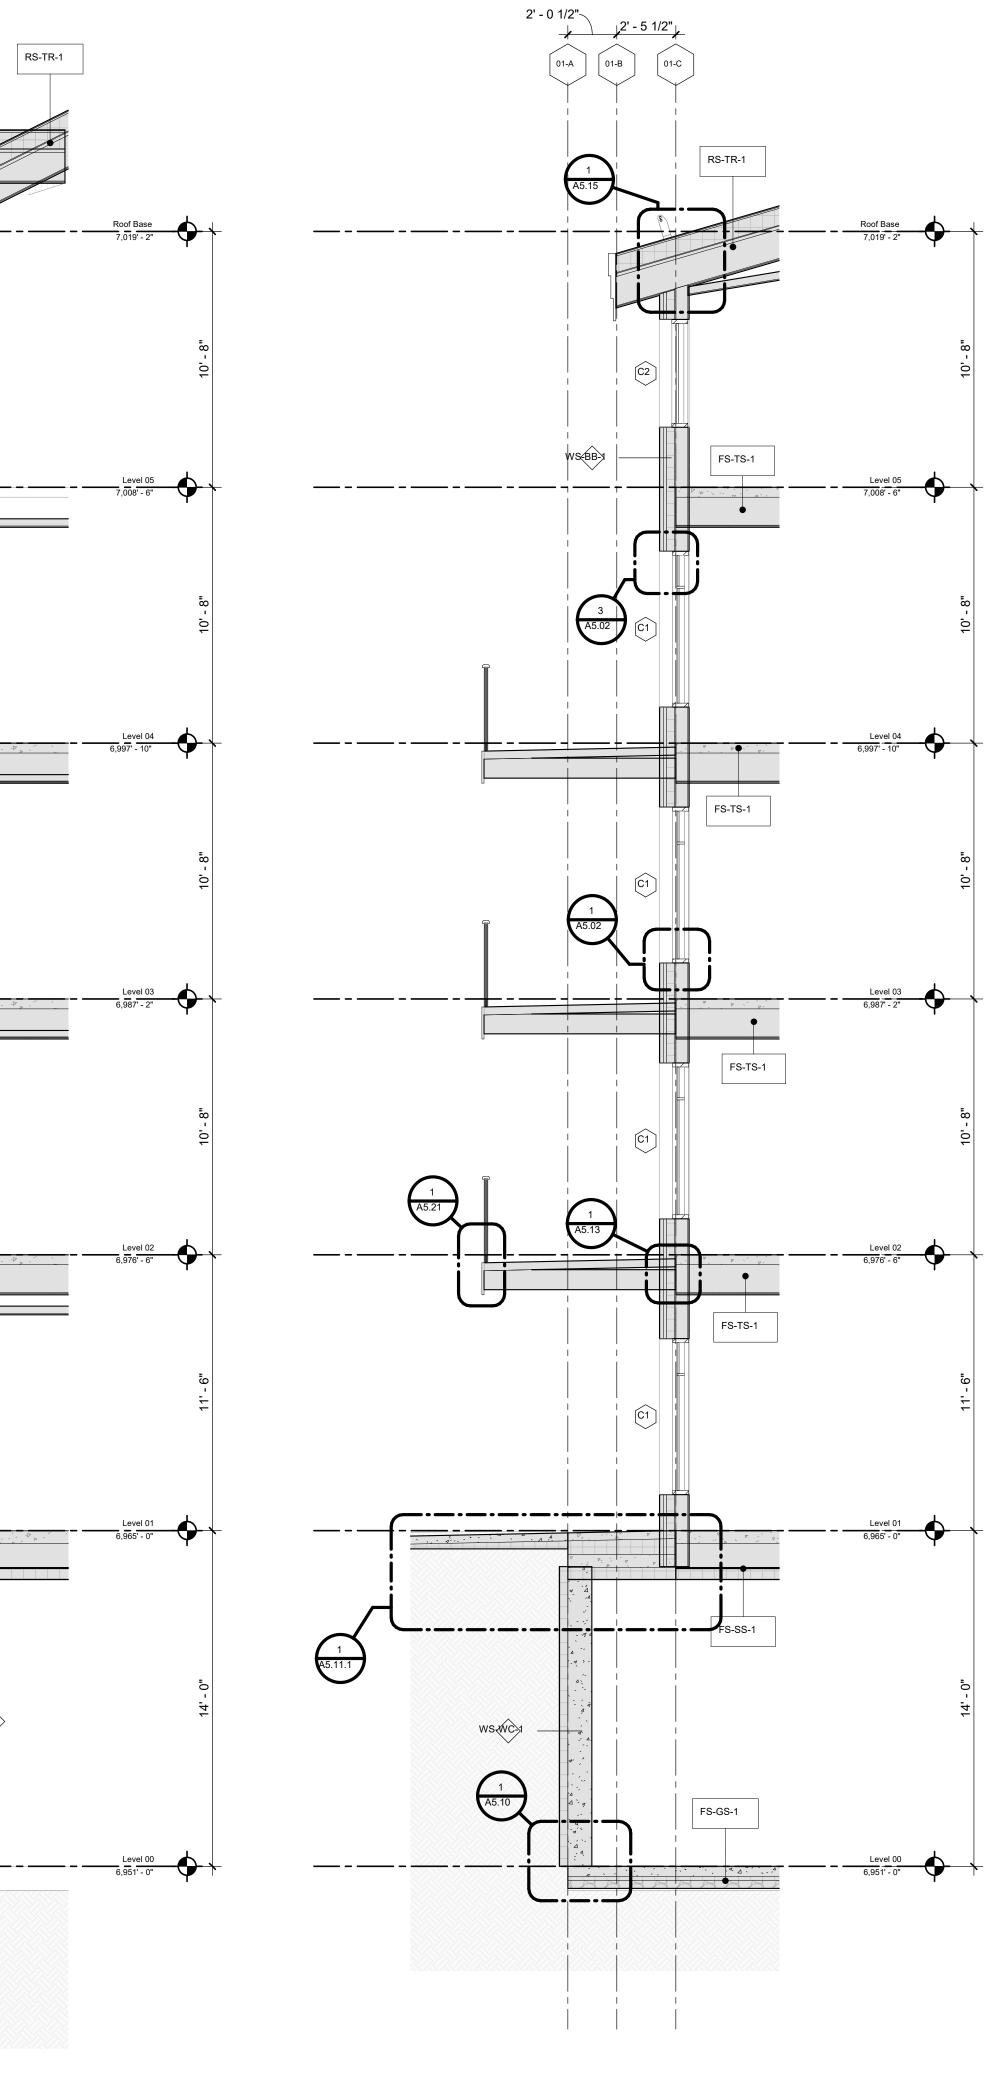


WS5_NORTH SECTION 01 2

1/4" = 1'-0"

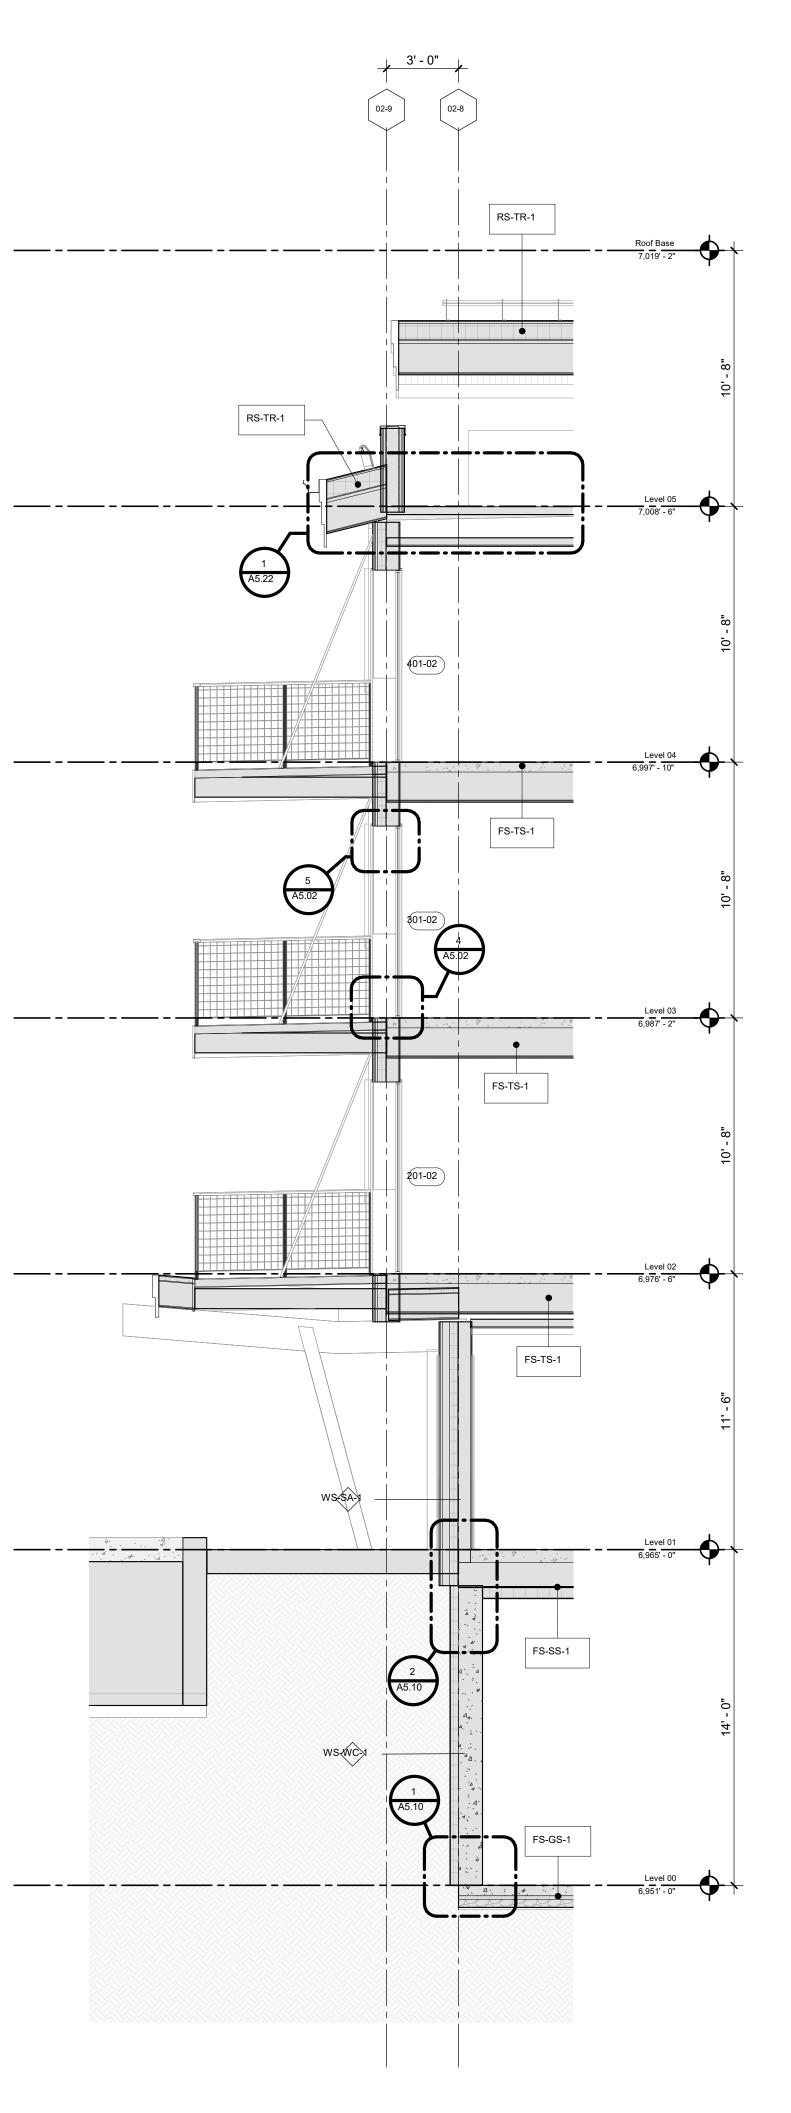






WS4_North Lobby 01

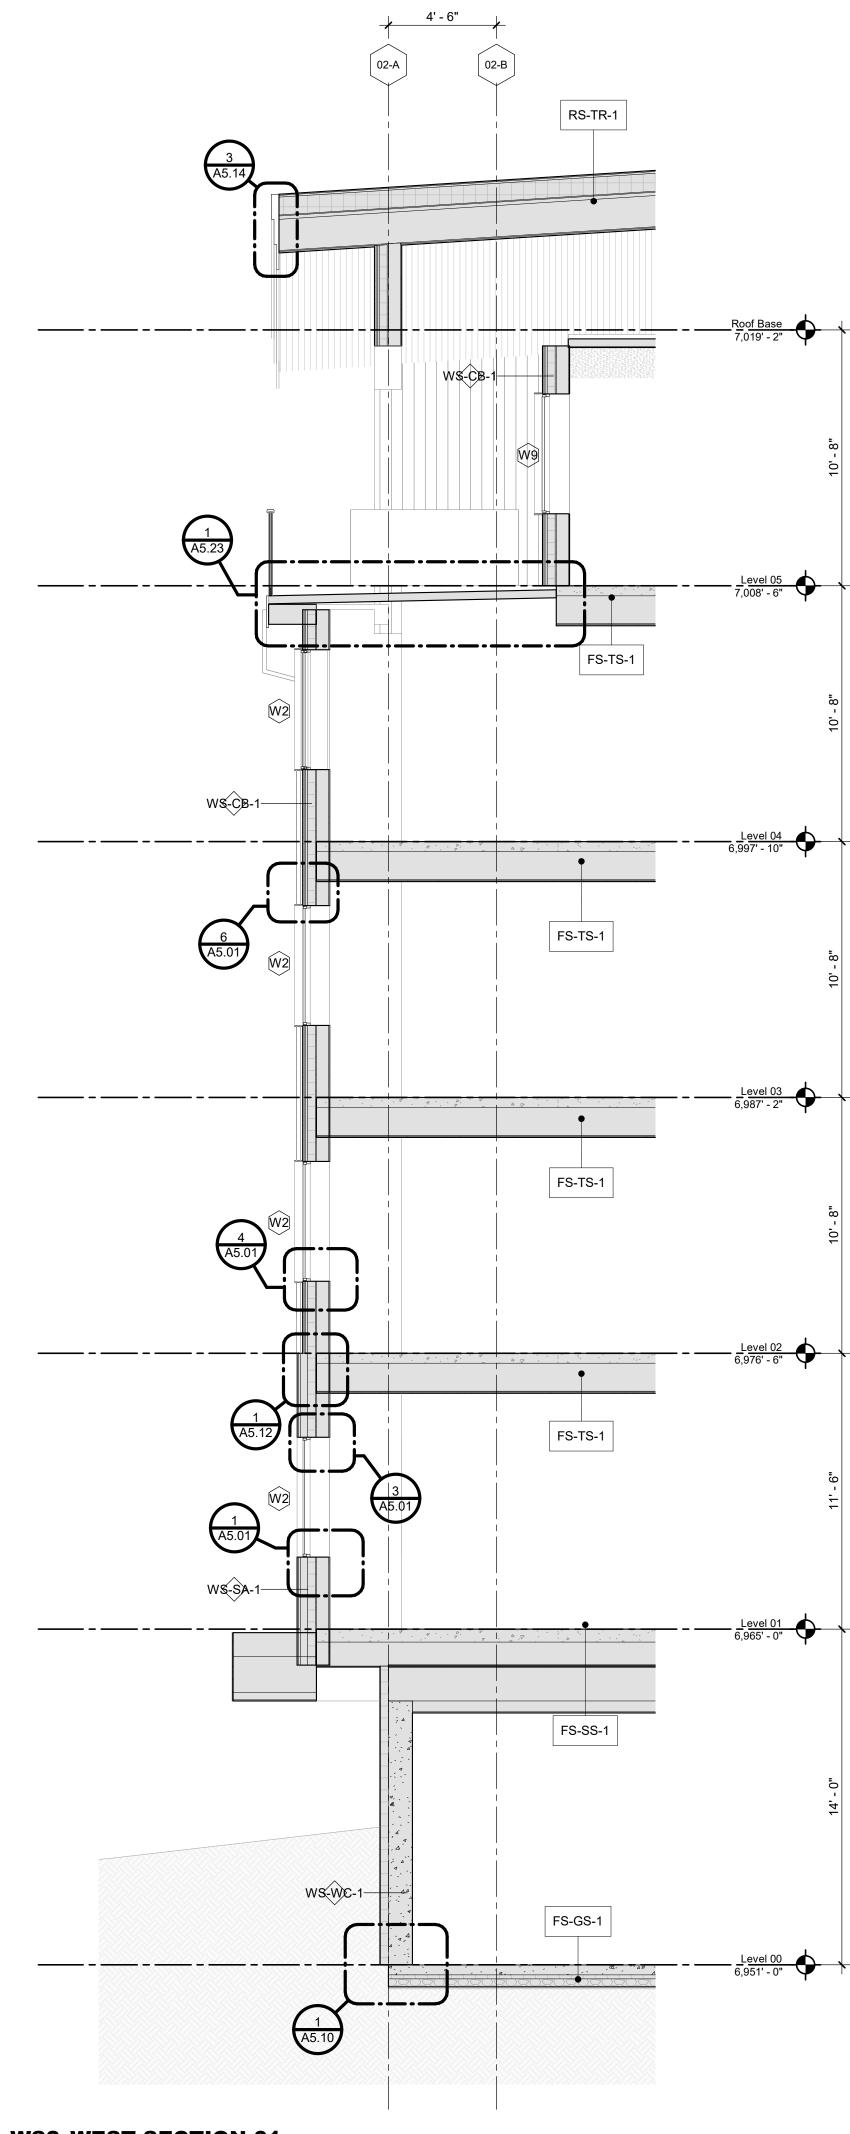




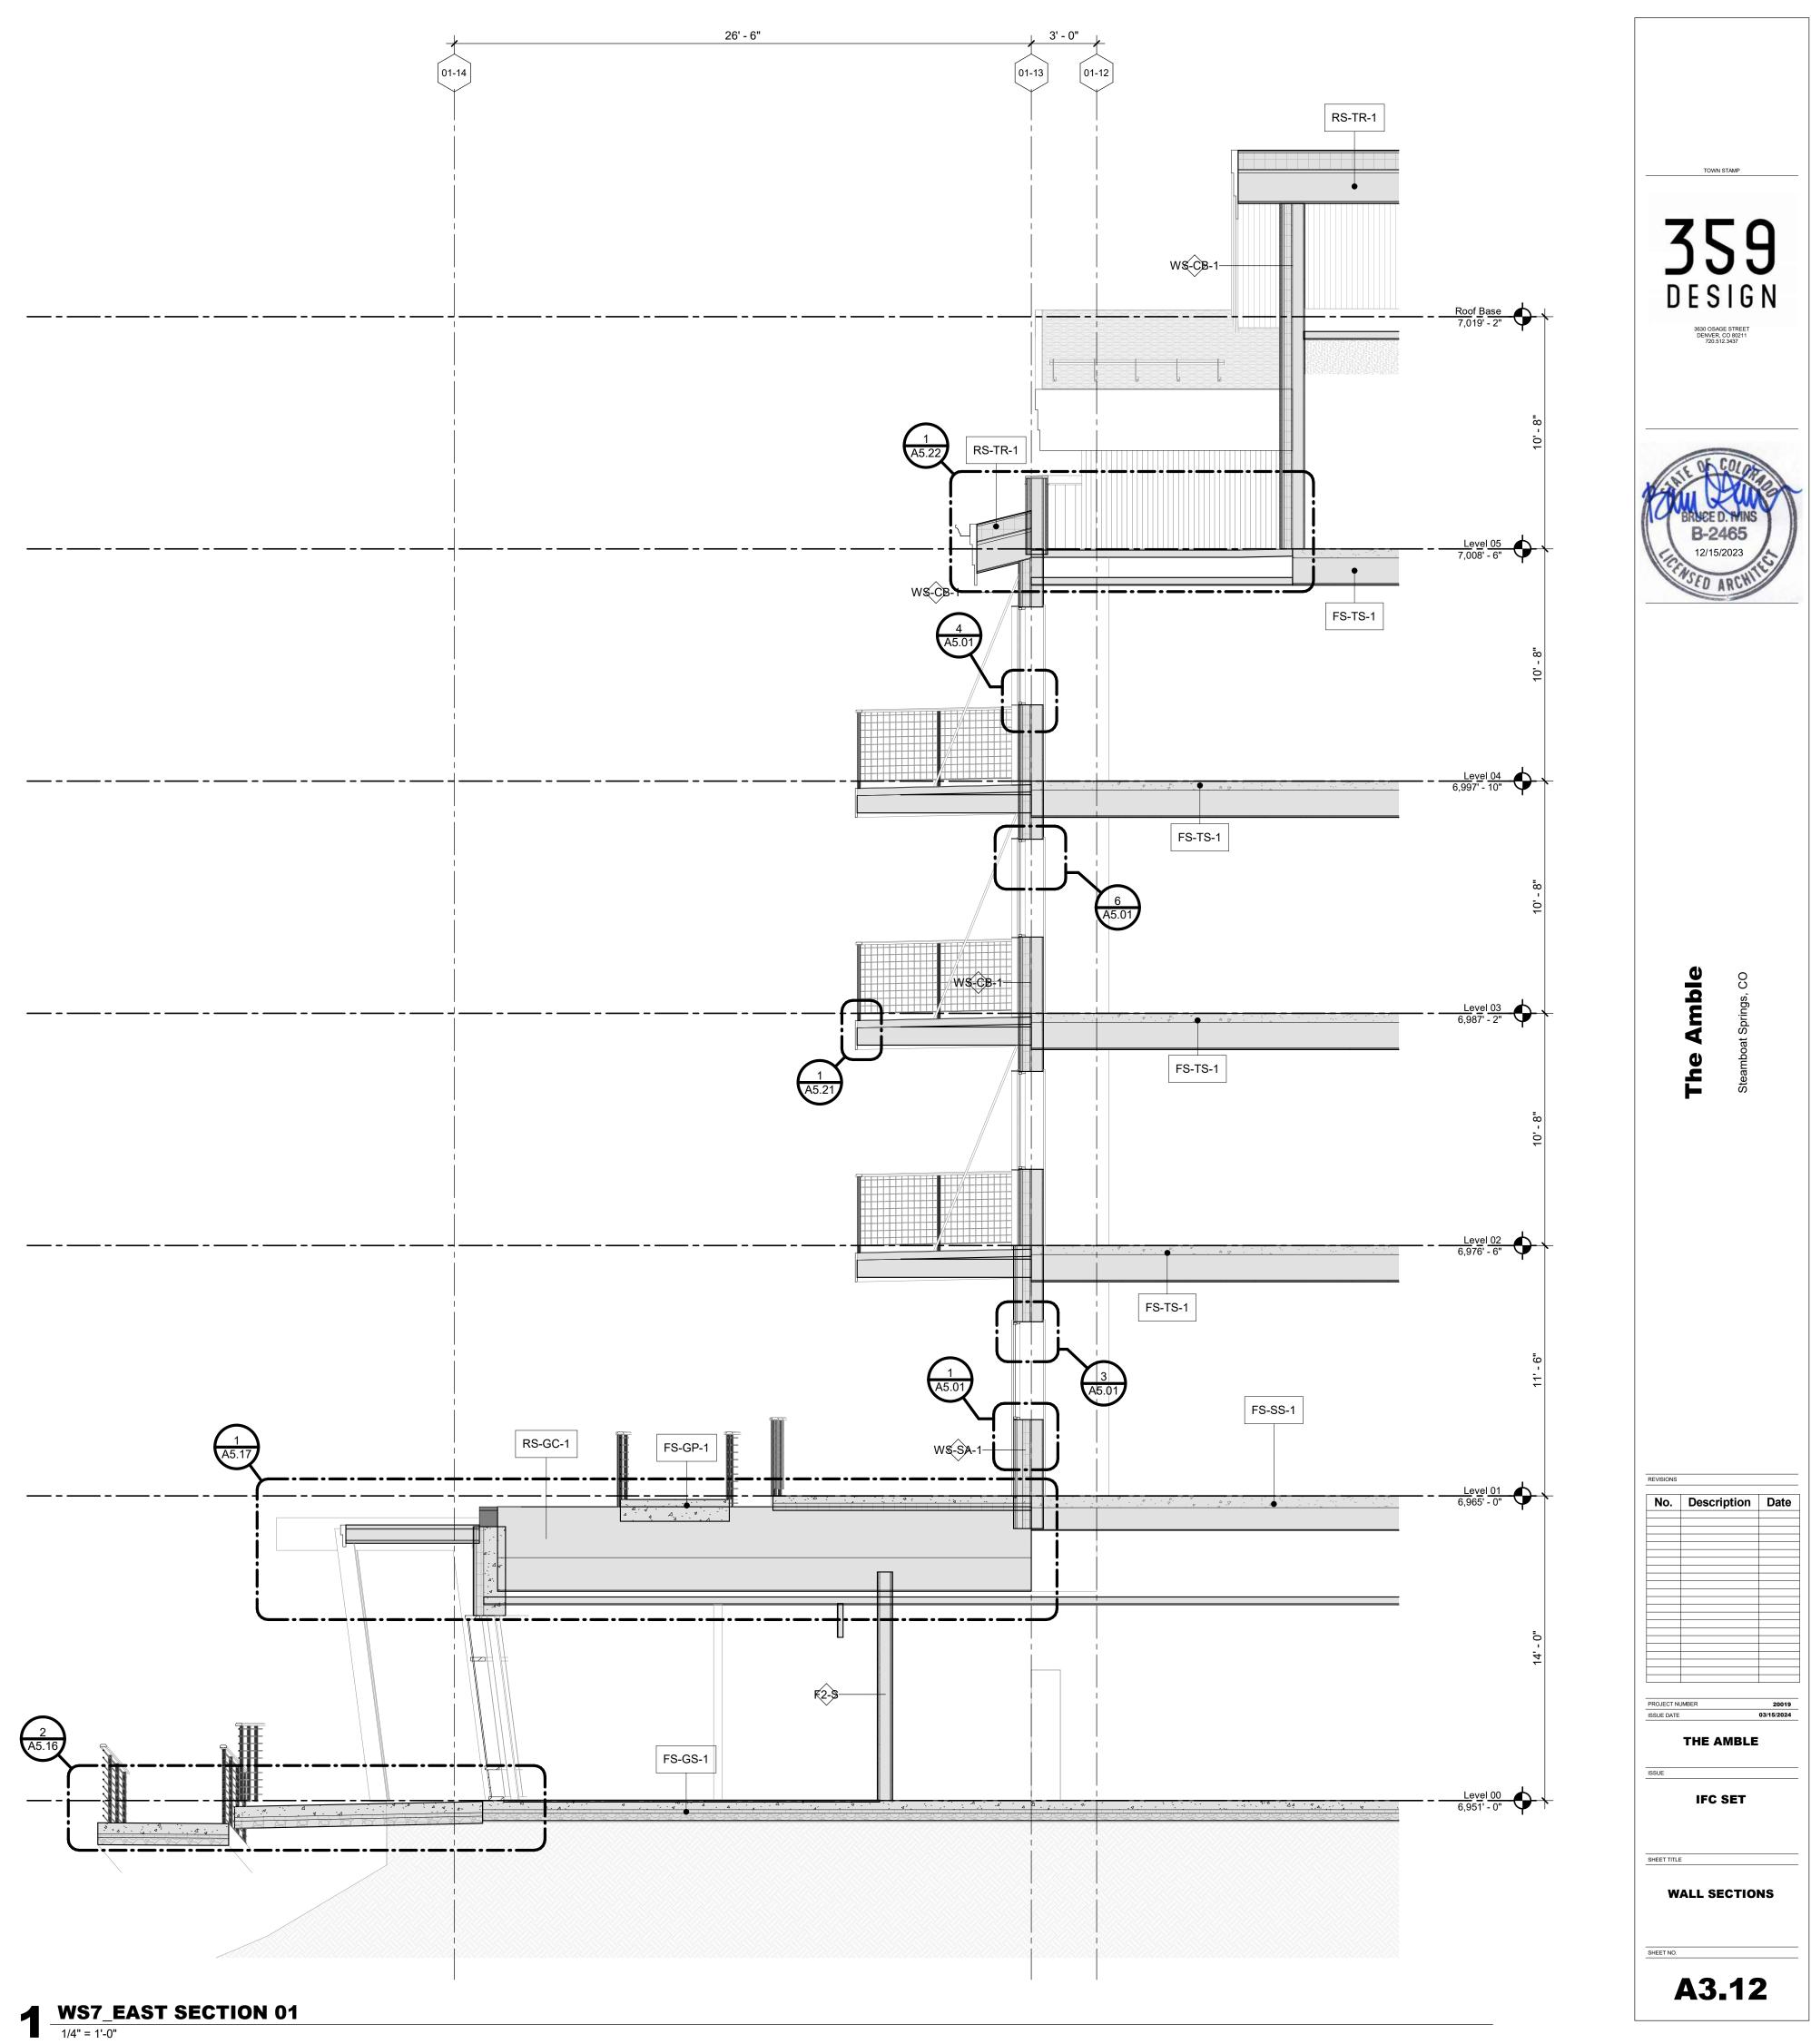


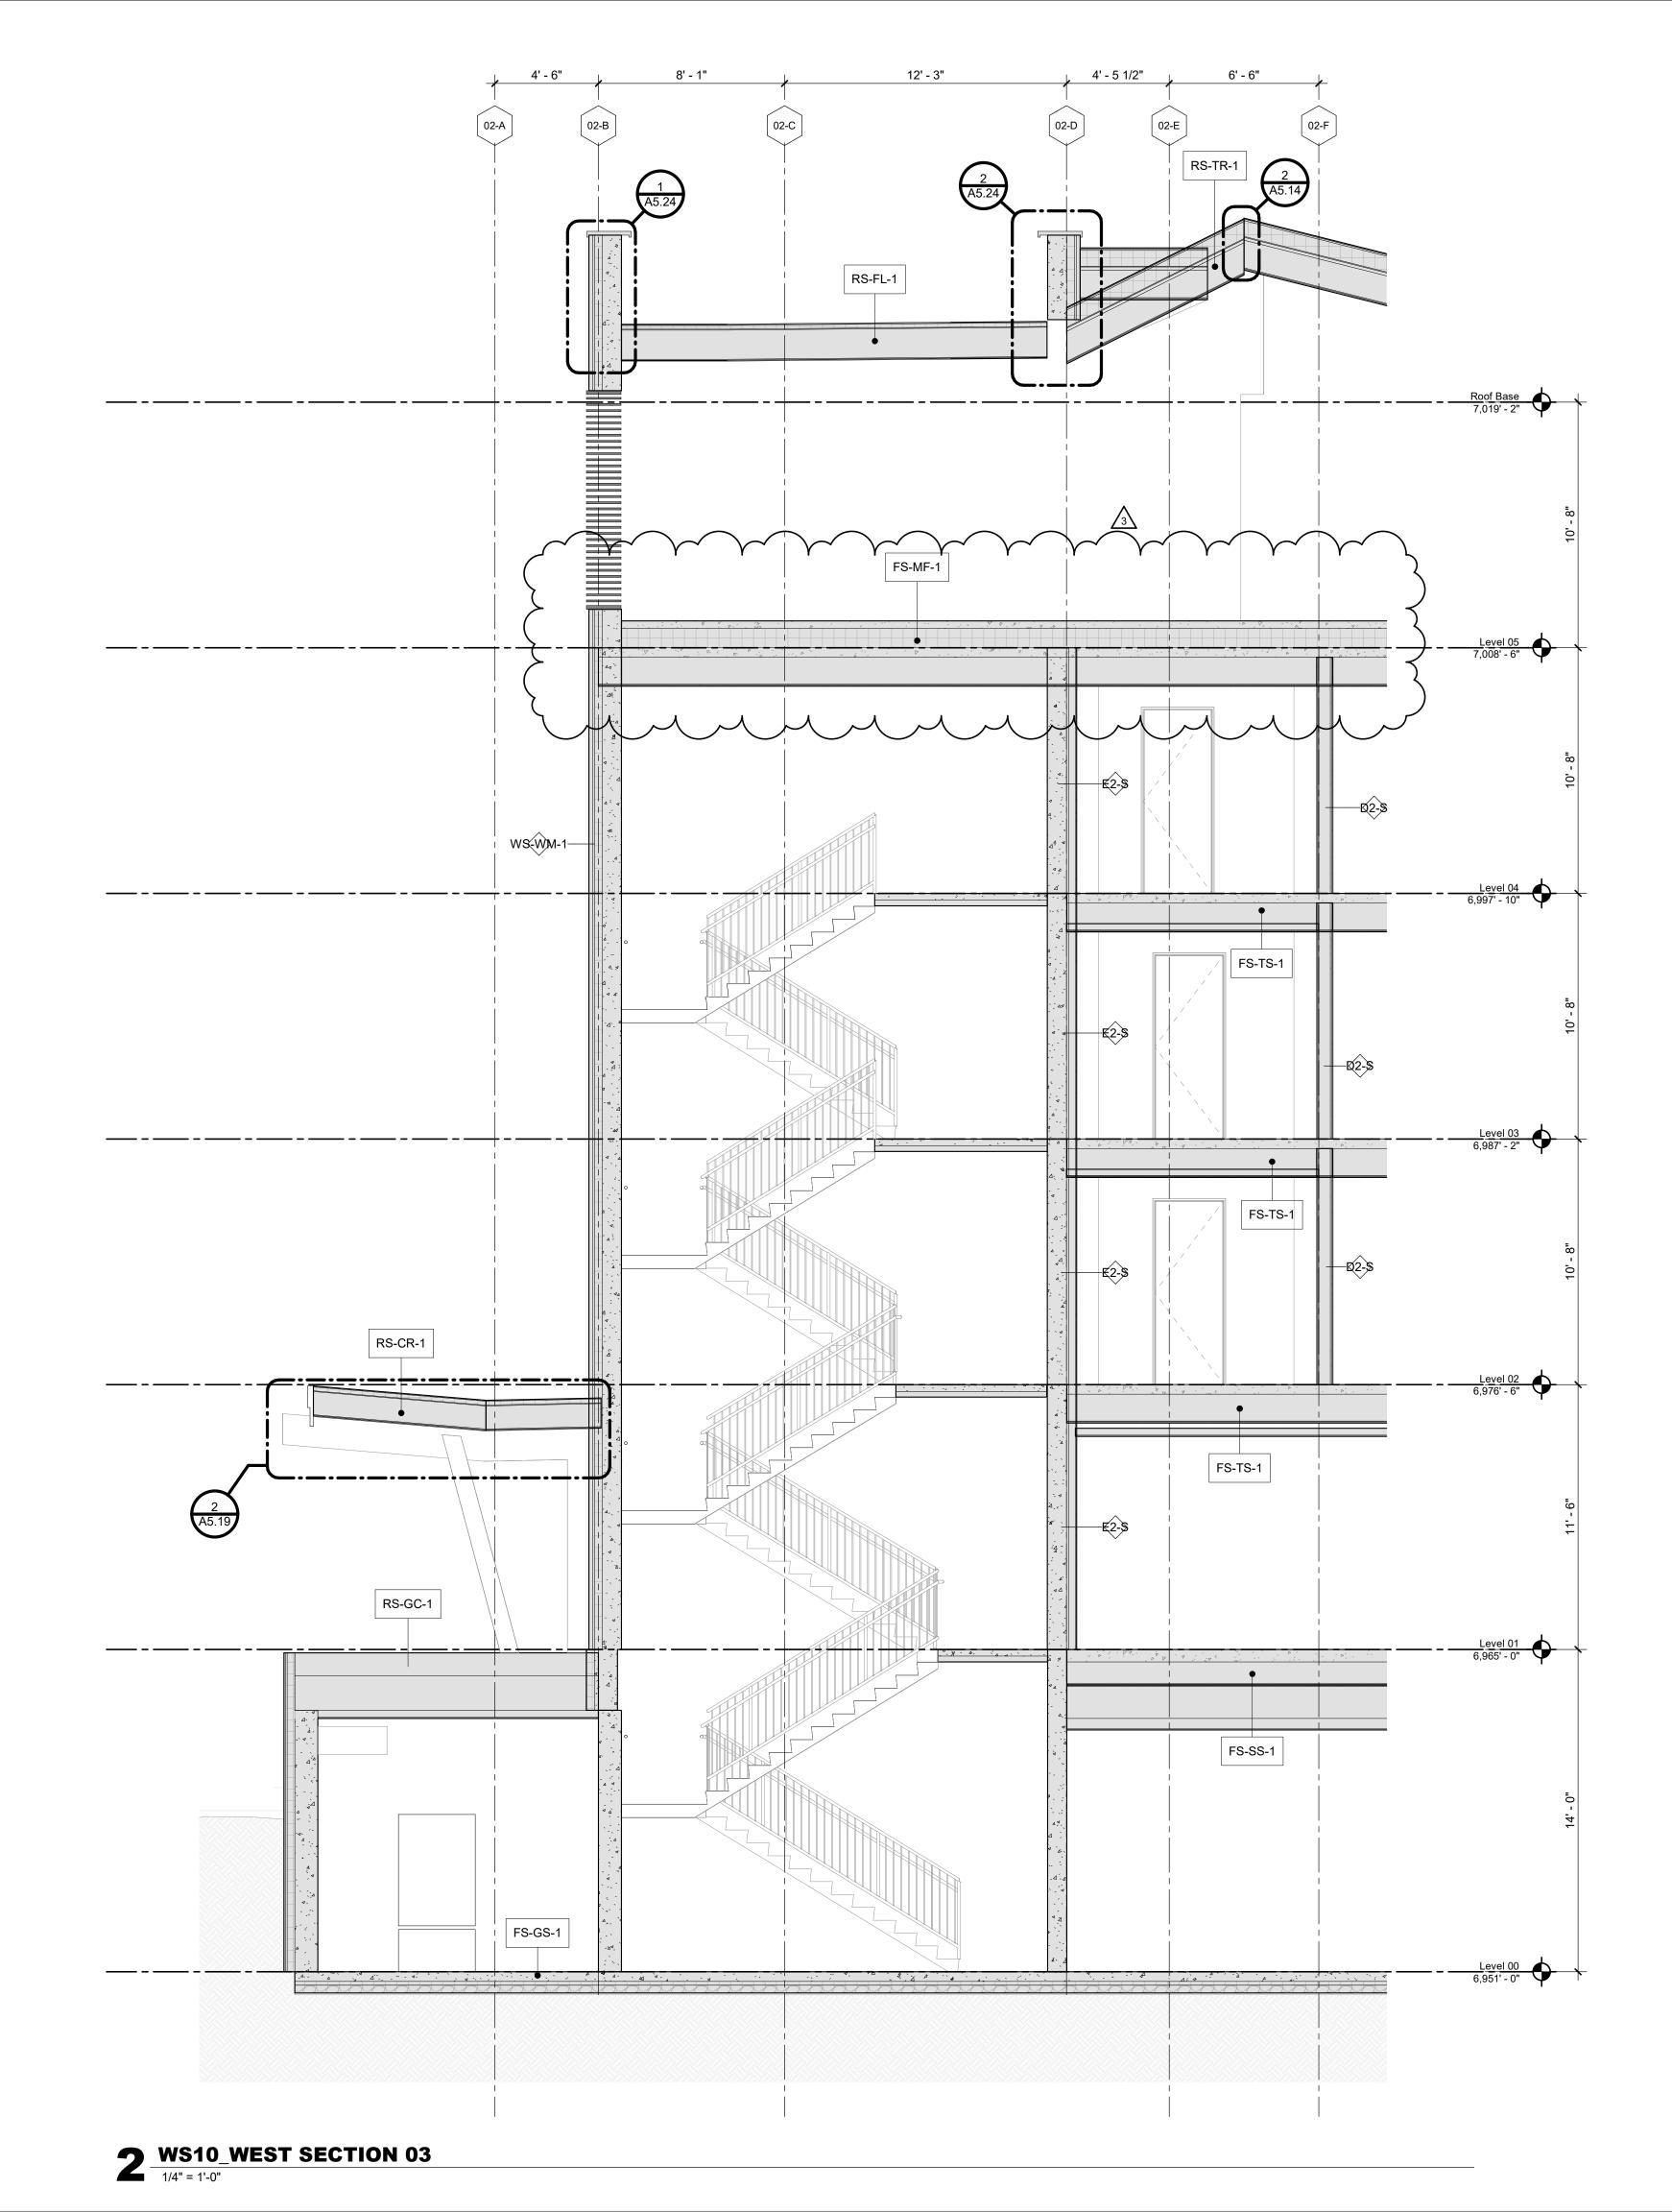

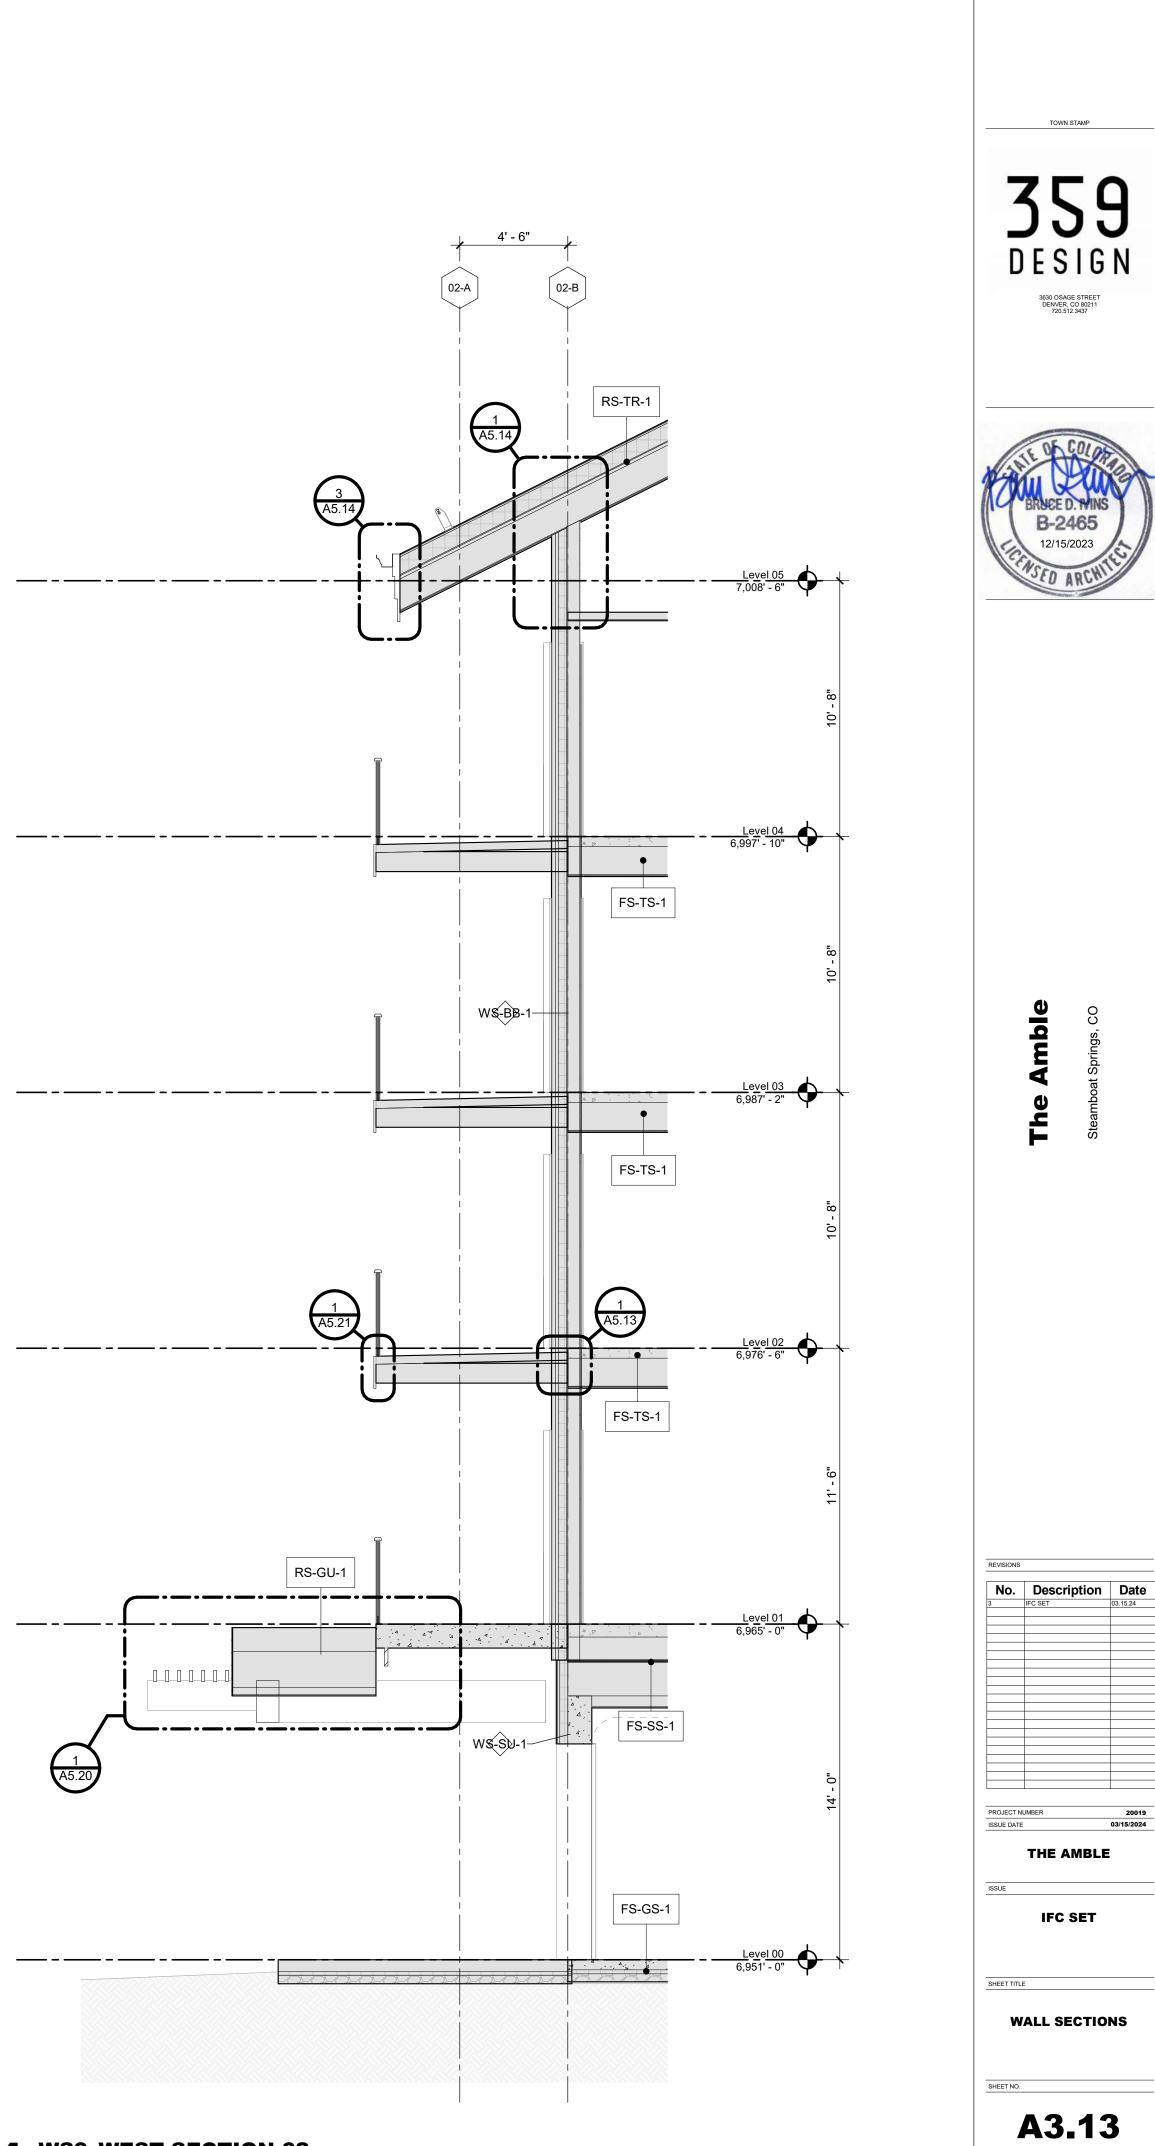


WS9_WEST SECTION 02 1/4" = 1'-0"

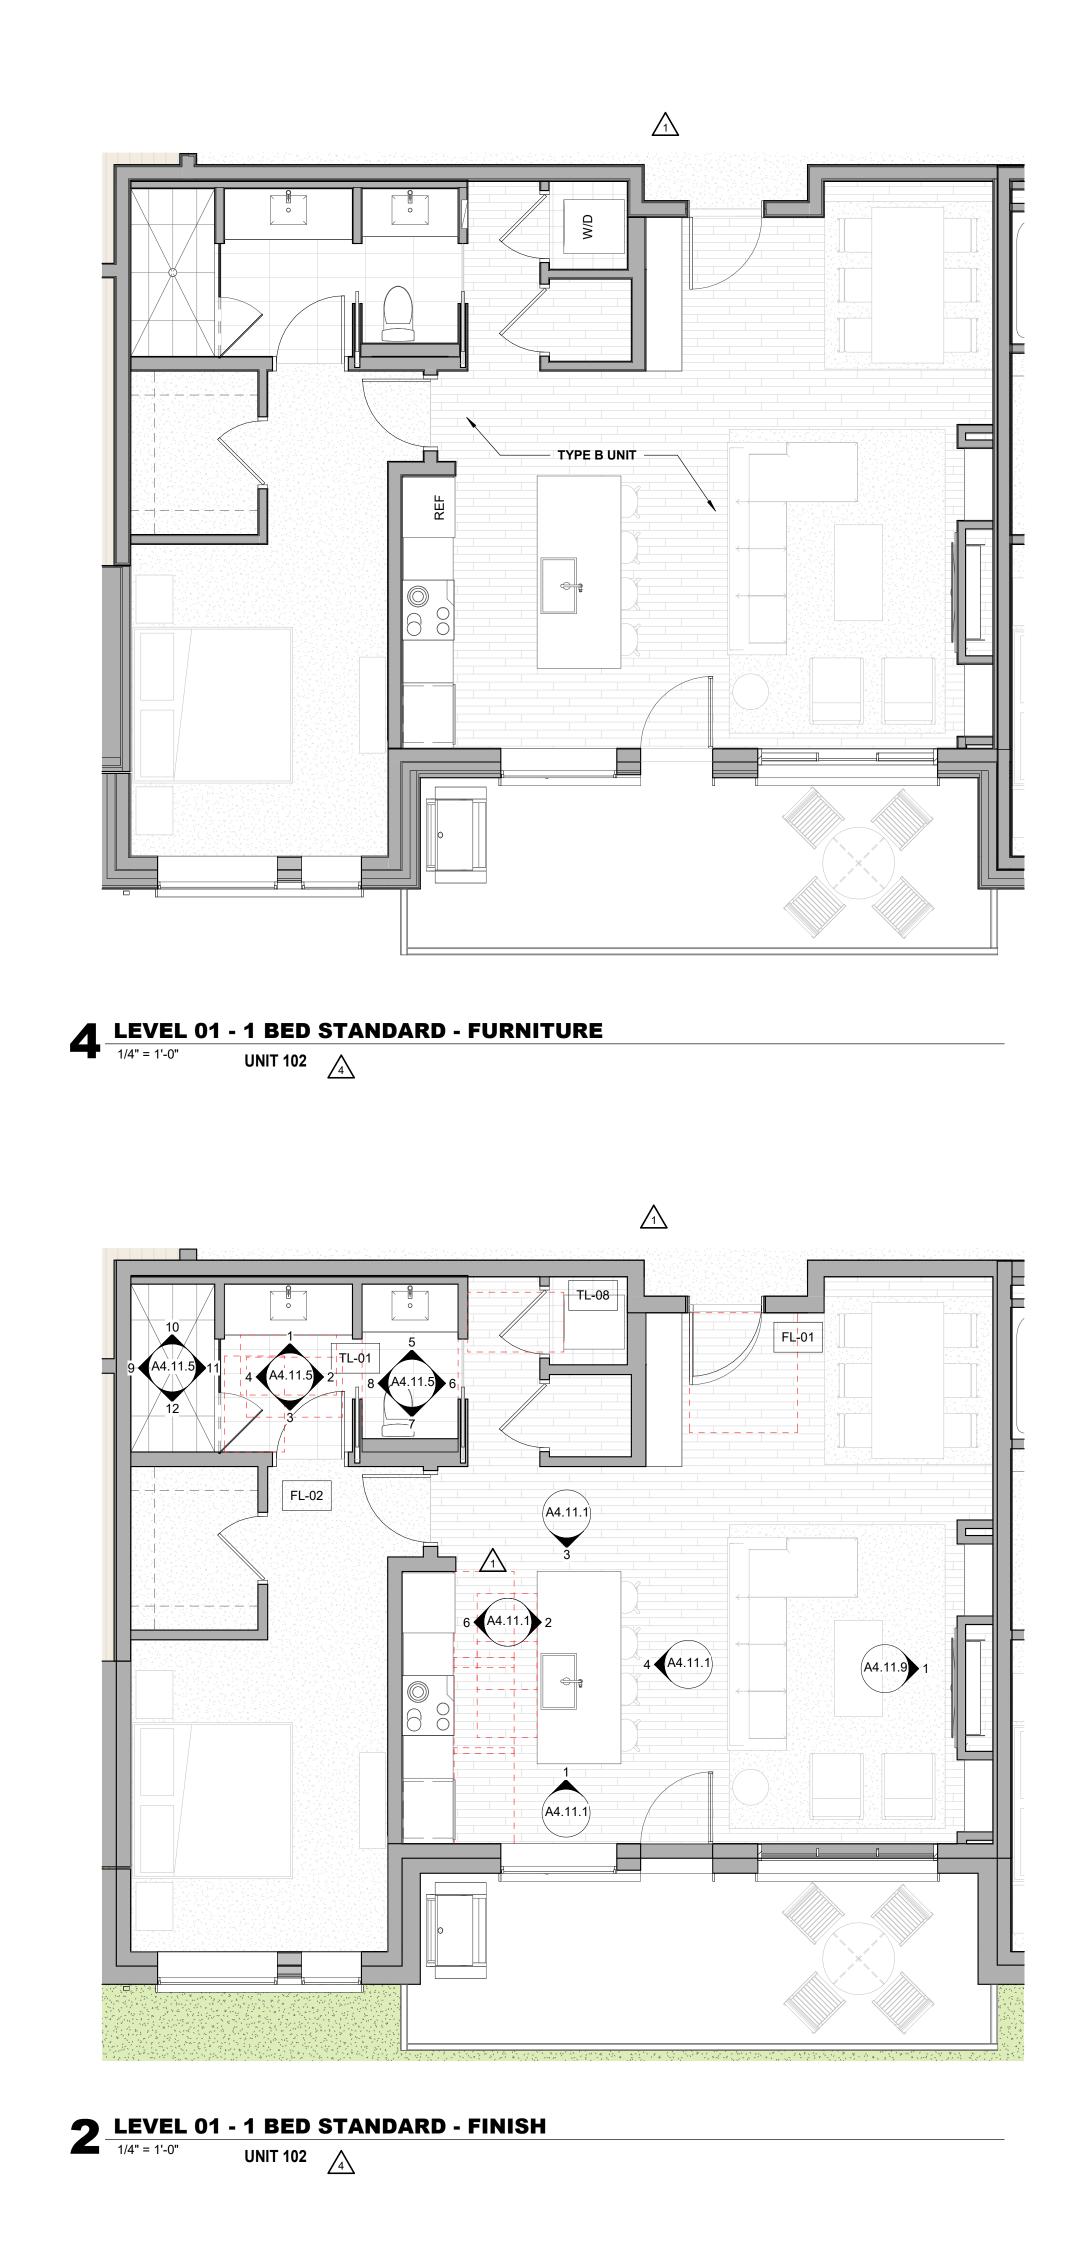

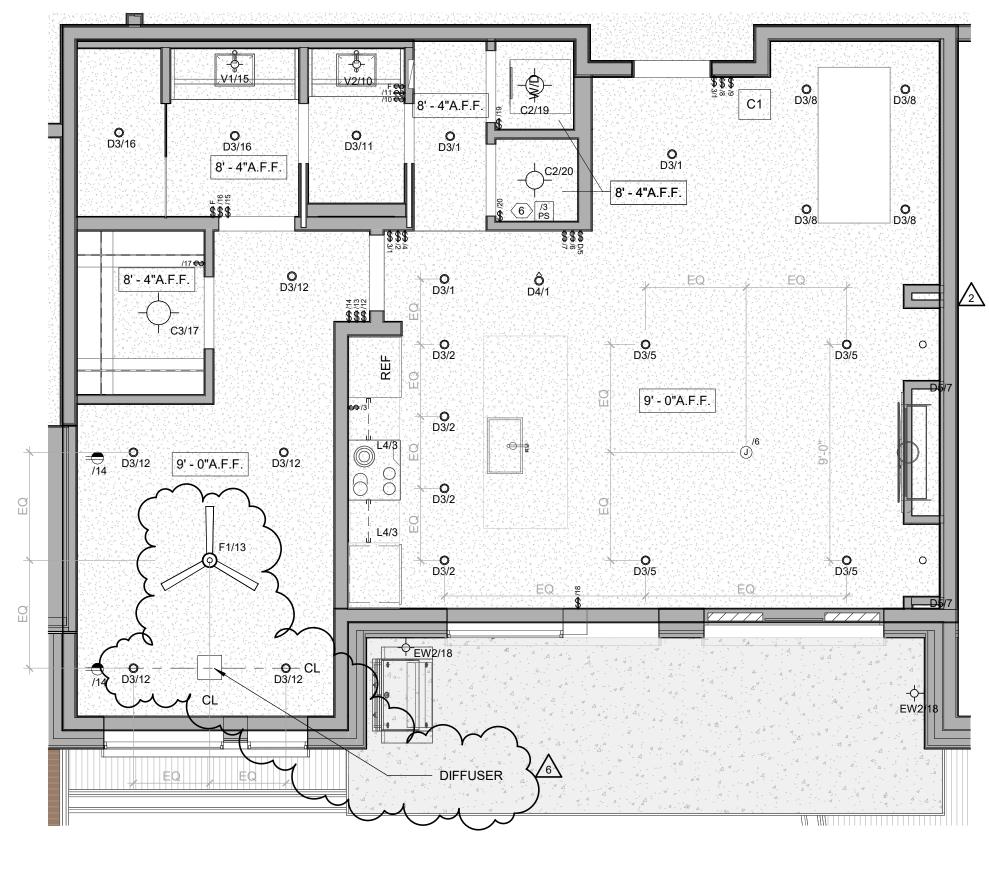



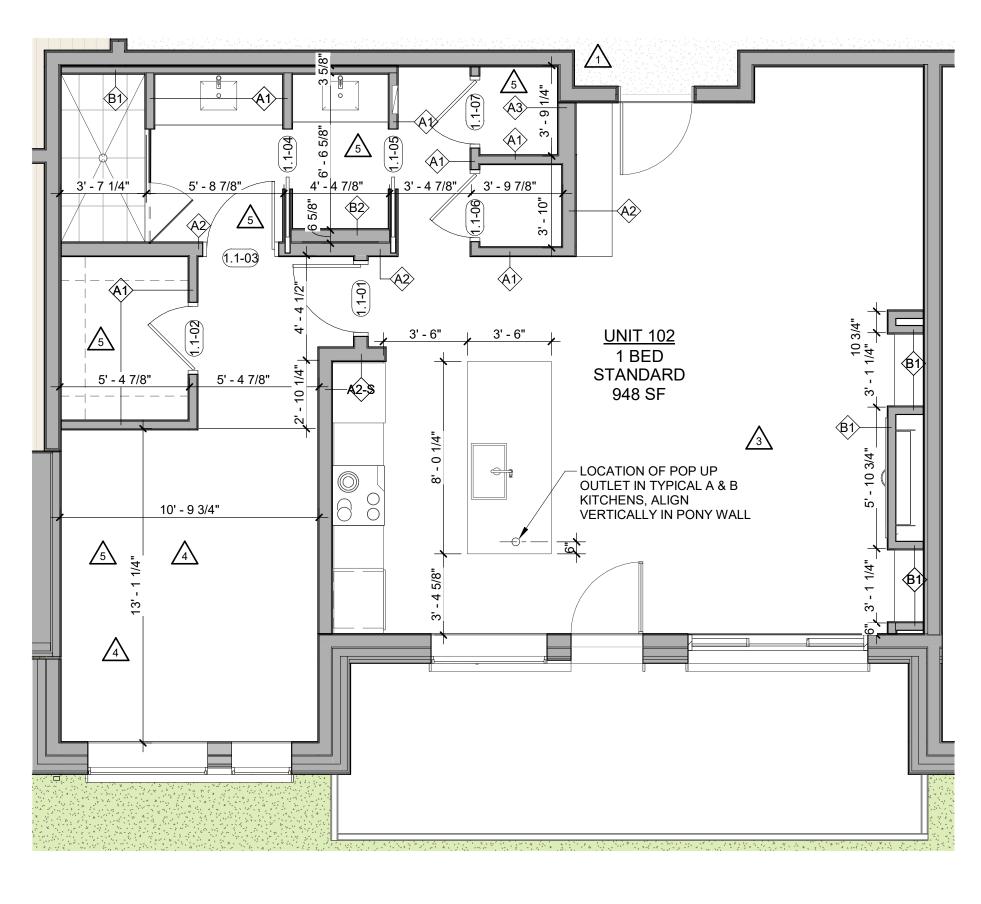

LEVEL 01 - 1 BED STANDARD - DIMENSION

UNIT 102

1/4" = 1'-0"

ENLARGED FLOOR PLAN - GENERAL NOTES

- 1. REFER TO G0.2X SHEETS FOR EXTERIOR AND INTERIOR BUILDING ENCLOSURE ASSEMBLIES.
- REFER TO A1.0X SHEETS FOR EXTERIOR WALL, DEMISING WALL, AND CORRIDOR WALL TYPES AND LOCATIONS.
 REFER TO A1.1X SHEETS FOR INTERIOR AND EXTERIOR WINDOW/DOOR TAGS WITH UNIT BACKGROUNDS FOR
- REFERENCE. 4. ALIGN WALLS WHERE THEY APPEAR TO ALIGN, U.N.O.
- 5. THE INSIDE FACE OF DOOR JAMBS SHALL BE 4" FROM ADJACENT WALL OR FINISHED COLUMN, U.N.O.
- B. PROVIDE BLOCKING FOR ALL WALL MOUNTED EQUIPMENT AND ACCESSORIES.
- THE CENTERLINE OF ALL RESIDENTIAL TOILETS SHALL BE
- LOCATED 18" OFF OF FINISH FACE OF WALL, U.N.O. SWING CLEARANCE AT UNIT ENTRY SHALL BE 18" MIN.
- FROM FINISH FACE OF ADJACENT SURFACE. ALL DIMENSIONS ARE TO FACE OF STUD, GRID LINE, OR FACE OF CONCRETE, U.N.O.
- 10. WHERE "CLEAR" IS CALLED OUT ON A DIMENSION, PROVIDE DIMENSION FROM FACE OF FINISH TO FACE OF FINISH.
- FURNITURE IS NOT IN CONTRACT, U.N.O., AND IS SHOWN FOR DIAGRAMATIC PURPOSES ONLY.
 CONSULTANT MODELS SHOWN FOR REFERENCE ONLY.

ENLARGED FLOOR PLAN - LEGEND

	CARPET RE: FINISH SCHED.		RUBBER (F7) RE LANDSCAPE
	TILE RE: FINISH SCHED.		CONCRETE (F8) RE: LANDSCAPE
	WOOD - UNIT RE: FINISH SCHED.		PAVERS (F9) RE: LANDSCAPE
	WOOD - PUBLIC RE: FINISH SCHED.		
4 - 4 	POLISHED CONC. (F5.1) INTERIOR		
	SEALED CONC. (F5.2) INTERIOR		
	HERRINGBONE TILE (F6) RE: FINISH SCHED.		
ENI	ARGED FLOOR PLAN - (CLEARA	NCE NOTES
	FLOOR CLEARANCE		
Α	DOOR CLEARANCE, 54" X	60"	
В	APPLIANCE CLEARANCE,	30" X 48"	
С	CLEAR FLOOR CLEARANC	E, 30" X	48"


- D VANITY CLEARANCE, 30" X 48"
- E TOILET CLEARANCE, 48" X 56" OR ADA 60" X 56"
- F SHOWER/TUB CLEARANCE, 30" X 48" (B)
- G TURN AROUND CLEARANCE
- GRAB BAR BLOCKING REQ. AT TOILET WALL WHERE APPLICABLE

ENLARGED RCP - GENERAL NOTES

- ALL UNIT CEILINGS SHALL BE 9' 0" A.F.F. U.N.O. REFER TO ENLARGED RCP'S FOR COMMON AREA CEILING HEIGHTS.
 IN THE CASE OF MINOR DISCREPANCIES BETWEEN MEP
- AND ARCHITECTURAL DOCUMENTS ON THE LOCATION OF CEILING MOUNTED COMPONENTS, THE ARCHITECTURAL RCP'S GOVERN. IN THE CASE OF MAJOR DISCREPANCIES, THE ARCHITECT SHALL BE NOTIFIED AS SOON AS THE DISCREPANCY IS DISCOVERED PRIOR TO PROCEEDING WITH THE WORK.
- 3. REFERENCE MECHANICAL AND ELECTRICAL DRAWINGS FOR MOUNTING LOCATIONS OF ITEMS WHERE NO CEILING IS REQUIRED OR INDICATED.
- 4. COORDINATE ALL TRADES INVOLVED IN THE CEILING WORK TO ENSURE CLEARANCE FOR FIXTURES, DUCTS, PIPING, CEILING SUSPENSION SYSTEMS, ETC. NECESSARY TO MAINTAIN CEILING HEIGHTS NOTED.
- LIGHTS, DIFFUSERS, EXIT SIGNS, SMOKE DETECTORS, SPEAKERS, STROBES, AND MISC. DEVICES SHALL BE CENTERED IN THE CEILING WHERE THEY OCCUR, U.N.O.
 FIRE PROTECTION SCOPE SHALL BE DESIGN-BUILD. ALL
- CORRIDOR SPRINKLER HEADS SHALL BE ALIGNED IN THE SAME LOCATION PARALLEL TO THE WALL WITHIN EACH SPECIFIC CEILING CONSTRUCTION.
- 7. SMOKE ALARMS SHALL BE PROVIDED IN ALL BEDROOMS, OUTSIDE OF ALL BEDROOMS, AND ON EACH FLOOR AS REQUIRED. CARBON MONOXIDE DETECTORS SHALL BE INSTALLED OUTSIDE OF ALL BEDROOMS. SMOKE ALARMS AND CO DETECTORS SHALL BE HARDWIRED AND HAVE BATTERY BACKUP.
- 8. ACCESS DOOR LOCATIONS IN GYPSUM BOARD CEILINGS ARE INDICATED ON RCP'S ONLY WHERE ARCHITECTURALLY SIGNIFICANT. REFERENCE SPECIFICATIONS AND MEP DRAWINGS FOR OTHER ACCESS DOOR LOCATIONS.
- 9. UNLESS PREFINISHED TO MATCH ADJACENT SURFACE, PAINT MECHANICAL GRILLS, DIFFUSERS, ACCESS PANELS, AND OTHER EQUIPMENT TO MATCH ADJACENT SURFACE.
 10. EXIT SIGNS ARE SHOWN ON RCP'S ONLY WHERE
- EXIT SIGNS ARE SHOWN ON RCF S ONLY WHERE LOCATIONS ARE ARCHITECTURALLY SIGNIFICANT.
 PROVIDE UL-CLASSIFIED LIGHT FIXTURES OR ENCLOSURES IN RATED FLOOR/CEILING ASSEMBLIES IN
- ACCORDANCE WITH IBC CHAPTER 7. 12. REFER TO LIGHTING PLANS FOR EXACT FIXTURE TYPES AND LOCATIONS. FIXTURES SHOWN HERE ARE
- REFERENCED AND SHOWN FOR GENERAL ALIGNMENT.


(GWB (C1) INTERIOR	\rightarrow	SLOPE CEILING AS NOTED
	T&G CEILING (C2) INTERIOR	0	CEILING MOUNTED LIGHT FIXTURE
	FIBER-CEMENT SOFFIT (C3) - EXTERIOR	+ + + + + + + + + + + + + + + + + + + +	VINYL SCRIM CLG - Interior
	ACCESS PANEL		ACCOUSTIC VINYL Tile CLG - Interioi

TOWN STAMP	
BRUCE D. MAR B-2465 12/15/2023	inter a
The Amble Steamboat Springs, CO	
REVISIONS No. Description 1 IFC SET 2 RFI #103 4 ASI 004 5 RFI #183 6 RFI #223.1 0 0 1 0 0 0 0 0 0 0 0 0 0 0 0 0 0 0 0 <td< th=""><th>03.15.24 06.14.24 08.07.24 08.02.24 10.16.24 20019 03/15/2024 .E - 1 NDARD -</th></td<>	03.15.24 06.14.24 08.07.24 08.02.24 10.16.24 20019 03/15/2024 .E - 1 NDARD -
SHEET NO.	.1

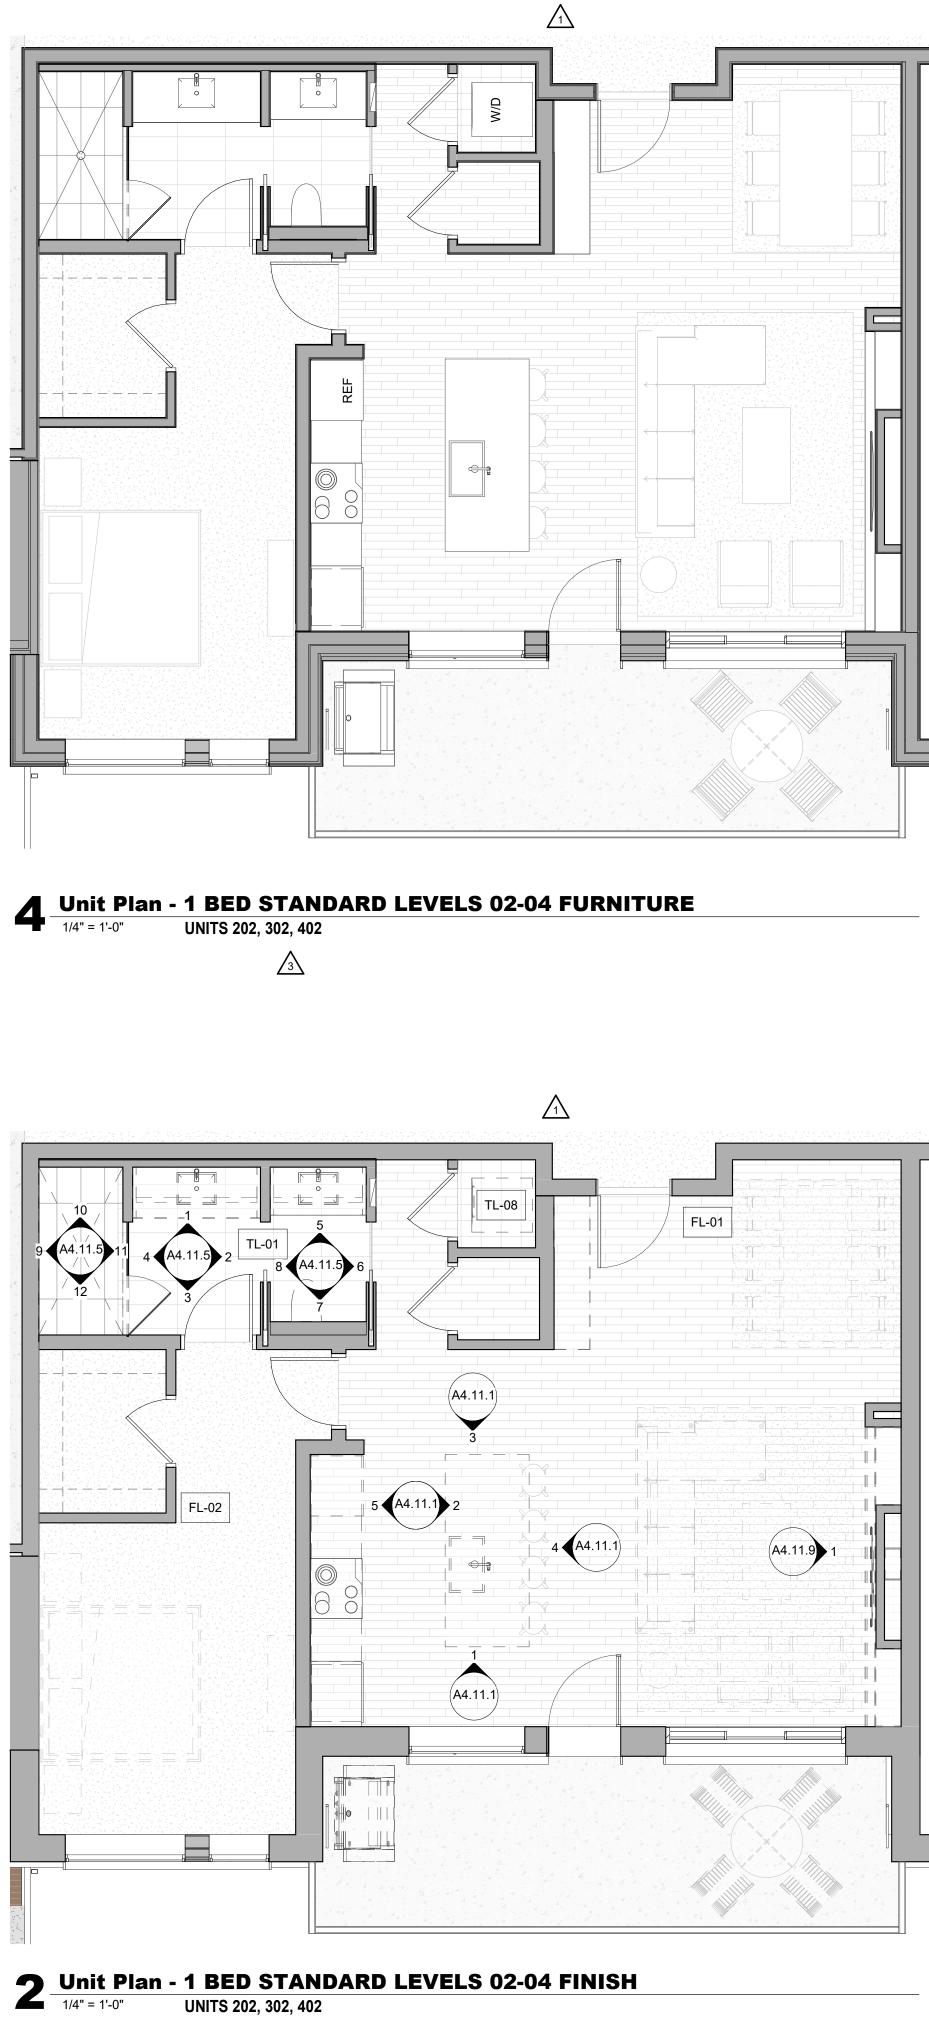



1 Unit Plan - 1 BED STANDARD LEVELS 02-04 RCP **5** <u>1/4" = 1'-0"</u> UNITS 202, 302, 402 $\sqrt{3}$

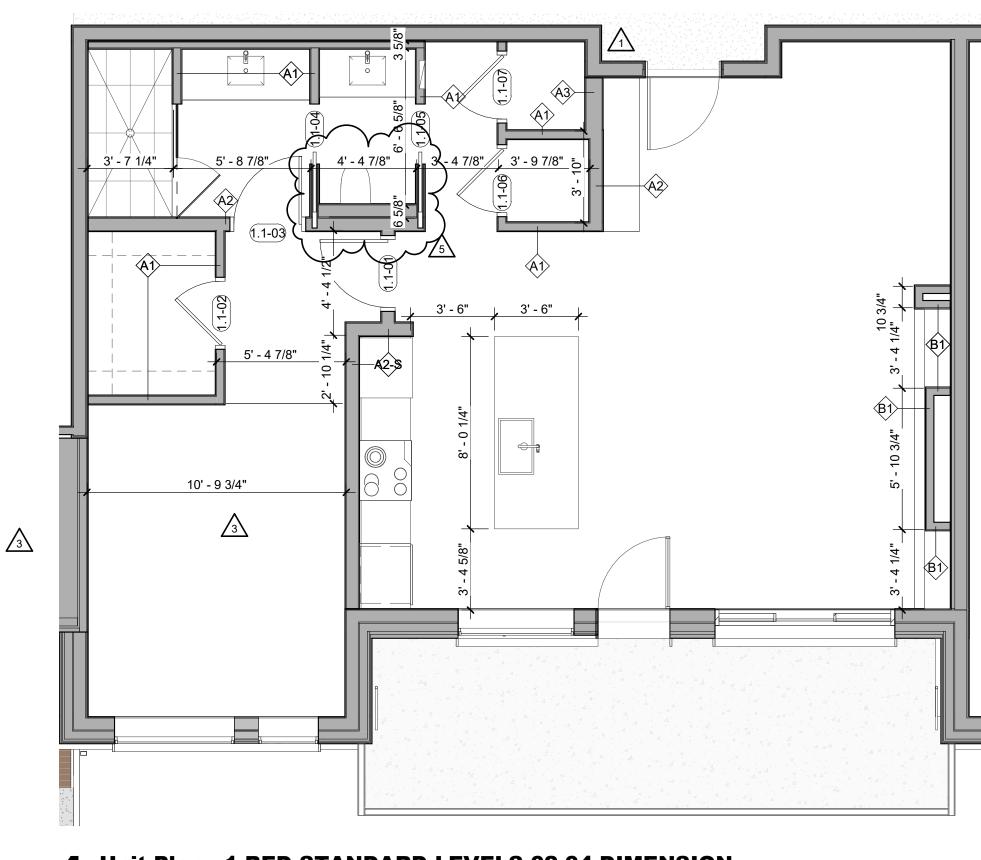


Unit Plan - 1 BED STANDARD LEVELS 02-04 DIMENSION UNITS 202, 302, 402 1/4" = 1'-0"

ENLARGED FLOOR PLAN - GENERAL NOTES

- REFER TO G0.2X SHEETS FOR EXTERIOR AND INTERIOR BUILDING ENCLOSURE ASSEMBLIES.
- REFER TO A1.0X SHEETS FOR EXTERIOR WALL, DEMISING WALL, AND CORRIDOR WALL TYPES AND LOCATIONS. REFER TO A1.1X SHEETS FOR INTERIOR AND EXTERIOR
- WINDOW/DOOR TAGS WITH UNIT BACKGROUNDS FOR REFERENCE. ALIGN WALLS WHERE THEY APPEAR TO ALIGN, U.N.O.
- THE INSIDE FACE OF DOOR JAMBS SHALL BE 4" FROM ADJACENT WALL OR FINISHED COLUMN, U.N.O.
- PROVIDE BLOCKING FOR ALL WALL MOUNTED EQUIPMENT AND ACCESSORIES.
- THE CENTERLINE OF ALL RESIDENTIAL TOILETS SHALL BE
- LOCATED 18" OFF OF FINISH FACE OF WALL, U.N.O. SWING CLEARANCE AT UNIT ENTRY SHALL BE 18" MIN.
- FROM FINISH FACE OF ADJACENT SURFACE. ALL DIMENSIONS ARE TO FACE OF STUD, GRID LINE, OR
- FACE OF CONCRETE, U.N.O. 10. WHERE "CLEAR" IS CALLED OUT ON A DIMENSION, PROVIDE DIMENSION FROM FACE OF FINISH TO FACE OF
- FINISH 11. FURNITURE IS NOT IN CONTRACT, U.N.O., AND IS SHOWN
- FOR DIAGRAMATIC PURPOSES ONLY. 12. CONSULTANT MODELS SHOWN FOR REFERENCE ONLY.

ENLARGED FLOOR PLAN - LEGEND

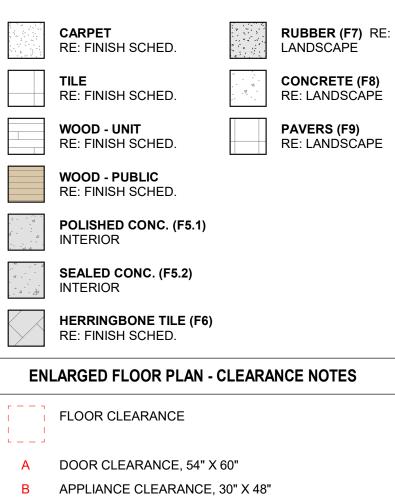

- C CLEAR FLOOR CLEARANCE, 30" X 48"
- D VANITY CLEARANCE, 30" X 48"
- E TOILET CLEARANCE, 48" X 56" OR ADA 60" X 56"
- F SHOWER/TUB CLEARANCE, 30" X 48" (B)
- G TURN AROUND CLEARANCE

WALL WHERE APPLICABLE


GRAB BAR BLOCKING REQ. AT TOILET


ENLARGED RCP - GENERAL NOTES

- ALL UNIT CEILINGS SHALL BE 9' 0" A.F.F. U.N.O. REFER TO ENLARGED RCP'S FOR COMMON AREA CEILING HEIGHTS.
- IN THE CASE OF MINOR DISCREPANCIES BETWEEN MEP AND ARCHITECTURAL DOCUMENTS ON THE LOCATION OF CEILING MOUNTED COMPONENTS, THE ARCHITECTURAL RCP'S GOVERN. IN THE CASE OF MAJOR DISCREPANCIES, THE ARCHITECT SHALL BE NOTIFIED AS SOON AS THE DISCREPANCY IS DISCOVERED PRIOR TO PROCEEDING WITH THE WORK.
- REFERENCE MECHANICAL AND ELECTRICAL DRAWINGS FOR MOUNTING LOCATIONS OF ITEMS WHERE NO CEILING IS REQUIRED OR INDICATED.
- COORDINATE ALL TRADES INVOLVED IN THE CEILING WORK TO ENSURE CLEARANCE FOR FIXTURES, DUCTS, PIPING, CEILING SUSPENSION SYSTEMS, ETC. NECESSARY TO MAINTAIN CEILING HEIGHTS NOTED.
- LIGHTS, DIFFUSERS, EXIT SIGNS, SMOKE DETECTORS, SPEAKERS, STROBES, AND MISC. DEVICES SHALL BE CENTERED IN THE CEILING WHERE THEY OCCUR, U.N.O. FIRE PROTECTION SCOPE SHALL BE DESIGN-BUILD. ALL
- CORRIDOR SPRINKLER HEADS SHALL BE ALIGNED IN THE SAME LOCATION PARALLEL TO THE WALL WITHIN EACH SPECIFIC CEILING CONSTRUCTION. SMOKE ALARMS SHALL BE PROVIDED IN ALL BEDROOMS,
- OUTSIDE OF ALL BEDROOMS, AND ON EACH FLOOR AS REQUIRED. CARBON MONOXIDE DETECTORS SHALL BE INSTALLED OUTSIDE OF ALL BEDROOMS. SMOKE ALARMS AND CO DETECTORS SHALL BE HARDWIRED AND HAVE BATTERY BACKUP.
- ACCESS DOOR LOCATIONS IN GYPSUM BOARD CEILINGS ARE INDICATED ON RCP'S ONLY WHERE ARCHITECTURALLY SIGNIFICANT. REFERENCE SPECIFICATIONS AND MEP DRAWINGS FOR OTHER ACCESS DOOR LOCATIONS.
- UNLESS PREFINISHED TO MATCH ADJACENT SURFACE, PAINT MECHANICAL GRILLS, DIFFUSERS, ACCESS PANELS, AND OTHER EQUIPMENT TO MATCH ADJACENT SURFACE. 10. EXIT SIGNS ARE SHOWN ON RCP'S ONLY WHERE
- LOCATIONS ARE ARCHITECTURALLY SIGNIFICANT. 1. PROVIDE UL-CLASSIFIED LIGHT FIXTURES OR ENCLOSURES IN RATED FLOOR/CEILING ASSEMBLIES IN
- ACCORDANCE WITH IBC CHAPTER 7. 12. REFER TO LIGHTING PLANS FOR EXACT FIXTURE TYPES AND LOCATIONS. FIXTURES SHOWN HERE ARE
- REFERENCED AND SHOWN FOR GENERAL ALIGNMENT.


$\begin{array}{cccccccccccccccccccccccccccccccccccc$	GWB (C1) INTERIOR	\rightarrow	SLOPE CEILING AS NOTED
	T&G CEILING (C2) INTERIOR	0	CEILING MOUNTED LIGHT FIXTURE
	FIBER-CEMENT SOFFIT (C3) - EXTERIOR	+ + + + + + + + + + + + + + + + + + + +	VINYL SCRIM CLG - Interior
	ACCESS PANEL		ACOUSTIC VINYL Tile CLG - Interiof

	тоwи : 3 5 5 Е 5 В 3630 ОSAG DE NYER, 720.512	5 C G)	
TO LEE	BRUCE D B-24 12/15/2			
	The Amble	Steamboat Springs, CO		
REVISIONS NO. 1 2 3 4 5 Image: Stress of the st	THE A	0 0 0 1 1 1 1 1 1 0 0 0 0 0 0 0 0 0 0 0	Date 3.15.24 6.14.24 8.07.24 0.16.24 1.19.24	
L BEDR I SHEET NO.	JNIT PI 200M S LEVELS	TAND 6 02-04	ARD -	

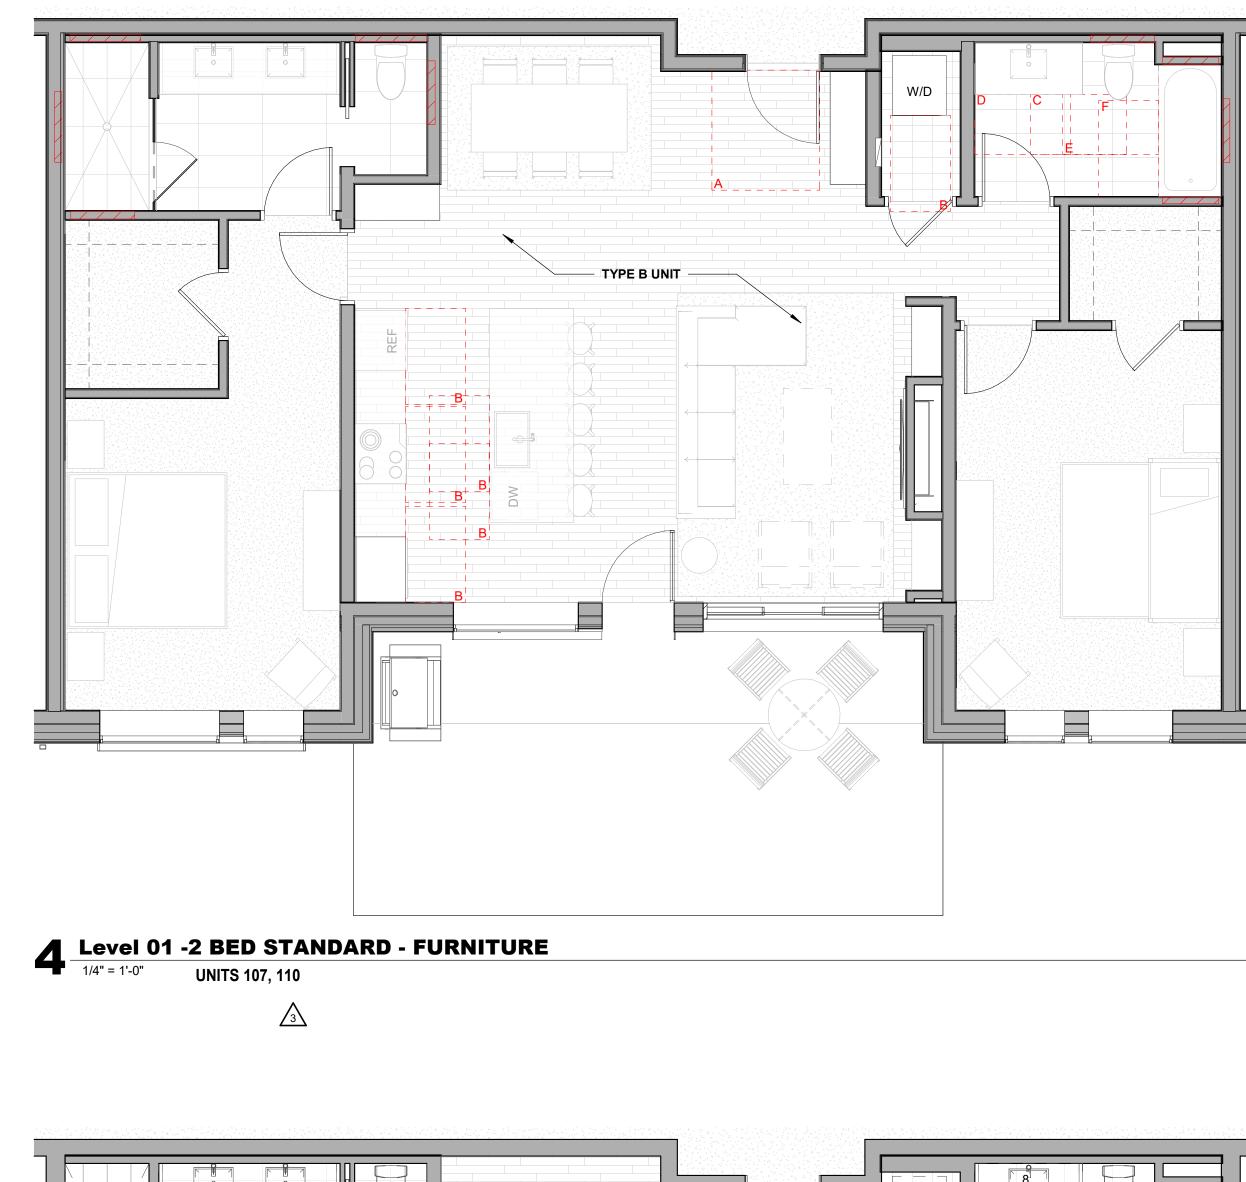


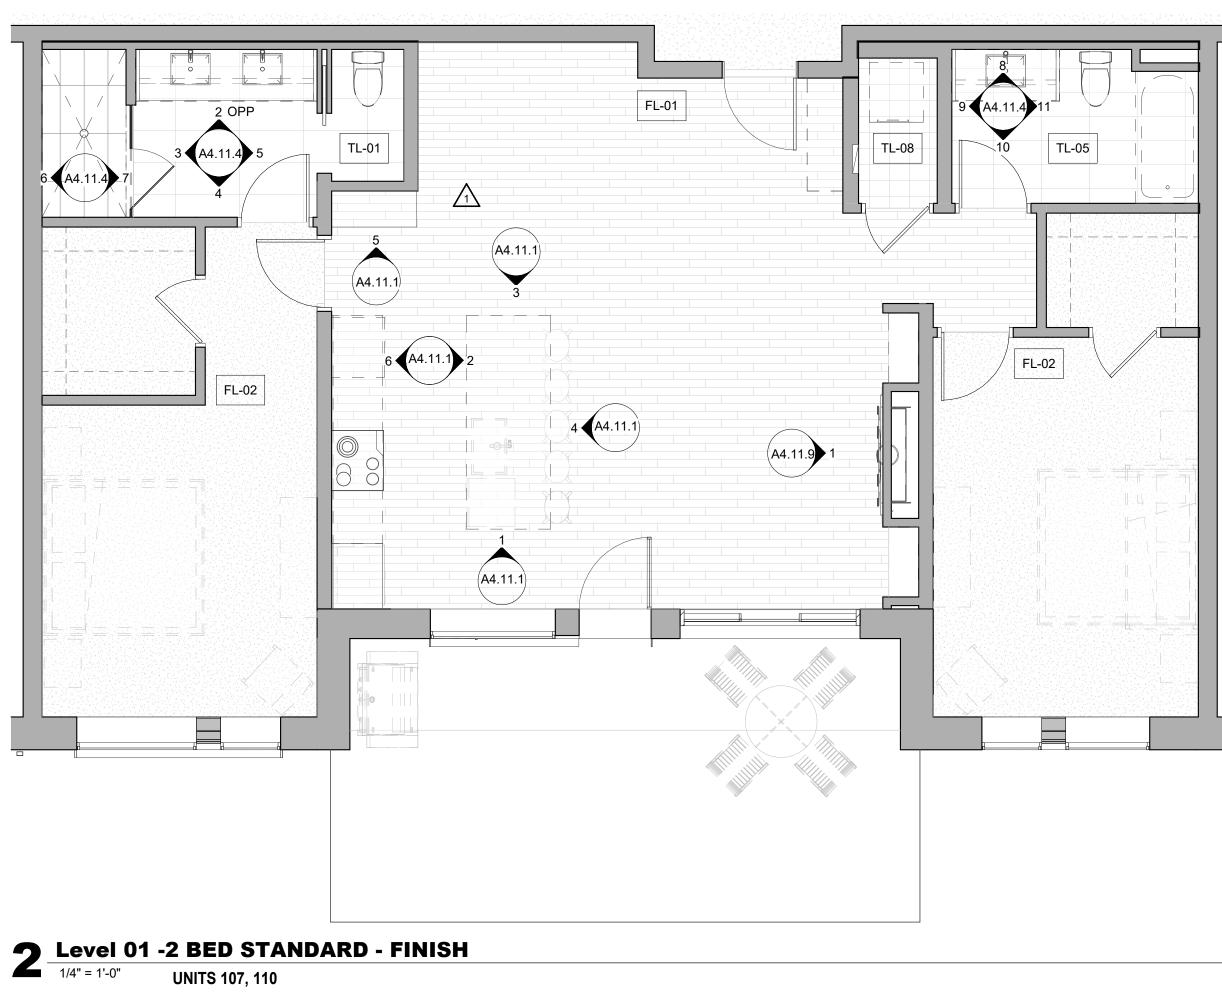

 $\sqrt{3}$

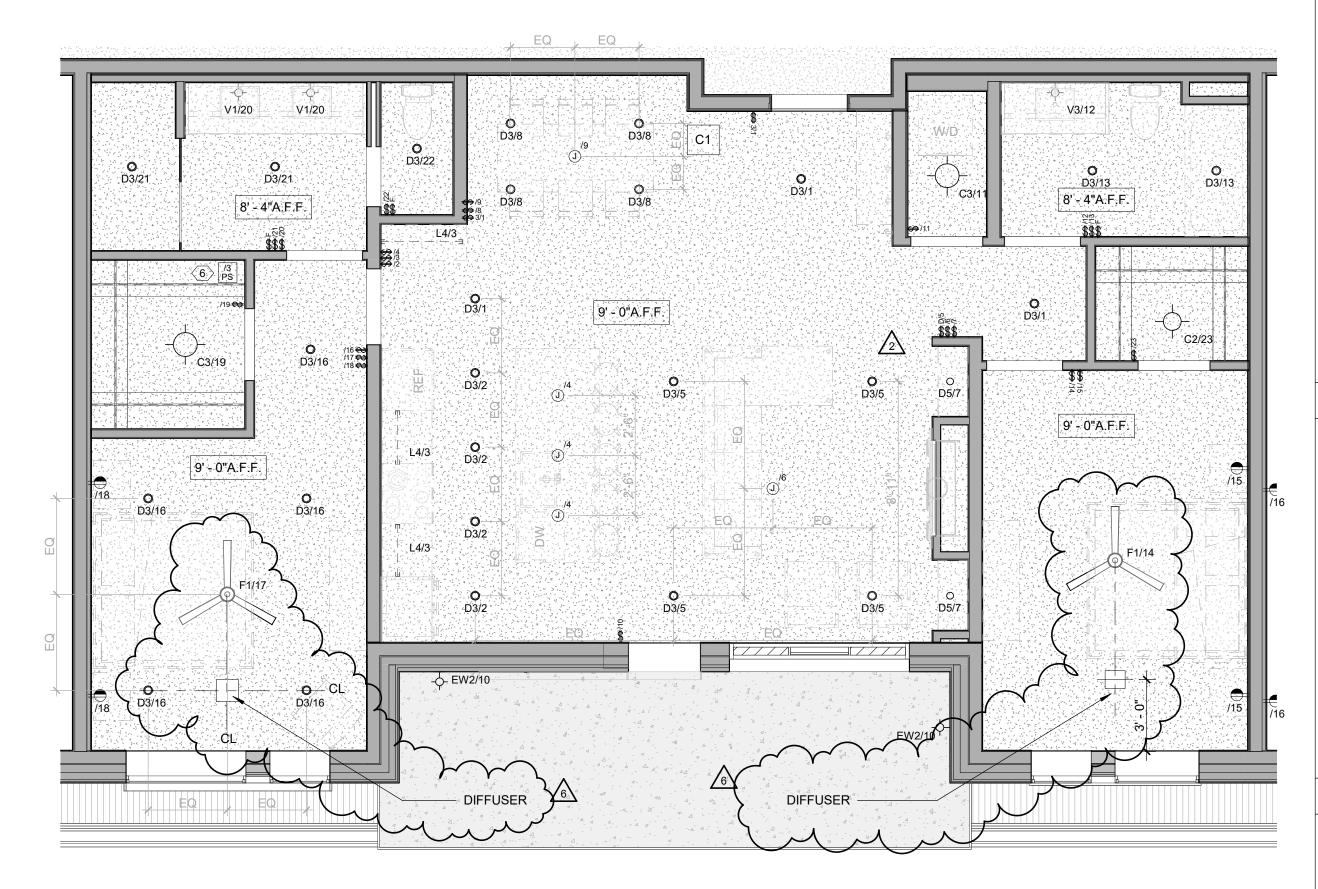




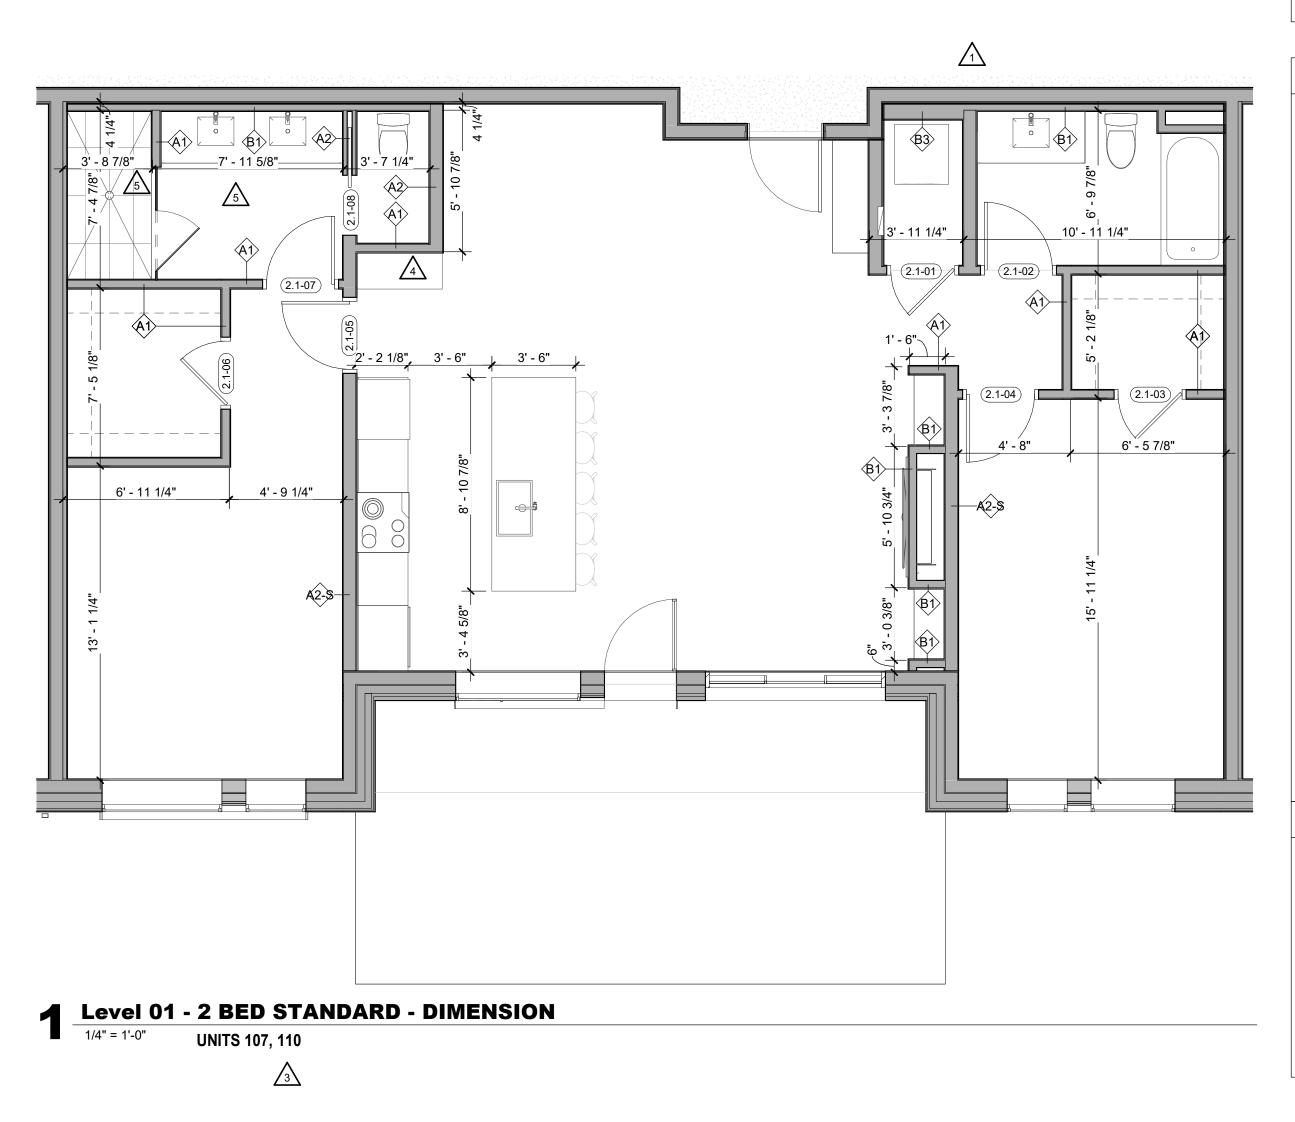

ENLARGED FLOOR PLAN - GENERAL NOTES

- REFER TO G0.2X SHEETS FOR EXTERIOR AND INTERIOR
- BUILDING ENCLOSURE ASSEMBLIES. REFER TO A1.0X SHEETS FOR EXTERIOR WALL, DEMISING
- WALL, AND CORRIDOR WALL TYPES AND LOCATIONS. REFER TO A1.1X SHEETS FOR INTERIOR AND EXTERIOR WINDOW/DOOR TAGS WITH UNIT BACKGROUNDS FOR REFERENCE.
- ALIGN WALLS WHERE THEY APPEAR TO ALIGN, U.N.O. THE INSIDE FACE OF DOOR JAMBS SHALL BE 4" FROM
- ADJACENT WALL OR FINISHED COLUMN, U.N.O. PROVIDE BLOCKING FOR ALL WALL MOUNTED EQUIPMENT
- AND ACCESSORIES.
- THE CENTERLINE OF ALL RESIDENTIAL TOILETS SHALL BE LOCATED 18" OFF OF FINISH FACE OF WALL, U.N.O.
- SWING CLEARANCE AT UNIT ENTRY SHALL BE 18" MIN. FROM FINISH FACE OF ADJACENT SURFACE.
- ALL DIMENSIONS ARE TO FACE OF STUD, GRID LINE, OR FACE OF CONCRETE, U.N.O. 10. WHERE "CLEAR" IS CALLED OUT ON A DIMENSION,
- PROVIDE DIMENSION FROM FACE OF FINISH TO FACE OF FINISH 11. FURNITURE IS NOT IN CONTRACT, U.N.O., AND IS SHOWN
- FOR DIAGRAMATIC PURPOSES ONLY. 12. CONSULTANT MODELS SHOWN FOR REFERENCE ONLY.

ENLARGED FLOOR PLAN - LEGEND

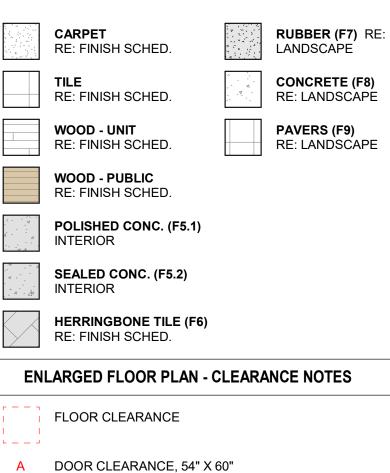


- B APPLIANCE CLEARANCE, 30" X 48"
- C CLEAR FLOOR CLEARANCE, 30" X 48"
- D VANITY CLEARANCE, 30" X 48"
- E TOILET CLEARANCE, 48" X 56" OR ADA 60" X 56"
- F SHOWER/TUB CLEARANCE, 30" X 48" (B)
- G TURN AROUND CLEARANCE
- GRAB BAR BLOCKING REQ. AT TOILET WALL WHERE APPLICABLE

ENLARGED RCP - GENERAL NOTES

- ALL UNIT CEILINGS SHALL BE 9' 0" A.F.F. U.N.O. REFER TO ENLARGED RCP'S FOR COMMON AREA CEILING HEIGHTS.
- IN THE CASE OF MINOR DISCREPANCIES BETWEEN MEP AND ARCHITECTURAL DOCUMENTS ON THE LOCATION OF CEILING MOUNTED COMPONENTS, THE ARCHITECTURAL RCP'S GOVERN. IN THE CASE OF MAJOR DISCREPANCIES, THE ARCHITECT SHALL BE NOTIFIED AS SOON AS THE DISCREPANCY IS DISCOVERED PRIOR TO PROCEEDING WITH THE WORK.
- REFERENCE MECHANICAL AND ELECTRICAL DRAWINGS FOR MOUNTING LOCATIONS OF ITEMS WHERE NO CEILING IS REQUIRED OR INDICATED.
- COORDINATE ALL TRADES INVOLVED IN THE CEILING WORK TO ENSURE CLEARANCE FOR FIXTURES, DUCTS, PIPING, CEILING SUSPENSION SYSTEMS, ETC. NECESSARY TO MAINTAIN CEILING HEIGHTS NOTED.
- LIGHTS, DIFFUSERS, EXIT SIGNS, SMOKE DETECTORS, SPEAKERS, STROBES, AND MISC. DEVICES SHALL BE CENTERED IN THE CEILING WHERE THEY OCCUR, U.N.O. FIRE PROTECTION SCOPE SHALL BE DESIGN-BUILD. ALL
- CORRIDOR SPRINKLER HEADS SHALL BE ALIGNED IN THE SAME LOCATION PARALLEL TO THE WALL WITHIN EACH SPECIFIC CEILING CONSTRUCTION.
- SMOKE ALARMS SHALL BE PROVIDED IN ALL BEDROOMS, OUTSIDE OF ALL BEDROOMS, AND ON EACH FLOOR AS REQUIRED. CARBON MONOXIDE DETECTORS SHALL BE INSTALLED OUTSIDE OF ALL BEDROOMS. SMOKE ALARMS AND CO DETECTORS SHALL BE HARDWIRED AND HAVE BATTERY BACKUP.
- ACCESS DOOR LOCATIONS IN GYPSUM BOARD CEILINGS ARE INDICATED ON RCP'S ONLY WHERE ARCHITECTURALLY SIGNIFICANT. REFERENCE SPECIFICATIONS AND MEP DRAWINGS FOR OTHER ACCESS DOOR LOCATIONS.
- UNLESS PREFINISHED TO MATCH ADJACENT SURFACE, PAINT MECHANICAL GRILLS, DIFFUSERS, ACCESS PANELS, AND OTHER EQUIPMENT TO MATCH ADJACENT SURFACE. 10. EXIT SIGNS ARE SHOWN ON RCP'S ONLY WHERE
- LOCATIONS ARE ARCHITECTURALLY SIGNIFICANT. 11. PROVIDE UL-CLASSIFIED LIGHT FIXTURES OR ENCLOSURES IN RATED FLOOR/CEILING ASSEMBLIES IN
- ACCORDANCE WITH IBC CHAPTER 7. 12. REFER TO LIGHTING PLANS FOR EXACT FIXTURE TYPES AND LOCATIONS. FIXTURES SHOWN HERE ARE

REFERENCED AND SHOWN FOR GENERAL ALIGNMENT.

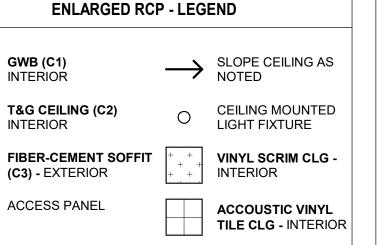

	тоwн 3555 555 555 5	5 G I G	9 N	
TO IN	BRUCE I B-24 12/15/			
	The Amble	Steamboat Springs, CO		
REVISIONS No. 1 2 3 4 5 6	THE A	MBLE	Date 03.15.24 06.14.24 08.07.24 08.21.24 09.07.24 10.16.24 10.16.24	
BEDR	IFC JNIT P ROOM S LEVE	LAN - STANE EL 01	DARD -	





 \int_{6}

2 Level 01 - 2 BED STANDARD TYPE A-FINISH 1/4" = 1'-0" UNITS 109

UNITS 109


▲ Level 01 - 2 BED STANDARD TYPE A-DIMENSION 1/4" = 1'-0" **UNITS 109**

 $\sqrt{5}$

ENLARGED FLOOR PLAN - GENERAL NOTES

- REFER TO G0.2X SHEETS FOR EXTERIOR AND INTERIOR
- BUILDING ENCLOSURE ASSEMBLIES. REFER TO A1.0X SHEETS FOR EXTERIOR WALL, DEMISING
- WALL, AND CORRIDOR WALL TYPES AND LOCATIONS. REFER TO A1.1X SHEETS FOR INTERIOR AND EXTERIOR WINDOW/DOOR TAGS WITH UNIT BACKGROUNDS FOR REFERENCE.
- ALIGN WALLS WHERE THEY APPEAR TO ALIGN, U.N.O. THE INSIDE FACE OF DOOR JAMBS SHALL BE 4" FROM
- ADJACENT WALL OR FINISHED COLUMN, U.N.O.
- PROVIDE BLOCKING FOR ALL WALL MOUNTED EQUIPMENT AND ACCESSORIES.
- THE CENTERLINE OF ALL RESIDENTIAL TOILETS SHALL BE LOCATED 18" OFF OF FINISH FACE OF WALL, U.N.O.
- SWING CLEARANCE AT UNIT ENTRY SHALL BE 18" MIN. FROM FINISH FACE OF ADJACENT SURFACE.
- ALL DIMENSIONS ARE TO FACE OF STUD, GRID LINE, OR FACE OF CONCRETE, U.N.O.
- 10. WHERE "CLEAR" IS CALLED OUT ON A DIMENSION, PROVIDE DIMENSION FROM FACE OF FINISH TO FACE OF FINISH
- 11. FURNITURE IS NOT IN CONTRACT, U.N.O., AND IS SHOWN FOR DIAGRAMATIC PURPOSES ONLY. 12. CONSULTANT MODELS SHOWN FOR REFERENCE ONLY.


ENLARGED FLOOR PLAN - LEGEND

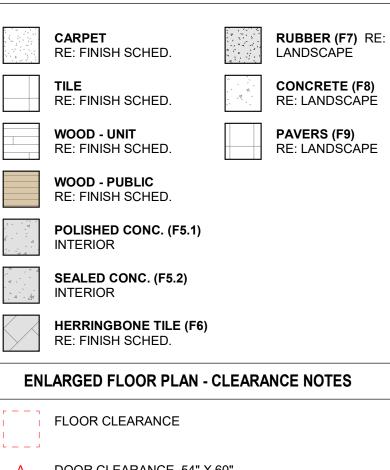

- A DOOR CLEARANCE, 54" X 60"
- B APPLIANCE CLEARANCE, 30" X 48"
- C CLEAR FLOOR CLEARANCE, 30" X 48"
- D VANITY CLEARANCE, 30" X 48"
- E TOILET CLEARANCE, 48" X 56" OR ADA 60" X 56"
- F SHOWER/TUB CLEARANCE, 30" X 48" (B)
- G TURN AROUND CLEARANCE
- GRAB BAR BLOCKING REQ. AT TOILET WALL WHERE APPLICABLE

ENLARGED RCP - GENERAL NOTES


- ALL UNIT CEILINGS SHALL BE 9' 0" A.F.F. U.N.O. REFER TO ENLARGED RCP'S FOR COMMON AREA CEILING HEIGHTS.
- IN THE CASE OF MINOR DISCREPANCIES BETWEEN MEP AND ARCHITECTURAL DOCUMENTS ON THE LOCATION OF CEILING MOUNTED COMPONENTS, THE ARCHITECTURAL RCP'S GOVERN. IN THE CASE OF MAJOR DISCREPANCIES, THE ARCHITECT SHALL BE NOTIFIED AS SOON AS THE DISCREPANCY IS DISCOVERED PRIOR TO PROCEEDING WITH THE WORK.
- REFERENCE MECHANICAL AND ELECTRICAL DRAWINGS FOR MOUNTING LOCATIONS OF ITEMS WHERE NO CEILING IS REQUIRED OR INDICATED.
- COORDINATE ALL TRADES INVOLVED IN THE CEILING WORK TO ENSURE CLEARANCE FOR FIXTURES, DUCTS, PIPING, CEILING SUSPENSION SYSTEMS, ETC. NECESSARY TO MAINTAIN CEILING HEIGHTS NOTED.
- LIGHTS, DIFFUSERS, EXIT SIGNS, SMOKE DETECTORS, SPEAKERS, STROBES, AND MISC. DEVICES SHALL BE CENTERED IN THE CEILING WHERE THEY OCCUR, U.N.O. FIRE PROTECTION SCOPE SHALL BE DESIGN-BUILD. ALL
- CORRIDOR SPRINKLER HEADS SHALL BE ALIGNED IN THE SAME LOCATION PARALLEL TO THE WALL WITHIN EACH SPECIFIC CEILING CONSTRUCTION.
- SMOKE ALARMS SHALL BE PROVIDED IN ALL BEDROOMS, OUTSIDE OF ALL BEDROOMS, AND ON EACH FLOOR AS REQUIRED. CARBON MONOXIDE DETECTORS SHALL BE INSTALLED OUTSIDE OF ALL BEDROOMS. SMOKE ALARMS AND CO DETECTORS SHALL BE HARDWIRED AND HAVE BATTERY BACKUP.
- ACCESS DOOR LOCATIONS IN GYPSUM BOARD CEILINGS ARE INDICATED ON RCP'S ONLY WHERE ARCHITECTURALLY SIGNIFICANT. REFERENCE SPECIFICATIONS AND MEP DRAWINGS FOR OTHER ACCESS DOOR LOCATIONS.
- UNLESS PREFINISHED TO MATCH ADJACENT SURFACE, PAINT MECHANICAL GRILLS, DIFFUSERS, ACCESS PANELS, AND OTHER EQUIPMENT TO MATCH ADJACENT SURFACE. 10. EXIT SIGNS ARE SHOWN ON RCP'S ONLY WHERE
- LOCATIONS ARE ARCHITECTURALLY SIGNIFICANT. 11. PROVIDE UL-CLASSIFIED LIGHT FIXTURES OR ENCLOSURES IN RATED FLOOR/CEILING ASSEMBLIES IN
- ACCORDANCE WITH IBC CHAPTER 7. 12. REFER TO LIGHTING PLANS FOR EXACT FIXTURE TYPES AND LOCATIONS. FIXTURES SHOWN HERE ARE

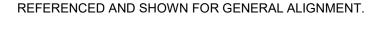

- (17) - (17) - (17) - (17) - (17) - (17) - (17)	GWB (C1) INTERIOR	\rightarrow	SLOPE CEILING AS NOTED
	T&G CEILING (C2) INTERIOR	0	CEILING MOUNTED LIGHT FIXTURE
	FIBER-CEMENT SOFFIT (C3) - EXTERIOR	+ + + + + +	VINYL SCRIM CLG - INTERIOR
	ACCESS PANEL		ACCOUSTIC VINYL TILE CLG - INTERIO


35 DES	stamp 599 IGN co 80211 i23437
BASEE B-2 12/15	
The Amble	Steamboat Springs, CO
No. Descr 1 IFC SET 2 RFI #110 3 RFI #110 4 ASI 001 5 ASI 004 6 RFI #219 7 RFI #214	iption Date 03.15.24 06.14.24 06.24.24 07.28.24 08.07.24 08.07.24 08.08.24 08.21.24

No.	Description	Date
1	IFC SET	03.15.24
2	RFI #110	06.14.24
3	RFI #119	06.24.24
4 5	ASI 001 ASI 004	07.26.24 08.07.24
6	RFI #219	08.08.24
7	RFI #214	08.21.24
8	RFI #223.1	10.16.24
	1	
PROJECT N		20019
ISSUE DATE		03/15/2024
IOOOL DATE	-	00/10/2024
ISSUE		
	IFC SET	
SHEET TITL	E	
	UNIT PLAN - ROOM STANI TYPE A	_
	TTPEA	
SHEET NO.		
A	4.02	.2

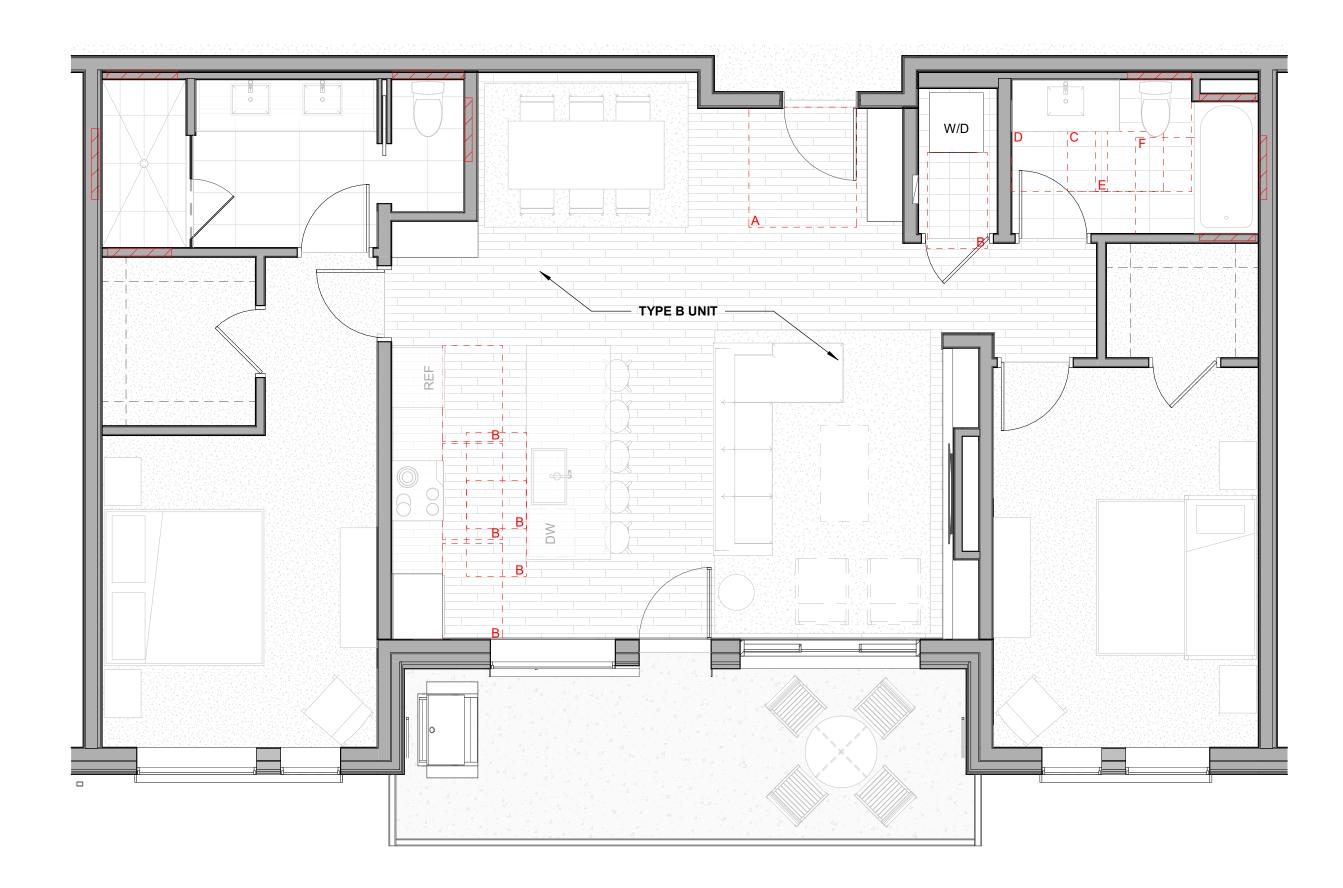

4 Level 02-03 - 2 BEDROOM STANDARD-FURNITURE


UNITS 207, 210, 307, 310 $\sqrt{3}$

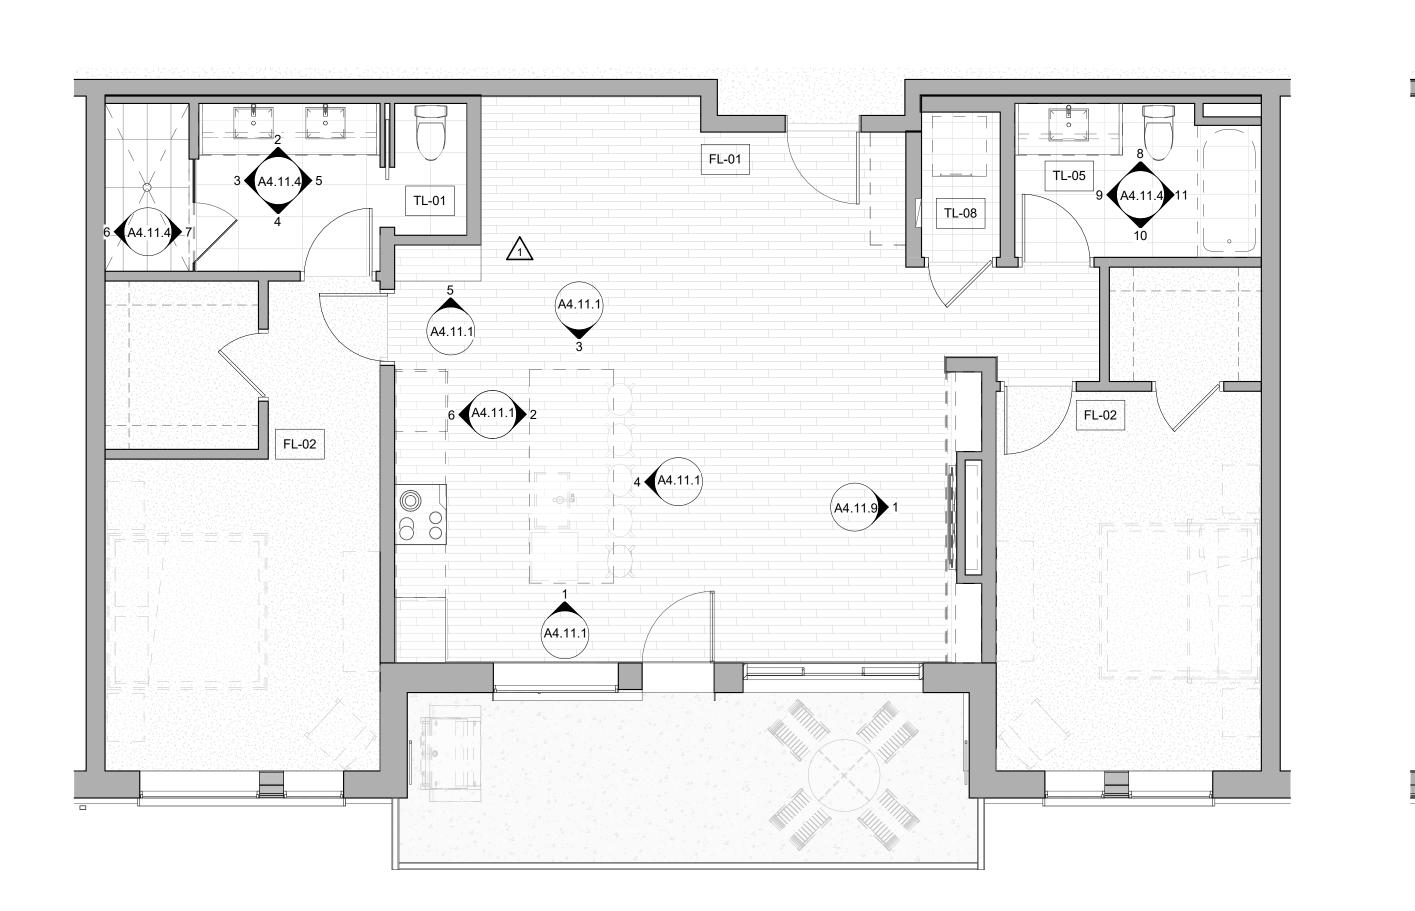


 $\sqrt{3}$

 \checkmark

(A4.11.4)

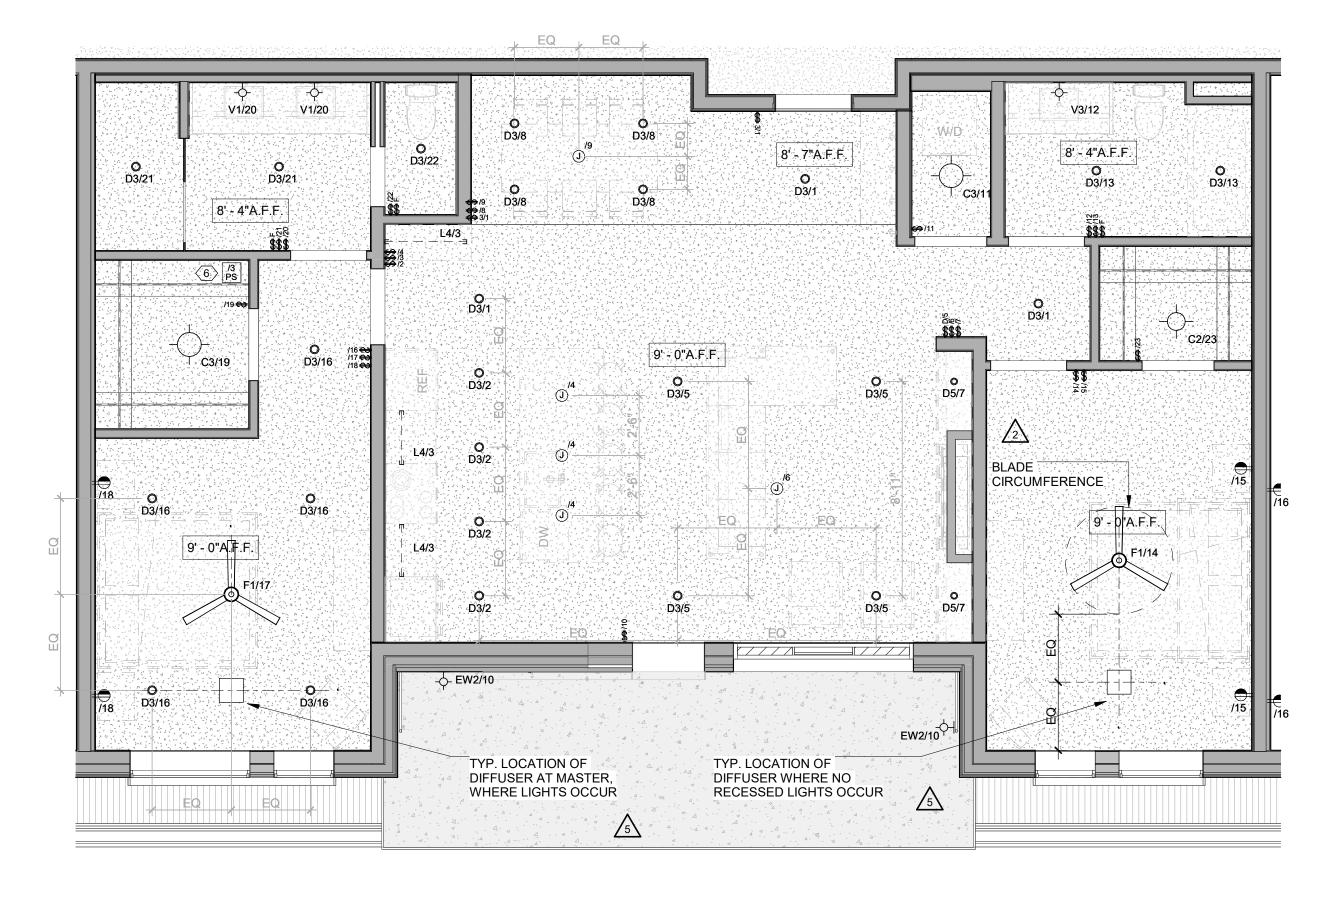

3 Level 02-03 - 2 BEDROOM STANDARD-RCP UNITS 207, 210, 307, 310

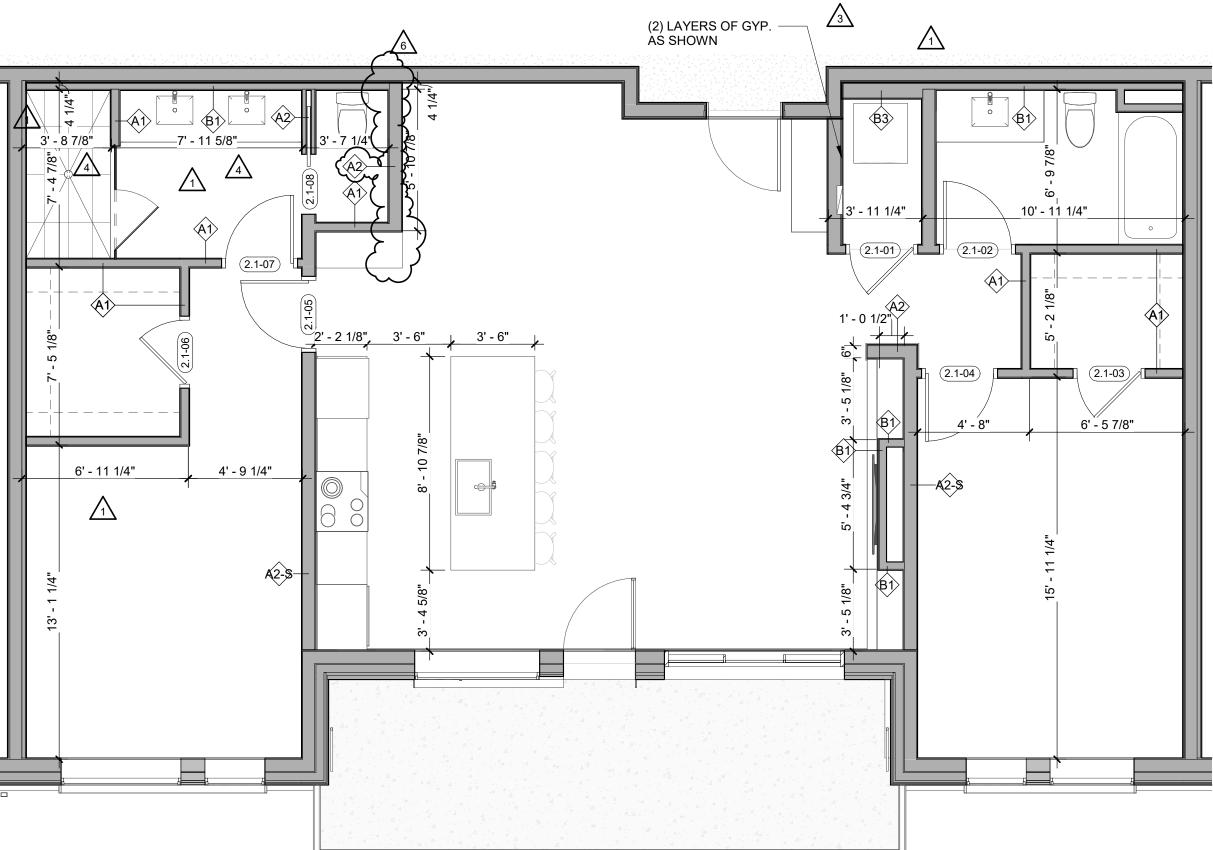

ENLARGED FLOOR PLAN - GENERAL NOTES

- REFER TO G0.2X SHEETS FOR EXTERIOR AND INTERIOR BUILDING ENCLOSURE ASSEMBLIES. REFER TO A1.0X SHEETS FOR EXTERIOR WALL, DEMISING WALL, AND CORRIDOR WALL TYPES AND LOCATIONS.
- REFER TO A1.1X SHEETS FOR INTERIOR AND EXTERIOR WINDOW/DOOR TAGS WITH UNIT BACKGROUNDS FOR REFERENCE.
- ALIGN WALLS WHERE THEY APPEAR TO ALIGN, U.N.O. THE INSIDE FACE OF DOOR JAMBS SHALL BE 4" FROM ADJACENT WALL OR FINISHED COLUMN, U.N.O.
- PROVIDE BLOCKING FOR ALL WALL MOUNTED EQUIPMENT AND ACCESSORIES.
- THE CENTERLINE OF ALL RESIDENTIAL TOILETS SHALL BE LOCATED 18" OFF OF FINISH FACE OF WALL, U.N.O.
- SWING CLEARANCE AT UNIT ENTRY SHALL BE 18" MIN. FROM FINISH FACE OF ADJACENT SURFACE.
- ALL DIMENSIONS ARE TO FACE OF STUD, GRID LINE, OR
- FACE OF CONCRETE, U.N.O. 0. WHERE "CLEAR" IS CALLED OUT ON A DIMENSION, PROVIDE DIMENSION FROM FACE OF FINISH TO FACE OF
- FINISH.
- 11. FURNITURE IS NOT IN CONTRACT, U.N.O., AND IS SHOWN FOR DIAGRAMATIC PURPOSES ONLY.
- 12. CONSULTANT MODELS SHOWN FOR REFERENCE ONLY.

ENLARGED FLOOR PLAN - LEGEND

	CARPET RE: FINISH SCHED.		RUBBER (F7) RE LANDSCAPE
	TILE RE: FINISH SCHED.		CONCRETE (F8) RE: LANDSCAPE
	WOOD - UNIT RE: FINISH SCHED.		PAVERS (F9) RE: LANDSCAPE
	WOOD - PUBLIC RE: FINISH SCHED.		
4 - 4 - 4	POLISHED CONC. (F5.1) INTERIOR		
	SEALED CONC. (F5.2) INTERIOR		
	HERRINGBONE TILE (F6) RE: FINISH SCHED.		
ENL	ARGED FLOOR PLAN - CLI	EARANC	E NOTES
	FLOOR CLEARANCE		


- L _ _ J A DOOR CLEARANCE, 54" X 60"
- B APPLIANCE CLEARANCE, 30" X 48"
- C CLEAR FLOOR CLEARANCE, 30" X 48"
- D VANITY CLEARANCE, 30" X 48"
- E TOILET CLEARANCE, 48" X 56" OR ADA 60" X 56"
- F SHOWER/TUB CLEARANCE, 30" X 48" (B) \triangle
- G TURN AROUND CLEARANCE
- GRAB BAR BLOCKING REQ. AT TOILET
- WALL WHERE APPLICABLE

ENLARGED RCP - GENERAL NOTES

- ALL UNIT CEILINGS SHALL BE 9' 0" A.F.F. U.N.O. REFER TO ENLARGED RCP'S FOR COMMON AREA CEILING HEIGHTS.
- IN THE CASE OF MINOR DISCREPANCIES BETWEEN MEP AND ARCHITECTURAL DOCUMENTS ON THE LOCATION OF CEILING MOUNTED COMPONENTS, THE ARCHITECTURAL RCP'S GOVERN. IN THE CASE OF MAJOR DISCREPANCIES, THE ARCHITECT SHALL BE NOTIFIED AS SOON AS THE DISCREPANCY IS DISCOVERED PRIOR TO PROCEEDING WITH THE WORK.
- REFERENCE MECHANICAL AND ELECTRICAL DRAWINGS FOR MOUNTING LOCATIONS OF ITEMS WHERE NO CEILING IS REQUIRED OR INDICATED.
- COORDINATE ALL TRADES INVOLVED IN THE CEILING WORK TO ENSURE CLEARANCE FOR FIXTURES, DUCTS, PIPING, CEILING SUSPENSION SYSTEMS, ETC. NECESSARY TO MAINTAIN CEILING HEIGHTS NOTED.
- LIGHTS, DIFFUSERS, EXIT SIGNS, SMOKE DETECTORS, SPEAKERS, STROBES, AND MISC. DEVICES SHALL BE CENTERED IN THE CEILING WHERE THEY OCCUR, U.N.O. FIRE PROTECTION SCOPE SHALL BE DESIGN-BUILD. ALL CORRIDOR SPRINKLER HEADS SHALL BE ALIGNED IN THE
- SAME LOCATION PARALLEL TO THE WALL WITHIN EACH SPECIFIC CEILING CONSTRUCTION. SMOKE ALARMS SHALL BE PROVIDED IN ALL BEDROOMS,
- OUTSIDE OF ALL BEDROOMS, AND ON EACH FLOOR AS REQUIRED. CARBON MONOXIDE DETECTORS SHALL BE INSTALLED OUTSIDE OF ALL BEDROOMS. SMOKE ALARMS AND CO DETECTORS SHALL BE HARDWIRED AND HAVE BATTERY BACKUP.
- ACCESS DOOR LOCATIONS IN GYPSUM BOARD CEILINGS ARE INDICATED ON RCP'S ONLY WHERE ARCHITECTURALLY SIGNIFICANT. REFERENCE SPECIFICATIONS AND MEP DRAWINGS FOR OTHER ACCESS DOOR LOCATIONS.
- UNLESS PREFINISHED TO MATCH ADJACENT SURFACE, PAINT MECHANICAL GRILLS, DIFFUSERS, ACCESS PANELS, AND OTHER EQUIPMENT TO MATCH ADJACENT SURFACE.
- 10. EXIT SIGNS ARE SHOWN ON RCP'S ONLY WHERE LOCATIONS ARE ARCHITECTURALLY SIGNIFICANT. 11. PROVIDE UL-CLASSIFIED LIGHT FIXTURES OR
- ENCLOSURES IN RATED FLOOR/CEILING ASSEMBLIES IN


ACCORDANCE WITH IBC CHAPTER 7. REFER TO LIGHTING PLANS FOR EXACT FIXTURE TYPES AND LOCATIONS. FIXTURES SHOWN HERE ARE REFERENCED AND SHOWN FOR GENERAL ALIGNMENT.				
	ENLARGED RCP	LEGENI)	
	GWB (C1) INTERIOR	\rightarrow	SLOPE CEILING AS NOTED	
	T&G CEILING (C2) INTERIOR	0	CEILING MOUNTED LIGHT FIXTURE	
	FIBER-CEMENT SOFFIT (C3) - EXTERIOR	+ + + + + + + + + + + + + + + + + + + +	VINYL SCRIM CLG - INTERIOR	
	ACCESS PANEL		ACOUSTIC VINYL TILE CLG - INTERIOR	


TOWN STAMP TABLE STAND
T20.512.3437
The Amble Steamboat Springs, CO
IFC SET SHEET TITLE UNIT PLAN - 2 BEDROOM STANDARD - LEVELS 02-03 SHEET NO.

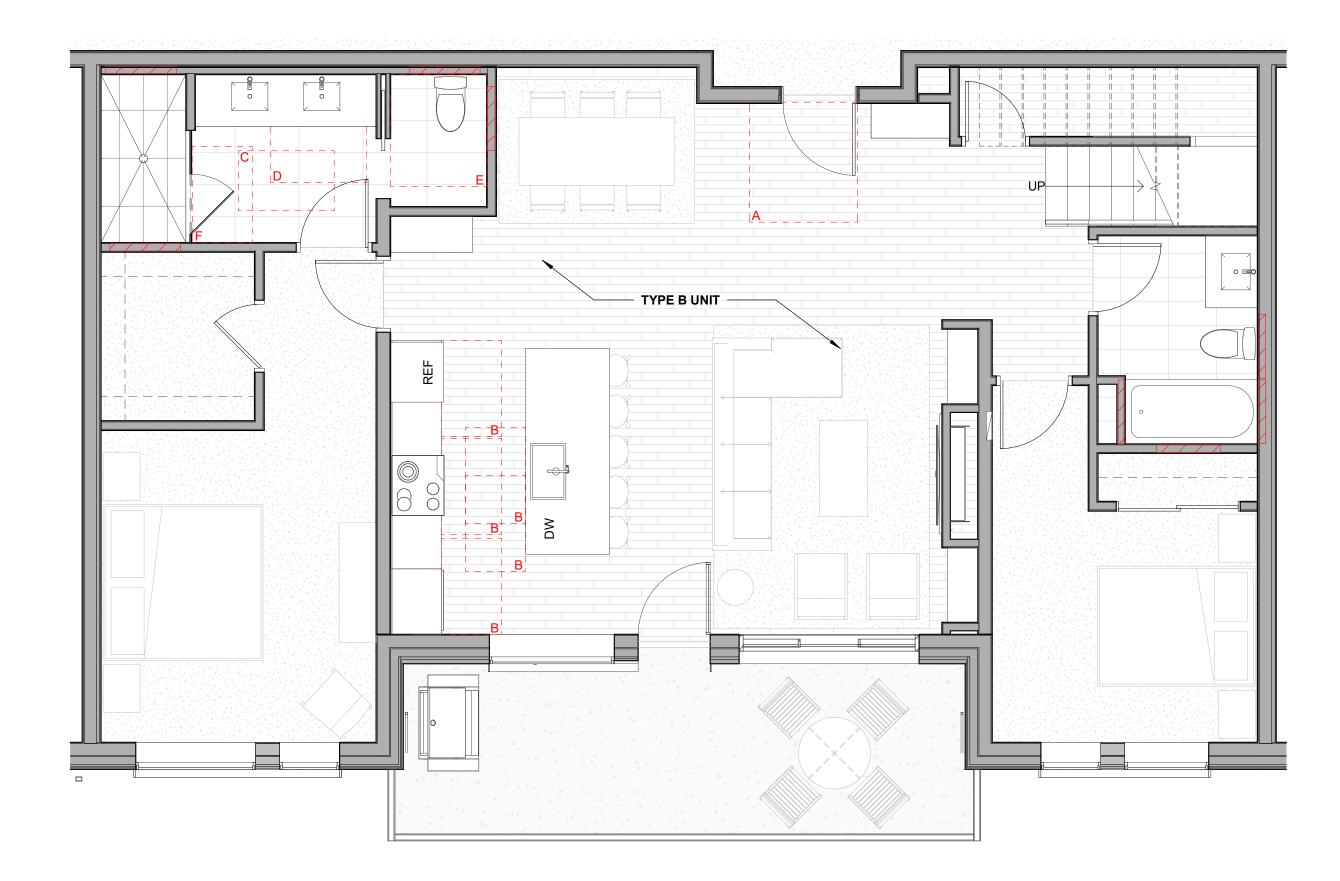


4 Level 04 - 2 BEDROOM STANDARD FURNITURE 1/4" = 1'-0" UNITS 407, 410

 $\sqrt{3}$

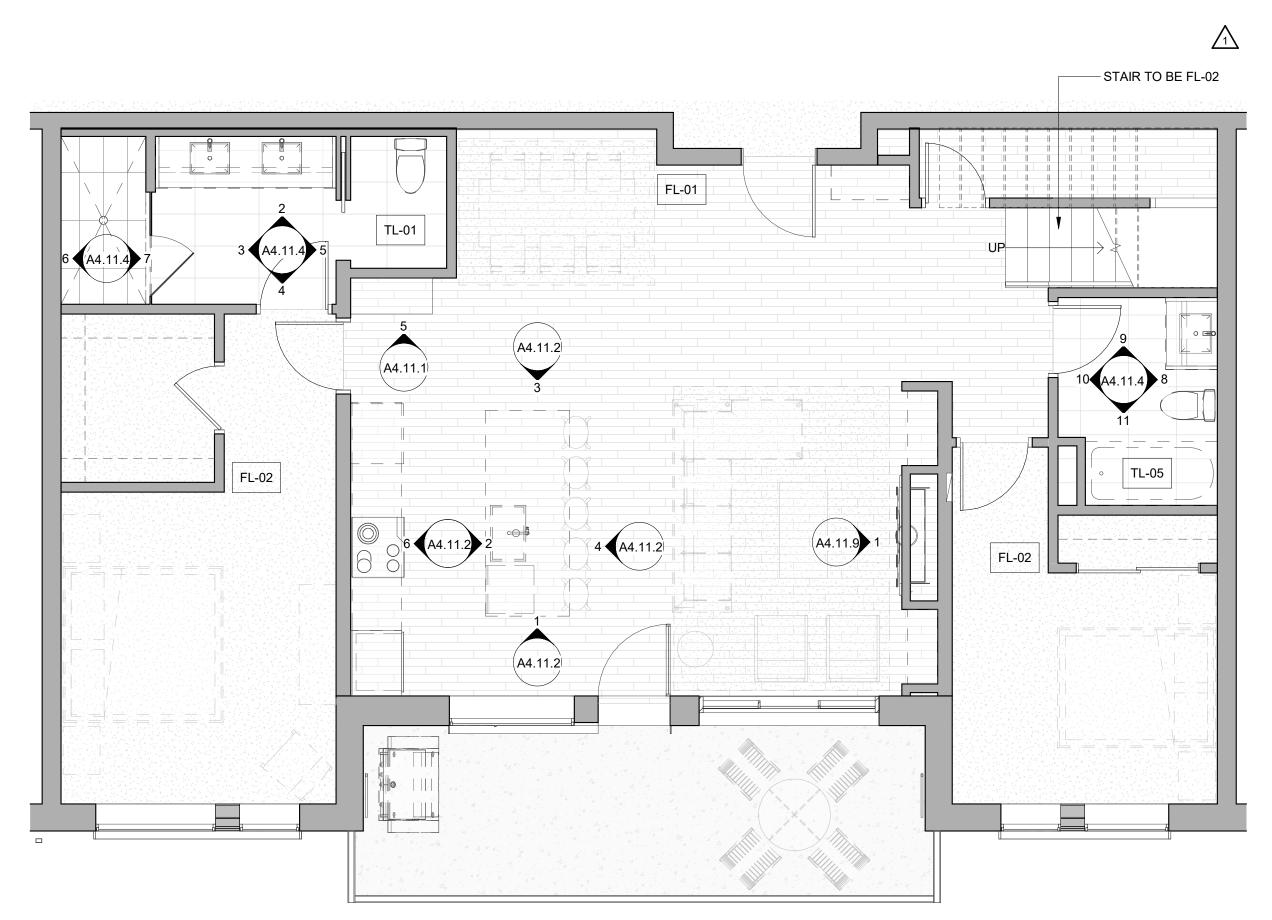

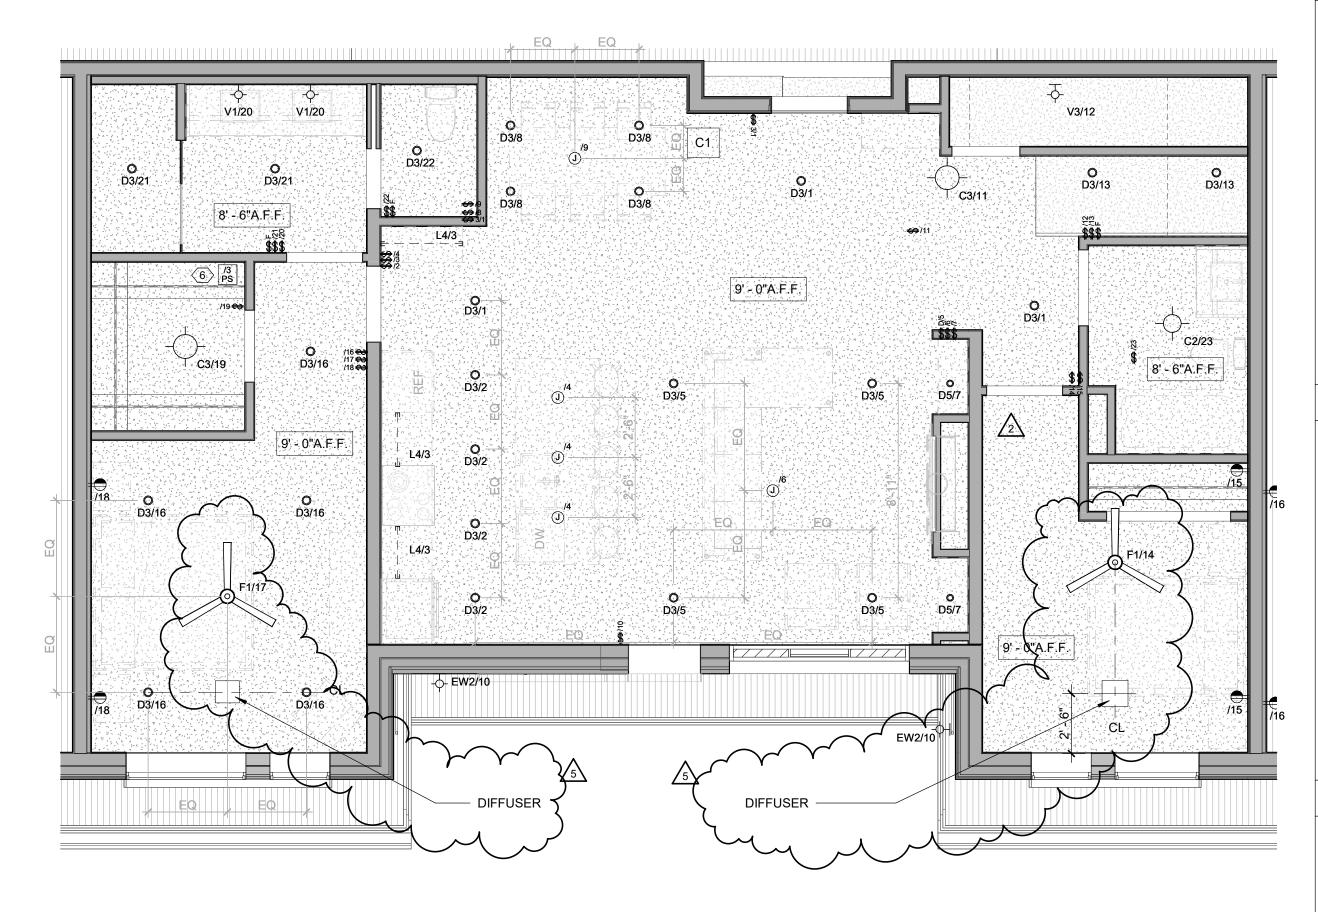

3 Level 04 - 2 BEDROOM STANDARD RCP 1/4" = 1'-0" UNITS 407, 410

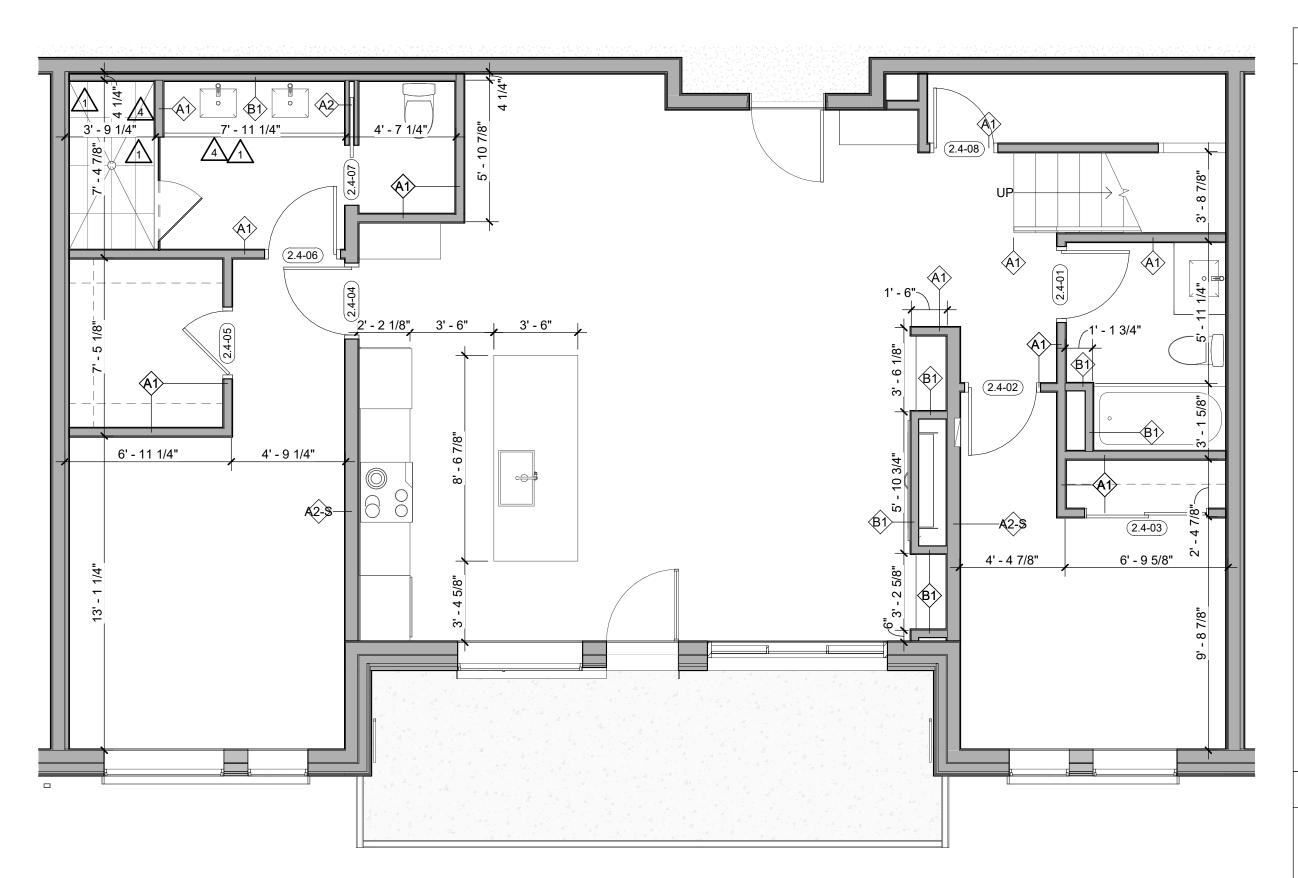


/3/

ENLARGED FLOOR PLAN - GENERAL NOTES

- REFER TO G0.2X SHEETS FOR EXTERIOR AND INTERIOR
- BUILDING ENCLOSURE ASSEMBLIES. 2. REFER TO A1.0X SHEETS FOR EXTERIOR WALL, DEMISING WALL, AND CORRIDOR WALL TYPES AND LOCATIONS.
- REFER TO A1.1X SHEETS FOR INTERIOR AND EXTERIOR WINDOW/DOOR TAGS WITH UNIT BACKGROUNDS FOR REFERENCE.
- ALIGN WALLS WHERE THEY APPEAR TO ALIGN, U.N.O.
 THE INSIDE FACE OF DOOR JAMBS SHALL BE 4" FROM
- ADJACENT WALL OR FINISHED COLUMN, U.N.O. 6. PROVIDE BLOCKING FOR ALL WALL MOUNTED EQUIPMENT
- AND ACCESSORIES.
- THE CENTERLINE OF ALL RESIDENTIAL TOILETS SHALL BE LOCATED 18" OFF OF FINISH FACE OF WALL, U.N.O.
 SWING CLEARANCE AT UNIT ENTRY SHALL BE 18" MIN.
- FROM FINISH FACE OF ADJACENT SURFACE. ALL DIMENSIONS ARE TO FACE OF STUD, GRID LINE, OR
- FACE OF CONCRETE, U.N.O. 10. WHERE "CLEAR" IS CALLED OUT ON A DIMENSION, PROVIDE DIMENSION FROM FACE OF FINISH TO FACE OF
- FINISH. 11. FURNITURE IS NOT IN CONTRACT, U.N.O., AND IS SHOWN
- FOR DIAGRAMATIC PURPOSES ONLY. 12. CONSULTANT MODELS SHOWN FOR REFERENCE ONLY.

ENLARGED FLOOR PLAN - LEGEND

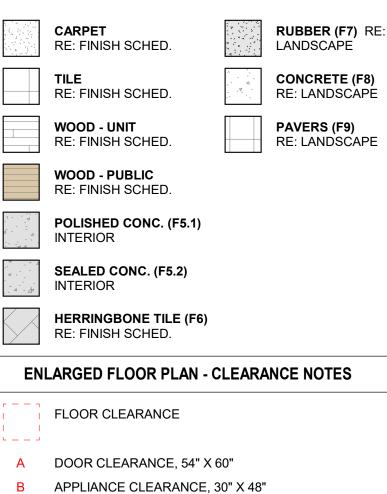

- APPLIANCE CLEARANCE, 30" X 48"
- C CLEAR FLOOR CLEARANCE, 30" X 48"
- D VANITY CLEARANCE, 30" X 48"
- E TOILET CLEARANCE, 48" X 56" OR ADA 60" X 56"
- F SHOWER/TUB CLEARANCE, 30" X 48" (B)
- G TURN AROUND CLEARANCE
- GRAB BAR BLOCKING REQ. AT TOILET WALL WHERE APPLICABLE

ENLARGED RCP - GENERAL NOTES

- 1. ALL UNIT CEILINGS SHALL BE 9' 0" A.F.F. U.N.O. REFER TO ENLARGED RCP'S FOR COMMON AREA CEILING HEIGHTS.
- 2. IN THE CASE OF MINOR DISCREPANCIES BETWEEN MEP AND ARCHITECTURAL DOCUMENTS ON THE LOCATION OF CEILING MOUNTED COMPONENTS, THE ARCHITECTURAL RCP'S GOVERN. IN THE CASE OF MAJOR DISCREPANCIES, THE ARCHITECT SHALL BE NOTIFIED AS SOON AS THE DISCREPANCY IS DISCOVERED PRIOR TO PROCEEDING WITH THE WORK.
- 3. REFERENCE MECHANICAL AND ELECTRICAL DRAWINGS FOR MOUNTING LOCATIONS OF ITEMS WHERE NO CEILING IS REQUIRED OR INDICATED.
- 4. COORDINATE ALL TRADES INVOLVED IN THE CEILING WORK TO ENSURE CLEARANCE FOR FIXTURES, DUCTS, PIPING, CEILING SUSPENSION SYSTEMS, ETC. NECESSARY TO MAINTAIN CEILING HEIGHTS NOTED.
- LIGHTS, DIFFUSERS, EXIT SIGNS, SMOKE DETECTORS, SPEAKERS, STROBES, AND MISC. DEVICES SHALL BE CENTERED IN THE CEILING WHERE THEY OCCUR, U.N.O.
 FIRE PROTECTION SCOPE SHALL BE DESIGN-BUILD. ALL
- CORRIDOR SPRINKLER HEADS SHALL BE ALIGNED IN THE SAME LOCATION PARALLEL TO THE WALL WITHIN EACH SPECIFIC CEILING CONSTRUCTION.
 7. SMOKE ALARMS SHALL BE PROVIDED IN ALL BEDROOMS,
- OUTSIDE OF ALL BEDROOMS, AND ON EACH FLOOR AS REQUIRED. CARBON MONOXIDE DETECTORS SHALL BE INSTALLED OUTSIDE OF ALL BEDROOMS. SMOKE ALARMS AND CO DETECTORS SHALL BE HARDWIRED AND HAVE BATTERY BACKUP.
- 8. ACCESS DOOR LOCATIONS IN GYPSUM BOARD CEILINGS ARE INDICATED ON RCP'S ONLY WHERE ARCHITECTURALLY SIGNIFICANT. REFERENCE SPECIFICATIONS AND MEP DRAWINGS FOR OTHER ACCESS DOOR LOCATIONS.
- UNLESS PREFINISHED TO MATCH ADJACENT SURFACE, PAINT MECHANICAL GRILLS, DIFFUSERS, ACCESS PANELS, AND OTHER EQUIPMENT TO MATCH ADJACENT SURFACE.
 EXIT SIGNS ARE SHOWN ON RCP'S ONLY WHERE
- LOCATIONS ARE ARCHITECTURALLY SIGNIFICANT. 1. PROVIDE UL-CLASSIFIED LIGHT FIXTURES OR ENCLOSURES IN RATED FLOOR/CEILING ASSEMBLIES IN
- ACCORDANCE WITH IBC CHAPTER 7.
 12. REFER TO LIGHTING PLANS FOR EXACT FIXTURE TYPES AND LOCATIONS. FIXTURES SHOWN HERE ARE

REFERENCED AND SHOWN FOR GENERAL ALIGNMENT.

REVISIONS		
No.	Description	Date
1 2	IFC SET RFI #110	03.15.24 06.14.24
3 4	ASI 004 RFI #232	08.07.24 09.17.24
5	RFI #223.1	10.16.24
		+
PROJECT N	JMBER	2001
ISSUE DATE		03/15/202
	THE AMBLE	E
ISSUE		
	IFC SET	
	JNIT PLAN - COOM STANI LEVEL 04	
SHEET NO.		

TOWN STAMP

359

DESIGN

3630 OSAGE STREET DENVER, CO 80211 720.512.3437

B-2465

12/15/2023

ED ARC

_



0

GWB (C1) INTERIOR

INTERIOR

T&G CEILING (C2)

(C3) - EXTERIOR

ACCESS PANEL

FIBER-CEMENT SOFFIT

 $\longrightarrow \underset{\mathsf{NOTED}}{\mathsf{SLOPE CEILING AS}}$


INTERIOR

CEILING MOUNTED

VINYL SCRIM CLG -

ACCOUSTIC VINYL TILE CLG - INTERIOR


LIGHT FIXTURE

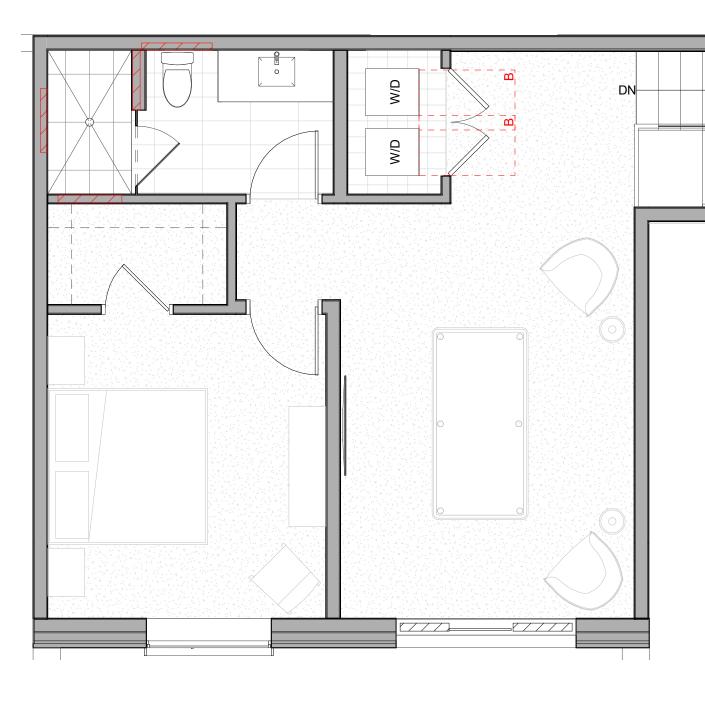




LEVEL 05 - 2 BED STANDARD LOFT FURNITURE


UNITS 407, 409, 410 $\sqrt{3}$

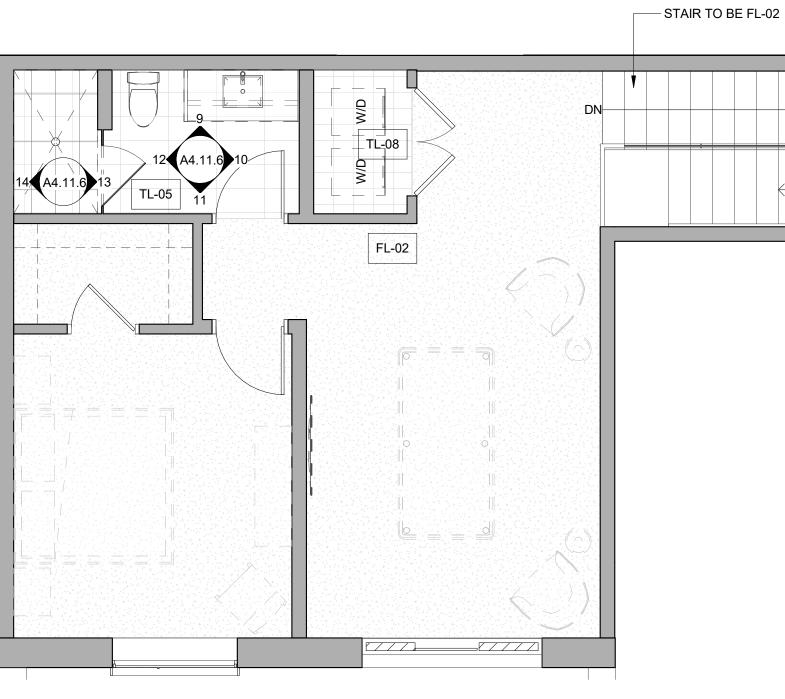





 $\sqrt{3}$

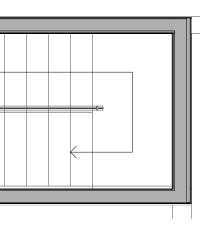

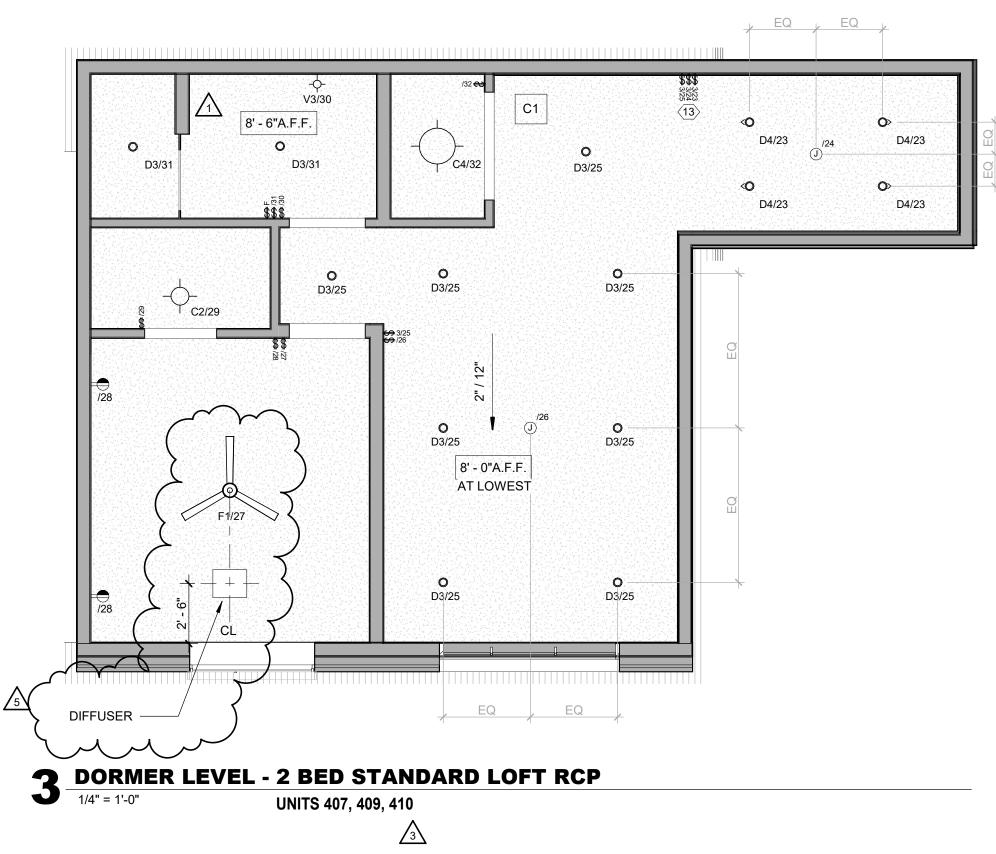



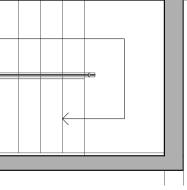

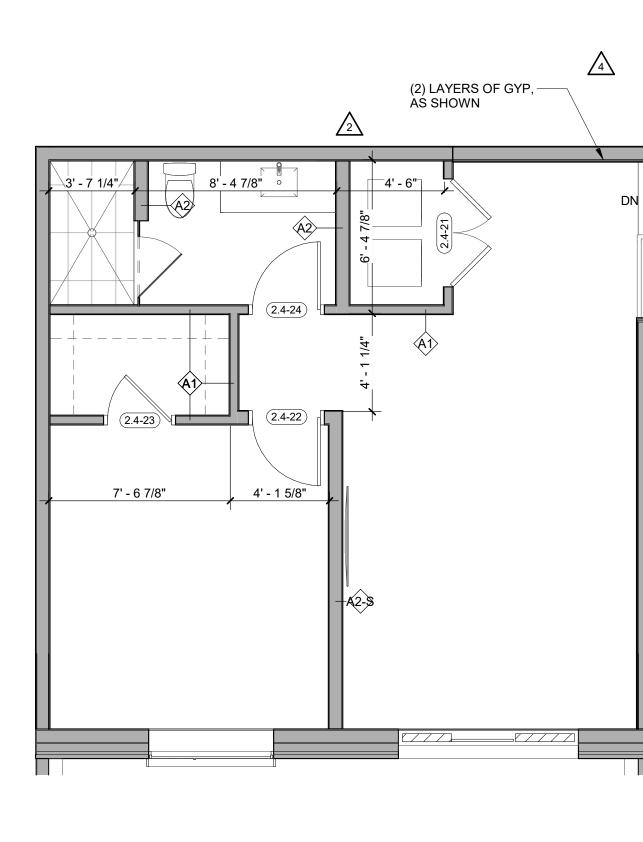

LEVEL 05 - 2 BED STANDARD DIMENSIONS UNITS 407, 409, 410 1/4" = 1'-0" $\sqrt{3}$

ENLARGED FLOOR PLAN - GENERAL NOTES

- REFER TO G0.2X SHEETS FOR EXTERIOR AND INTERIOR BUILDING ENCLOSURE ASSEMBLIES.
- REFER TO A1.0X SHEETS FOR EXTERIOR WALL, DEMISING WALL, AND CORRIDOR WALL TYPES AND LOCATIONS. REFER TO A1.1X SHEETS FOR INTERIOR AND EXTERIOR WINDOW/DOOR TAGS WITH UNIT BACKGROUNDS FOR
- REFERENCE. ALIGN WALLS WHERE THEY APPEAR TO ALIGN, U.N.O.
- THE INSIDE FACE OF DOOR JAMBS SHALL BE 4" FROM ADJACENT WALL OR FINISHED COLUMN, U.N.O.
- PROVIDE BLOCKING FOR ALL WALL MOUNTED EQUIPMENT AND ACCESSORIES.
- THE CENTERLINE OF ALL RESIDENTIAL TOILETS SHALL BE LOCATED 18" OFF OF FINISH FACE OF WALL, U.N.O.
- SWING CLEARANCE AT UNIT ENTRY SHALL BE 18" MIN. FROM FINISH FACE OF ADJACENT SURFACE.
- ALL DIMENSIONS ARE TO FACE OF STUD, GRID LINE, OR FACE OF CONCRETE, U.N.O. 10. WHERE "CLEAR" IS CALLED OUT ON A DIMENSION,
- PROVIDE DIMENSION FROM FACE OF FINISH TO FACE OF FINISH. 11. FURNITURE IS NOT IN CONTRACT, U.N.O., AND IS SHOWN
- FOR DIAGRAMATIC PURPOSES ONLY. 12. CONSULTANT MODELS SHOWN FOR REFERENCE ONLY.

ENLARGED FLOOR PLAN - LEGEND

	CARPET RE: FINISH SCHED.		RUBBER (F7) RE LANDSCAPE
	TILE RE: FINISH SCHED.		CONCRETE (F8) Re: Landscape
	WOOD - UNIT RE: FINISH SCHED.		PAVERS (F9) RE: LANDSCAPE
	WOOD - PUBLIC RE: FINISH SCHED.		
4 - 4 	POLISHED CONC. (F5.1) INTERIOR		
	SEALED CONC. (F5.2) INTERIOR		
	HERRINGBONE TILE (F6) RE: FINISH SCHED.		
ENI	ARGED FLOOR PLAN - C	CLEARA	NCE NOTES
	FLOOR CLEARANCE		


- A DOOR CLEARANCE, 54" X 60" B APPLIANCE CLEARANCE, 30" X 48"
- C CLEAR FLOOR CLEARANCE, 30" X 48"
- D VANITY CLEARANCE, 30" X 48"
- E TOILET CLEARANCE, 48" X 56" OR ADA 60" X 56"
- F SHOWER/TUB CLEARANCE, 30" X 48" (B)
- G TURN AROUND CLEARANCE
- GRAB BAR BLOCKING REQ. AT TOILET WALL WHERE APPLICABLE

ENLARGED RCP - GENERAL NOTES


- ALL UNIT CEILINGS SHALL BE 9' 0" A.F.F. U.N.O. REFER TO ENLARGED RCP'S FOR COMMON AREA CEILING HEIGHTS.
- IN THE CASE OF MINOR DISCREPANCIES BETWEEN MEP AND ARCHITECTURAL DOCUMENTS ON THE LOCATION OF CEILING MOUNTED COMPONENTS, THE ARCHITECTURAL RCP'S GOVERN. IN THE CASE OF MAJOR DISCREPANCIES, THE ARCHITECT SHALL BE NOTIFIED AS SOON AS THE DISCREPANCY IS DISCOVERED PRIOR TO PROCEEDING WITH THE WORK.
- REFERENCE MECHANICAL AND ELECTRICAL DRAWINGS FOR MOUNTING LOCATIONS OF ITEMS WHERE NO CEILING IS REQUIRED OR INDICATED.
- COORDINATE ALL TRADES INVOLVED IN THE CEILING WORK TO ENSURE CLEARANCE FOR FIXTURES, DUCTS, PIPING, CEILING SUSPENSION SYSTEMS, ETC. NECESSARY TO MAINTAIN CEILING HEIGHTS NOTED.
- LIGHTS, DIFFUSERS, EXIT SIGNS, SMOKE DETECTORS, SPEAKERS, STROBES, AND MISC. DEVICES SHALL BE CENTERED IN THE CEILING WHERE THEY OCCUR, U.N.O. FIRE PROTECTION SCOPE SHALL BE DESIGN-BUILD. ALL
- CORRIDOR SPRINKLER HEADS SHALL BE ALIGNED IN THE SAME LOCATION PARALLEL TO THE WALL WITHIN EACH SPECIFIC CEILING CONSTRUCTION.
- SMOKE ALARMS SHALL BE PROVIDED IN ALL BEDROOMS, OUTSIDE OF ALL BEDROOMS, AND ON EACH FLOOR AS REQUIRED. CARBON MONOXIDE DETECTORS SHALL BE INSTALLED OUTSIDE OF ALL BEDROOMS. SMOKE ALARMS AND CO DETECTORS SHALL BE HARDWIRED AND HAVE BATTERY BACKUP.
- ACCESS DOOR LOCATIONS IN GYPSUM BOARD CEILINGS ARE INDICATED ON RCP'S ONLY WHERE ARCHITECTURALLY SIGNIFICANT. REFERENCE SPECIFICATIONS AND MEP DRAWINGS FOR OTHER
- ACCESS DOOR LOCATIONS. UNLESS PREFINISHED TO MATCH ADJACENT SURFACE, PAINT MECHANICAL GRILLS, DIFFUSERS, ACCESS PANELS, AND OTHER EQUIPMENT TO MATCH ADJACENT SURFACE.
- 10. EXIT SIGNS ARE SHOWN ON RCP'S ONLY WHERE LOCATIONS ARE ARCHITECTURALLY SIGNIFICANT. 11. PROVIDE UL-CLASSIFIED LIGHT FIXTURES OR
- ENCLOSURES IN RATED FLOOR/CEILING ASSEMBLIES IN ACCORDANCE WITH IBC CHAPTER 7. 12. REFER TO LIGHTING PLANS FOR EXACT FIXTURE TYPES AND LOCATIONS. FIXTURES SHOWN HERE ARE
- REFERENCED AND SHOWN FOR GENERAL ALIGNMENT.

GWB (C1) INTERIOR	\rightarrow	SLOPE CEILING AS NOTED
T&G CEILING (C2) INTERIOR	0	CEILING MOUNTED LIGHT FIXTURE
FIBER-CEMENT SOFFIT (C3) - EXTERIOR	+ + + + + + + + + + + + + + + + + + + +	VINYL SCRIM CLG - INTERIOR
ACCESS PANEL		ACCOUSTIC VINYL TILE CLG - INTERIOR

<text><text></text></text>
BRSCED. WINS B-2465 12/15/2023
The Amble Steamboat Springs, CO
IFC SET IFC SET SHEET TITLE UNIT PLAN - 2 BEDROOM STANDARD - LEVEL 05 SHEET NO.

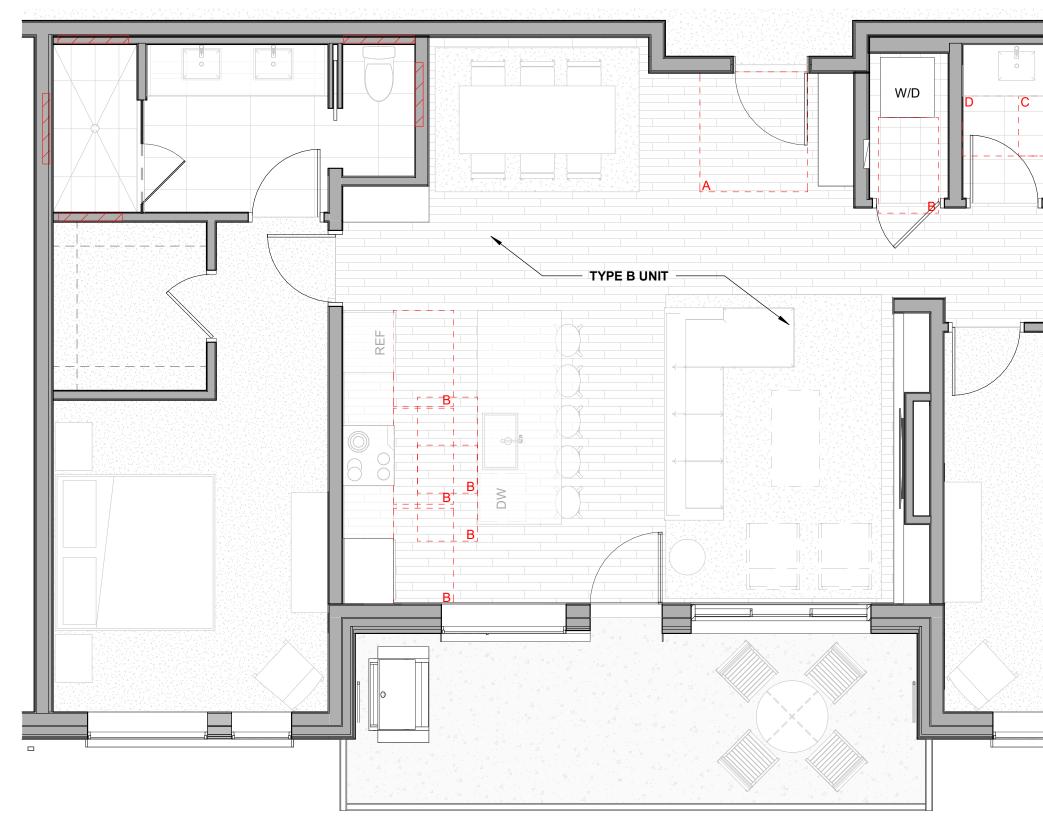





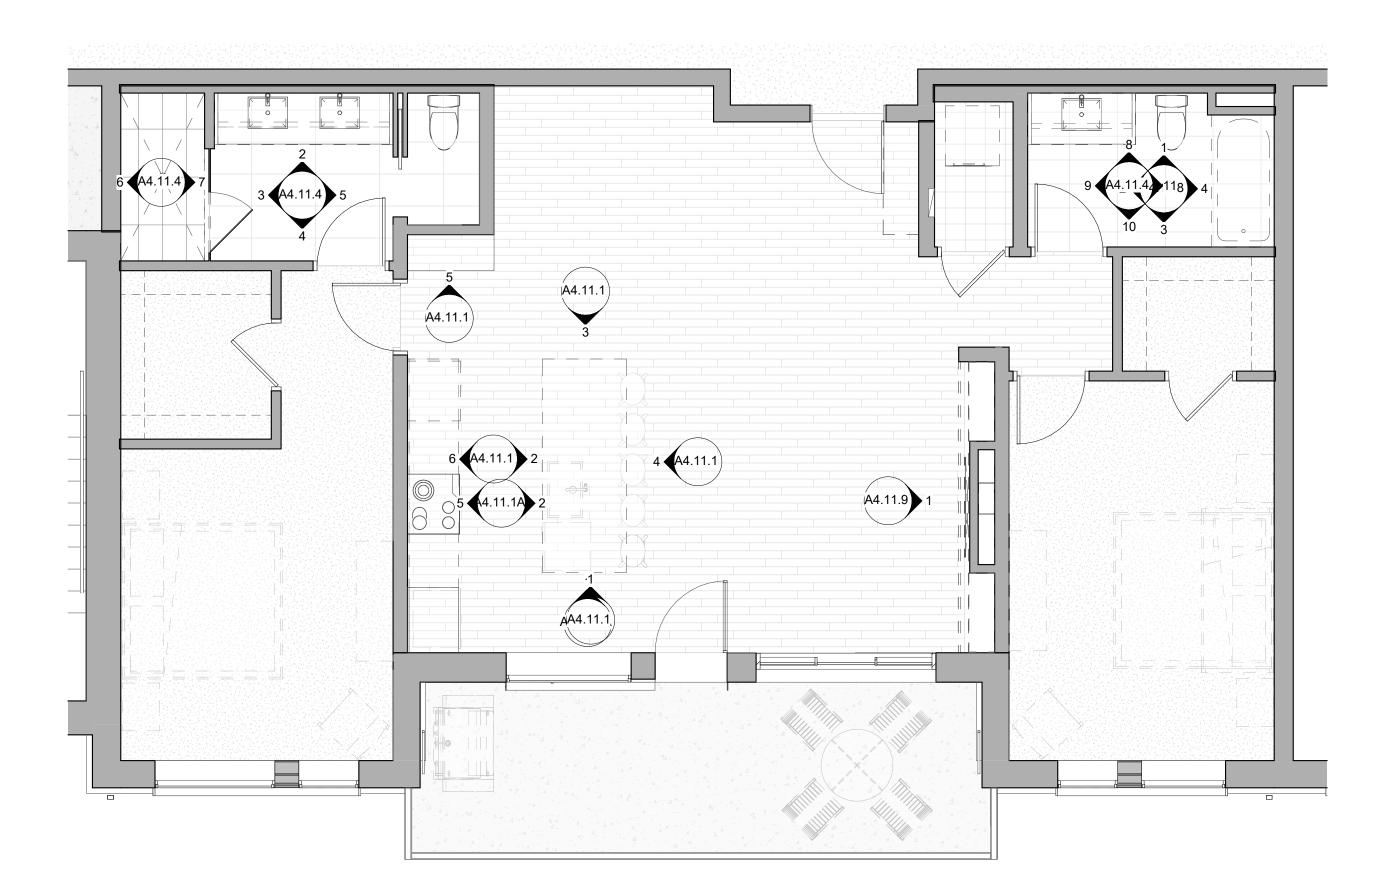


2 Level 02 - 2 BEDROOM STANDARD-FINISH 1/4" = 1'-0" UNIT 209

UNIT 209

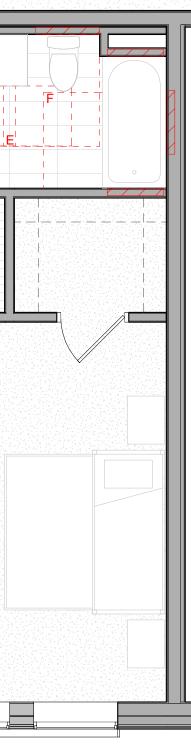

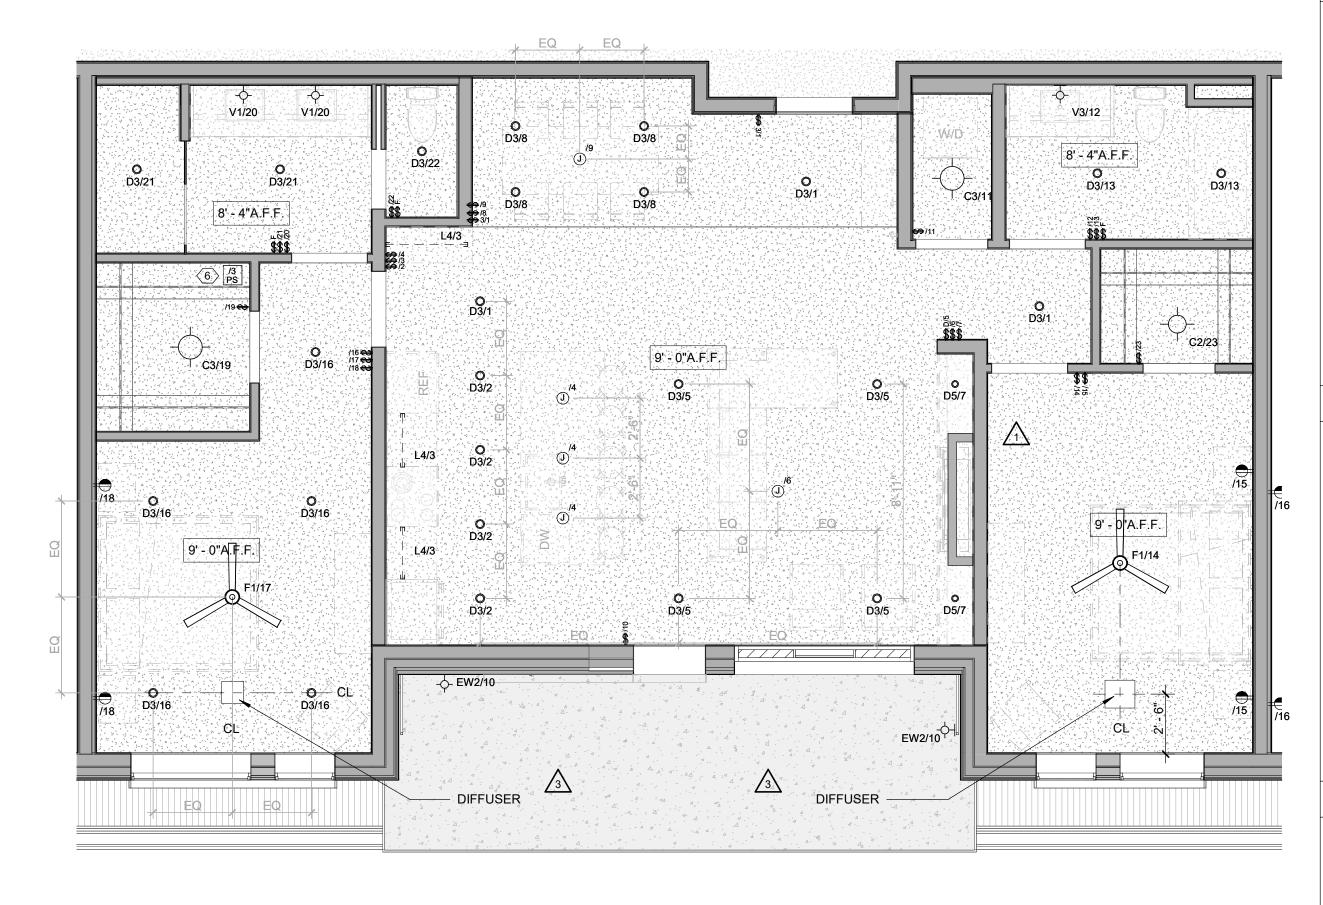


3 Level 02 - 2 BEDROOM STANDARD-RCP 1/4" = 1'-0" UNIT 209 **UNIT 209**

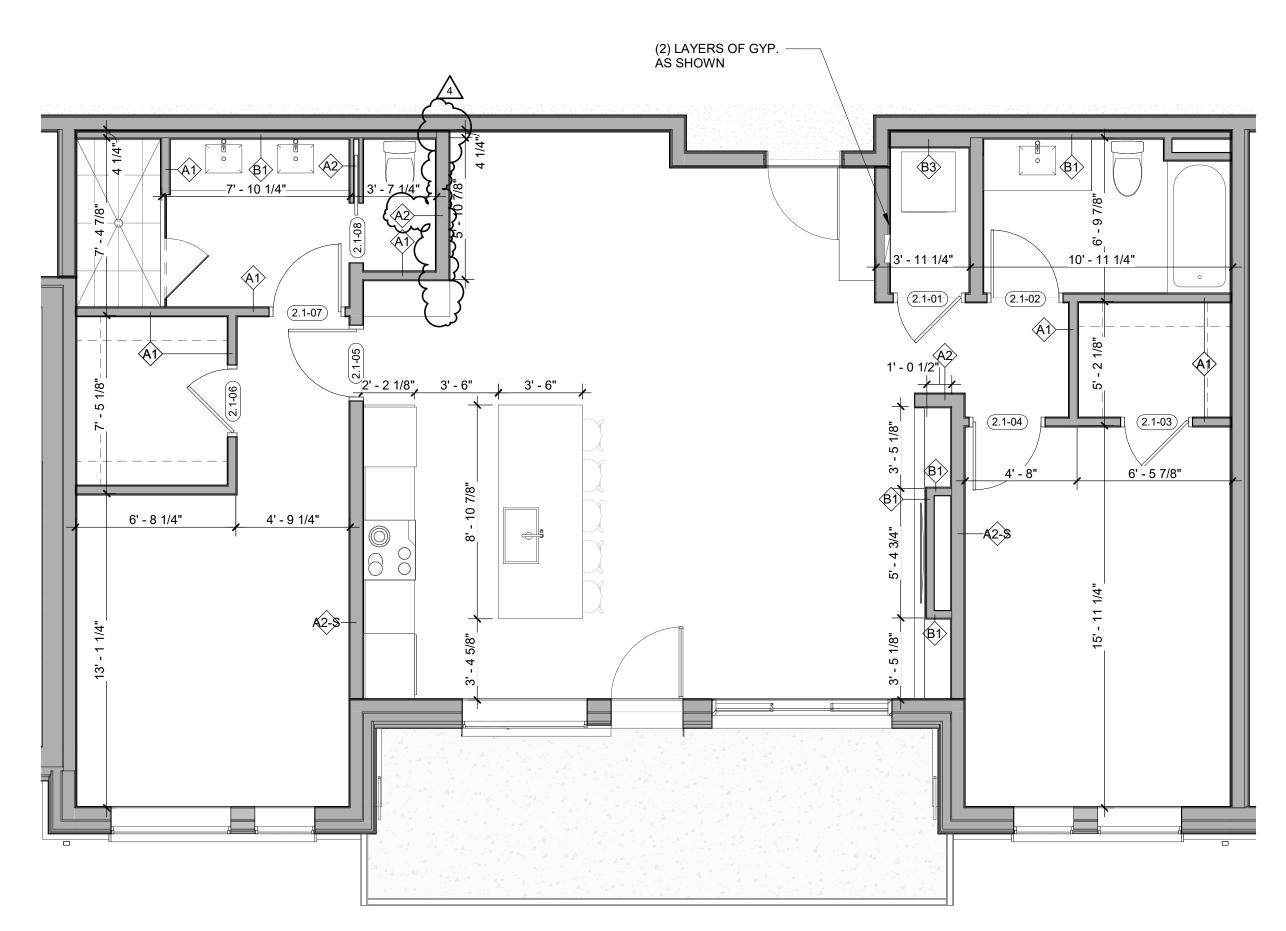

ENLARGED FLOOR PLAN - GENERAL NOTES

- REFER TO G0.2X SHEETS FOR EXTERIOR AND INTERIOR BUILDING ENCLOSURE ASSEMBLIES. REFER TO A1.0X SHEETS FOR EXTERIOR WALL, DEMISING WALL, AND CORRIDOR WALL TYPES AND LOCATIONS.
- REFER TO A1.1X SHEETS FOR INTERIOR AND EXTERIOR WINDOW/DOOR TAGS WITH UNIT BACKGROUNDS FOR REFERENCE.
- ALIGN WALLS WHERE THEY APPEAR TO ALIGN, U.N.O. THE INSIDE FACE OF DOOR JAMBS SHALL BE 4" FROM
- ADJACENT WALL OR FINISHED COLUMN, U.N.O. PROVIDE BLOCKING FOR ALL WALL MOUNTED EQUIPMENT AND ACCESSORIES.
- THE CENTERLINE OF ALL RESIDENTIAL TOILETS SHALL BE
- LOCATED 18" OFF OF FINISH FACE OF WALL, U.N.O. SWING CLEARANCE AT UNIT ENTRY SHALL BE 18" MIN.
- FROM FINISH FACE OF ADJACENT SURFACE. ALL DIMENSIONS ARE TO FACE OF STUD, GRID LINE, OR
- FACE OF CONCRETE, U.N.O. 10. WHERE "CLEAR" IS CALLED OUT ON A DIMENSION,
- PROVIDE DIMENSION FROM FACE OF FINISH TO FACE OF FINISH.
- 11. FURNITURE IS NOT IN CONTRACT, U.N.O., AND IS SHOWN FOR DIAGRAMATIC PURPOSES ONLY.
- 12. CONSULTANT MODELS SHOWN FOR REFERENCE ONLY.

ENLARGED FLOOR PLAN - LEGEND

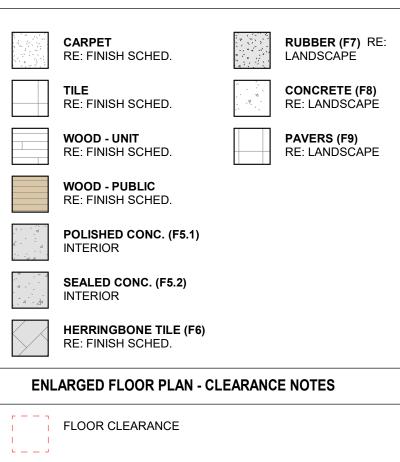


- A DOOR CLEARANCE, 54" X 60"
- B APPLIANCE CLEARANCE, 30" X 48"
- C CLEAR FLOOR CLEARANCE, 30" X 48"
- D VANITY CLEARANCE, 30" X 48"
- E TOILET CLEARANCE, 48" X 56" OR ADA 60" X 56"
- F SHOWER/TUB CLEARANCE, 30" X 48" (B) \triangle
- G TURN AROUND CLEARANCE
- GRAB BAR BLOCKING REQ. AT TOILET WALL WHERE APPLICABLE

ENLARGED RCP - GENERAL NOTES


- ALL UNIT CEILINGS SHALL BE 9' 0" A.F.F. U.N.O. REFER TO ENLARGED RCP'S FOR COMMON AREA CEILING HEIGHTS.
- IN THE CASE OF MINOR DISCREPANCIES BETWEEN MEP AND ARCHITECTURAL DOCUMENTS ON THE LOCATION OF CEILING MOUNTED COMPONENTS, THE ARCHITECTURAL RCP'S GOVERN. IN THE CASE OF MAJOR DISCREPANCIES, THE ARCHITECT SHALL BE NOTIFIED AS SOON AS THE DISCREPANCY IS DISCOVERED PRIOR TO PROCEEDING WITH THE WORK.
- REFERENCE MECHANICAL AND ELECTRICAL DRAWINGS FOR MOUNTING LOCATIONS OF ITEMS WHERE NO CEILING IS REQUIRED OR INDICATED.
- COORDINATE ALL TRADES INVOLVED IN THE CEILING WORK TO ENSURE CLEARANCE FOR FIXTURES, DUCTS, PIPING, CEILING SUSPENSION SYSTEMS, ETC. NECESSARY TO MAINTAIN CEILING HEIGHTS NOTED.
- LIGHTS, DIFFUSERS, EXIT SIGNS, SMOKE DETECTORS, SPEAKERS, STROBES, AND MISC. DEVICES SHALL BE CENTERED IN THE CEILING WHERE THEY OCCUR, U.N.O. FIRE PROTECTION SCOPE SHALL BE DESIGN-BUILD. ALL CORRIDOR SPRINKLER HEADS SHALL BE ALIGNED IN THE
- SAME LOCATION PARALLEL TO THE WALL WITHIN EACH SPECIFIC CEILING CONSTRUCTION. SMOKE ALARMS SHALL BE PROVIDED IN ALL BEDROOMS,
- OUTSIDE OF ALL BEDROOMS, AND ON EACH FLOOR AS REQUIRED. CARBON MONOXIDE DETECTORS SHALL BE INSTALLED OUTSIDE OF ALL BEDROOMS. SMOKE ALARMS AND CO DETECTORS SHALL BE HARDWIRED AND HAVE BATTERY BACKUP.
- ACCESS DOOR LOCATIONS IN GYPSUM BOARD CEILINGS ARE INDICATED ON RCP'S ONLY WHERE ARCHITECTURALLY SIGNIFICANT. REFERENCE SPECIFICATIONS AND MEP DRAWINGS FOR OTHER ACCESS DOOR LOCATIONS.
- UNLESS PREFINISHED TO MATCH ADJACENT SURFACE, PAINT MECHANICAL GRILLS, DIFFUSERS, ACCESS PANELS, AND OTHER EQUIPMENT TO MATCH ADJACENT SURFACE.
- 10. EXIT SIGNS ARE SHOWN ON RCP'S ONLY WHERE LOCATIONS ARE ARCHITECTURALLY SIGNIFICANT. 11. PROVIDE UL-CLASSIFIED LIGHT FIXTURES OR
- ENCLOSURES IN RATED FLOOR/CEILING ASSEMBLIES IN

REFER	RDANCE WITH IBC CHAPTER TO LIGHTING PLANS FOR E OCATIONS. FIXTURES SHOV RENCED AND SHOWN FOR (EXACT FIX	ARE	
	ENLARGED RCP -	LEGENI	D	
$\begin{array}{cccc} & \rightarrow & \sqrt{2} \\ & \rightarrow & \sqrt{2} \\ & \gamma & \gamma & \gamma & \gamma \\ & \gamma & \gamma & \gamma & \gamma \\ & \gamma & \gamma$	GWB (C1) INTERIOR	\rightarrow	SLOPE CEILING AS NOTED	
	T&G CEILING (C2) INTERIOR	0	CEILING MOUNTED LIGHT FIXTURE	
	FIBER-CEMENT SOFFIT (C3) - EXTERIOR	+ + + + + + + + + + + + + + + + + + + +	VINYL SCRIM CLG - INTERIOR	
	ACCESS PANEL		ACOUSTIC VINYL TILE CLG - INTERIOR	


<text><text></text></text>
BASEED. MINS B-2465 12/15/2023
The Amble Steamboat Springs, CO
REVISIONS No. Description Date 1 06 14 24 08 07 24 3 01 62 24 01 62 24 4 RFI #339 11 13 24 4 Gatta and and and and and and and and and an
SHEET TITLE UNIT PLAN - 2 BEDROOM STANDARD - LEVELS 02 UNIT 209 SHEET NO.

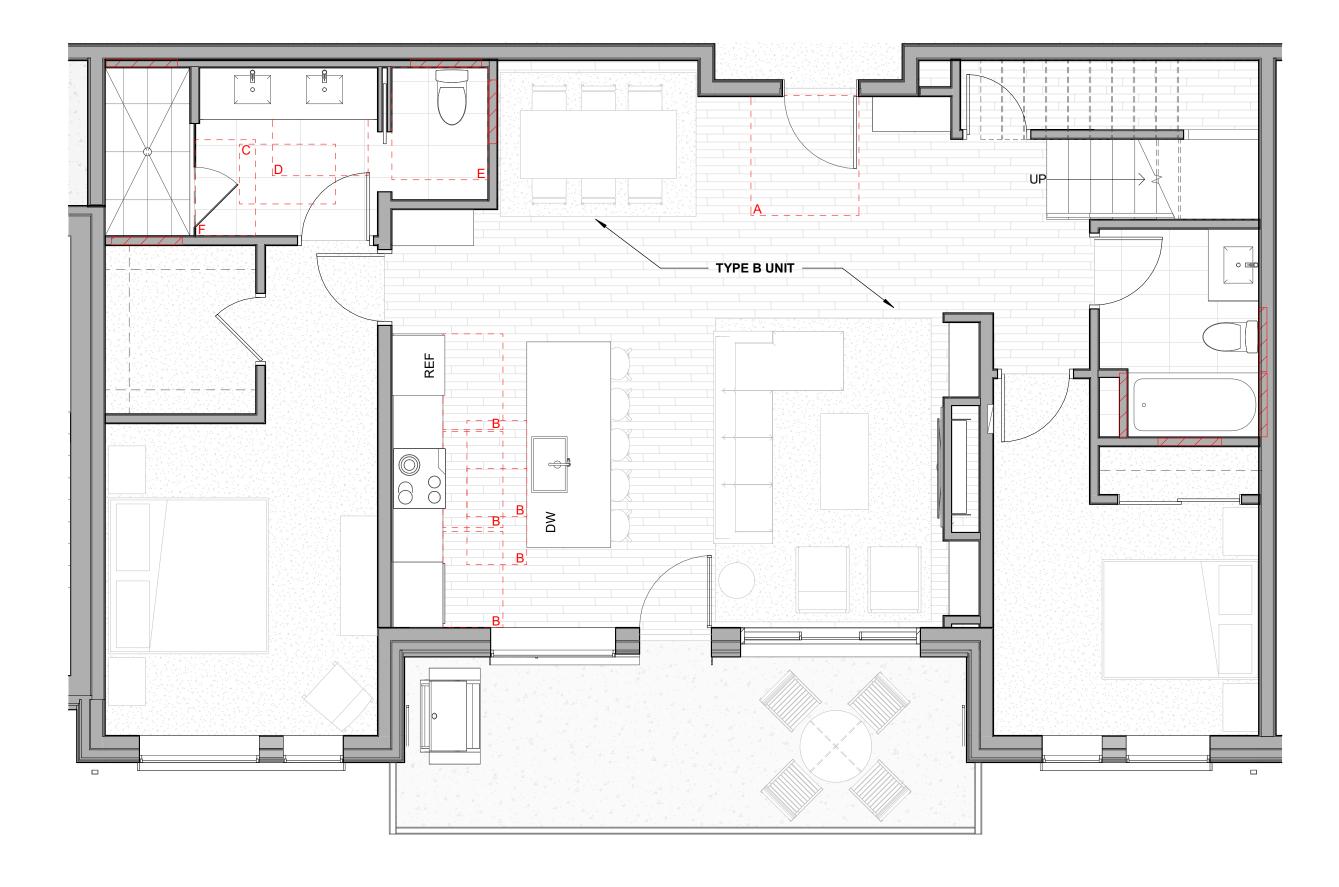



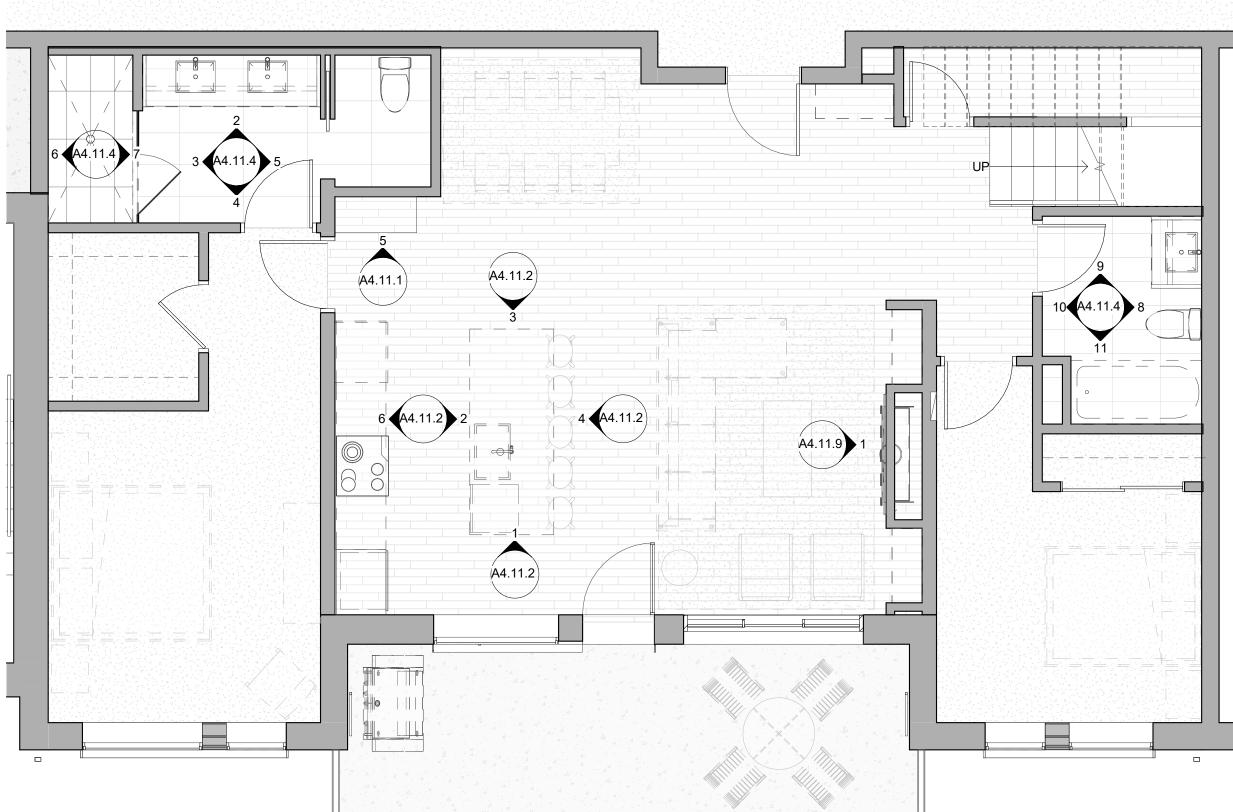


SEE 3/A4.02.4 FOR UNIT RCP

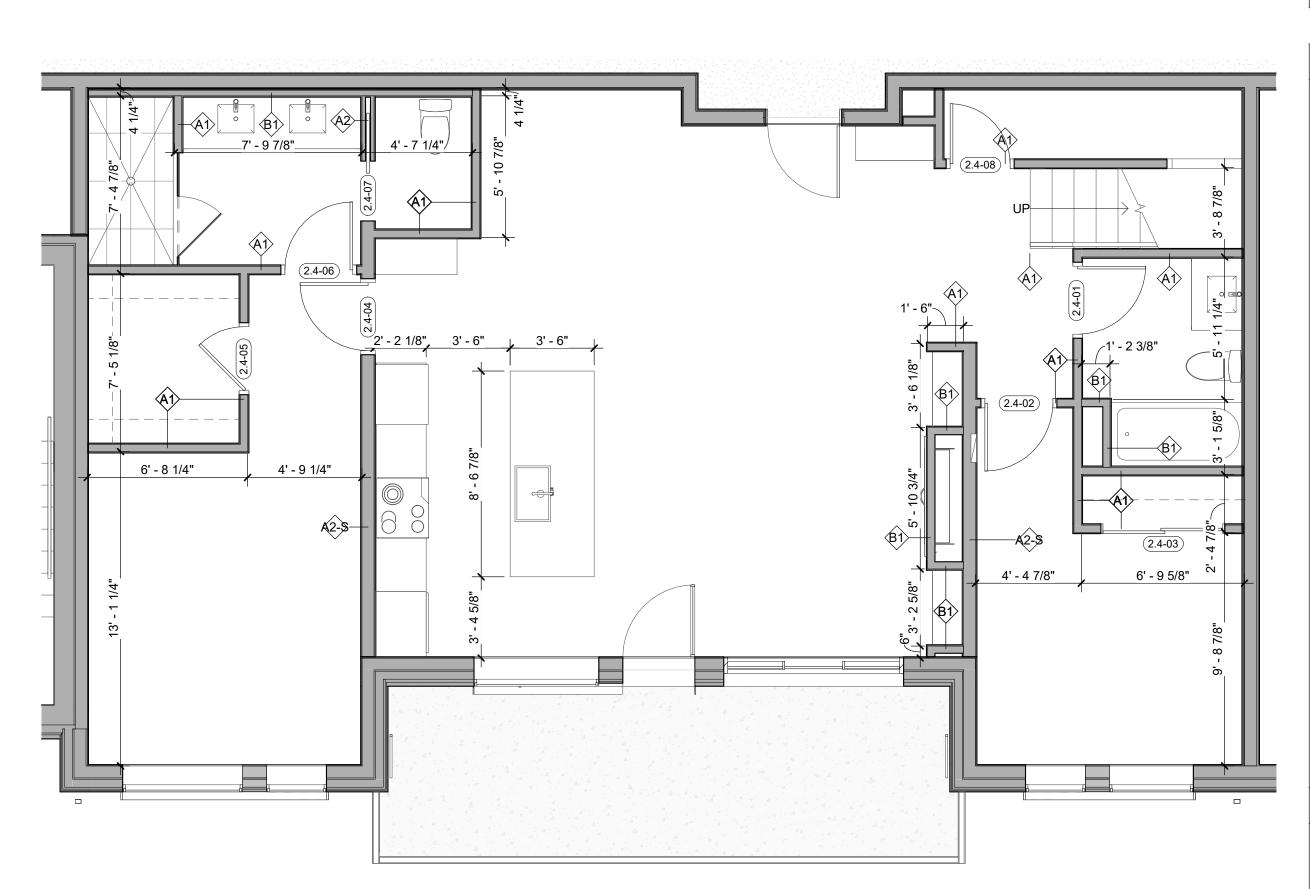

ENLARGED FLOOR PLAN - GENERAL NOTES

- . REFER TO G0.2X SHEETS FOR EXTERIOR AND INTERIOR
- BUILDING ENCLOSURE ASSEMBLIES. 2. REFER TO A1.0X SHEETS FOR EXTERIOR WALL, DEMISING
- WALL, AND CORRIDOR WALL TYPES AND LOCATIONS.
 REFER TO A1.1X SHEETS FOR INTERIOR AND EXTERIOR WINDOW/DOOR TAGS WITH UNIT BACKGROUNDS FOR REFERENCE.
- 4. ALIGN WALLS WHERE THEY APPEAR TO ALIGN, U.N.O.
- 5. THE INSIDE FACE OF DOOR JAMBS SHALL BE 4" FROM ADJACENT WALL OR FINISHED COLUMN, U.N.O.
- 6. PROVIDE BLOCKING FOR ALL WALL MOUNTED EQUIPMENT AND ACCESSORIES.
- 7. THE CENTERLINE OF ALL RESIDENTIAL TOILETS SHALL BE
- LOCATED 18" OFF OF FINISH FACE OF WALL, U.N.O. 8. SWING CLEARANCE AT UNIT ENTRY SHALL BE 18" MIN.
- FROM FINISH FACE OF ADJACENT SURFACE. 9. ALL DIMENSIONS ARE TO FACE OF STUD, GRID LINE, OR
- 9. ALL DIMENSIONS ARE TO FACE OF STUD, GRID LINE, OR FACE OF CONCRETE, U.N.O.
 10. WHERE "CLEAR" IS CALLED OUT ON A DIMENSION,
- PROVIDE DIMENSION FROM FACE OF FINISH TO FACE OF FINISH.11. FURNITURE IS NOT IN CONTRACT, U.N.O., AND IS SHOWN
- FOR DIAGRAMATIC PURPOSES ONLY. 12. CONSULTANT MODELS SHOWN FOR REFERENCE ONLY.

ENLARGED FLOOR PLAN - LEGEND

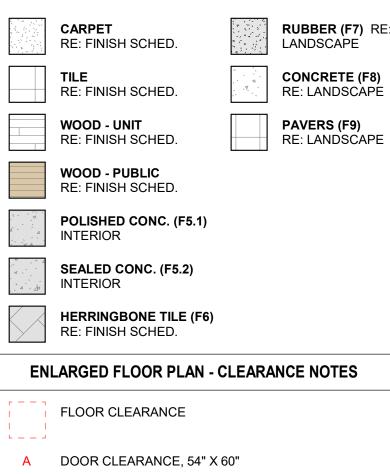

- A DOOR CLEARANCE, 34 X 80
 B APPLIANCE CLEARANCE, 30" X 48"
 C CLEAR FLOOR CLEARANCE, 30" X 48"
 D VANITY CLEARANCE, 30" X 48"
- E TOILET CLEARANCE, 48" X 56" OR ADA 60" X 56"
- F SHOWER/TUB CLEARANCE, 30" X 48" (B)
 G TURN AROUND CLEARANCE
- GRAB BAR BLOCKING REQ. AT TOILET WALL WHERE APPLICABLE

ENLARGED RCP - GENERAL NOTES

- 1. ALL UNIT CEILINGS SHALL BE 9' 0" A.F.F. U.N.O. REFER TO ENLARGED RCP'S FOR COMMON AREA CEILING HEIGHTS.
- 2. IN THE CASE OF MINOR DISCREPANCIES BETWEEN MEP AND ARCHITECTURAL DOCUMENTS ON THE LOCATION OF CEILING MOUNTED COMPONENTS, THE ARCHITECTURAL RCP'S GOVERN. IN THE CASE OF MAJOR DISCREPANCIES, THE ARCHITECT SHALL BE NOTIFIED AS SOON AS THE DISCREPANCY IS DISCOVERED PRIOR TO PROCEEDING WITH THE WORK.
- 3. REFERENCE MECHANICAL AND ELECTRICAL DRAWINGS FOR MOUNTING LOCATIONS OF ITEMS WHERE NO CEILING IS REQUIRED OR INDICATED.
- 4. COORDINATE ALL TRADES INVOLVED IN THE CEILING WORK TO ENSURE CLEARANCE FOR FIXTURES, DUCTS, PIPING, CEILING SUSPENSION SYSTEMS, ETC. NECESSARY TO MAINTAIN CEILING HEIGHTS NOTED.
- LIGHTS, DIFFUSERS, EXIT SIGNS, SMOKE DETECTORS, SPEAKERS, STROBES, AND MISC. DEVICES SHALL BE CENTERED IN THE CEILING WHERE THEY OCCUR, U.N.O.
 FIRE PROTECTION SCOPE SHALL BE DESIGN-BUILD. ALL
- CORRIDOR SPRINKLER HEADS SHALL BE ALIGNED IN THE SAME LOCATION PARALLEL TO THE WALL WITHIN EACH SPECIFIC CEILING CONSTRUCTION.
- 7. SMOKE ALARMS SHALL BE PROVIDED IN ALL BEDROOMS, OUTSIDE OF ALL BEDROOMS, AND ON EACH FLOOR AS REQUIRED. CARBON MONOXIDE DETECTORS SHALL BE INSTALLED OUTSIDE OF ALL BEDROOMS. SMOKE ALARMS AND CO DETECTORS SHALL BE HARDWIRED AND HAVE BATTERY BACKUP.
- 8. ACCESS DOOR LOCATIONS IN GYPSUM BOARD CEILINGS ARE INDICATED ON RCP'S ONLY WHERE ARCHITECTURALLY SIGNIFICANT. REFERENCE SPECIFICATIONS AND MEP DRAWINGS FOR OTHER ACCESS DOOR LOCATIONS.
- 9. UNLESS PREFINISHED TO MATCH ADJACENT SURFACE, PAINT MECHANICAL GRILLS, DIFFUSERS, ACCESS PANELS, AND OTHER EQUIPMENT TO MATCH ADJACENT SURFACE.
 10. EXIT SIGNS ARE SHOWN ON RCP'S ONLY WHERE
- LOCATIONS ARE ARCHITECTURALLY SIGNIFICANT.
 PROVIDE UL-CLASSIFIED LIGHT FIXTURES OR ENCLOSURES IN RATED FLOOR/CEILING ASSEMBLIES IN
- ACCORDANCE WITH IBC CHAPTER 7.
 12. REFER TO LIGHTING PLANS FOR EXACT FIXTURE TYPES AND LOCATIONS. FIXTURES SHOWN HERE ARE

REFERENCED AND SHOWN FOR GENERAL ALIGNMENT.

	The Amble	Steamboat Springs, CO	
REVISIONS NO.	Des(cription	Date
PROJECT NI	JMBER		20019
ISSUE DATE	THE	AMBLE C SET PLAN -	2
LEV	ELS		

TOWN STAMP

359

DESIGN


3630 OSAGE STREET DENVER, CO 80211 720.512.3437


B-2465


12/15/2023

ED ARU

ENLARGED RCP - LEGEND

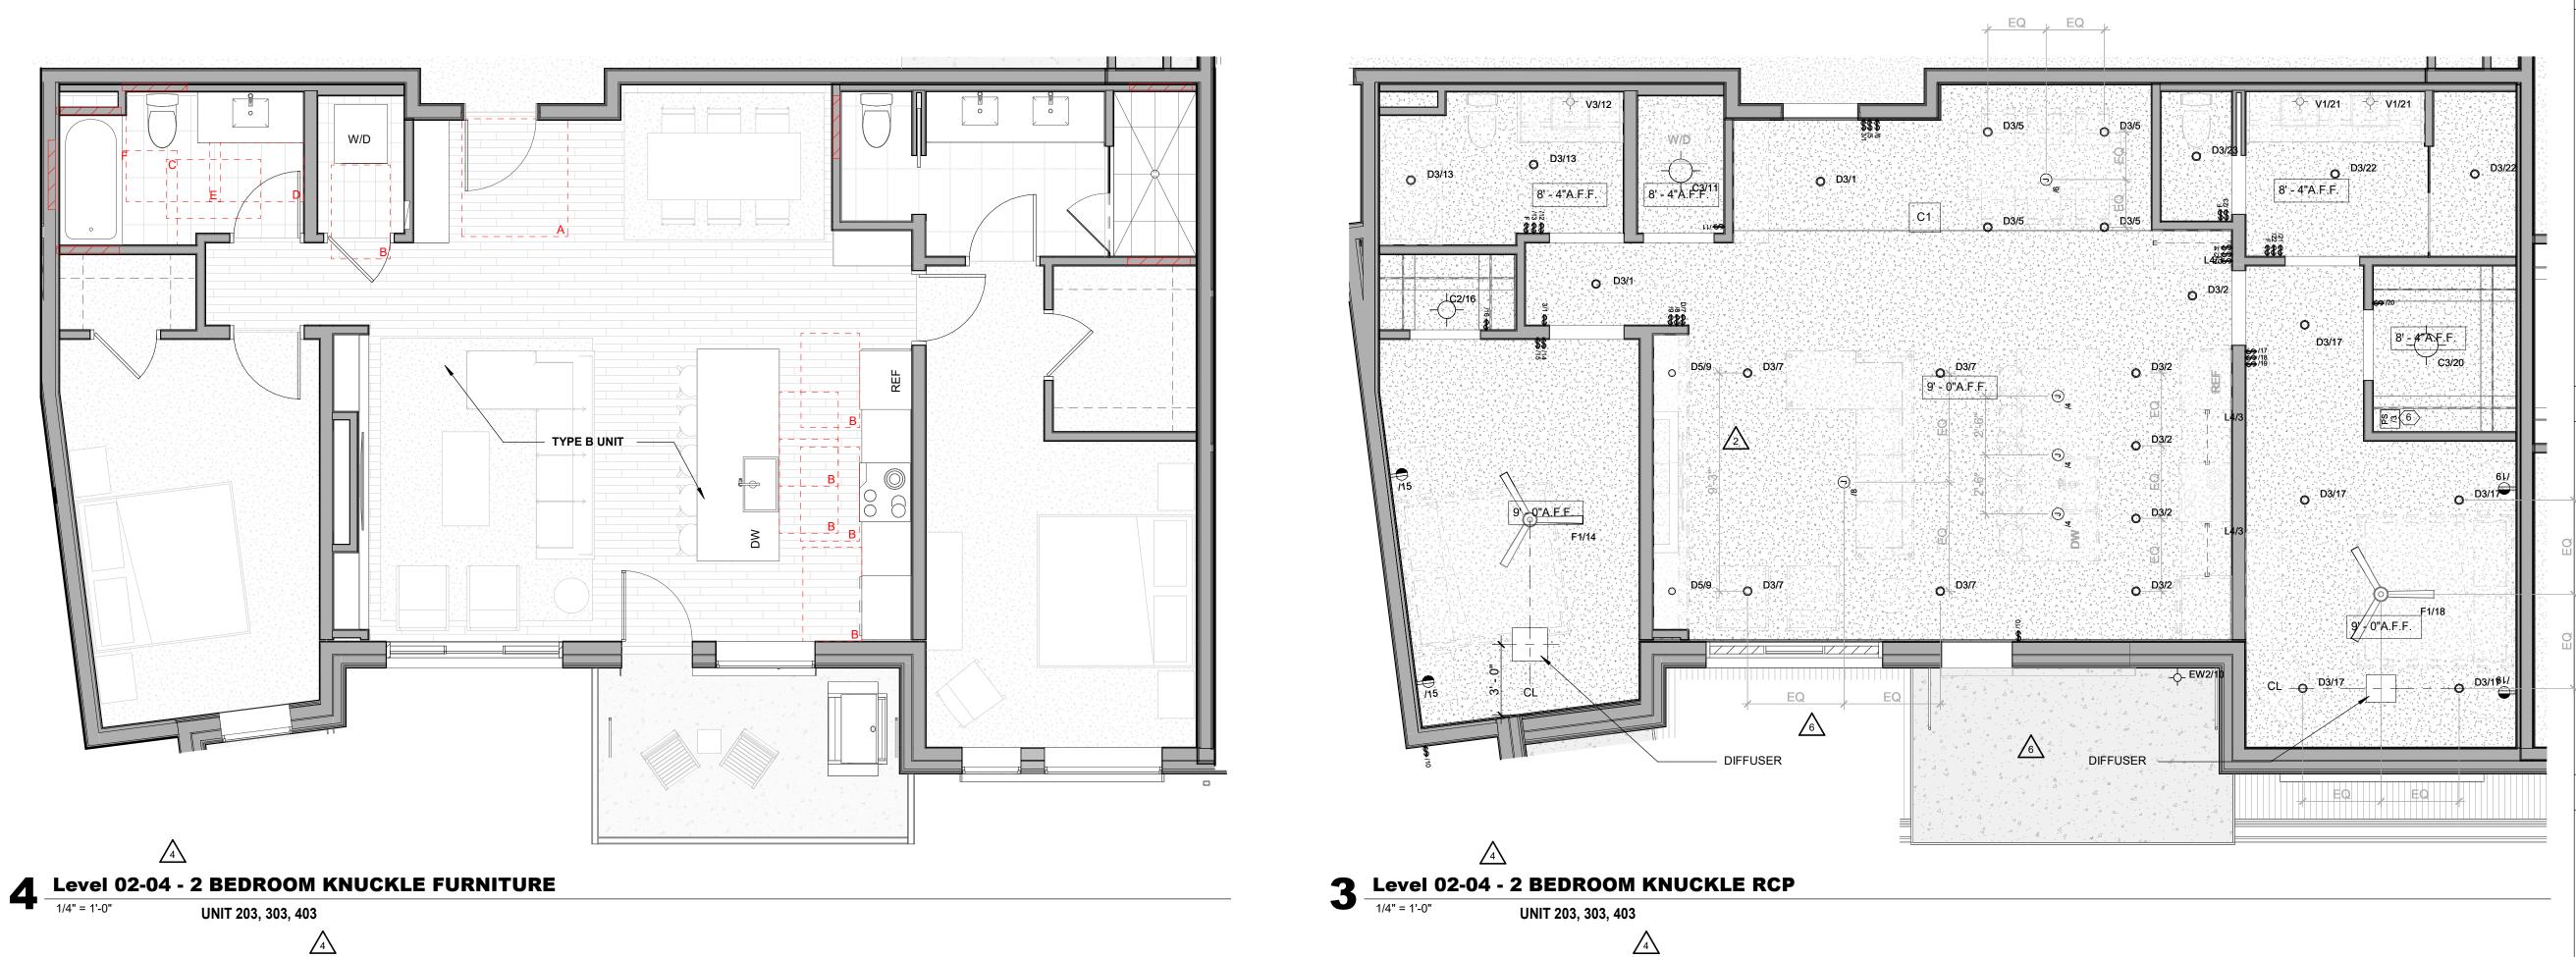

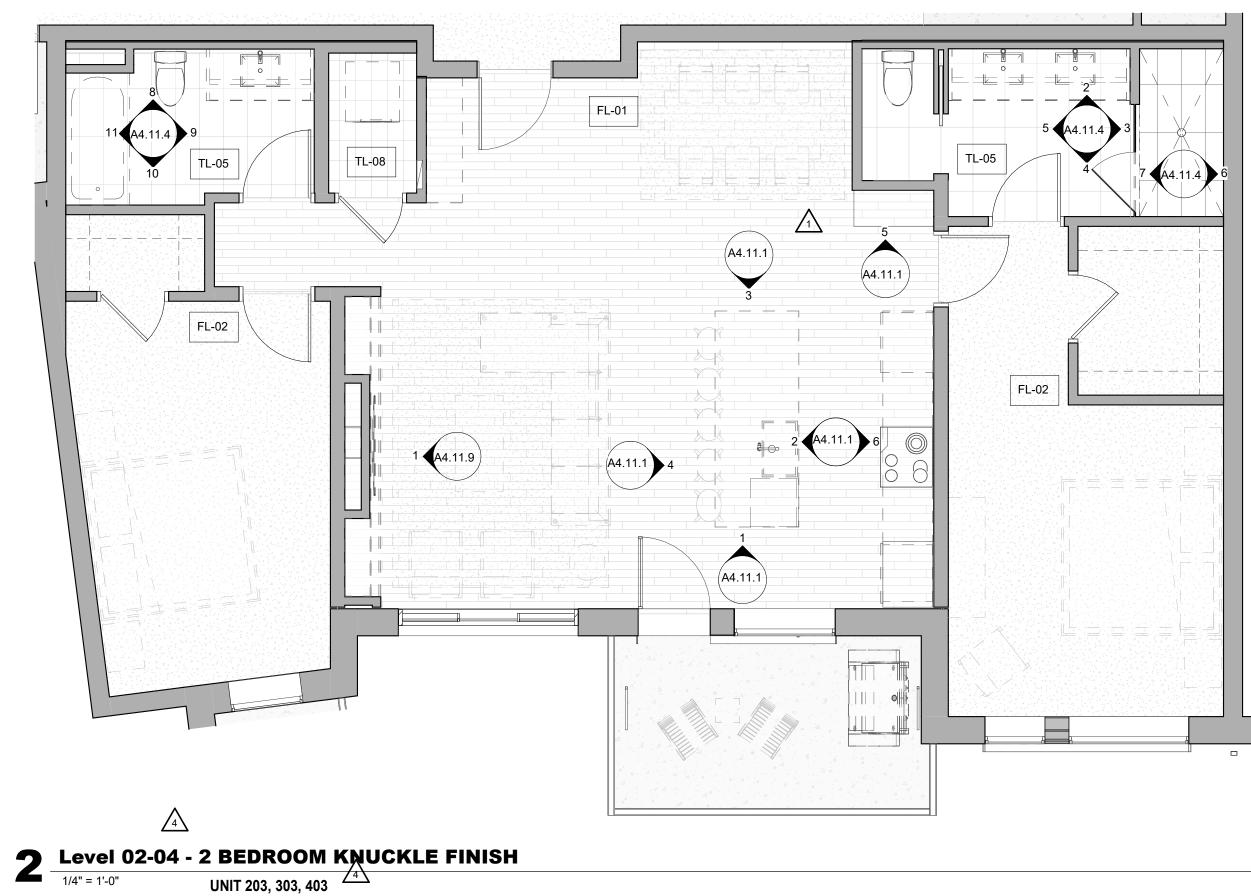

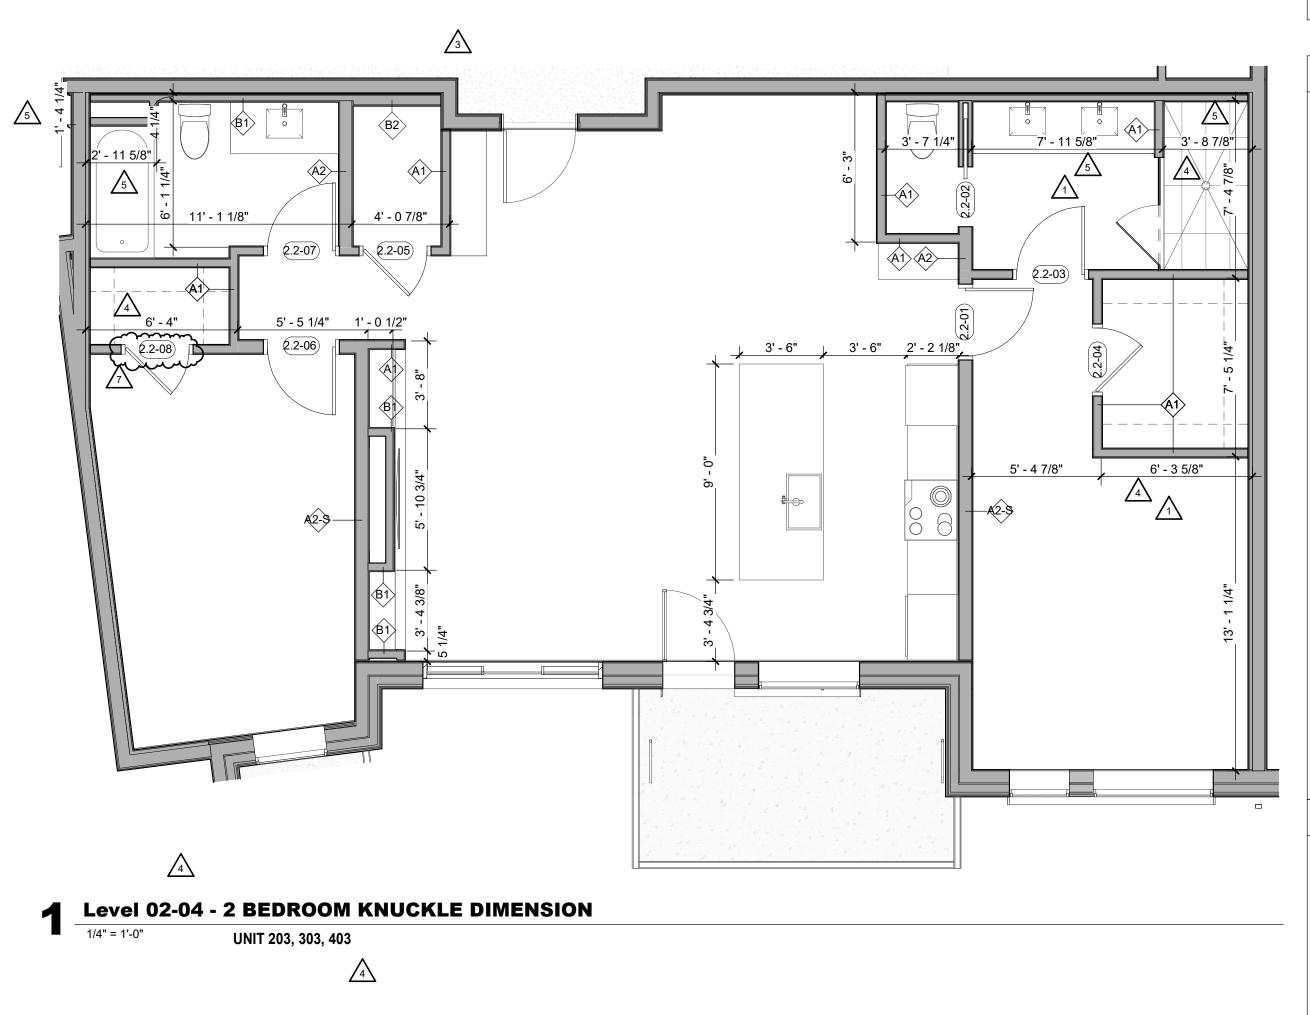

- REFER TO G0.2X SHEETS FOR EXTERIOR AND INTERIOR BUILDING ENCLOSURE ASSEMBLIES. REFER TO A1.0X SHEETS FOR EXTERIOR WALL, DEMISING WALL, AND CORRIDOR WALL TYPES AND LOCATIONS.
- REFER TO A1.1X SHEETS FOR INTERIOR AND EXTERIOR WINDOW/DOOR TAGS WITH UNIT BACKGROUNDS FOR REFERENCE.
- ALIGN WALLS WHERE THEY APPEAR TO ALIGN, U.N.O. THE INSIDE FACE OF DOOR JAMBS SHALL BE 4" FROM ADJACENT WALL OR FINISHED COLUMN, U.N.O.
- PROVIDE BLOCKING FOR ALL WALL MOUNTED EQUIPMENT AND ACCESSORIES.
- THE CENTERLINE OF ALL RESIDENTIAL TOILETS SHALL BE LOCATED 18" OFF OF FINISH FACE OF WALL, U.N.O.
- SWING CLEARANCE AT UNIT ENTRY SHALL BE 18" MIN. FROM FINISH FACE OF ADJACENT SURFACE.
- ALL DIMENSIONS ARE TO FACE OF STUD, GRID LINE, OR
- FACE OF CONCRETE, U.N.O. WHERE "CLEAR" IS CALLED OUT ON A DIMENSION,
- PROVIDE DIMENSION FROM FACE OF FINISH TO FACE OF FINISH. 11. FURNITURE IS NOT IN CONTRACT, U.N.O., AND IS SHOWN
- FOR DIAGRAMATIC PURPOSES ONLY. 12. CONSULTANT MODELS SHOWN FOR REFERENCE ONLY.

ENLARGED FLOOR PLAN - LEGEND

- RUBBER (F7) RE: CARPET RE: FINISH SCHED. LANDSCAPE CONCRETE (F8) TILE RE: FINISH SCHED. RE: LANDSCAPE WOOD - UNIT PAVERS (F9) RE: FINISH SCHED. RE: LANDSCAPE WOOD - PUBLIC RE: FINISH SCHED. POLISHED CONC. (F5.1) INTERIOR SEALED CONC. (F5.2) INTERIOR HERRINGBONE TILE (F6) RE: FINISH SCHED. ENLARGED FLOOR PLAN - CLEARANCE NOTES FLOOR CLEARANCE _ __ _ _
- A DOOR CLEARANCE, 54" X 60"
- B APPLIANCE CLEARANCE, 30" X 48"
- C CLEAR FLOOR CLEARANCE, 30" X 48"
- D VANITY CLEARANCE, 30" X 48"
- E TOILET CLEARANCE, 48" X 56" OR ADA 60" X 56" \triangle
- F SHOWER/TUB CLEARANCE, 30" X 48" (B)
- G TURN AROUND CLEARANCE
- GRAB BAR BLOCKING RE WALL WHERE APPLICAB

ENLARGED RCP - GENERAL NOTES

- ALL UNIT CEILINGS SHALL BE 9' 0" A.F.F. U.N.O. REFER TO ENLARGED RCP'S FOR COMMON AREA CEILING HEIGHTS.
- IN THE CASE OF MINOR DISCREPANCIES BETWEEN MEP AND ARCHITECTURAL DOCUMENTS ON THE LOCATION OF CEILING MOUNTED COMPONENTS, THE ARCHITECTURAL RCP'S GOVERN. IN THE CASE OF MAJOR DISCREPANCIES, THE ARCHITECT SHALL BE NOTIFIED AS SOON AS THE DISCREPANCY IS DISCOVERED PRIOR TO PROCEEDING
- WITH THE WORK. REFERENCE MECHANICAL AND ELECTRICAL DRAWINGS FOR MOUNTING LOCATIONS OF ITEMS WHERE NO CEILING IS REQUIRED OR INDICATED.
- COORDINATE ALL TRADES INVOLVED IN THE CEILING WORK TO ENSURE CLEARANCE FOR FIXTURES, DUCTS, PIPING, CEILING SUSPENSION SYSTEMS, ETC. NECESSARY TO MAINTAIN CEILING HEIGHTS NOTED.
- LIGHTS, DIFFUSERS, EXIT SIGNS, SMOKE DETECTORS, SPEAKERS, STROBES, AND MISC. DEVICES SHALL BE CENTERED IN THE CEILING WHERE THEY OCCUR, U.N.O. FIRE PROTECTION SCOPE SHALL BE DESIGN-BUILD. ALL
- CORRIDOR SPRINKLER HEADS SHALL BE ALIGNED IN THE SAME LOCATION PARALLEL TO THE WALL WITHIN EACH SPECIFIC CEILING CONSTRUCTION. SMOKE ALARMS SHALL BE PROVIDED IN ALL BEDROOMS,
- OUTSIDE OF ALL BEDROOMS, AND ON EACH FLOOR AS REQUIRED. CARBON MONOXIDE DETECTORS SHALL BE INSTALLED OUTSIDE OF ALL BEDROOMS. SMOKE ALARMS AND CO DETECTORS SHALL BE HARDWIRED AND HAVE BATTERY BACKUP.
- ACCESS DOOR LOCATIONS IN GYPSUM BOARD CEILINGS ARE INDICATED ON RCP'S ONLY WHERE ARCHITECTURALLY SIGNIFICANT. REFERENCE SPECIFICATIONS AND MEP DRAWINGS FOR OTHER
- ACCESS DOOR LOCATIONS. UNLESS PREFINISHED TO MATCH ADJACENT SURFACE, PAINT MECHANICAL GRILLS, DIFFUSERS, ACCESS PANELS, AND OTHER EQUIPMENT TO MATCH ADJACENT SURFACE.
- 10. EXIT SIGNS ARE SHOWN ON RCP'S ONLY WHERE LOCATIONS ARE ARCHITECTURALLY SIGNIFICANT.
- 11. PROVIDE UL-CLASSIFIED LIGHT FIXTURES OR ENCLOSURES IN RATED FLOOR/CEILING ASSEMBLIES IN ACCORDANCE WITH IBC CHAPTER 7. 12. REFER TO LIGHTING PLANS FOR EXACT FIXTURE TYPES
- AND LOCATIONS. FIXTURES SHOWN HERE ARE REFERENCED AND SHOWN FOR GENERAL ALIGNMENT.

	The Amble	Steamboat Springs, CO	
	The /	Steamboat	
REVISIONS		ption	Date
No. 1 2 3	Descri IFC SET RFI #110 RFI #125	ption	Date 03.15.24 06.14.24 06.24.24
No.	Descri	ption	03.15.24 06.14.24
No. 1 2 3 4 5 6	Descri IFC SET RFI #110 RFI #125 ASI 004 RFI #232 RFI #223.1	ption	03.15.24 06.14.24 06.24.24 08.07.24 09.17.24 10.16.24
No. 1 2 3 4 5 6	Descri IFC SET RFI #110 RFI #125 ASI 004 RFI #232 RFI #223.1	ption	03.15.24 06.14.24 06.24.24 08.07.24 09.17.24 10.16.24
No. 1 2 3 4 5 6	Descri IFC SET RFI #110 RFI #125 ASI 004 RFI #232 RFI #223.1	ption	03.15.24 06.14.24 06.24.24 08.07.24 09.17.24 10.16.24
No. 1 2 3 4 5 6	Descri IFC SET RFI #110 RFI #125 ASI 004 RFI #232 RFI #223.1	ption	03.15.24 06.14.24 06.24.24 08.07.24 09.17.24 10.16.24
No. 1 2 3 4 5 6 7	Descri IFC 8ET RFI #110 RFI #125 ASI 004 RFI #232 RFI #232 RFI #367	ption	03.15.24 06.14.24 06.24.24 08.07.24 09.17.24 10.16.24 12.04.24 12.04.24
No. 1 2 3 4 5 6 7	Descri IFC 8ET RFI #10 RFI #125 ASI 004 RFI #232 RFI #232 RFI #232.1 RFI #367		03.15.24 06.14.24 06.02.424 08.07.24 09.17.24 12.04.24 12.04.24
No. 1 2 3 4 5 6 7	Descri IFC 8ET RFI #110 RFI #125 ASI 004 RFI #232 RFI #232 RFI #367		03.15.24 06.14.24 06.24.24 08.07.24 09.17.24 10.16.24 12.04.24 12.04.24
No. 1 2 3 4 5 6 7	Descri IFC SET RFI #125 ASI 004 RFI #125 ASI 004 RFI #232 RFI #232 RFI #232 RFI #232 RFI #232 RFI #232 ASI 004 RFI #232 RFI #232 NUMBER E	MBLE	03.15.24 06.14.24 06.24.24 08.07.24 09.17.24 10.16.24 12.04.24 12.04.24
No. 1 2 3 4 5 6 7	Descri IFC 8ET RFI #10 RFI #125 ASI 004 RFI #232 RFI #232 RFI #232.1 RFI #367	MBLE	03.15.24 06.14.24 06.24.24 08.07.24 09.17.24 10.16.24 12.04.24 12.04.24
No. 1 2 3 4 5 6 7	Descri IFC SET RFI #125 ASI 004 RFI #125 ASI 004 RFI #232 RFI #232 RFI #232 RFI #232 RFI #232 RFI #232 ASI 004 RFI #232 RFI #232 NUMBER E THE AI IFC \$	MBLE	03.15.24 06.14.24 06.24.24 08.07.24 09.17.24 10.16.24 12.04.24 12.04.24

TOWN STAMP

359


DESIGN

3630 OSAGE STREET DENVER, CO 80211 720.512.3437


B-2465


12/15/2023


SED ARCT

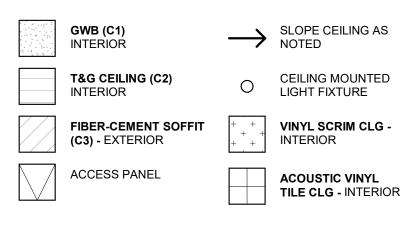


REQ. AT TOILET BLE	

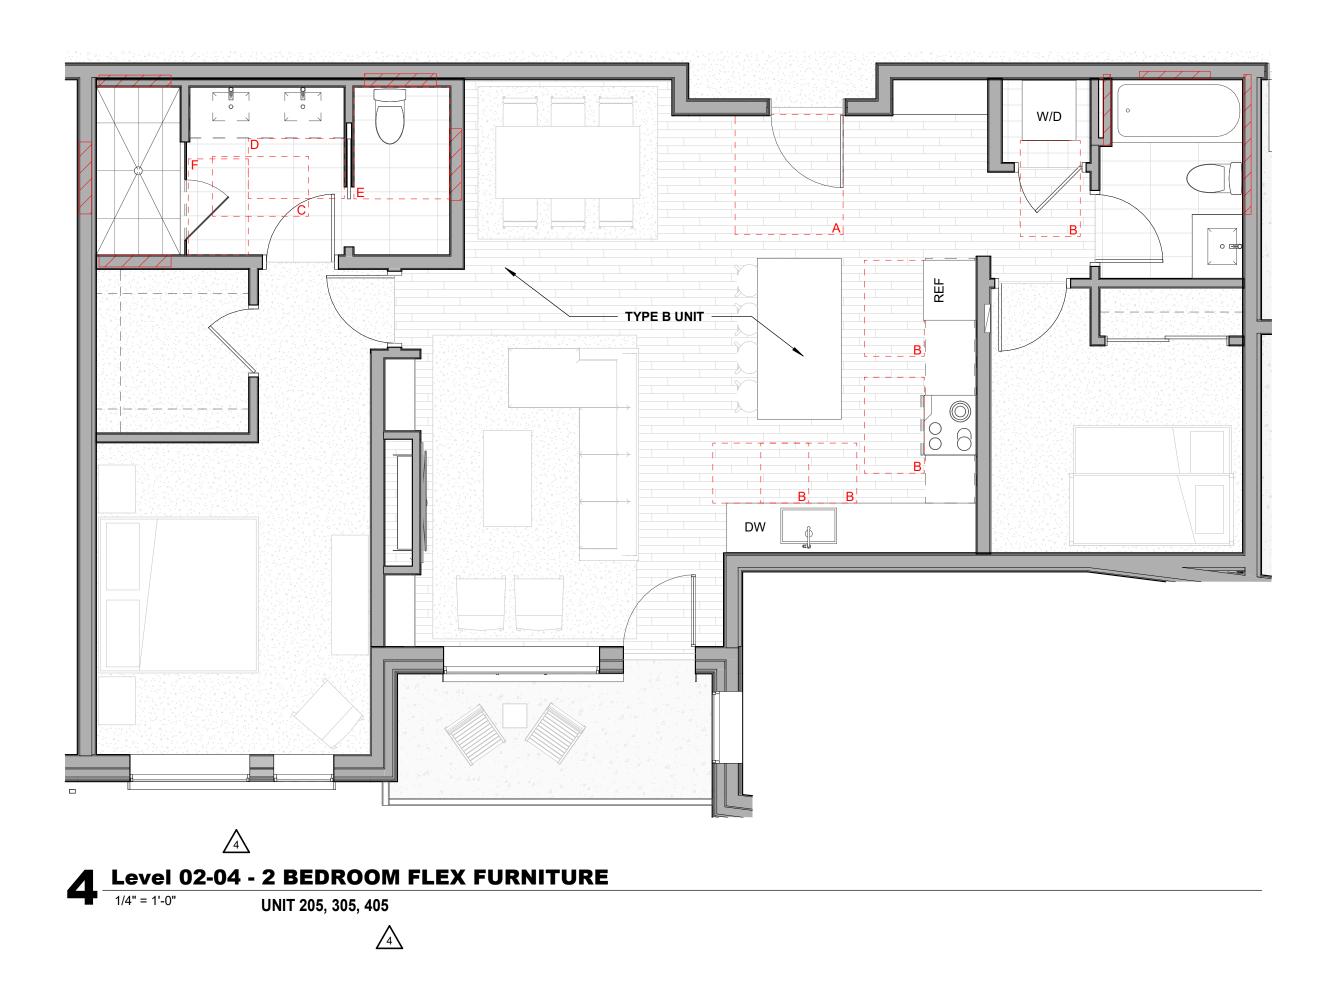

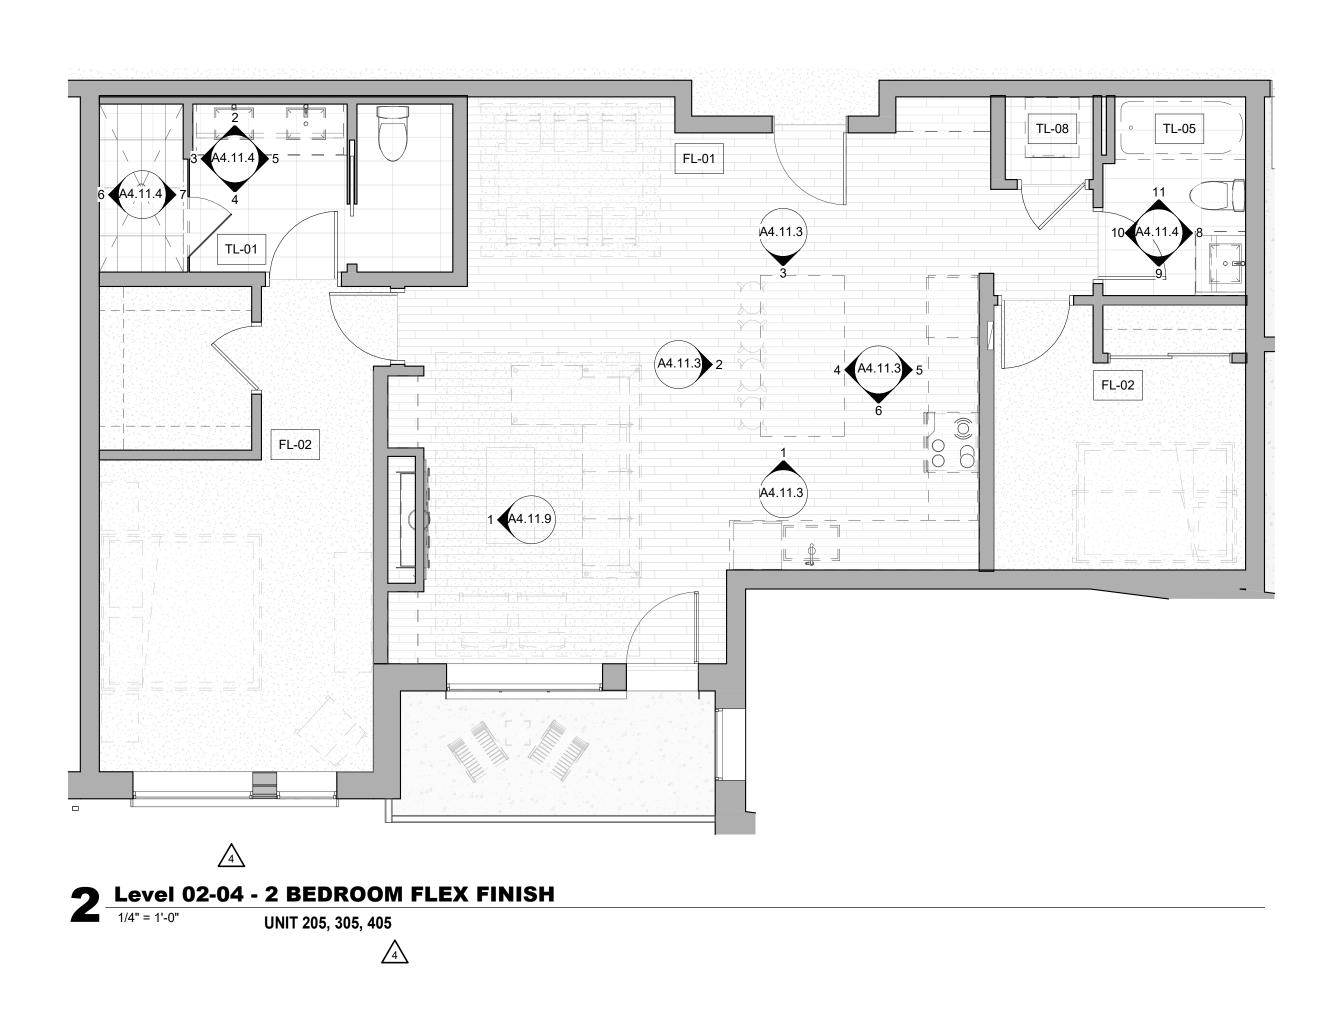

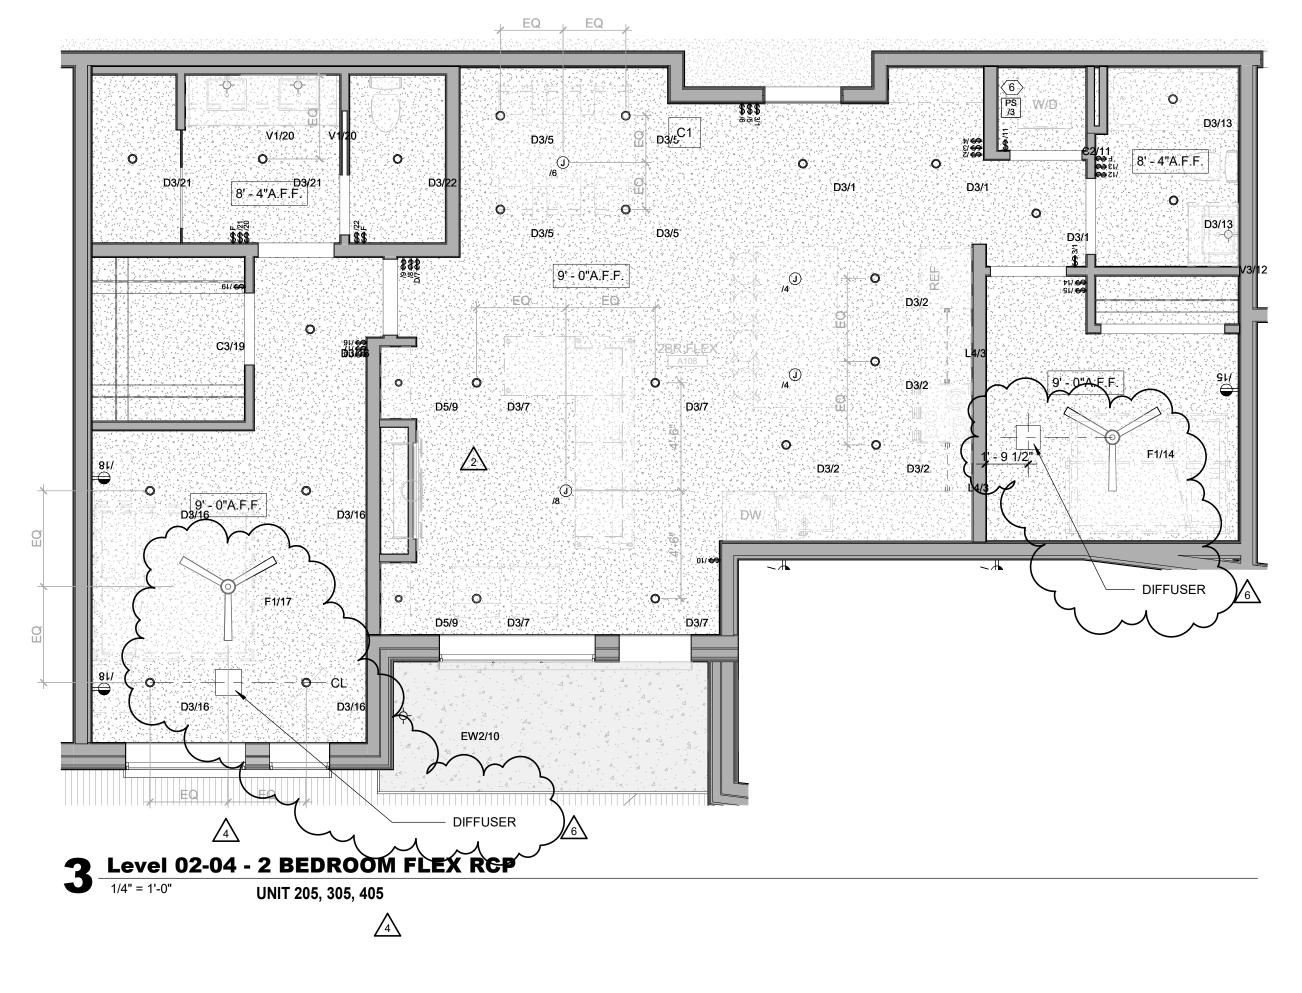

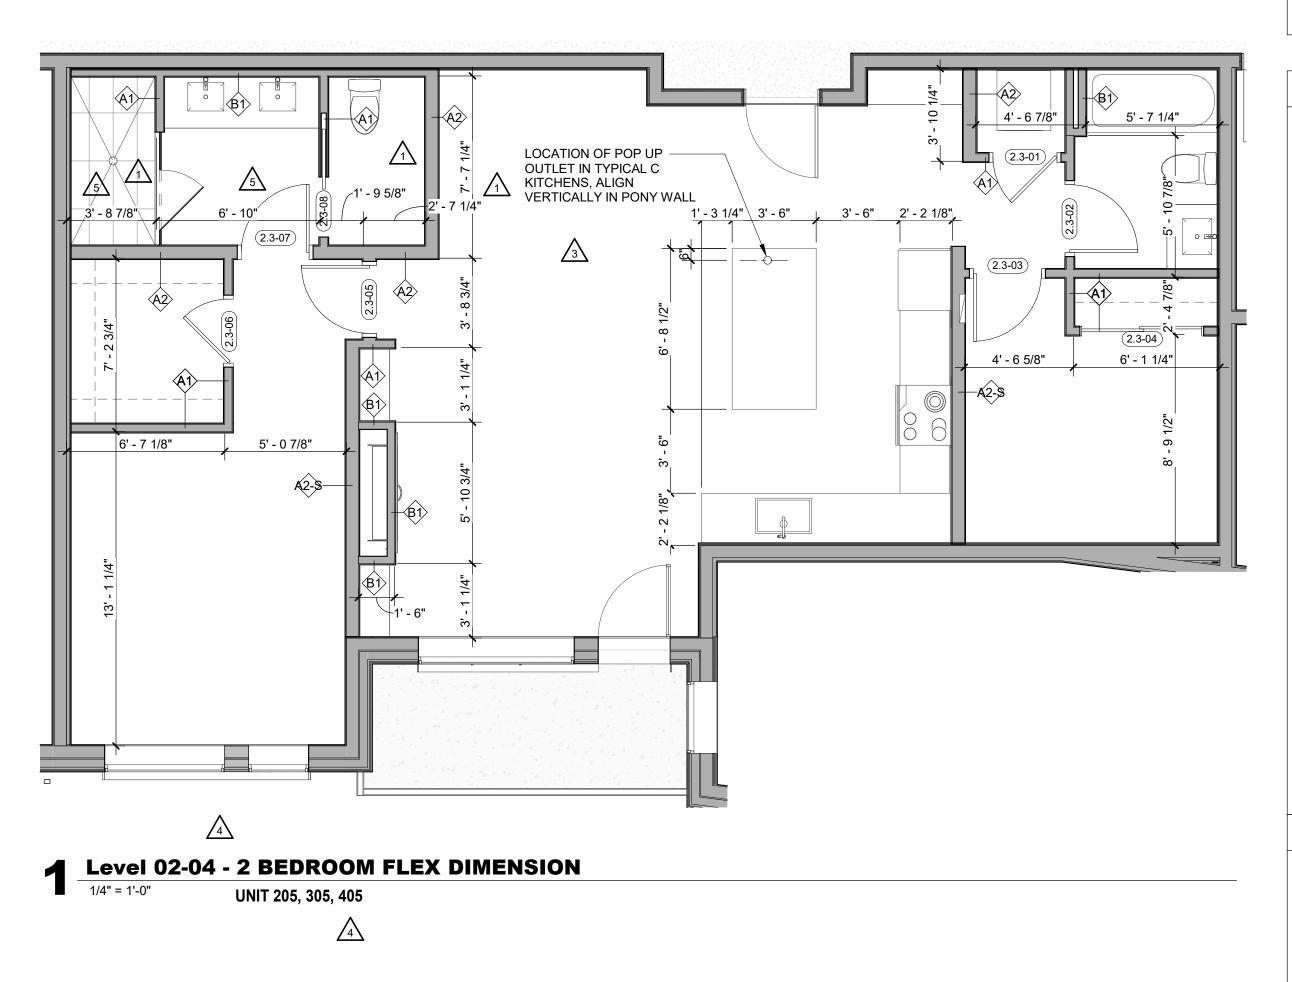

- REFER TO G0.2X SHEETS FOR EXTERIOR AND INTERIOR
- BUILDING ENCLOSURE ASSEMBLIES. REFER TO A1.0X SHEETS FOR EXTERIOR WALL, DEMISING
- WALL, AND CORRIDOR WALL TYPES AND LOCATIONS.
 REFER TO A1.1X SHEETS FOR INTERIOR AND EXTERIOR WINDOW/DOOR TAGS WITH UNIT BACKGROUNDS FOR REFERENCE.
- ALIGN WALLS WHERE THEY APPEAR TO ALIGN, U.N.O.
 THE INSIDE FACE OF DOOR JAMBS SHALL BE 4" FROM
- ADJACENT WALL OR FINISHED COLUMN, U.N.O.
- 6. PROVIDE BLOCKING FOR ALL WALL MOUNTED EQUIPMENT AND ACCESSORIES.
- 7. THE CENTERLINE OF ALL RESIDENTIAL TOILETS SHALL BE LOCATED 18" OFF OF FINISH FACE OF WALL, U.N.O.
- 8. SWING CLEARANCE AT UNIT ENTRY SHALL BE 18" MIN.
- FROM FINISH FACE OF ADJACENT SURFACE. ALL DIMENSIONS ARE TO FACE OF STUD, GRID LINE, OR FACE OF CONCRETE, U.N.O.
- 10. WHERE "CLEAR" IS CALLED OUT ON A DIMENSION, PROVIDE DIMENSION FROM FACE OF FINISH TO FACE OF FINISH
- FURNITURE IS NOT IN CONTRACT, U.N.O., AND IS SHOWN FOR DIAGRAMATIC PURPOSES ONLY.
 CONSULTANT MODELS SHOWN FOR REFERENCE ONLY.

ENLARGED FLOOR PLAN - LEGEND


- RUBBER (F7) RE: CARPET RE: FINISH SCHED. LANDSCAPE CONCRETE (F8) TILE RE: FINISH SCHED. RE: LANDSCAPE PAVERS (F9) WOOD - UNIT RE: FINISH SCHED. RE: LANDSCAPE WOOD - PUBLIC RE: FINISH SCHED. POLISHED CONC. (F5.1) INTERIOR SEALED CONC. (F5.2) INTERIOR HERRINGBONE TILE (F6) RE: FINISH SCHED. ENLARGED FLOOR PLAN - CLEARANCE NOTES FLOOR CLEARANCE L _ _ J
- A DOOR CLEARANCE, 54" X 60"
- B APPLIANCE CLEARANCE, 30" X 48"
- C CLEAR FLOOR CLEARANCE, 30" X 48"
- D VANITY CLEARANCE, 30" X 48"
- E TOILET CLEARANCE, 48" X 56" OR ADA 60" X 56"
- F SHOWER/TUB CLEARANCE, 30" X 48" (B)
- G TURN AROUND CLEARANCE
- GRAB BAR BLOCKING REQ. AT TOILET WALL WHERE APPLICABLE

ENLARGED RCP - GENERAL NOTES

- 1. ALL UNIT CEILINGS SHALL BE 9' 0" A.F.F. U.N.O. REFER TO ENLARGED RCP'S FOR COMMON AREA CEILING HEIGHTS.
- 2. IN THE CASE OF MINOR DISCREPANCIES BETWEEN MEP AND ARCHITECTURAL DOCUMENTS ON THE LOCATION OF CEILING MOUNTED COMPONENTS, THE ARCHITECTURAL RCP'S GOVERN. IN THE CASE OF MAJOR DISCREPANCIES, THE ARCHITECT SHALL BE NOTIFIED AS SOON AS THE DISCREPANCY IS DISCOVERED PRIOR TO PROCEEDING WITH THE WORK.
- 3. REFERENCE MECHANICAL AND ELECTRICAL DRAWINGS FOR MOUNTING LOCATIONS OF ITEMS WHERE NO CEILING IS REQUIRED OR INDICATED.
- 4. COORDINATE ALL TRADES INVOLVED IN THE CEILING WORK TO ENSURE CLEARANCE FOR FIXTURES, DUCTS, PIPING, CEILING SUSPENSION SYSTEMS, ETC. NECESSARY TO MAINTAIN CEILING HEIGHTS NOTED.
- LIGHTS, DIFFUSERS, EXIT SIGNS, SMOKE DETECTORS, SPEAKERS, STROBES, AND MISC. DEVICES SHALL BE CENTERED IN THE CEILING WHERE THEY OCCUR, U.N.O.
 FIRE PROTECTION SCOPE SHALL BE DESIGN-BUILD. ALL
- CORRIDOR SPRINKLER HEADS SHALL BE ALIGNED IN THE SAME LOCATION PARALLEL TO THE WALL WITHIN EACH SPECIFIC CEILING CONSTRUCTION.
 7. SMOKE ALARMS SHALL BE PROVIDED IN ALL BEDROOMS,
- OUTSIDE OF ALL BEDROOMS, AND ON EACH FLOOR AS REQUIRED. CARBON MONOXIDE DETECTORS SHALL BE INSTALLED OUTSIDE OF ALL BEDROOMS. SMOKE ALARMS AND CO DETECTORS SHALL BE HARDWIRED AND HAVE BATTERY BACKUP.
- 8. ACCESS DOOR LOCATIONS IN GYPSUM BOARD CEILINGS ARE INDICATED ON RCP'S ONLY WHERE ARCHITECTURALLY SIGNIFICANT. REFERENCE SPECIFICATIONS AND MEP DRAWINGS FOR OTHER ACCESS DOOR LOCATIONS.
- 9. UNLESS PREFINISHED TO MATCH ADJACENT SURFACE, PAINT MECHANICAL GRILLS, DIFFUSERS, ACCESS PANELS, AND OTHER EQUIPMENT TO MATCH ADJACENT SURFACE.
- 10. EXIT SIGNS ARE SHOWN ON RCP'S ONLY WHERE LOCATIONS ARE ARCHITECTURALLY SIGNIFICANT.
 11. PROVIDE UL-CLASSIFIED LIGHT FIXTURES OR ENCLOSURES IN RATED FLOOR/CEILING ASSEMBLIES IN
- ACCORDANCE WITH IBC CHAPTER 7. 12. REFER TO LIGHTING PLANS FOR EXACT FIXTURE TYPES AND LOCATIONS. FIXTURES SHOWN HERE ARE
- REFERENCED AND SHOWN FOR GENERAL ALIGNMENT.


GWB (C1) INTERIOR	\rightarrow	SLOPE CEILING AS NOTED
T&G CEILING (C2) INTERIOR	0	CEILING MOUNTED LIGHT FIXTURE
FIBER-CEMENT SOFFIT (C3) - EXTERIOR	+ + + + + +	VINYL SCRIM CLG - INTERIOR
ACCESS PANEL		ACCOUSTIC VINYL TILE CLG - INTERIOR
	INTERÌOR T&G CEILING (C2) INTERIOR FIBER-CEMENT SOFFIT (C3) - EXTERIOR	INTERIOR T&G CEILING (C2) INTERIOR FIBER-CEMENT SOFFIT (C3) - EXTERIOR + + + + + +

BRSCED. WINS B-2465 12/15/2023
The Amble Steamboat Springs, CO
REVISIONS No. Description Date 1 IFC SET 03.15.24 2 RFI #110 06.14.24 3 RFI #232 09.17.24 6 RFI #232 09.17.24 6 RFI #232.1 10.16.24 0 10.15.24 10.15.24 1 0.15.24 10.15.24 2 RFI #232.1 10.16.24 1 0.15.24 10.15.24 1 0.15.24 10.15.24 1 0.15.24 10.15.24 1 0.15.24 10.15.24 1 0.15.24 10.15.24 1 0.15.24 10.15.24 1 0.15.24 10.15.24 1 0.15.24 10.15.24 1 0.15.24 10.15.24 1 0.15.24 10.15.24 1 0.15.24 10.15.24 1 0.115/2024 11.11/21
IFC SET IFC SET UNIT PLAN - 2 BEDROOM FLEX - LEVEL 02-04

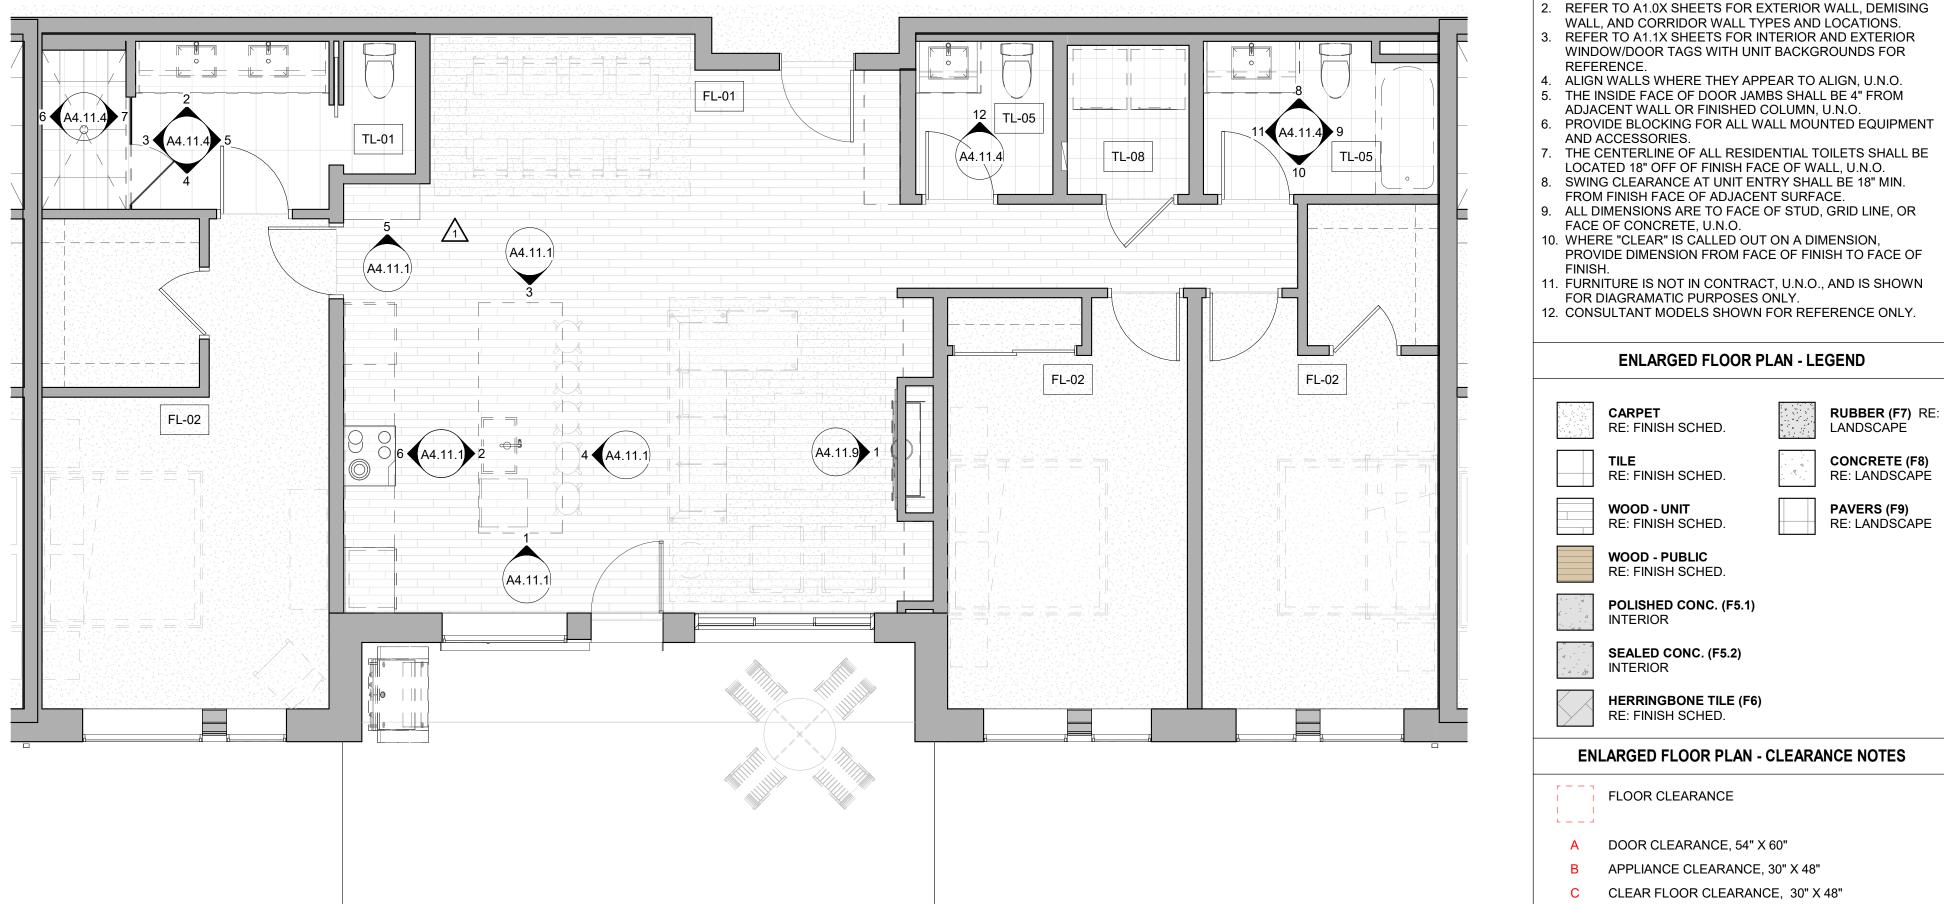

1 Level 01 - 3 BED FLEX FINISH 1/4" = 1'-0" **UNIT 108**

 $\sqrt{3}$

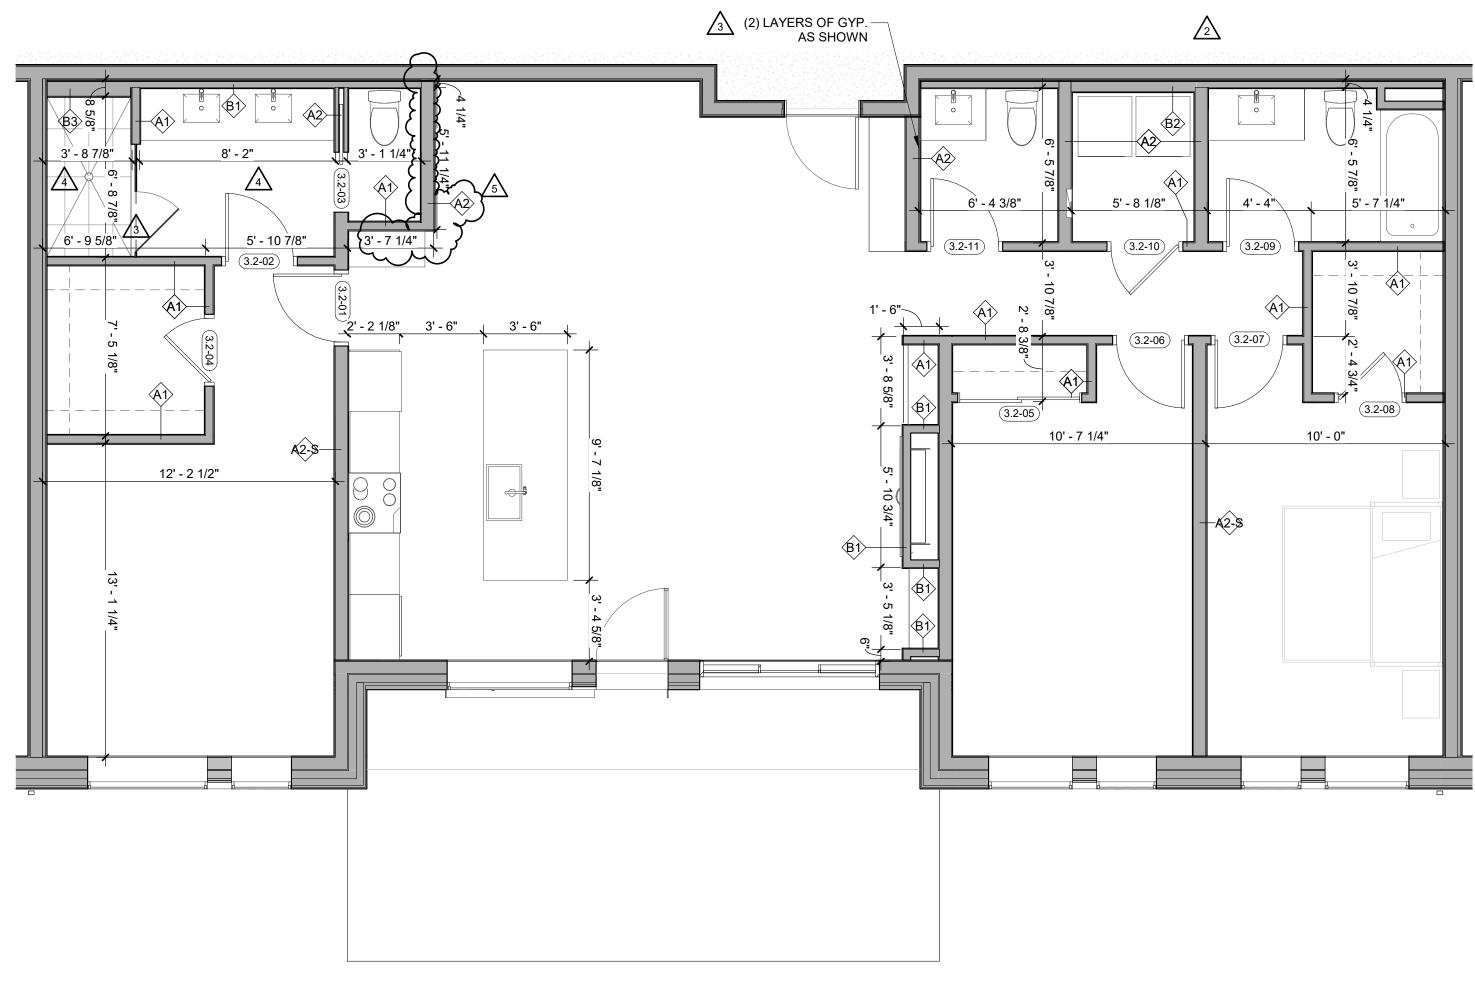

Level 01 - 3 BED FLEX DIMENSION 1/4" = 1'-0" **UNIT 108**

- REFER TO G0.2X SHEETS FOR EXTERIOR AND INTERIOR BUILDING ENCLOSURE ASSEMBLIES.

- D VANITY CLEARANCE, 30" X 48"
- E TOILET CLEARANCE, 48" X 56" OR ADA 60" X 56"
- F SHOWER/TUB CLEARANCE, 30" X 48" (B)
- G TURN AROUND CLEARANCE
- GRAB BAR BLOCKING REQ. AT TOILET WALL WHERE APPLICABLE

ENLARGED RCP - GENERAL NOTES

- ALL UNIT CEILINGS SHALL BE 9' 0" A.F.F. U.N.O. REFER TO ENLARGED RCP'S FOR COMMON AREA CEILING HEIGHTS.
- IN THE CASE OF MINOR DISCREPANCIES BETWEEN MEP AND ARCHITECTURAL DOCUMENTS ON THE LOCATION OF CEILING MOUNTED COMPONENTS, THE ARCHITECTURAL RCP'S GOVERN. IN THE CASE OF MAJOR DISCREPANCIES, THE ARCHITECT SHALL BE NOTIFIED AS SOON AS THE DISCREPANCY IS DISCOVERED PRIOR TO PROCEEDING WITH THE WORK.
- REFERENCE MECHANICAL AND ELECTRICAL DRAWINGS FOR MOUNTING LOCATIONS OF ITEMS WHERE NO CEILING IS REQUIRED OR INDICATED.
- COORDINATE ALL TRADES INVOLVED IN THE CEILING WORK TO ENSURE CLEARANCE FOR FIXTURES, DUCTS, PIPING, CEILING SUSPENSION SYSTEMS, ETC. NECESSARY TO MAINTAIN CEILING HEIGHTS NOTED.
- LIGHTS, DIFFUSERS, EXIT SIGNS, SMOKE DETECTORS, SPEAKERS, STROBES, AND MISC. DEVICES SHALL BE CENTERED IN THE CEILING WHERE THEY OCCUR, U.N.O. FIRE PROTECTION SCOPE SHALL BE DESIGN-BUILD. ALL
- CORRIDOR SPRINKLER HEADS SHALL BE ALIGNED IN THE SAME LOCATION PARALLEL TO THE WALL WITHIN EACH SPECIFIC CEILING CONSTRUCTION.
- SMOKE ALARMS SHALL BE PROVIDED IN ALL BEDROOMS, OUTSIDE OF ALL BEDROOMS, AND ON EACH FLOOR AS REQUIRED. CARBON MONOXIDE DETECTORS SHALL BE INSTALLED OUTSIDE OF ALL BEDROOMS. SMOKE ALARMS AND CO DETECTORS SHALL BE HARDWIRED AND HAVE BATTERY BACKUP.
- ACCESS DOOR LOCATIONS IN GYPSUM BOARD CEILINGS ARE INDICATED ON RCP'S ONLY WHERE ARCHITECTURALLY SIGNIFICANT. REFERENCE SPECIFICATIONS AND MEP DRAWINGS FOR OTHER ACCESS DOOR LOCATIONS.
- UNLESS PREFINISHED TO MATCH ADJACENT SURFACE, PAINT MECHANICAL GRILLS, DIFFUSERS, ACCESS PANELS, AND OTHER EQUIPMENT TO MATCH ADJACENT SURFACE. 10. EXIT SIGNS ARE SHOWN ON RCP'S ONLY WHERE
- LOCATIONS ARE ARCHITECTURALLY SIGNIFICANT. 1. PROVIDE UL-CLASSIFIED LIGHT FIXTURES OR ENCLOSURES IN RATED FLOOR/CEILING ASSEMBLIES IN
- ACCORDANCE WITH IBC CHAPTER 7. 12. REFER TO LIGHTING PLANS FOR EXACT FIXTURE TYPES AND LOCATIONS. FIXTURES SHOWN HERE ARE
- REFERENCED AND SHOWN FOR GENERAL ALIGNMENT.

ENLARGED RCP - LEGEND $\longrightarrow \underset{\mathsf{NOTED}}{\mathsf{SLOPE CEILING AS}}$ GWB (C1) INTERIOR T&G CEILING (C2) CEILING MOUNTED 0 LIGHT FIXTURE INTERIOR

VINYL SCRIM CLG -


INTERIOR

ACCESS PANEL


(C3) - EXTERIOR

FIBER-CEMENT SOFFIT

35 D E S	stamp	
BASE BASE 12/15	15.10	
The Amble	Steamboat Springs, CO	
No. Descr 1 IFC SET 2 RFI #125 3 ASI 004 4 RFI #232 5 RFI #214.1	iption Date 03.15.24 06.24.24 08.07.24 09.17.24 09.18.24	
ISSUE IFC SHEET TITLE UNIT P BEDROOM F	20019 03/15/2024 AMBLE SET SET	

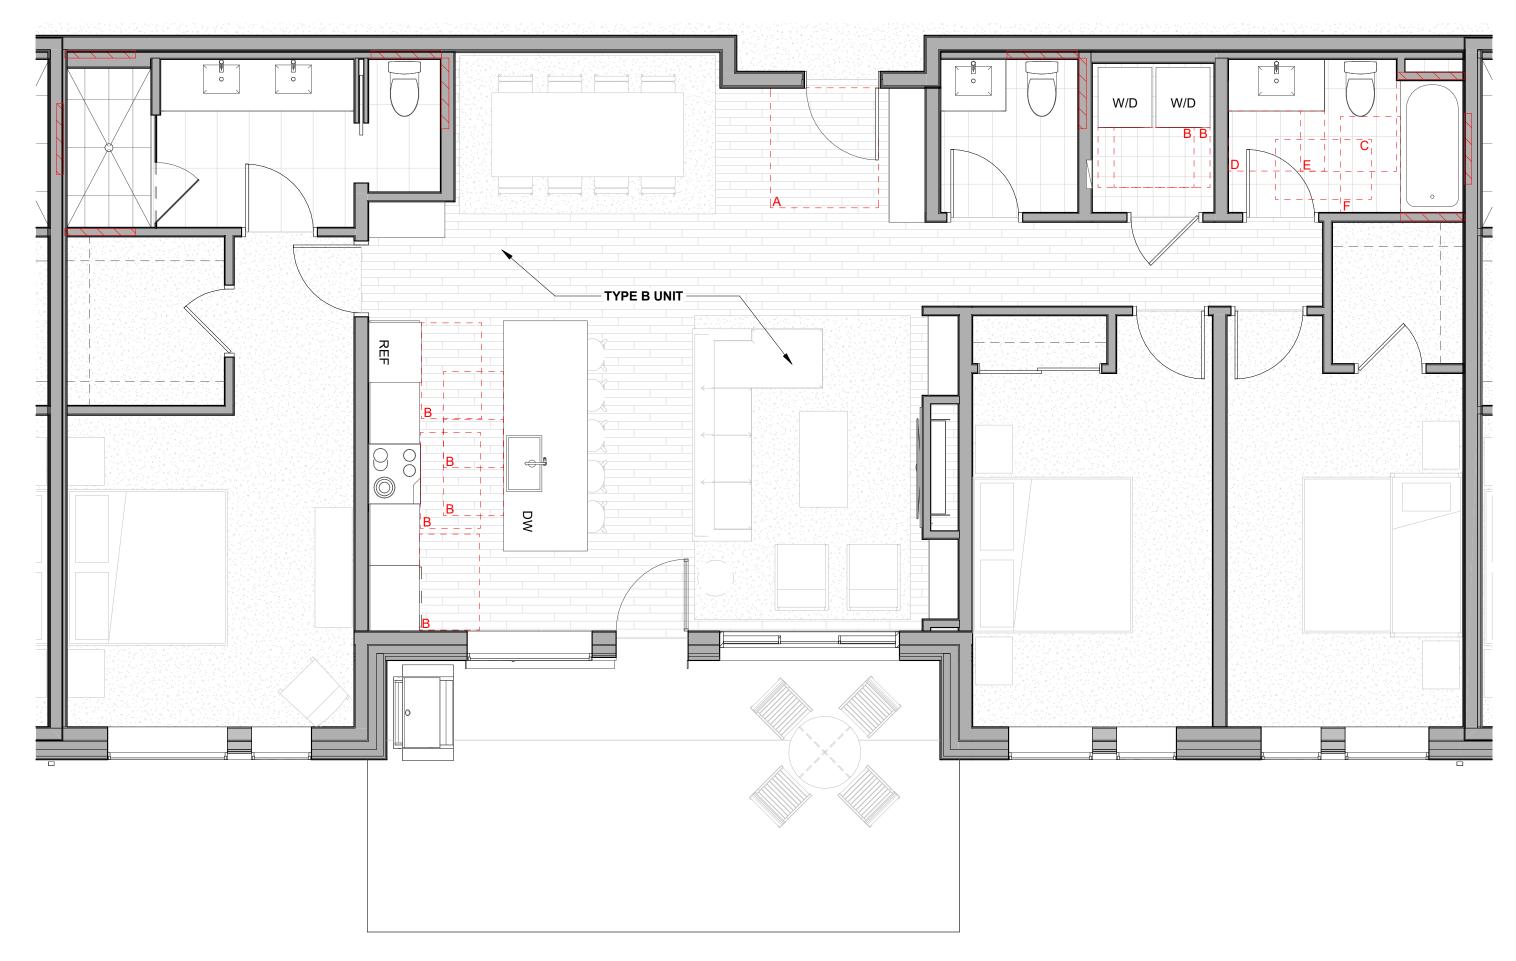




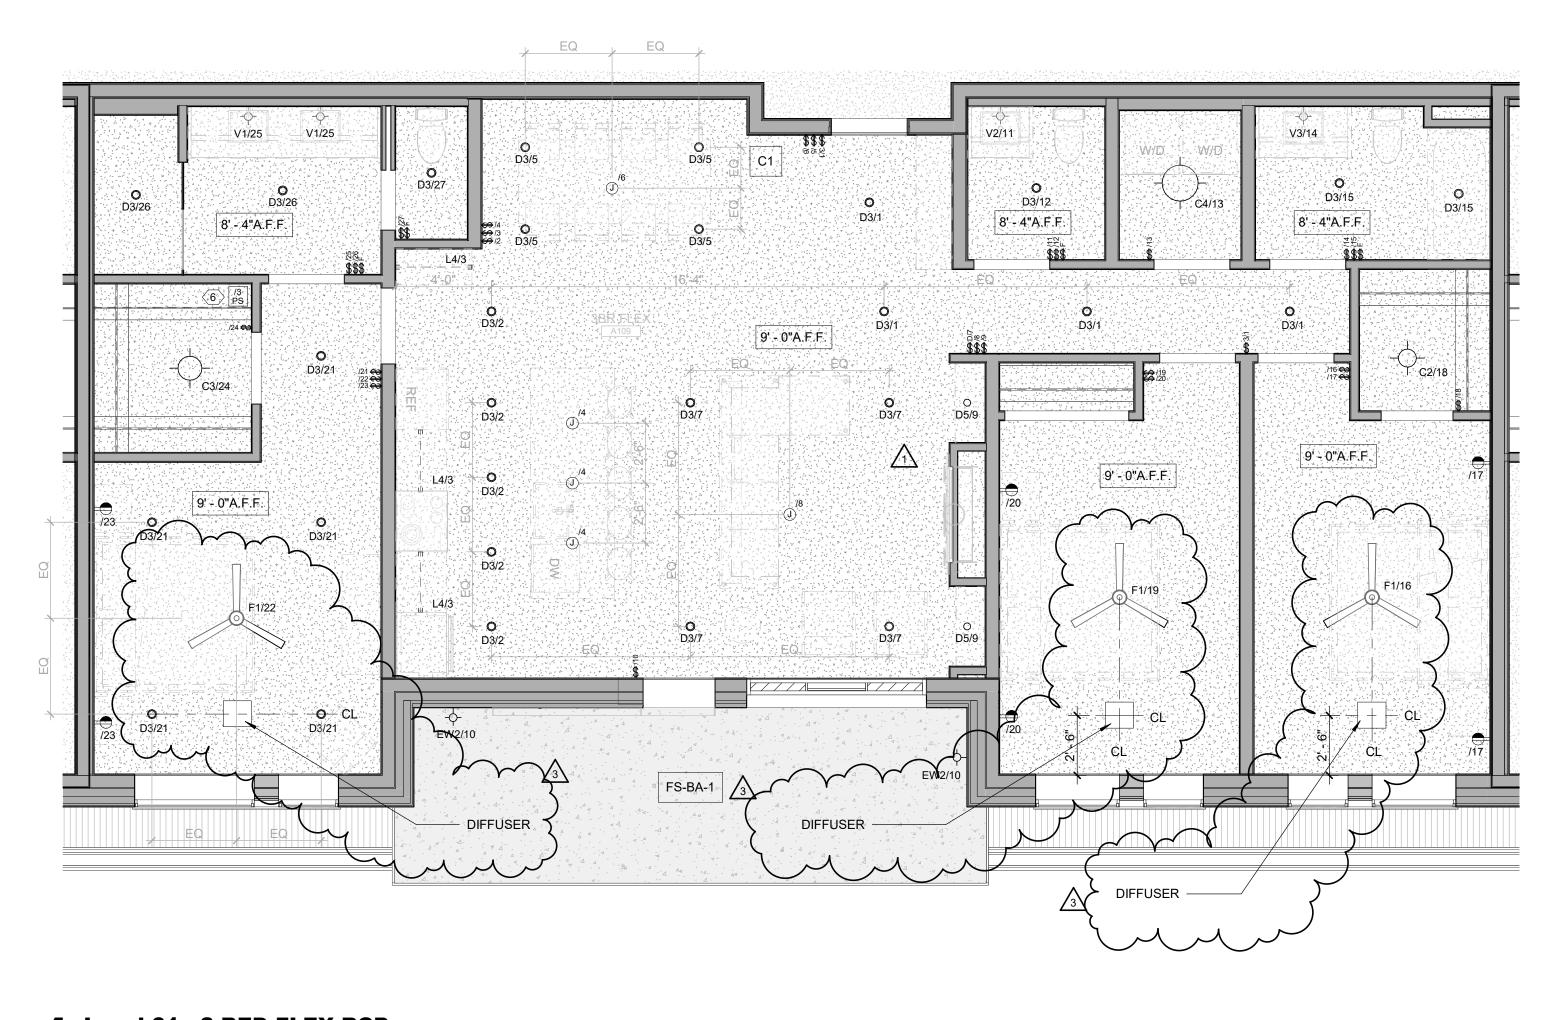

- REFER TO G0.2X SHEETS FOR EXTERIOR AND INTERIOR BUILDING ENCLOSURE ASSEMBLIES.
- REFER TO A1.0X SHEETS FOR EXTERIOR WALL, DEMISING WALL, AND CORRIDOR WALL TYPES AND LOCATIONS. REFER TO A1.1X SHEETS FOR INTERIOR AND EXTERIOR WINDOW/DOOR TAGS WITH UNIT BACKGROUNDS FOR
- REFERENCE. ALIGN WALLS WHERE THEY APPEAR TO ALIGN, U.N.O.
- THE INSIDE FACE OF DOOR JAMBS SHALL BE 4" FROM ADJACENT WALL OR FINISHED COLUMN, U.N.O.
- PROVIDE BLOCKING FOR ALL WALL MOUNTED EQUIPMENT
- AND ACCESSORIES. THE CENTERLINE OF ALL RESIDENTIAL TOILETS SHALL BE
- LOCATED 18" OFF OF FINISH FACE OF WALL, U.N.O. SWING CLEARANCE AT UNIT ENTRY SHALL BE 18" MIN.
- FROM FINISH FACE OF ADJACENT SURFACE. ALL DIMENSIONS ARE TO FACE OF STUD, GRID LINE, OR
- FACE OF CONCRETE, U.N.O. 10. WHERE "CLEAR" IS CALLED OUT ON A DIMENSION, PROVIDE DIMENSION FROM FACE OF FINISH TO FACE OF
- FINISH. 11. FURNITURE IS NOT IN CONTRACT, U.N.O., AND IS SHOWN FOR DIAGRAMATIC PURPOSES ONLY.
- 12. CONSULTANT MODELS SHOWN FOR REFERENCE ONLY.

ENLARGED FLOOR PLAN - LEGEND

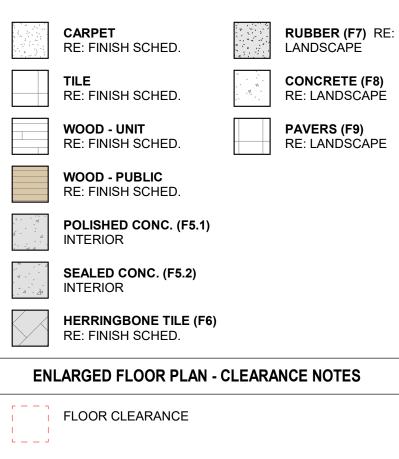

- A DOOR CLEARANCE, 54" X 60"
- B APPLIANCE CLEARANCE, 30" X 48"
- C CLEAR FLOOR CLEARANCE, 30" X 48"
- D VANITY CLEARANCE, 30" X 48"
- E TOILET CLEARANCE, 48" X 56" OR ADA 60" X 56"
- F SHOWER/TUB CLEARANCE, 30" X 48" (B)
- G TURN AROUND CLEARANCE
- GRAB BAR BLOCKING REQ. AT TOILET WALL WHERE APPLICABLE

ENLARGED RCP - GENERAL NOTES


- ALL UNIT CEILINGS SHALL BE 9' 0" A.F.F. U.N.O. REFER TO ENLARGED RCP'S FOR COMMON AREA CEILING HEIGHTS.
- IN THE CASE OF MINOR DISCREPANCIES BETWEEN MEP AND ARCHITECTURAL DOCUMENTS ON THE LOCATION OF CEILING MOUNTED COMPONENTS, THE ARCHITECTURAL RCP'S GOVERN. IN THE CASE OF MAJOR DISCREPANCIES, THE ARCHITECT SHALL BE NOTIFIED AS SOON AS THE DISCREPANCY IS DISCOVERED PRIOR TO PROCEEDING WITH THE WORK.
- REFERENCE MECHANICAL AND ELECTRICAL DRAWINGS FOR MOUNTING LOCATIONS OF ITEMS WHERE NO CEILING IS REQUIRED OR INDICATED.
- COORDINATE ALL TRADES INVOLVED IN THE CEILING WORK TO ENSURE CLEARANCE FOR FIXTURES, DUCTS, PIPING, CEILING SUSPENSION SYSTEMS, ETC. NECESSARY TO MAINTAIN CEILING HEIGHTS NOTED.
- LIGHTS, DIFFUSERS, EXIT SIGNS, SMOKE DETECTORS, SPEAKERS, STROBES, AND MISC. DEVICES SHALL BE CENTERED IN THE CEILING WHERE THEY OCCUR, U.N.O.
- FIRE PROTECTION SCOPE SHALL BE DESIGN-BUILD. ALL CORRIDOR SPRINKLER HEADS SHALL BE ALIGNED IN THE SAME LOCATION PARALLEL TO THE WALL WITHIN EACH SPECIFIC CEILING CONSTRUCTION.
- SMOKE ALARMS SHALL BE PROVIDED IN ALL BEDROOMS, OUTSIDE OF ALL BEDROOMS, AND ON EACH FLOOR AS REQUIRED. CARBON MONOXIDE DETECTORS SHALL BE INSTALLED OUTSIDE OF ALL BEDROOMS. SMOKE ALARMS AND CO DETECTORS SHALL BE HARDWIRED AND HAVE BATTERY BACKUP.
- ACCESS DOOR LOCATIONS IN GYPSUM BOARD CEILINGS ARE INDICATED ON RCP'S ONLY WHERE ARCHITECTURALLY SIGNIFICANT. REFERENCE SPECIFICATIONS AND MEP DRAWINGS FOR OTHER
- ACCESS DOOR LOCATIONS. UNLESS PREFINISHED TO MATCH ADJACENT SURFACE, PAINT MECHANICAL GRILLS, DIFFUSERS, ACCESS PANELS, AND OTHER EQUIPMENT TO MATCH ADJACENT SURFACE.
- 10. EXIT SIGNS ARE SHOWN ON RCP'S ONLY WHERE LOCATIONS ARE ARCHITECTURALLY SIGNIFICANT. 1. PROVIDE UL-CLASSIFIED LIGHT FIXTURES OR
- ENCLOSURES IN RATED FLOOR/CEILING ASSEMBLIES IN ACCORDANCE WITH IBC CHAPTER 7. 12. REFER TO LIGHTING PLANS FOR EXACT FIXTURE TYPES AND LOCATIONS. FIXTURES SHOWN HERE ARE
- REFERENCED AND SHOWN FOR GENERAL ALIGNMENT.

GWB (C1) INTERIOR	\rightarrow	SLOPE CEILING AS NOTED
T&G CEILING (C2) INTERIOR	0	CEILING MOUNTED LIGHT FIXTURE
FIBER-CEMENT SOFFIT (C3) - EXTERIOR	+ + + + + +	VINYL SCRIM CLG - INTERIOR
ACCESS PANEL		ACCOUSTIC VINYL Tile CLG - Interio
	INTERIOR T&G CEILING (C2) INTERIOR FIBER-CEMENT SOFFIT (C3) - EXTERIOR	INTERIOR T&G CEILING (C2) INTERIOR FIBER-CEMENT SOFFIT (C3) - EXTERIOR (C2) (C

<text><text></text></text>
BRUCE D. MINS B-2465 12/15/2023
The Amble Steamboat Springs, CO
REVISIONS No. Description Date 1 06.14.24 06.07.24 2 ASI 004 06.07.24 3 RFI #223.1 10.16.24 4 06.07.24 10.16.24 4 01.016.24 04.012 10 01.16.24 04.012 10 01.16.24 04.012 10 01.16.24 04.012 10 01.16.24 04.012 10 01.16.24 04.012 10 01.16.24 04.012 10 01.16.24 04.012 10 01.16.24 04.012 10 01.16.24 04.014 10 01.016.24 04.014 10 01.016.24 04.014 10 01.016.24 04.014 10 01.016.24 04.014 10 01.016.24 04.014 10 01.016.24 04.014 10 01.016.24 04.014 10 01.016.24 04.014 10 01.016.24 04.0
SHEET TITLE UNIT PLAN - 3 BEDROOM FLEX - LEVEL 01 SHEET NO.






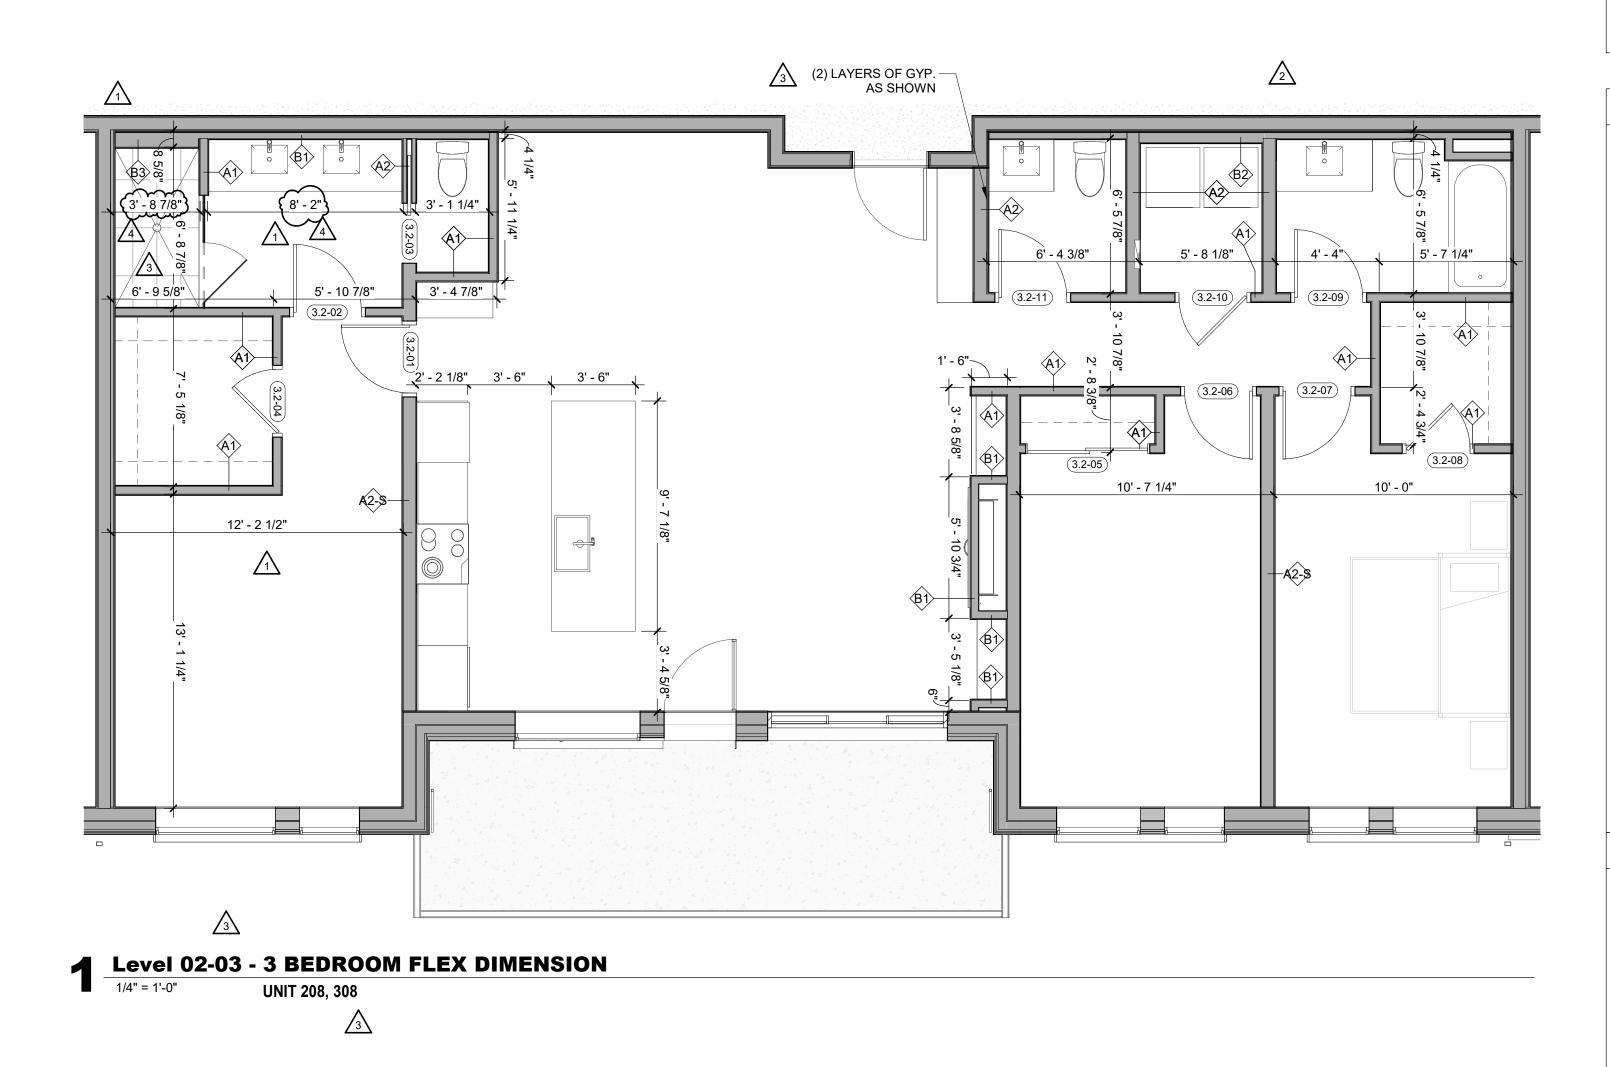

- . REFER TO G0.2X SHEETS FOR EXTERIOR AND INTERIOR BUILDING ENCLOSURE ASSEMBLIES.
- REFER TO A1.0X SHEETS FOR EXTERIOR WALL, DEMISING WALL, AND CORRIDOR WALL TYPES AND LOCATIONS.
 REFER TO A1.1X SHEETS FOR INTERIOR AND EXTERIOR
- WINDOW/DOOR TAGS WITH UNIT BACKGROUNDS FOR REFERENCE. 4. ALIGN WALLS WHERE THEY APPEAR TO ALIGN, U.N.O.
- 5. THE INSIDE FACE OF DOOR JAMBS SHALL BE 4" FROM ADJACENT WALL OR FINISHED COLUMN, U.N.O.
- 6. PROVIDE BLOCKING FOR ALL WALL MOUNTED EQUIPMENT
- AND ACCESSORIES. 7. THE CENTERLINE OF ALL RESIDENTIAL TOILETS SHALL BE
- LOCATED 18" OFF OF FINISH FACE OF WALL, U.N.O. 3. SWING CLEARANCE AT UNIT ENTRY SHALL BE 18" MIN.
- FROM FINISH FACE OF ADJACENT SURFACE. ALL DIMENSIONS ARE TO FACE OF STUD, GRID LINE, OR
- FACE OF CONCRETE, U.N.O.10. WHERE "CLEAR" IS CALLED OUT ON A DIMENSION, PROVIDE DIMENSION FROM FACE OF FINISH TO FACE OF
- FINISH. 11. FURNITURE IS NOT IN CONTRACT, U.N.O., AND IS SHOWN
- FOR DIAGRAMATIC PURPOSES ONLY. 12. CONSULTANT MODELS SHOWN FOR REFERENCE ONLY.

ENLARGED FLOOR PLAN - LEGEND

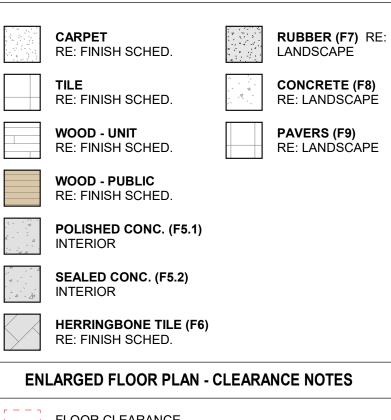

FLOOR CLEARANCE

A DOOR CLEARANCE, 54" X 60"


- B APPLIANCE CLEARANCE, 30" X 48"
- C CLEAR FLOOR CLEARANCE, 30" X 48"
- D VANITY CLEARANCE, 30" X 48"
- E TOILET CLEARANCE, 48" X 56" OR ADA 60" X 56"
- F SHOWER/TUB CLEARANCE, 30" X 48" (B)
- G TURN AROUND CLEARANCE
- GRAB BAR BLOCKING REQ. AT TOILET WALL WHERE APPLICABLE

ENLARGED RCP - GENERAL NOTES


- 1. ALL UNIT CEILINGS SHALL BE 9' 0" A.F.F. U.N.O. REFER TO ENLARGED RCP'S FOR COMMON AREA CEILING HEIGHTS.
- 2. IN THE CASE OF MINOR DISCREPANCIES BETWEEN MEP AND ARCHITECTURAL DOCUMENTS ON THE LOCATION OF CEILING MOUNTED COMPONENTS, THE ARCHITECTURAL RCP'S GOVERN. IN THE CASE OF MAJOR DISCREPANCIES, THE ARCHITECT SHALL BE NOTIFIED AS SOON AS THE DISCREPANCY IS DISCOVERED PRIOR TO PROCEEDING WITH THE WORK.
- 3. REFERENCE MECHANICAL AND ELECTRICAL DRAWINGS FOR MOUNTING LOCATIONS OF ITEMS WHERE NO CEILING IS REQUIRED OR INDICATED.
- 4. COORDINATE ALL TRADES INVOLVED IN THE CEILING WORK TO ENSURE CLEARANCE FOR FIXTURES, DUCTS, PIPING, CEILING SUSPENSION SYSTEMS, ETC. NECESSARY TO MAINTAIN CEILING HEIGHTS NOTED.
- LIGHTS, DIFFUSERS, EXIT SIGNS, SMOKE DETECTORS, SPEAKERS, STROBES, AND MISC. DEVICES SHALL BE CENTERED IN THE CEILING WHERE THEY OCCUR, U.N.O.
 FIRE PROTECTION SCOPE SHALL BE DESIGN-BUILD. ALL
- CORRIDOR SPRINKLER HEADS SHALL BE ALIGNED IN THE SAME LOCATION PARALLEL TO THE WALL WITHIN EACH SPECIFIC CEILING CONSTRUCTION.
- 7. SMOKE ALARMS SHALL BE PROVIDED IN ALL BEDROOMS, OUTSIDE OF ALL BEDROOMS, AND ON EACH FLOOR AS REQUIRED. CARBON MONOXIDE DETECTORS SHALL BE INSTALLED OUTSIDE OF ALL BEDROOMS. SMOKE ALARMS AND CO DETECTORS SHALL BE HARDWIRED AND HAVE BATTERY BACKUP.
- 8. ACCESS DOOR LOCATIONS IN GYPSUM BOARD CEILINGS ARE INDICATED ON RCP'S ONLY WHERE ARCHITECTURALLY SIGNIFICANT. REFERENCE SPECIFICATIONS AND MEP DRAWINGS FOR OTHER ACCESS DOOR LOCATIONS.
- UNLESS PREFINISHED TO MATCH ADJACENT SURFACE, PAINT MECHANICAL GRILLS, DIFFUSERS, ACCESS PANELS, AND OTHER EQUIPMENT TO MATCH ADJACENT SURFACE.
 EXIT SIGNS ARE SHOWN ON RCP'S ONLY WHERE
- LOCATIONS ARE ARCHITECTURALLY SIGNIFICANT. 1. PROVIDE UL-CLASSIFIED LIGHT FIXTURES OR ENCLOSURES IN RATED FLOOR/CEILING ASSEMBLIES IN
- ACCORDANCE WITH IBC CHAPTER 7. 12. REFER TO LIGHTING PLANS FOR EXACT FIXTURE TYPES AND LOCATIONS. FIXTURES SHOWN HERE ARE REFERENCED AND SHOWN FOR GENERAL ALIGNMENT.

GWB (C1) INTERIOR	\rightarrow	SLOPE CEILING AS NOTED
T&G CEILING (C2) INTERIOR	0	CEILING MOUNTED LIGHT FIXTURE
FIBER-CEMENT SOFFIT (C3) - EXTERIOR	+ + + + + + + + + + + + + + + + + + + +	VINYL SCRIM CLG - INTERIOR
ACCESS PANEL		

<text><text></text></text>
BRUCE D. MINS B-2465 12/15/2023
The Amble Steamboat Springs, CO
No. Description Date 1 IFC SET 03.15.24 2 RFI #125 06.24.24 3 ASI 004 08.07.24 4 RFI #232 09.17.24 - - - - - - - - - - - -
PROJECT NUMBER 2019 ISSUE DATE 03/15/2024 THE AMBLE
SHEET TITLE UNIT PLAN - 3 BEDROOM FLEX - LEVELS 02-03 SHEET NO.

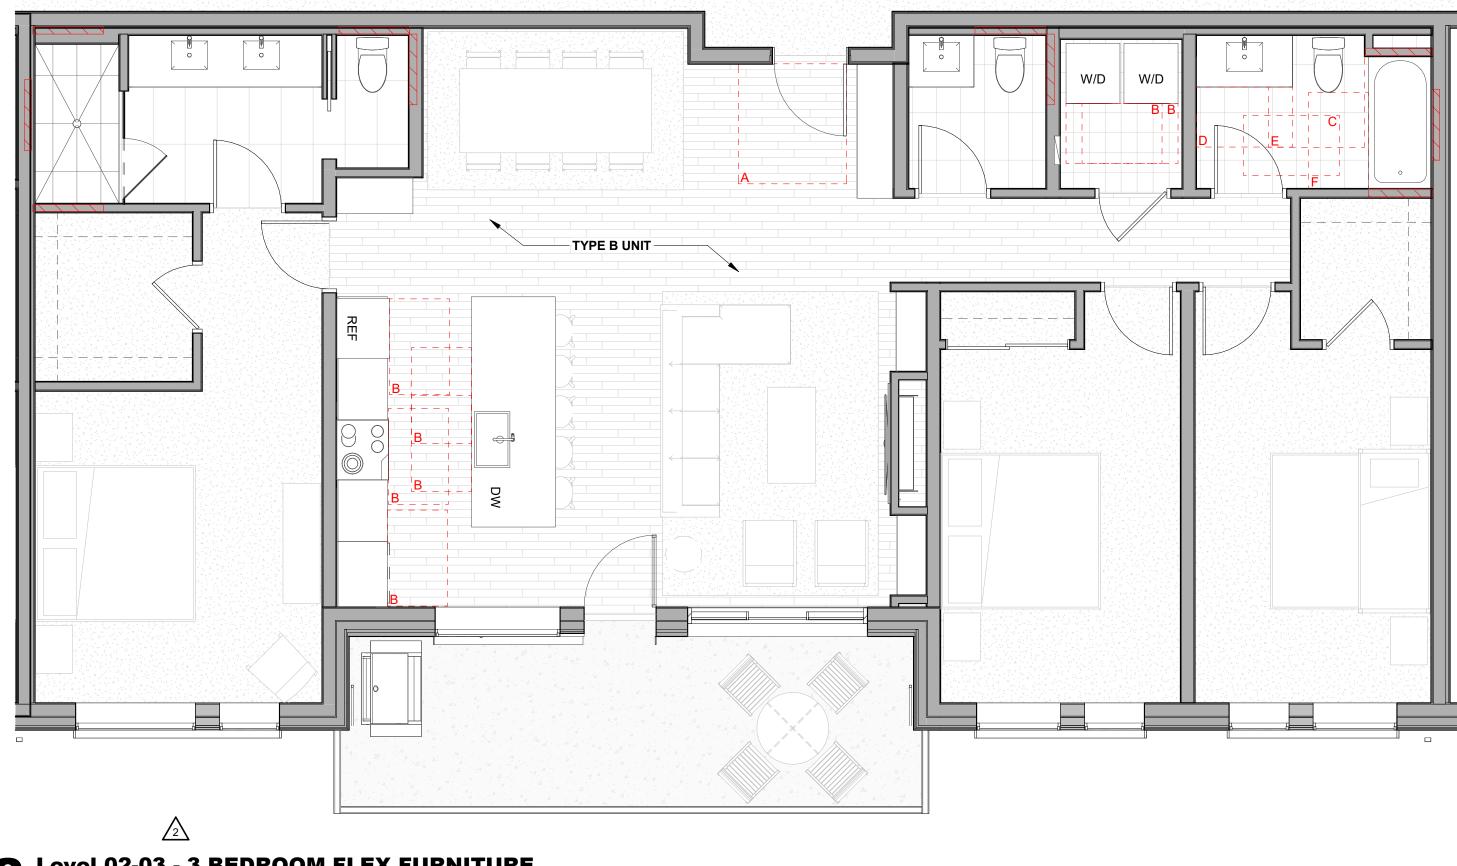



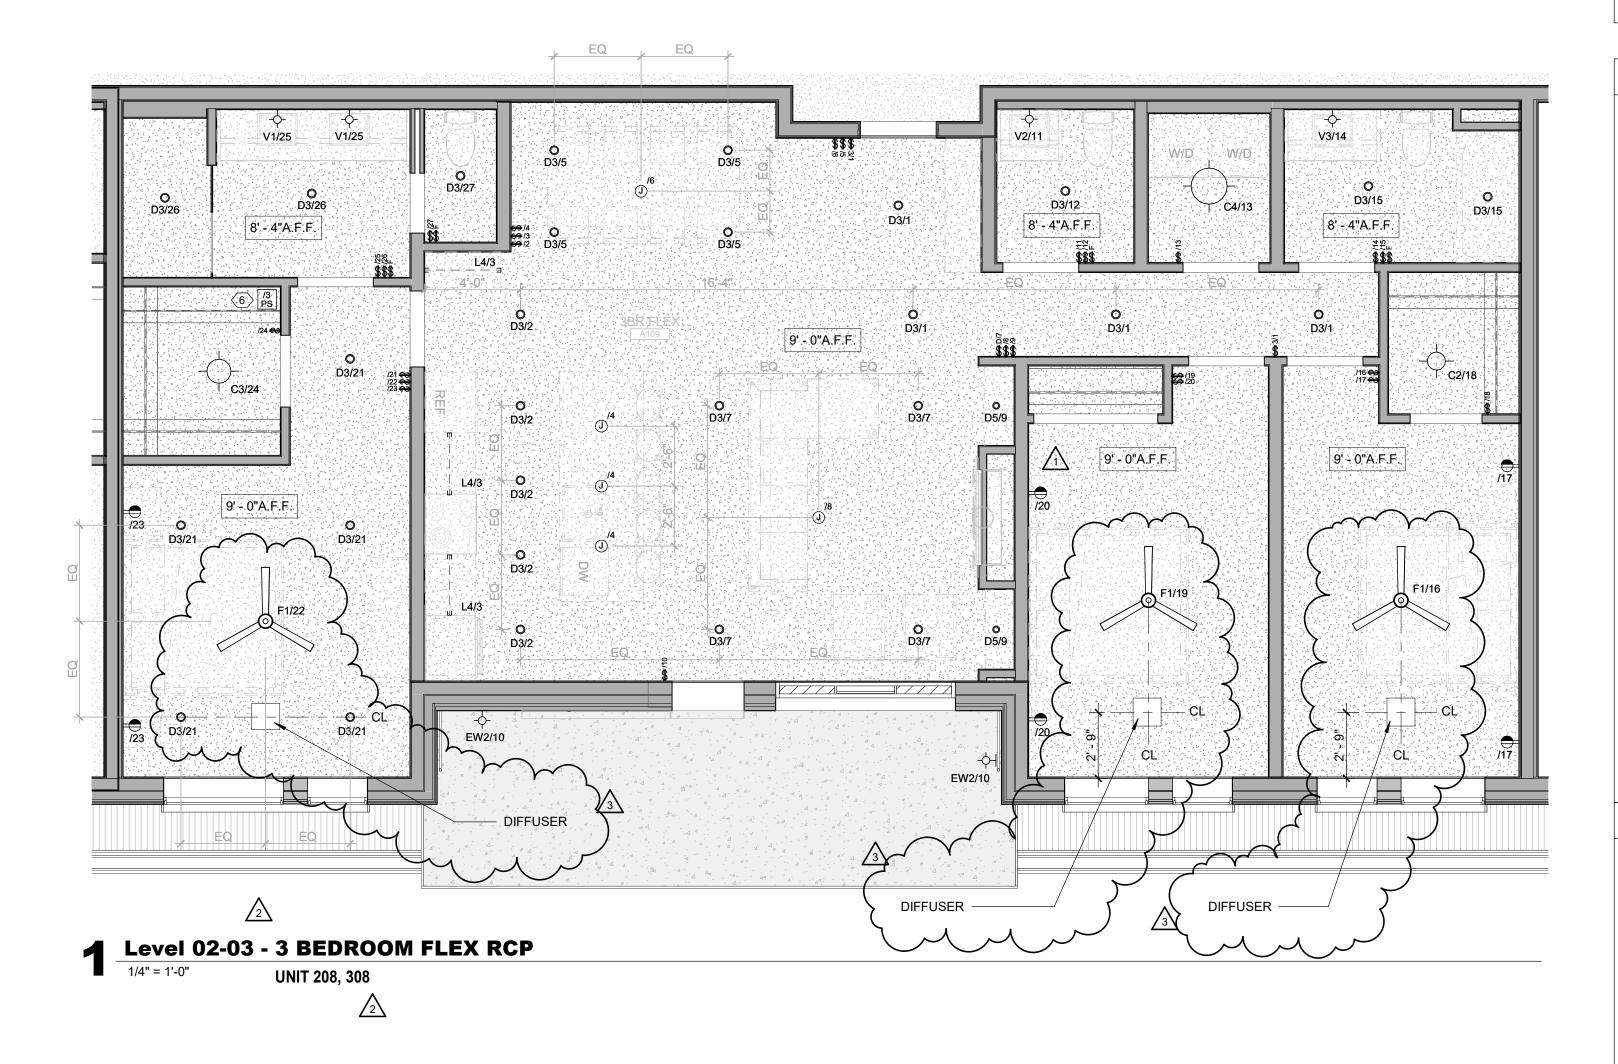


REFER TO G0.2X SHEETS FOR EXTERIOR AND INTERIOR

BUILDING ENCLOSURE ASSEMBLIES.

- 2. REFER TO A1.0X SHEETS FOR EXTERIOR WALL, DEMISING WALL, AND CORRIDOR WALL TYPES AND LOCATIONS.
- REFER TO A1.1X SHEETS FOR INTERIOR AND EXTERIOR WINDOW/DOOR TAGS WITH UNIT BACKGROUNDS FOR REFERENCE.
 ALIGN WALLS WHERE THEY APPEAR TO ALIGN, U.N.O.
- 5. THE INSIDE FACE OF DOOR JAMBS SHALL BE 4" FROM
- ADJACENT WALL OR FINISHED COLUMN, U.N.O. 6. PROVIDE BLOCKING FOR ALL WALL MOUNTED EQUIPMENT
- AND ACCESSORIES. 7. THE CENTERLINE OF ALL RESIDENTIAL TOILETS SHALL BE
- LOCATED 18" OFF OF FINISH FACE OF WALL, U.N.O. 8. SWING CLEARANCE AT UNIT ENTRY SHALL BE 18" MIN.
- FROM FINISH FACE OF ADJACENT SURFACE. 9. ALL DIMENSIONS ARE TO FACE OF STUD, GRID LINE, OR
- FACE OF CONCRETE, U.N.O. 10. WHERE "CLEAR" IS CALLED OUT ON A DIMENSION, PROVIDE DIMENSION FROM FACE OF FINISH TO FACE OF
- FINISH. 11. FURNITURE IS NOT IN CONTRACT, U.N.O., AND IS SHOWN
- FOR DIAGRAMATIC PURPOSES ONLY. 12. CONSULTANT MODELS SHOWN FOR REFERENCE ONLY.

ENLARGED FLOOR PLAN - LEGEND

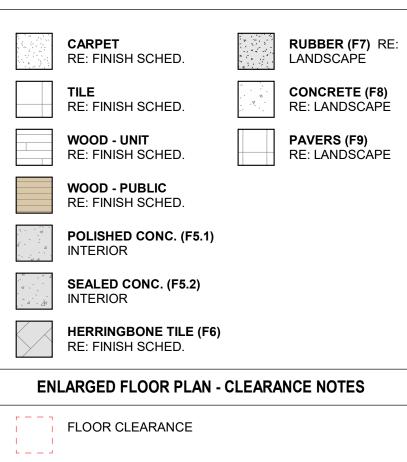


- A DOOR CLEARANCE, 54" X 60"
- B APPLIANCE CLEARANCE, 30" X 48"
- C CLEAR FLOOR CLEARANCE, 30" X 48"
- D VANITY CLEARANCE, 30" X 48"
- E TOILET CLEARANCE, 48" X 56" OR ADA 60" X 56"
- F SHOWER/TUB CLEARANCE, 30" X 48" (B)
- G TURN AROUND CLEARANCE
- GRAB BAR BLOCKING REQ. AT TOILET WALL WHERE APPLICABLE

ENLARGED RCP - GENERAL NOTES


- 1. ALL UNIT CEILINGS SHALL BE 9' 0" A.F.F. U.N.O. REFER TO ENLARGED RCP'S FOR COMMON AREA CEILING HEIGHTS.
- 2. IN THE CASE OF MINOR DISCREPANCIES BETWEEN MEP AND ARCHITECTURAL DOCUMENTS ON THE LOCATION OF CEILING MOUNTED COMPONENTS, THE ARCHITECTURAL RCP'S GOVERN. IN THE CASE OF MAJOR DISCREPANCIES, THE ARCHITECT SHALL BE NOTIFIED AS SOON AS THE DISCREPANCY IS DISCOVERED PRIOR TO PROCEEDING WITH THE WORK.
- 3. REFERENCE MECHANICAL AND ELECTRICAL DRAWINGS FOR MOUNTING LOCATIONS OF ITEMS WHERE NO CEILING IS REQUIRED OR INDICATED.
- 4. COORDINATE ALL TRADES INVOLVED IN THE CEILING WORK TO ENSURE CLEARANCE FOR FIXTURES, DUCTS, PIPING, CEILING SUSPENSION SYSTEMS, ETC. NECESSARY TO MAINTAIN CEILING HEIGHTS NOTED.
- 5. LIGHTS, DIFFUSERS, EXIT SIGNS, SMOKE DETECTORS, SPEAKERS, STROBES, AND MISC. DEVICES SHALL BE CENTERED IN THE CEILING WHERE THEY OCCUR, U.N.O.
- 6. FIRE PROTECTION SCOPE SHALL BE DESIGN-BUILD. ALL CORRIDOR SPRINKLER HEADS SHALL BE ALIGNED IN THE SAME LOCATION PARALLEL TO THE WALL WITHIN EACH SPECIFIC CEILING CONSTRUCTION.
- 7. SMOKE ALARMS SHALL BE PROVIDED IN ALL BEDROOMS, OUTSIDE OF ALL BEDROOMS, AND ON EACH FLOOR AS REQUIRED. CARBON MONOXIDE DETECTORS SHALL BE INSTALLED OUTSIDE OF ALL BEDROOMS. SMOKE ALARMS AND CO DETECTORS SHALL BE HARDWIRED AND HAVE BATTERY BACKUP.
- 8. ACCESS DOOR LOCATIONS IN GYPSUM BOARD CEILINGS ARE INDICATED ON RCP'S ONLY WHERE ARCHITECTURALLY SIGNIFICANT. REFERENCE SPECIFICATIONS AND MEP DRAWINGS FOR OTHER
- ACCESS DOOR LOCATIONS.
 9. UNLESS PREFINISHED TO MATCH ADJACENT SURFACE, PAINT MECHANICAL GRILLS, DIFFUSERS, ACCESS PANELS, AND OTHER EQUIPMENT TO MATCH ADJACENT SURFACE.
- EXIT SIGNS ARE SHOWN ON RCP'S ONLY WHERE LOCATIONS ARE ARCHITECTURALLY SIGNIFICANT.
 PROVIDE UL-CLASSIFIED LIGHT FIXTURES OR
- ENCLOSURES IN RATED FLOOR/CEILING ASSEMBLIES IN ACCORDANCE WITH IBC CHAPTER 7.12. REFER TO LIGHTING PLANS FOR EXACT FIXTURE TYPES AND LOCATIONS. FIXTURES SHOWN HERE ARE
- REFERENCED AND SHOWN FOR GENERAL ALIGNMENT.

GWB (C1) INTERIOR	\rightarrow	SLOPE CEILING AS NOTED
T&G CEILING (C2) INTERIOR	0	CEILING MOUNTED LIGHT FIXTURE
FIBER-CEMENT SOFFIT (C3) - EXTERIOR	+ + + + + +	VINYL SCRIM CLG - Interior
ACCESS PANEL		ACCOUSTIC VINYL
		TILE CLG - INTERIOF

<text><text></text></text>
BRUCE D. MINS B-2465 12/15/2023
The Amble Steamboat Springs, CO
IFC SET IFC SET SHEET TITLE UNIT PLAN - 3 BEDROOM FLEX - LEVELS 02-03 SHEET NO.

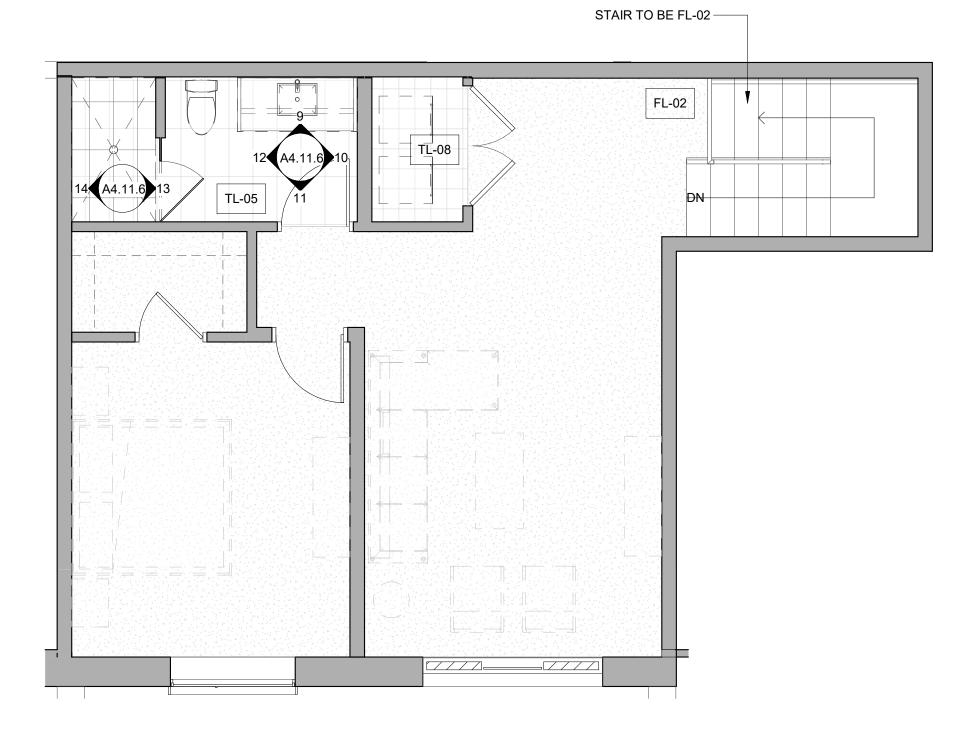




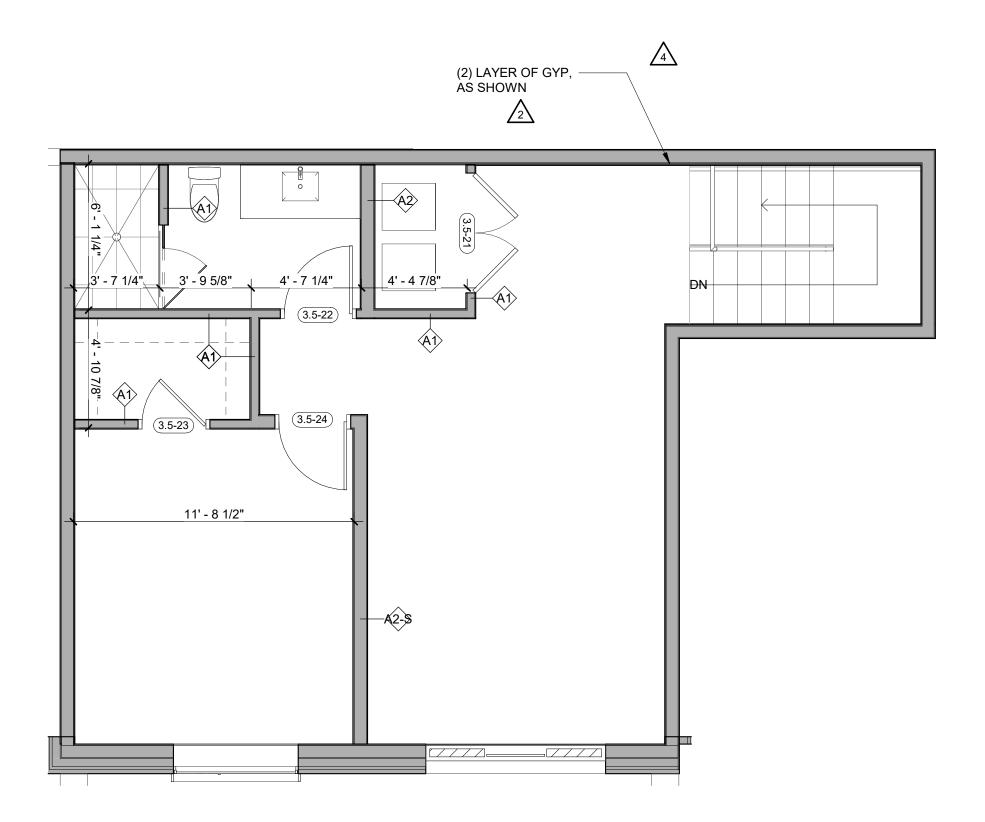


3 LEVEL 05 - 3 BED FLEX DIMENSION 1/4" = 1'-0" UNIT 408

UNIT 408

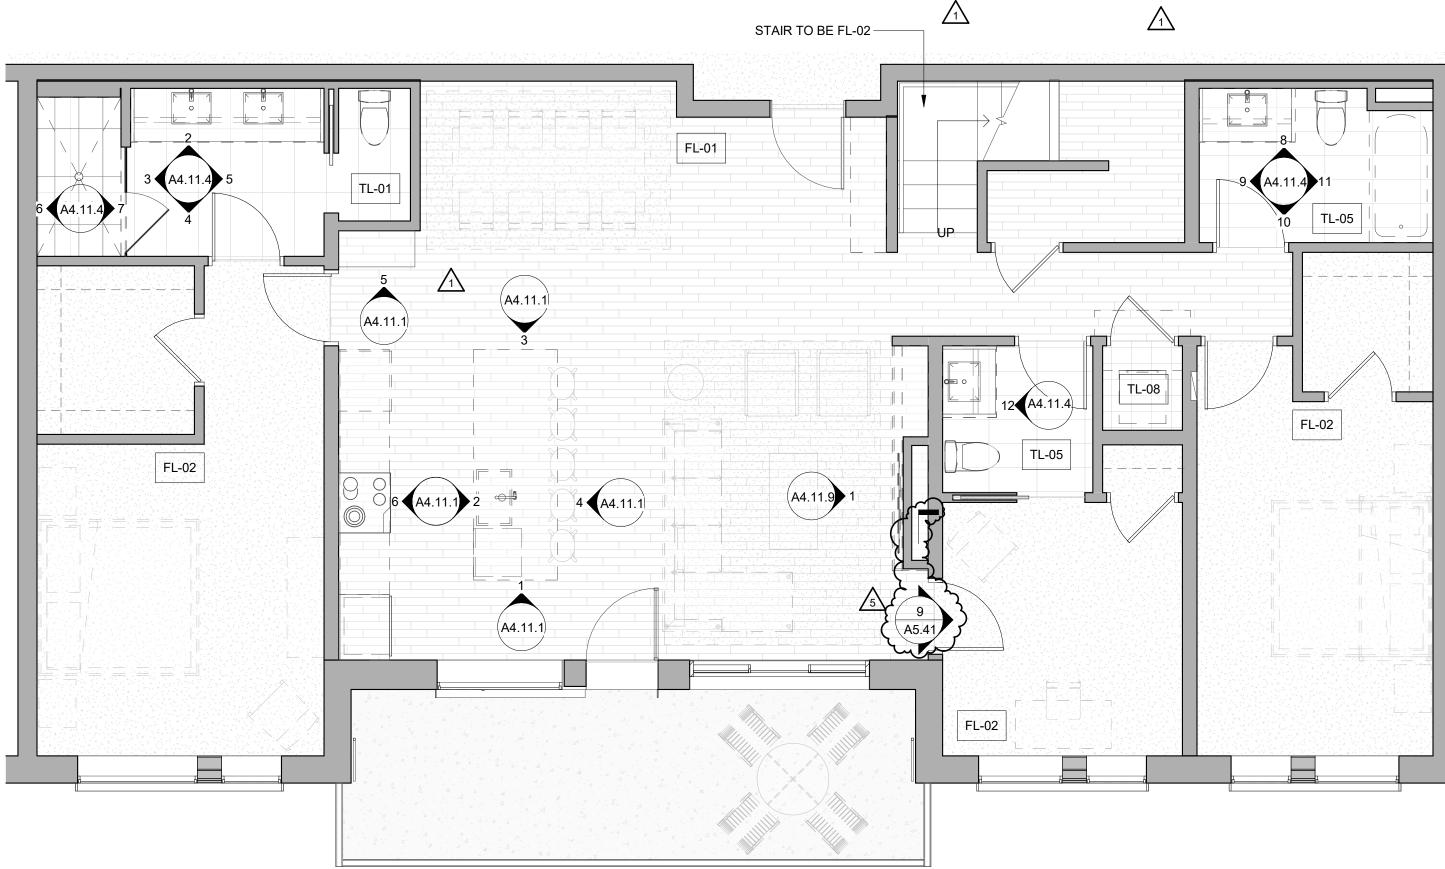

Level 04 - 3 BEDROOM FLEX FINISH 1/4" = 1'-0" **UNIT 408**

 $\sqrt{3}$

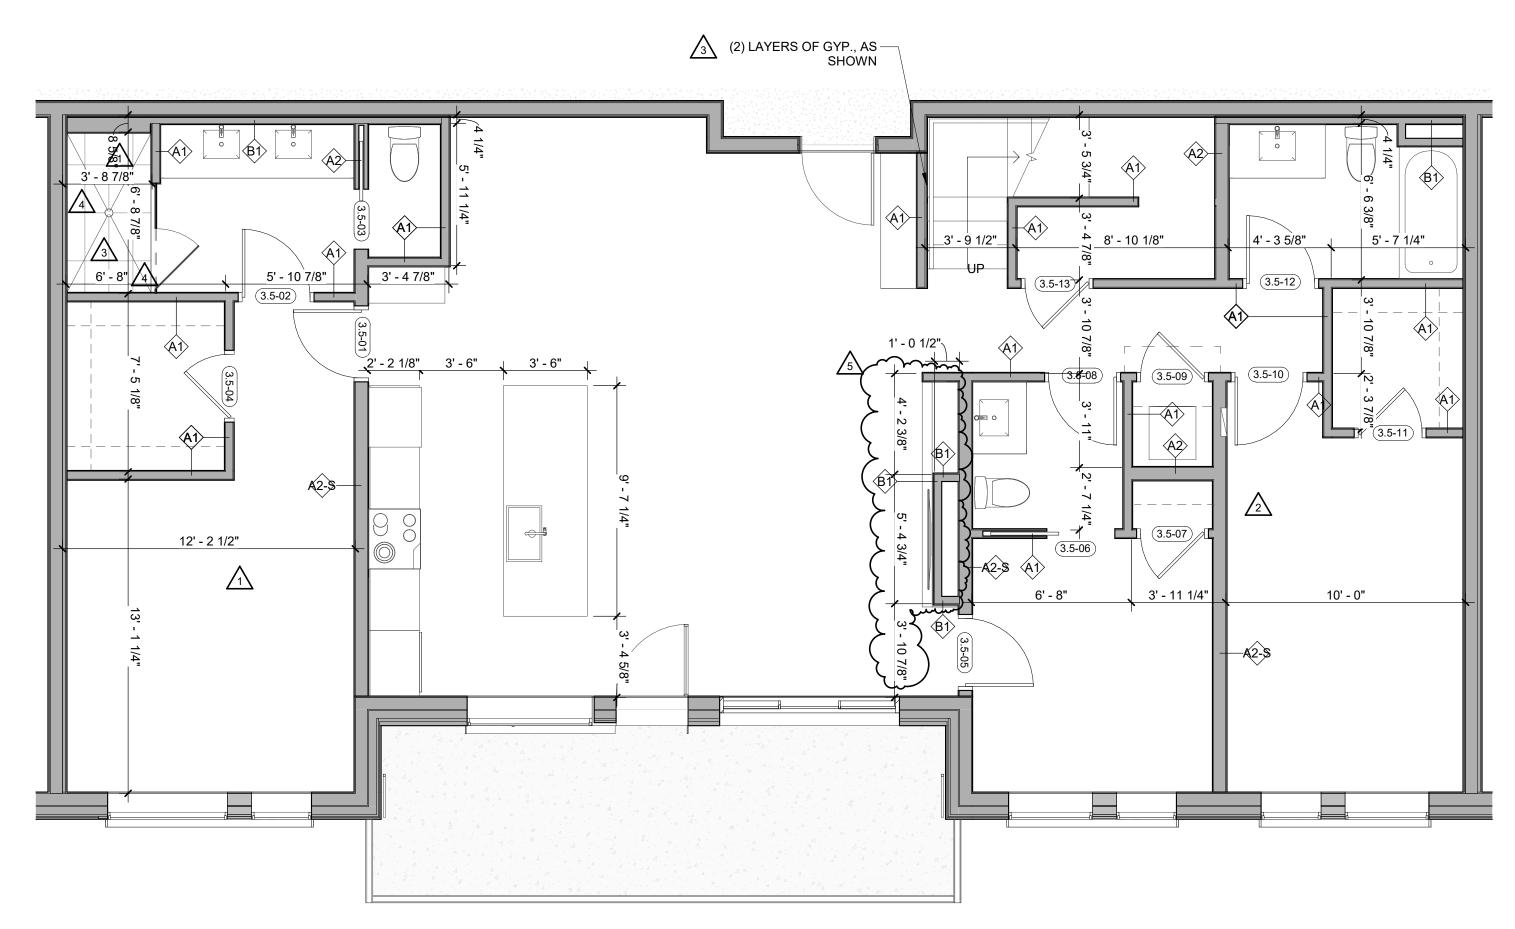


Level 04 - 3 BEDROOM FLEX DIMENSION **Level 0** 1/4" = 1'-0"

UNIT 408

ENLARGED FLOOR PLAN - GENERAL NOTES

- REFER TO G0.2X SHEETS FOR EXTERIOR AND INTERIOR BUILDING ENCLOSURE ASSEMBLIES.
- REFER TO A1.0X SHEETS FOR EXTERIOR WALL, DEMISING WALL, AND CORRIDOR WALL TYPES AND LOCATIONS. REFER TO A1.1X SHEETS FOR INTERIOR AND EXTERIOR WINDOW/DOOR TAGS WITH UNIT BACKGROUNDS FOR
- REFERENCE. ALIGN WALLS WHERE THEY APPEAR TO ALIGN, U.N.O.
- THE INSIDE FACE OF DOOR JAMBS SHALL BE 4" FROM ADJACENT WALL OR FINISHED COLUMN, U.N.O.
- PROVIDE BLOCKING FOR ALL WALL MOUNTED EQUIPMENT AND ACCESSORIES.
- THE CENTERLINE OF ALL RESIDENTIAL TOILETS SHALL BE LOCATED 18" OFF OF FINISH FACE OF WALL, U.N.O.
- SWING CLEARANCE AT UNIT ENTRY SHALL BE 18" MIN. FROM FINISH FACE OF ADJACENT SURFACE.
- ALL DIMENSIONS ARE TO FACE OF STUD, GRID LINE, OR FACE OF CONCRETE, U.N.O.
- 10. WHERE "CLEAR" IS CALLED OUT ON A DIMENSION, PROVIDE DIMENSION FROM FACE OF FINISH TO FACE OF FINISH
- 11. FURNITURE IS NOT IN CONTRACT, U.N.O., AND IS SHOWN FOR DIAGRAMATIC PURPOSES ONLY. 12. CONSULTANT MODELS SHOWN FOR REFERENCE ONLY.

ENLARGED FLOOR PLAN - LEGEND

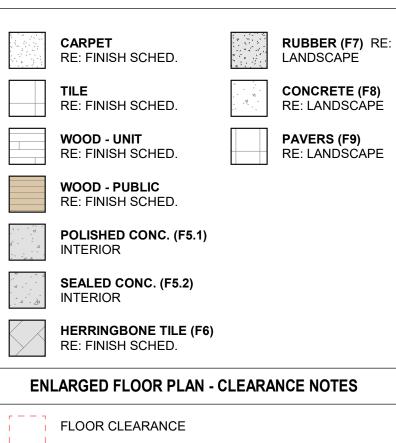

A DOOR CLEARANCE, 54" X 60"

- B APPLIANCE CLEARANCE, 30" X 48"
- C CLEAR FLOOR CLEARANCE, 30" X 48"
- D VANITY CLEARANCE, 30" X 48"
- E TOILET CLEARANCE, 48" X 56" OR ADA 60" X 56"
- F SHOWER/TUB CLEARANCE, 30" X 48" (B)
- G TURN AROUND CLEARANCE
- GRAB BAR BLOCKING REQ. AT TOILET WALL WHERE APPLICABLE

ENLARGED RCP - GENERAL NOTES


- ALL UNIT CEILINGS SHALL BE 9' 0" A.F.F. U.N.O. REFER TO ENLARGED RCP'S FOR COMMON AREA CEILING HEIGHTS.
- IN THE CASE OF MINOR DISCREPANCIES BETWEEN MEP AND ARCHITECTURAL DOCUMENTS ON THE LOCATION OF CEILING MOUNTED COMPONENTS, THE ARCHITECTURAL RCP'S GOVERN. IN THE CASE OF MAJOR DISCREPANCIES, THE ARCHITECT SHALL BE NOTIFIED AS SOON AS THE DISCREPANCY IS DISCOVERED PRIOR TO PROCEEDING WITH THE WORK.
- REFERENCE MECHANICAL AND ELECTRICAL DRAWINGS FOR MOUNTING LOCATIONS OF ITEMS WHERE NO CEILING IS REQUIRED OR INDICATED.
- COORDINATE ALL TRADES INVOLVED IN THE CEILING WORK TO ENSURE CLEARANCE FOR FIXTURES, DUCTS, PIPING, CEILING SUSPENSION SYSTEMS, ETC. NECESSARY TO MAINTAIN CEILING HEIGHTS NOTED.
- LIGHTS, DIFFUSERS, EXIT SIGNS, SMOKE DETECTORS, SPEAKERS, STROBES, AND MISC. DEVICES SHALL BE CENTERED IN THE CEILING WHERE THEY OCCUR, U.N.O. FIRE PROTECTION SCOPE SHALL BE DESIGN-BUILD. ALL
- CORRIDOR SPRINKLER HEADS SHALL BE ALIGNED IN THE SAME LOCATION PARALLEL TO THE WALL WITHIN EACH SPECIFIC CEILING CONSTRUCTION. SMOKE ALARMS SHALL BE PROVIDED IN ALL BEDROOMS,
- OUTSIDE OF ALL BEDROOMS, AND ON EACH FLOOR AS REQUIRED. CARBON MONOXIDE DETECTORS SHALL BE INSTALLED OUTSIDE OF ALL BEDROOMS. SMOKE ALARMS AND CO DETECTORS SHALL BE HARDWIRED AND HAVE BATTERY BACKUP.
- ACCESS DOOR LOCATIONS IN GYPSUM BOARD CEILINGS ARE INDICATED ON RCP'S ONLY WHERE ARCHITECTURALLY SIGNIFICANT. REFERENCE SPECIFICATIONS AND MEP DRAWINGS FOR OTHER ACCESS DOOR LOCATIONS.
- UNLESS PREFINISHED TO MATCH ADJACENT SURFACE, PAINT MECHANICAL GRILLS, DIFFUSERS, ACCESS PANELS, AND OTHER EQUIPMENT TO MATCH ADJACENT SURFACE. 10. EXIT SIGNS ARE SHOWN ON RCP'S ONLY WHERE
- LOCATIONS ARE ARCHITECTURALLY SIGNIFICANT. 1. PROVIDE UL-CLASSIFIED LIGHT FIXTURES OR ENCLOSURES IN RATED FLOOR/CEILING ASSEMBLIES IN
- ACCORDANCE WITH IBC CHAPTER 7. 12. REFER TO LIGHTING PLANS FOR EXACT FIXTURE TYPES AND LOCATIONS. FIXTURES SHOWN HERE ARE REFERENCED AND SHOWN FOR GENERAL ALIGNMENT.

D SHOWIN C	ALIGNNEN


- 1	GWB (C1) INTERIOR	\rightarrow	SLOPE CEILING AS NOTED
	T&G CEILING (C2) INTERIOR	0	CEILING MOUNTED LIGHT FIXTURE
	FIBER-CEMENT SOFFIT (C3) - EXTERIOR	+ + + + + + + + + + + + + + + + + + + +	VINYL SCRIM CLG - Interior
	ACCESS PANEL		ACOUSTIC VINYL Tile Clg - Interio

TOWN	STAMP
3630 OSA	59 10 10 10 10 10 10 10 10
BRSCE I BRSCE I B-24 12/15/	
The Amble	Steamboat Springs, CO

No.	Description	Date
	IFC SET	03.15.24
	RFI #125	06.24.24
	ASI 004	08.07.24
	RFI #232 RFI #241	09.17.24
PROJECT N		20019
SSUE		
	IFC SET	
SHEET TITI	E	
	UNIT PLAN - ROOM FLEX -	-
DEDL	04	

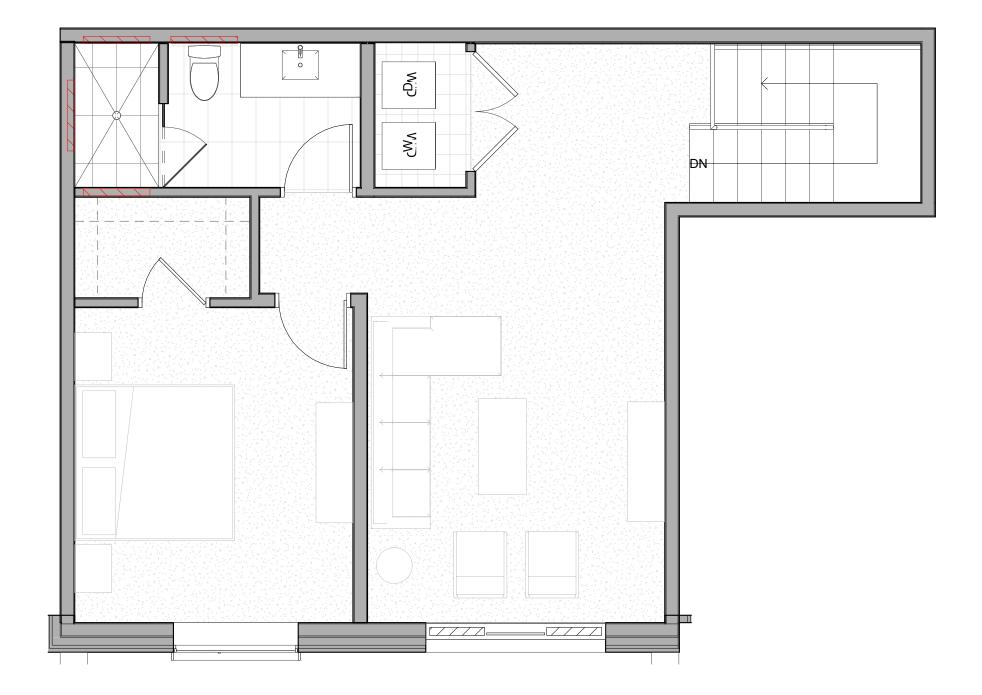




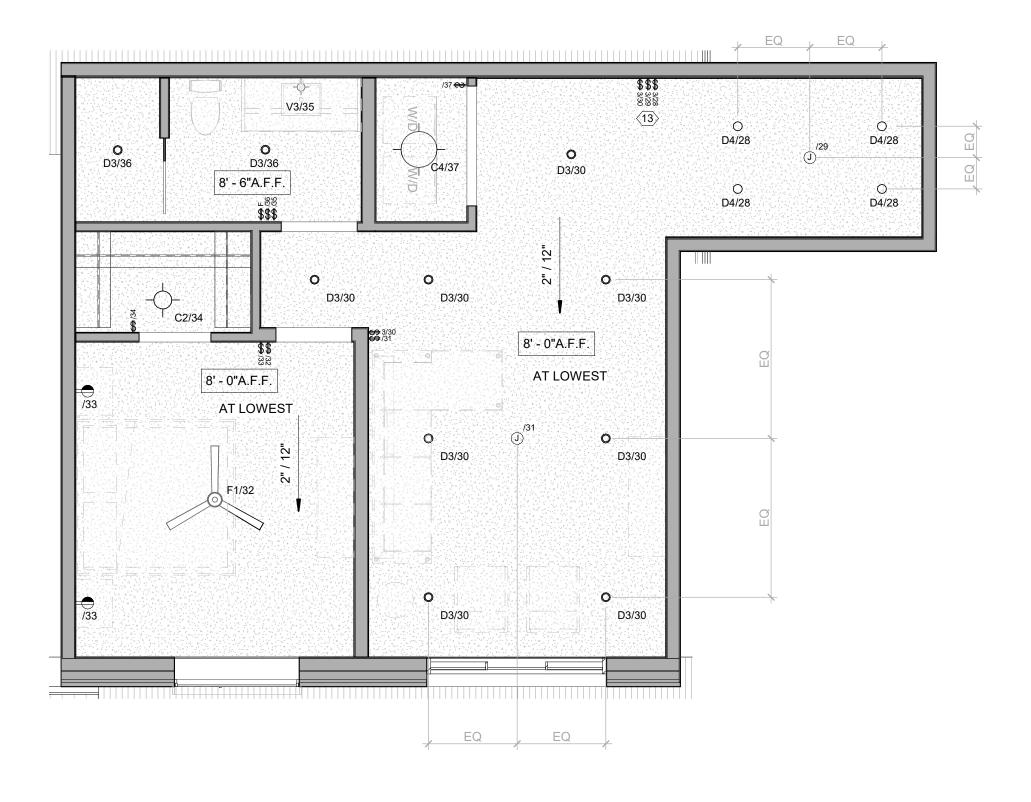




2

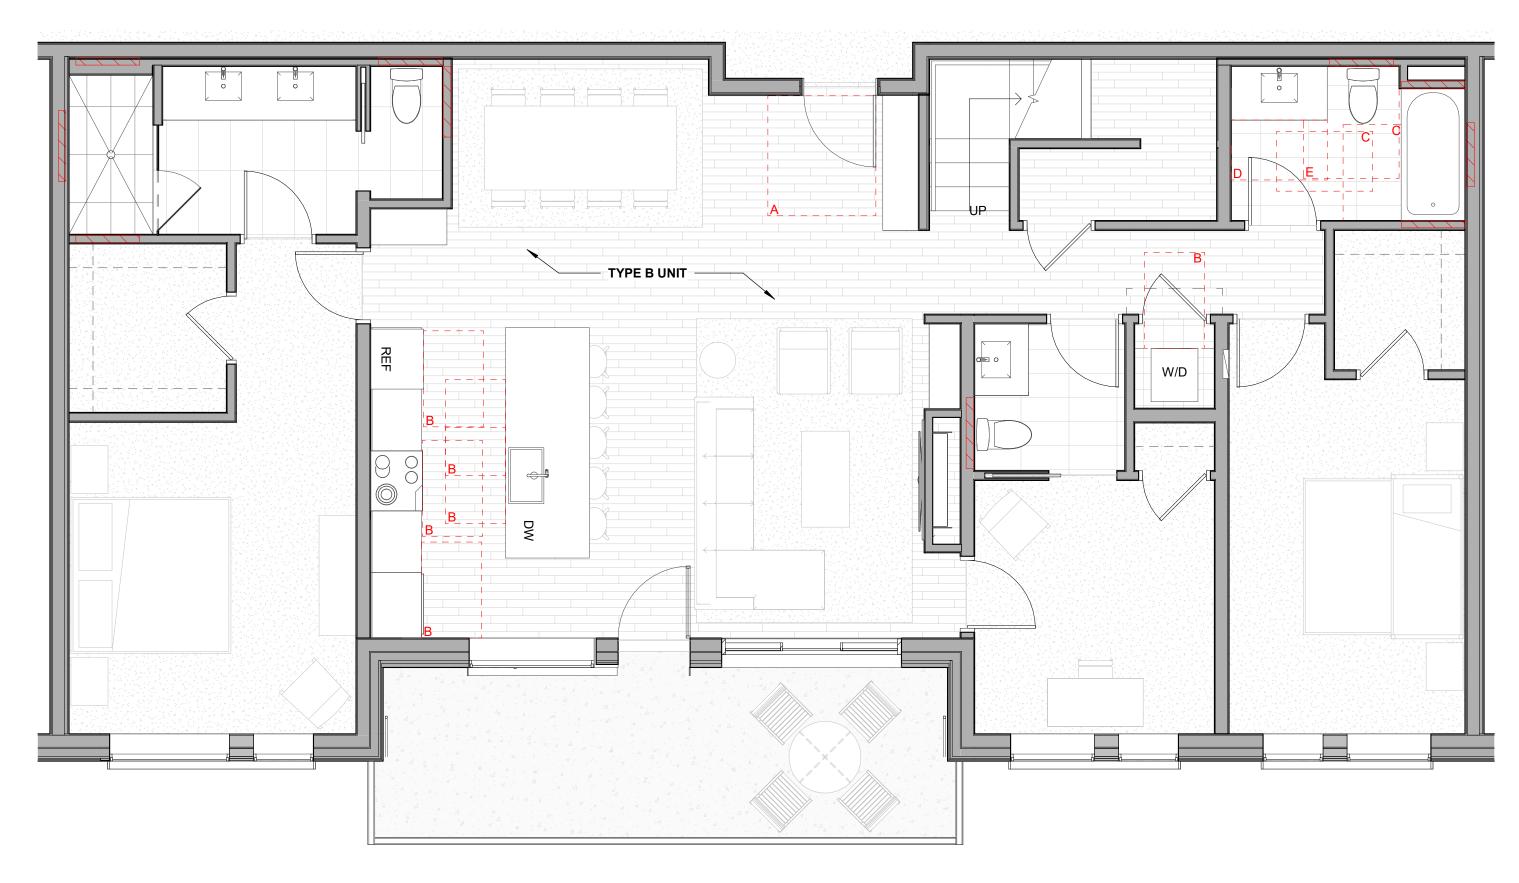

2 Level 04 - 3 BEDROOM FLEX FURNITURE 1/4" = 1'-0" UNIT 408

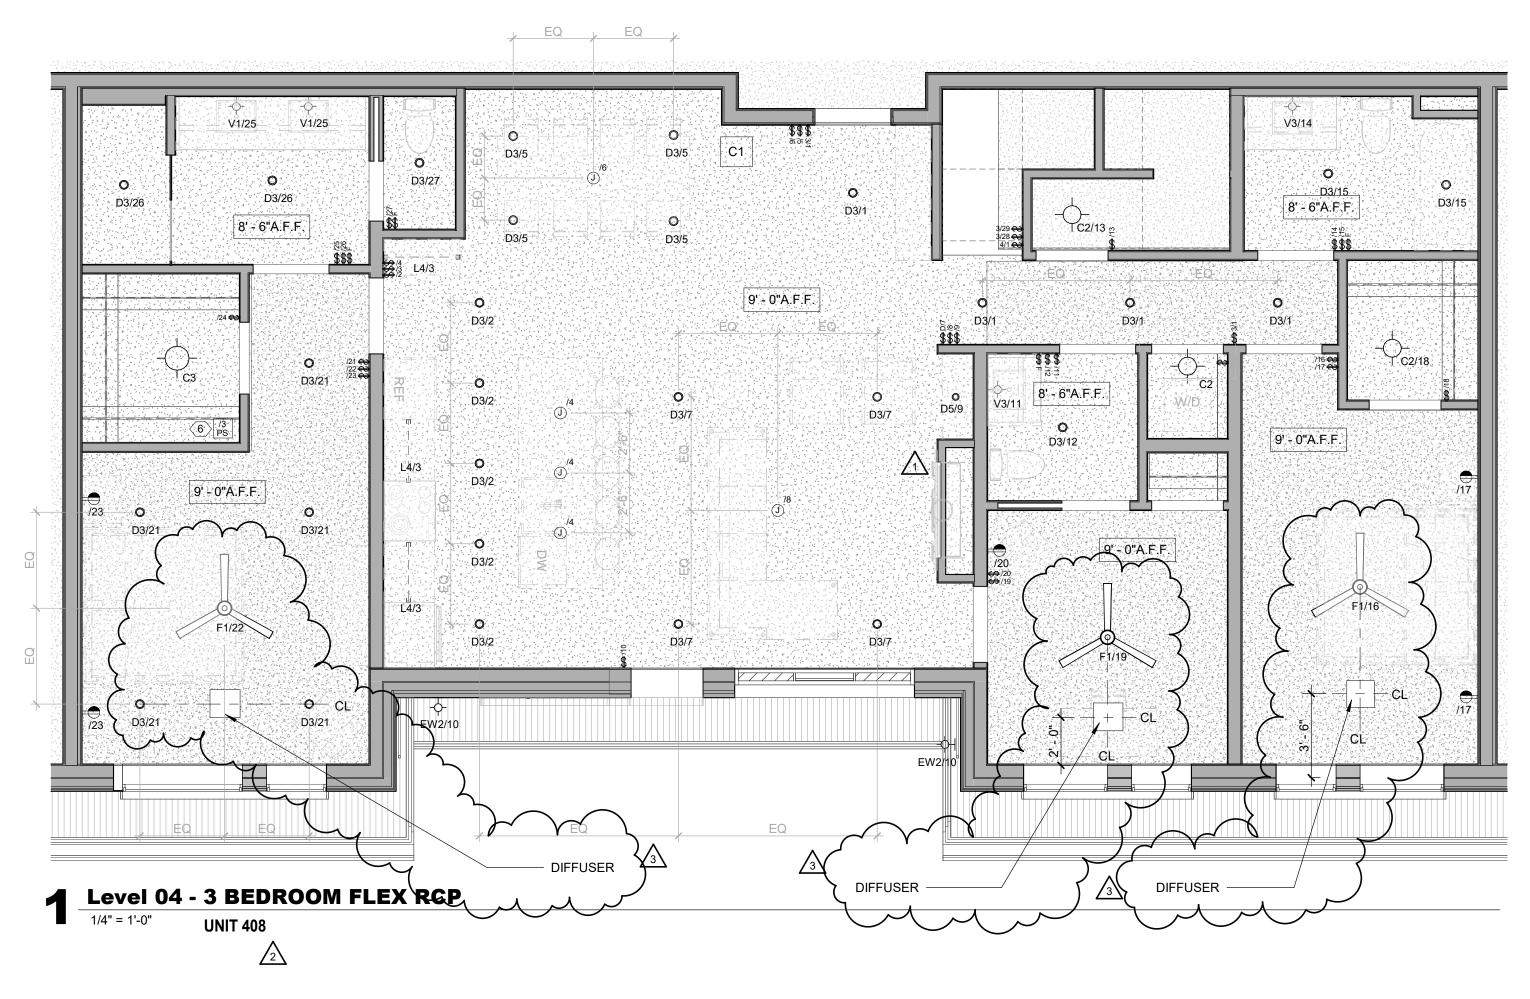

- . REFER TO G0.2X SHEETS FOR EXTERIOR AND INTERIOR BUILDING ENCLOSURE ASSEMBLIES.
- REFER TO A1.0X SHEETS FOR EXTERIOR WALL, DEMISING WALL, AND CORRIDOR WALL TYPES AND LOCATIONS.
 REFER TO A1.1X SHEETS FOR INTERIOR AND EXTERIOR
- WINDOW/DOOR TAGS WITH UNIT BACKGROUNDS FOR REFERENCE. 4. ALIGN WALLS WHERE THEY APPEAR TO ALIGN, U.N.O.
- 5. THE INSIDE FACE OF DOOR JAMBS SHALL BE 4" FROM ADJACENT WALL OR FINISHED COLUMN, U.N.O.
- 6. PROVIDE BLOCKING FOR ALL WALL MOUNTED EQUIPMENT
- AND ACCESSORIES. 7. THE CENTERLINE OF ALL RESIDENTIAL TOILETS SHALL BE
- LOCATED 18" OFF OF FINISH FACE OF WALL, U.N.O. 3. SWING CLEARANCE AT UNIT ENTRY SHALL BE 18" MIN.
- FROM FINISH FACE OF ADJACENT SURFACE.
 ALL DIMENSIONS ARE TO FACE OF STUD, GRID LINE, OR FACE OF CONCRETE, U.N.O.
- WHERE "CLEAR" IS CALLED OUT ON A DIMENSION, PROVIDE DIMENSION FROM FACE OF FINISH TO FACE OF
- FINISH. 11. FURNITURE IS NOT IN CONTRACT, U.N.O., AND IS SHOWN FOR DIAGRAMATIC PURPOSES ONLY. 12. CONSULTANT MODELS SHOWN FOR REFERENCE ONLY.



- RUBBER (F7) RE: CARPET RE: FINISH SCHED. LANDSCAPE CONCRETE (F8) TILE RE: LANDSCAPE RE: FINISH SCHED. PAVERS (F9) WOOD - UNIT RE: LANDSCAPE RE: FINISH SCHED. WOOD - PUBLIC RE: FINISH SCHED. POLISHED CONC. (F5.1) INTERIOR SEALED CONC. (F5.2) INTERIOR HERRINGBONE TILE (F6) RE: FINISH SCHED. ENLARGED FLOOR PLAN - CLEARANCE NOTES FLOOR CLEARANCE
- A DOOR CLEARANCE, 54" X 60"
- B APPLIANCE CLEARANCE, 30" X 48"
- C CLEAR FLOOR CLEARANCE, 30" X 48"
- D VANITY CLEARANCE, 30" X 48"
- E TOILET CLEARANCE, 48" X 56" OR ADA 60" X 56"
- F SHOWER/TUB CLEARANCE, 30" X 48" (B)
- G TURN AROUND CLEARANCE
- GRAB BAR BLOCKING REQ. AT TOILET WALL WHERE APPLICABLE


ENLARGED RCP - GENERAL NOTES

- 1. ALL UNIT CEILINGS SHALL BE 9' 0" A.F.F. U.N.O. REFER TO ENLARGED RCP'S FOR COMMON AREA CEILING HEIGHTS.
- 2. IN THE CASE OF MINOR DISCREPANCIES BETWEEN MEP AND ARCHITECTURAL DOCUMENTS ON THE LOCATION OF CEILING MOUNTED COMPONENTS, THE ARCHITECTURAL RCP'S GOVERN. IN THE CASE OF MAJOR DISCREPANCIES, THE ARCHITECT SHALL BE NOTIFIED AS SOON AS THE DISCREPANCY IS DISCOVERED PRIOR TO PROCEEDING WITH THE WORK.
- 3. REFERENCE MECHANICAL AND ELECTRICAL DRAWINGS FOR MOUNTING LOCATIONS OF ITEMS WHERE NO CEILING IS REQUIRED OR INDICATED.
- 4. COORDINATE ALL TRADES INVOLVED IN THE CEILING WORK TO ENSURE CLEARANCE FOR FIXTURES, DUCTS, PIPING, CEILING SUSPENSION SYSTEMS, ETC. NECESSARY TO MAINTAIN CEILING HEIGHTS NOTED.
- LIGHTS, DIFFUSERS, EXIT SIGNS, SMOKE DETECTORS, SPEAKERS, STROBES, AND MISC. DEVICES SHALL BE CENTERED IN THE CEILING WHERE THEY OCCUR, U.N.O.
 FIRE PROTECTION SCOPE SHALL BE DESIGN-BUILD. ALL
- CORRIDOR SPRINKLER HEADS SHALL BE ALIGNED IN THE SAME LOCATION PARALLEL TO THE WALL WITHIN EACH SPECIFIC CEILING CONSTRUCTION.
- 7. SMOKE ALARMS SHALL BE PROVIDED IN ALL BEDROOMS, OUTSIDE OF ALL BEDROOMS, AND ON EACH FLOOR AS REQUIRED. CARBON MONOXIDE DETECTORS SHALL BE INSTALLED OUTSIDE OF ALL BEDROOMS. SMOKE ALARMS AND CO DETECTORS SHALL BE HARDWIRED AND HAVE BATTERY BACKUP.
- 8. ACCESS DOOR LOCATIONS IN GYPSUM BOARD CEILINGS ARE INDICATED ON RCP'S ONLY WHERE ARCHITECTURALLY SIGNIFICANT. REFERENCE SPECIFICATIONS AND MEP DRAWINGS FOR OTHER
- ACCESS DOOR LOCATIONS.
 9. UNLESS PREFINISHED TO MATCH ADJACENT SURFACE, PAINT MECHANICAL GRILLS, DIFFUSERS, ACCESS PANELS, AND OTHER EQUIPMENT TO MATCH ADJACENT SURFACE.
- EXIT SIGNS ARE SHOWN ON RCP'S ONLY WHERE LOCATIONS ARE ARCHITECTURALLY SIGNIFICANT.
 PROVIDE UL-CLASSIFIED LIGHT FIXTURES OR
- ENCLOSURES IN RATED FLOOR/CEILING ASSEMBLIES IN ACCORDANCE WITH IBC CHAPTER 7.12. REFER TO LIGHTING PLANS FOR EXACT FIXTURE TYPES AND LOCATIONS. FIXTURES SHOWN HERE ARE
- REFERENCED AND SHOWN FOR GENERAL ALIGNMENT.

GWB (C1) INTERIOR	\rightarrow	SLOPE CEILING AS NOTED
T&G CEILING (C2) INTERIOR	0	CEILING MOUNTED LIGHT FIXTURE
FIBER-CEMENT SOFFIT (C3) - EXTERIOR	+ + + + + + + + + + + + + + + + + + + +	VINYL SCRIM CLG - Interior
ACCESS PANEL		ACCOUSTIC VINYL TILE CLG - INTERIOF


	35) E S	STAMP	Ν
10 IIII	BRUCE I B-24 12/15/	/	
	The Amble	Steamboat Springs, CO	
REVISIONS	RFI #110 ASI 004 RFI #223.1	06. 08.	Date 14.24 07.24 16.24
	THE A IFC UNIT P ROOM F 0	MBLE SET	20019 15/2024 EVEL



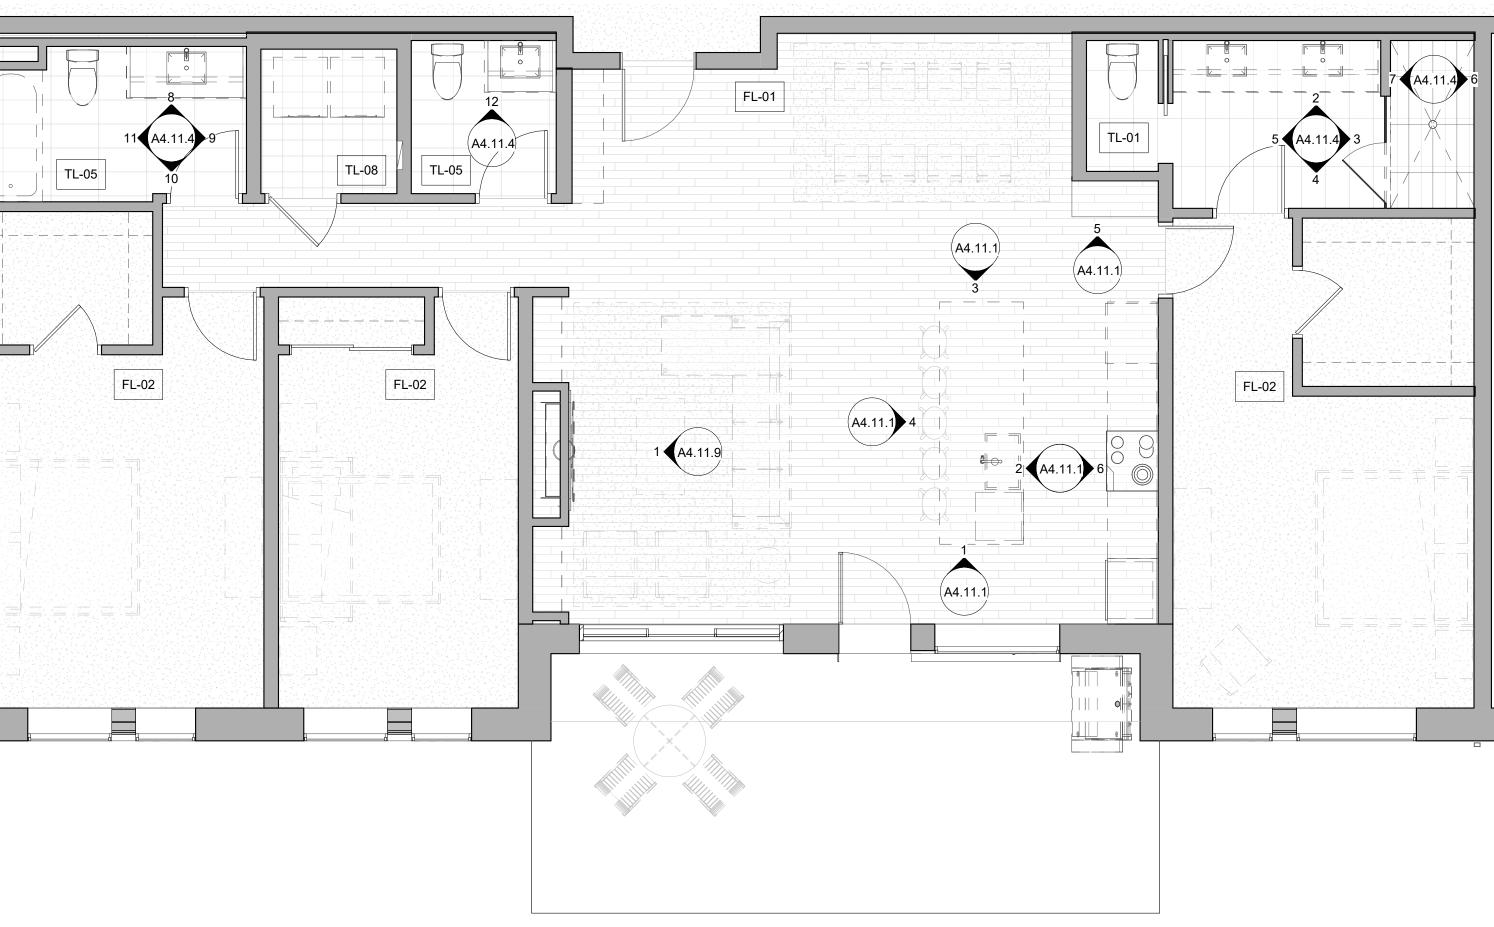

2 Level 01 - 3 BED STANDARD FINISH 1/4" = 1'-0" UNIT 106 UNIT 106


<u>/2</u>

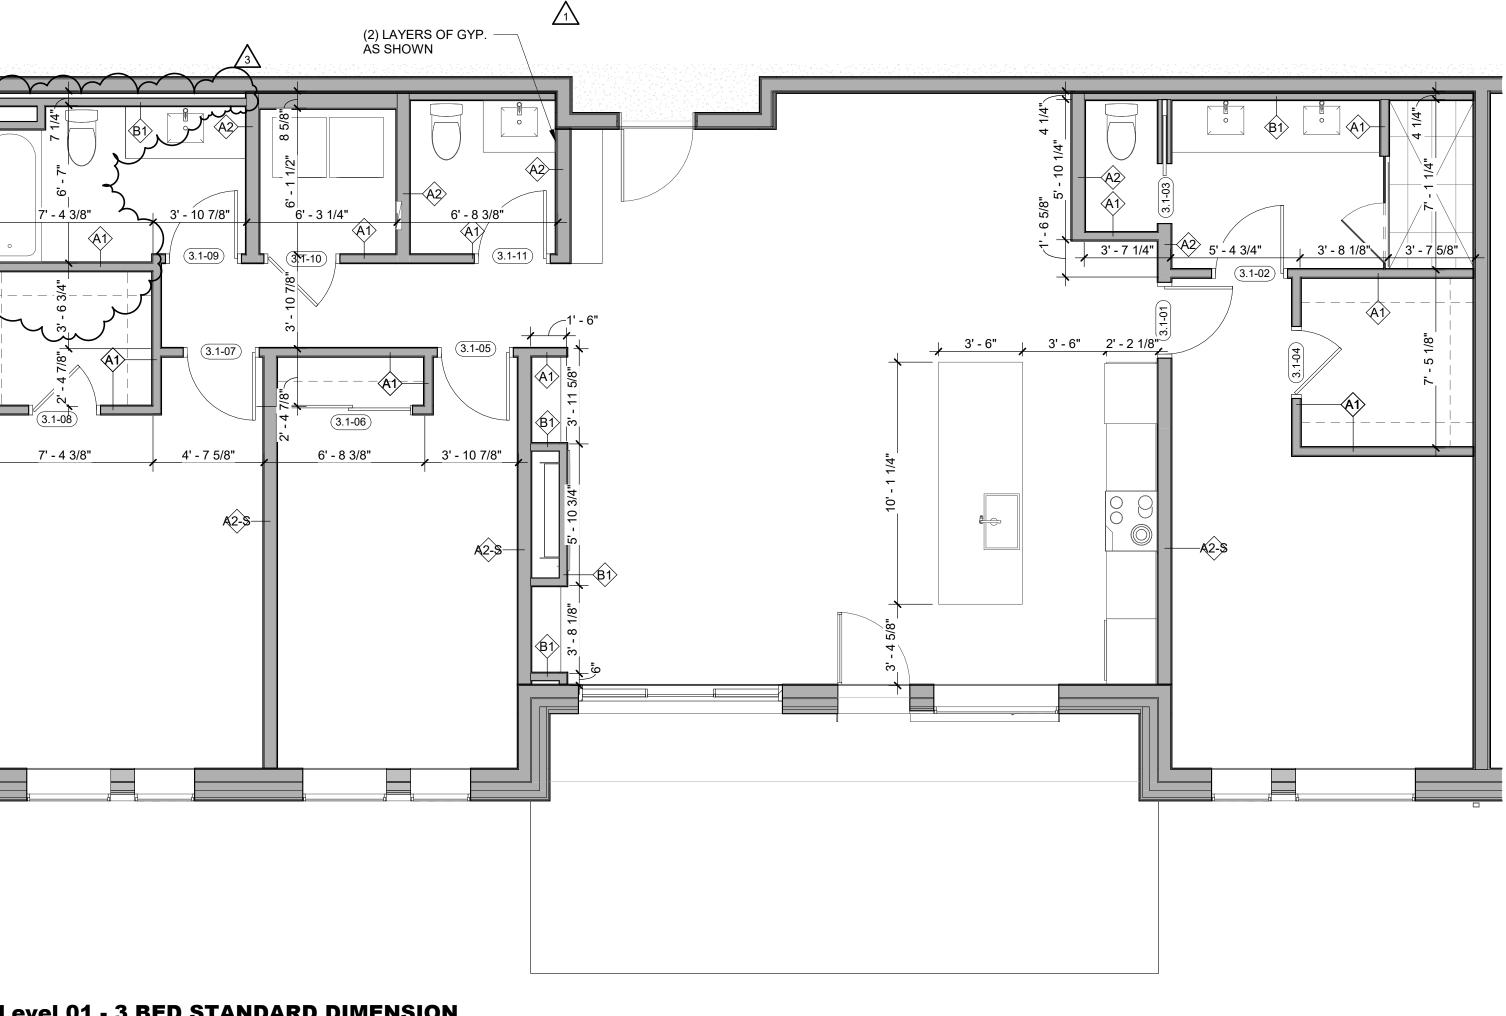

Level 01 - 3 BED STANDARD DIMENSION 1/4" = 1'-0"

- REFER TO G0.2X SHEETS FOR EXTERIOR AND INTERIOR
- BUILDING ENCLOSURE ASSEMBLIES. REFER TO A1.0X SHEETS FOR EXTERIOR WALL, DEMISING WALL, AND CORRIDOR WALL TYPES AND LOCATIONS.
- REFER TO A1.1X SHEETS FOR INTERIOR AND EXTERIOR WINDOW/DOOR TAGS WITH UNIT BACKGROUNDS FOR REFERENCE.
- ALIGN WALLS WHERE THEY APPEAR TO ALIGN, U.N.O. THE INSIDE FACE OF DOOR JAMBS SHALL BE 4" FROM
- ADJACENT WALL OR FINISHED COLUMN, U.N.O. PROVIDE BLOCKING FOR ALL WALL MOUNTED EQUIPMENT
- AND ACCESSORIES.
- THE CENTERLINE OF ALL RESIDENTIAL TOILETS SHALL BE LOCATED 18" OFF OF FINISH FACE OF WALL, U.N.O. SWING CLEARANCE AT UNIT ENTRY SHALL BE 18" MIN.
- FROM FINISH FACE OF ADJACENT SURFACE. ALL DIMENSIONS ARE TO FACE OF STUD, GRID LINE, OR
- FACE OF CONCRETE, U.N.O. 10. WHERE "CLEAR" IS CALLED OUT ON A DIMENSION,
- PROVIDE DIMENSION FROM FACE OF FINISH TO FACE OF FINISH. 11. FURNITURE IS NOT IN CONTRACT, U.N.O., AND IS SHOWN
- FOR DIAGRAMATIC PURPOSES ONLY. 12. CONSULTANT MODELS SHOWN FOR REFERENCE ONLY.

ENLARGED FLOOR PLAN - LEGEND

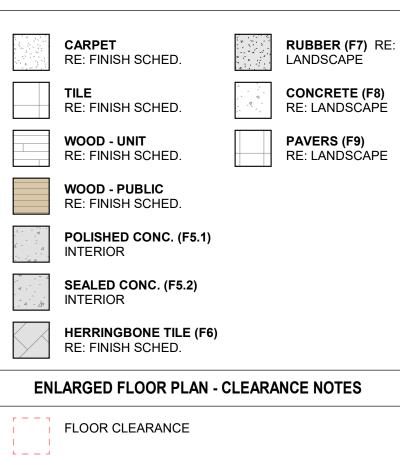

- A DOOR CLEARANCE, 54" X 60"
- B APPLIANCE CLEARANCE, 30" X 48"
- C CLEAR FLOOR CLEARANCE, 30" X 48"
- D VANITY CLEARANCE, 30" X 48"
- E TOILET CLEARANCE, 48" X 56" OR ADA 60" X 56"
- F SHOWER/TUB CLEARANCE, 30" X 48" (B)
- G TURN AROUND CLEARANCE
- GRAB BAR BLOCKING REQ. AT TOILET WALL WHERE APPLICABLE

ENLARGED RCP - GENERAL NOTES

- ALL UNIT CEILINGS SHALL BE 9' 0" A.F.F. U.N.O. REFER TO ENLARGED RCP'S FOR COMMON AREA CEILING HEIGHTS.
- IN THE CASE OF MINOR DISCREPANCIES BETWEEN MEP AND ARCHITECTURAL DOCUMENTS ON THE LOCATION OF CEILING MOUNTED COMPONENTS, THE ARCHITECTURAL RCP'S GOVERN. IN THE CASE OF MAJOR DISCREPANCIES, THE ARCHITECT SHALL BE NOTIFIED AS SOON AS THE DISCREPANCY IS DISCOVERED PRIOR TO PROCEEDING WITH THE WORK.
- REFERENCE MECHANICAL AND ELECTRICAL DRAWINGS FOR MOUNTING LOCATIONS OF ITEMS WHERE NO CEILING IS REQUIRED OR INDICATED.
- COORDINATE ALL TRADES INVOLVED IN THE CEILING WORK TO ENSURE CLEARANCE FOR FIXTURES, DUCTS, PIPING, CEILING SUSPENSION SYSTEMS, ETC. NECESSARY TO MAINTAIN CEILING HEIGHTS NOTED.
- LIGHTS, DIFFUSERS, EXIT SIGNS, SMOKE DETECTORS, SPEAKERS, STROBES, AND MISC. DEVICES SHALL BE CENTERED IN THE CEILING WHERE THEY OCCUR, U.N.O. FIRE PROTECTION SCOPE SHALL BE DESIGN-BUILD. ALL
- CORRIDOR SPRINKLER HEADS SHALL BE ALIGNED IN THE SAME LOCATION PARALLEL TO THE WALL WITHIN EACH SPECIFIC CEILING CONSTRUCTION.
- SMOKE ALARMS SHALL BE PROVIDED IN ALL BEDROOMS, OUTSIDE OF ALL BEDROOMS, AND ON EACH FLOOR AS REQUIRED. CARBON MONOXIDE DETECTORS SHALL BE INSTALLED OUTSIDE OF ALL BEDROOMS. SMOKE ALARMS AND CO DETECTORS SHALL BE HARDWIRED AND HAVE BATTERY BACKUP.
- ACCESS DOOR LOCATIONS IN GYPSUM BOARD CEILINGS ARE INDICATED ON RCP'S ONLY WHERE ARCHITECTURALLY SIGNIFICANT. REFERENCE SPECIFICATIONS AND MEP DRAWINGS FOR OTHER
- ACCESS DOOR LOCATIONS. UNLESS PREFINISHED TO MATCH ADJACENT SURFACE, PAINT MECHANICAL GRILLS, DIFFUSERS, ACCESS PANELS, AND OTHER EQUIPMENT TO MATCH ADJACENT SURFACE.
- 10. EXIT SIGNS ARE SHOWN ON RCP'S ONLY WHERE LOCATIONS ARE ARCHITECTURALLY SIGNIFICANT. 11. PROVIDE UL-CLASSIFIED LIGHT FIXTURES OR ENCLOSURES IN RATED FLOOR/CEILING ASSEMBLIES IN
- ACCORDANCE WITH IBC CHAPTER 7. 12. REFER TO LIGHTING PLANS FOR EXACT FIXTURE TYPES AND LOCATIONS. FIXTURES SHOWN HERE ARE
- REFERENCED AND SHOWN FOR GENERAL ALIGNMENT.

GWB (C1) INTERIOR

INTERIOR

T&G CEILING (C2)

(C3) - EXTERIOR

ACCESS PANEL

FIBER-CEMENT SOFFIT

ENLARGED RCP - LEGEND

0

 $\longrightarrow \underset{\mathsf{NOTED}}{\mathsf{SLOPE CEILING AS}}$

INTERIOR

CEILING MOUNTED

VINYL SCRIM CLG -

LIGHT FIXTURE

REVISIONS	8	
No.	Description	Date
1	IFC SET ASI 004	03.15.24
2 3	RFI #214	08.07.24
PROJECT I		20019
SSUE DAT	E	03/15/2024
	THE AMBLE	E
SSUE		
	IFC SET	
SHEET TIT		
	UNIT PLAN - ROOM STANI LEVEL 01	-

TOWN STAMP

359

DESIGN

3630 OSAGE STREET DENVER, CO 80211 720.512.3437


B-2465

12/15/2023

SED ARCH

U

q

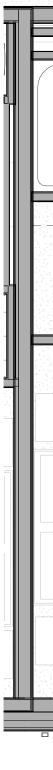





UNIT 106

2





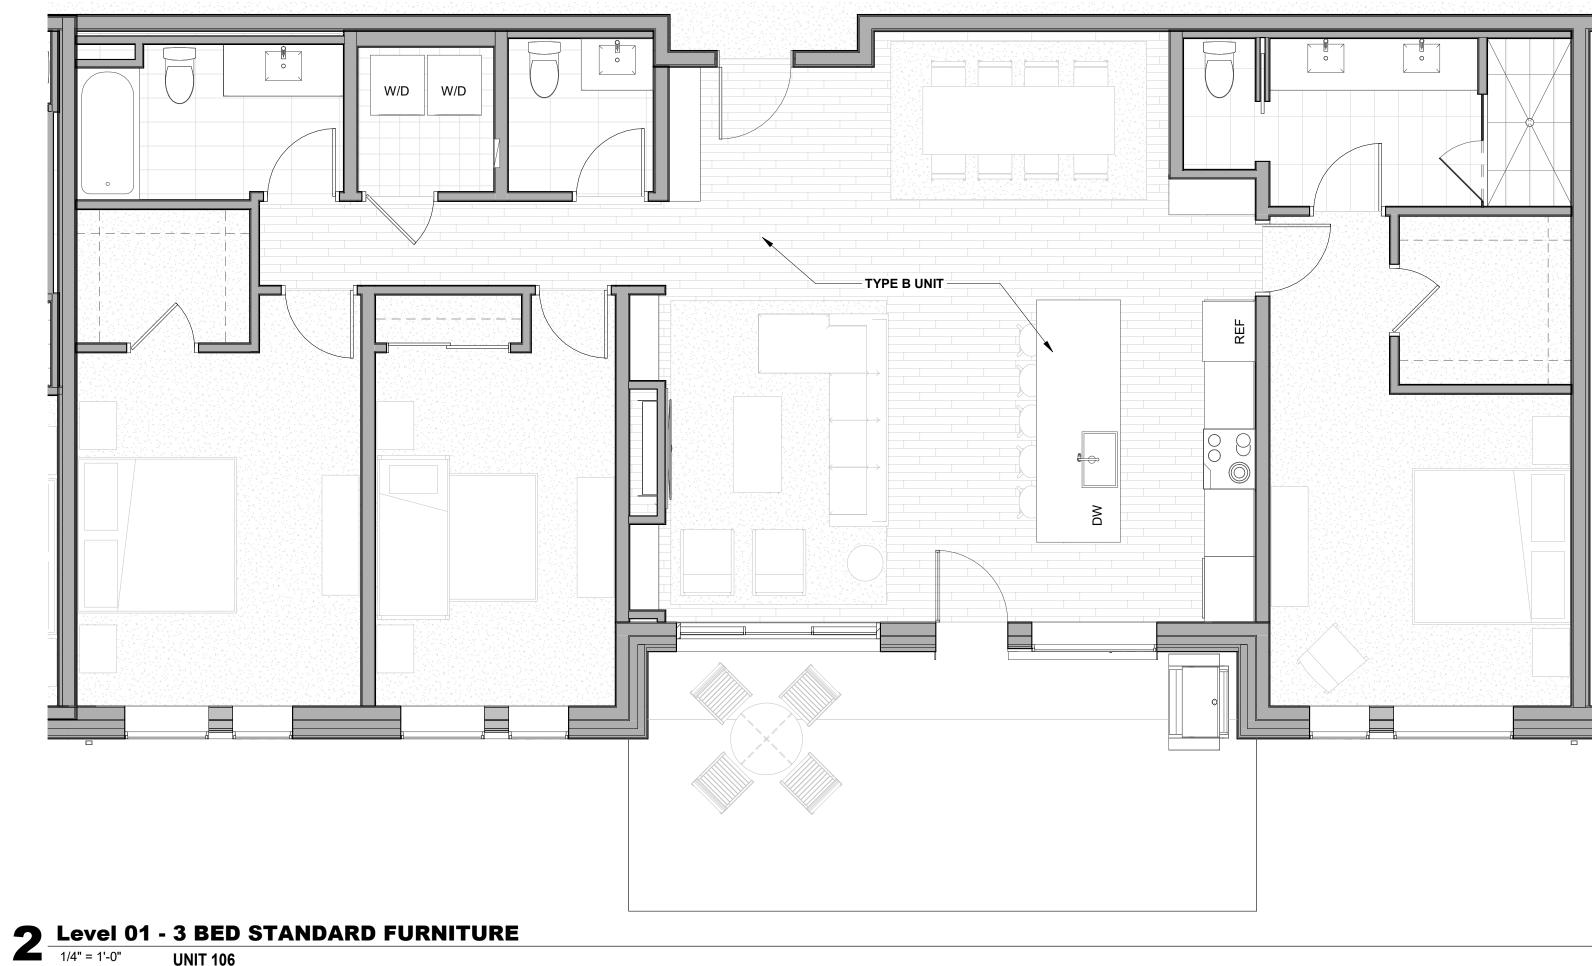

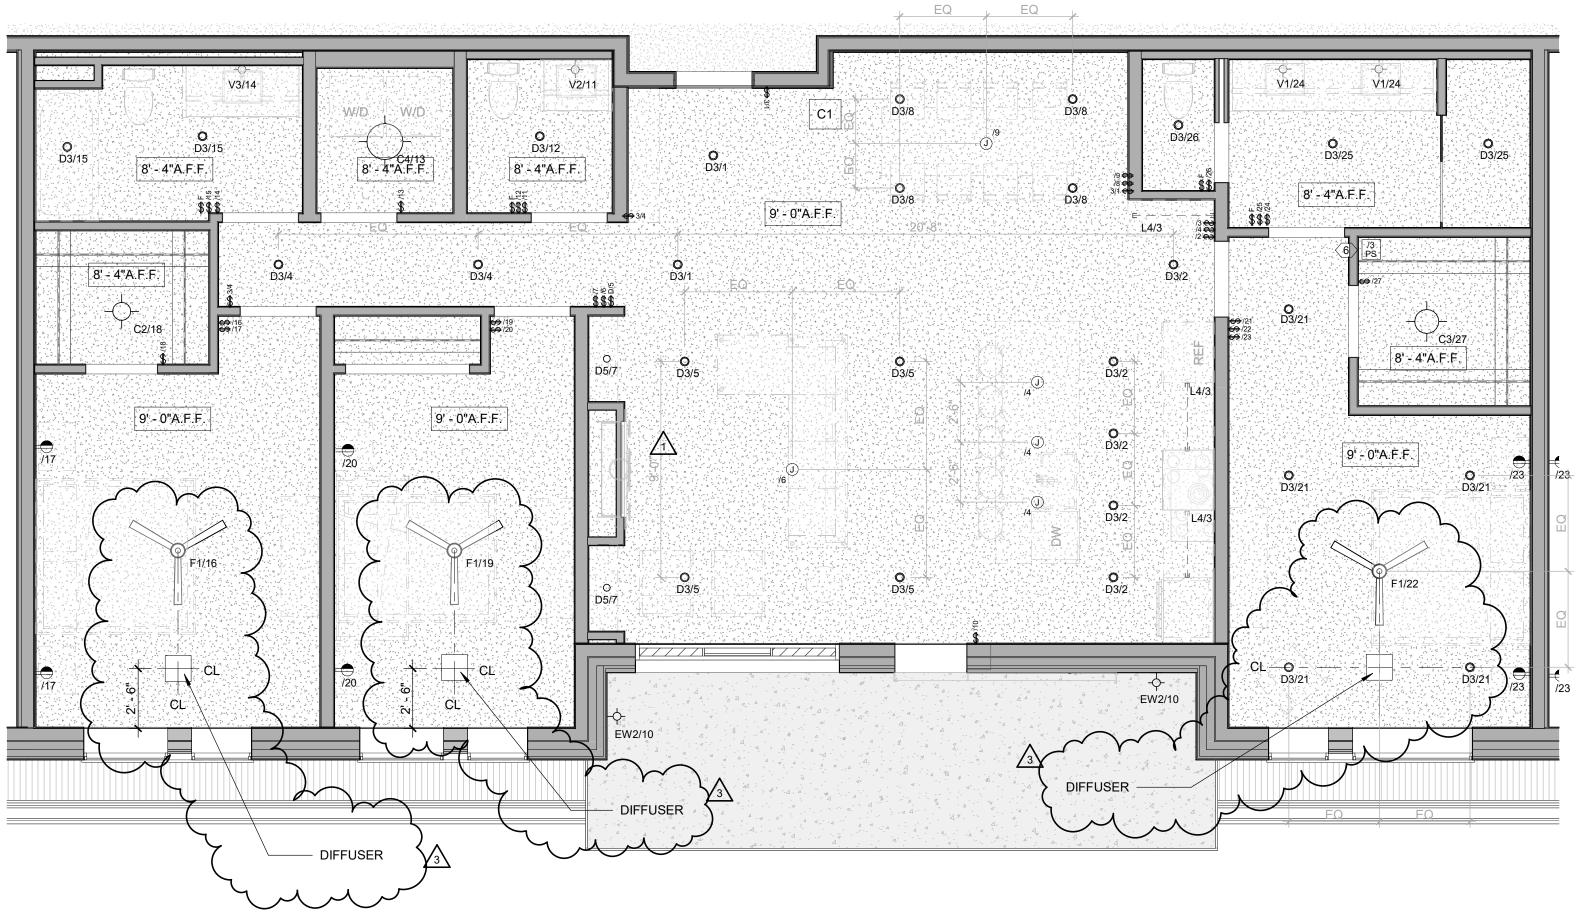


Level 01 - 3 BED STANDARD RCP

UNIT 106 2

ENLARGED FLOOR PLAN - GENERAL NOTES

- REFER TO G0.2X SHEETS FOR EXTERIOR AND INTERIOR BUILDING ENCLOSURE ASSEMBLIES.
- REFER TO A1.0X SHEETS FOR EXTERIOR WALL, DEMISING WALL, AND CORRIDOR WALL TYPES AND LOCATIONS. REFER TO A1.1X SHEETS FOR INTERIOR AND EXTERIOR
- WINDOW/DOOR TAGS WITH UNIT BACKGROUNDS FOR REFERENCE. ALIGN WALLS WHERE THEY APPEAR TO ALIGN, U.N.O.
- THE INSIDE FACE OF DOOR JAMBS SHALL BE 4" FROM ADJACENT WALL OR FINISHED COLUMN, U.N.O.
- PROVIDE BLOCKING FOR ALL WALL MOUNTED EQUIPMENT
- AND ACCESSORIES. THE CENTERLINE OF ALL RESIDENTIAL TOILETS SHALL BE
- LOCATED 18" OFF OF FINISH FACE OF WALL, U.N.O. SWING CLEARANCE AT UNIT ENTRY SHALL BE 18" MIN.
- FROM FINISH FACE OF ADJACENT SURFACE. ALL DIMENSIONS ARE TO FACE OF STUD, GRID LINE, OR
- FACE OF CONCRETE, U.N.O. 10. WHERE "CLEAR" IS CALLED OUT ON A DIMENSION, PROVIDE DIMENSION FROM FACE OF FINISH TO FACE OF
- FINISH. 11. FURNITURE IS NOT IN CONTRACT, U.N.O., AND IS SHOWN FOR DIAGRAMATIC PURPOSES ONLY.
- 12. CONSULTANT MODELS SHOWN FOR REFERENCE ONLY.

ENLARGED FLOOR PLAN - LEGEND

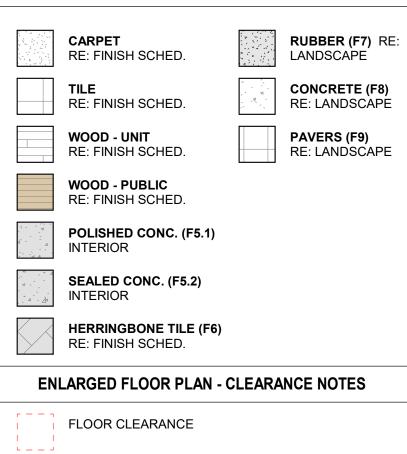

- A DOOR CLEARANCE, 54" X 60"
- B APPLIANCE CLEARANCE, 30" X 48"
- C CLEAR FLOOR CLEARANCE, 30" X 48"
- D VANITY CLEARANCE, 30" X 48"
- E TOILET CLEARANCE, 48" X 56" OR ADA 60" X 56"
- F SHOWER/TUB CLEARANCE, 30" X 48" (B)
- G TURN AROUND CLEARANCE
- GRAB BAR BLOCKING REQ. AT TOILET WALL WHERE APPLICABLE

ENLARGED RCP - GENERAL NOTES

- ALL UNIT CEILINGS SHALL BE 9' 0" A.F.F. U.N.O. REFER TO ENLARGED RCP'S FOR COMMON AREA CEILING HEIGHTS.
- IN THE CASE OF MINOR DISCREPANCIES BETWEEN MEP AND ARCHITECTURAL DOCUMENTS ON THE LOCATION OF CEILING MOUNTED COMPONENTS, THE ARCHITECTURAL RCP'S GOVERN. IN THE CASE OF MAJOR DISCREPANCIES, THE ARCHITECT SHALL BE NOTIFIED AS SOON AS THE DISCREPANCY IS DISCOVERED PRIOR TO PROCEEDING WITH THE WORK.
- REFERENCE MECHANICAL AND ELECTRICAL DRAWINGS FOR MOUNTING LOCATIONS OF ITEMS WHERE NO CEILING IS REQUIRED OR INDICATED.
- COORDINATE ALL TRADES INVOLVED IN THE CEILING WORK TO ENSURE CLEARANCE FOR FIXTURES, DUCTS, PIPING, CEILING SUSPENSION SYSTEMS, ETC. NECESSARY TO MAINTAIN CEILING HEIGHTS NOTED.
- LIGHTS, DIFFUSERS, EXIT SIGNS, SMOKE DETECTORS, SPEAKERS, STROBES, AND MISC. DEVICES SHALL BE CENTERED IN THE CEILING WHERE THEY OCCUR, U.N.O.
- FIRE PROTECTION SCOPE SHALL BE DESIGN-BUILD. ALL CORRIDOR SPRINKLER HEADS SHALL BE ALIGNED IN THE SAME LOCATION PARALLEL TO THE WALL WITHIN EACH SPECIFIC CEILING CONSTRUCTION.
- SMOKE ALARMS SHALL BE PROVIDED IN ALL BEDROOMS, OUTSIDE OF ALL BEDROOMS, AND ON EACH FLOOR AS REQUIRED. CARBON MONOXIDE DETECTORS SHALL BE INSTALLED OUTSIDE OF ALL BEDROOMS. SMOKE ALARMS AND CO DETECTORS SHALL BE HARDWIRED AND HAVE BATTERY BACKUP.
- ACCESS DOOR LOCATIONS IN GYPSUM BOARD CEILINGS ARE INDICATED ON RCP'S ONLY WHERE ARCHITECTURALLY SIGNIFICANT. REFERENCE SPECIFICATIONS AND MEP DRAWINGS FOR OTHER
- ACCESS DOOR LOCATIONS. UNLESS PREFINISHED TO MATCH ADJACENT SURFACE, PAINT MECHANICAL GRILLS, DIFFUSERS, ACCESS PANELS, AND OTHER EQUIPMENT TO MATCH ADJACENT SURFACE.
- 10. EXIT SIGNS ARE SHOWN ON RCP'S ONLY WHERE LOCATIONS ARE ARCHITECTURALLY SIGNIFICANT. 1. PROVIDE UL-CLASSIFIED LIGHT FIXTURES OR
- ENCLOSURES IN RATED FLOOR/CEILING ASSEMBLIES IN ACCORDANCE WITH IBC CHAPTER 7. 12. REFER TO LIGHTING PLANS FOR EXACT FIXTURE TYPES AND LOCATIONS. FIXTURES SHOWN HERE ARE
- REFERENCED AND SHOWN FOR GENERAL ALIGNMENT.

GWB (C1) INTERIOR	\rightarrow	SLOPE CEILING AS NOTED
T&G CEILING (C2) INTERIOR	0	CEILING MOUNTED LIGHT FIXTURE
FIBER-CEMENT SOFFIT (C3) - EXTERIOR	+ + + + + + + + + + + + + + + + + + + +	VINYL SCRIM CLG - Interior
ACCESS PANEL		ACCOUSTIC VINYL TILE CLG - INTERIOR

	TOWN ST	5 C I G N)
TON B	12/15/2	01000 0000 00000 00000 00000 00000 00000 00000 00000 00000 00000 0	
i	The Amble	Steamboat Springs, CO	
2 A3 3 Ri 		06 08 10 10 10 10 10 10 10 10 10 10 10 10 10	Date 14.24 16.24 1
SHEET TITLE	IFC S	ET AN - 3 TANDA L 01	




 \wedge



2 Level 02 - 3 BEDROOM STANDARD TYPE A - FINISH 1/4" = 1'-0" UNIT 206

UNIT 206 4

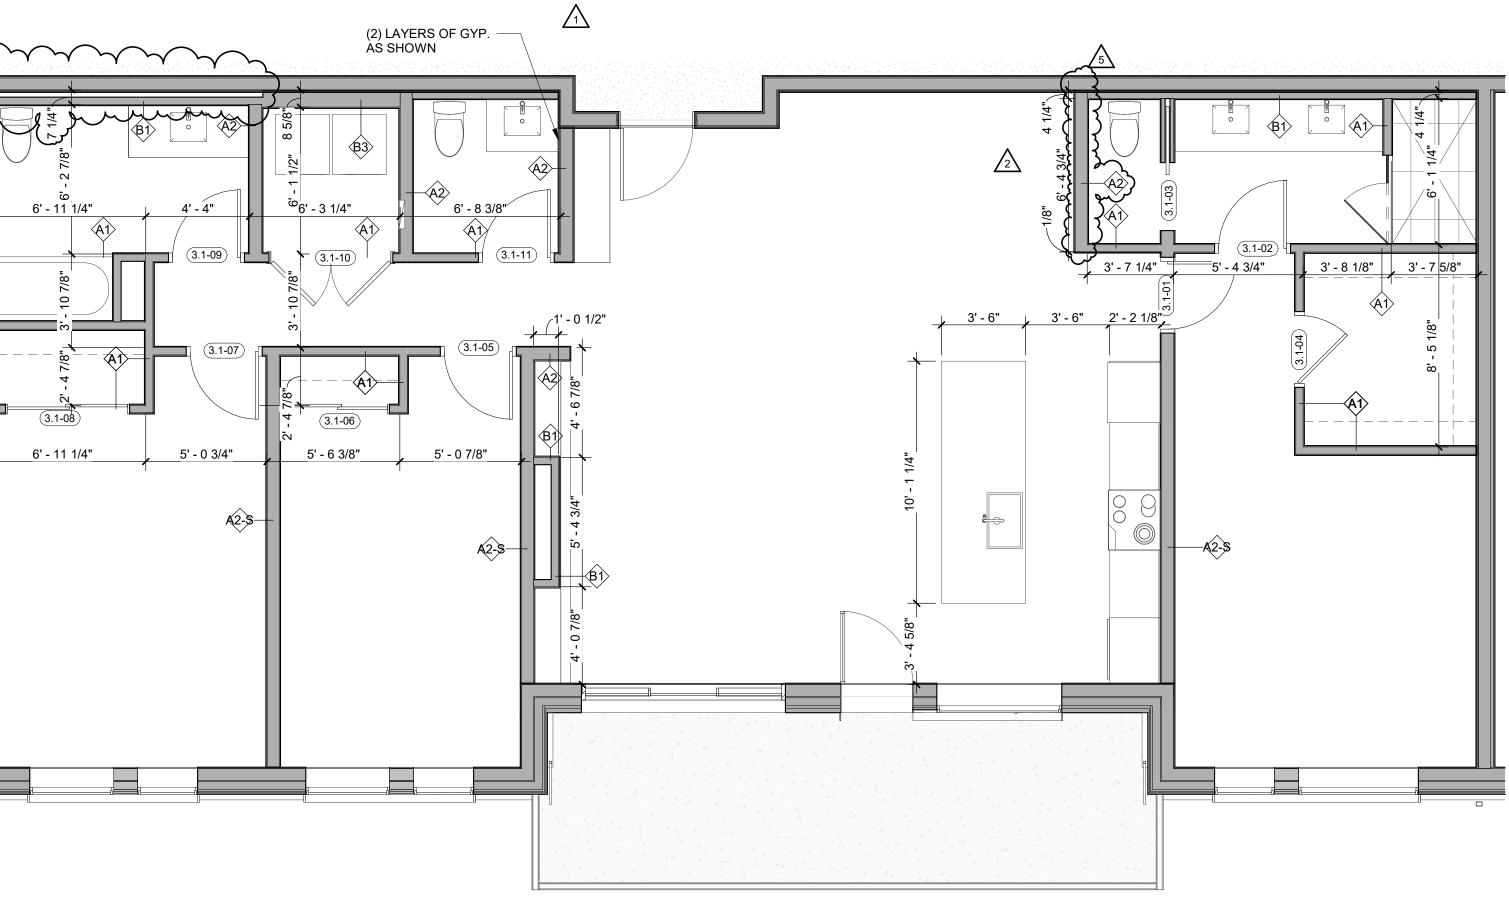

 Level 02 - 3 BEDROOM STANDARD TYPE A - DIMENSION

 1/4" = 1'-0"
 UNIT 206
 UNIT 206

ENLARGED FLOOR PLAN - GENERAL NOTES

- REFER TO G0.2X SHEETS FOR EXTERIOR AND INTERIOR BUILDING ENCLOSURE ASSEMBLIES. REFER TO A1.0X SHEETS FOR EXTERIOR WALL, DEMISING WALL, AND CORRIDOR WALL TYPES AND LOCATIONS.
- REFER TO A1.1X SHEETS FOR INTERIOR AND EXTERIOR WINDOW/DOOR TAGS WITH UNIT BACKGROUNDS FOR REFERENCE.
- ALIGN WALLS WHERE THEY APPEAR TO ALIGN, U.N.O. THE INSIDE FACE OF DOOR JAMBS SHALL BE 4" FROM
- ADJACENT WALL OR FINISHED COLUMN, U.N.O. PROVIDE BLOCKING FOR ALL WALL MOUNTED EQUIPMENT AND ACCESSORIES.
- THE CENTERLINE OF ALL RESIDENTIAL TOILETS SHALL BE LOCATED 18" OFF OF FINISH FACE OF WALL, U.N.O.
- SWING CLEARANCE AT UNIT ENTRY SHALL BE 18" MIN.
- FROM FINISH FACE OF ADJACENT SURFACE. ALL DIMENSIONS ARE TO FACE OF STUD, GRID LINE, OR
- FACE OF CONCRETE, U.N.O. 10. WHERE "CLEAR" IS CALLED OUT ON A DIMENSION, PROVIDE DIMENSION FROM FACE OF FINISH TO FACE OF
- FINISH. 11. FURNITURE IS NOT IN CONTRACT, U.N.O., AND IS SHOWN
- FOR DIAGRAMATIC PURPOSES ONLY. 12. CONSULTANT MODELS SHOWN FOR REFERENCE ONLY.

ENLARGED FLOOR PLAN - LEGEND

	CARPET RE: FINISH SCHED.		RUBBER (F7) RE: LANDSCAPE
	TILE RE: FINISH SCHED.		CONCRETE (F8) RE: LANDSCAPE
	WOOD - UNIT RE: FINISH SCHED.		PAVERS (F9) RE: LANDSCAPE
	WOOD - PUBLIC RE: FINISH SCHED.		
d - d	POLISHED CONC. (F5.1) INTERIOR		
	SEALED CONC. (F5.2) INTERIOR		
	HERRINGBONE TILE (F6) RE: FINISH SCHED.		
ENL	ARGED FLOOR PLAN - CL	EARANC	E NOTES


- FLOOR CLEARANCE
- A DOOR CLEARANCE, 54" X 60"
- B APPLIANCE CLEARANCE, 30" X 48"
- C CLEAR FLOOR CLEARANCE, 30" X 48"
- D VANITY CLEARANCE, 30" X 48"
- E TOILET CLEARANCE, 48" X 56" OR ADA 60" X 56" \triangle
- F SHOWER/TUB CLEARANCE, 30" X 48" (B) G TURN AROUND CLEARANCE
- GRAB BAR BLOCKING REQ. AT TOILET WALL WHERE APPLICABLE


ENLARGED RCP - GENERAL NOTES


- ALL UNIT CEILINGS SHALL BE 9' 0" A.F.F. U.N.O. REFER TO ENLARGED RCP'S FOR COMMON AREA CEILING HEIGHTS.
- IN THE CASE OF MINOR DISCREPANCIES BETWEEN MEP AND ARCHITECTURAL DOCUMENTS ON THE LOCATION OF CEILING MOUNTED COMPONENTS, THE ARCHITECTURAL RCP'S GOVERN. IN THE CASE OF MAJOR DISCREPANCIES, THE ARCHITECT SHALL BE NOTIFIED AS SOON AS THE DISCREPANCY IS DISCOVERED PRIOR TO PROCEEDING WITH THE WORK.
- REFERENCE MECHANICAL AND ELECTRICAL DRAWINGS FOR MOUNTING LOCATIONS OF ITEMS WHERE NO CEILING IS REQUIRED OR INDICATED.
- COORDINATE ALL TRADES INVOLVED IN THE CEILING WORK TO ENSURE CLEARANCE FOR FIXTURES, DUCTS, PIPING, CEILING SUSPENSION SYSTEMS, ETC. NECESSARY TO MAINTAIN CEILING HEIGHTS NOTED.
- LIGHTS, DIFFUSERS, EXIT SIGNS, SMOKE DETECTORS, SPEAKERS, STROBES, AND MISC. DEVICES SHALL BE CENTERED IN THE CEILING WHERE THEY OCCUR, U.N.O. FIRE PROTECTION SCOPE SHALL BE DESIGN-BUILD. ALL
- CORRIDOR SPRINKLER HEADS SHALL BE ALIGNED IN THE SAME LOCATION PARALLEL TO THE WALL WITHIN EACH SPECIFIC CEILING CONSTRUCTION. SMOKE ALARMS SHALL BE PROVIDED IN ALL BEDROOMS,
- OUTSIDE OF ALL BEDROOMS, AND ON EACH FLOOR AS REQUIRED. CARBON MONOXIDE DETECTORS SHALL BE INSTALLED OUTSIDE OF ALL BEDROOMS. SMOKE ALARMS AND CO DETECTORS SHALL BE HARDWIRED AND HAVE BATTERY BACKUP.
- ACCESS DOOR LOCATIONS IN GYPSUM BOARD CEILINGS ARE INDICATED ON RCP'S ONLY WHERE ARCHITECTURALLY SIGNIFICANT. REFERENCE SPECIFICATIONS AND MEP DRAWINGS FOR OTHER
- ACCESS DOOR LOCATIONS. UNLESS PREFINISHED TO MATCH ADJACENT SURFACE, PAINT MECHANICAL GRILLS, DIFFUSERS, ACCESS PANELS, AND OTHER EQUIPMENT TO MATCH ADJACENT SURFACE.
- 10. EXIT SIGNS ARE SHOWN ON RCP'S ONLY WHERE LOCATIONS ARE ARCHITECTURALLY SIGNIFICANT.
- 12 F

ROVIDE UL-CLASSIFIED LIGHT FIXTURES OR NCLOSURES IN RATED FLOOR/CEILING ASSEMBLIES IN CCORDANCE WITH IBC CHAPTER 7. EFER TO LIGHTING PLANS FOR EXACT FIXTURE TYPES ND LOCATIONS. FIXTURES SHOWN HERE ARE EFERENCED AND SHOWN FOR GENERAL ALIGNMENT.				
	ENLARGED RCP	- LEGENI	0	
× (,,_,, 2 ''' - , , -) - ,	GWB (C1) INTERIOR	\rightarrow	SLOPE CEILING AS NOTED	
	T&G CEILING (C2) INTERIOR	0	CEILING MOUNTED LIGHT FIXTURE	
	FIBER-CEMENT SOFFIT (C3) - EXTERIOR	+ + + + + + + + + + + + + + + + + + + +	VINYL SCRIM CLG - INTERIOR	
	ACCESS PANEL		ACOUSTIC VINYL TILE CLG - INTERIOR	

	TOWN ST 555 555 563 5630 OSAGE DENVER, CC 720, 512, 3	9 IGN	
	12/15/20	NINS 65 D23 ACHITE	
	The Amble	Steamboat Springs, CO	
2 F 3 / / 4 / 5 F 5 F 	THE AN IFC S	03.1 06.2 07.2 08.0 11.1 03/1 03/1 NBLE	4.24 5.24 7.24
BEDR TYP	NIT PL ROOM S E A - LE	TANDA Evels (02

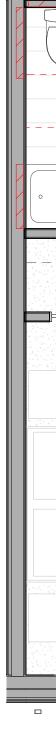

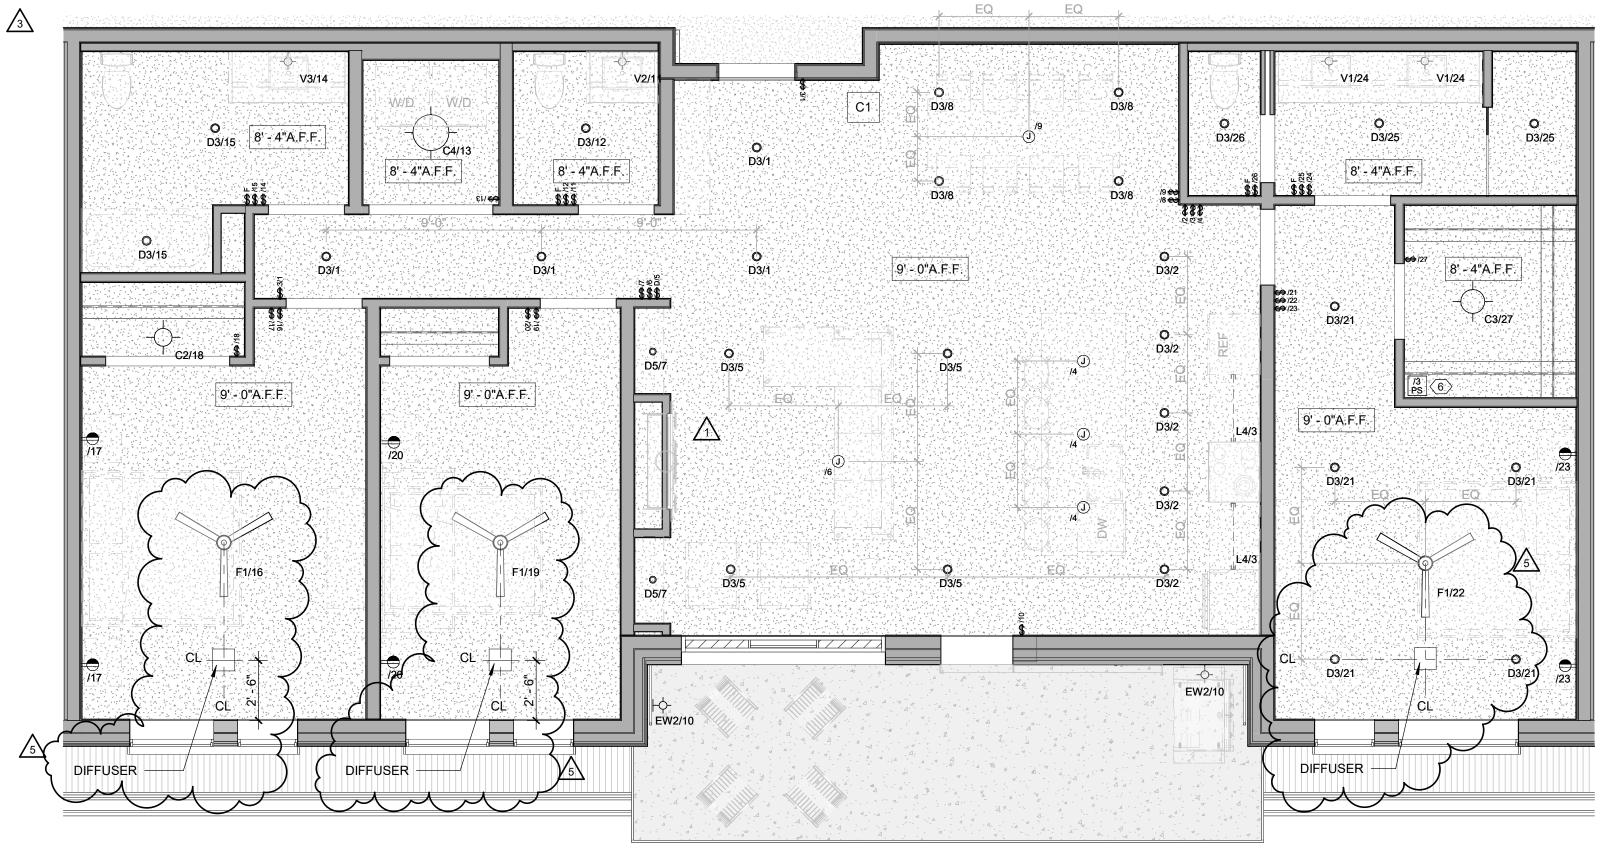

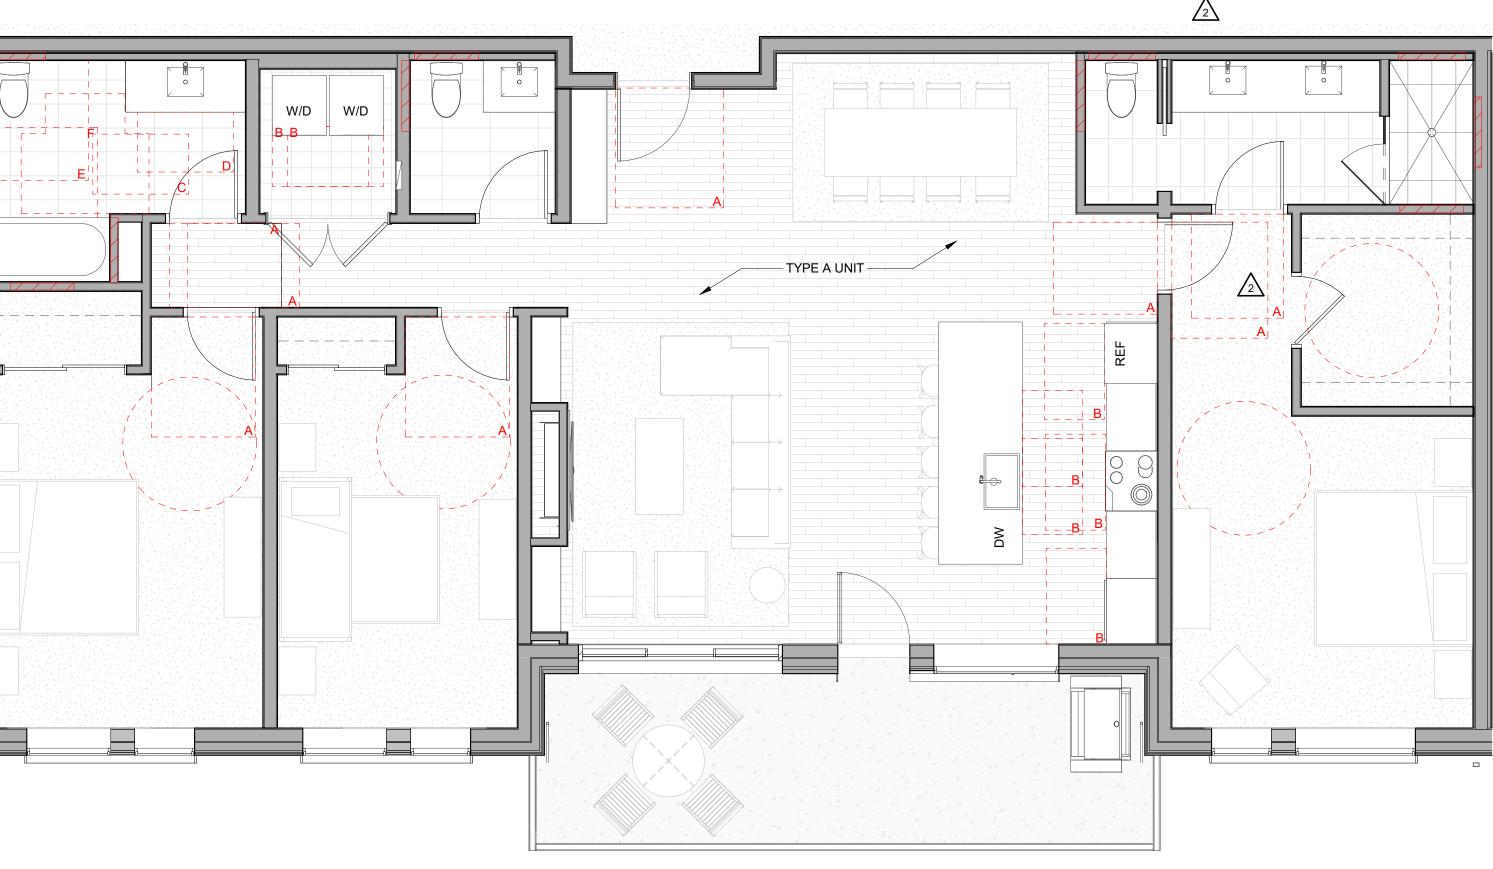


2 Level 02 - 3 BEDROOM STANDARD TYPE A - FURNITURE 1/4" = 1'-0" UNIT 206 **UNIT 206**

Level 02 - 3 BEDROOM STANDARD TYPE A - RCP 1/4" = 1'-0" UNIT 206

UNIT 206

- REFER TO G0.2X SHEETS FOR EXTERIOR AND INTERIOR
- BUILDING ENCLOSURE ASSEMBLIES. REFER TO A1.0X SHEETS FOR EXTERIOR WALL, DEMISING WALL, AND CORRIDOR WALL TYPES AND LOCATIONS.
- REFER TO A1.1X SHEETS FOR INTERIOR AND EXTERIOR WINDOW/DOOR TAGS WITH UNIT BACKGROUNDS FOR REFERENCE.
- ALIGN WALLS WHERE THEY APPEAR TO ALIGN, U.N.O. THE INSIDE FACE OF DOOR JAMBS SHALL BE 4" FROM
- ADJACENT WALL OR FINISHED COLUMN, U.N.O. PROVIDE BLOCKING FOR ALL WALL MOUNTED EQUIPMENT
- AND ACCESSORIES.
- THE CENTERLINE OF ALL RESIDENTIAL TOILETS SHALL BE LOCATED 18" OFF OF FINISH FACE OF WALL, U.N.O.
- SWING CLEARANCE AT UNIT ENTRY SHALL BE 18" MIN. FROM FINISH FACE OF ADJACENT SURFACE.
- ALL DIMENSIONS ARE TO FACE OF STUD, GRID LINE, OR FACE OF CONCRETE, U.N.O. 10. WHERE "CLEAR" IS CALLED OUT ON A DIMENSION,
- PROVIDE DIMENSION FROM FACE OF FINISH TO FACE OF FINISH.
- 11. FURNITURE IS NOT IN CONTRACT, U.N.O., AND IS SHOWN FOR DIAGRAMATIC PURPOSES ONLY. 12. CONSULTANT MODELS SHOWN FOR REFERENCE ONLY.

ENLARGED FLOOR PLAN - LEGEND

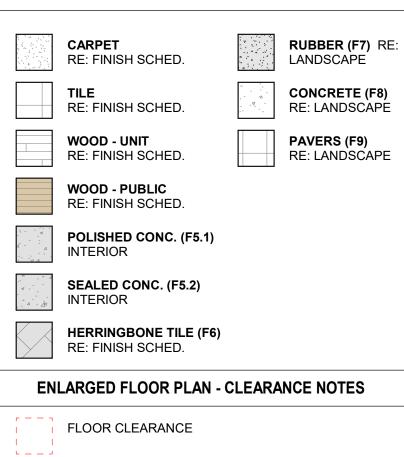

- A DOOR CLEARANCE, 54" X 60"
- B APPLIANCE CLEARANCE, 30" X 48"
- C CLEAR FLOOR CLEARANCE, 30" X 48"
- D VANITY CLEARANCE, 30" X 48"
- E TOILET CLEARANCE, 48" X 56" OR ADA 60" X 56"
- F SHOWER/TUB CLEARANCE, 30" X 48" (B)
- G TURN AROUND CLEARANCE
- GRAB BAR BLOCKING REQ. AT TOILET WALL WHERE APPLICABLE

ENLARGED RCP - GENERAL NOTES


- ALL UNIT CEILINGS SHALL BE 9' 0" A.F.F. U.N.O. REFER TO ENLARGED RCP'S FOR COMMON AREA CEILING HEIGHTS.
- IN THE CASE OF MINOR DISCREPANCIES BETWEEN MEP AND ARCHITECTURAL DOCUMENTS ON THE LOCATION OF CEILING MOUNTED COMPONENTS, THE ARCHITECTURAL RCP'S GOVERN. IN THE CASE OF MAJOR DISCREPANCIES, THE ARCHITECT SHALL BE NOTIFIED AS SOON AS THE DISCREPANCY IS DISCOVERED PRIOR TO PROCEEDING WITH THE WORK.
- REFERENCE MECHANICAL AND ELECTRICAL DRAWINGS FOR MOUNTING LOCATIONS OF ITEMS WHERE NO CEILING IS REQUIRED OR INDICATED.
- COORDINATE ALL TRADES INVOLVED IN THE CEILING WORK TO ENSURE CLEARANCE FOR FIXTURES, DUCTS, PIPING, CEILING SUSPENSION SYSTEMS, ETC. NECESSARY TO MAINTAIN CEILING HEIGHTS NOTED.
- LIGHTS, DIFFUSERS, EXIT SIGNS, SMOKE DETECTORS, SPEAKERS, STROBES, AND MISC. DEVICES SHALL BE CENTERED IN THE CEILING WHERE THEY OCCUR, U.N.O.
- FIRE PROTECTION SCOPE SHALL BE DESIGN-BUILD. ALL CORRIDOR SPRINKLER HEADS SHALL BE ALIGNED IN THE SAME LOCATION PARALLEL TO THE WALL WITHIN EACH SPECIFIC CEILING CONSTRUCTION.
- SMOKE ALARMS SHALL BE PROVIDED IN ALL BEDROOMS, OUTSIDE OF ALL BEDROOMS, AND ON EACH FLOOR AS REQUIRED. CARBON MONOXIDE DETECTORS SHALL BE INSTALLED OUTSIDE OF ALL BEDROOMS. SMOKE ALARMS AND CO DETECTORS SHALL BE HARDWIRED AND HAVE BATTERY BACKUP.
- ACCESS DOOR LOCATIONS IN GYPSUM BOARD CEILINGS ARE INDICATED ON RCP'S ONLY WHERE ARCHITECTURALLY SIGNIFICANT. REFERENCE SPECIFICATIONS AND MEP DRAWINGS FOR OTHER
- ACCESS DOOR LOCATIONS. UNLESS PREFINISHED TO MATCH ADJACENT SURFACE, PAINT MECHANICAL GRILLS, DIFFUSERS, ACCESS PANELS, AND OTHER EQUIPMENT TO MATCH ADJACENT SURFACE.
- 10. EXIT SIGNS ARE SHOWN ON RCP'S ONLY WHERE LOCATIONS ARE ARCHITECTURALLY SIGNIFICANT. 1. PROVIDE UL-CLASSIFIED LIGHT FIXTURES OR
- ENCLOSURES IN RATED FLOOR/CEILING ASSEMBLIES IN ACCORDANCE WITH IBC CHAPTER 7. 12. REFER TO LIGHTING PLANS FOR EXACT FIXTURE TYPES AND LOCATIONS. FIXTURES SHOWN HERE ARE
- REFERENCED AND SHOWN FOR GENERAL ALIGNMENT.

ENLARGED RCP - LEGEND

GWB (C1) INTERIOR	\rightarrow	SLOPE CEILING AS NOTED
 T&G CEILING (C2) INTERIOR	0	CEILING MOUNTED LIGHT FIXTURE
FIBER-CEMENT SOFFIT (C3) - EXTERIOR	+ + + + + + + + + + + + + + + + + + + +	VINYL SCRIM CLG - Interior
ACCESS PANEL		ACCOUSTIC VINYL TILE CLG - INTERIOF


35 D E S	STAMP
BRUCE BRUCE	COLOR 1000 1000 1000 1000 1000 1000 1000 10
The Amble	Steamboat Springs, CO
EVISIONS No. Descr RFI #110 RFI #119 ASI 001 ASI 004 RFI #223.1	biption Date 06.14.24 06.24.24 07.26.24 06.07.24 08.07.24 01.16.24
ROJECT NUMBER ISSUE DATE	20019 03/15/2024
IFC	MBLE SET

A4.06.4

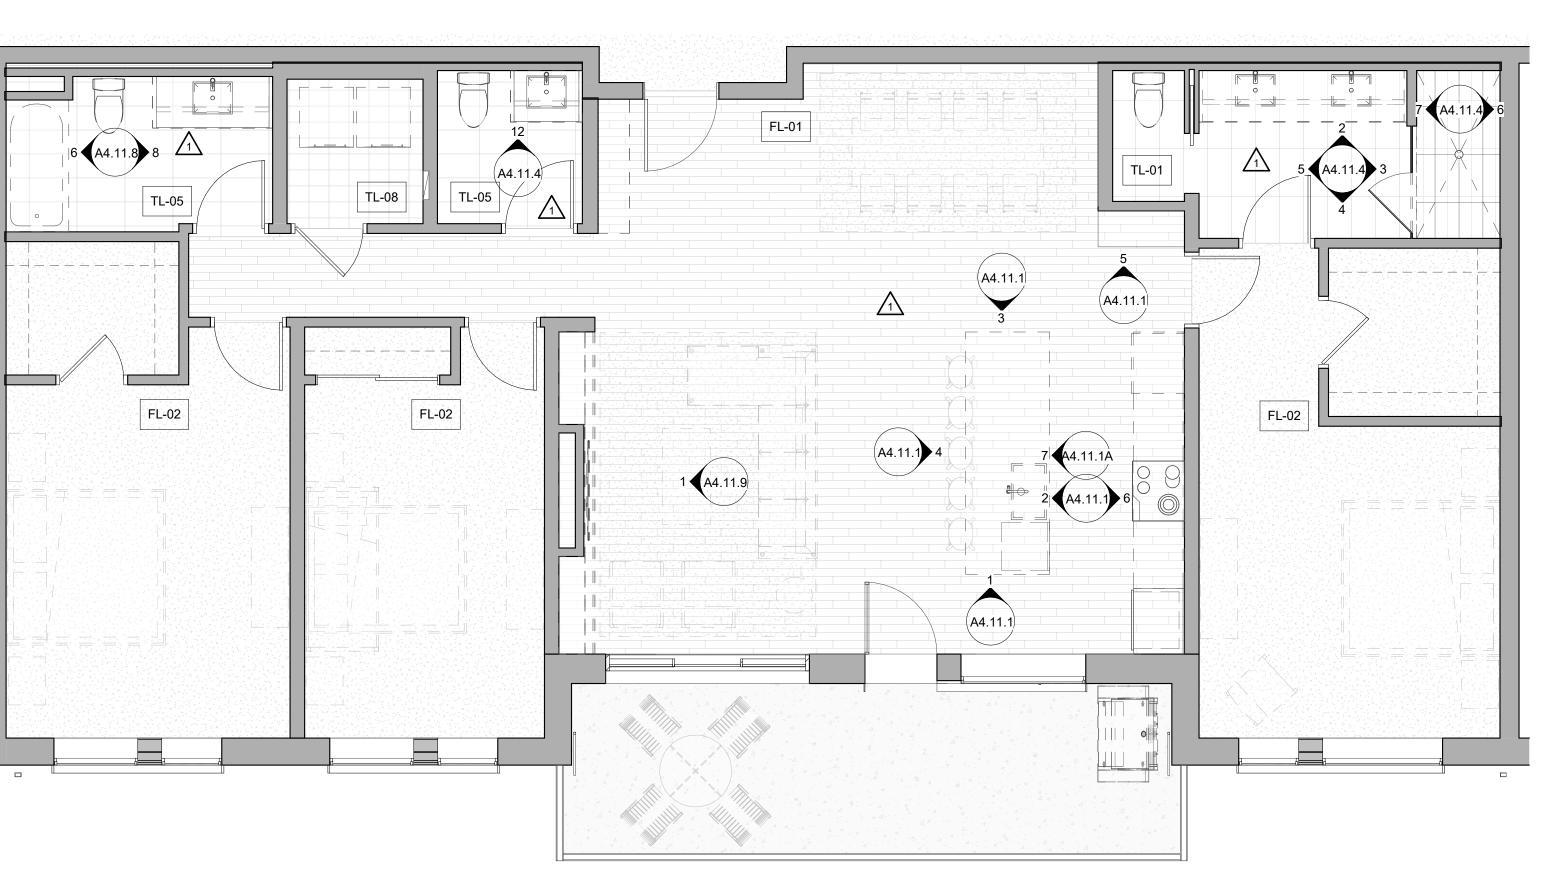

2 Level 03 - 3 BEDROOM STANDARD-FINISH 1/4" = 1'-0" UNIT 306

UNIT 306 2

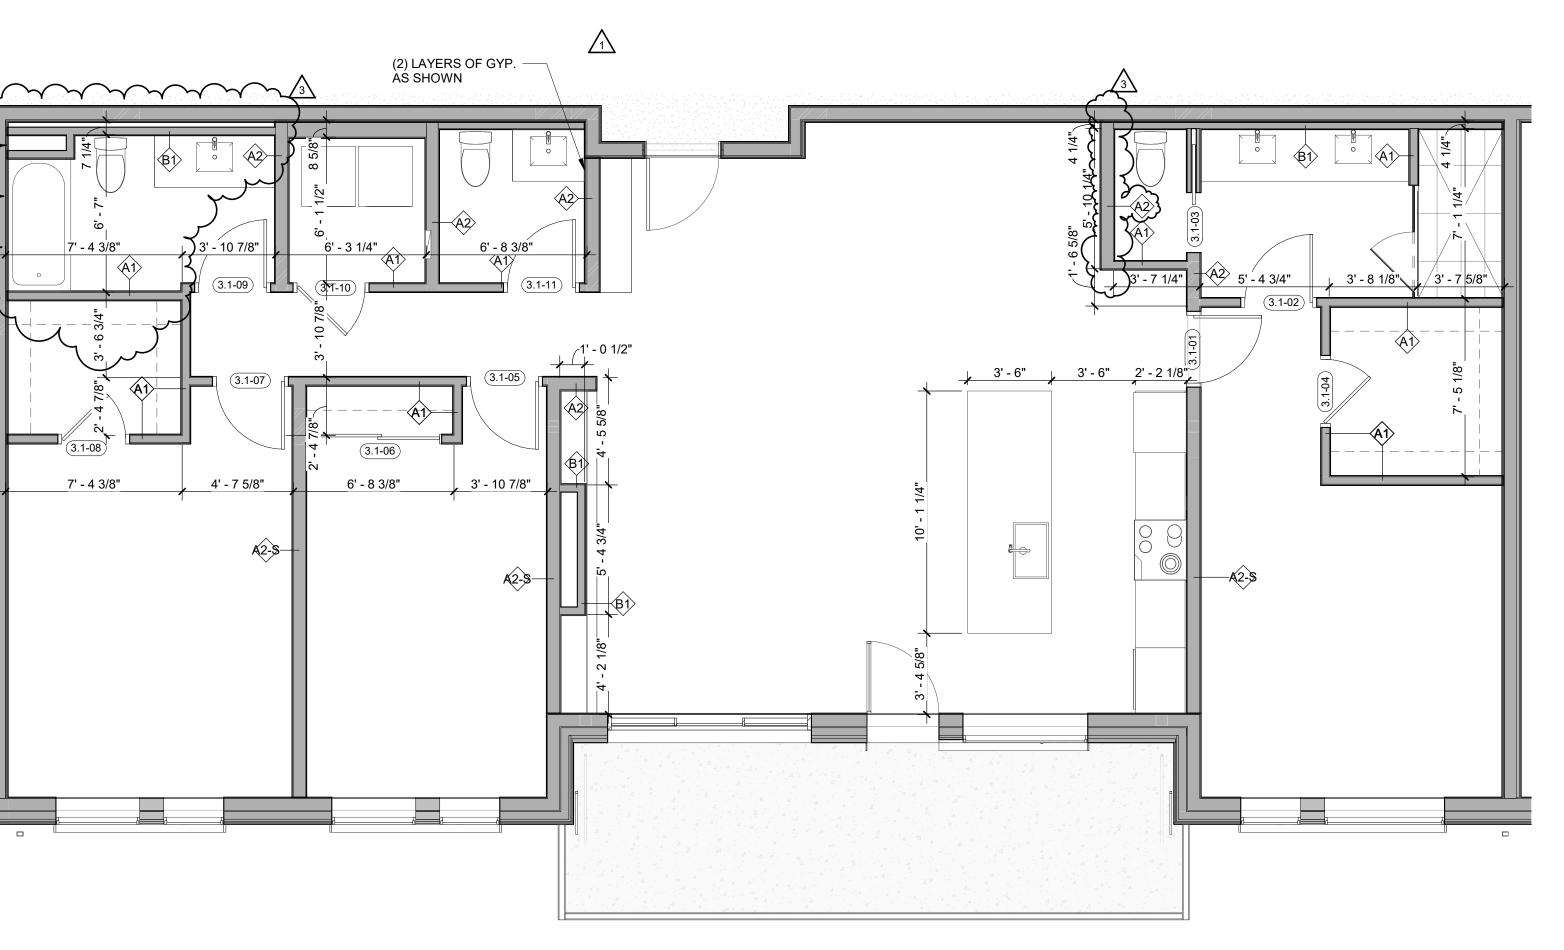


Level 03 - 3 BEDROOM STANDARD-DIMENSION 1/4" = 1'-0"
UNIT 306

UNIT 306 2

ENLARGED FLOOR PLAN - GENERAL NOTES

- REFER TO G0.2X SHEETS FOR EXTERIOR AND INTERIOR BUILDING ENCLOSURE ASSEMBLIES. REFER TO A1.0X SHEETS FOR EXTERIOR WALL, DEMISING WALL, AND CORRIDOR WALL TYPES AND LOCATIONS.
- REFER TO A1.1X SHEETS FOR INTERIOR AND EXTERIOR WINDOW/DOOR TAGS WITH UNIT BACKGROUNDS FOR REFERENCE.
- ALIGN WALLS WHERE THEY APPEAR TO ALIGN, U.N.O. THE INSIDE FACE OF DOOR JAMBS SHALL BE 4" FROM ADJACENT WALL OR FINISHED COLUMN, U.N.O.
- PROVIDE BLOCKING FOR ALL WALL MOUNTED EQUIPMENT AND ACCESSORIES.
- THE CENTERLINE OF ALL RESIDENTIAL TOILETS SHALL BE LOCATED 18" OFF OF FINISH FACE OF WALL, U.N.O.
- SWING CLEARANCE AT UNIT ENTRY SHALL BE 18" MIN. FROM FINISH FACE OF ADJACENT SURFACE.
- ALL DIMENSIONS ARE TO FACE OF STUD, GRID LINE, OR
- FACE OF CONCRETE, U.N.O. 10. WHERE "CLEAR" IS CALLED OUT ON A DIMENSION, PROVIDE DIMENSION FROM FACE OF FINISH TO FACE OF
- FINISH. 11. FURNITURE IS NOT IN CONTRACT, U.N.O., AND IS SHOWN
- FOR DIAGRAMATIC PURPOSES ONLY.
- 12. CONSULTANT MODELS SHOWN FOR REFERENCE ONLY.

ENLARGED FLOOR PLAN - LEGEND

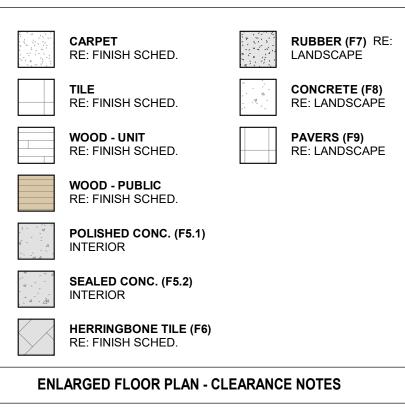


- FLOOR CLEARANCE
- A DOOR CLEARANCE, 54" X 60"
- B APPLIANCE CLEARANCE, 30" X 48"
- C CLEAR FLOOR CLEARANCE, 30" X 48"
- D VANITY CLEARANCE, 30" X 48" E TOILET CLEARANCE, 48" X 56" OR ADA 60" X 56"
- F SHOWER/TUB CLEARANCE, 30" X 48" (B) \bigtriangleup
- G TURN AROUND CLEARANCE
- GRAB BAR BLOCKING REQ. AT TOILET
- WALL WHERE APPLICABLE

ENLARGED RCP - GENERAL NOTES


- ALL UNIT CEILINGS SHALL BE 9' 0" A.F.F. U.N.O. REFER TO ENLARGED RCP'S FOR COMMON AREA CEILING HEIGHTS.
- IN THE CASE OF MINOR DISCREPANCIES BETWEEN MEP AND ARCHITECTURAL DOCUMENTS ON THE LOCATION OF CEILING MOUNTED COMPONENTS, THE ARCHITECTURAL RCP'S GOVERN. IN THE CASE OF MAJOR DISCREPANCIES, THE ARCHITECT SHALL BE NOTIFIED AS SOON AS THE DISCREPANCY IS DISCOVERED PRIOR TO PROCEEDING WITH THE WORK.
- REFERENCE MECHANICAL AND ELECTRICAL DRAWINGS FOR MOUNTING LOCATIONS OF ITEMS WHERE NO CEILING IS REQUIRED OR INDICATED.
- COORDINATE ALL TRADES INVOLVED IN THE CEILING WORK TO ENSURE CLEARANCE FOR FIXTURES, DUCTS, PIPING, CEILING SUSPENSION SYSTEMS, ETC. NECESSARY TO MAINTAIN CEILING HEIGHTS NOTED.
- LIGHTS, DIFFUSERS, EXIT SIGNS, SMOKE DETECTORS, SPEAKERS, STROBES, AND MISC. DEVICES SHALL BE CENTERED IN THE CEILING WHERE THEY OCCUR, U.N.O. FIRE PROTECTION SCOPE SHALL BE DESIGN-BUILD. ALL
- CORRIDOR SPRINKLER HEADS SHALL BE ALIGNED IN THE SAME LOCATION PARALLEL TO THE WALL WITHIN EACH SPECIFIC CEILING CONSTRUCTION. SMOKE ALARMS SHALL BE PROVIDED IN ALL BEDROOMS,
- OUTSIDE OF ALL BEDROOMS, AND ON EACH FLOOR AS REQUIRED. CARBON MONOXIDE DETECTORS SHALL BE INSTALLED OUTSIDE OF ALL BEDROOMS. SMOKE ALARMS AND CO DETECTORS SHALL BE HARDWIRED AND HAVE BATTERY BACKUP.
- ACCESS DOOR LOCATIONS IN GYPSUM BOARD CEILINGS ARE INDICATED ON RCP'S ONLY WHERE ARCHITECTURALLY SIGNIFICANT. REFERENCE SPECIFICATIONS AND MEP DRAWINGS FOR OTHER
- ACCESS DOOR LOCATIONS. UNLESS PREFINISHED TO MATCH ADJACENT SURFACE, PAINT MECHANICAL GRILLS, DIFFUSERS, ACCESS PANELS, AND OTHER EQUIPMENT TO MATCH ADJACENT SURFACE.
- 10. EXIT SIGNS ARE SHOWN ON RCP'S ONLY WHERE LOCATIONS ARE ARCHITECTURALLY SIGNIFICANT.
- 11. PROVIDE UL-CLASSIFIED LIGHT FIXTURES OR ΕN AC 12. RE
- A١ RF


ICLOSURES IN RATED FLOOR/CEILING ASSEMBLIES IN CORDANCE WITH IBC CHAPTER 7. FER TO LIGHTING PLANS FOR EXACT FIXTURE TYPES ID LOCATIONS. FIXTURES SHOWN HERE ARE FERENCED AND SHOWN FOR GENERAL ALIGNMENT.			
	ENLARGED RCP	- LEGENI	ס
()_(2 - () -) - () - () - () - () - () - ()	GWB (C1) INTERIOR	\rightarrow	SLOPE CEILING AS NOTED
	T&G CEILING (C2) INTERIOR	0	CEILING MOUNTED LIGHT FIXTURE
	FIBER-CEMENT SOFFIT (C3) - EXTERIOR	+ + + + + + + + + + + + + + + + + + + +	VINYL SCRIM CLG - Interior
	ACCESS PANEL		ACOUSTIC VINYL TILE CLG - INTERIOR

BRSCE D. WINS B-2465 12/15/2023
The Amble Stamboat Springs, CO
REVISIONS No. Description Date 1 15.24 03.15.24 2 03.15.24 03.15.24 3 RFI #339 11.13.24 1 11.13.24 11.13.24 1 Description Date 2 RFI #339 11.13.24 1 Description Date 2 NFI #339 11.13.24 1 Description Date 2 NET 31.13.24 1 Description Date 2 NET 31.13.24 1 Description Date 2 NE 31.13.24 2 Description Date 2
SHEET TITLE UNIT PLAN - 3 BEDROOM STANDARD - LEVEL 03 SHEET NO.

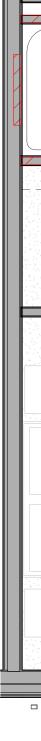




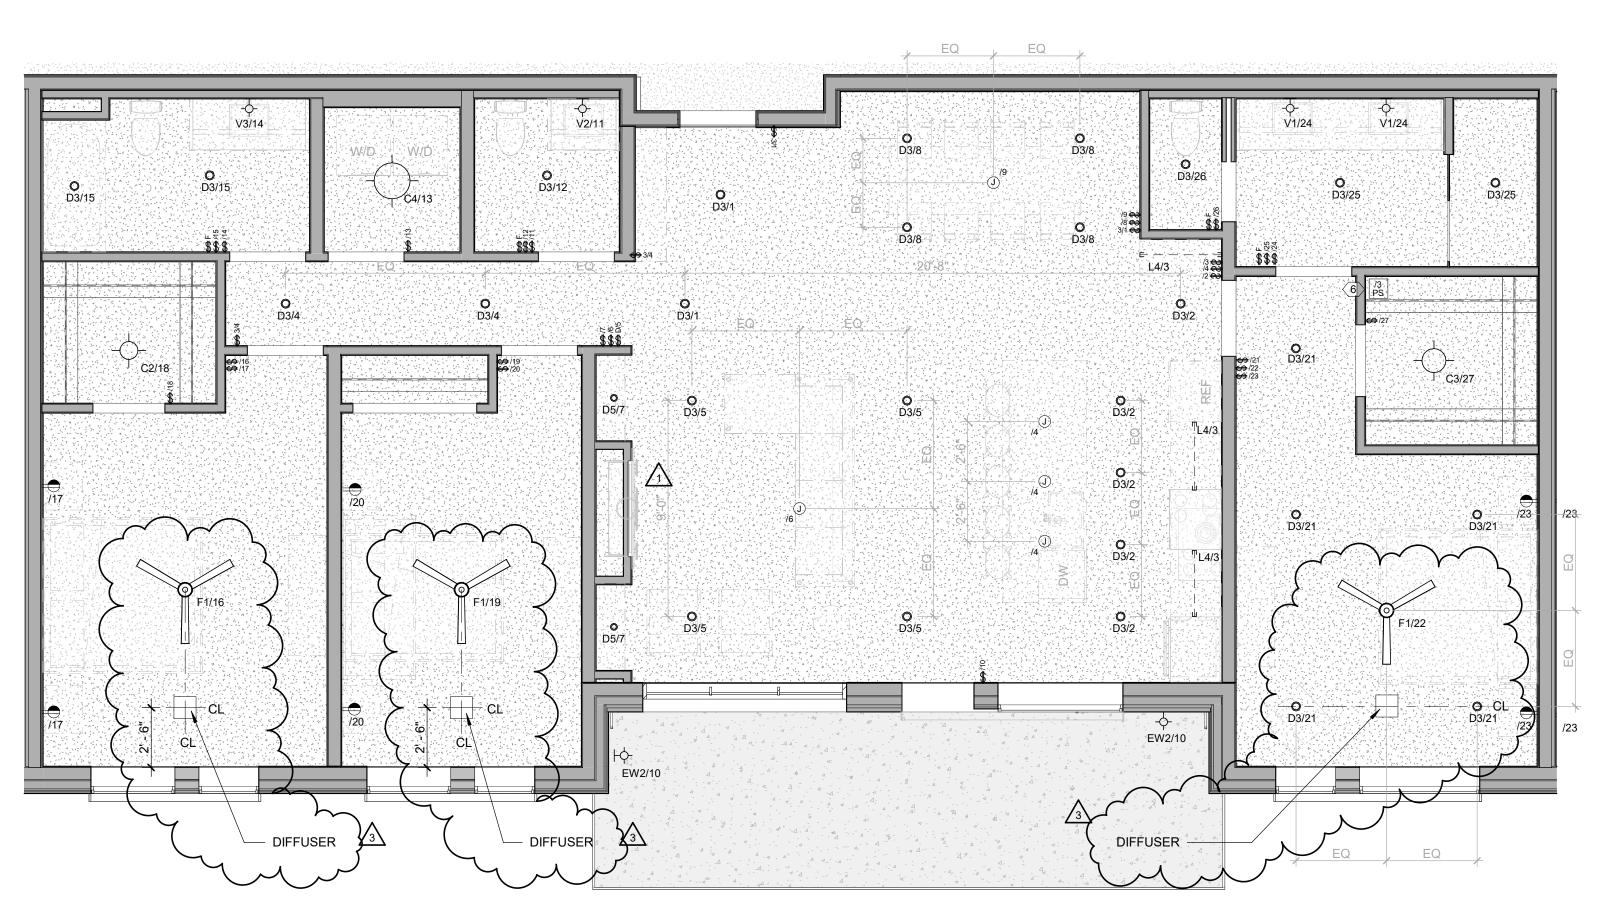

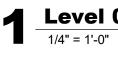



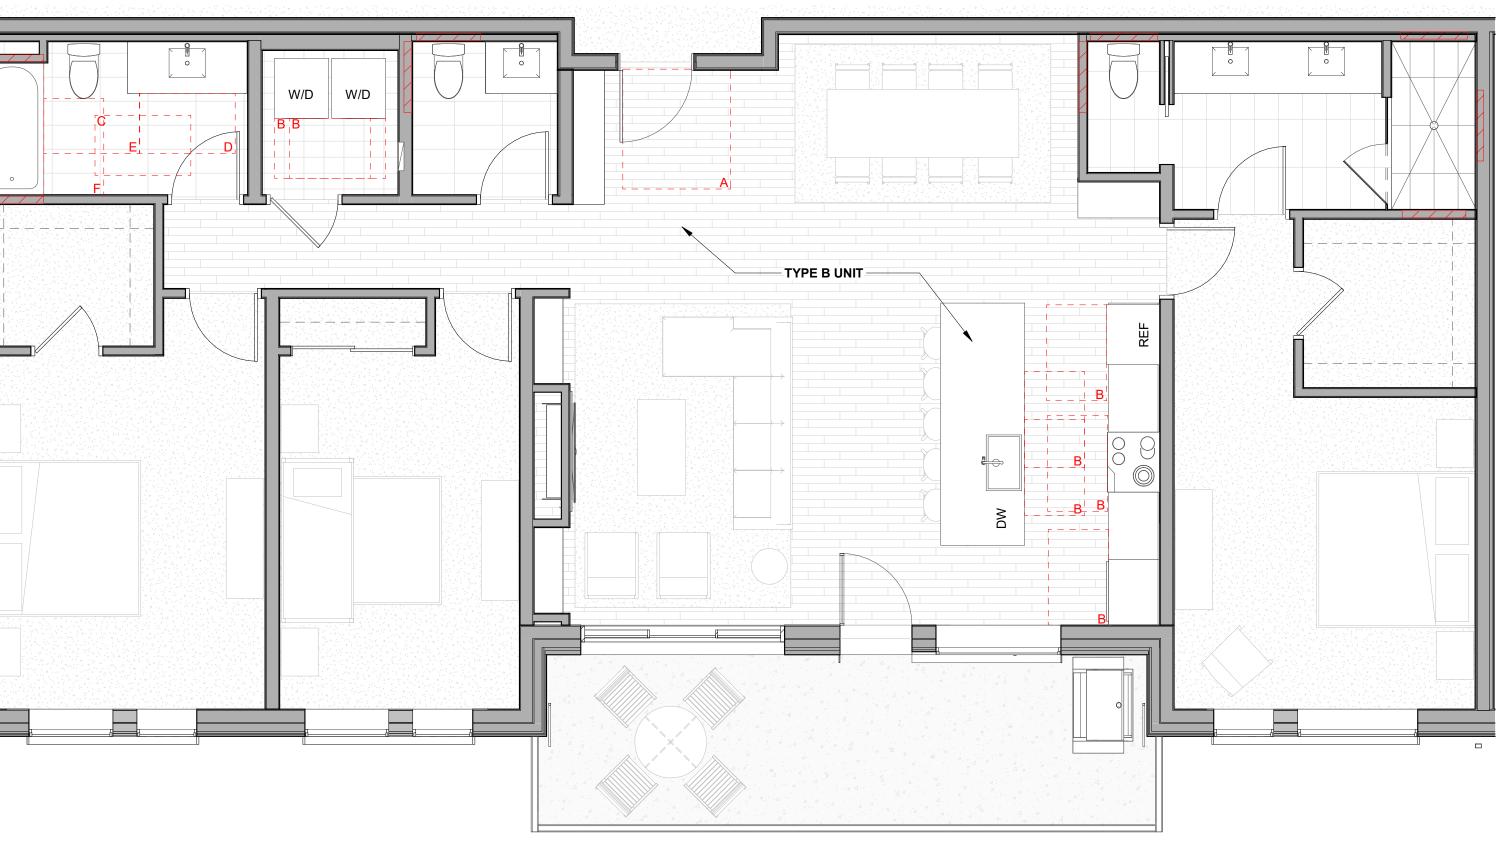


2 Level 03 - 3 BEDROOM STANDARD-FURNITURE 1/4" = 1'-0" UNIT 306 **UNIT 306**

Level 03 - 3 BEDROOM STANDARD-RCP **UNIT 306**

- REFER TO G0.2X SHEETS FOR EXTERIOR AND INTERIOR BUILDING ENCLOSURE ASSEMBLIES.
- REFER TO A1.0X SHEETS FOR EXTERIOR WALL, DEMISING WALL, AND CORRIDOR WALL TYPES AND LOCATIONS. REFER TO A1.1X SHEETS FOR INTERIOR AND EXTERIOR WINDOW/DOOR TAGS WITH UNIT BACKGROUNDS FOR
- REFERENCE. ALIGN WALLS WHERE THEY APPEAR TO ALIGN, U.N.O.
- THE INSIDE FACE OF DOOR JAMBS SHALL BE 4" FROM ADJACENT WALL OR FINISHED COLUMN, U.N.O.
- PROVIDE BLOCKING FOR ALL WALL MOUNTED EQUIPMENT AND ACCESSORIES.
- THE CENTERLINE OF ALL RESIDENTIAL TOILETS SHALL BE
- LOCATED 18" OFF OF FINISH FACE OF WALL, U.N.O. SWING CLEARANCE AT UNIT ENTRY SHALL BE 18" MIN.
- FROM FINISH FACE OF ADJACENT SURFACE. ALL DIMENSIONS ARE TO FACE OF STUD, GRID LINE, OR FACE OF CONCRETE, U.N.O.
- 10. WHERE "CLEAR" IS CALLED OUT ON A DIMENSION, PROVIDE DIMENSION FROM FACE OF FINISH TO FACE OF FINISH.
- 11. FURNITURE IS NOT IN CONTRACT, U.N.O., AND IS SHOWN FOR DIAGRAMATIC PURPOSES ONLY. 12. CONSULTANT MODELS SHOWN FOR REFERENCE ONLY.

ENLARGED FLOOR PLAN - LEGEND

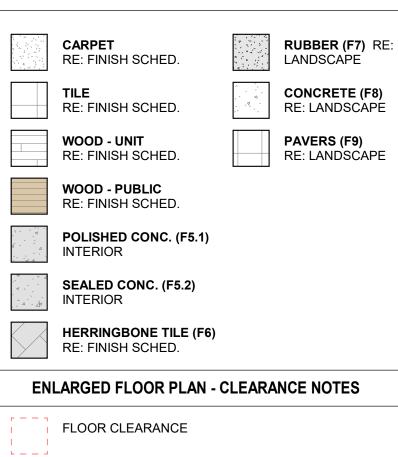


- A DOOR CLEARANCE, 54" X 60"
- B APPLIANCE CLEARANCE, 30" X 48"
- C CLEAR FLOOR CLEARANCE, 30" X 48"
- D VANITY CLEARANCE, 30" X 48"
- E TOILET CLEARANCE, 48" X 56" OR ADA 60" X 56"
- F SHOWER/TUB CLEARANCE, 30" X 48" (B)
- G TURN AROUND CLEARANCE
- GRAB BAR BLOCKING REQ. AT TOILET WALL WHERE APPLICABLE

ENLARGED RCP - GENERAL NOTES


- ALL UNIT CEILINGS SHALL BE 9' 0" A.F.F. U.N.O. REFER TO ENLARGED RCP'S FOR COMMON AREA CEILING HEIGHTS.
- IN THE CASE OF MINOR DISCREPANCIES BETWEEN MEP AND ARCHITECTURAL DOCUMENTS ON THE LOCATION OF CEILING MOUNTED COMPONENTS, THE ARCHITECTURAL RCP'S GOVERN. IN THE CASE OF MAJOR DISCREPANCIES, THE ARCHITECT SHALL BE NOTIFIED AS SOON AS THE DISCREPANCY IS DISCOVERED PRIOR TO PROCEEDING WITH THE WORK.
- REFERENCE MECHANICAL AND ELECTRICAL DRAWINGS FOR MOUNTING LOCATIONS OF ITEMS WHERE NO CEILING IS REQUIRED OR INDICATED.
- COORDINATE ALL TRADES INVOLVED IN THE CEILING WORK TO ENSURE CLEARANCE FOR FIXTURES, DUCTS, PIPING, CEILING SUSPENSION SYSTEMS, ETC. NECESSARY TO MAINTAIN CEILING HEIGHTS NOTED.
- LIGHTS, DIFFUSERS, EXIT SIGNS, SMOKE DETECTORS, SPEAKERS, STROBES, AND MISC. DEVICES SHALL BE CENTERED IN THE CEILING WHERE THEY OCCUR, U.N.O.
- FIRE PROTECTION SCOPE SHALL BE DESIGN-BUILD. ALL CORRIDOR SPRINKLER HEADS SHALL BE ALIGNED IN THE SAME LOCATION PARALLEL TO THE WALL WITHIN EACH SPECIFIC CEILING CONSTRUCTION.
- SMOKE ALARMS SHALL BE PROVIDED IN ALL BEDROOMS, OUTSIDE OF ALL BEDROOMS, AND ON EACH FLOOR AS REQUIRED. CARBON MONOXIDE DETECTORS SHALL BE INSTALLED OUTSIDE OF ALL BEDROOMS. SMOKE ALARMS AND CO DETECTORS SHALL BE HARDWIRED AND HAVE BATTERY BACKUP.
- ACCESS DOOR LOCATIONS IN GYPSUM BOARD CEILINGS ARE INDICATED ON RCP'S ONLY WHERE ARCHITECTURALLY SIGNIFICANT. REFERENCE SPECIFICATIONS AND MEP DRAWINGS FOR OTHER
- ACCESS DOOR LOCATIONS. UNLESS PREFINISHED TO MATCH ADJACENT SURFACE, PAINT MECHANICAL GRILLS, DIFFUSERS, ACCESS PANELS, AND OTHER EQUIPMENT TO MATCH ADJACENT SURFACE.
- 10. EXIT SIGNS ARE SHOWN ON RCP'S ONLY WHERE LOCATIONS ARE ARCHITECTURALLY SIGNIFICANT. I. PROVIDE UL-CLASSIFIED LIGHT FIXTURES OR
- ENCLOSURES IN RATED FLOOR/CEILING ASSEMBLIES IN ACCORDANCE WITH IBC CHAPTER 7. 12. REFER TO LIGHTING PLANS FOR EXACT FIXTURE TYPES AND LOCATIONS. FIXTURES SHOWN HERE ARE
- REFERENCED AND SHOWN FOR GENERAL ALIGNMENT.

GWB (C1) INTERIOR	\rightarrow	SLOPE CEILING AS NOTED
T&G CEILING (C2) INTERIOR	0	CEILING MOUNTED LIGHT FIXTURE
FIBER-CEMENT SOFFIT	+ + + +	VINYL SCRIM CLG -
(C3) - EXTERIOR	+ +	INTERIOR
(C3) - EXTERIOR	+ +	ACCOUSTIC VINYL TILE CLG - INTERIOF

D	35 E S	STAMP)
	BRUCE I B-24 12/15		
	The Amble	Steamboat Springs, CO	
REVISIONS	Descr RFI#110 ASI 004 RFI#223.1	06	Date 3.14.24 3.07.24 3.07.24 3.16.24
2 3			

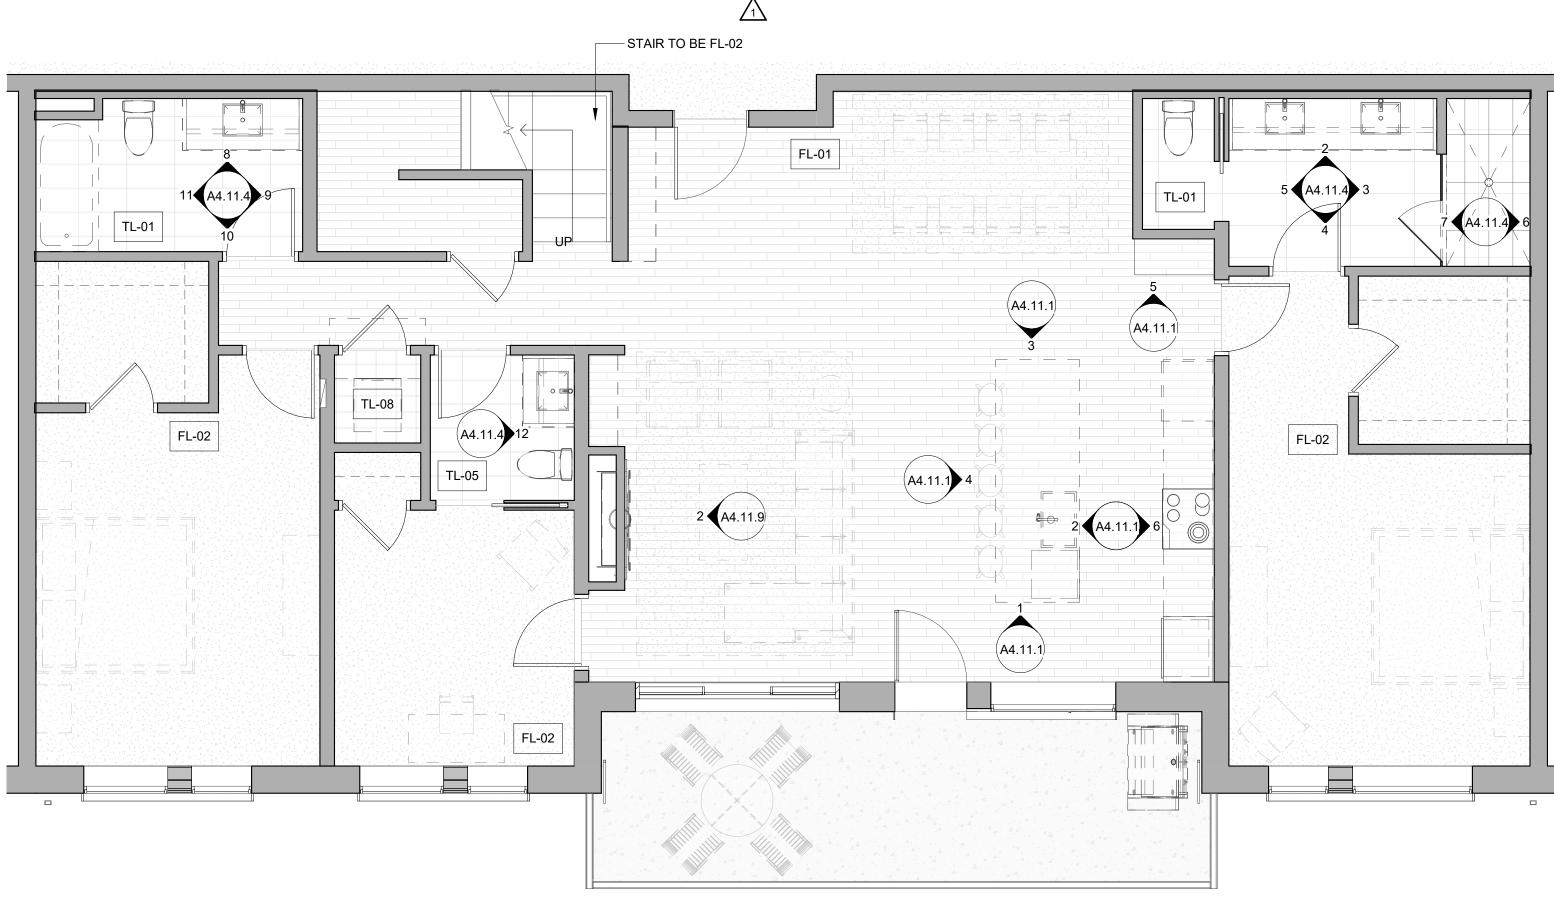



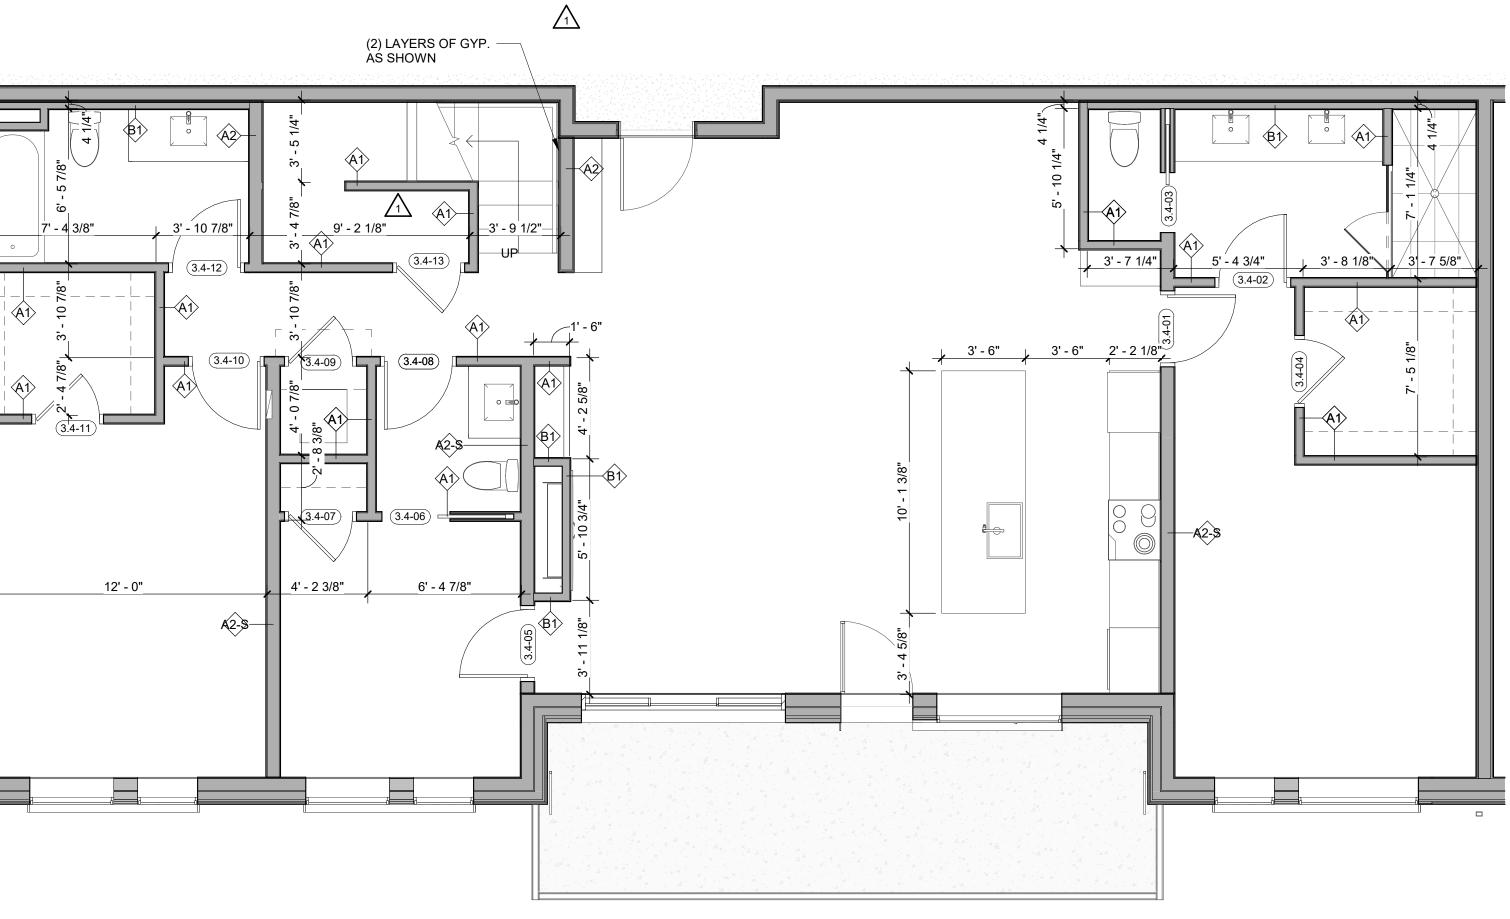


Level 04 - 3 BEDROOM STANDARD DIMENSION



- REFER TO G0.2X SHEETS FOR EXTERIOR AND INTERIOR
- BUILDING ENCLOSURE ASSEMBLIES. REFER TO A1.0X SHEETS FOR EXTERIOR WALL, DEMISING WALL, AND CORRIDOR WALL TYPES AND LOCATIONS.
- REFER TO A1.1X SHEETS FOR INTERIOR AND EXTERIOR WINDOW/DOOR TAGS WITH UNIT BACKGROUNDS FOR REFERENCE.
- ALIGN WALLS WHERE THEY APPEAR TO ALIGN, U.N.O. THE INSIDE FACE OF DOOR JAMBS SHALL BE 4" FROM
- ADJACENT WALL OR FINISHED COLUMN, U.N.O. PROVIDE BLOCKING FOR ALL WALL MOUNTED EQUIPMENT
- AND ACCESSORIES.
- THE CENTERLINE OF ALL RESIDENTIAL TOILETS SHALL BE LOCATED 18" OFF OF FINISH FACE OF WALL, U.N.O. SWING CLEARANCE AT UNIT ENTRY SHALL BE 18" MIN.
- FROM FINISH FACE OF ADJACENT SURFACE. ALL DIMENSIONS ARE TO FACE OF STUD, GRID LINE, OR
- FACE OF CONCRETE, U.N.O. 10. WHERE "CLEAR" IS CALLED OUT ON A DIMENSION,
- PROVIDE DIMENSION FROM FACE OF FINISH TO FACE OF FINISH 11. FURNITURE IS NOT IN CONTRACT, U.N.O., AND IS SHOWN
- FOR DIAGRAMATIC PURPOSES ONLY. 12. CONSULTANT MODELS SHOWN FOR REFERENCE ONLY.

ENLARGED FLOOR PLAN - LEGEND

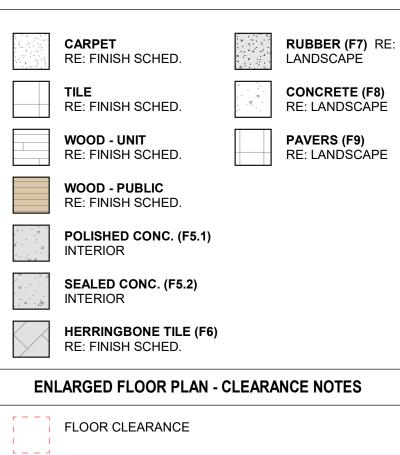

- A DOOR CLEARANCE, 54" X 60"
- B APPLIANCE CLEARANCE, 30" X 48"
- C CLEAR FLOOR CLEARANCE, 30" X 48"
- D VANITY CLEARANCE, 30" X 48"
- E TOILET CLEARANCE, 48" X 56" OR ADA 60" X 56"
- F SHOWER/TUB CLEARANCE, 30" X 48" (B) \bigtriangleup
- G TURN AROUND CLEARANCE
- GRAB BAR BLOCKING REQ. AT TOILET
- WALL WHERE APPLICABLE

ENLARGED RCP - GENERAL NOTES

- ALL UNIT CEILINGS SHALL BE 9' 0" A.F.F. U.N.O. REFER TO ENLARGED RCP'S FOR COMMON AREA CEILING HEIGHTS.
- IN THE CASE OF MINOR DISCREPANCIES BETWEEN MEP AND ARCHITECTURAL DOCUMENTS ON THE LOCATION OF CEILING MOUNTED COMPONENTS, THE ARCHITECTURAL RCP'S GOVERN. IN THE CASE OF MAJOR DISCREPANCIES, THE ARCHITECT SHALL BE NOTIFIED AS SOON AS THE DISCREPANCY IS DISCOVERED PRIOR TO PROCEEDING WITH THE WORK.
- REFERENCE MECHANICAL AND ELECTRICAL DRAWINGS FOR MOUNTING LOCATIONS OF ITEMS WHERE NO CEILING IS REQUIRED OR INDICATED.
- COORDINATE ALL TRADES INVOLVED IN THE CEILING WORK TO ENSURE CLEARANCE FOR FIXTURES, DUCTS, PIPING, CEILING SUSPENSION SYSTEMS, ETC. NECESSARY TO MAINTAIN CEILING HEIGHTS NOTED.
- LIGHTS, DIFFUSERS, EXIT SIGNS, SMOKE DETECTORS, SPEAKERS, STROBES, AND MISC. DEVICES SHALL BE CENTERED IN THE CEILING WHERE THEY OCCUR, U.N.O. FIRE PROTECTION SCOPE SHALL BE DESIGN-BUILD. ALL
- CORRIDOR SPRINKLER HEADS SHALL BE ALIGNED IN THE SAME LOCATION PARALLEL TO THE WALL WITHIN EACH SPECIFIC CEILING CONSTRUCTION.
- SMOKE ALARMS SHALL BE PROVIDED IN ALL BEDROOMS, OUTSIDE OF ALL BEDROOMS, AND ON EACH FLOOR AS REQUIRED. CARBON MONOXIDE DETECTORS SHALL BE INSTALLED OUTSIDE OF ALL BEDROOMS. SMOKE ALARMS AND CO DETECTORS SHALL BE HARDWIRED AND HAVE BATTERY BACKUP.
- ACCESS DOOR LOCATIONS IN GYPSUM BOARD CEILINGS ARE INDICATED ON RCP'S ONLY WHERE ARCHITECTURALLY SIGNIFICANT. REFERENCE SPECIFICATIONS AND MEP DRAWINGS FOR OTHER
- ACCESS DOOR LOCATIONS. UNLESS PREFINISHED TO MATCH ADJACENT SURFACE, PAINT MECHANICAL GRILLS, DIFFUSERS, ACCESS PANELS, AND OTHER EQUIPMENT TO MATCH ADJACENT SURFACE.
- 10. EXIT SIGNS ARE SHOWN ON RCP'S ONLY WHERE LOCATIONS ARE ARCHITECTURALLY SIGNIFICANT. 11. PROVIDE UL-CLASSIFIED LIGHT FIXTURES OR ENCLOSURES IN RATED FLOOR/CEILING ASSEMBLIES IN
- ACCORDANCE WITH IBC CHAPTER 7. 12. REFER TO LIGHTING PLANS FOR EXACT FIXTURE TYPES AND LOCATIONS. FIXTURES SHOWN HERE ARE
- REFERENCED AND SHOWN FOR GENERAL ALIGNMENT.

REVISIONS	T	
No.	Description	Date 03 15 24
	IFC SET ASI 004	03.15.24 08.07.24
-		
ROJECT N		20019 03/15/2024
	THE AMBLE	I
SUE		
	IFC SET	
	F	
	UNIT PLAN - ROOM STANE LEVEL 04	
	UNIT PLAN - ROOM STANI LEVEL 04	
BEDI	UNIT PLAN - ROOM STANI LEVEL 04	DARD -

TOWN STAMP

359

DESIGN

3630 OSAGE STREET DENVER, CO 80211 720.512.3437

B-2465


12/15/2023

SED ARCT

- CU

Q

T

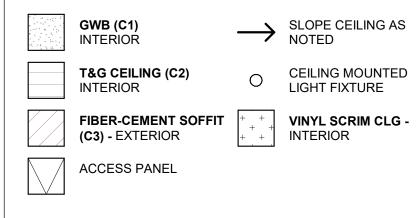











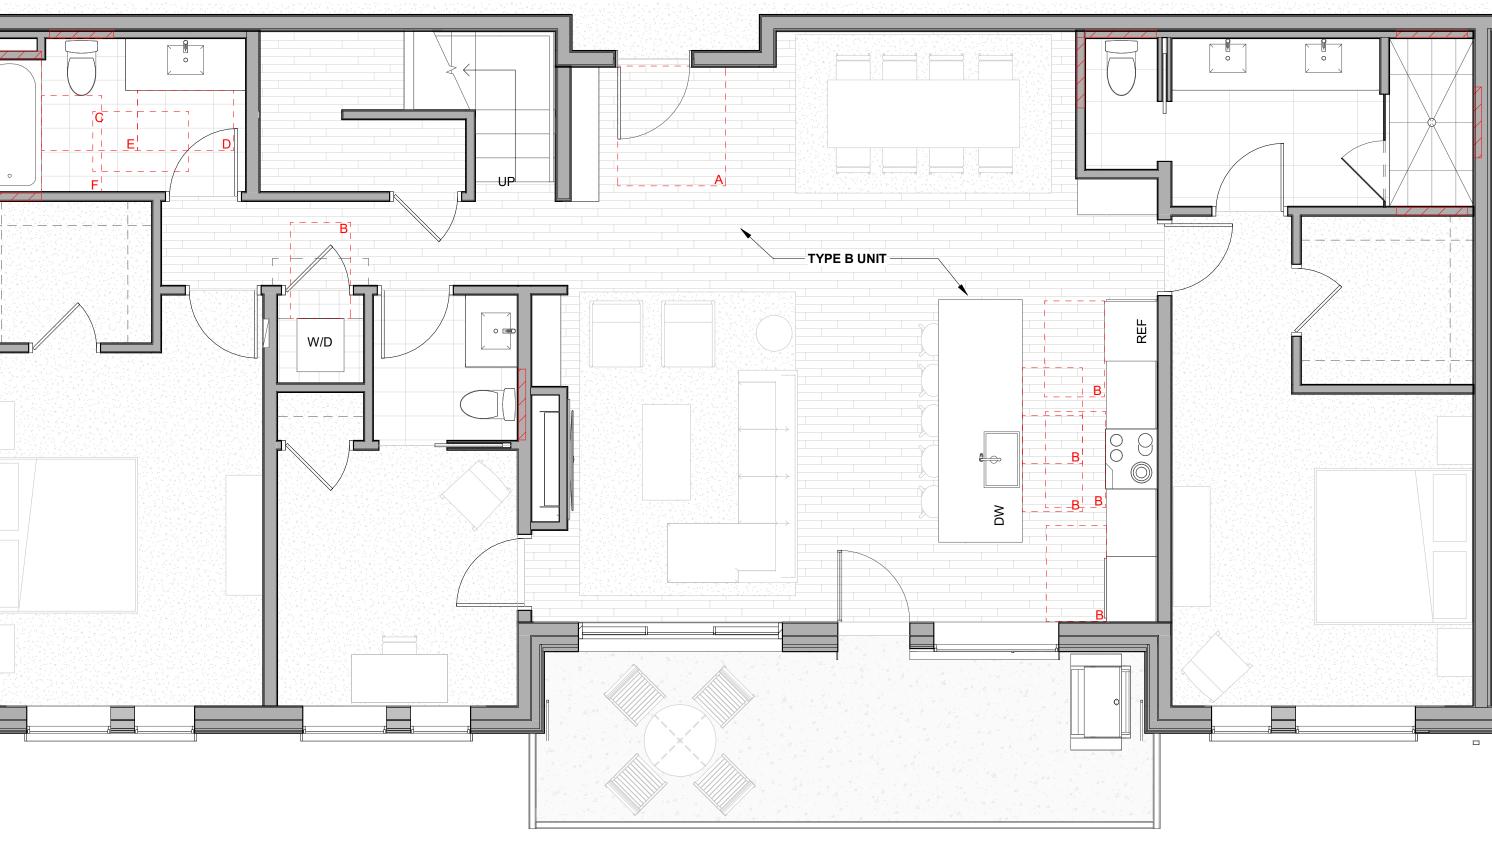


2 Level 04 - 3 BEDROOM STANDARD FURNITURE 1/4" = 1'-0" UNIT 406

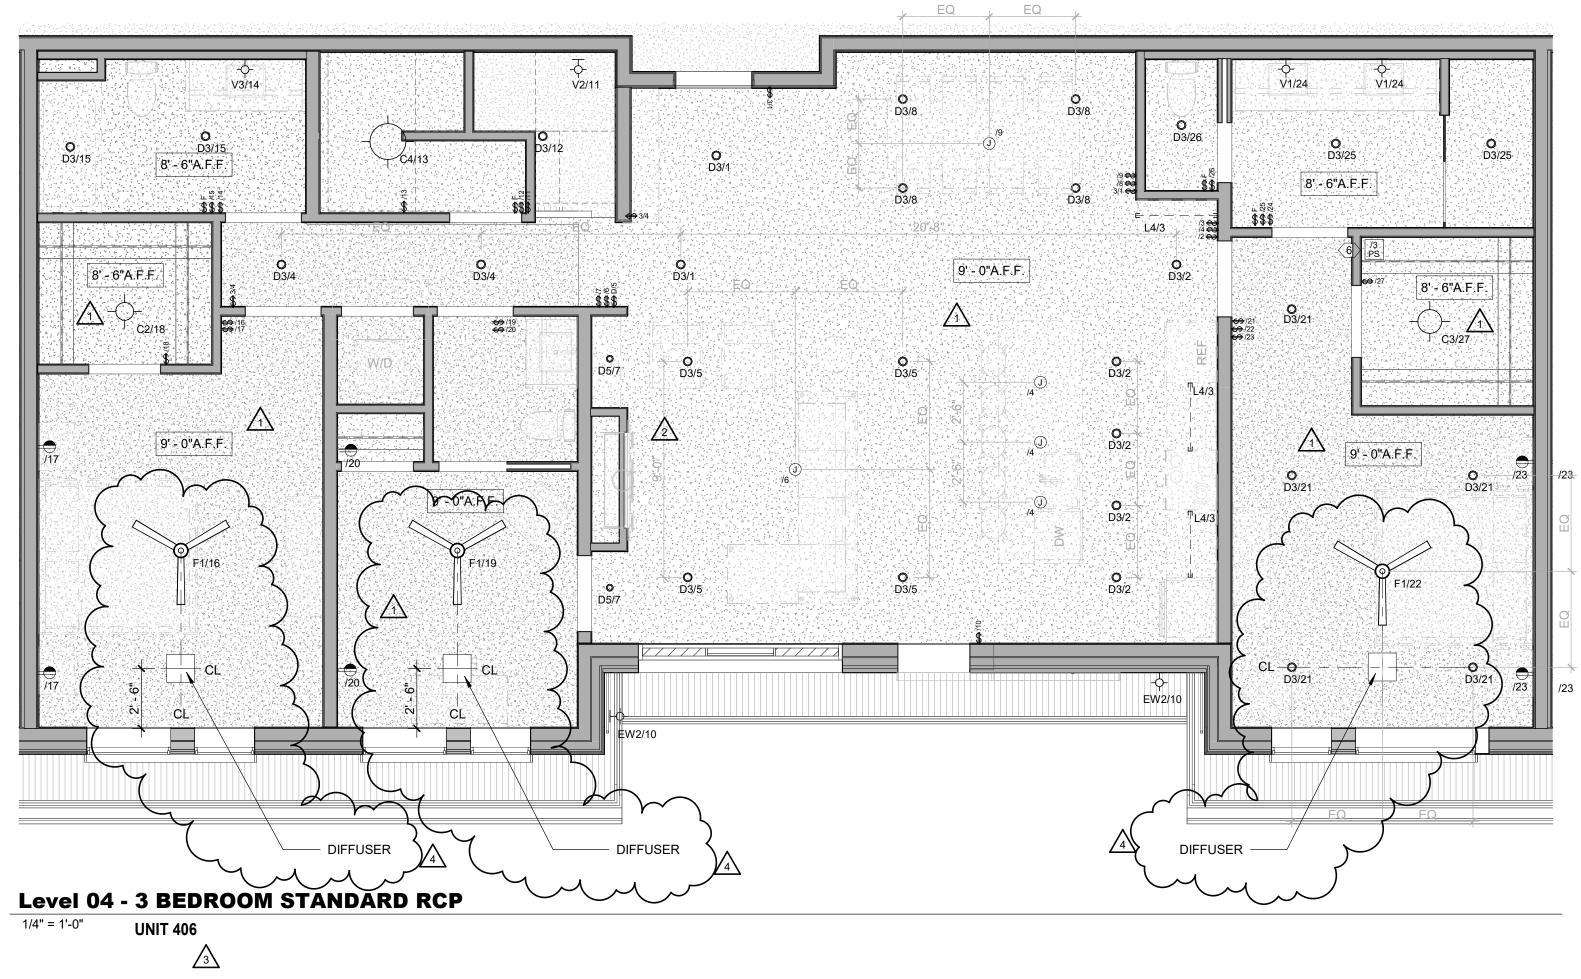

- REFER TO G0.2X SHEETS FOR EXTERIOR AND INTERIOR BUILDING ENCLOSURE ASSEMBLIES.
- REFER TO A1.0X SHEETS FOR EXTERIOR WALL, DEMISING WALL, AND CORRIDOR WALL TYPES AND LOCATIONS.
- REFER TO A1.1X SHEETS FOR INTERIOR AND EXTERIOR WINDOW/DOOR TAGS WITH UNIT BACKGROUNDS FOR REFERENCE. ALIGN WALLS WHERE THEY APPEAR TO ALIGN, U.N.O.
- THE INSIDE FACE OF DOOR JAMBS SHALL BE 4" FROM
- ADJACENT WALL OR FINISHED COLUMN, U.N.O. PROVIDE BLOCKING FOR ALL WALL MOUNTED EQUIPMENT
- AND ACCESSORIES. THE CENTERLINE OF ALL RESIDENTIAL TOILETS SHALL BE
- LOCATED 18" OFF OF FINISH FACE OF WALL, U.N.O. SWING CLEARANCE AT UNIT ENTRY SHALL BE 18" MIN.
- FROM FINISH FACE OF ADJACENT SURFACE. ALL DIMENSIONS ARE TO FACE OF STUD, GRID LINE, OR
- FACE OF CONCRETE, U.N.O. 10. WHERE "CLEAR" IS CALLED OUT ON A DIMENSION, PROVIDE DIMENSION FROM FACE OF FINISH TO FACE OF
- FINISH. 11. FURNITURE IS NOT IN CONTRACT, U.N.O., AND IS SHOWN
- FOR DIAGRAMATIC PURPOSES ONLY. 12. CONSULTANT MODELS SHOWN FOR REFERENCE ONLY.

ENLARGED FLOOR PLAN - LEGEND

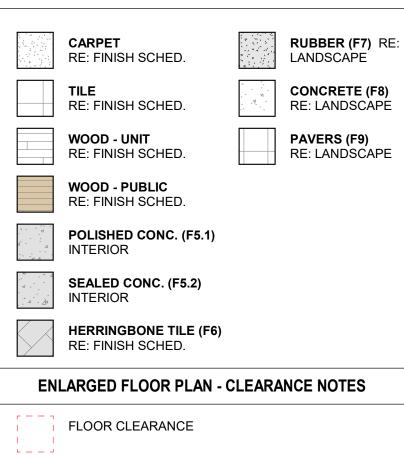

- A DOOR CLEARANCE, 54" X 60"
- B APPLIANCE CLEARANCE, 30" X 48"
- C CLEAR FLOOR CLEARANCE, 30" X 48"
- D VANITY CLEARANCE, 30" X 48"
- E TOILET CLEARANCE, 48" X 56" OR ADA 60" X 56"
- F SHOWER/TUB CLEARANCE, 30" X 48" (B)
- G TURN AROUND CLEARANCE
- GRAB BAR BLOCKING REQ. AT TOILET WALL WHERE APPLICABLE

ENLARGED RCP - GENERAL NOTES

- ALL UNIT CEILINGS SHALL BE 9' 0" A.F.F. U.N.O. REFER TO ENLARGED RCP'S FOR COMMON AREA CEILING HEIGHTS.
- IN THE CASE OF MINOR DISCREPANCIES BETWEEN MEP AND ARCHITECTURAL DOCUMENTS ON THE LOCATION OF CEILING MOUNTED COMPONENTS, THE ARCHITECTURAL RCP'S GOVERN. IN THE CASE OF MAJOR DISCREPANCIES, THE ARCHITECT SHALL BE NOTIFIED AS SOON AS THE DISCREPANCY IS DISCOVERED PRIOR TO PROCEEDING WITH THE WORK.
- REFERENCE MECHANICAL AND ELECTRICAL DRAWINGS FOR MOUNTING LOCATIONS OF ITEMS WHERE NO CEILING IS REQUIRED OR INDICATED.
- COORDINATE ALL TRADES INVOLVED IN THE CEILING WORK TO ENSURE CLEARANCE FOR FIXTURES, DUCTS, PIPING, CEILING SUSPENSION SYSTEMS, ETC. NECESSARY TO MAINTAIN CEILING HEIGHTS NOTED.
- LIGHTS, DIFFUSERS, EXIT SIGNS, SMOKE DETECTORS, SPEAKERS, STROBES, AND MISC. DEVICES SHALL BE CENTERED IN THE CEILING WHERE THEY OCCUR, U.N.O. FIRE PROTECTION SCOPE SHALL BE DESIGN-BUILD. ALL
- CORRIDOR SPRINKLER HEADS SHALL BE ALIGNED IN THE SAME LOCATION PARALLEL TO THE WALL WITHIN EACH SPECIFIC CEILING CONSTRUCTION.
- SMOKE ALARMS SHALL BE PROVIDED IN ALL BEDROOMS, OUTSIDE OF ALL BEDROOMS, AND ON EACH FLOOR AS REQUIRED. CARBON MONOXIDE DETECTORS SHALL BE INSTALLED OUTSIDE OF ALL BEDROOMS. SMOKE ALARMS AND CO DETECTORS SHALL BE HARDWIRED AND HAVE BATTERY BACKUP.
- ACCESS DOOR LOCATIONS IN GYPSUM BOARD CEILINGS ARE INDICATED ON RCP'S ONLY WHERE ARCHITECTURALLY SIGNIFICANT. REFERENCE SPECIFICATIONS AND MEP DRAWINGS FOR OTHER
- ACCESS DOOR LOCATIONS. UNLESS PREFINISHED TO MATCH ADJACENT SURFACE, PAINT MECHANICAL GRILLS, DIFFUSERS, ACCESS PANELS, AND OTHER EQUIPMENT TO MATCH ADJACENT SURFACE.
- 10. EXIT SIGNS ARE SHOWN ON RCP'S ONLY WHERE LOCATIONS ARE ARCHITECTURALLY SIGNIFICANT. I. PROVIDE UL-CLASSIFIED LIGHT FIXTURES OR
- ENCLOSURES IN RATED FLOOR/CEILING ASSEMBLIES IN ACCORDANCE WITH IBC CHAPTER 7. 12. REFER TO LIGHTING PLANS FOR EXACT FIXTURE TYPES AND LOCATIONS. FIXTURES SHOWN HERE ARE
- REFERENCED AND SHOWN FOR GENERAL ALIGNMENT.

ENLARGED RCP - LEGEND


GWB (C1) INTERIOR	\rightarrow	SLOPE CEILING AS NOTED
T&G CEILING (C2) INTERIOR	0	CEILING MOUNTED LIGHT FIXTURE
FIBER-CEMENT SOFFIT (C3) - EXTERIOR	+ + + + + + + + + + + + + + + + + + + +	VINYL SCRIM CLG - INTERIOR
	+ + + + + + + + + + + + + + + + + + + +	

	35 E S	STAMP)
	12/15	2023 ARCH	and a second
	The Amble	Steamboat Springs, CO	
No. 1 2 3 4	Descr IFC SET RFI #110 ASI 004 RFI #223.1	iption	Date 03.15.24 06.14.24 08.07.24 10.16.24
PROJECT N ISSUE DATE ISSUE	THE A	SET	


LEVEL 04

A4.06.8


SHEET NO.

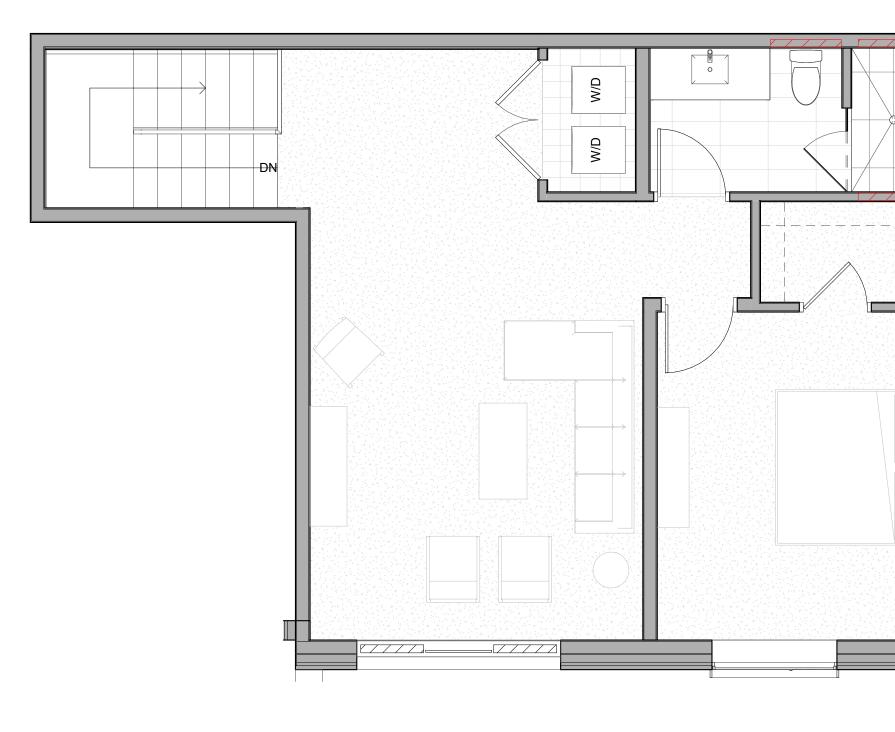



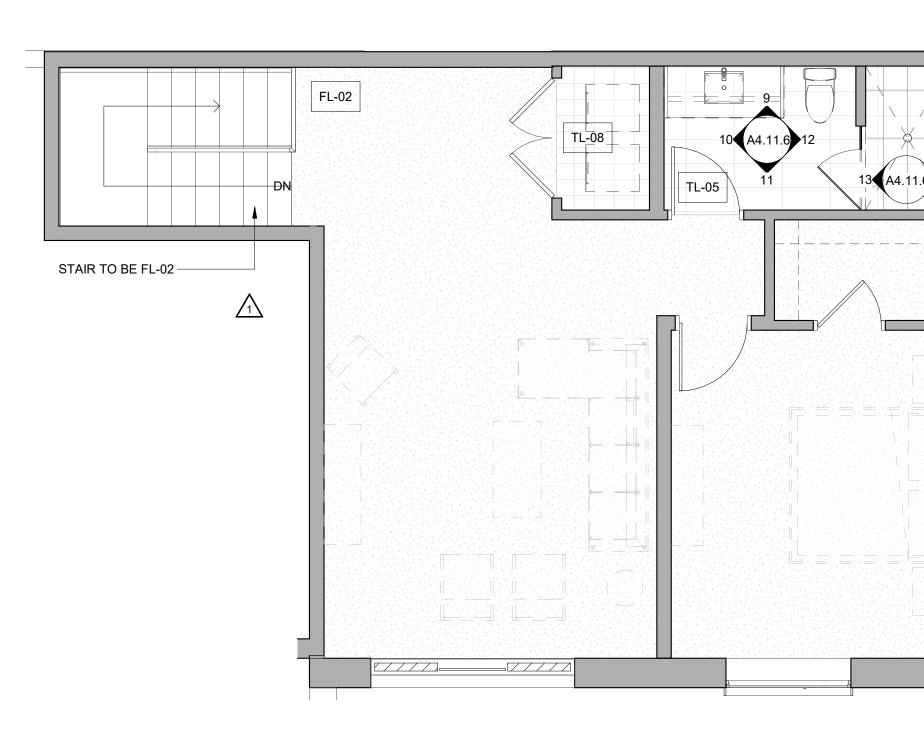




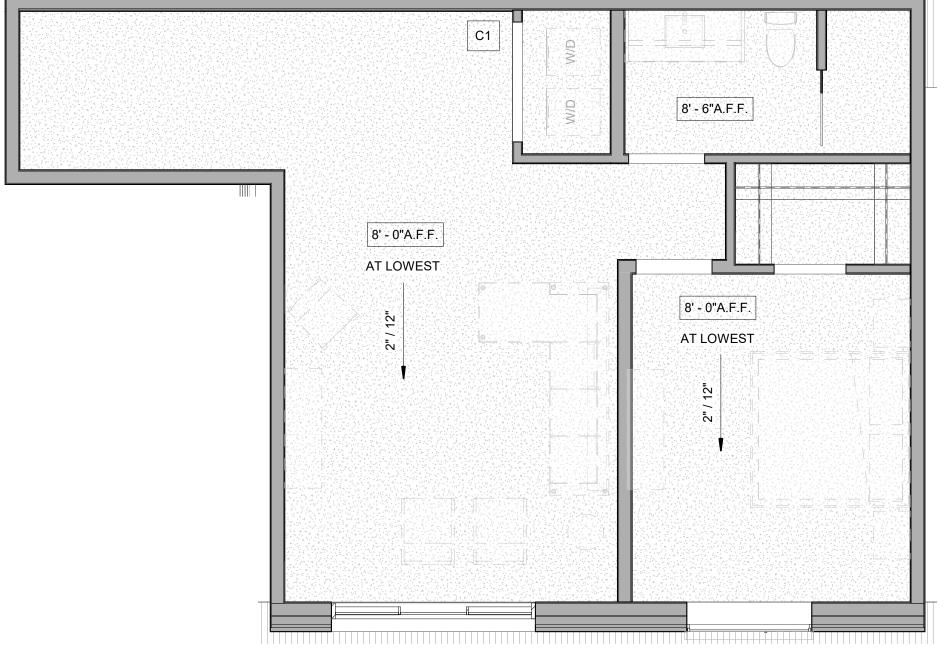



3 DORMER LEVEL - 3 BED STANDARD LOFT RCP 1/4" = 1'-0" UNIT 406 UNIT 406

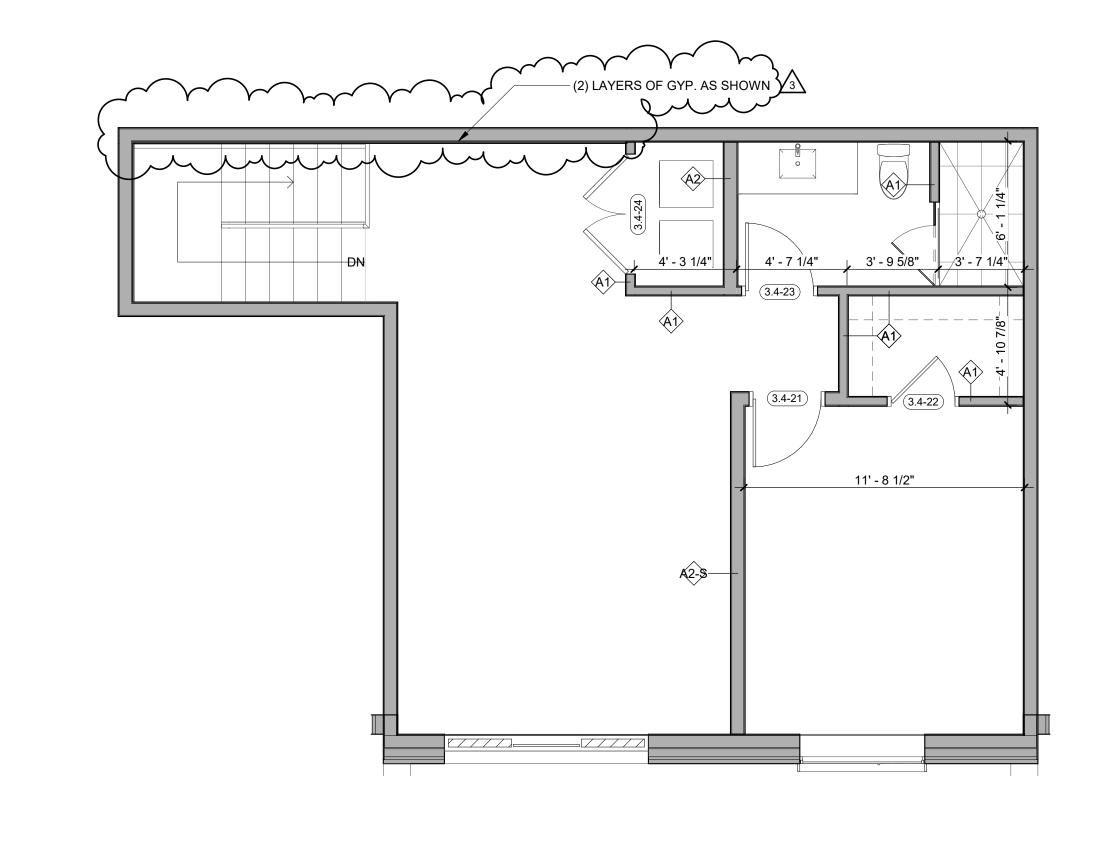



UNIT 406

ENLARGED FLOOR PLAN - GENERAL NOTES

- REFER TO G0.2X SHEETS FOR EXTERIOR AND INTERIOR
- BUILDING ENCLOSURE ASSEMBLIES. REFER TO A1.0X SHEETS FOR EXTERIOR WALL, DEMISING
- WALL, AND CORRIDOR WALL TYPES AND LOCATIONS. REFER TO A1.1X SHEETS FOR INTERIOR AND EXTERIOR WINDOW/DOOR TAGS WITH UNIT BACKGROUNDS FOR
- REFERENCE. ALIGN WALLS WHERE THEY APPEAR TO ALIGN, U.N.O.
- THE INSIDE FACE OF DOOR JAMBS SHALL BE 4" FROM 5 ADJACENT WALL OR FINISHED COLUMN, U.N.O.
- PROVIDE BLOCKING FOR ALL WALL MOUNTED EQUIPMENT AND ACCESSORIES.

TOWN STAMP

359 Design

3630 OSAGE STREET DENVER, CO 80211 720.512.3437

2/15/2023

- CU

Q

REVISIONS

PROJECT NUMBER

No. Description Date

20019

RFI #232

- THE CENTERLINE OF ALL RESIDENTIAL TOILETS SHALL BE
- LOCATED 18" OFF OF FINISH FACE OF WALL, U.N.O. SWING CLEARANCE AT UNIT ENTRY SHALL BE 18" MIN.
- FROM FINISH FACE OF ADJACENT SURFACE. ALL DIMENSIONS ARE TO FACE OF STUD, GRID LINE, OR
- FACE OF CONCRETE, U.N.O. 10. WHERE "CLEAR" IS CALLED OUT ON A DIMENSION,
- PROVIDE DIMENSION FROM FACE OF FINISH TO FACE OF FINISH. 11. FURNITURE IS NOT IN CONTRACT, U.N.O., AND IS SHOWN
- FOR DIAGRAMATIC PURPOSES ONLY. 12. CONSULTANT MODELS SHOWN FOR REFERENCE ONLY.

ENLARGED FLOOR PLAN - LEGEND


	CARPET RE: FINISH SCHED.		RUBBER (F7) RI Landscape
	TILE RE: FINISH SCHED.		CONCRETE (F8) RE: LANDSCAPE
	WOOD - UNIT RE: FINISH SCHED.		PAVERS (F9) RE: LANDSCAPE
	WOOD - PUBLIC RE: FINISH SCHED.		
	POLISHED CONC. (F5.1) INTERIOR		
	SEALED CONC. (F5.2) INTERIOR		
	HERRINGBONE TILE (F6) RE: FINISH SCHED.		
ENI	ARGED FLOOR PLAN - (CLEARA	NCE NOTES
	FLOOR CLEARANCE		

A DOOR CLEARANCE, 54" X 60" B APPLIANCE CLEARANCE, 30" X 48" C CLEAR FLOOR CLEARANCE, 30" X 48" D VANITY CLEARANCE, 30" X 48" E TOILET CLEARANCE, 48" X 56" OR ADA 60" X 56" \bigtriangleup F SHOWER/TUB CLEARANCE, 30" X 48" (B) G TURN AROUND CLEARANCE GRAB BAR BLOCKING REQ. AT TOILET WALL WHERE APPLICABLE

ENLARGED RCP - GENERAL NOTES

- ALL UNIT CEILINGS SHALL BE 9' 0" A.F.F. U.N.O. REFER TO ENLARGED RCP'S FOR COMMON AREA CEILING HEIGHTS.
- IN THE CASE OF MINOR DISCREPANCIES BETWEEN MEP AND ARCHITECTURAL DOCUMENTS ON THE LOCATION OF CEILING MOUNTED COMPONENTS, THE ARCHITECTURAL RCP'S GOVERN. IN THE CASE OF MAJOR DISCREPANCIES, THE ARCHITECT SHALL BE NOTIFIED AS SOON AS THE DISCREPANCY IS DISCOVERED PRIOR TO PROCEEDING WITH THE WORK.
- REFERENCE MECHANICAL AND ELECTRICAL DRAWINGS FOR MOUNTING LOCATIONS OF ITEMS WHERE NO CEILING IS REQUIRED OR INDICATED.
- COORDINATE ALL TRADES INVOLVED IN THE CEILING WORK TO ENSURE CLEARANCE FOR FIXTURES, DUCTS, PIPING, CEILING SUSPENSION SYSTEMS, ETC. NECESSARY TO MAINTAIN CEILING HEIGHTS NOTED.
- LIGHTS, DIFFUSERS, EXIT SIGNS, SMOKE DETECTORS, SPEAKERS, STROBES, AND MISC. DEVICES SHALL BE CENTERED IN THE CEILING WHERE THEY OCCUR, U.N.O. FIRE PROTECTION SCOPE SHALL BE DESIGN-BUILD. ALL
- CORRIDOR SPRINKLER HEADS SHALL BE ALIGNED IN THE SAME LOCATION PARALLEL TO THE WALL WITHIN EACH SPECIFIC CEILING CONSTRUCTION. SMOKE ALARMS SHALL BE PROVIDED IN ALL BEDROOMS,
- OUTSIDE OF ALL BEDROOMS, AND ON EACH FLOOR AS REQUIRED. CARBON MONOXIDE DETECTORS SHALL BE INSTALLED OUTSIDE OF ALL BEDROOMS. SMOKE ALARMS AND CO DETECTORS SHALL BE HARDWIRED AND HAVE BATTERY BACKUP.
- ACCESS DOOR LOCATIONS IN GYPSUM BOARD CEILINGS ARE INDICATED ON RCP'S ONLY WHERE ARCHITECTURALLY SIGNIFICANT. REFERENCE SPECIFICATIONS AND MEP DRAWINGS FOR OTHER ACCESS DOOR LOCATIONS.
- UNLESS PREFINISHED TO MATCH ADJACENT SURFACE, PAINT MECHANICAL GRILLS, DIFFUSERS, ACCESS PANELS, AND OTHER EQUIPMENT TO MATCH ADJACENT SURFACE.
- 10. EXIT SIGNS ARE SHOWN ON RCP'S ONLY WHERE LOCATIONS ARE ARCHITECTURALLY SIGNIFICANT. 11. PROVIDE UL-CLASSIFIED LIGHT FIXTURES OR
- ENCLOSURES IN RATED FLOOR/CEILING ASSEMBLIES IN ACCORDANCE WITH IBC CHAPTER 7. 12. REFER TO LIGHTING PLANS FOR EXACT FIXTURE TYPES AND LOCATIONS. FIXTURES SHOWN HERE ARE
- REFERENCED /

	ISSUE DATE 03/15/2024
	THE AMBLE
EGEND	IFC SET
SLOPE CEILING AS NOTED	SHEET TITLE
CEILING MOUNTED LIGHT FIXTURE	UNIT PLAN - 3 BEDROOM STANDARD -
VINYL SCRIM CLG - INTERIOR	LEVEL 05
	A4.06.9
	A4.00.3
	NERAL ALIGNMENT. EGEND → SLOPE CEILING AS NOTED → CEILING MOUNTED LIGHT FIXTURE → VINYL SCRIM CLG -

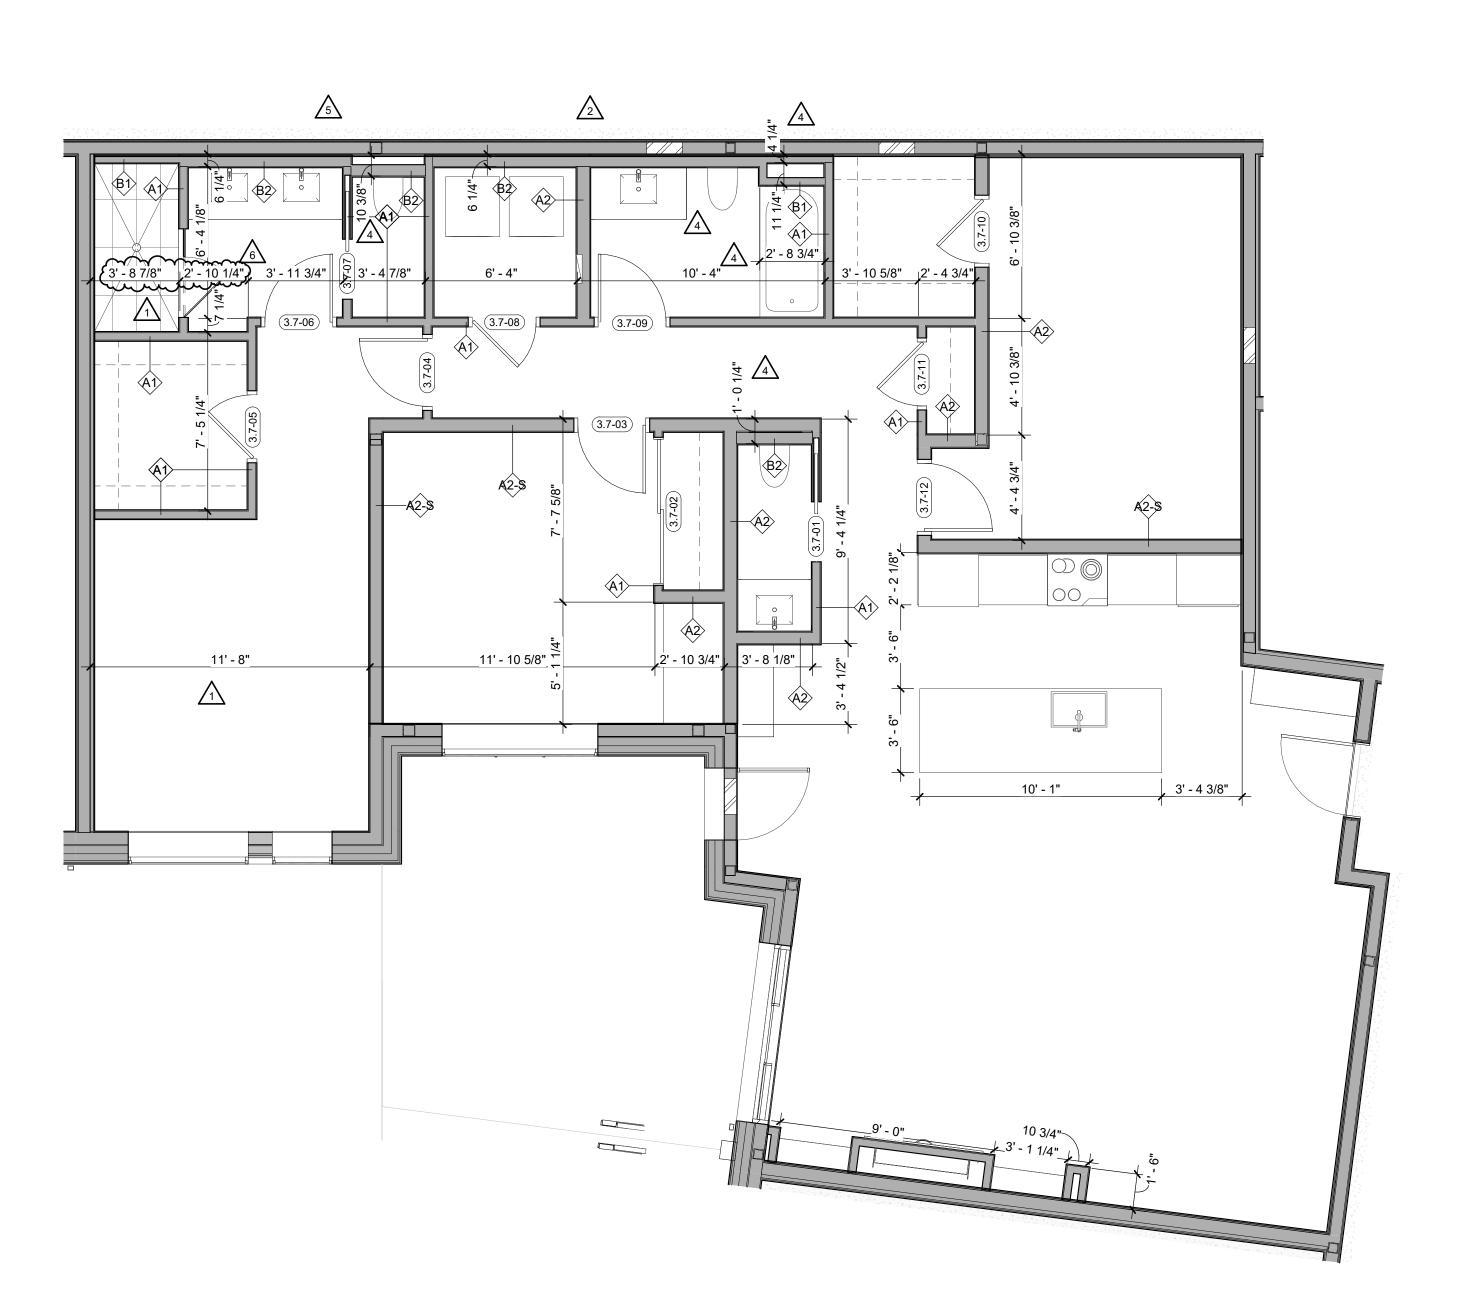


Level 01 - 3 BED KNUCKLE DIMENSION 1/4" = 1'-0" UNIT 105

 $\sqrt{3}$

ENLARGED FLOOR PLAN - GENERAL NOTES

- . REFER TO G0.2X SHEETS FOR EXTERIOR AND INTERIOR
- BUILDING ENCLOSURE ASSEMBLIES. 2. REFER TO A1.0X SHEETS FOR EXTERIOR WALL, DEMISING
- WALL, AND CORRIDOR WALL TYPES AND LOCATIONS.3. REFER TO A1.1X SHEETS FOR INTERIOR AND EXTERIOR WINDOW/DOOR TAGS WITH UNIT BACKGROUNDS FOR
- REFERENCE. 4. ALIGN WALLS WHERE THEY APPEAR TO ALIGN, U.N.O.
- 5. THE INSIDE FACE OF DOOR JAMBS SHALL BE 4" FROM ADJACENT WALL OR FINISHED COLUMN, U.N.O.
- 6. PROVIDE BLOCKING FOR ALL WALL MOUNTED EQUIPMENT AND ACCESSORIES.
- 7. THE CENTERLINE OF ALL RESIDENTIAL TOILETS SHALL BE
- LOCATED 18" OFF OF FINISH FACE OF WALL, U.N.O. 8. SWING CLEARANCE AT UNIT ENTRY SHALL BE 18" MIN.
- FROM FINISH FACE OF ADJACENT SURFACE. 9. ALL DIMENSIONS ARE TO FACE OF STUD, GRID LINE, OR
- FACE OF CONCRETE, U.N.O. 10. WHERE "CLEAR" IS CALLED OUT ON A DIMENSION, PROVIDE DIMENSION FROM FACE OF FINISH TO FACE OF
- FINISH. 11. FURNITURE IS NOT IN CONTRACT, U.N.O., AND IS SHOWN
- FOR DIAGRAMATIC PURPOSES ONLY. 12. CONSULTANT MODELS SHOWN FOR REFERENCE ONLY.

ENLARGED FLOOR PLAN - LEGEND

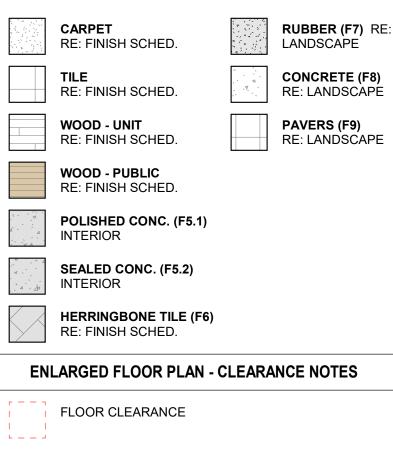

- A DOOR CLEARANCE, 54" X 60"
 B APPLIANCE CLEARANCE, 30" X 48"
 C CLEAR FLOOR CLEARANCE, 30" X 48"
 D VANITY CLEARANCE, 30" X 48"
 E TOILET CLEARANCE, 48" X 56" OR ADA 60" X 56"
 F SHOWER/TUB CLEARANCE, 30" X 48" (B)
 G TURN AROUND CLEARANCE
- GRAB BAR BLOCKING REQ. AT TOILET WALL WHERE APPLICABLE

ENLARGED RCP - GENERAL NOTES

- 1. ALL UNIT CEILINGS SHALL BE 9' 0" A.F.F. U.N.O. REFER TO ENLARGED RCP'S FOR COMMON AREA CEILING HEIGHTS.
- 2. IN THE CASE OF MINOR DISCREPANCIES BETWEEN MEP AND ARCHITECTURAL DOCUMENTS ON THE LOCATION OF CEILING MOUNTED COMPONENTS, THE ARCHITECTURAL RCP'S GOVERN. IN THE CASE OF MAJOR DISCREPANCIES, THE ARCHITECT SHALL BE NOTIFIED AS SOON AS THE DISCREPANCY IS DISCOVERED PRIOR TO PROCEEDING WITH THE WORK.
- 3. REFERENCE MECHANICAL AND ELECTRICAL DRAWINGS FOR MOUNTING LOCATIONS OF ITEMS WHERE NO CEILING IS REQUIRED OR INDICATED.
- 4. COORDINATE ALL TRADES INVOLVED IN THE CEILING WORK TO ENSURE CLEARANCE FOR FIXTURES, DUCTS, PIPING, CEILING SUSPENSION SYSTEMS, ETC. NECESSARY TO MAINTAIN CEILING HEIGHTS NOTED.
- LIGHTS, DIFFUSERS, EXIT SIGNS, SMOKE DETECTORS, SPEAKERS, STROBES, AND MISC. DEVICES SHALL BE CENTERED IN THE CEILING WHERE THEY OCCUR, U.N.O.
 FIRE PROTECTION SCOPE SHALL BE DESIGN-BUILD. ALL
- CORRIDOR SPRINKLER HEADS SHALL BE ALIGNED IN THE SAME LOCATION PARALLEL TO THE WALL WITHIN EACH SPECIFIC CEILING CONSTRUCTION.
 7. SMOKE ALARMS SHALL BE PROVIDED IN ALL BEDROOMS,
- OUTSIDE OF ALL BEDROOMS, AND ON EACH FLOOR AS REQUIRED. CARBON MONOXIDE DETECTORS SHALL BE INSTALLED OUTSIDE OF ALL BEDROOMS. SMOKE ALARMS AND CO DETECTORS SHALL BE HARDWIRED AND HAVE BATTERY BACKUP.
- 8. ACCESS DOOR LOCATIONS IN GYPSUM BOARD CEILINGS ARE INDICATED ON RCP'S ONLY WHERE ARCHITECTURALLY SIGNIFICANT. REFERENCE SPECIFICATIONS AND MEP DRAWINGS FOR OTHER ACCESS DOOR LOCATIONS.
- UNLESS PREFINISHED TO MATCH ADJACENT SURFACE, PAINT MECHANICAL GRILLS, DIFFUSERS, ACCESS PANELS, AND OTHER EQUIPMENT TO MATCH ADJACENT SURFACE.
 EXIT SIGNS ARE SHOWN ON RCP'S ONLY WHERE
- LOCATIONS ARE ARCHITECTURALLY SIGNIFICANT. 11. PROVIDE UL-CLASSIFIED LIGHT FIXTURES OR
- ENCLOSURES IN RATED FLOOR/CEILING ASSEMBLIES IN ACCORDANCE WITH IBC CHAPTER 7.12. REFER TO LIGHTING PLANS FOR EXACT FIXTURE TYPES AND LOCATIONS. FIXTURES SHOWN HERE ARE
- REFERENCED AND SHOWN FOR GENERAL ALIGNMENT.

	The Amble Steamboat Springs, Co	
REVISIONS		
No.	Description	Date 03.15.24
2 3	RFI #125 ASI 004	06.24.24 08.07.24
5	RFI #183 RFI #214	08.02.24 08.21.24 09.17.24
6	RFI #232	09.17.24
		<u> </u>
		<u> </u>
		
		<u> </u>
		. <u> </u>
		20019
		02/45/000
		03/15/2024
ISSUE DATE		
ISSUE DATE	=	
ISSUE DATE	THE AMBLE	
ISSUE DATE	THE AMBLE	
ISSUE DATE	THE AMBLE IFC SET	E
	THE AMBLE	3
SHEET NO.	THE AMBLE IFC SET	3 CKLE

TOWN STAMP

359

DESIGN

3630 OSAGE STREET DENVER, CO 80211 720.512.3437


B-2465

12/15/2023

PED ARCY

U



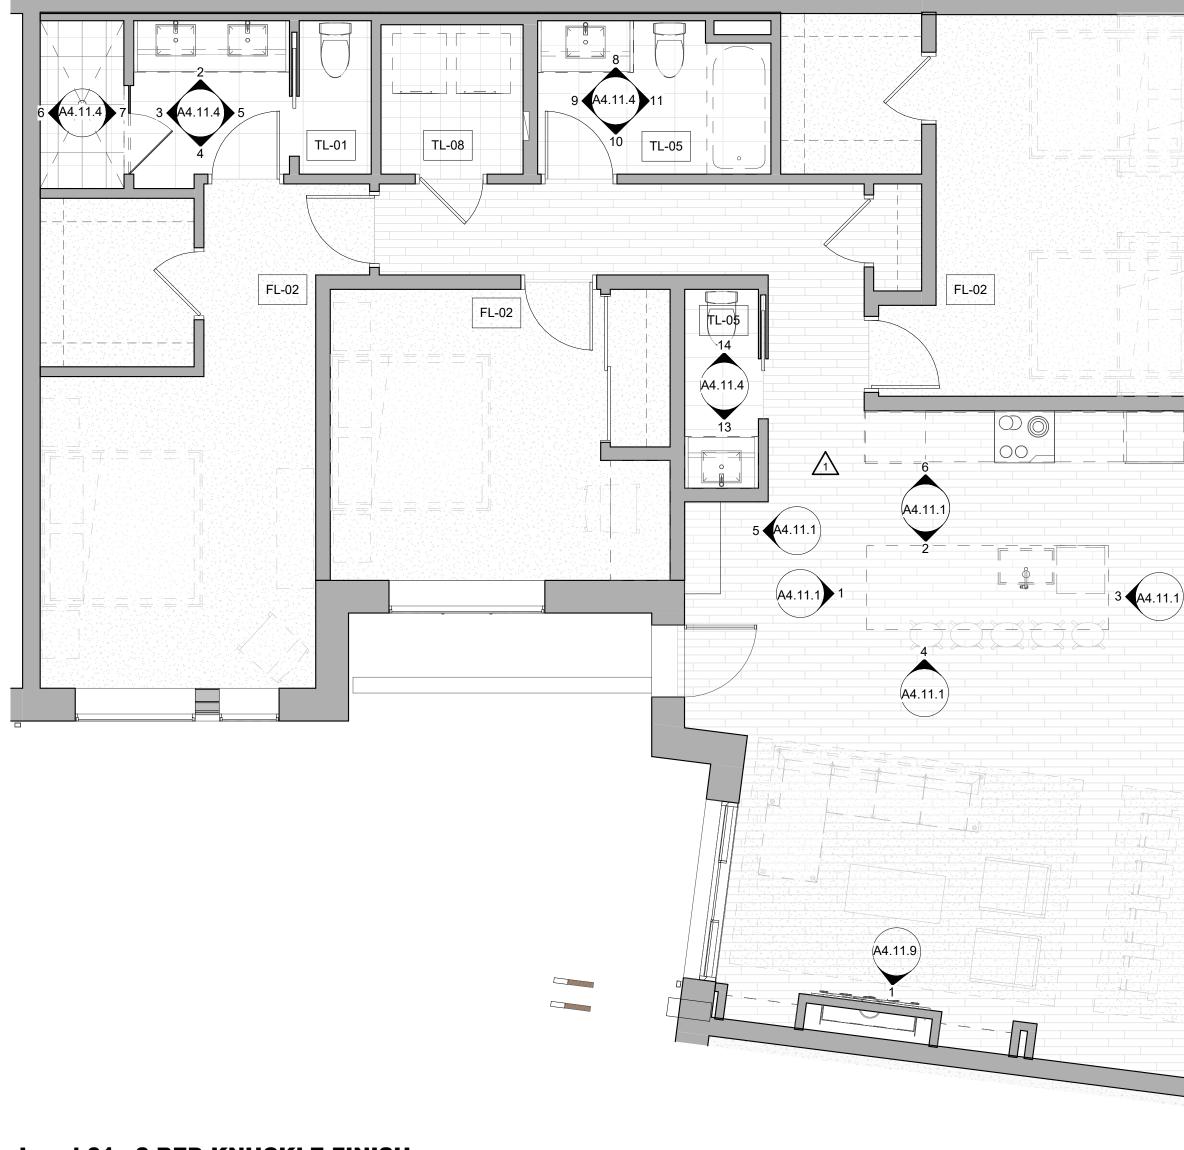

Level 01 - 3 BED KNUCKLE FINISH UNIT 105

ENLARGED FLOOR PLAN - GENERAL NOTES

- REFER TO G0.2X SHEETS FOR EXTERIOR AND INTERIOR
- BUILDING ENCLOSURE ASSEMBLIES. REFER TO A1.0X SHEETS FOR EXTERIOR WALL, DEMISING
- WALL, AND CORRIDOR WALL TYPES AND LOCATIONS. REFER TO A1.1X SHEETS FOR INTERIOR AND EXTERIOR WINDOW/DOOR TAGS WITH UNIT BACKGROUNDS FOR REFERENCE.
- ALIGN WALLS WHERE THEY APPEAR TO ALIGN, U.N.O.
- 5. THE INSIDE FACE OF DOOR JAMBS SHALL BE 4" FROM ADJACENT WALL OR FINISHED COLUMN, U.N.O.
- PROVIDE BLOCKING FOR ALL WALL MOUNTED EQUIPMENT AND ACCESSORIES.
- THE CENTERLINE OF ALL RESIDENTIAL TOILETS SHALL BE LOCATED 18" OFF OF FINISH FACE OF WALL, U.N.O.
- SWING CLEARANCE AT UNIT ENTRY SHALL BE 18" MIN.
- FROM FINISH FACE OF ADJACENT SURFACE. ALL DIMENSIONS ARE TO FACE OF STUD, GRID LINE, OR FACE OF CONCRETE, U.N.O.
- 10. WHERE "CLEAR" IS CALLED OUT ON A DIMENSION, PROVIDE DIMENSION FROM FACE OF FINISH TO FACE OF FINISH.
- 11. FURNITURE IS NOT IN CONTRACT, U.N.O., AND IS SHOWN FOR DIAGRAMATIC PURPOSES ONLY.
- 12. CONSULTANT MODELS SHOWN FOR REFERENCE ONLY.

ENLARGED FLOOR PLAN - LEGEND

$\begin{array}{cccccccccccccccccccccccccccccccccccc$	CARPET RE: FINISH SCHED.		RUBBER (F7) RE LANDSCAPE
	TILE RE: FINISH SCHED.		CONCRETE (F8) RE: LANDSCAPE
	WOOD - UNIT RE: FINISH SCHED.		PAVERS (F9) RE: LANDSCAPE
	WOOD - PUBLIC RE: FINISH SCHED.		
	POLISHED CONC. (F5.1) INTERIOR		
	SEALED CONC. (F5.2) INTERIOR		
	HERRINGBONE TILE (F6) RE: FINISH SCHED.		
ENI	LARGED FLOOR PLAN - (CLEARA	NCE NOTES
	FLOOR CLEARANCE		

- A DOOR CLEARANCE, 54" X 60" B APPLIANCE CLEARANCE, 30" X 48" C CLEAR FLOOR CLEARANCE, 30" X 48" D VANITY CLEARANCE, 30" X 48" E TOILET CLEARANCE, 48" X 56" OR ADA 60" X 56" F SHOWER/TUB CLEARANCE, 30" X 48" (B) G TURN AROUND CLEARANCE
- GRAB BAR BLOCKING REQ. AT TOILET WALL WHERE APPLICABLE

ENLARGED RCP - GENERAL NOTES

- ALL UNIT CEILINGS SHALL BE 9' 0" A.F.F. U.N.O. REFER TO ENLARGED RCP'S FOR COMMON AREA CEILING HEIGHTS.
- IN THE CASE OF MINOR DISCREPANCIES BETWEEN MEP AND ARCHITECTURAL DOCUMENTS ON THE LOCATION OF CEILING MOUNTED COMPONENTS, THE ARCHITECTURAL RCP'S GOVERN. IN THE CASE OF MAJOR DISCREPANCIES, THE ARCHITECT SHALL BE NOTIFIED AS SOON AS THE DISCREPANCY IS DISCOVERED PRIOR TO PROCEEDING WITH THE WORK.
- REFERENCE MECHANICAL AND ELECTRICAL DRAWINGS FOR MOUNTING LOCATIONS OF ITEMS WHERE NO CEILING IS REQUIRED OR INDICATED.
- COORDINATE ALL TRADES INVOLVED IN THE CEILING WORK TO ENSURE CLEARANCE FOR FIXTURES, DUCTS, PIPING, CEILING SUSPENSION SYSTEMS, ETC. NECESSARY TO MAINTAIN CEILING HEIGHTS NOTED.
- LIGHTS, DIFFUSERS, EXIT SIGNS, SMOKE DETECTORS, SPEAKERS, STROBES, AND MISC. DEVICES SHALL BE CENTERED IN THE CEILING WHERE THEY OCCUR, U.N.O. FIRE PROTECTION SCOPE SHALL BE DESIGN-BUILD. ALL
- CORRIDOR SPRINKLER HEADS SHALL BE ALIGNED IN THE SAME LOCATION PARALLEL TO THE WALL WITHIN EACH SPECIFIC CEILING CONSTRUCTION. SMOKE ALARMS SHALL BE PROVIDED IN ALL BEDROOMS,

FL-01

11


- OUTSIDE OF ALL BEDROOMS, AND ON EACH FLOOR AS REQUIRED. CARBON MONOXIDE DETECTORS SHALL BE INSTALLED OUTSIDE OF ALL BEDROOMS. SMOKE ALARMS AND CO DETECTORS SHALL BE HARDWIRED AND HAVE BATTERY BACKUP.
- ACCESS DOOR LOCATIONS IN GYPSUM BOARD CEILINGS ARE INDICATED ON RCP'S ONLY WHERE ARCHITECTURALLY SIGNIFICANT. REFERENCE SPECIFICATIONS AND MEP DRAWINGS FOR OTHER ACCESS DOOR LOCATIONS.
- UNLESS PREFINISHED TO MATCH ADJACENT SURFACE, PAINT MECHANICAL GRILLS, DIFFUSERS, ACCESS PANELS, AND OTHER EQUIPMENT TO MATCH ADJACENT SURFACE.
- 10. EXIT SIGNS ARE SHOWN ON RCP'S ONLY WHERE LOCATIONS ARE ARCHITECTURALLY SIGNIFICANT. 11. PROVIDE UL-CLASSIFIED LIGHT FIXTURES OR
- ENCLOSURES IN RATED FLOOR/CEILING ASSEMBLIES IN ACCORDANCE WITH IBC CHAPTER 7. 12. REFER TO LIGHTING PLANS FOR EXACT FIXTURE TYPES AND LOCATIONS. FIXTURES SHOWN HERE ARE
- REFERENCED AND SHOWN FOR GENERAL ALIGNMENT.

ENLARGED RCP - LEGEND

GWB (C1) INTERIOR	\rightarrow	SLOPE CEILING AS NOTED
T&G CEILING (C2) INTERIOR	0	CEILING MOUNTED LIGHT FIXTURE
FIBER-CEMENT SOFFIT (C3) - EXTERIOR	+ + + + + +	VINYL SCRIM CLG - INTERIOR

	3 5 E S	GE STREET L CO 80211 12.3437	9 N
TO LICE	BRUCE B-2 12/15	CO (0) 0. WINS 465 /2023	
	The Amble	Steamboat Springs, CO	
REVISIONS No. 1 2		iption	Date 03.15.24 08.07.24
	THE A		3


A4.07.2

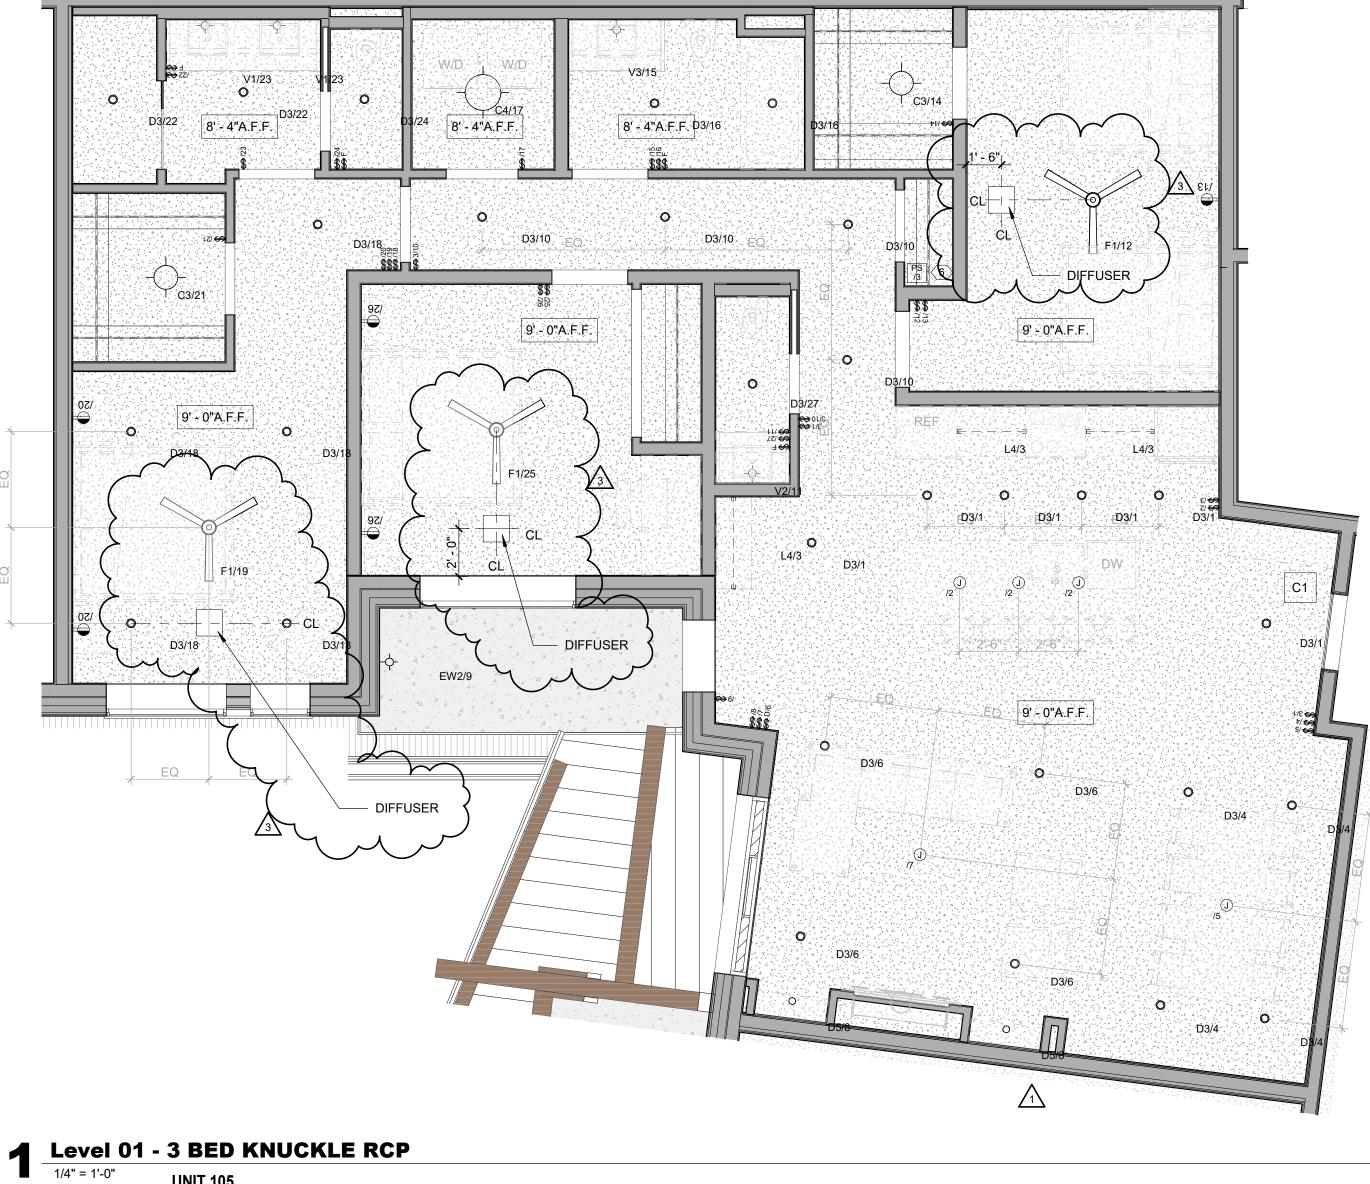

UNIT 105

ENLARGED FLOOR PLAN - GENERAL NOTES

- 1. REFER TO G0.2X SHEETS FOR EXTERIOR AND INTERIOR
- BUILDING ENCLOSURE ASSEMBLIES.2. REFER TO A1.0X SHEETS FOR EXTERIOR WALL, DEMISING
- WALL, AND CORRIDOR WALL TYPES AND LOCATIONS.
 REFER TO A1.1X SHEETS FOR INTERIOR AND EXTERIOR WINDOW/DOOR TAGS WITH UNIT BACKGROUNDS FOR REFERENCE.
- 4. ALIGN WALLS WHERE THEY APPEAR TO ALIGN, U.N.O.
- 5. THE INSIDE FACE OF DOOR JAMBS SHALL BE 4" FROM ADJACENT WALL OR FINISHED COLUMN, U.N.O.
- 6. PROVIDE BLOCKING FOR ALL WALL MOUNTED EQUIPMENT AND ACCESSORIES.
- 7. THE CENTERLINE OF ALL RESIDENTIAL TOILETS SHALL BE LOCATED 18" OFF OF FINISH FACE OF WALL, U.N.O.
- B. SWING CLEARANCE AT UNIT ENTRY SHALL BE 18" MIN.
- FROM FINISH FACE OF ADJACENT SURFACE. 9. ALL DIMENSIONS ARE TO FACE OF STUD, GRID LINE, OR FACE OF CONCRETE, U.N.O.
- 10. WHERE "CLEAR" IS CALLED OUT ON A DIMENSION, PROVIDE DIMENSION FROM FACE OF FINISH TO FACE OF FINISH.
- FURNITURE IS NOT IN CONTRACT, U.N.O., AND IS SHOWN FOR DIAGRAMATIC PURPOSES ONLY.
 CONSULTANT MODELS SHOWN FOR REFERENCE ONLY.

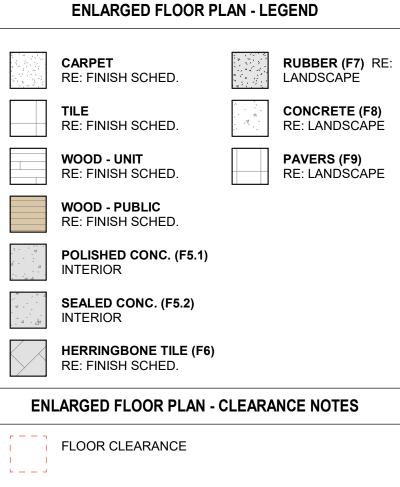

- A DOOR CLEARANCE, 54" X 60"
 B APPLIANCE CLEARANCE, 30" X 48"
 C CLEAR FLOOR CLEARANCE, 30" X 48"
 D VANITY CLEARANCE, 30" X 48"
 E TOILET CLEARANCE, 48" X 56" OR ADA 60" X 56"
 F SHOWER/TUB CLEARANCE, 30" X 48" (B)
 G TURN AROUND CLEARANCE
- GRAB BAR BLOCKING REQ. AT TOILET WALL WHERE APPLICABLE

ENLARGED RCP - GENERAL NOTES

- 1. ALL UNIT CEILINGS SHALL BE 9' 0" A.F.F. U.N.O. REFER TO ENLARGED RCP'S FOR COMMON AREA CEILING HEIGHTS.
- 2. IN THE CASE OF MINOR DISCREPANCIES BETWEEN MEP AND ARCHITECTURAL DOCUMENTS ON THE LOCATION OF CEILING MOUNTED COMPONENTS, THE ARCHITECTURAL RCP'S GOVERN. IN THE CASE OF MAJOR DISCREPANCIES, THE ARCHITECT SHALL BE NOTIFIED AS SOON AS THE DISCREPANCY IS DISCOVERED PRIOR TO PROCEEDING WITH THE WORK.
- 3. REFERENCE MECHANICAL AND ELECTRICAL DRAWINGS FOR MOUNTING LOCATIONS OF ITEMS WHERE NO CEILING IS REQUIRED OR INDICATED.
- 4. COORDINATE ALL TRADES INVOLVED IN THE CEILING WORK TO ENSURE CLEARANCE FOR FIXTURES, DUCTS, PIPING, CEILING SUSPENSION SYSTEMS, ETC. NECESSARY TO MAINTAIN CEILING HEIGHTS NOTED.
- LIGHTS, DIFFUSERS, EXIT SIGNS, SMOKE DETECTORS, SPEAKERS, STROBES, AND MISC. DEVICES SHALL BE CENTERED IN THE CEILING WHERE THEY OCCUR, U.N.O.
 FIRE PROTECTION SCOPE SHALL BE DESIGN-BUILD. ALL
- CORRIDOR SPRINKLER HEADS SHALL BE ALIGNED IN THE SAME LOCATION PARALLEL TO THE WALL WITHIN EACH SPECIFIC CEILING CONSTRUCTION.
 7. SMOKE ALARMS SHALL BE PROVIDED IN ALL BEDROOMS,
- OUTSIDE OF ALL BEDROOMS, AND ON EACH FLOOR AS REQUIRED. CARBON MONOXIDE DETECTORS SHALL BE INSTALLED OUTSIDE OF ALL BEDROOMS. SMOKE ALARMS AND CO DETECTORS SHALL BE HARDWIRED AND HAVE BATTERY BACKUP.
- 8. ACCESS DOOR LOCATIONS IN GYPSUM BOARD CEILINGS ARE INDICATED ON RCP'S ONLY WHERE ARCHITECTURALLY SIGNIFICANT. REFERENCE SPECIFICATIONS AND MEP DRAWINGS FOR OTHER ACCESS DOOR LOCATIONS.
- UNLESS PREFINISHED TO MATCH ADJACENT SURFACE, PAINT MECHANICAL GRILLS, DIFFUSERS, ACCESS PANELS, AND OTHER EQUIPMENT TO MATCH ADJACENT SURFACE.
 EXIT SIGNS ARE SHOWN ON RCP'S ONLY WHERE
- LOCATIONS ARE ARCHITECTURALLY SIGNIFICANT. 11. PROVIDE UL-CLASSIFIED LIGHT FIXTURES OR
- ENCLOSURES IN RATED FLOOR/CEILING ASSEMBLIES IN ACCORDANCE WITH IBC CHAPTER 7.12. REFER TO LIGHTING PLANS FOR EXACT FIXTURE TYPES AND LOCATIONS. FIXTURES SHOWN HERE ARE
- REFERENCED AND SHOWN FOR GENERAL ALIGNMENT.

 GWB (C1) INTERIOR	\rightarrow	SLOPE CEILING AS NOTED
T&G CEILING (C2) INTERIOR	0	CEILING MOUNTED LIGHT FIXTURE
FIBER-CEMENT SOFFIT (C3) - EXTERIOR	+ + + + + + + + + + + + + + + + + + + +	VINYL SCRIM CLG - INTERIOR
ACCESS PANEL		ACCOUSTIC VINYL TILE CLG - INTERIOF

D	3 5 E S	STAMP	Ð
Line Aller	BRUCE I B-24 12/15,	2023 465 72023	
	The Amble	Steamboat Springs, CO	
REVISIONS 1 2 3 1 PROJECT N ISSUE DATE			Date 06.14.24 08.07.24 10.16.24
BED		SET LAN - KNU(3 CKLE



1 Level 01 - 3 BED KNUCKLE FURNITURE

ENLARGED FLOOR PLAN - GENERAL NOTES

- REFER TO G0.2X SHEETS FOR EXTERIOR AND INTERIOR
- BUILDING ENCLOSURE ASSEMBLIES. REFER TO A1.0X SHEETS FOR EXTERIOR WALL, DEMISING
- WALL, AND CORRIDOR WALL TYPES AND LOCATIONS. REFER TO A1.1X SHEETS FOR INTERIOR AND EXTERIOR WINDOW/DOOR TAGS WITH UNIT BACKGROUNDS FOR REFERENCE.
- ALIGN WALLS WHERE THEY APPEAR TO ALIGN, U.N.O. 5. THE INSIDE FACE OF DOOR JAMBS SHALL BE 4" FROM
- ADJACENT WALL OR FINISHED COLUMN, U.N.O.
- PROVIDE BLOCKING FOR ALL WALL MOUNTED EQUIPMENT AND ACCESSORIES.
- THE CENTERLINE OF ALL RESIDENTIAL TOILETS SHALL BE
- LOCATED 18" OFF OF FINISH FACE OF WALL, U.N.O. SWING CLEARANCE AT UNIT ENTRY SHALL BE 18" MIN.
- FROM FINISH FACE OF ADJACENT SURFACE. ALL DIMENSIONS ARE TO FACE OF STUD, GRID LINE, OR
- FACE OF CONCRETE, U.N.O. 10. WHERE "CLEAR" IS CALLED OUT ON A DIMENSION,
- PROVIDE DIMENSION FROM FACE OF FINISH TO FACE OF FINISH. 11. FURNITURE IS NOT IN CONTRACT, U.N.O., AND IS SHOWN
- FOR DIAGRAMATIC PURPOSES ONLY. 12. CONSULTANT MODELS SHOWN FOR REFERENCE ONLY.

ENLARGED FLOOR PLAN - LEGEND

	CARPET RE: FINISH SCHED.		RUBBER (F7) RE LANDSCAPE
	TILE RE: FINISH SCHED.	· · · · · · · · · · · · · · · · · · ·	CONCRETE (F8) RE: LANDSCAPE
	WOOD - UNIT RE: FINISH SCHED.		PAVERS (F9) RE: LANDSCAPE
	WOOD - PUBLIC RE: FINISH SCHED.		
	POLISHED CONC. (F5.1) INTERIOR		
	SEALED CONC. (F5.2) INTERIOR		
	HERRINGBONE TILE (F6) RE: FINISH SCHED.		
ENI	LARGED FLOOR PLAN - (CLEARA	NCE NOTES
	FLOOR CLEARANCE		


- A DOOR CLEARANCE, 54" X 60" B APPLIANCE CLEARANCE, 30" X 48" C CLEAR FLOOR CLEARANCE, 30" X 48" D VANITY CLEARANCE, 30" X 48" E TOILET CLEARANCE, 48" X 56" OR ADA 60" X 56" F SHOWER/TUB CLEARANCE, 30" X 48" (B) G TURN AROUND CLEARANCE
- GRAB BAR BLOCKING REQ. AT TOILET WALL WHERE APPLICABLE


ENLARGED RCP - GENERAL NOTES

- ALL UNIT CEILINGS SHALL BE 9' 0" A.F.F. U.N.O. REFER TO ENLARGED RCP'S FOR COMMON AREA CEILING HEIGHTS.
- IN THE CASE OF MINOR DISCREPANCIES BETWEEN MEP AND ARCHITECTURAL DOCUMENTS ON THE LOCATION OF CEILING MOUNTED COMPONENTS, THE ARCHITECTURAL RCP'S GOVERN. IN THE CASE OF MAJOR DISCREPANCIES, THE ARCHITECT SHALL BE NOTIFIED AS SOON AS THE DISCREPANCY IS DISCOVERED PRIOR TO PROCEEDING WITH THE WORK.
- REFERENCE MECHANICAL AND ELECTRICAL DRAWINGS FOR MOUNTING LOCATIONS OF ITEMS WHERE NO CEILING IS REQUIRED OR INDICATED.
- COORDINATE ALL TRADES INVOLVED IN THE CEILING WORK TO ENSURE CLEARANCE FOR FIXTURES, DUCTS, PIPING, CEILING SUSPENSION SYSTEMS, ETC. NECESSARY TO MAINTAIN CEILING HEIGHTS NOTED.
- LIGHTS, DIFFUSERS, EXIT SIGNS, SMOKE DETECTORS, SPEAKERS, STROBES, AND MISC. DEVICES SHALL BE CENTERED IN THE CEILING WHERE THEY OCCUR, U.N.O. FIRE PROTECTION SCOPE SHALL BE DESIGN-BUILD. ALL
- CORRIDOR SPRINKLER HEADS SHALL BE ALIGNED IN THE SAME LOCATION PARALLEL TO THE WALL WITHIN EACH SPECIFIC CEILING CONSTRUCTION. SMOKE ALARMS SHALL BE PROVIDED IN ALL BEDROOMS,
- OUTSIDE OF ALL BEDROOMS, AND ON EACH FLOOR AS REQUIRED. CARBON MONOXIDE DETECTORS SHALL BE INSTALLED OUTSIDE OF ALL BEDROOMS. SMOKE ALARMS AND CO DETECTORS SHALL BE HARDWIRED AND HAVE BATTERY BACKUP.
- ACCESS DOOR LOCATIONS IN GYPSUM BOARD CEILINGS ARE INDICATED ON RCP'S ONLY WHERE ARCHITECTURALLY SIGNIFICANT. REFERENCE SPECIFICATIONS AND MEP DRAWINGS FOR OTHER ACCESS DOOR LOCATIONS.
- UNLESS PREFINISHED TO MATCH ADJACENT SURFACE, PAINT MECHANICAL GRILLS, DIFFUSERS, ACCESS PANELS, AND OTHER EQUIPMENT TO MATCH ADJACENT SURFACE. 10. EXIT SIGNS ARE SHOWN ON RCP'S ONLY WHERE
- LOCATIONS ARE ARCHITECTURALLY SIGNIFICANT. 11. PROVIDE UL-CLASSIFIED LIGHT FIXTURES OR ENCLOSURES IN RATED FLOOR/CEILING ASSEMBLIES IN
- ACCORDANCE WITH IBC CHAPTER 7. 12. REFER TO LIGHTING PLANS FOR EXACT FIXTURE TYPES AND LOCATIONS. FIXTURES SHOWN HERE ARE
- REFERENCED AND SHOWN FOR GENERAL ALIGNMENT.

$\begin{array}{cccccccccccccccccccccccccccccccccccc$	GWB (C1) INTERIOR	\rightarrow	SLOPE CEILING AS NOTED
	T&G CEILING (C2) INTERIOR	0	CEILING MOUNTED LIGHT FIXTURE
	FIBER-CEMENT SOFFIT (C3) - EXTERIOR	+ + + + + + + + + + + + + + + + + + + +	VINYL SCRIM CLG - INTERIOR

	35 E S	ISTAMP	
	B-2 12/15	2023 465 /2023	
	The Amble	Steamboat Springs, CO	
REVISIONS	Descr ASI 004		Date 07.24
	THE A IFC	O3	20019 15/2024

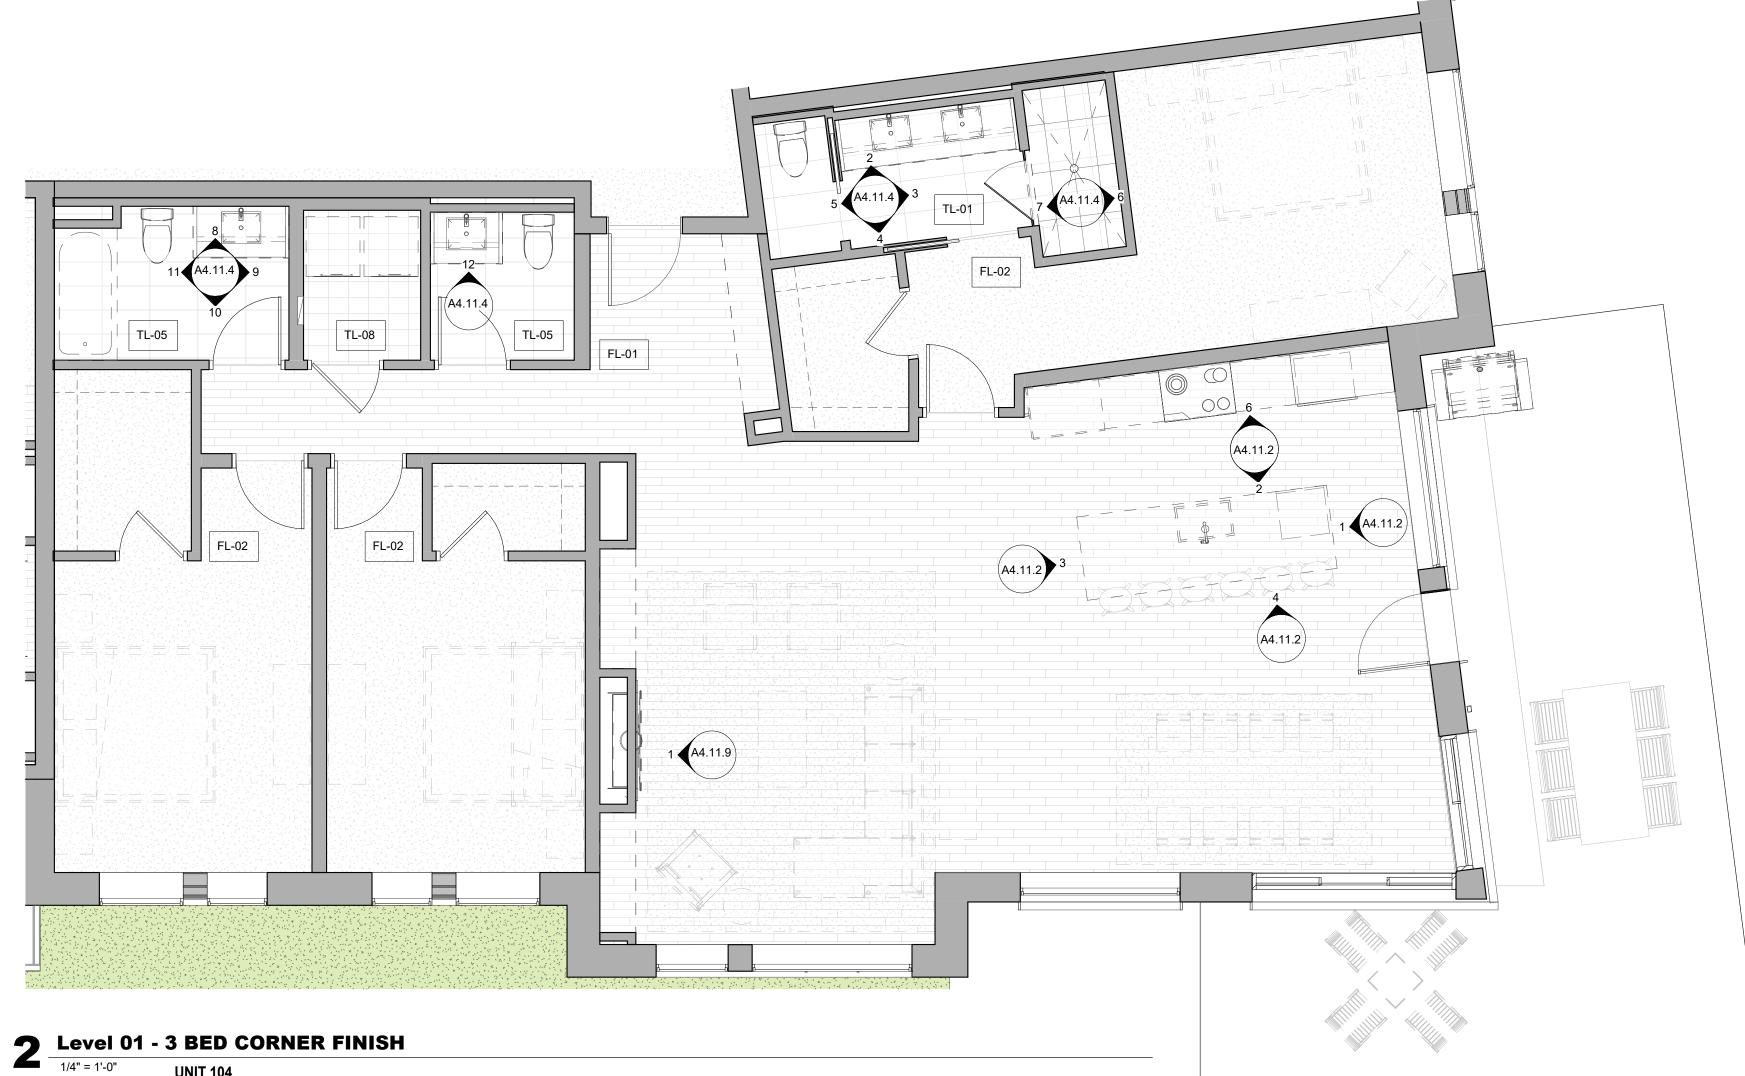

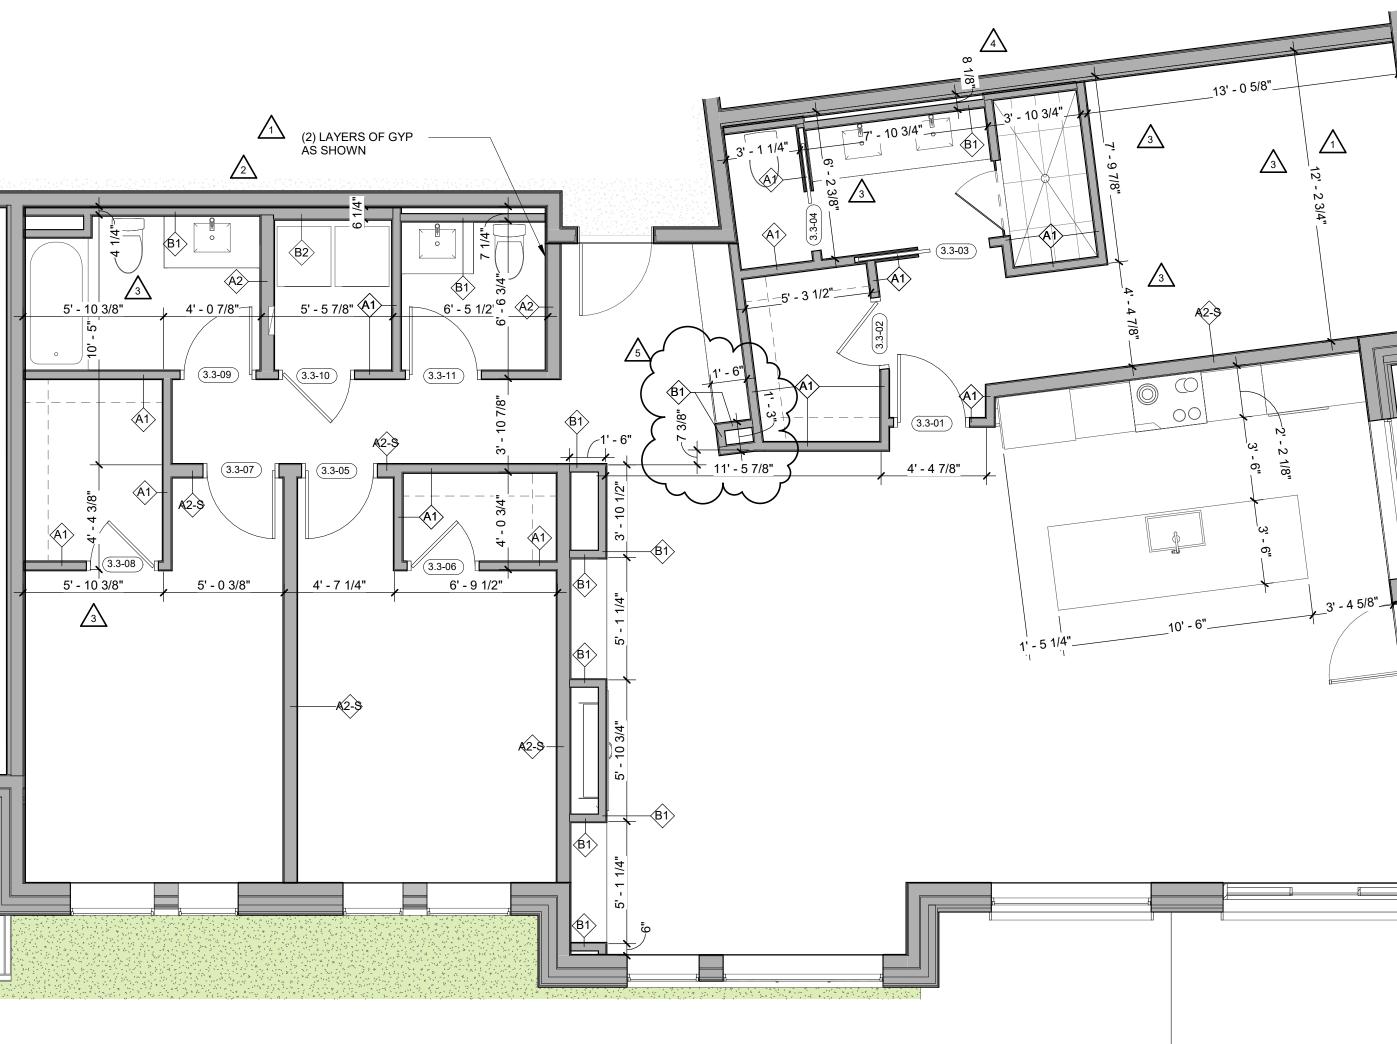

1/4" = 1'-0" UNIT 104

UNIT 104

Level 01 - 3 BED CORNER DIMENSION

ENLARGED FLOOR PLAN - GENERAL NOTES

- REFER TO G0.2X SHEETS FOR EXTERIOR AND INTERIOR BUILDING ENCLOSURE ASSEMBLIES. REFER TO A1.0X SHEETS FOR EXTERIOR WALL, DEMISING
- WALL, AND CORRIDOR WALL TYPES AND LOCATIONS. REFER TO A1.1X SHEETS FOR INTERIOR AND EXTERIOR WINDOW/DOOR TAGS WITH UNIT BACKGROUNDS FOR
- REFERENCE. ALIGN WALLS WHERE THEY APPEAR TO ALIGN, U.N.O. 5. THE INSIDE FACE OF DOOR JAMBS SHALL BE 4" FROM
- ADJACENT WALL OR FINISHED COLUMN, U.N.O. PROVIDE BLOCKING FOR ALL WALL MOUNTED EQUIPMENT
- AND ACCESSORIES.
- THE CENTERLINE OF ALL RESIDENTIAL TOILETS SHALL BE LOCATED 18" OFF OF FINISH FACE OF WALL, U.N.O. SWING CLEARANCE AT UNIT ENTRY SHALL BE 18" MIN.
- FROM FINISH FACE OF ADJACENT SURFACE. ALL DIMENSIONS ARE TO FACE OF STUD, GRID LINE, OR
- FACE OF CONCRETE, U.N.O. 10. WHERE "CLEAR" IS CALLED OUT ON A DIMENSION,
- PROVIDE DIMENSION FROM FACE OF FINISH TO FACE OF FINISH.
- 11. FURNITURE IS NOT IN CONTRACT, U.N.O., AND IS SHOWN FOR DIAGRAMATIC PURPOSES ONLY.
- 12. CONSULTANT MODELS SHOWN FOR REFERENCE ONLY.

ENLARGED FLOOR PLAN - LEGEND

	CARPET RE: FINISH SCHED.		RUBBER (F7) RE: LANDSCAPE
	TILE RE: FINISH SCHED.		CONCRETE (F8) RE: LANDSCAPE
	WOOD - UNIT RE: FINISH SCHED.		Pavers (F9) Re: Landscape
	WOOD - PUBLIC RE: FINISH SCHED.		
1 - 4 - 4	POLISHED CONC. (F5.1) INTERIOR		
	SEALED CONC. (F5.2) INTERIOR		
\searrow	HERRINGBONE TILE (F6) RE: FINISH SCHED.		
ENL	ARGED FLOOR PLAN - CL	EARANC	E NOTES
·	FLOOR CLEARANCE		

- A DOOR CLEARANCE, 54" X 60"
- B APPLIANCE CLEARANCE, 30" X 48"
- C CLEAR FLOOR CLEARANCE, 30" X 48"
- D VANITY CLEARANCE, 30" X 48"
- E TOILET CLEARANCE, 48" X 56" OR ADA 60" X 56"
- F SHOWER/TUB CLEARANCE, 30" X 48" (B) \triangle
- G TURN AROUND CLEARANCE
- GRAB BAR BLOCKING REQ. AT TOILET WALL WHERE APPLICABLE

ENLARGED RCP - GENERAL NOTES

- ALL UNIT CEILINGS SHALL BE 9' 0" A.F.F. U.N.O. REFER TO ENLARGED RCP'S FOR COMMON AREA CEILING HEIGHTS.
- IN THE CASE OF MINOR DISCREPANCIES BETWEEN MEP AND ARCHITECTURAL DOCUMENTS ON THE LOCATION OF CEILING MOUNTED COMPONENTS, THE ARCHITECTURAL RCP'S GOVERN. IN THE CASE OF MAJOR DISCREPANCIES, THE ARCHITECT SHALL BE NOTIFIED AS SOON AS THE DISCREPANCY IS DISCOVERED PRIOR TO PROCEEDING WITH THE WORK.
- REFERENCE MECHANICAL AND ELECTRICAL DRAWINGS FOR MOUNTING LOCATIONS OF ITEMS WHERE NO CEILING IS REQUIRED OR INDICATED.
- COORDINATE ALL TRADES INVOLVED IN THE CEILING WORK TO ENSURE CLEARANCE FOR FIXTURES, DUCTS, PIPING, CEILING SUSPENSION SYSTEMS, ETC. NECESSARY TO MAINTAIN CEILING HEIGHTS NOTED.
- LIGHTS, DIFFUSERS, EXIT SIGNS, SMOKE DETECTORS, SPEAKERS, STROBES, AND MISC. DEVICES SHALL BE CENTERED IN THE CEILING WHERE THEY OCCUR, U.N.O. 6. FIRE PROTECTION SCOPE SHALL BE DESIGN-BUILD. ALL
- CORRIDOR SPRINKLER HEADS SHALL BE ALIGNED IN THE SAME LOCATION PARALLEL TO THE WALL WITHIN EACH SPECIFIC CEILING CONSTRUCTION.
- SMOKE ALARMS SHALL BE PROVIDED IN ALL BEDROOMS, OUTSIDE OF ALL BEDROOMS, AND ON EACH FLOOR AS REQUIRED. CARBON MONOXIDE DETECTORS SHALL BE INSTALLED OUTSIDE OF ALL BEDROOMS. SMOKE ALARMS AND CO DETECTORS SHALL BE HARDWIRED AND HAVE BATTERY BACKUP.
- ACCESS DOOR LOCATIONS IN GYPSUM BOARD CEILINGS ARE INDICATED ON RCP'S ONLY WHERE ARCHITECTURALLY SIGNIFICANT. REFERENCE SPECIFICATIONS AND MEP DRAWINGS FOR OTHER
- ACCESS DOOR LOCATIONS. 9. UNLESS PREFINISHED TO MATCH ADJACENT SURFACE, PAINT MECHANICAL GRILLS, DIFFUSERS, ACCESS PANELS AND OTHER EQUIPM
- 10. EXIT SIGNS ARE SH LOCATIONS ARE AF
- 11. PROVIDE UL-CLASS ENCLOSURES IN RA
- ACCORDANCE WIT 12. REFER TO LIGHTIN AND LOCATIONS. F REFERENCED AND

MECHANICAL GRILLS, DIFF THER EQUIPMENT TO MAT IGNS ARE SHOWN ON RCP TONS ARE ARCHITECTURA DE UL-CLASSIFIED LIGHT F OSURES IN RATED FLOOR/(RDANCE WITH IBC CHAPTE TO LIGHTING PLANS FOR OCATIONS. FIXTURES SHO ENCED AND SHOWN FOR	CH ADJAC "S ONLY V LLY SIGNI IXTURES CEILING A R 7. EXACT FI, WN HERE	CENT SURFACE. VHERE FICANT. OR SSEMBLIES IN XTURE TYPES ARE	PROJECT	
				THE AMBLE
ENLARGED RCP	- LEGEN	D		IFC SET
GWB (C1) INTERIOR	\rightarrow	SLOPE CEILING AS NOTED		
T&G CEILING (C2) INTERIOR	0	CEILING MOUNTED LIGHT FIXTURE		UNIT PLAN - 3 DROOM CORNER -
FIBER-CEMENT SOFFIT (C3) - EXTERIOR	+ + + + + + + + + + + + + + + + + + +	VINYL SCRIM CLG - Interior		LEVEL 01
ACCESS PANEL		ACOUSTIC VINYL TILE CLG - INTERIOR		4.08.1

12/15/2023

TOWN STAMP

359 Design

3630 OSAGE STREET DENVER, CO 80211 720.512.3437

qu Ч Ч

EVISIONS		
No.	Description	Date
	IFC SET	03.15.24
	RFI #125	06.24.24
	ASI 004	08.07.24
	RFI #214	08.21.24
	RFI #388	01.06.25
		-
ROJECT N	UMBER	20019
SUE DATE		03/15/2024
	THE AMBLE	
SUE		
	IFC SET	
HEET TITLE	1	
	JNIT PLAN - 3 ROOM CORN LEVEL 01	





 $\sqrt{3}$

D3/1

ENLARGED FLOOR PLAN - GENERAL NOTES

- REFER TO G0.2X SHEETS FOR EXTERIOR AND INTERIOR BUILDING ENCLOSURE ASSEMBLIES.
- REFER TO A1.0X SHEETS FOR EXTERIOR WALL, DEMISING WALL, AND CORRIDOR WALL TYPES AND LOCATIONS.
- REFER TO A1.1X SHEETS FOR INTERIOR AND EXTERIOR WINDOW/DOOR TAGS WITH UNIT BACKGROUNDS FOR REFERENCE. ALIGN WALLS WHERE THEY APPEAR TO ALIGN, U.N.O.
- 5. THE INSIDE FACE OF DOOR JAMBS SHALL BE 4" FROM
- ADJACENT WALL OR FINISHED COLUMN, U.N.O. PROVIDE BLOCKING FOR ALL WALL MOUNTED EQUIPMENT
- AND ACCESSORIES. THE CENTERLINE OF ALL RESIDENTIAL TOILETS SHALL BE
- LOCATED 18" OFF OF FINISH FACE OF WALL, U.N.O. SWING CLEARANCE AT UNIT ENTRY SHALL BE 18" MIN.
- FROM FINISH FACE OF ADJACENT SURFACE.
- ALL DIMENSIONS ARE TO FACE OF STUD, GRID LINE, OR FACE OF CONCRETE, U.N.O. 10. WHERE "CLEAR" IS CALLED OUT ON A DIMENSION,
- PROVIDE DIMENSION FROM FACE OF FINISH TO FACE OF FINISH 11. FURNITURE IS NOT IN CONTRACT, U.N.O., AND IS SHOWN
- FOR DIAGRAMATIC PURPOSES ONLY. 12. CONSULTANT MODELS SHOWN FOR REFERENCE ONLY.

ENLARGED FLOOR PLAN - LEGEND

	CARPET RE: FINISH SCHED.		RUBBER (F7) R LANDSCAPE
	TILE RE: FINISH SCHED.	· · · · · · · · · · · · · · · · · · ·	CONCRETE (F8) Re: Landscape
	WOOD - UNIT RE: FINISH SCHED.		Pavers (F9) Re: Landscape
	WOOD - PUBLIC RE: FINISH SCHED.		
á - a	POLISHED CONC. (F5.1) INTERIOR		
	SEALED CONC. (F5.2) INTERIOR		
	HERRINGBONE TILE (F6) RE: FINISH SCHED.		
ENI	ARGED FLOOR PLAN - (CLEARA	NCE NOTES
	FLOOR CLEARANCE		
А	DOOR CLEARANCE, 54" X	60"	
D			

- B APPLIANCE CLEARANCE, 30" X 48"
- C CLEAR FLOOR CLEARANCE, 30" X 48"
- D VANITY CLEARANCE, 30" X 48"
- E TOILET CLEARANCE, 48" X 56" OR ADA 60" X 56"
- F SHOWER/TUB CLEARANCE, 30" X 48" (B)
- G TURN AROUND CLEARANCE
- GRAB BAR BLOCKING REQ. AT TOILET WALL WHERE APPLICABLE

ENLARGED RCP - GENERAL NOTES

- ALL UNIT CEILINGS SHALL BE 9' 0" A.F.F. U.N.O. REFER TO ENLARGED RCP'S FOR COMMON AREA CEILING HEIGHTS. IN THE CASE OF MINOR DISCREPANCIES BETWEEN MEP
- AND ARCHITECTURAL DOCUMENTS ON THE LOCATION OF CEILING MOUNTED COMPONENTS, THE ARCHITECTURAL RCP'S GOVERN. IN THE CASE OF MAJOR DISCREPANCIES, THE ARCHITECT SHALL BE NOTIFIED AS SOON AS THE DISCREPANCY IS DISCOVERED PRIOR TO PROCEEDING WITH THE WORK.
- REFERENCE MECHANICAL AND ELECTRICAL DRAWINGS FOR MOUNTING LOCATIONS OF ITEMS WHERE NO CEILING IS REQUIRED OR INDICATED.
- COORDINATE ALL TRADES INVOLVED IN THE CEILING WORK TO ENSURE CLEARANCE FOR FIXTURES, DUCTS, PIPING, CEILING SUSPENSION SYSTEMS, ETC. NECESSARY TO MAINTAIN CEILING HEIGHTS NOTED.
- LIGHTS, DIFFUSERS, EXIT SIGNS, SMOKE DETECTORS, SPEAKERS, STROBES, AND MISC. DEVICES SHALL BE CENTERED IN THE CEILING WHERE THEY OCCUR, U.N.O. FIRE PROTECTION SCOPE SHALL BE DESIGN-BUILD. ALL
- CORRIDOR SPRINKLER HEADS SHALL BE ALIGNED IN THE SAME LOCATION PARALLEL TO THE WALL WITHIN EACH SPECIFIC CEILING CONSTRUCTION.
- SMOKE ALARMS SHALL BE PROVIDED IN ALL BEDROOMS, OUTSIDE OF ALL BEDROOMS, AND ON EACH FLOOR AS REQUIRED. CARBON MONOXIDE DETECTORS SHALL BE INSTALLED OUTSIDE OF ALL BEDROOMS. SMOKE ALARMS AND CO DETECTORS SHALL BE HARDWIRED AND HAVE BATTERY BACKUP.
- ACCESS DOOR LOCATIONS IN GYPSUM BOARD CEILINGS ARE INDICATED ON RCP'S ONLY WHERE ARCHITECTURALLY SIGNIFICANT. REFERENCE SPECIFICATIONS AND MEP DRAWINGS FOR OTHER ACCESS DOOR LOCATIONS.
- UNLESS PREFINISHED TO MATCH ADJACENT SURFACE, PAINT MECHANICAL GRILLS, DIFFUSERS, ACCESS PANELS, AND OTHER EQUIPMENT TO MATCH ADJACENT SURFACE.
- 10. EXIT SIGNS ARE SHOWN ON RCP'S ONLY WHERE LOCATIONS ARE ARCHITECTURALLY SIGNIFICANT. 11. PROVIDE UL-CLASSIFIED LIGHT FIXTURES OR
- ENCLOSURES IN RATED FLOOR/CEILING ASSEMBLIES IN ACCORDANCE WITH IBC CHAPTER 7. 12. REFER TO LIGHTING PLANS FOR EXACT FIXTURE TYPES AND LOCATIONS. FIXTURES SHOWN HERE ARE
- REFERENCED AND SHOWN FOR GENERAL ALIGNMENT.


ENLARGED RCP - LEGEND


- 1 - 1 - 1 - 1 - 1 - 1 - 1 - 1 - 1 - 1	GWB (C1) INTERIOR	\rightarrow	SLOPE CEILING AS NOTED
	T&G CEILING (C2) INTERIOR	0	CEILING MOUNTED
	FIBER-CEMENT SOFFIT (C3) - EXTERIOR	+ + + + + + + + + + + + + + + + + + + +	VINYL SCRIM CLG INTERIOR
\square	ACCESS PANEL		ACCOUSTIC VINYL Tile Clg - Interio

SHEET NO.

A4.08.2

35 DES	ASTAMP S S S S S S S S S S S S S S S S S S S
BASE BASE 12/15	COLORIS D. WINS 465 /2023
The Amble	Steamboat Springs, CO
No. Descr 1 RFI #110 2 RFI #132 3 ASI 004 4 RFI #223.1 - - - - - - - - - - - - - - - - - -	iption Date 06:14:24 07:31:24 08:07:24 10:16:24 10 10
ISSUE	20019 03/15/2024 AMBLE SET

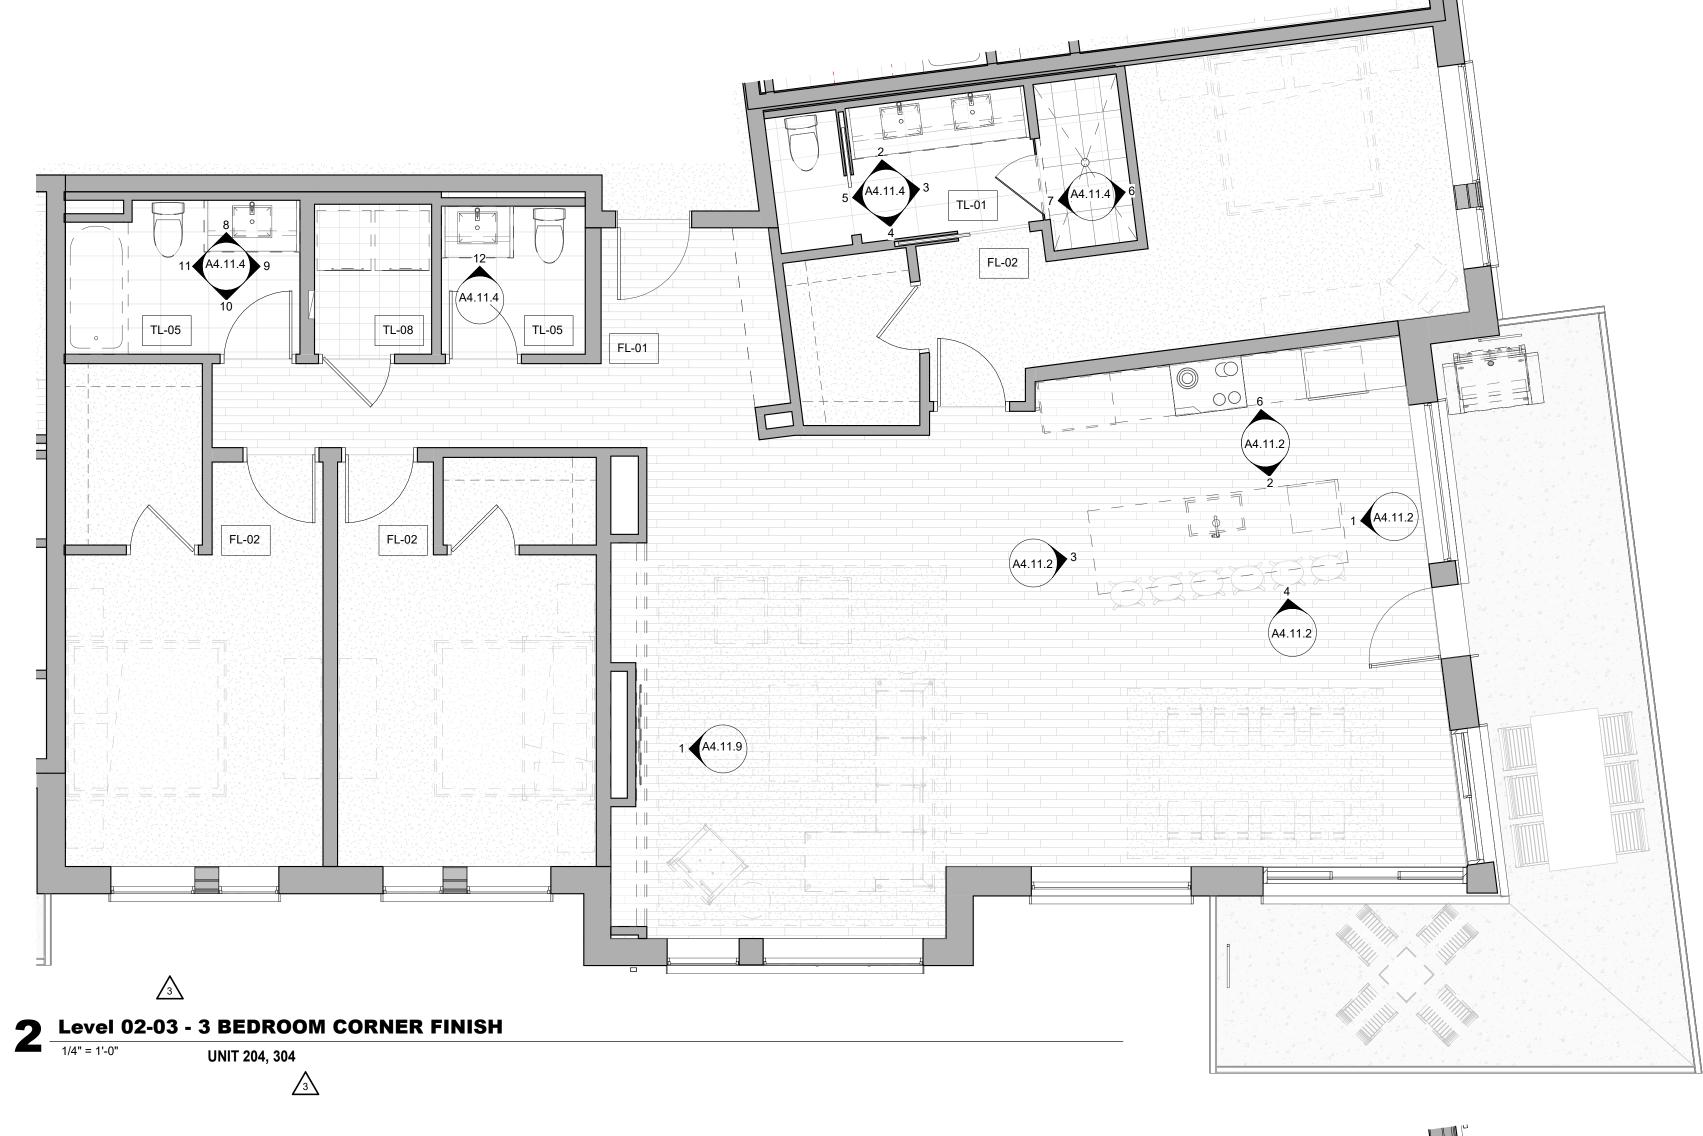

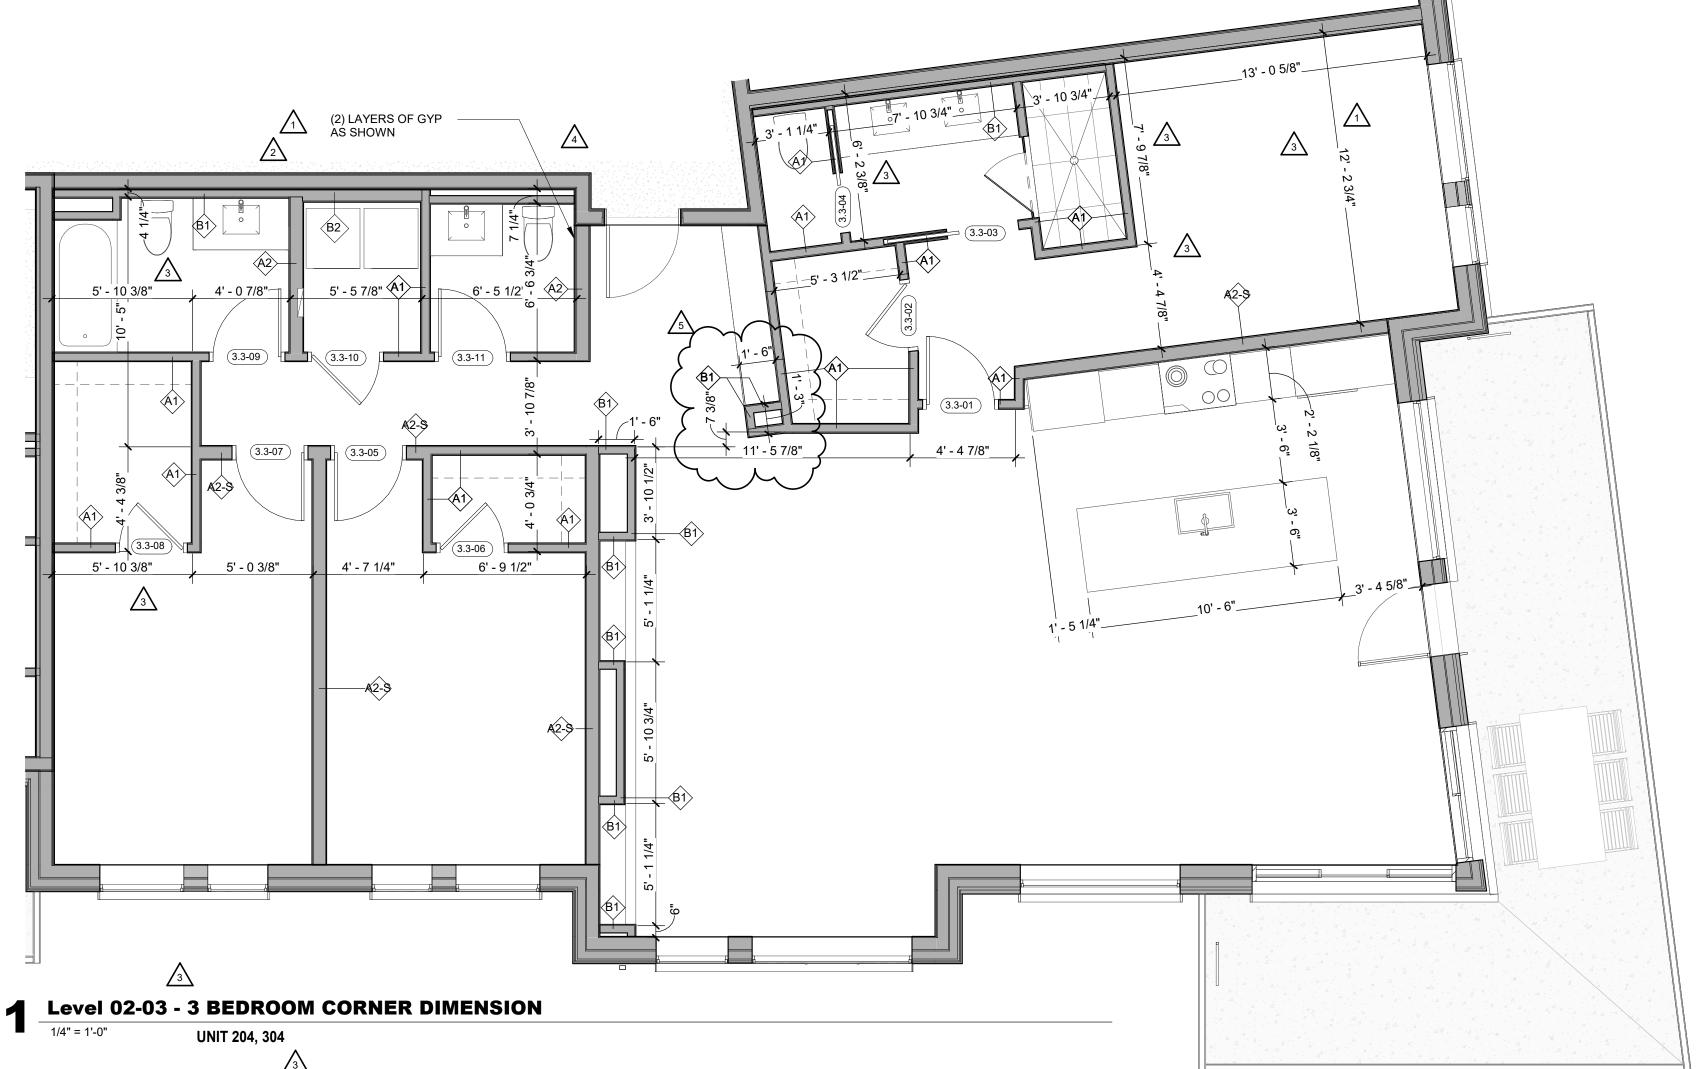

- REFER TO G0.2X SHEETS FOR EXTERIOR AND INTERIOR BUILDING ENCLOSURE ASSEMBLIES. REFER TO A1.0X SHEETS FOR EXTERIOR WALL, DEMISING
- WALL, AND CORRIDOR WALL TYPES AND LOCATIONS. REFER TO A1.1X SHEETS FOR INTERIOR AND EXTERIOR WINDOW/DOOR TAGS WITH UNIT BACKGROUNDS FOR
- REFERENCE. ALIGN WALLS WHERE THEY APPEAR TO ALIGN, U.N.O. 5. THE INSIDE FACE OF DOOR JAMBS SHALL BE 4" FROM
- ADJACENT WALL OR FINISHED COLUMN, U.N.O. PROVIDE BLOCKING FOR ALL WALL MOUNTED EQUIPMENT
- AND ACCESSORIES. THE CENTERLINE OF ALL RESIDENTIAL TOILETS SHALL BE
- LOCATED 18" OFF OF FINISH FACE OF WALL, U.N.O. SWING CLEARANCE AT UNIT ENTRY SHALL BE 18" MIN.
- FROM FINISH FACE OF ADJACENT SURFACE. ALL DIMENSIONS ARE TO FACE OF STUD, GRID LINE, OR
- FACE OF CONCRETE, U.N.O. 10. WHERE "CLEAR" IS CALLED OUT ON A DIMENSION,
- PROVIDE DIMENSION FROM FACE OF FINISH TO FACE OF FINISH.
- 11. FURNITURE IS NOT IN CONTRACT, U.N.O., AND IS SHOWN FOR DIAGRAMATIC PURPOSES ONLY.
- 12. CONSULTANT MODELS SHOWN FOR REFERENCE ONLY.

ENLARGED FLOOR PLAN - LEGEND

	CARPET RE: FINISH SCHED.		RUBBER (F7) RE: LANDSCAPE
	TILE RE: FINISH SCHED.		CONCRETE (F8) RE: LANDSCAPE
	WOOD - UNIT RE: FINISH SCHED.		Pavers (F9) Re: Landscape
	WOOD - PUBLIC RE: FINISH SCHED.		
4 - 4 4 - 4	POLISHED CONC. (F5.1) INTERIOR		
	SEALED CONC. (F5.2) INTERIOR		
	HERRINGBONE TILE (F6) RE: FINISH SCHED.		
ENL	ARGED FLOOR PLAN - CLI	EARANC	E NOTES
	FLOOR CLEARANCE		
Α	DOOR CLEARANCE, 54" X 60	n	
В	APPLIANCE CLEARANCE, 30	" X 48"	

- C CLEAR FLOOR CLEARANCE, 30" X 48"
- D VANITY CLEARANCE, 30" X 48"
- E TOILET CLEARANCE, 48" X 56" OR ADA 60" X 56" \triangle
- F SHOWER/TUB CLEARANCE, 30" X 48" (B) G TURN AROUND CLEARANCE
- GRAB BAR BLOCKING REQ. AT TOILET
- WALL WHERE APPLICABLE

ENLARGED RCP - GENERAL NOTES

- ALL UNIT CEILINGS SHALL BE 9' 0" A.F.F. U.N.O. REFER TO ENLARGED RCP'S FOR COMMON AREA CEILING HEIGHTS.
- IN THE CASE OF MINOR DISCREPANCIES BETWEEN MEP AND ARCHITECTURAL DOCUMENTS ON THE LOCATION OF CEILING MOUNTED COMPONENTS, THE ARCHITECTURAL RCP'S GOVERN. IN THE CASE OF MAJOR DISCREPANCIES, THE ARCHITECT SHALL BE NOTIFIED AS SOON AS THE DISCREPANCY IS DISCOVERED PRIOR TO PROCEEDING
- WITH THE WORK. REFERENCE MECHANICAL AND ELECTRICAL DRAWINGS FOR MOUNTING LOCATIONS OF ITEMS WHERE NO CEILING IS REQUIRED OR INDICATED.
- COORDINATE ALL TRADES INVOLVED IN THE CEILING WORK TO ENSURE CLEARANCE FOR FIXTURES, DUCTS, PIPING, CEILING SUSPENSION SYSTEMS, ETC. NECESSARY TO MAINTAIN CEILING HEIGHTS NOTED.
- LIGHTS, DIFFUSERS, EXIT SIGNS, SMOKE DETECTORS, SPEAKERS, STROBES, AND MISC. DEVICES SHALL BE CENTERED IN THE CEILING WHERE THEY OCCUR, U.N.O. FIRE PROTECTION SCOPE SHALL BE DESIGN-BUILD. ALL
- CORRIDOR SPRINKLER HEADS SHALL BE ALIGNED IN THE SAME LOCATION PARALLEL TO THE WALL WITHIN EACH SPECIFIC CEILING CONSTRUCTION.
- SMOKE ALARMS SHALL BE PROVIDED IN ALL BEDROOMS, OUTSIDE OF ALL BEDROOMS, AND ON EACH FLOOR AS REQUIRED. CARBON MONOXIDE DETECTORS SHALL BE INSTALLED OUTSIDE OF ALL BEDROOMS. SMOKE ALARMS AND CO DETECTORS SHALL BE HARDWIRED AND HAVE BATTERY BACKUP.
- ACCESS DOOR LOCATIONS IN GYPSUM BOARD CEILINGS ARE INDICATED ON RCP'S ONLY WHERE ARCHITECTURALLY SIGNIFICANT. REFERENCE SPECIFICATIONS AND MEP DRAWINGS FOR OTHER
- ACCESS DOOR LOCATIONS. UNLESS PREFINISHED TO MATCH ADJACENT SURFACE, PAINT MECHANICAL GRILLS, DIFFUSERS, ACCESS PANELS, AND OTHER EQUIPMENT TO MATCH ADJACENT SURFACE.
- 10. EXIT SIGNS ARE SHOWN ON RCP'S ONLY WHERE LOCATIONS ARE ARCHITECTURALLY SIGNIFICANT.
- 11. PROVIDE UL-CLASSIFIED LIGHT FIXTURES OR ENCLOSURES IN RATED FLOOR/CEILING ASSEMBLIES IN

REFER	RDANCE WITH IBC CHAPTER TO LIGHTING PLANS FOR I OCATIONS. FIXTURES SHOV RENCED AND SHOWN FOR (EXACT FI) WN HERE	ARE	
	ENLARGED RCP -	LEGENI	ס	
	GWB (C1) INTERIOR	\rightarrow	SLOPE CEILING AS NOTED	
	T&G CEILING (C2) INTERIOR	0	CEILING MOUNTED LIGHT FIXTURE	
	FIBER-CEMENT SOFFIT (C3) - EXTERIOR	+ + + + + + + + + + + + + + + + + + + +	VINYL SCRIM CLG - INTERIOR	
	ACCESS PANEL		ACOUSTIC VINYL TILE CLG - INTERIOR	

<text><text></text></text>
BRNCE D. WINS B-2465 12/15/2023
The Amble Steamboat Springs, CO
IFC SET SHEET TITLE UNIT PLAN - 3 BEDROOM CORNER - LEVELS 02-03 SHEET NO. BHEET NO.





2

D3/1

ENLARGED FLOOR PLAN - GENERAL NOTES

- REFER TO G0.2X SHEETS FOR EXTERIOR AND INTERIOR BUILDING ENCLOSURE ASSEMBLIES.
- REFER TO A1.0X SHEETS FOR EXTERIOR WALL, DEMISING WALL, AND CORRIDOR WALL TYPES AND LOCATIONS.
- REFER TO A1.1X SHEETS FOR INTERIOR AND EXTERIOR WINDOW/DOOR TAGS WITH UNIT BACKGROUNDS FOR REFERENCE.
- ALIGN WALLS WHERE THEY APPEAR TO ALIGN, U.N.O. 5. THE INSIDE FACE OF DOOR JAMBS SHALL BE 4" FROM
- ADJACENT WALL OR FINISHED COLUMN, U.N.O. PROVIDE BLOCKING FOR ALL WALL MOUNTED EQUIPMENT
- AND ACCESSORIES. THE CENTERLINE OF ALL RESIDENTIAL TOILETS SHALL BE
- LOCATED 18" OFF OF FINISH FACE OF WALL, U.N.O. SWING CLEARANCE AT UNIT ENTRY SHALL BE 18" MIN.
- FROM FINISH FACE OF ADJACENT SURFACE. ALL DIMENSIONS ARE TO FACE OF STUD, GRID LINE, OR
- FACE OF CONCRETE, U.N.O. 10. WHERE "CLEAR" IS CALLED OUT ON A DIMENSION,
- PROVIDE DIMENSION FROM FACE OF FINISH TO FACE OF FINISH 11. FURNITURE IS NOT IN CONTRACT, U.N.O., AND IS SHOWN
- FOR DIAGRAMATIC PURPOSES ONLY. 12. CONSULTANT MODELS SHOWN FOR REFERENCE ONLY.

ENLARGED FLOOR PLAN - LEGEND

	CARPET RE: FINISH SCHED.		RUBBER (F7) RE LANDSCAPE			
	TILE RE: FINISH SCHED.		CONCRETE (F8) RE: LANDSCAPE			
	WOOD - UNIT RE: FINISH SCHED.		PAVERS (F9) RE: LANDSCAPE			
	WOOD - PUBLIC RE: FINISH SCHED.					
	POLISHED CONC. (F5.1) INTERIOR					
	SEALED CONC. (F5.2) INTERIOR					
	HERRINGBONE TILE (F6) RE: FINISH SCHED.					
ENI	ARGED FLOOR PLAN - (CLEARA	NCE NOTES			
	FLOOR CLEARANCE					
А	DOOR CLEARANCE, 54" X 60"					
В	APPLIANCE CLEARANCE, 30" X 48"					
C						

- C CLEAR FLOOR CLEARANCE, 30" X 48"
- D VANITY CLEARANCE, 30" X 48"
- E TOILET CLEARANCE, 48" X 56" OR ADA 60" X 56"
- F SHOWER/TUB CLEARANCE, 30" X 48" (B)
- G TURN AROUND CLEARANCE
- GRAB BAR BLOCKING REQ. AT TOILET

WALL WHERE APPLICABLE

ENLARGED RCP - GENERAL NOTES

- ALL UNIT CEILINGS SHALL BE 9' 0" A.F.F. U.N.O. REFER TO ENLARGED RCP'S FOR COMMON AREA CEILING HEIGHTS.
- IN THE CASE OF MINOR DISCREPANCIES BETWEEN MEP AND ARCHITECTURAL DOCUMENTS ON THE LOCATION OF CEILING MOUNTED COMPONENTS, THE ARCHITECTURAL RCP'S GOVERN. IN THE CASE OF MAJOR DISCREPANCIES, THE ARCHITECT SHALL BE NOTIFIED AS SOON AS THE DISCREPANCY IS DISCOVERED PRIOR TO PROCEEDING WITH THE WORK.
- REFERENCE MECHANICAL AND ELECTRICAL DRAWINGS FOR MOUNTING LOCATIONS OF ITEMS WHERE NO CEILING IS REQUIRED OR INDICATED.
- COORDINATE ALL TRADES INVOLVED IN THE CEILING WORK TO ENSURE CLEARANCE FOR FIXTURES, DUCTS, PIPING, CEILING SUSPENSION SYSTEMS, ETC. NECESSARY TO MAINTAIN CEILING HEIGHTS NOTED.
- LIGHTS, DIFFUSERS, EXIT SIGNS, SMOKE DETECTORS, SPEAKERS, STROBES, AND MISC. DEVICES SHALL BE CENTERED IN THE CEILING WHERE THEY OCCUR, U.N.O. FIRE PROTECTION SCOPE SHALL BE DESIGN-BUILD. ALL
- CORRIDOR SPRINKLER HEADS SHALL BE ALIGNED IN THE SAME LOCATION PARALLEL TO THE WALL WITHIN EACH SPECIFIC CEILING CONSTRUCTION.
- SMOKE ALARMS SHALL BE PROVIDED IN ALL BEDROOMS, OUTSIDE OF ALL BEDROOMS, AND ON EACH FLOOR AS REQUIRED. CARBON MONOXIDE DETECTORS SHALL BE INSTALLED OUTSIDE OF ALL BEDROOMS. SMOKE ALARMS AND CO DETECTORS SHALL BE HARDWIRED AND HAVE BATTERY BACKUP.
- ACCESS DOOR LOCATIONS IN GYPSUM BOARD CEILINGS ARE INDICATED ON RCP'S ONLY WHERE ARCHITECTURALLY SIGNIFICANT. REFERENCE SPECIFICATIONS AND MEP DRAWINGS FOR OTHER ACCESS DOOR LOCATIONS.
- UNLESS PREFINISHED TO MATCH ADJACENT SURFACE, PAINT MECHANICAL GRILLS, DIFFUSERS, ACCESS PANELS, AND OTHER EQUIPMENT TO MATCH ADJACENT SURFACE.
- 10. EXIT SIGNS ARE SHOWN ON RCP'S ONLY WHERE LOCATIONS ARE ARCHITECTURALLY SIGNIFICANT. 11. PROVIDE UL-CLASSIFIED LIGHT FIXTURES OR
- ENCLOSURES IN RATED FLOOR/CEILING ASSEMBLIES IN ACCORDANCE WITH IBC CHAPTER 7. 12. REFER TO LIGHTING PLANS FOR EXACT FIXTURE TYPES AND LOCATIONS. FIXTURES SHOWN HERE ARE
- REFERENCED AND SHOWN FOR GENERAL ALIGNMENT.

ENLARGED RCP - LEGEND

(* * (* *) (* *) (* *) (* *) (* *) (* *)	GWB (C1) INTERIOR	\rightarrow	SLOPE CEILING AS NOTED
	T&G CEILING (C2) INTERIOR	0	CEILING MOUNTED LIGHT FIXTURE
	FIBER-CEMENT SOFFIT	+ +	VINYL SCRIM CLG -
	(C3) - EXTERIOR	+ + +	INTERIOR

_

D	3 E \$	NWN STAMP	B
	BASE B-	CO ED.WINS 2465 15/2023 ARCW	
	The Amble	Steamboat Springs, CO	
REVISIONS No. 1 2 3	RFI #110 ASI 004 RFI #223.1	cription	Date 06.14.24 08.07.24 10.16.24
ISSUE DATE	THE	AMBLE C SET	03/15/2024

UNIT PLAN - 3
BEDROOM CORNER -
LEVELS 02-03

A4.08.4

SHEET TITLE

SHEET NO.