












Level 00 SITE ACCESSIBILITY
1/16" = 1'-0"



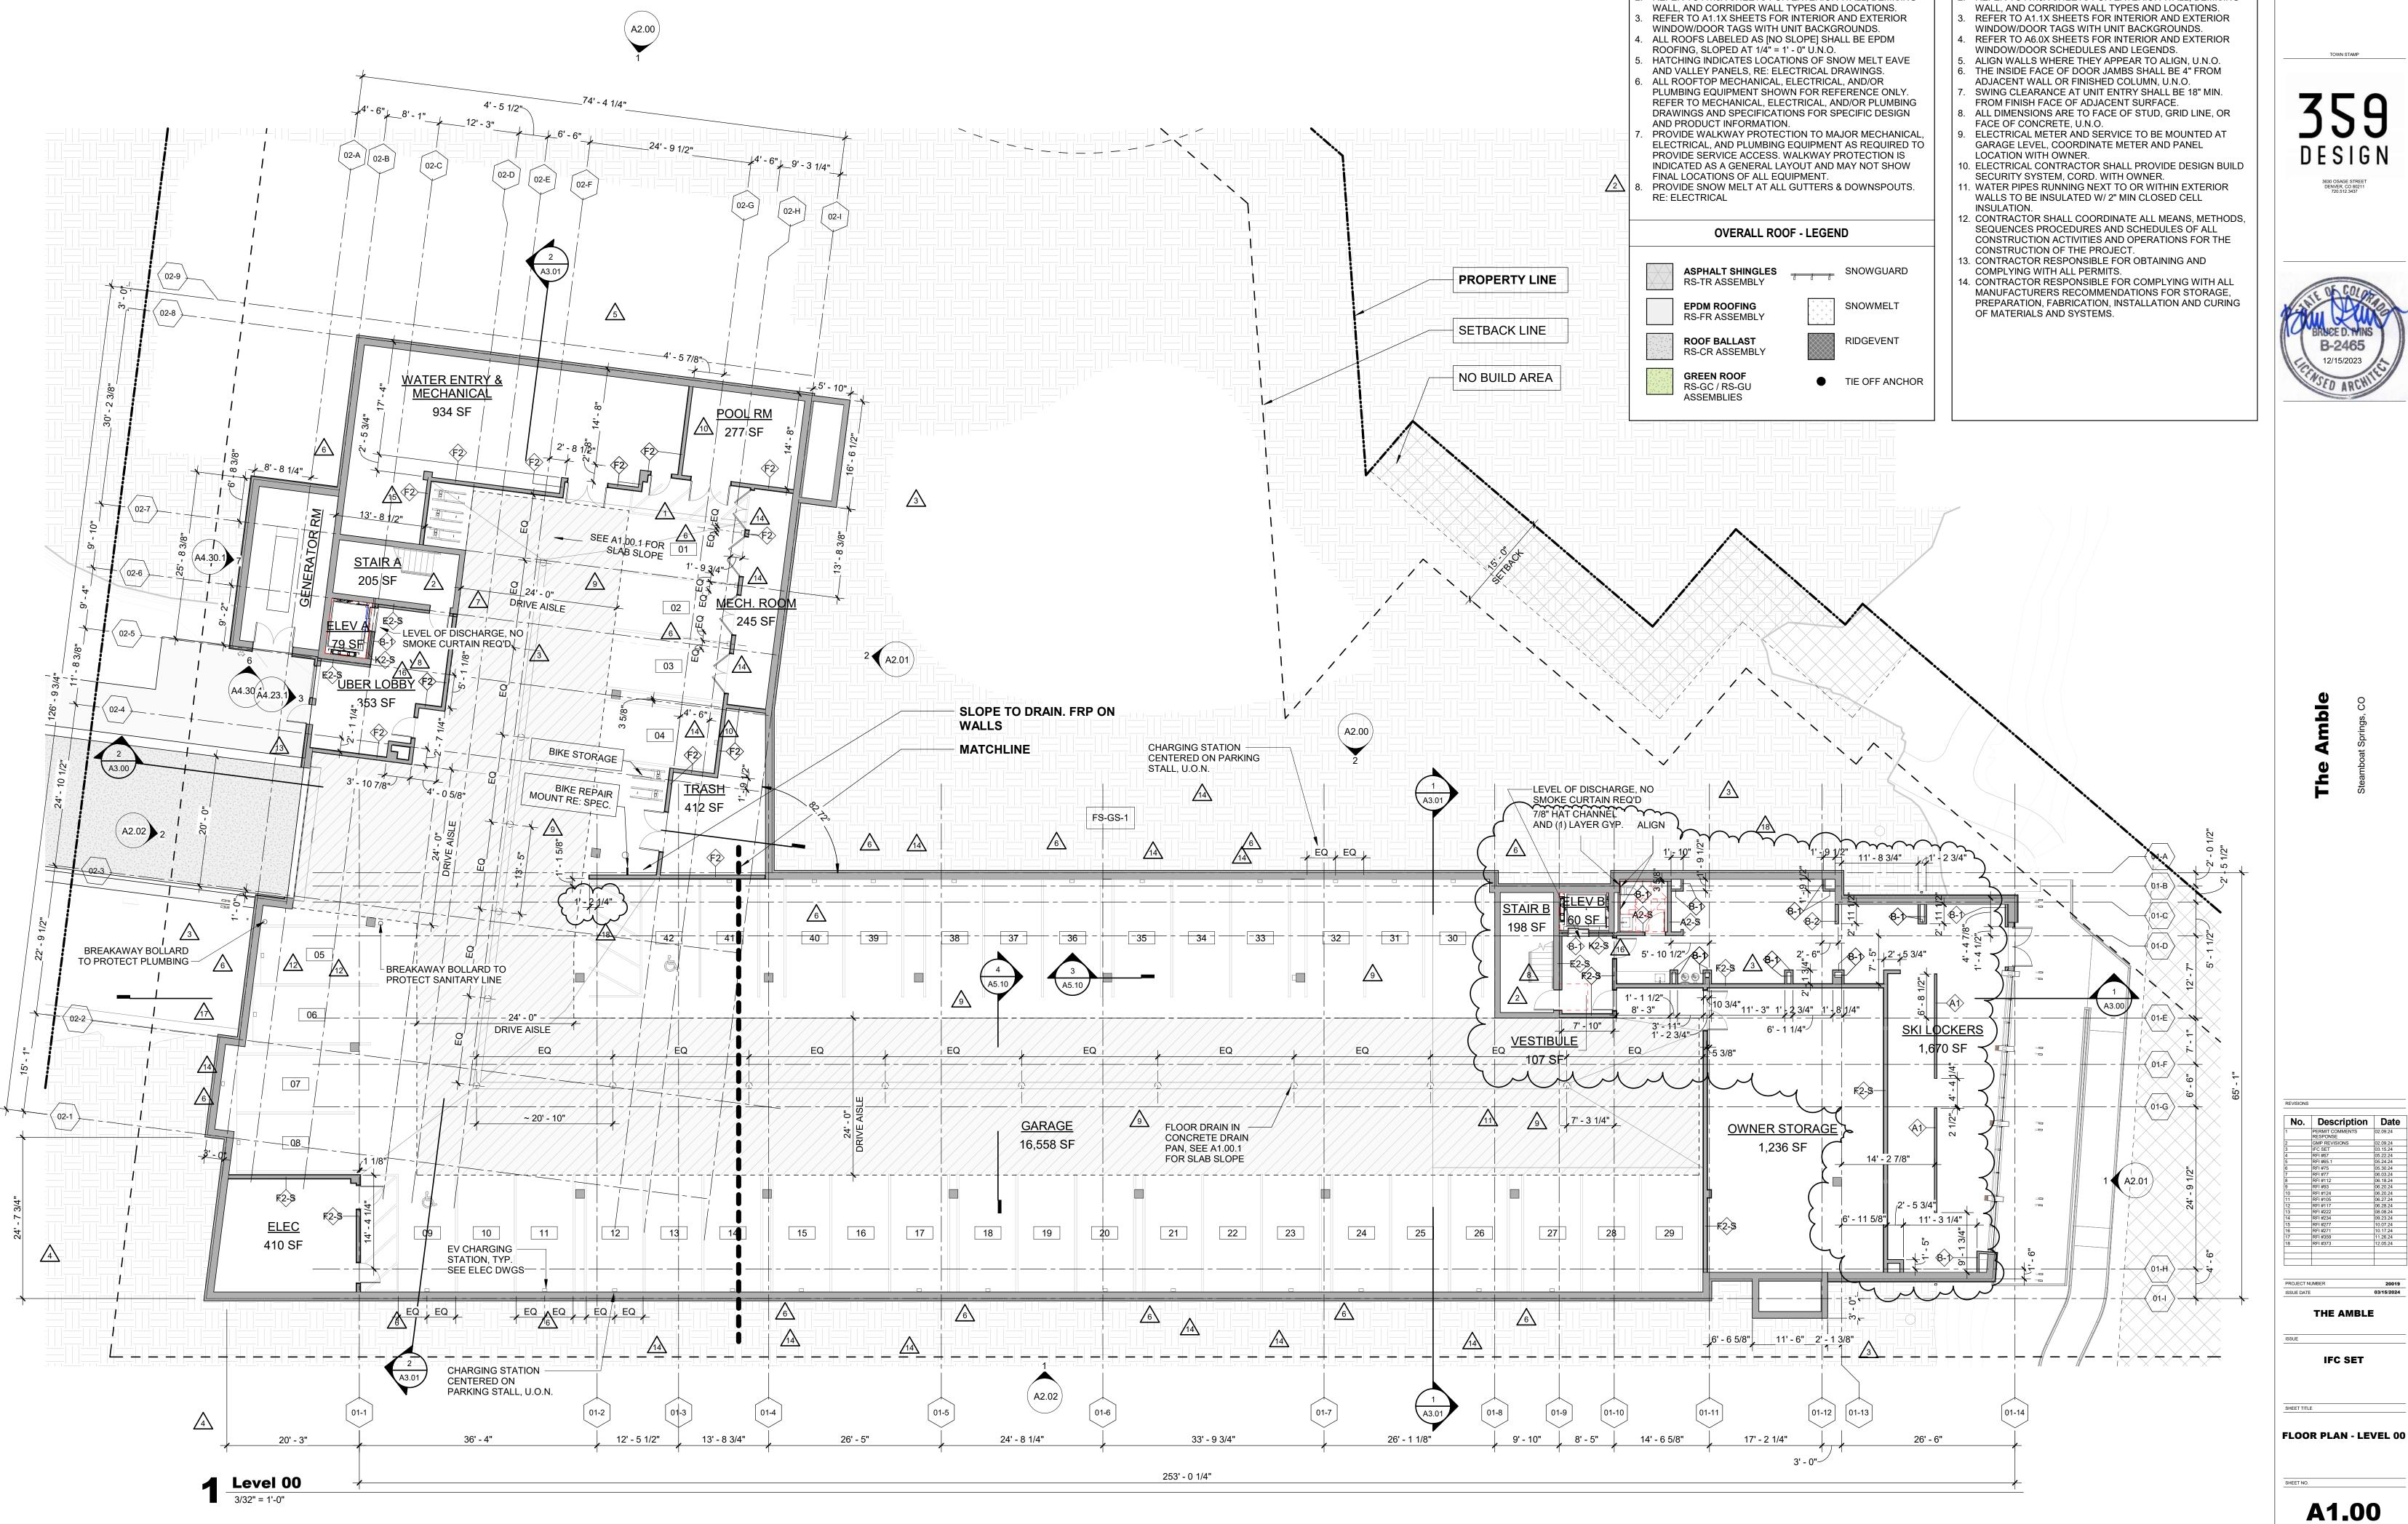


REFER TO G0.2X SHEETS FOR EXTERIOR AND INTERIOR

BUILDING ENCLOSURE ASSEMBLIES. REFER TO A1.0X SHEETS FOR EXTERIOR WALL, DEMISING

## **OVERALL PLAN - GENERAL NOTES**

- REFER TO G0.2X SHEETS FOR EXTERIOR AND INTERIOR BUILDING ENCLOSURE ASSEMBLIES.
- REFER TO A1.0X SHEETS FOR EXTERIOR WALL, DEMISING



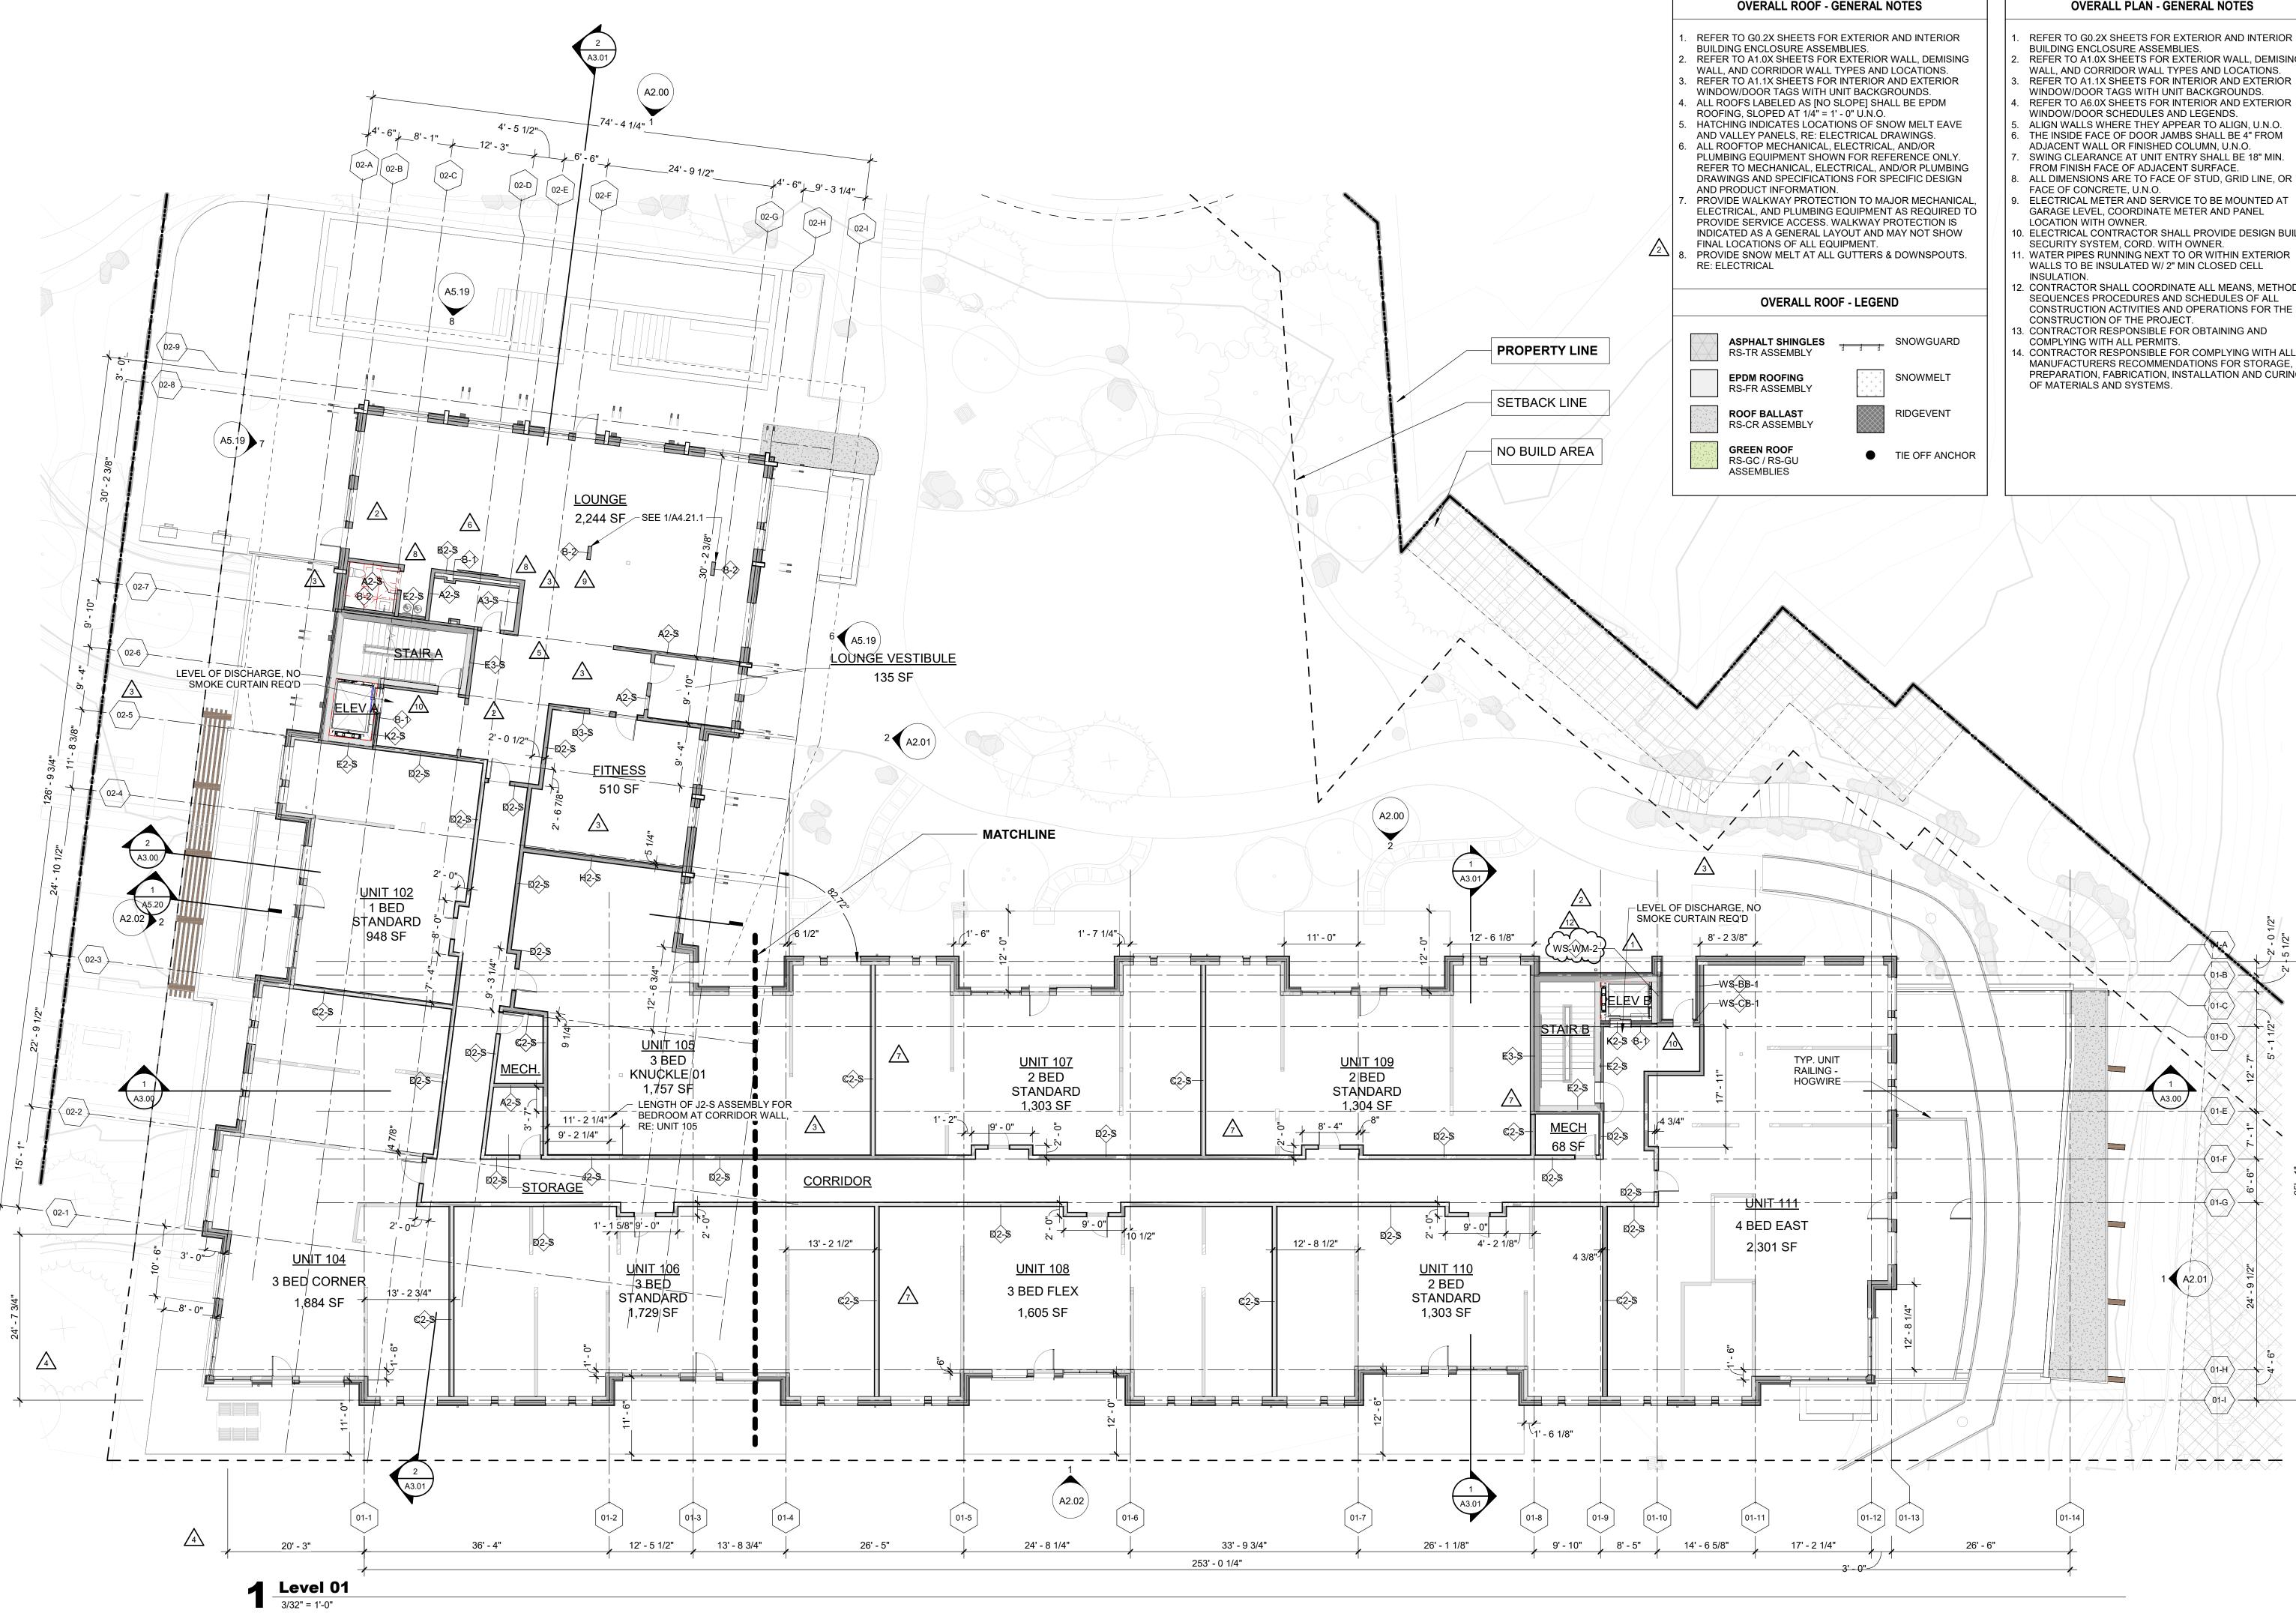

**OVERALL PLAN - GENERAL NOTES** 

- REFER TO G0.2X SHEETS FOR EXTERIOR AND INTERIOR
- REFER TO A1.0X SHEETS FOR EXTERIOR WALL, DEMISING WALL, AND CORRIDOR WALL TYPES AND LOCATIONS.
- WINDOW/DOOR TAGS WITH UNIT BACKGROUNDS. REFER TO A6.0X SHEETS FOR INTERIOR AND EXTERIOR
- WINDOW/DOOR SCHEDULES AND LEGENDS.
- THE INSIDE FACE OF DOOR JAMBS SHALL BE 4" FROM
- SWING CLEARANCE AT UNIT ENTRY SHALL BE 18" MIN.
- ALL DIMENSIONS ARE TO FACE OF STUD, GRID LINE, OR
- ELECTRICAL METER AND SERVICE TO BE MOUNTED AT GARAGE LEVEL, COORDINATE METER AND PANEL
- 0. ELECTRICAL CONTRACTOR SHALL PROVIDE DESIGN BUILD SECURITY SYSTEM, CORD. WITH OWNER. . WATER PIPES RUNNING NEXT TO OR WITHIN EXTERIOR
- WALLS TO BE INSULATED W/ 2" MIN CLOSED CELL
- 2. CONTRACTOR SHALL COORDINATE ALL MEANS, METHODS, SEQUENCES PROCEDURES AND SCHEDULES OF ALL CONSTRUCTION ACTIVITIES AND OPERATIONS FOR THE CONSTRUCTION OF THE PROJECT.
- L CONTRACTOR RESPONSIBLE FOR COMPLYING WITH ALL MANUFACTURERS RECOMMENDATIONS FOR STORAGE,
- PREPARATION, FABRICATION, INSTALLATION AND CURING

TOWN STAMP 359 Design 3630 OSAGE STREET DENVER, CO 80211 720.512.3437 **B-2465** 12/15/2023 ED ARC \_0 No. Description Date PERMIT COMMENTS RESPONSE GMP REVISIONS 
 IFC SET

 RFI #67

 RFI #125

 RFI #214

 RFI #214

 RFI #214

 RFI #214

 RFI #214.1

 RFI #214.1

 RFI #214.1

 RFI #214.3

 RFI #214.1

 RFI #232

 RFI #246.3

 RFI #271

 RFI #348

 RFI #369
 PROJECT NUMBER ISSUE DATE 03/15/2024 THE AMBLE IFC SET SHEET TITLE FLOOR PLAN - LEVEL 01 SHEET NO. A1.01

-0 1/2"

<01-E >


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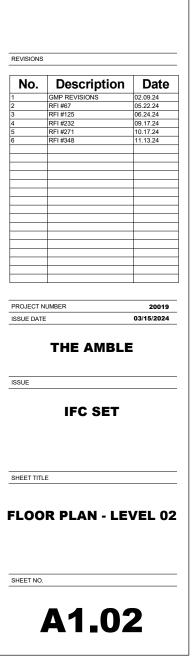
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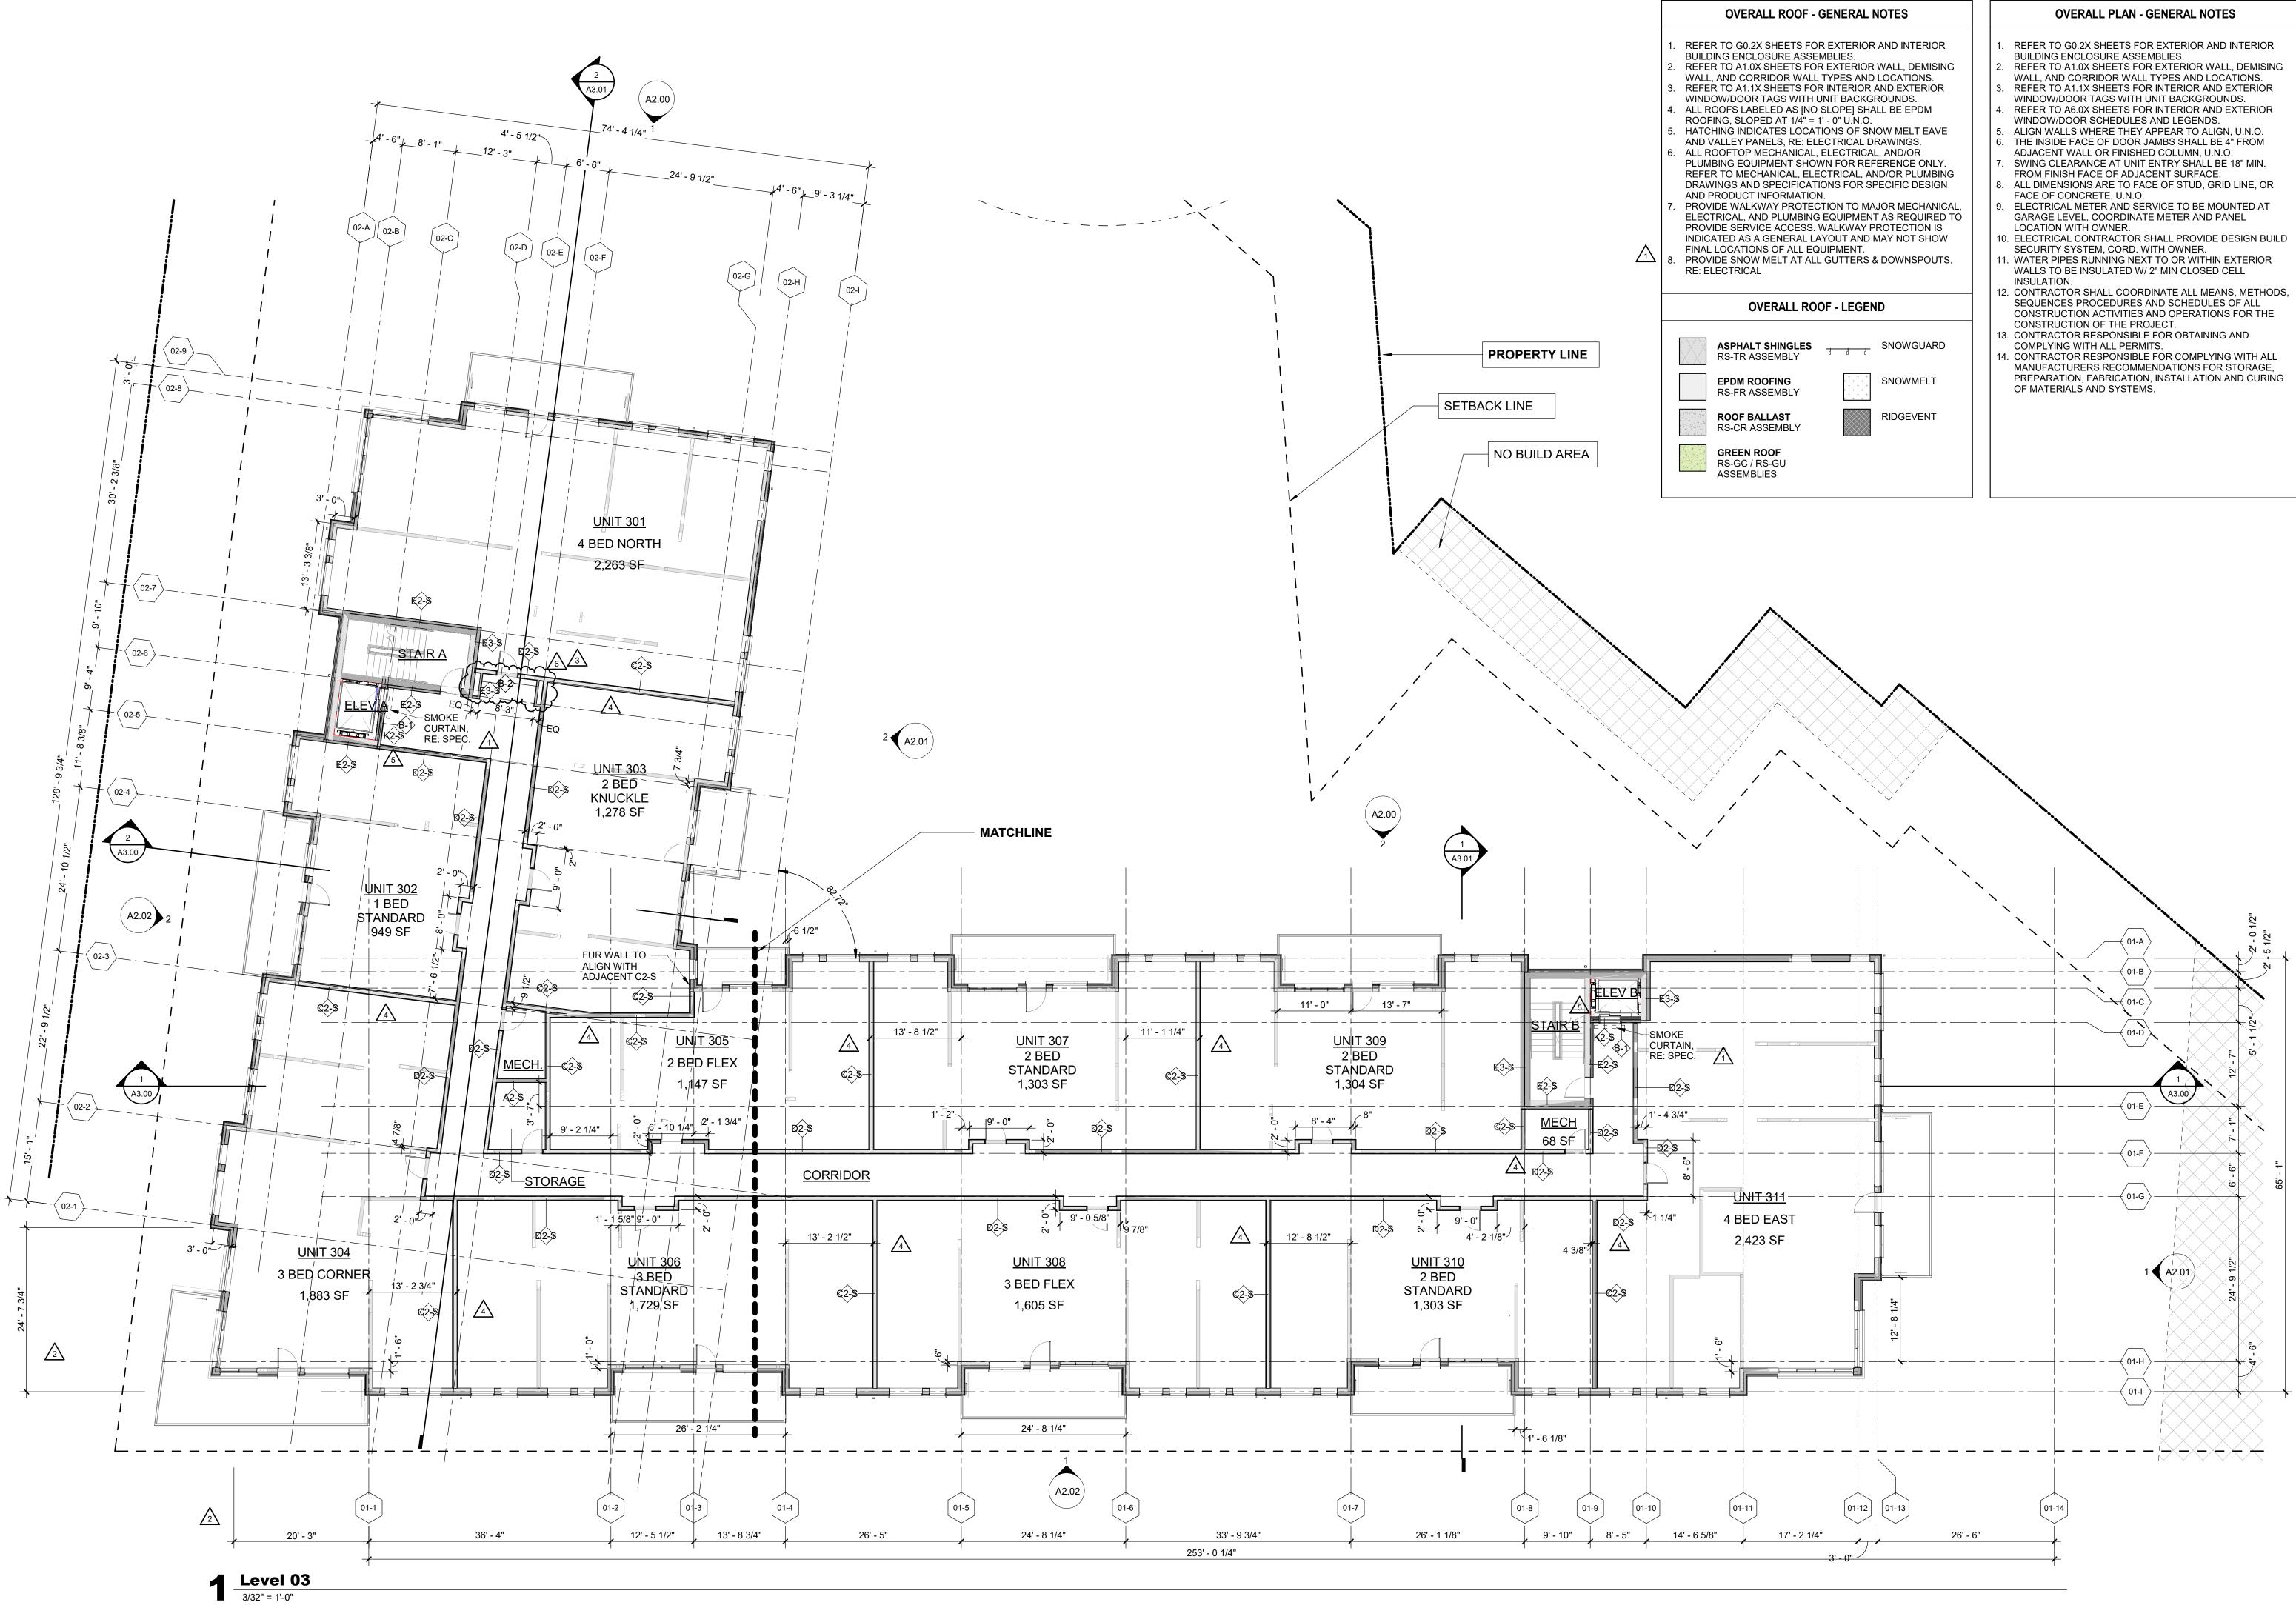
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359 Design 3630 OSAGE STREET DENVER, CO 80211 720.512.3437 **B-2465** 12/15/2023 

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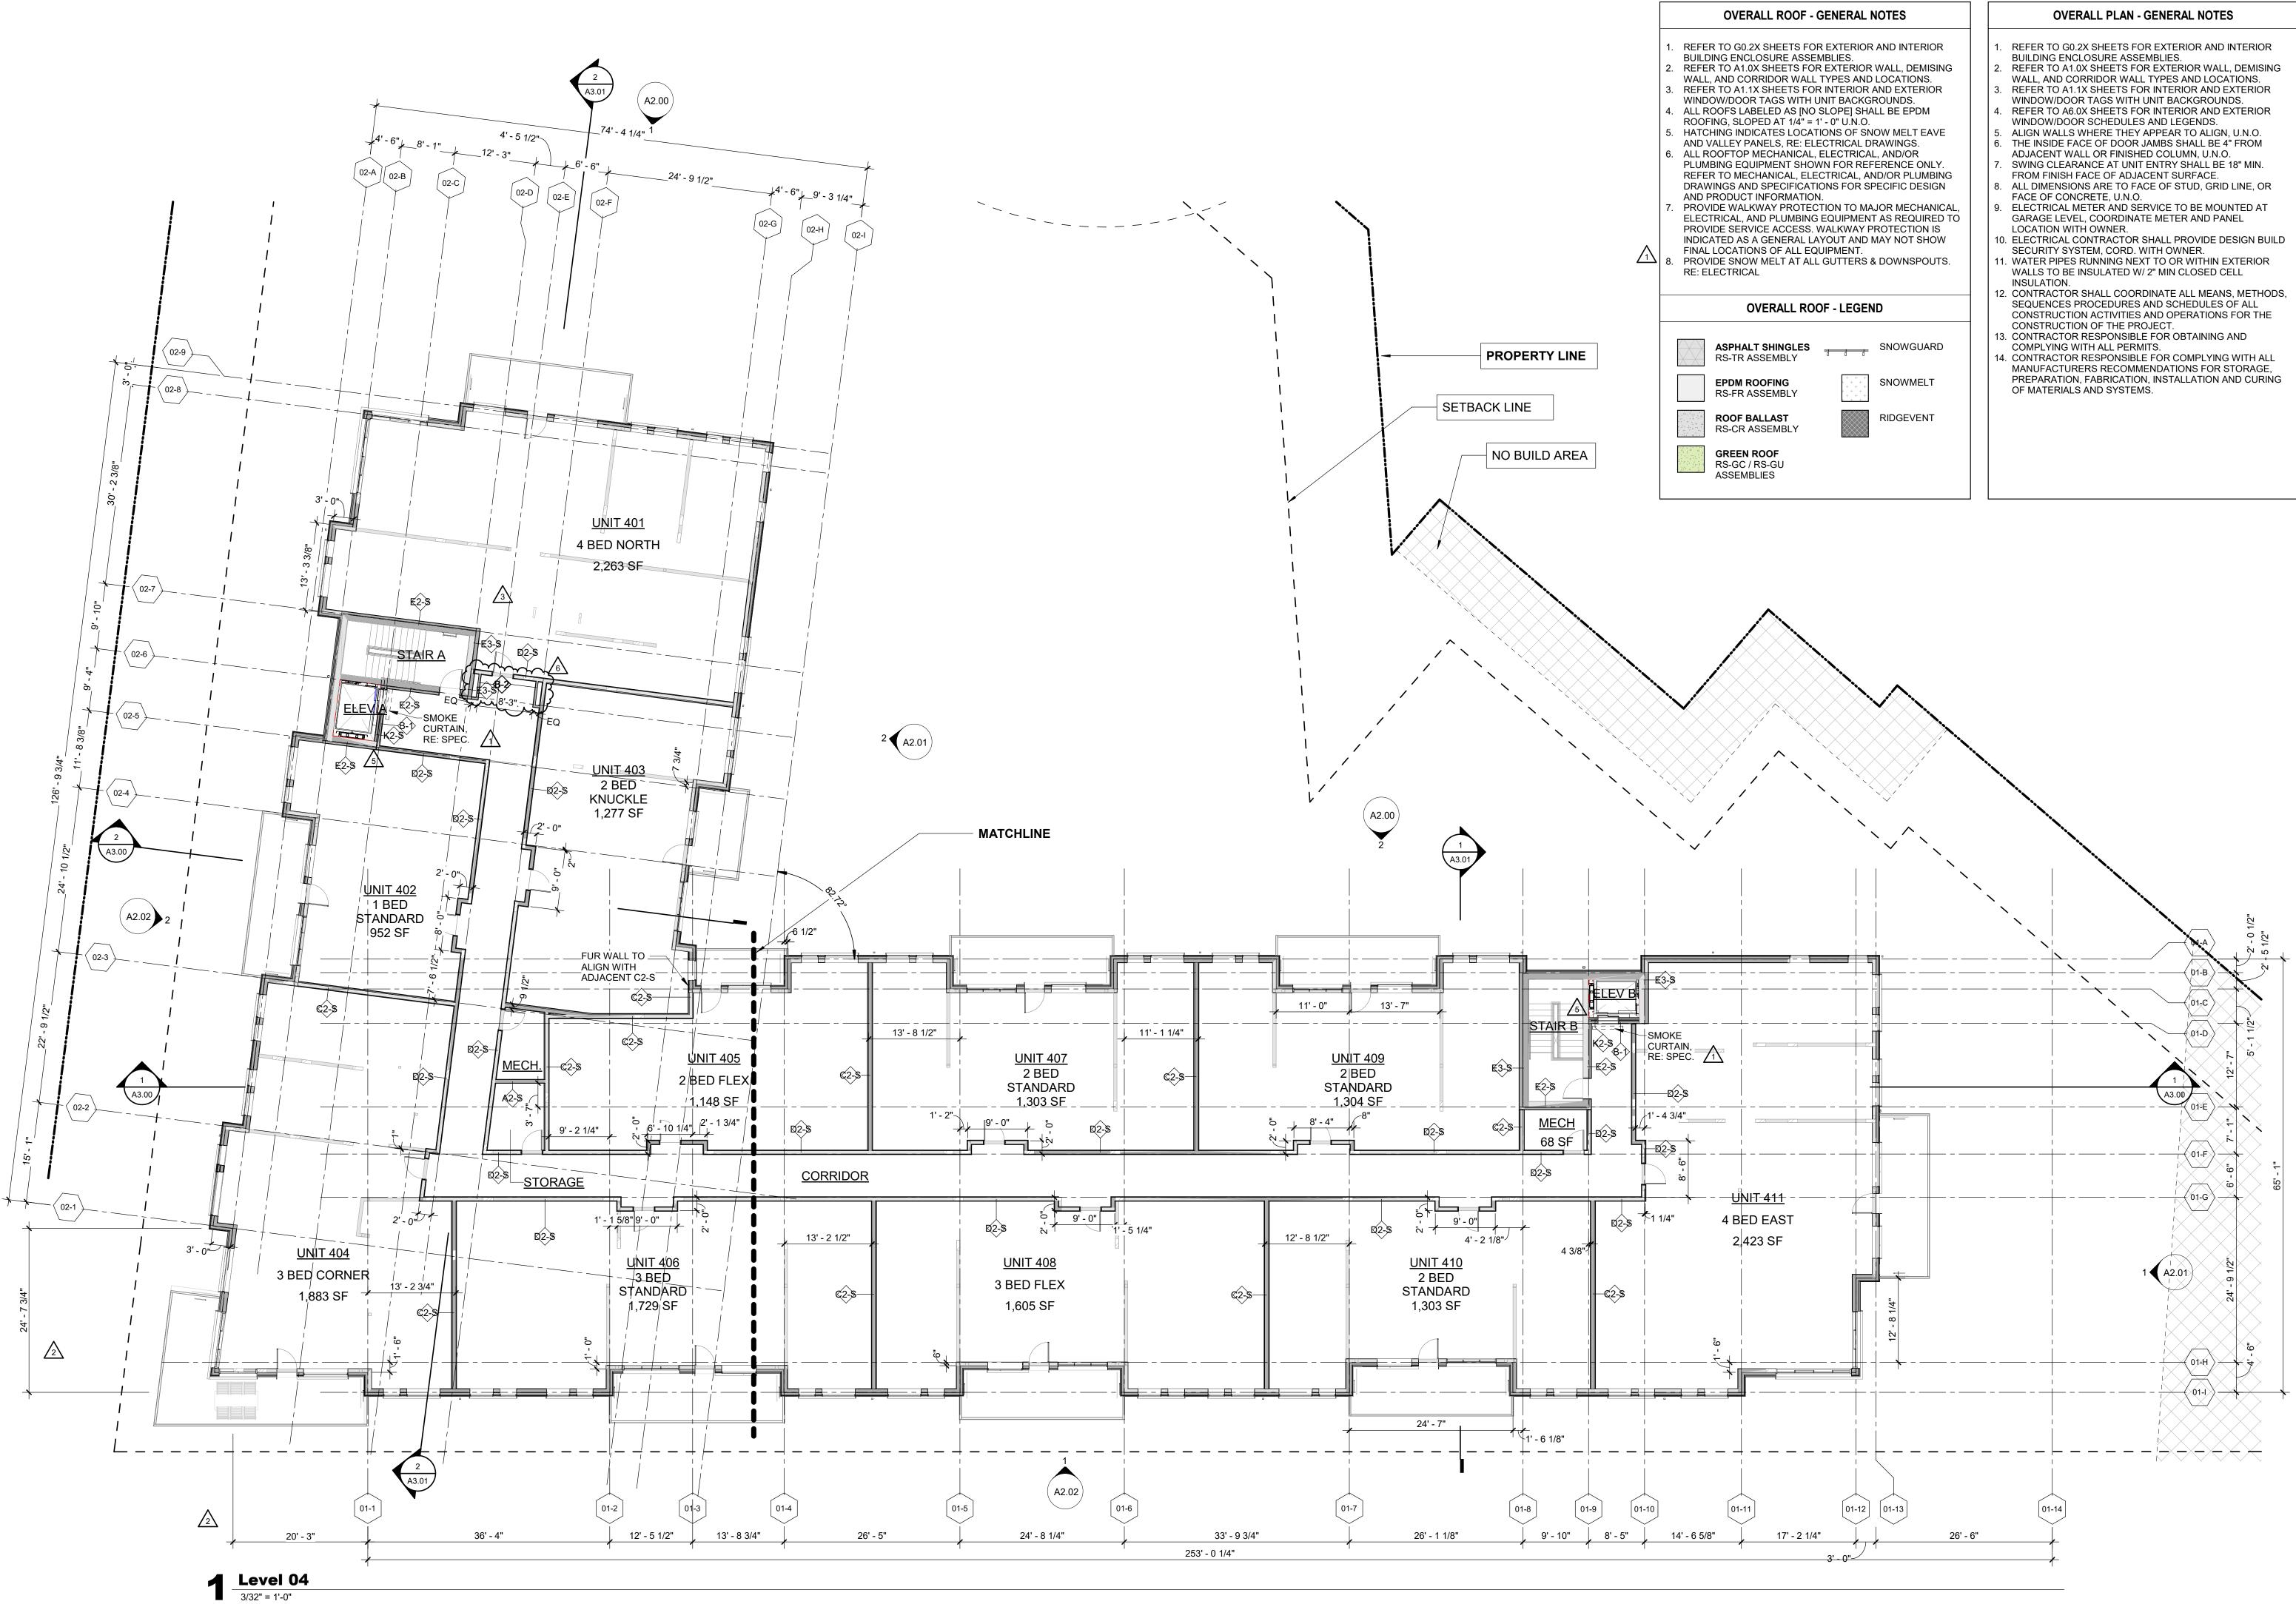









SHEET NO.
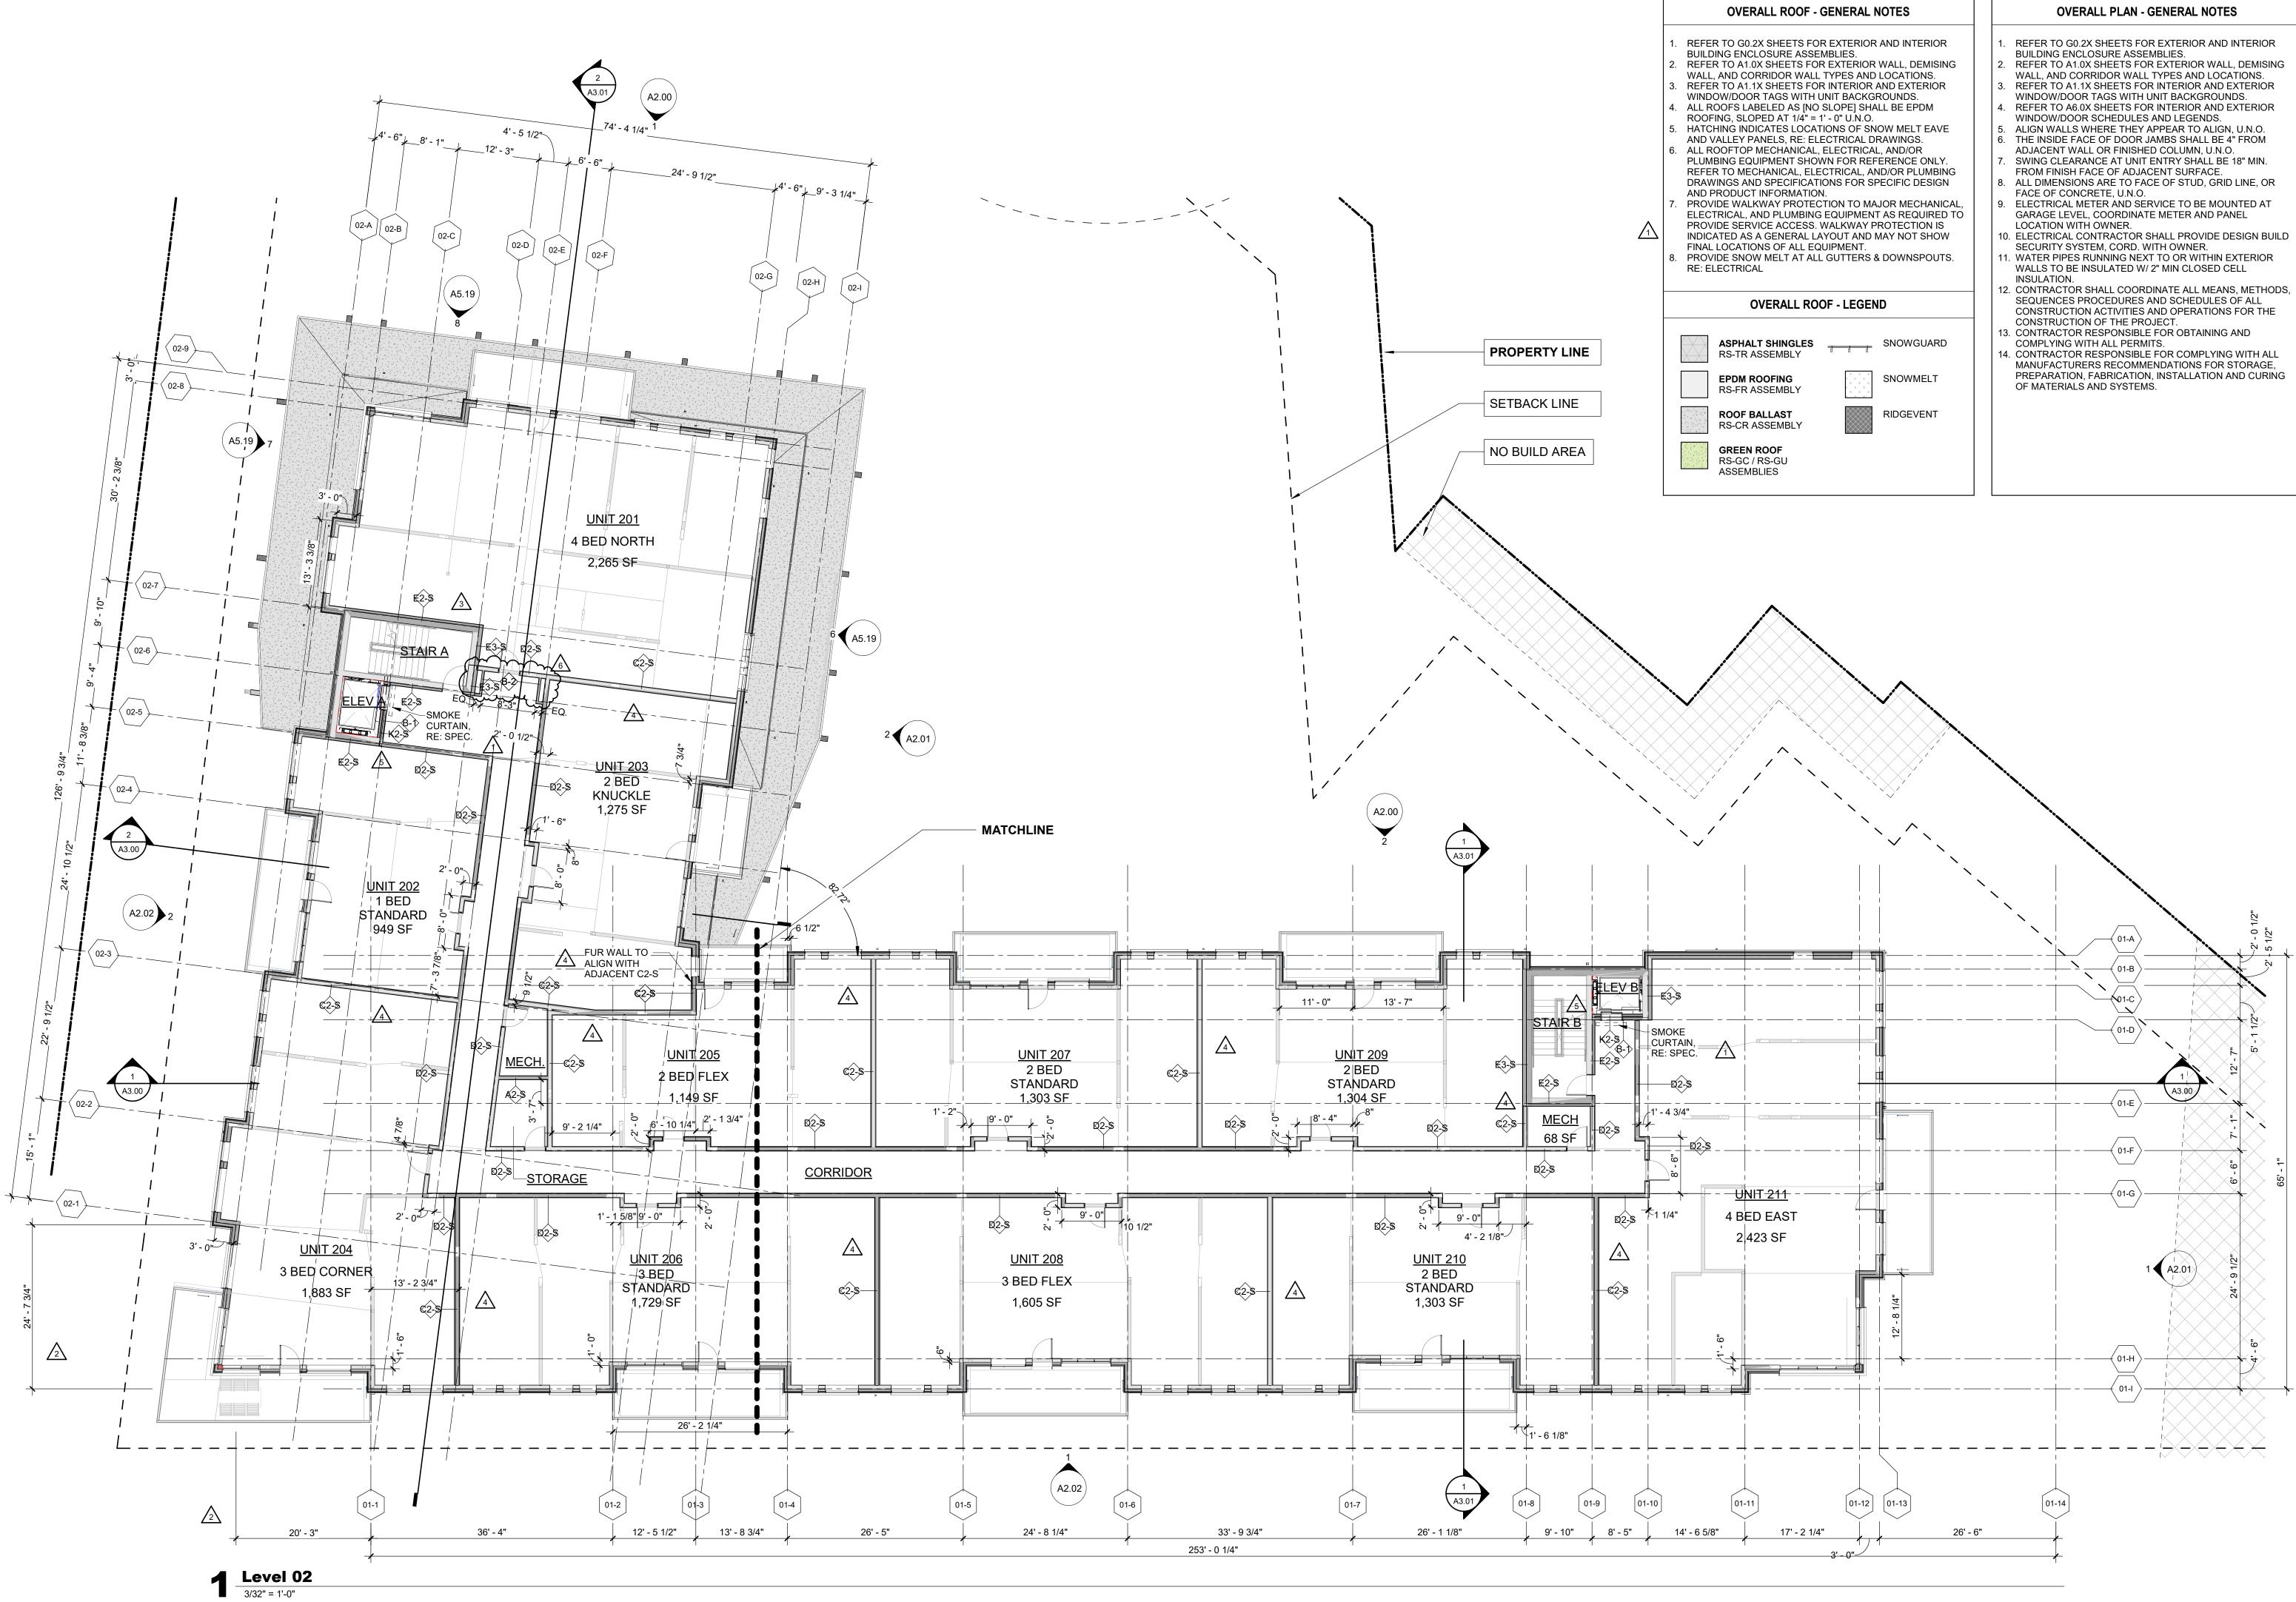
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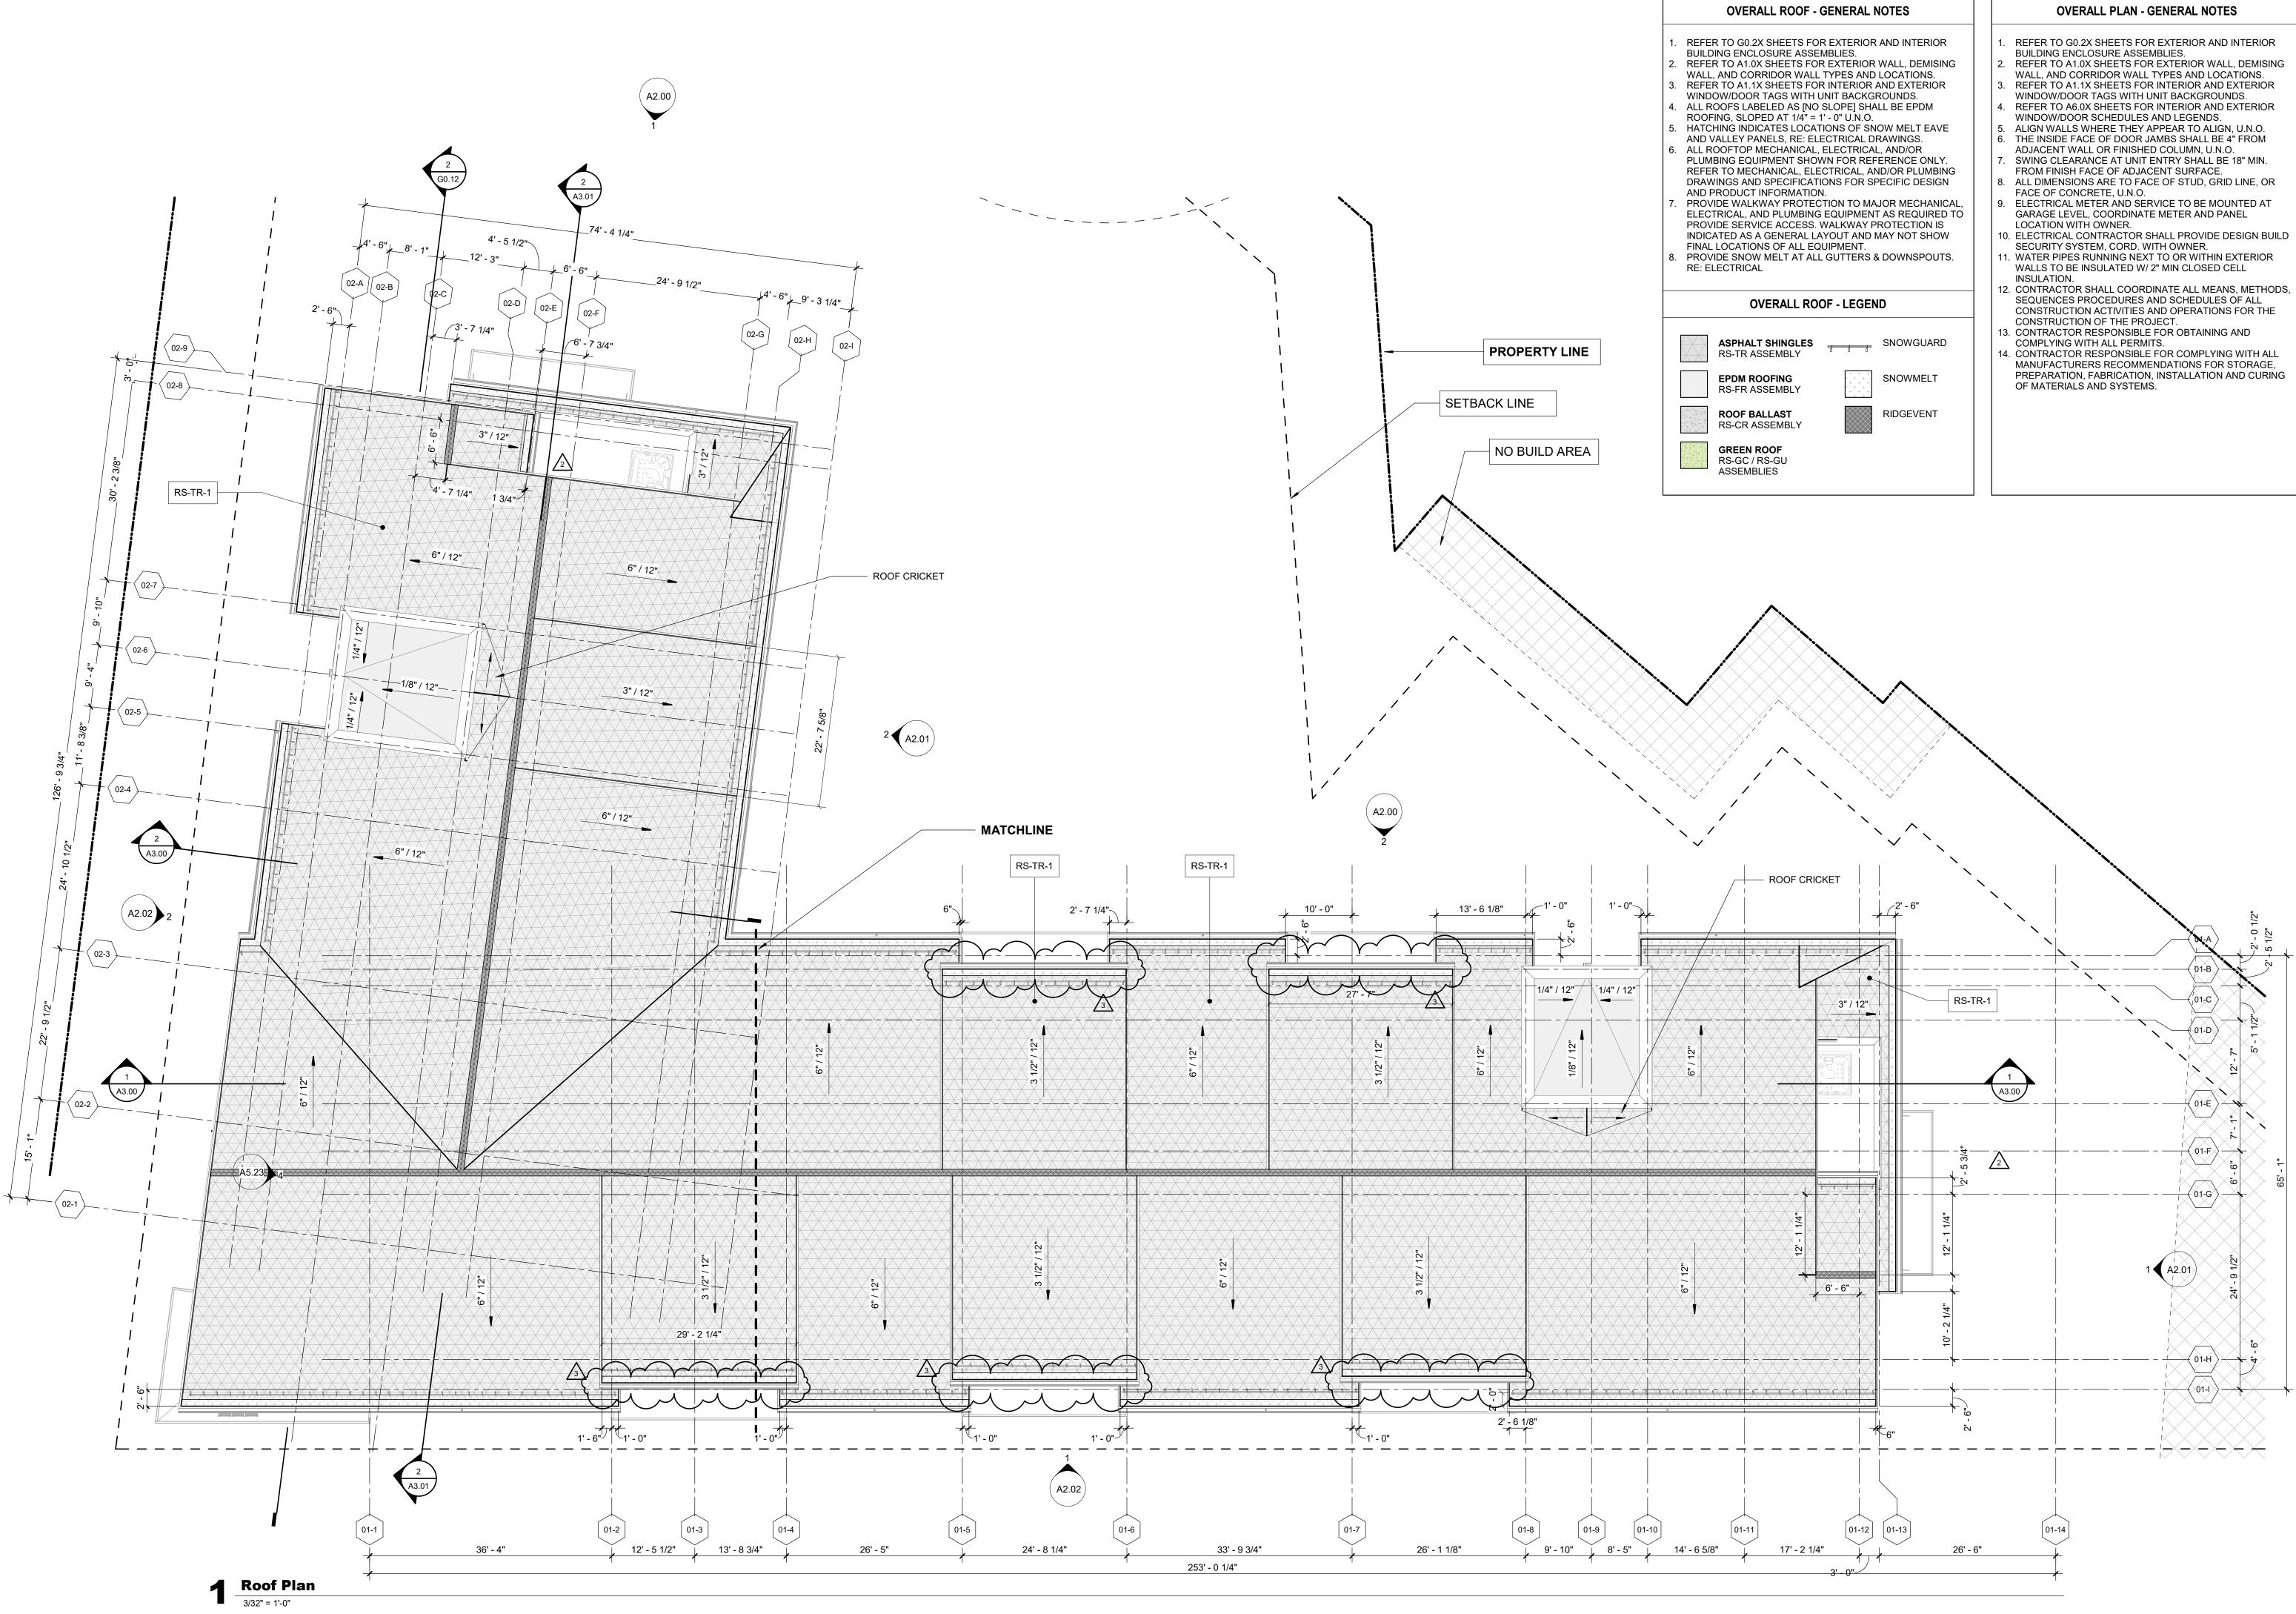
IFC SET

SHEET TITLE

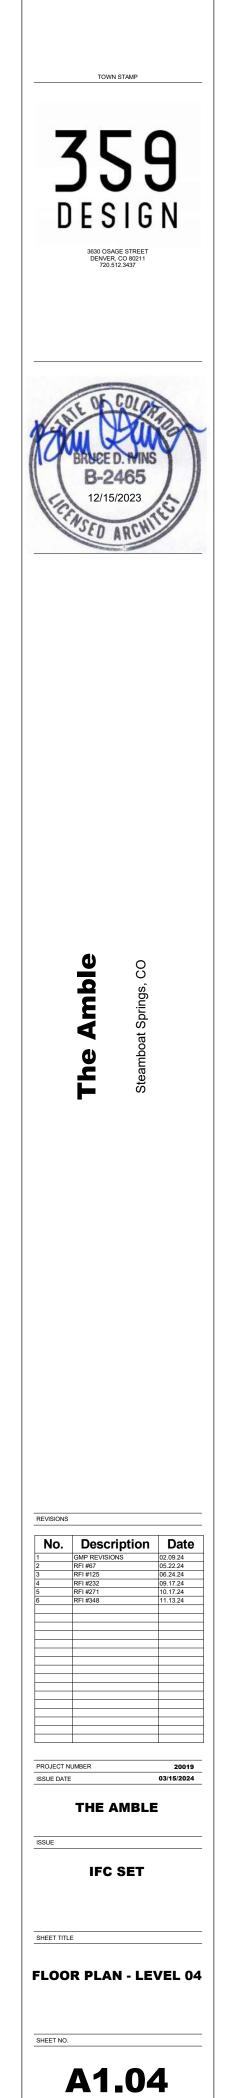**FLOOR PLAN - LEVEL 05** 

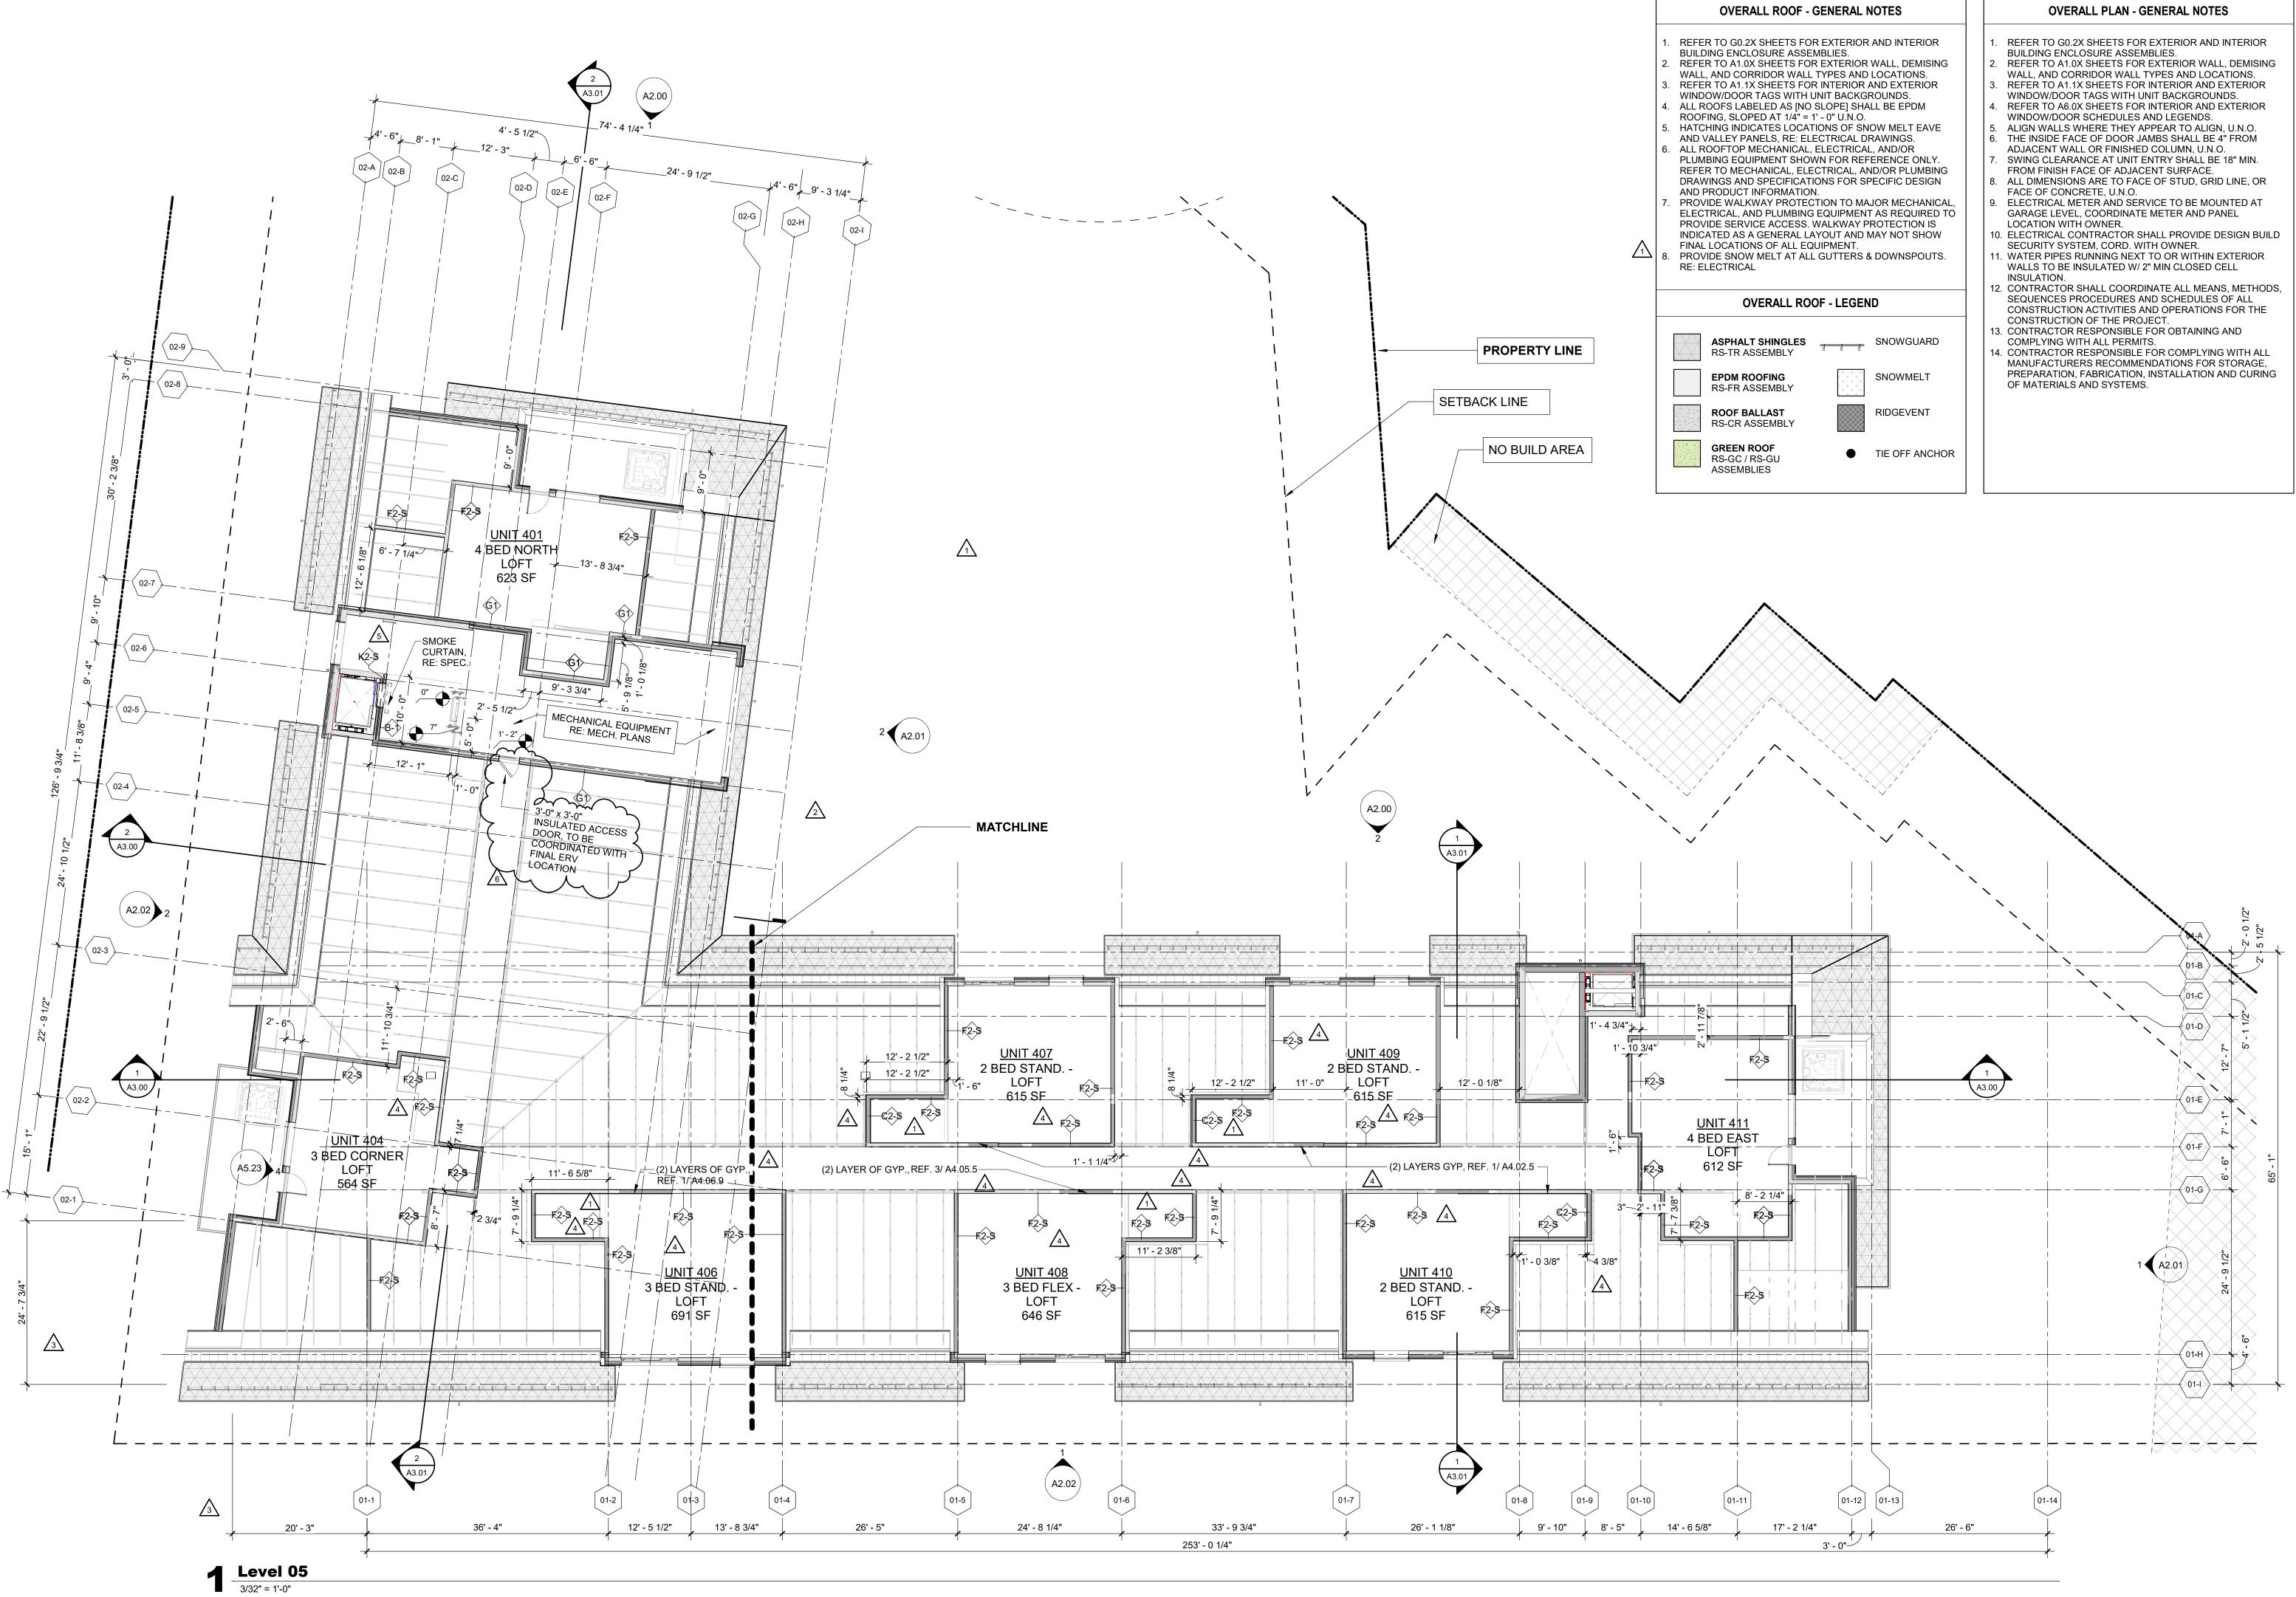A1.05

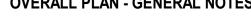
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TOWN STAMP

A1.06




REFER TO G0.2X SHEETS FOR EXTERIOR AND INTERIOR

BUILDING ENCLOSURE ASSEMBLIES. REFER TO A1.0X SHEETS FOR EXTERIOR WALL, DEMISING WALL, AND CORRIDOR WALL TYPES AND LOCATIONS. REFER TO A1.1X SHEETS FOR INTERIOR AND EXTERIOR WINDOW/DOOR TAGS WITH UNIT BACKGROUNDS. ALL ROOFS LABELED AS [NO SLOPE] SHALL BE EPDM ROOFING, SLOPED AT 1/4" = 1' - 0" U.N.O. HATCHING INDICATES LOCATIONS OF SNOW MELT EAVE AND VALLEY PANELS, RE: ELECTRICAL DRAWINGS. ALL ROOFTOP MECHANICAL, ELECTRICAL, AND/OR PLUMBING EQUIPMENT SHOWN FOR REFERENCE ONLY. REFER TO MECHANICAL, ELECTRICAL, AND/OR PLUMBING DRAWINGS AND SPECIFICATIONS FOR SPECIFIC DESIGN

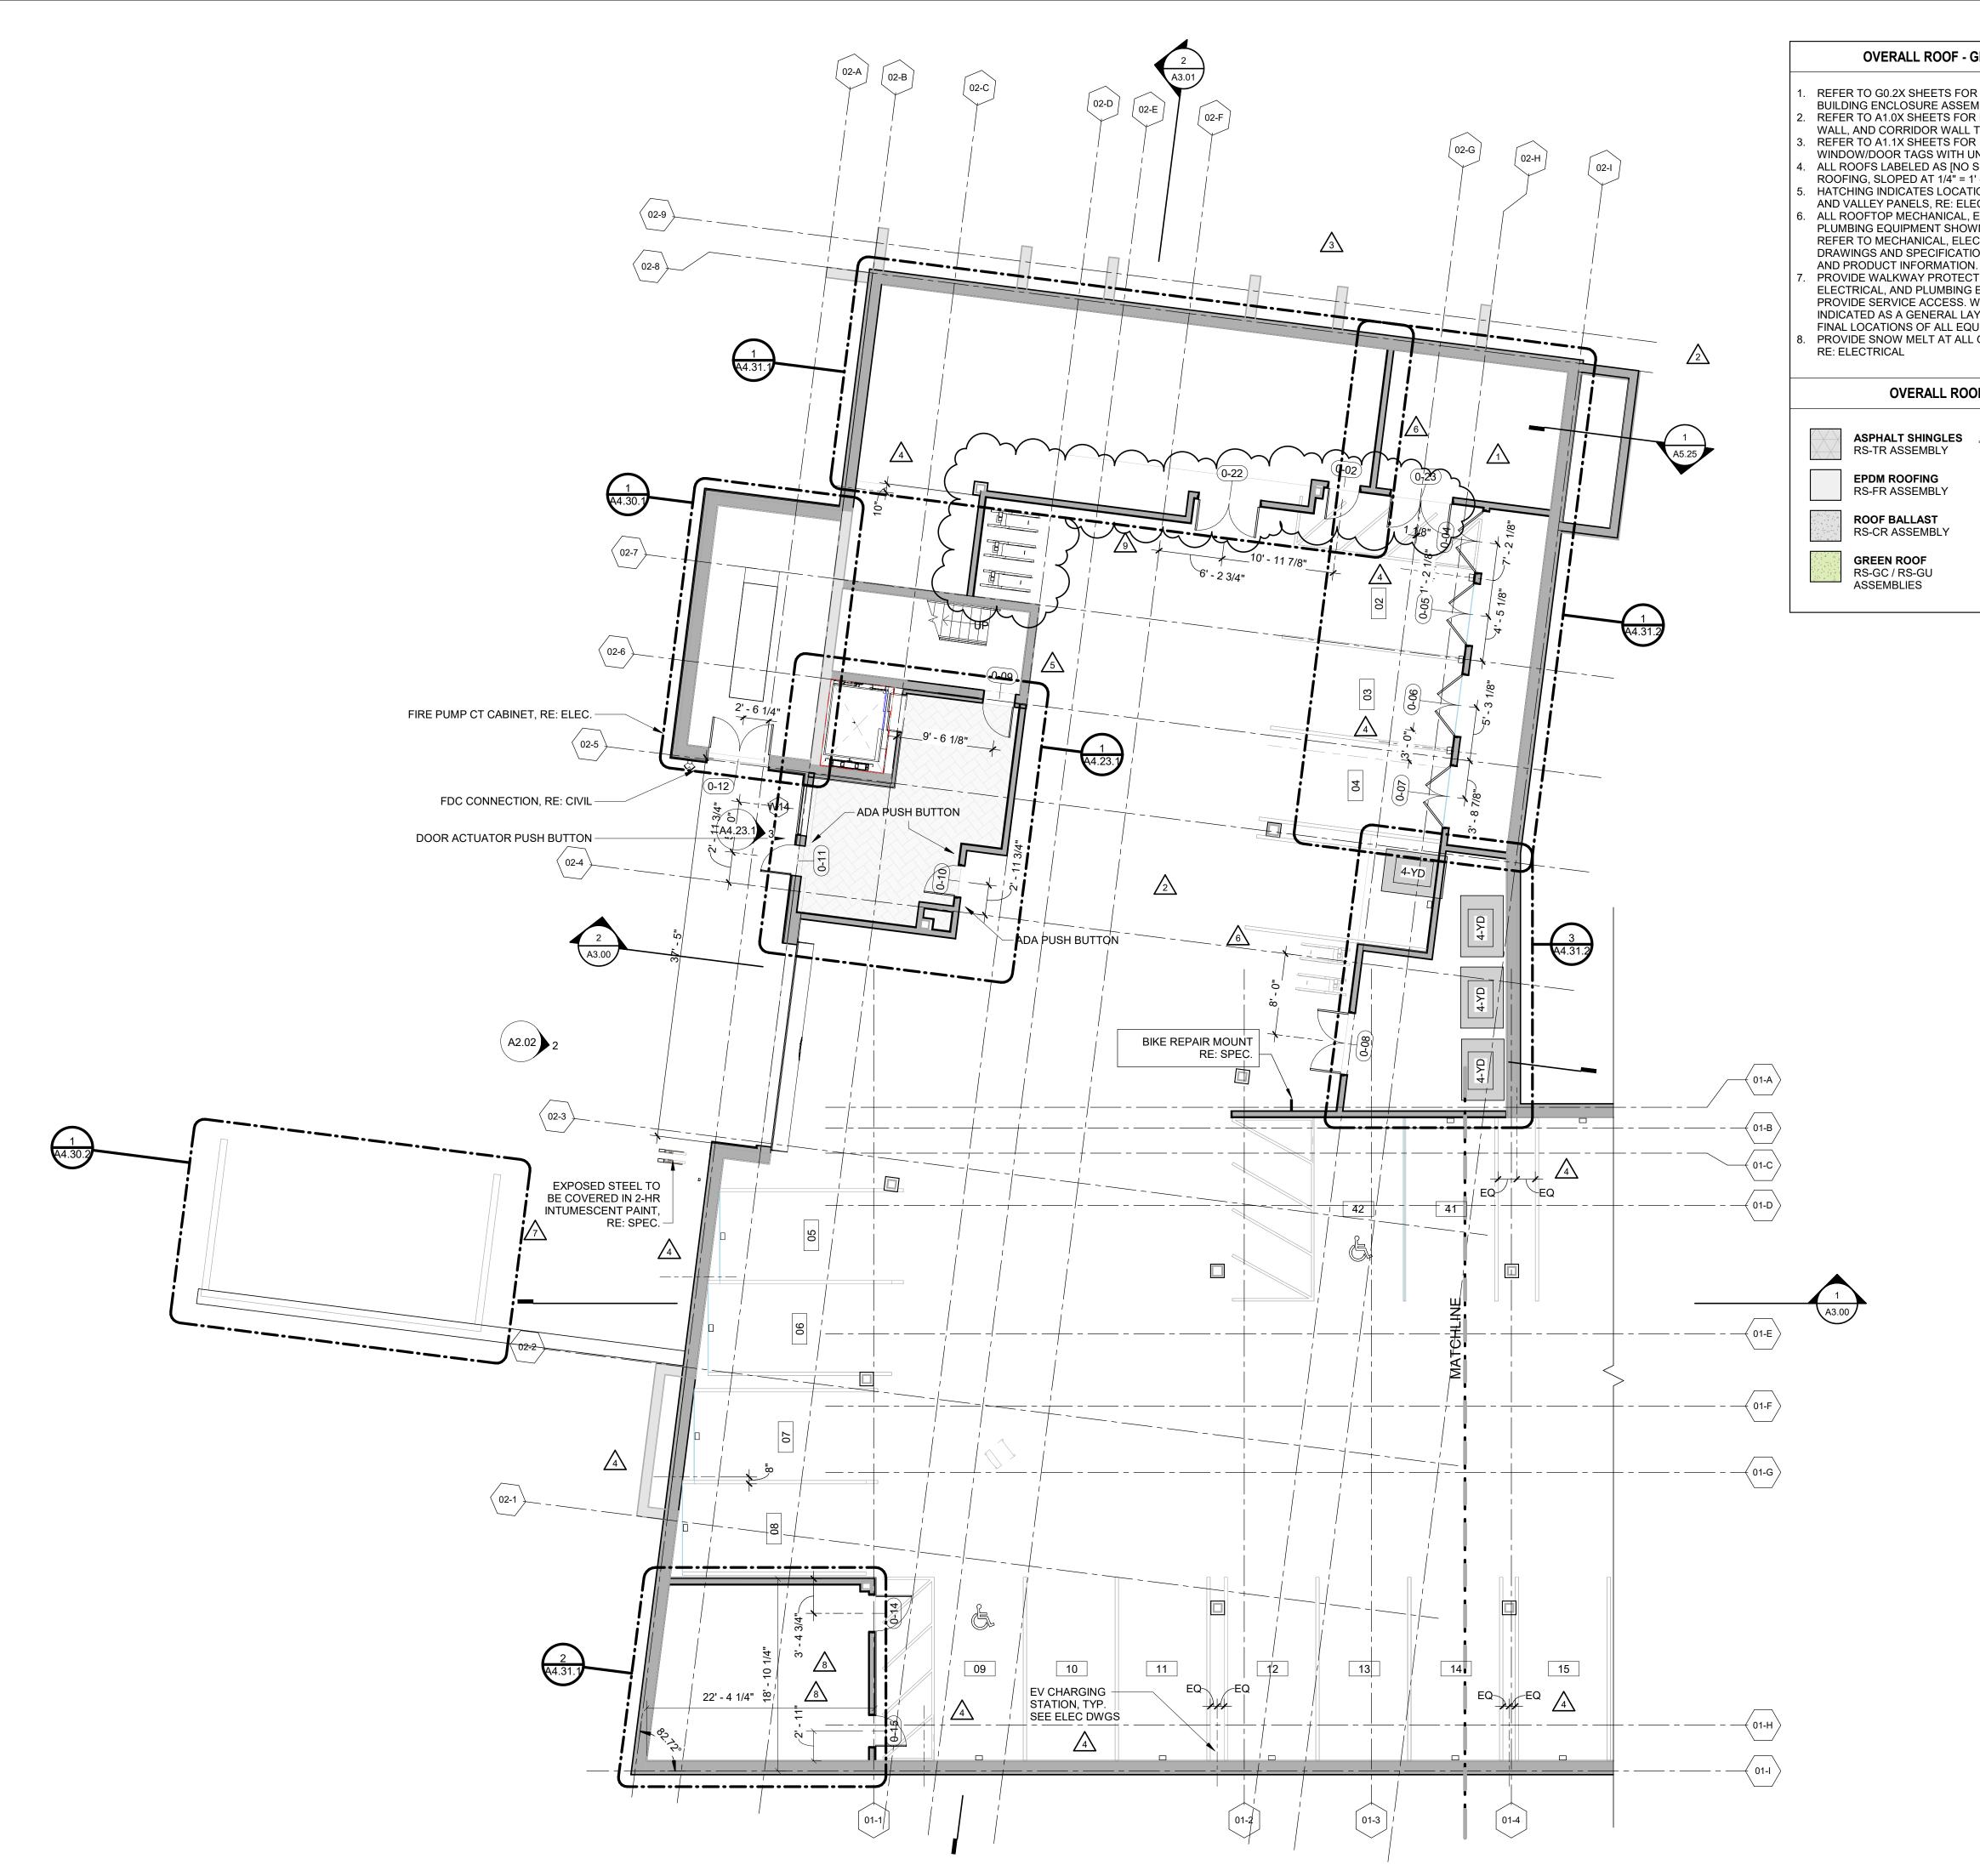PROVIDE WALKWAY PROTECTION TO MAJOR MECHANICAL, ELECTRICAL, AND PLUMBING EQUIPMENT AS REQUIRED TO PROVIDE SERVICE ACCESS. WALKWAY PROTECTION IS INDICATED AS A GENERAL LAYOUT AND MAY NOT SHOW FINAL LOCATIONS OF ALL EQUIPMENT. PROVIDE SNOW MELT AT ALL GUTTERS & DOWNSPOUTS. RE: ELECTRICAL

### OVERALL ROOF - LEGEND

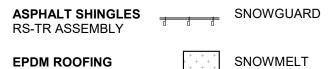

SNOWMELT

RIDGEVENT

#### ROOF BALLAST RS-CR ASSEMBLY

**GREEN ROOF** RS-GC / RS-GU ASSEMBLIES

- **OVERALL PLAN GENERAL NOTES**
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- WINDOW/DOOR SCHEDULES AND LEGENDS.
- ALIGN WALLS WHERE THEY APPEAR TO ALIGN, U.N.O. THE INSIDE FACE OF DOOR JAMBS SHALL BE 4" FROM
- ADJACENT WALL OR FINISHED COLUMN, U.N.O. SWING CLEARANCE AT UNIT ENTRY SHALL BE 18" MIN. FROM FINISH FACE OF ADJACENT SURFACE.
- ALL DIMENSIONS ARE TO FACE OF STUD, GRID LINE, OR FACE OF CONCRETE, U.N.O.
- ELECTRICAL METER AND SERVICE TO BE MOUNTED AT GARAGE LEVEL, COORDINATE METER AND PANEL
- LOCATION WITH OWNER. 0. ELECTRICAL CONTRACTOR SHALL PROVIDE DESIGN BUILD SECURITY SYSTEM, CORD. WITH OWNER.
- . WATER PIPES RUNNING NEXT TO OR WITHIN EXTERIOR WALLS TO BE INSULATED W/ 2" MIN CLOSED CELL INSULATION.
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- 13. CONTRACTOR RESPONSIBLE FOR OBTAINING AND COMPLYING WITH ALL PERMITS. 4. CONTRACTOR RESPONSIBLE FOR COMPLYING WITH ALL
- MANUFACTURERS RECOMMENDATIONS FOR STORAGE, PREPARATION, FABRICATION, INSTALLATION AND CURING OF MATERIALS AND SYSTEMS.

**B-2465** 12/15/2023 Ω L


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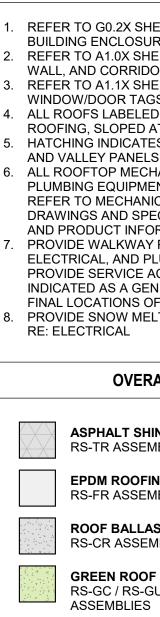
359 Design

3630 OSAGE STREET DENVER, CO 80211 720.512.3437

REVISIONS	3	
No.	Description	Date
	GMP REVISIONS	02.09.24
	IFC SET	03.15.24
	RFI #65.1	05.24.24
	RFI #75	05.30.24
	RFI #77 RFI #124	06.03.24
	RFI #124	08.01.24
	RFI #272	09.25.24
	RFI #277	10.07.24
		20019 03/15/2024
SSUE DAT	E	03/15/2024
ISSUE DAT	THE AMBLE	03/15/2024
ISSUE DAT	THE AMBLE IFC SET	03/15/2024
ISSUE DAT	E THE AMBLE IFC SET	03/15/2024

**FLOOR PLAN - LEVEL 00 - EAST**1/8" = 1'-0"




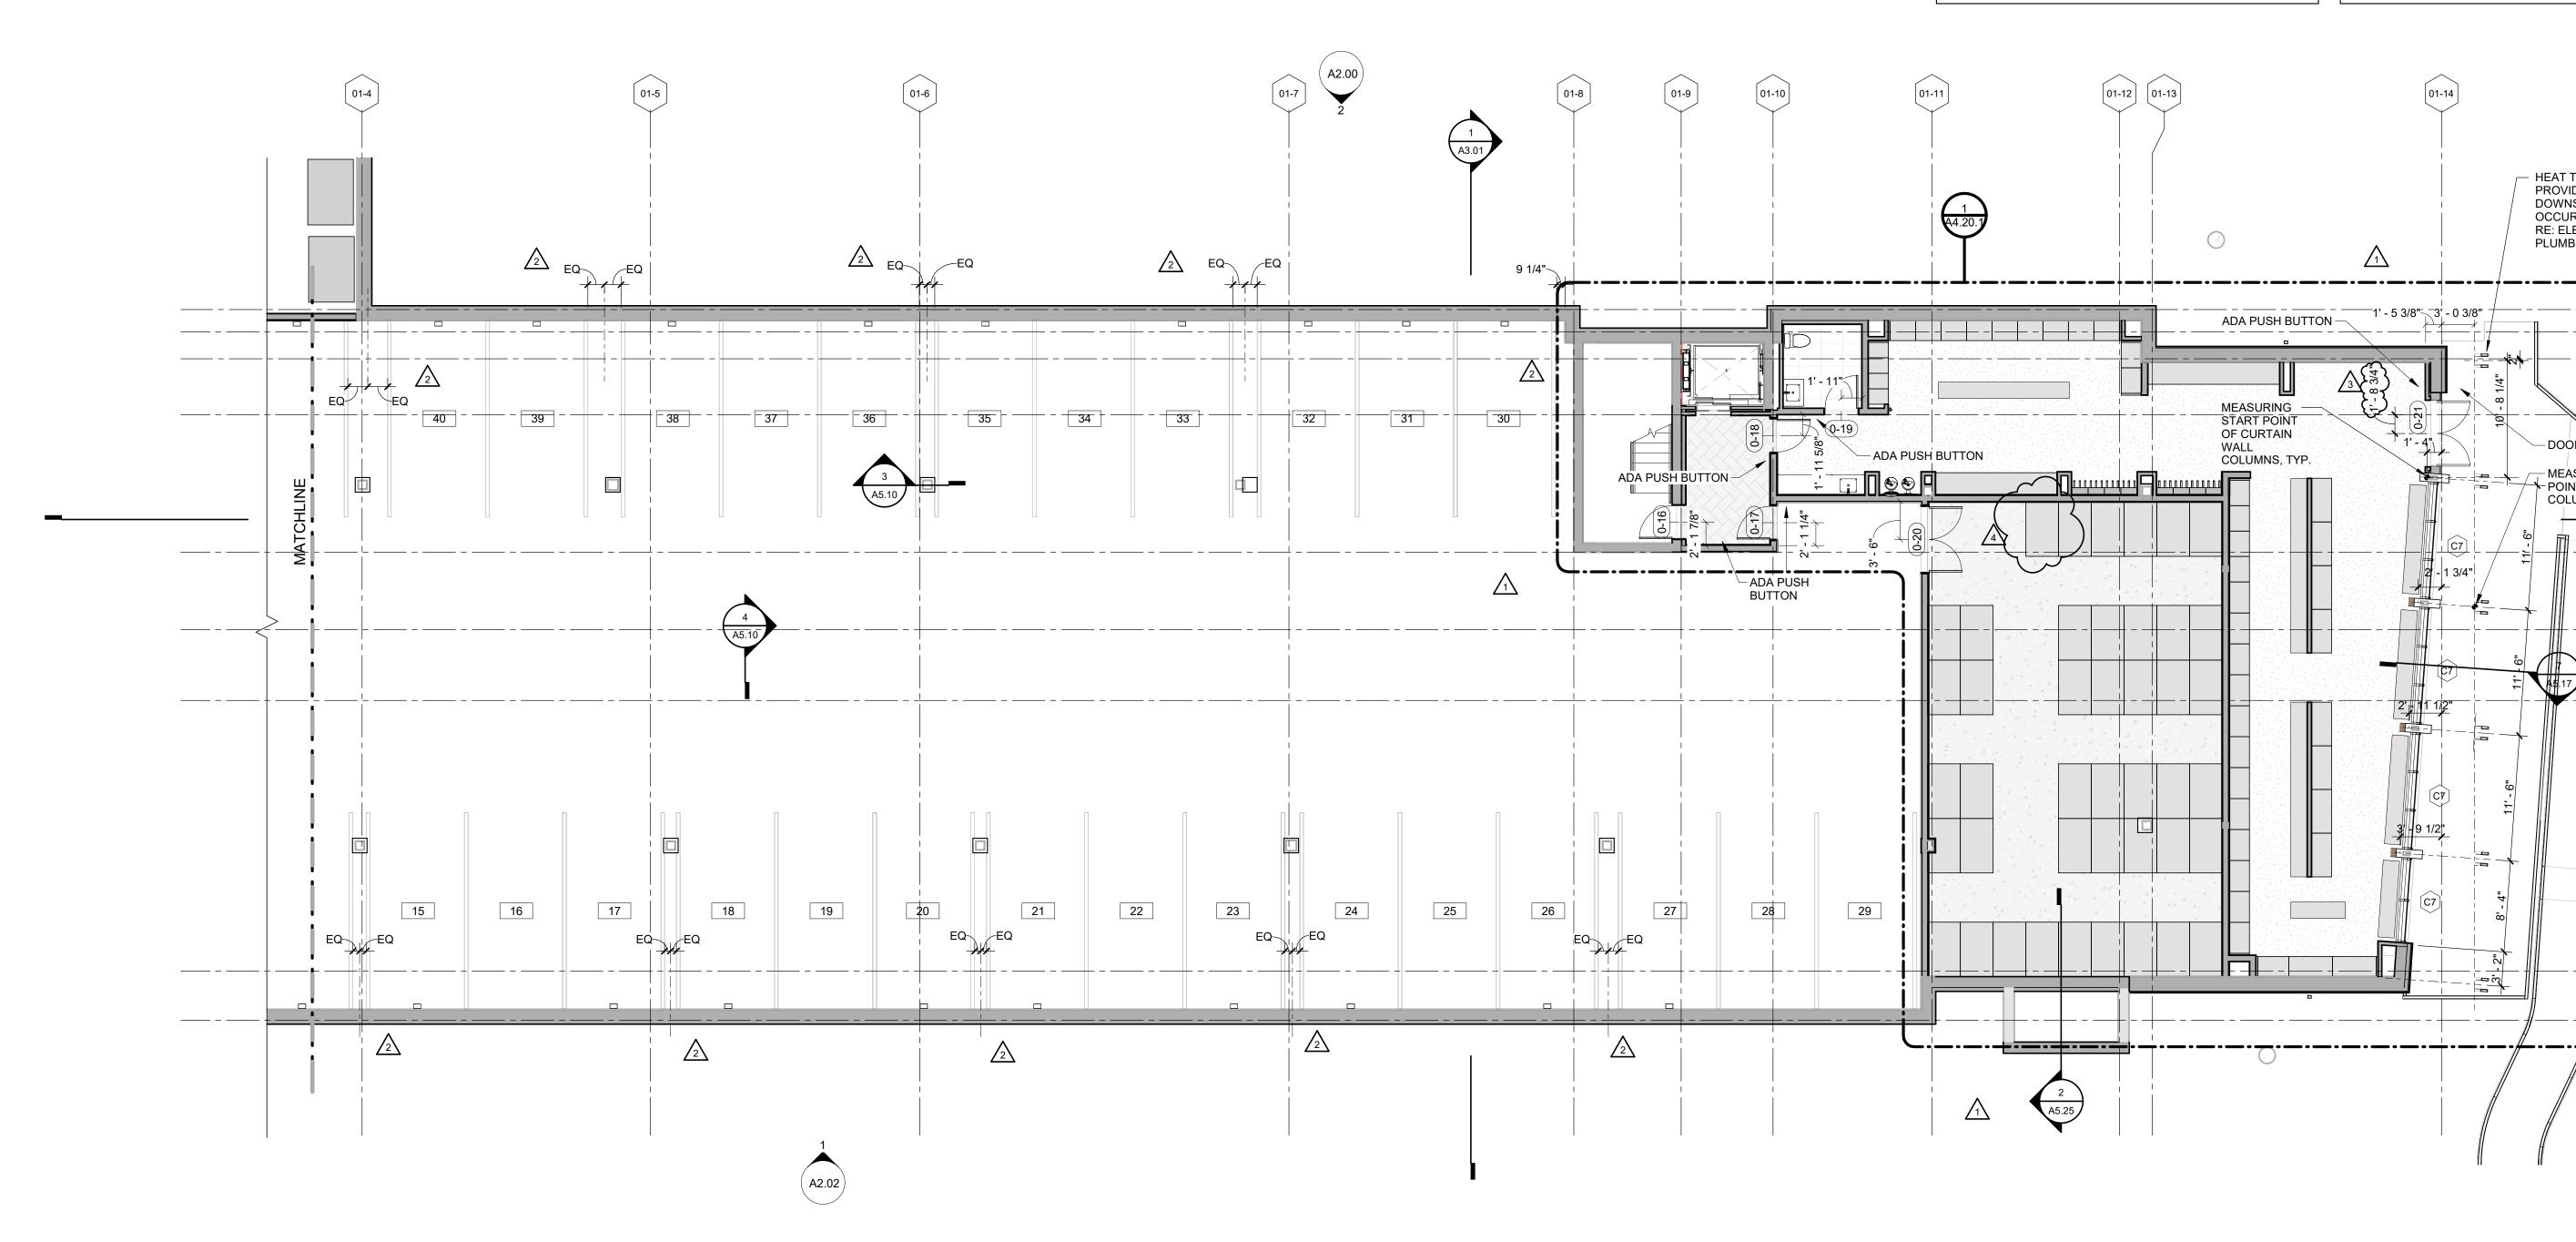



## **OVERALL ROOF - GENERAL NOTES**

REFER TO G0.2X SHEETS FOR EXTERIOR AND INTERIOR BUILDING ENCLOSURE ASSEMBLIES.

- WALL, AND CORRIDOR WALL TYPES AND LOCATIONS. REFER TO A1.1X SHEETS FOR INTERIOR AND EXTERIOR WINDOW/DOOR TAGS WITH UNIT BACKGROUNDS.
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- AND VALLEY PANELS, RE: ELECTRICAL DRAWINGS. ALL ROOFTOP MECHANICAL, ELECTRICAL, AND/OR PLUMBING EQUIPMENT SHOWN FOR REFERENCE ONLY.
- REFER TO MECHANICAL, ELECTRICAL, AND/OR PLUMBING DRAWINGS AND SPECIFICATIONS FOR SPECIFIC DESIGN AND PRODUCT INFORMATION. PROVIDE WALKWAY PROTECTION TO MAJOR MECHANICAL
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- RE: ELECTRICAL

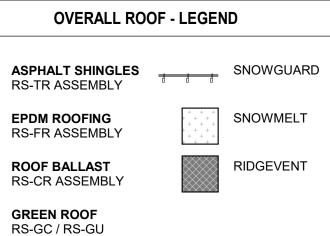

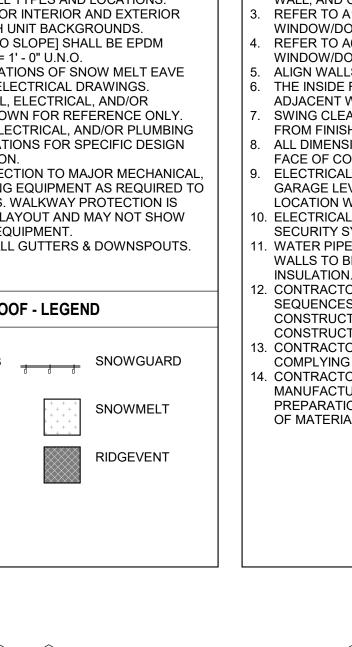

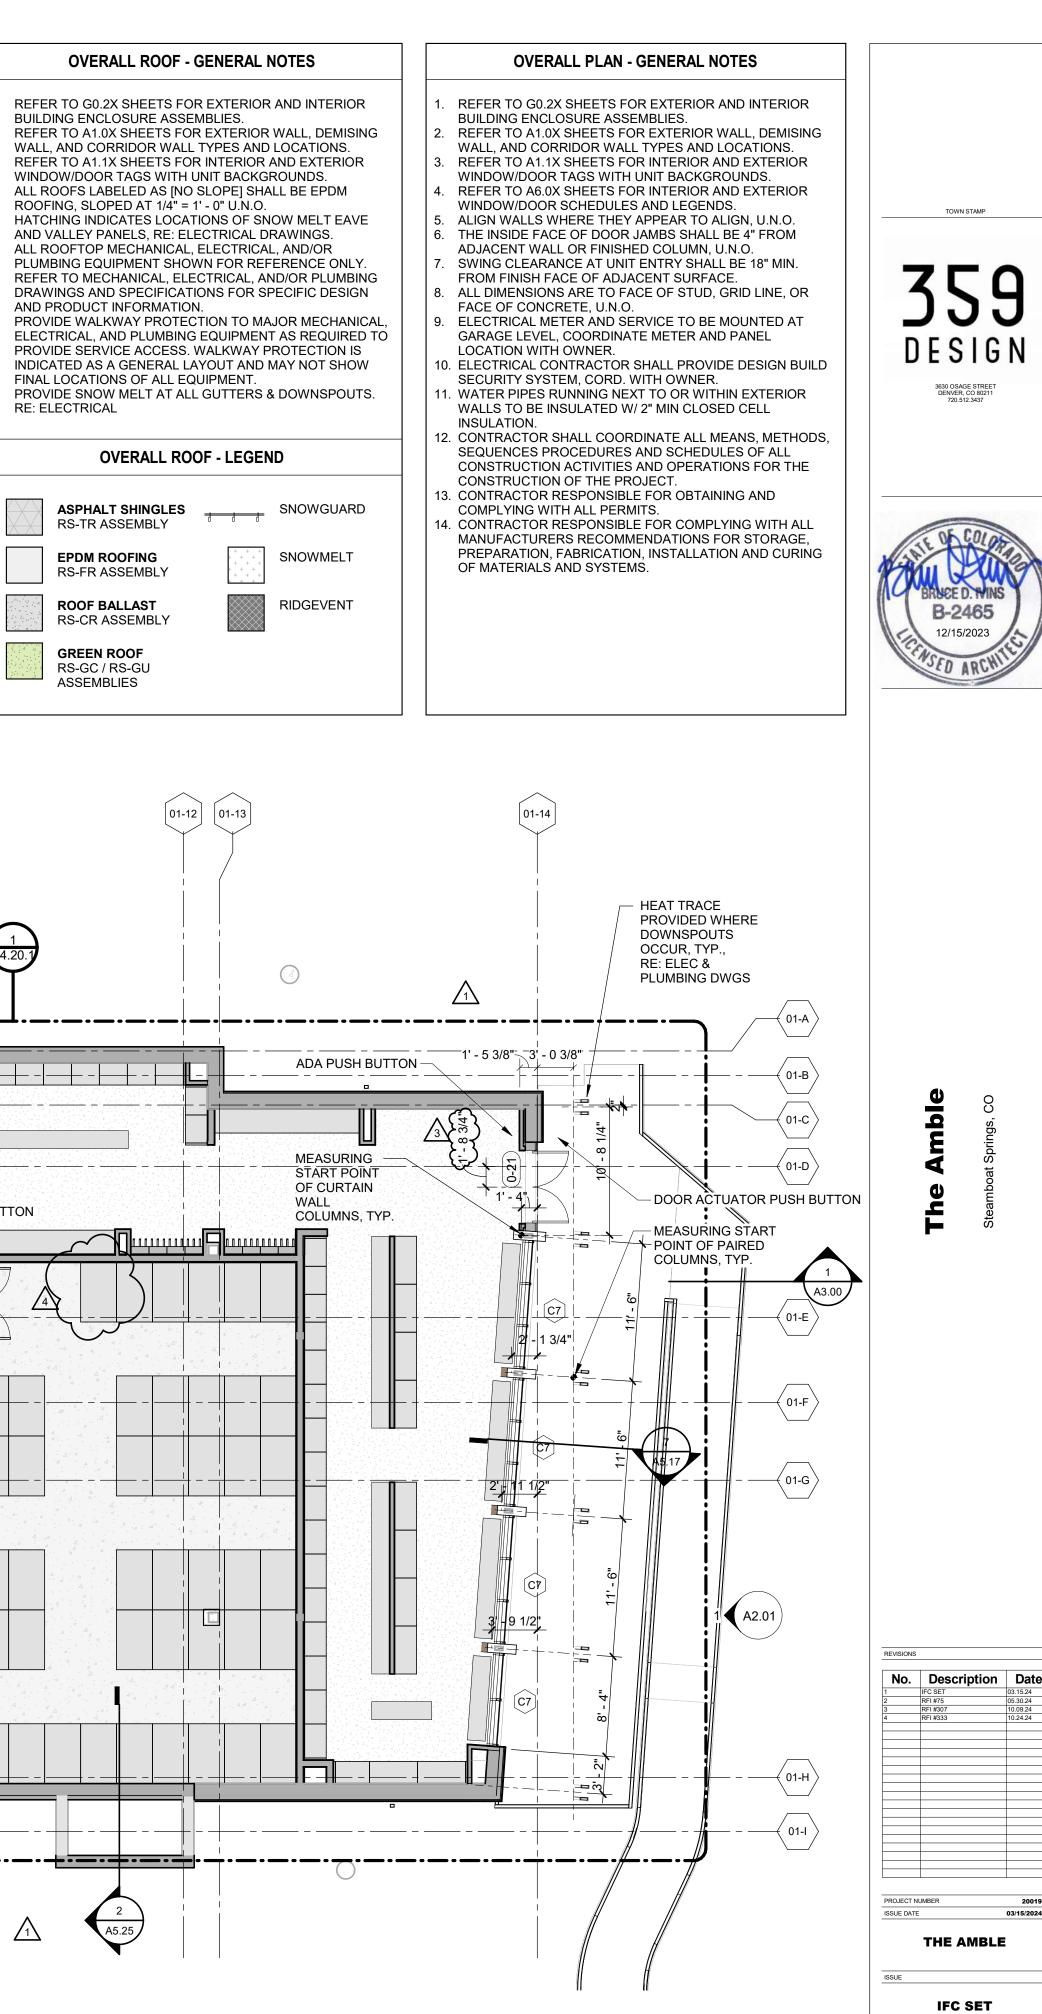

FLOOR PLAN - LEVEL 00

- EAST

SHEET NO.





02-1

### **OVERALL ROOF - GENERAL NOTES**

REFER TO G0.2X SHEETS FOR EXTERIOR AND INTERIOR

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SNOWMELT

RIDGEVENT

#### OVERALL ROOF - LEGEND



EPDM ROOFING RS-FR ASSEMBLY

ROOF BALLAST RS-CR ASSEMBLY

**GREEN ROOF** RS-GC / RS-GU ASSEMBLIES

## **OVERALL PLAN - GENERAL NOTES**

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- WINDOW/DOOR SCHEDULES AND LEGENDS. ALIGN WALLS WHERE THEY APPEAR TO ALIGN, U.N.O.
- THE INSIDE FACE OF DOOR JAMBS SHALL BE 4" FROM ADJACENT WALL OR FINISHED COLUMN, U.N.O.
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- INSULATION. 2. CONTRACTOR SHALL COORDINATE ALL MEANS, METHODS, SEQUENCES PROCEDURES AND SCHEDULES OF ALL CONSTRUCTION ACTIVITIES AND OPERATIONS FOR THE CONSTRUCTION OF THE PROJECT.
- 13. CONTRACTOR RESPONSIBLE FOR OBTAINING AND COMPLYING WITH ALL PERMITS. 4. CONTRACTOR RESPONSIBLE FOR COMPLYING WITH ALL
- MANUFACTURERS RECOMMENDATIONS FOR STORAGE. PREPARATION, FABRICATION, INSTALLATION AND CURING OF MATERIALS AND SYSTEMS.


B-2465 12/15/2023 LO ARC 2

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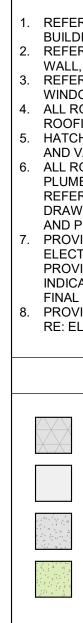
**359** Design

3630 OSAGE STREET DENVER, CO 80211 720.512.3437

No.	Description	Date
1	GMP REVISIONS	02.09.24
2	IFC SET	02.09.24
3	RFI #21	03.15.24 04.16.24
4	RFI #129	06.27.24
5	RFI #214	08.21.24
3	RFI #214.1	09.18.24
7 B	RFI #252 RFI #318	10.01.24
9	RFI #332	10.13.24
0	RFI #348	11.13.24
	THE AMBLE	•
ISSUE	IFC SET	
SHEET TITL	E	
	R PLAN - LE	VEL O

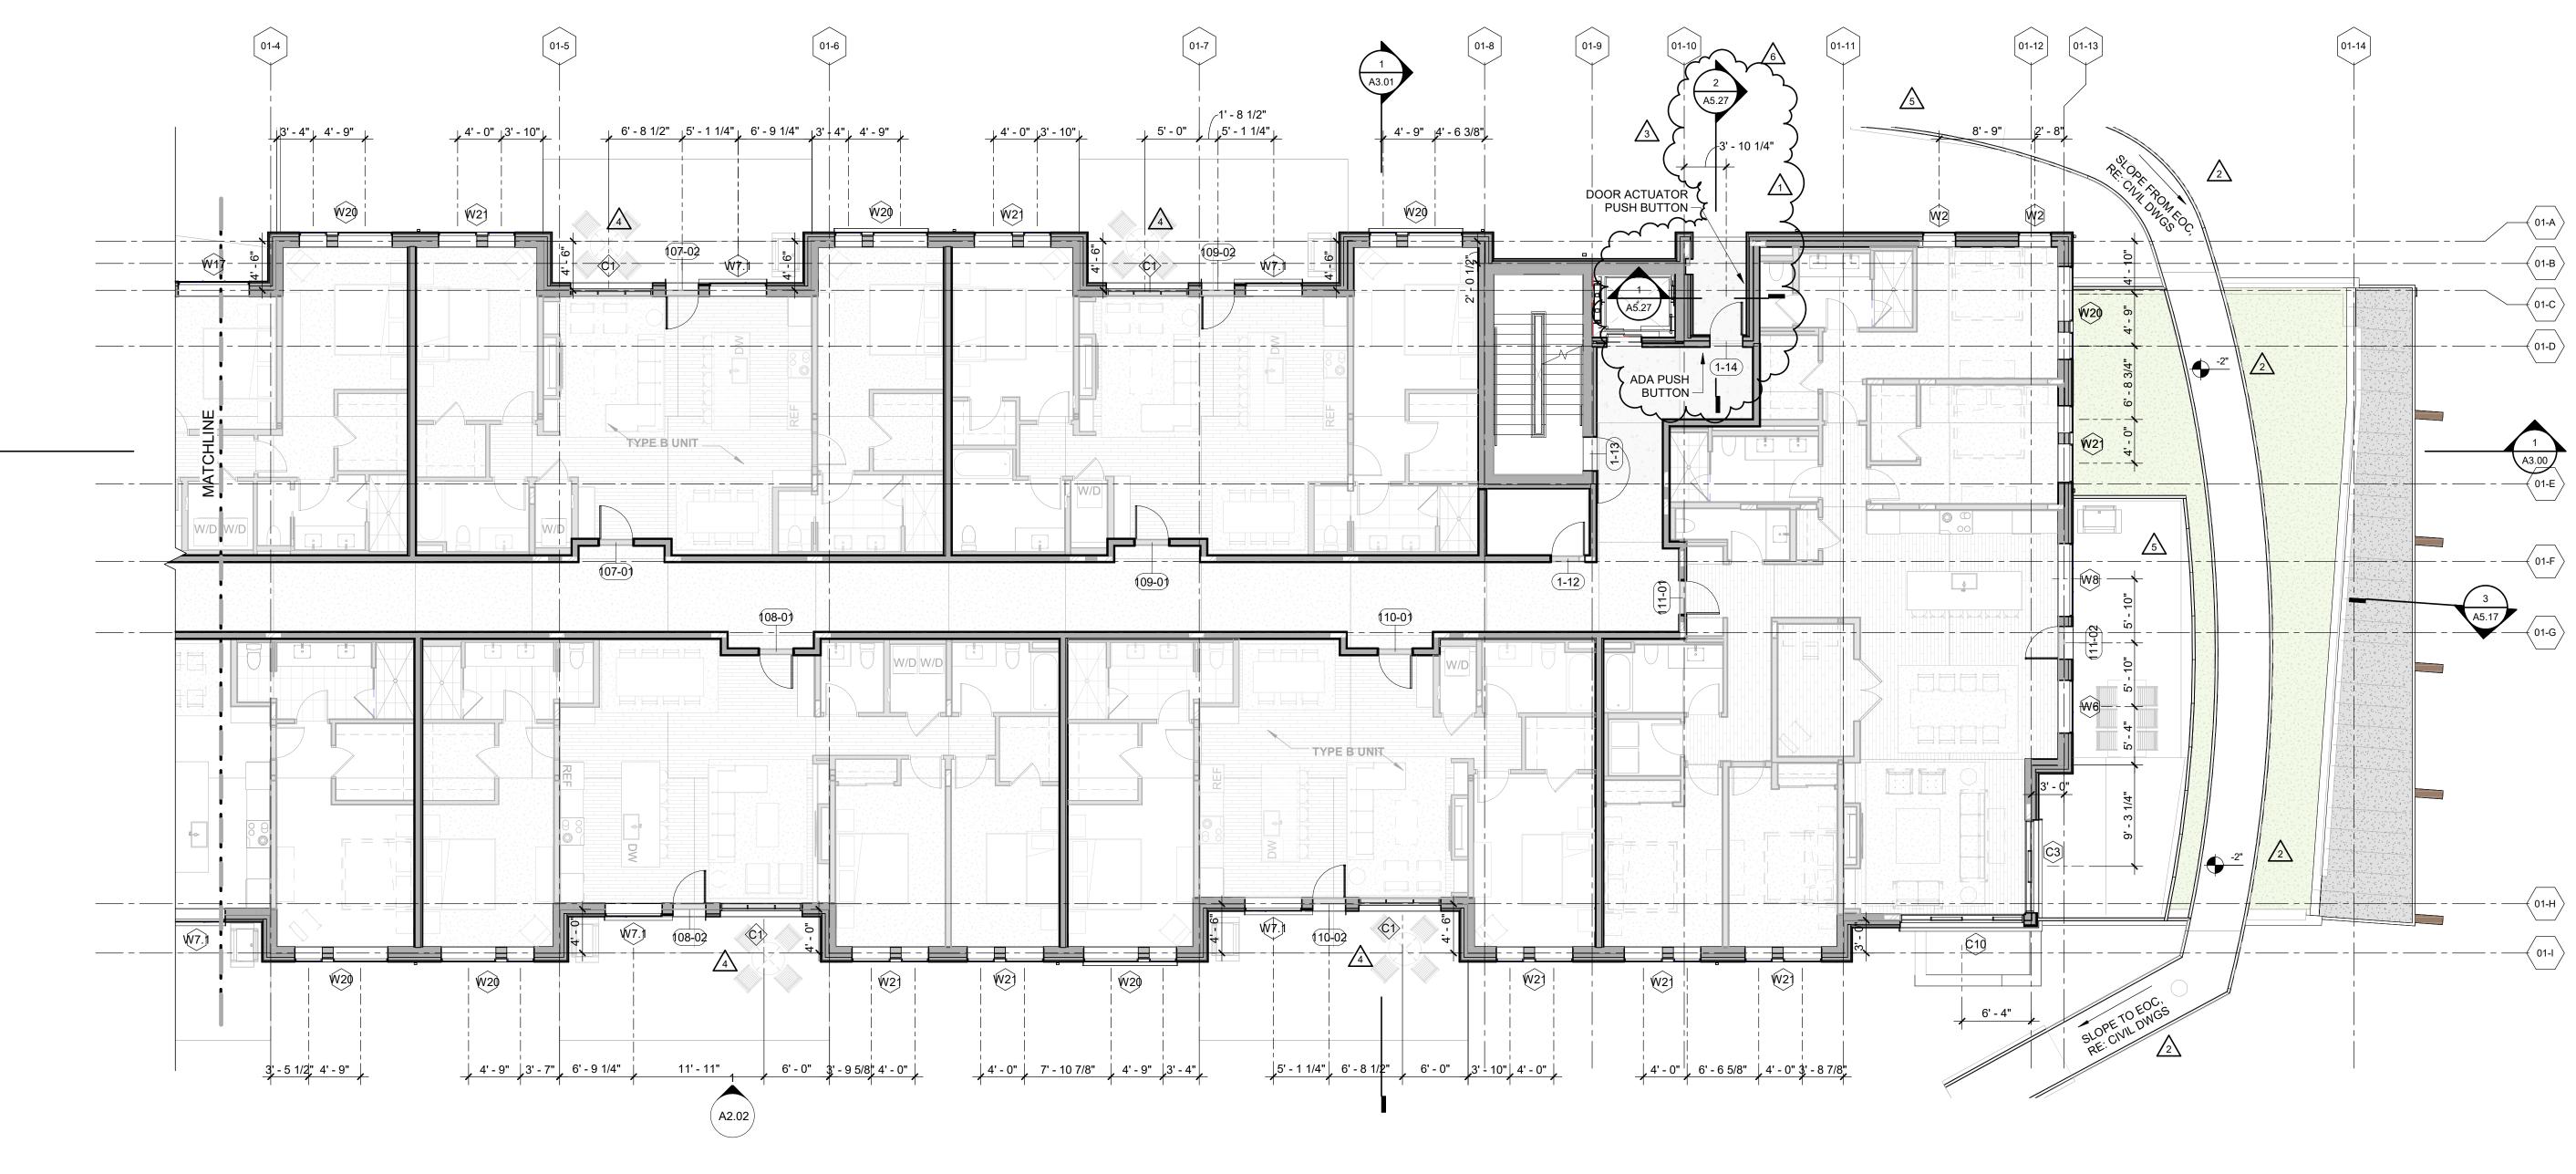

**FLOOR PLAN - LEVEL 01 - EAST** 1/8" = 1'-0"




## **OVERALL ROOF - GENERAL NOTES**

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 PROVIDE WALKWAY PROTECTION TO MAJOR MECHANICAL, ELECTRICAL, AND PLUMBING EQUIPMENT AS REQUIRED TO PROVIDE SERVICE ACCESS. WALKWAY PROTECTION IS INDICATED AS A GENERAL LAYOUT AND MAY NOT SHOW FINAL LOCATIONS OF ALL EQUIPMENT.
 PROVIDE SNOW MELT AT ALL GUTTERS & DOWNSPOUTS. RE: ELECTRICAL

## OVERALL ROOF - LEGEND



# **OVERALL PLAN - GENERAL NOTES**

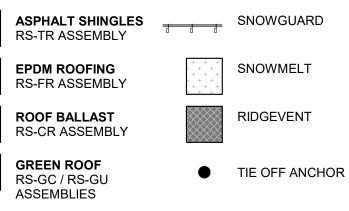- 1. REFER TO G0.2X SHEETS FOR EXTERIOR AND INTERIOR BUILDING ENCLOSURE ASSEMBLIES.
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   REFER TO A1.1X SHEETS FOR INTERIOR AND EXTERIOR
- WINDOW/DOOR TAGS WITH UNIT BACKGROUNDS. 4. REFER TO A6.0X SHEETS FOR INTERIOR AND EXTERIOR
- WINDOW/DOOR SCHEDULES AND LEGENDS. 5. ALIGN WALLS WHERE THEY APPEAR TO ALIGN, U.N.O.
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- ALL DIMENSIONS ARE TO FACE OF STUD, GRID LINE, OR FACE OF CONCRETE, U.N.O.
- ELECTRICAL METER AND SERVICE TO BE MOUNTED AT GARAGE LEVEL, COORDINATE METER AND PANEL
- LOCATION WITH OWNER. 0. ELECTRICAL CONTRACTOR SHALL PROVIDE DESIGN BUILD SECURITY SYSTEM, CORD. WITH OWNER.
- 11. WATER PIPES RUNNING NEXT TO OR WITHIN EXTERIOR WALLS TO BE INSULATED W/ 2" MIN CLOSED CELL INSULATION.
- CONTRACTOR SHALL COORDINATE ALL MEANS, METHODS, SEQUENCES PROCEDURES AND SCHEDULES OF ALL CONSTRUCTION ACTIVITIES AND OPERATIONS FOR THE CONSTRUCTION OF THE PROJECT.
   CONTRACTOR RESPONSIBLE FOR OBTAINING AND
- COMPLYING WITH ALL PERMITS. 14. CONTRACTOR RESPONSIBLE FOR COMPLYING WITH ALL
- MANUFACTURERS RECOMMENDATIONS FOR STORAGE, PREPARATION, FABRICATION, INSTALLATION AND CURING OF MATERIALS AND SYSTEMS.


TOWN STAMP **359** Design 3630 OSAGE STREET DENVER, CO 80211 720.512.3437 B-2465 12/15/2023 ED ARC' U q No. Description Date PROJECT NUMBER ISSUE DATE THE AMBLE

IFC SET


SHEET TITLE FLOOR PLAN - LEVEL 01 - EAST

A1.11.2

SHEET NO.

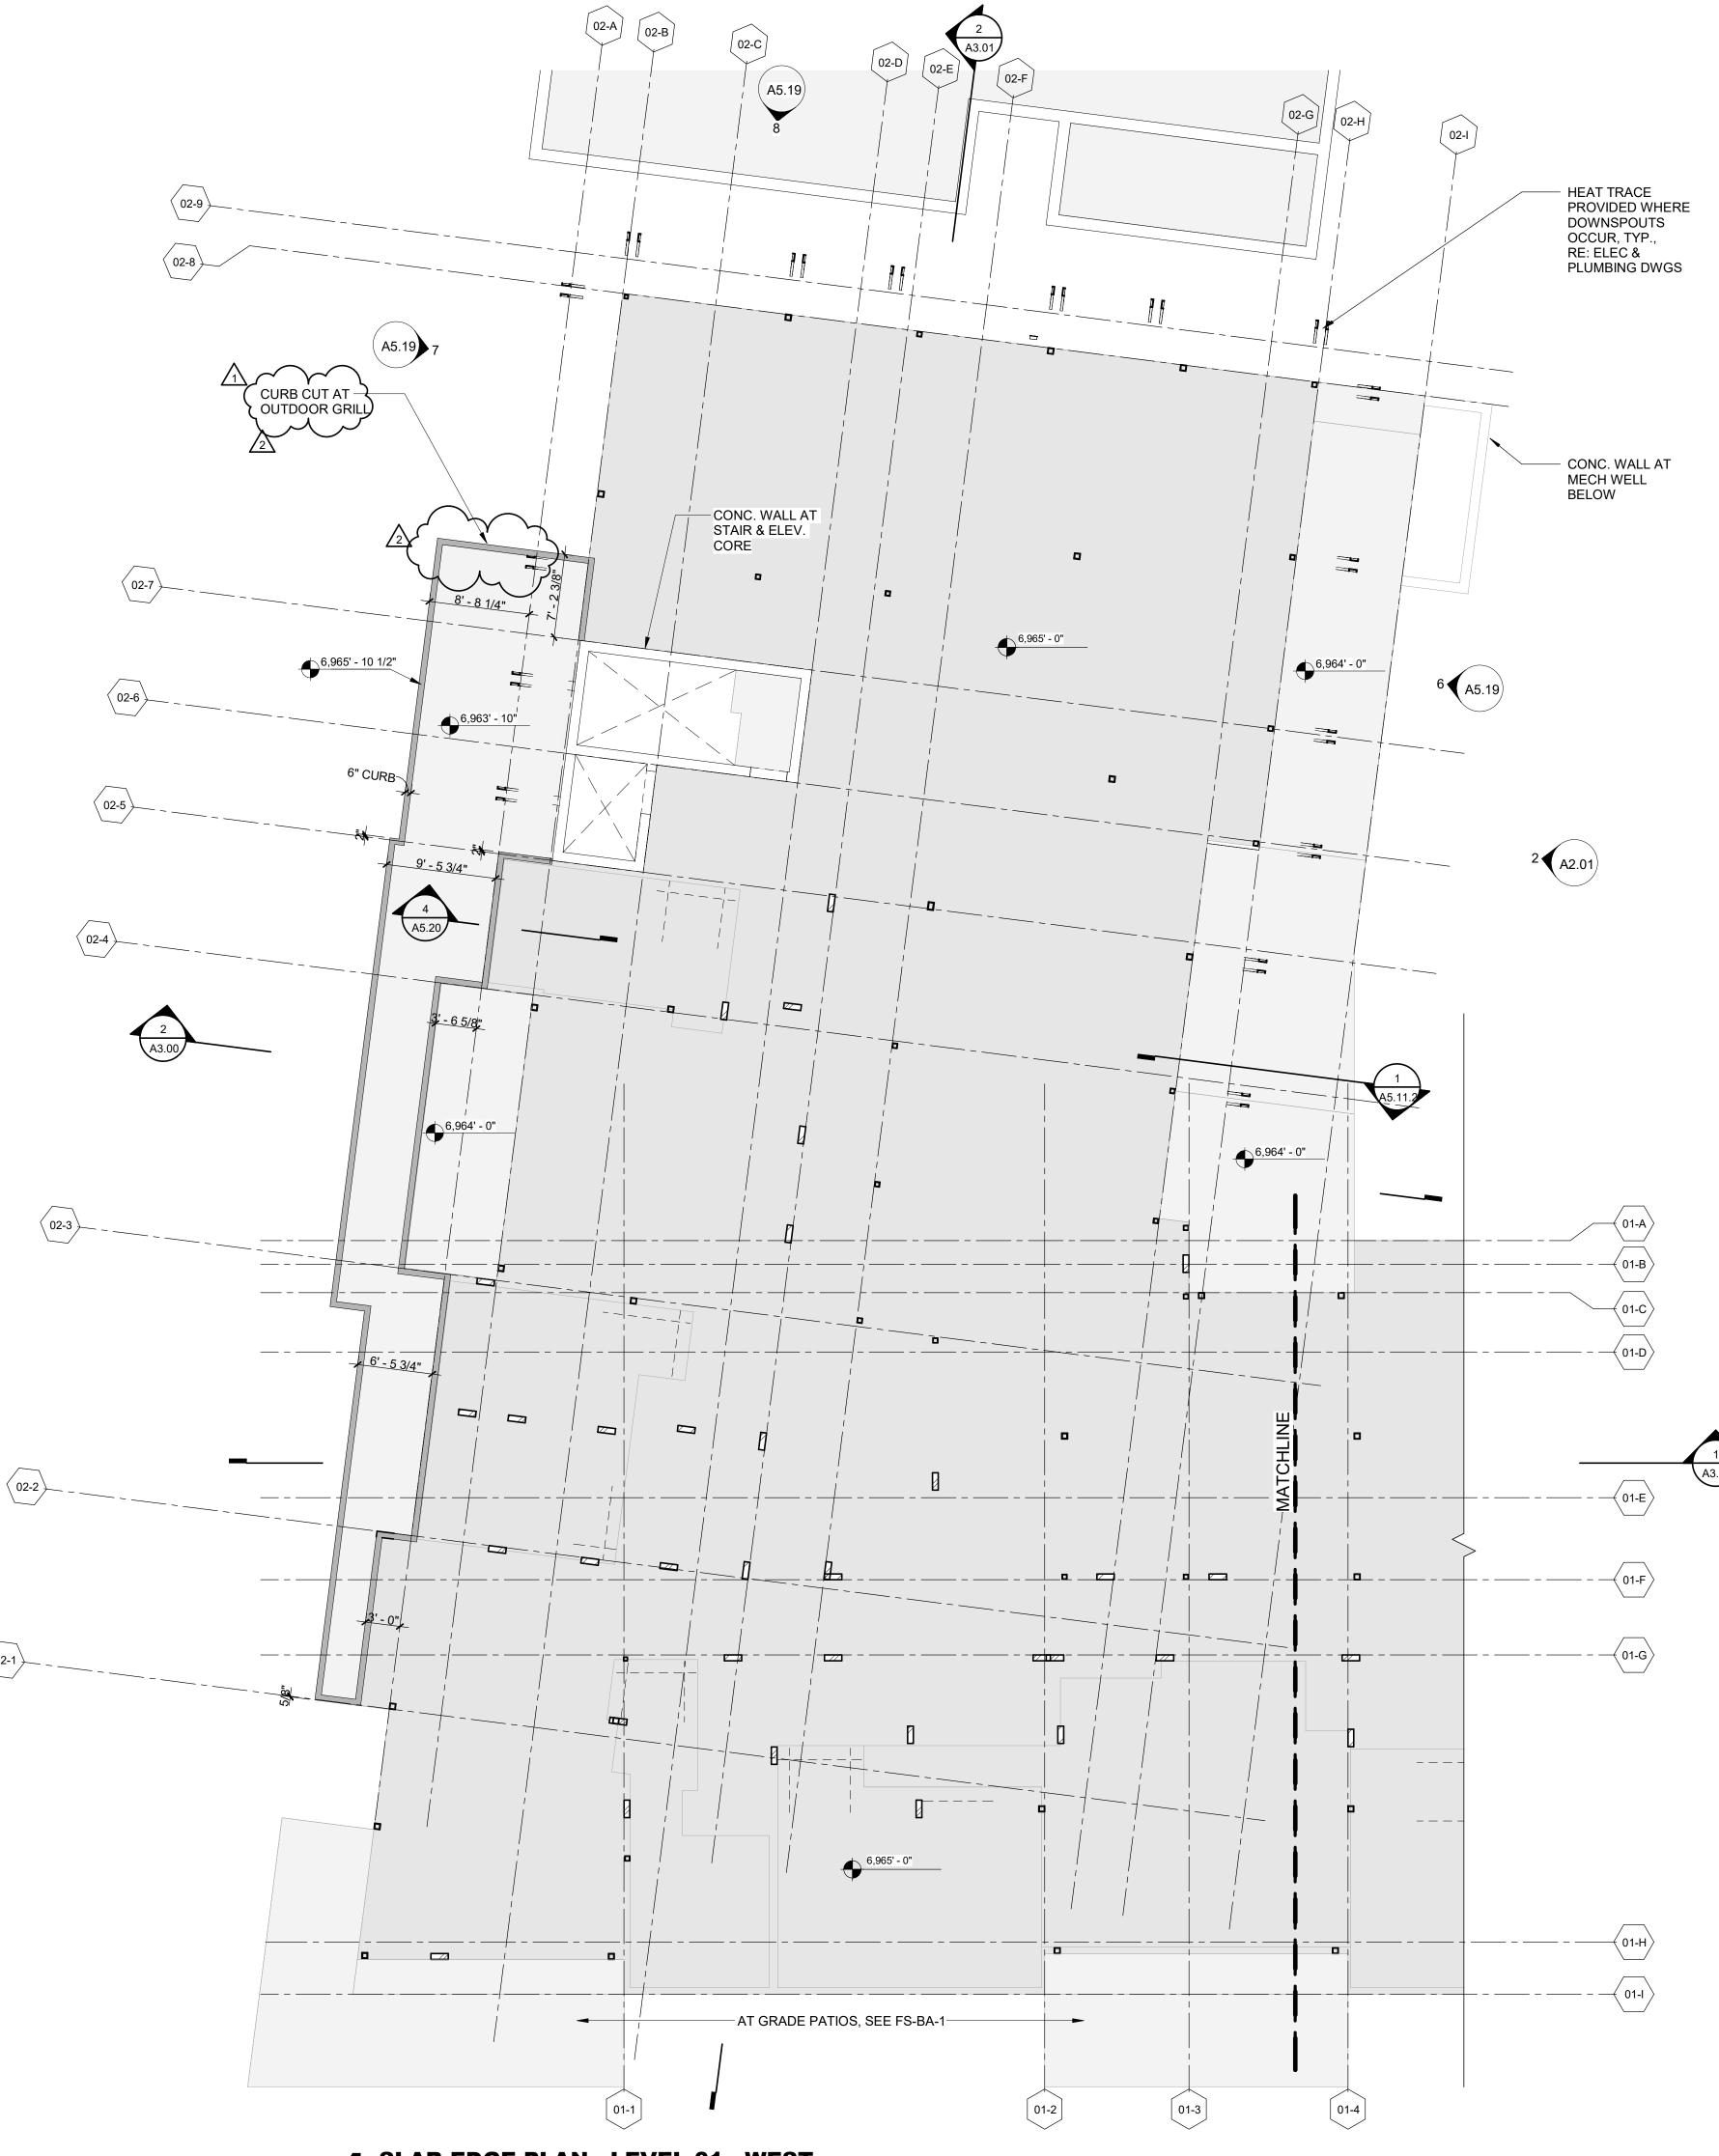

⟨ 02-1 ⟩

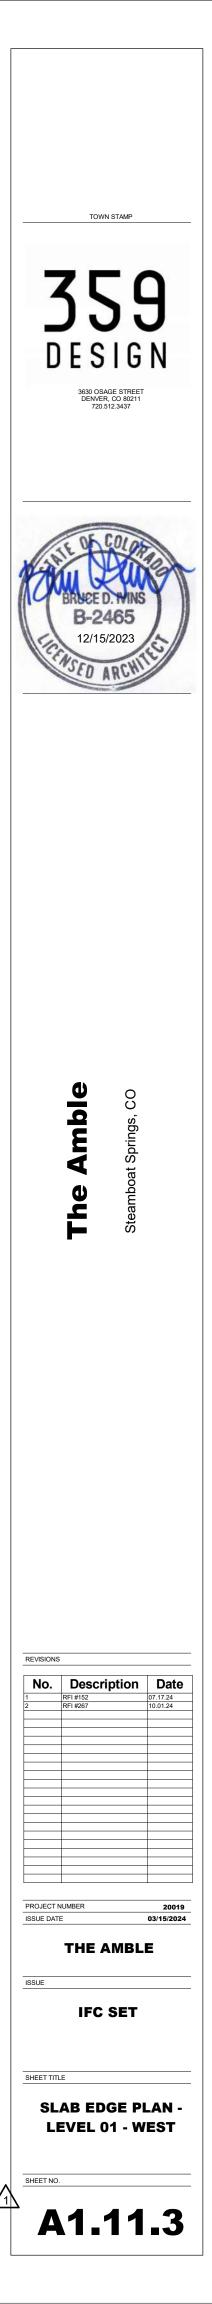





RIOR AND INTERIOR		1. REFER TO G0.2X SHEETS FOR EXTERIOR AND INTERIOR BUILDING ENCLOSURE ASSEMBLIES.	
RIOR WALL, DEMISING		2. REFER TO A1.0X SHEETS FOR EXTERIOR WALL, DEMISING	
AND LOCATIONS.		WALL, AND CORRIDOR WALL TYPES AND LOCATIONS.	
RIOR AND EXTERIOR		3. REFER TO A1.1X SHEETS FOR INTERIOR AND EXTERIOR	
CKGROUNDS.		WINDOW/DOOR TAGS WITH UNIT BACKGROUNDS.	
] SHALL BE EPDM	4	4. REFER TO A6.0X SHEETS FOR INTERIOR AND EXTERIOR	
N.O.		WINDOW/DOOR SCHEDULES AND LEGENDS.	TOWN STAMP
OF SNOW MELT EAVE	5	5. ALIGN WALLS WHERE THEY APPEAR TO ALIGN, U.N.O.	
AL DRAWINGS.	6	5. THE INSIDE FACE OF DOOR JAMBS SHALL BE 4" FROM	
RICAL, AND/OR		ADJACENT WALL OR FINISHED COLUMN, U.N.O.	
R REFERENCE ONLY.		7. SWING CLEARANCE AT UNIT ENTRY SHALL BE 18" MIN.	
AL, AND/OR PLUMBING		FROM FINISH FACE OF ADJACENT SURFACE.	
OR SPECIFIC DESIGN	8	3. ALL DIMENSIONS ARE TO FACE OF STUD, GRID LINE, OR	359
		FACE OF CONCRETE, U.N.O.	
O MAJOR MECHANICAL,	9	9. ELECTRICAL METER AND SERVICE TO BE MOUNTED AT	
MENT AS REQUIRED TO		GARAGE LEVEL, COORDINATE METER AND PANEL	DECION
AY PROTECTION IS		LOCATION WITH OWNER.	DESIGN
AND MAY NOT SHOW	-	10. ELECTRICAL CONTRACTOR SHALL PROVIDE DESIGN BUILD	DEGIGI
NT.		SECURITY SYSTEM, CORD. WITH OWNER.	3630 OSAGE STREET
ERS & DOWNSPOUTS.	-	11. WATER PIPES RUNNING NEXT TO OR WITHIN EXTERIOR	DENVER, CO 80211 720.512.3437
		WALLS TO BE INSULATED W/ 2" MIN CLOSED CELL	
		INSULATION.	
		12. CONTRACTOR SHALL COORDINATE ALL MEANS, METHODS,	
EGEND		SEQUENCES PROCEDURES AND SCHEDULES OF ALL	
		CONSTRUCTION ACTIVITIES AND OPERATIONS FOR THE	
		CONSTRUCTION OF THE PROJECT.	
	· ·	13. CONTRACTOR RESPONSIBLE FOR OBTAINING AND	
SNOWGUARD		COMPLYING WITH ALL PERMITS.	
U	-	14. CONTRACTOR RESPONSIBLE FOR COMPLYING WITH ALL	25 60.
		MANUFACTURERS RECOMMENDATIONS FOR STORAGE,	14 0 60100
		PREPARATION, FABRICATION, INSTALLATION AND CURING	
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+ +			A POLICE D MING
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**OVERALL PLAN - GENERAL NOTES** 




8

VISIONS		
No.	Description	Date
	RFI #129	06.27.24
	RFI #154	07.03.24
OJECT	NUMBER	20019
SUE DAT	E	03/15/2024
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SUE		
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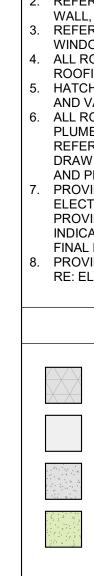
FLOOR PLAN - LEVEL 02 - WEST

A1.12.1

IEET	NO.	

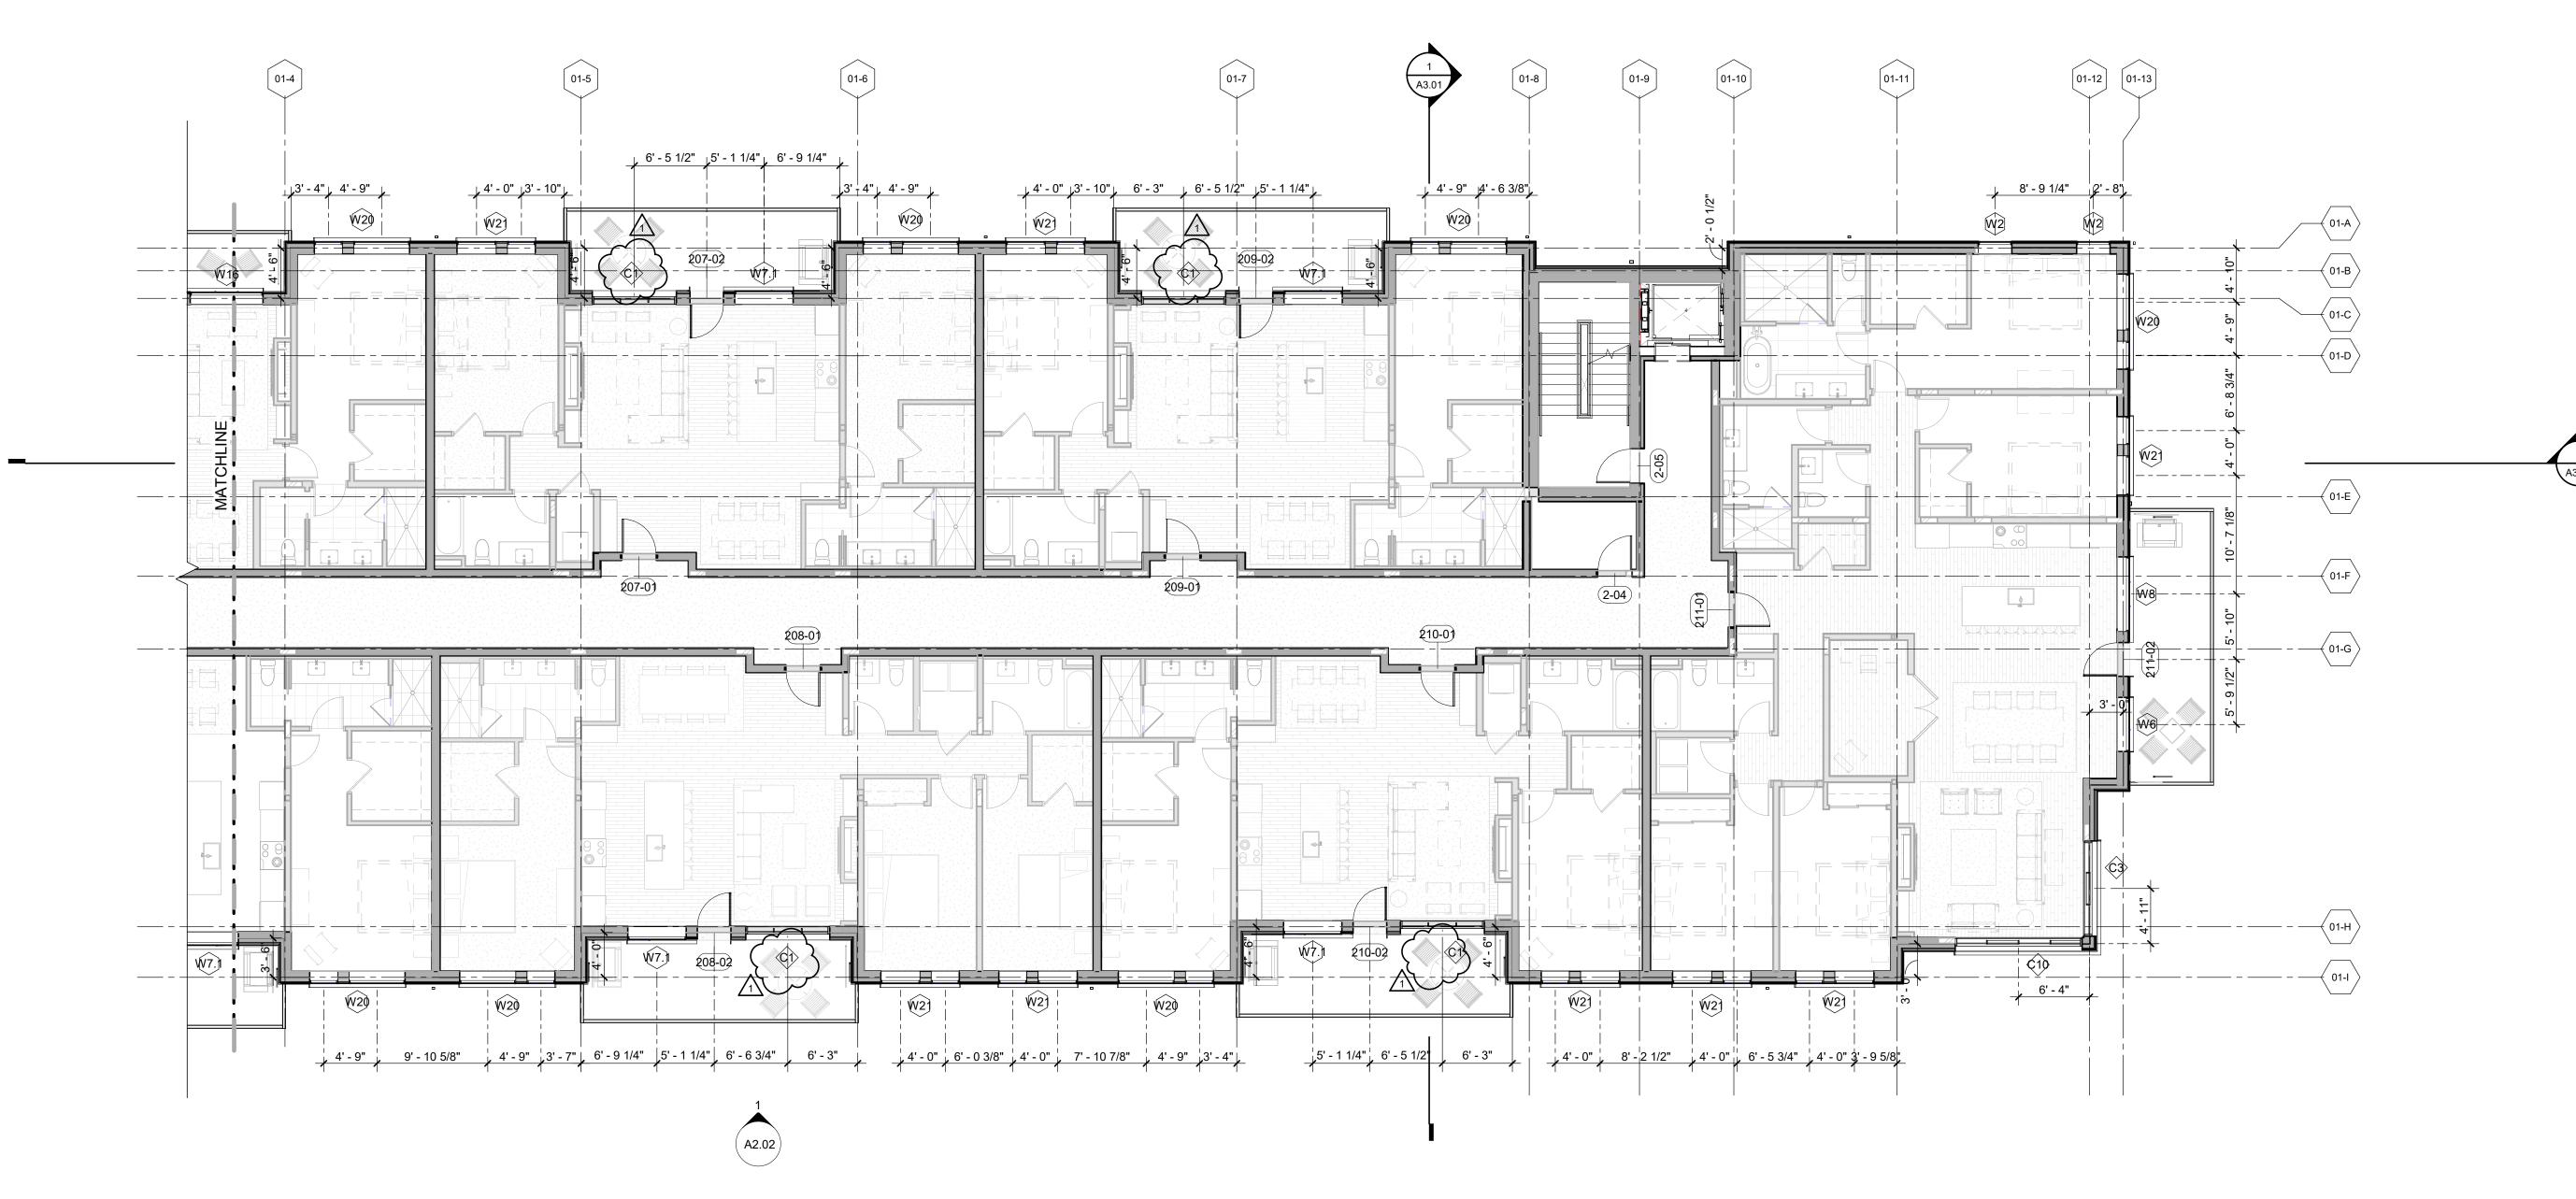

**FLOOR PLAN - LEVEL 02 - EAST** 1/8" = 1'-0"




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### OVERALL ROOF - LEGEND



## OVERALL PLAN - GENERAL NOTES

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- 3. ALL DIMENSIONS ARE TO FACE OF STUD, GRID LINE, OR FACE OF CONCRETE, U.N.O.
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TOWN STAMP

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### OVERALL ROOF - LEGEND

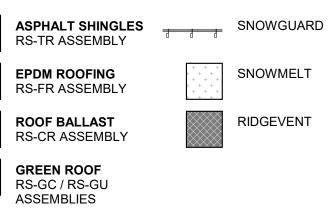

SNOWMELT

RIDGEVENT

#### ROOF BALLAST RS-CR ASSEMBLY

RS-FR ASSEMBLY

**GREEN ROOF** RS-GC / RS-GU ASSEMBLIES

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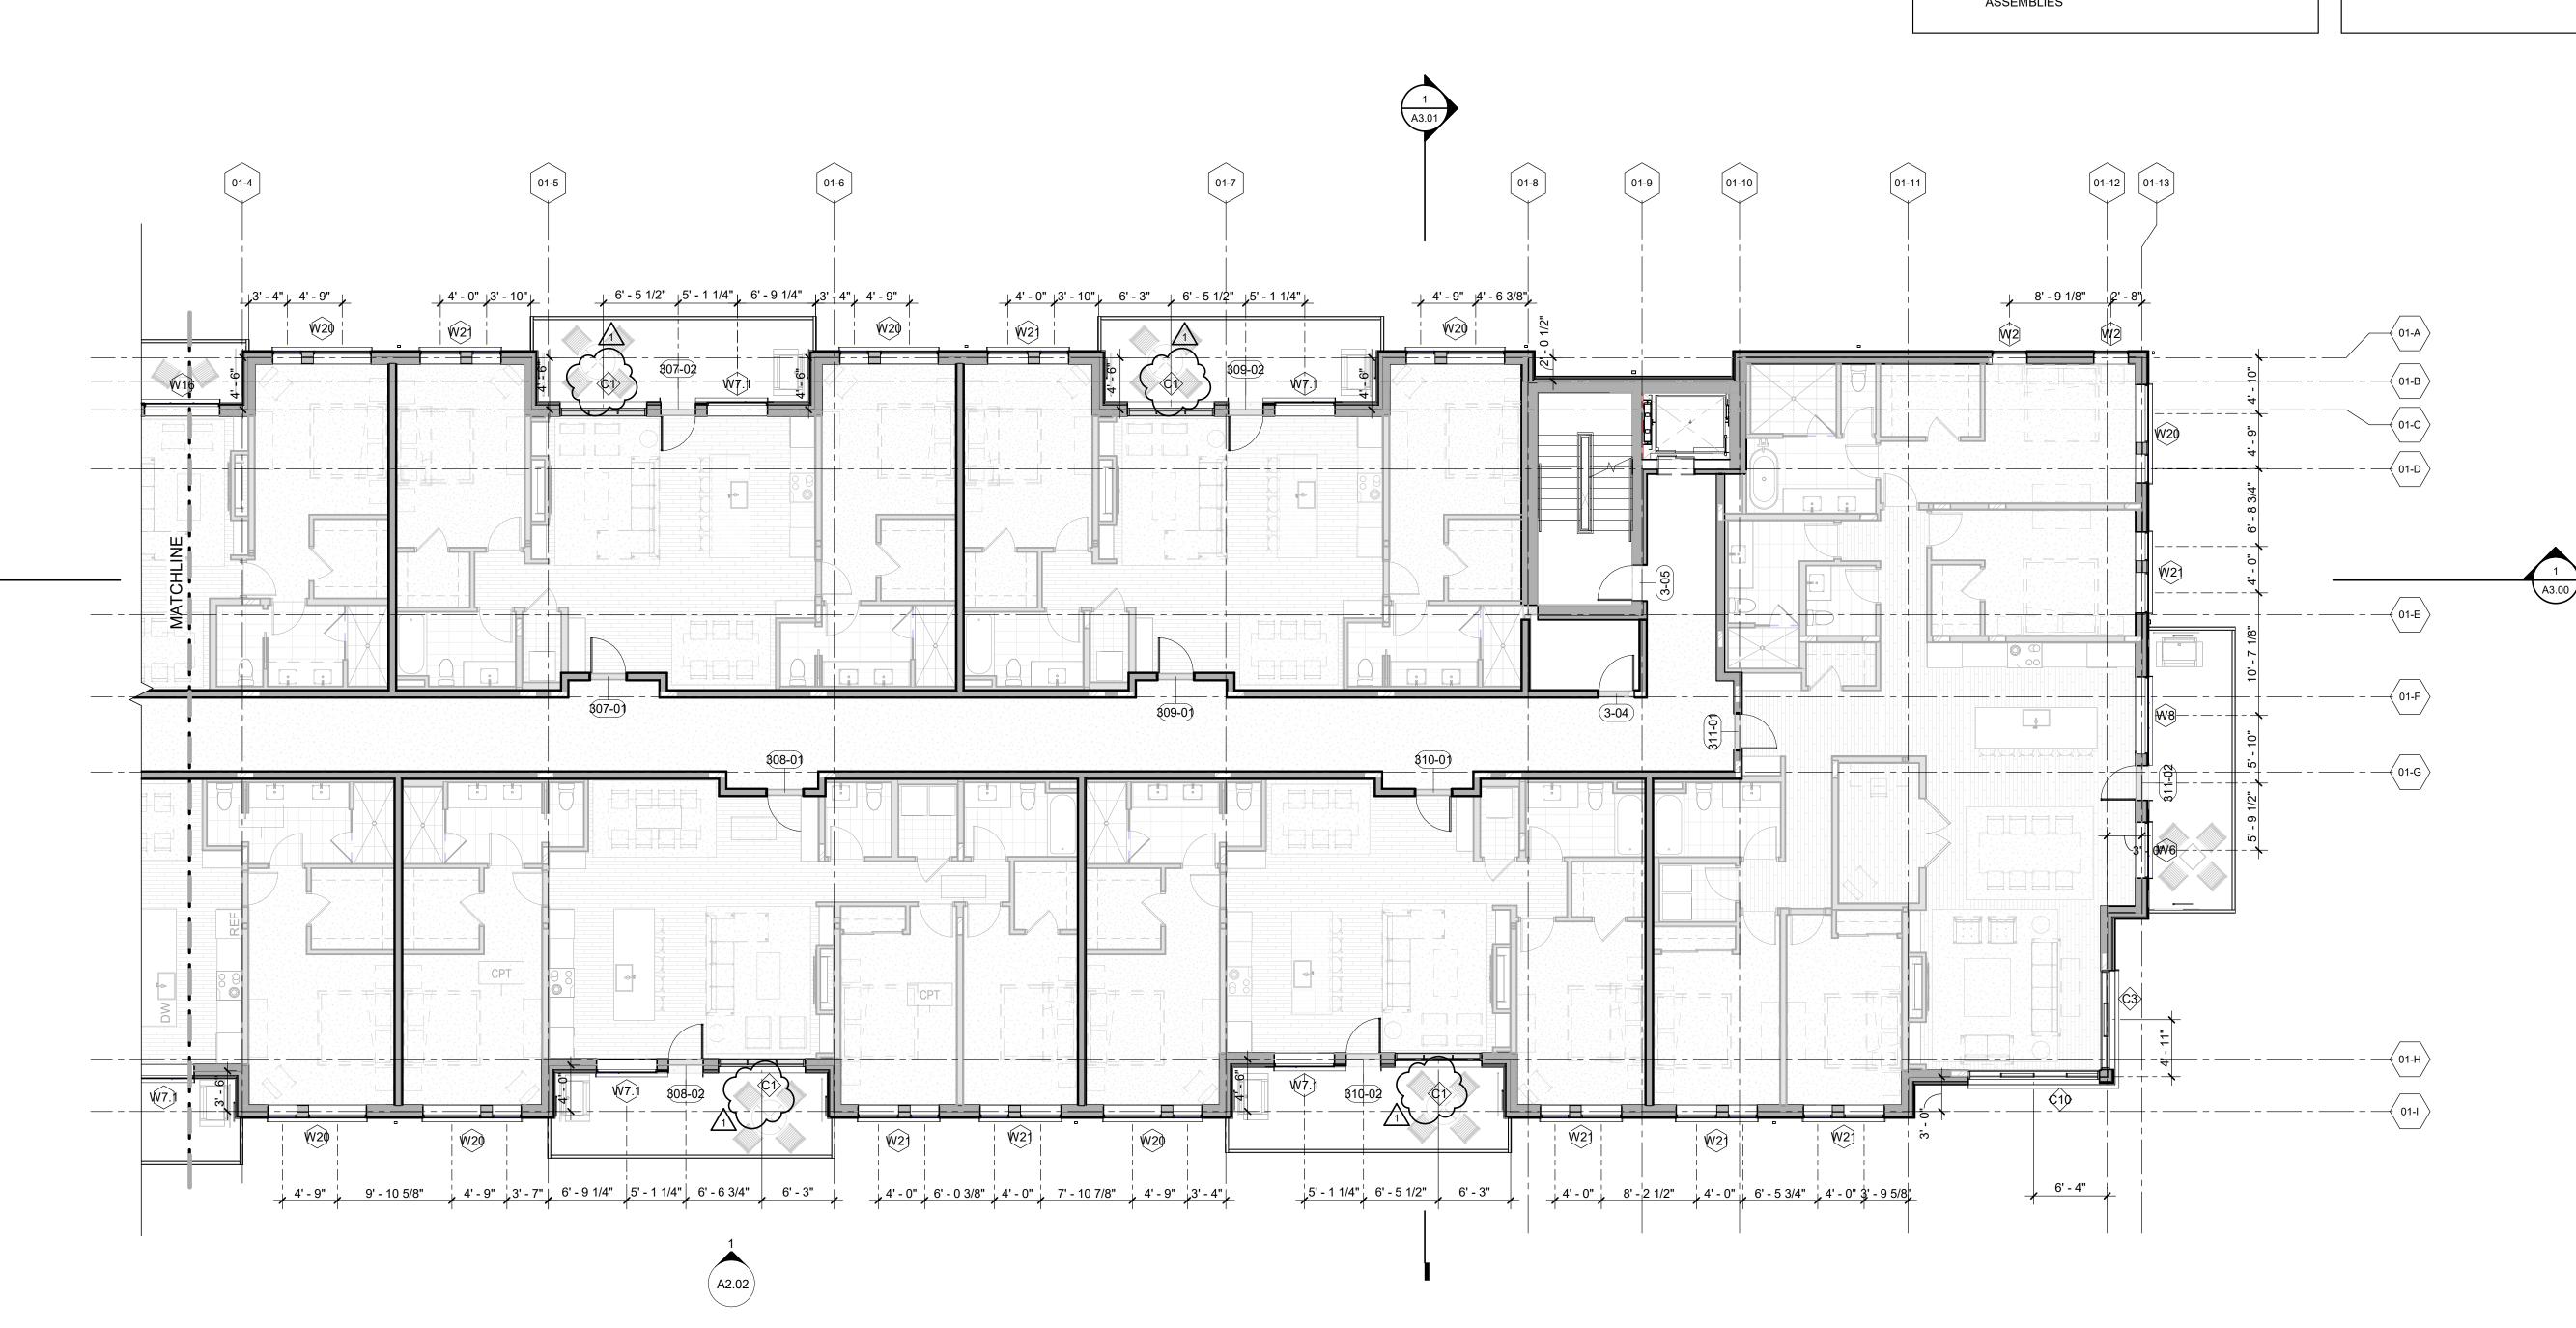
TOWN STAMP **359** Design 3630 OSAGE STREET DENVER, CO 80211 720.512.3437 B-2465 12/15/2023 ED ARC Ð q L No. Description Date PROJECT NUMBER ISSUE DATE THE AMBLE IFC SET

FLOOR PLAN - LEVEL 03 - WEST

SHEET NO.

A1.13.1

SHEET TITLE



**1 FLOOR PLAN - LEVEL 03 - EAST** 


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## OVERALL ROOF - LEGEND



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Creamboat Springs, CO

TOWN STAMP

359

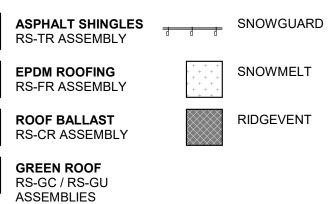DESIGN

3630 OSAGE STREET DENVER, CO 80211 720.512.3437

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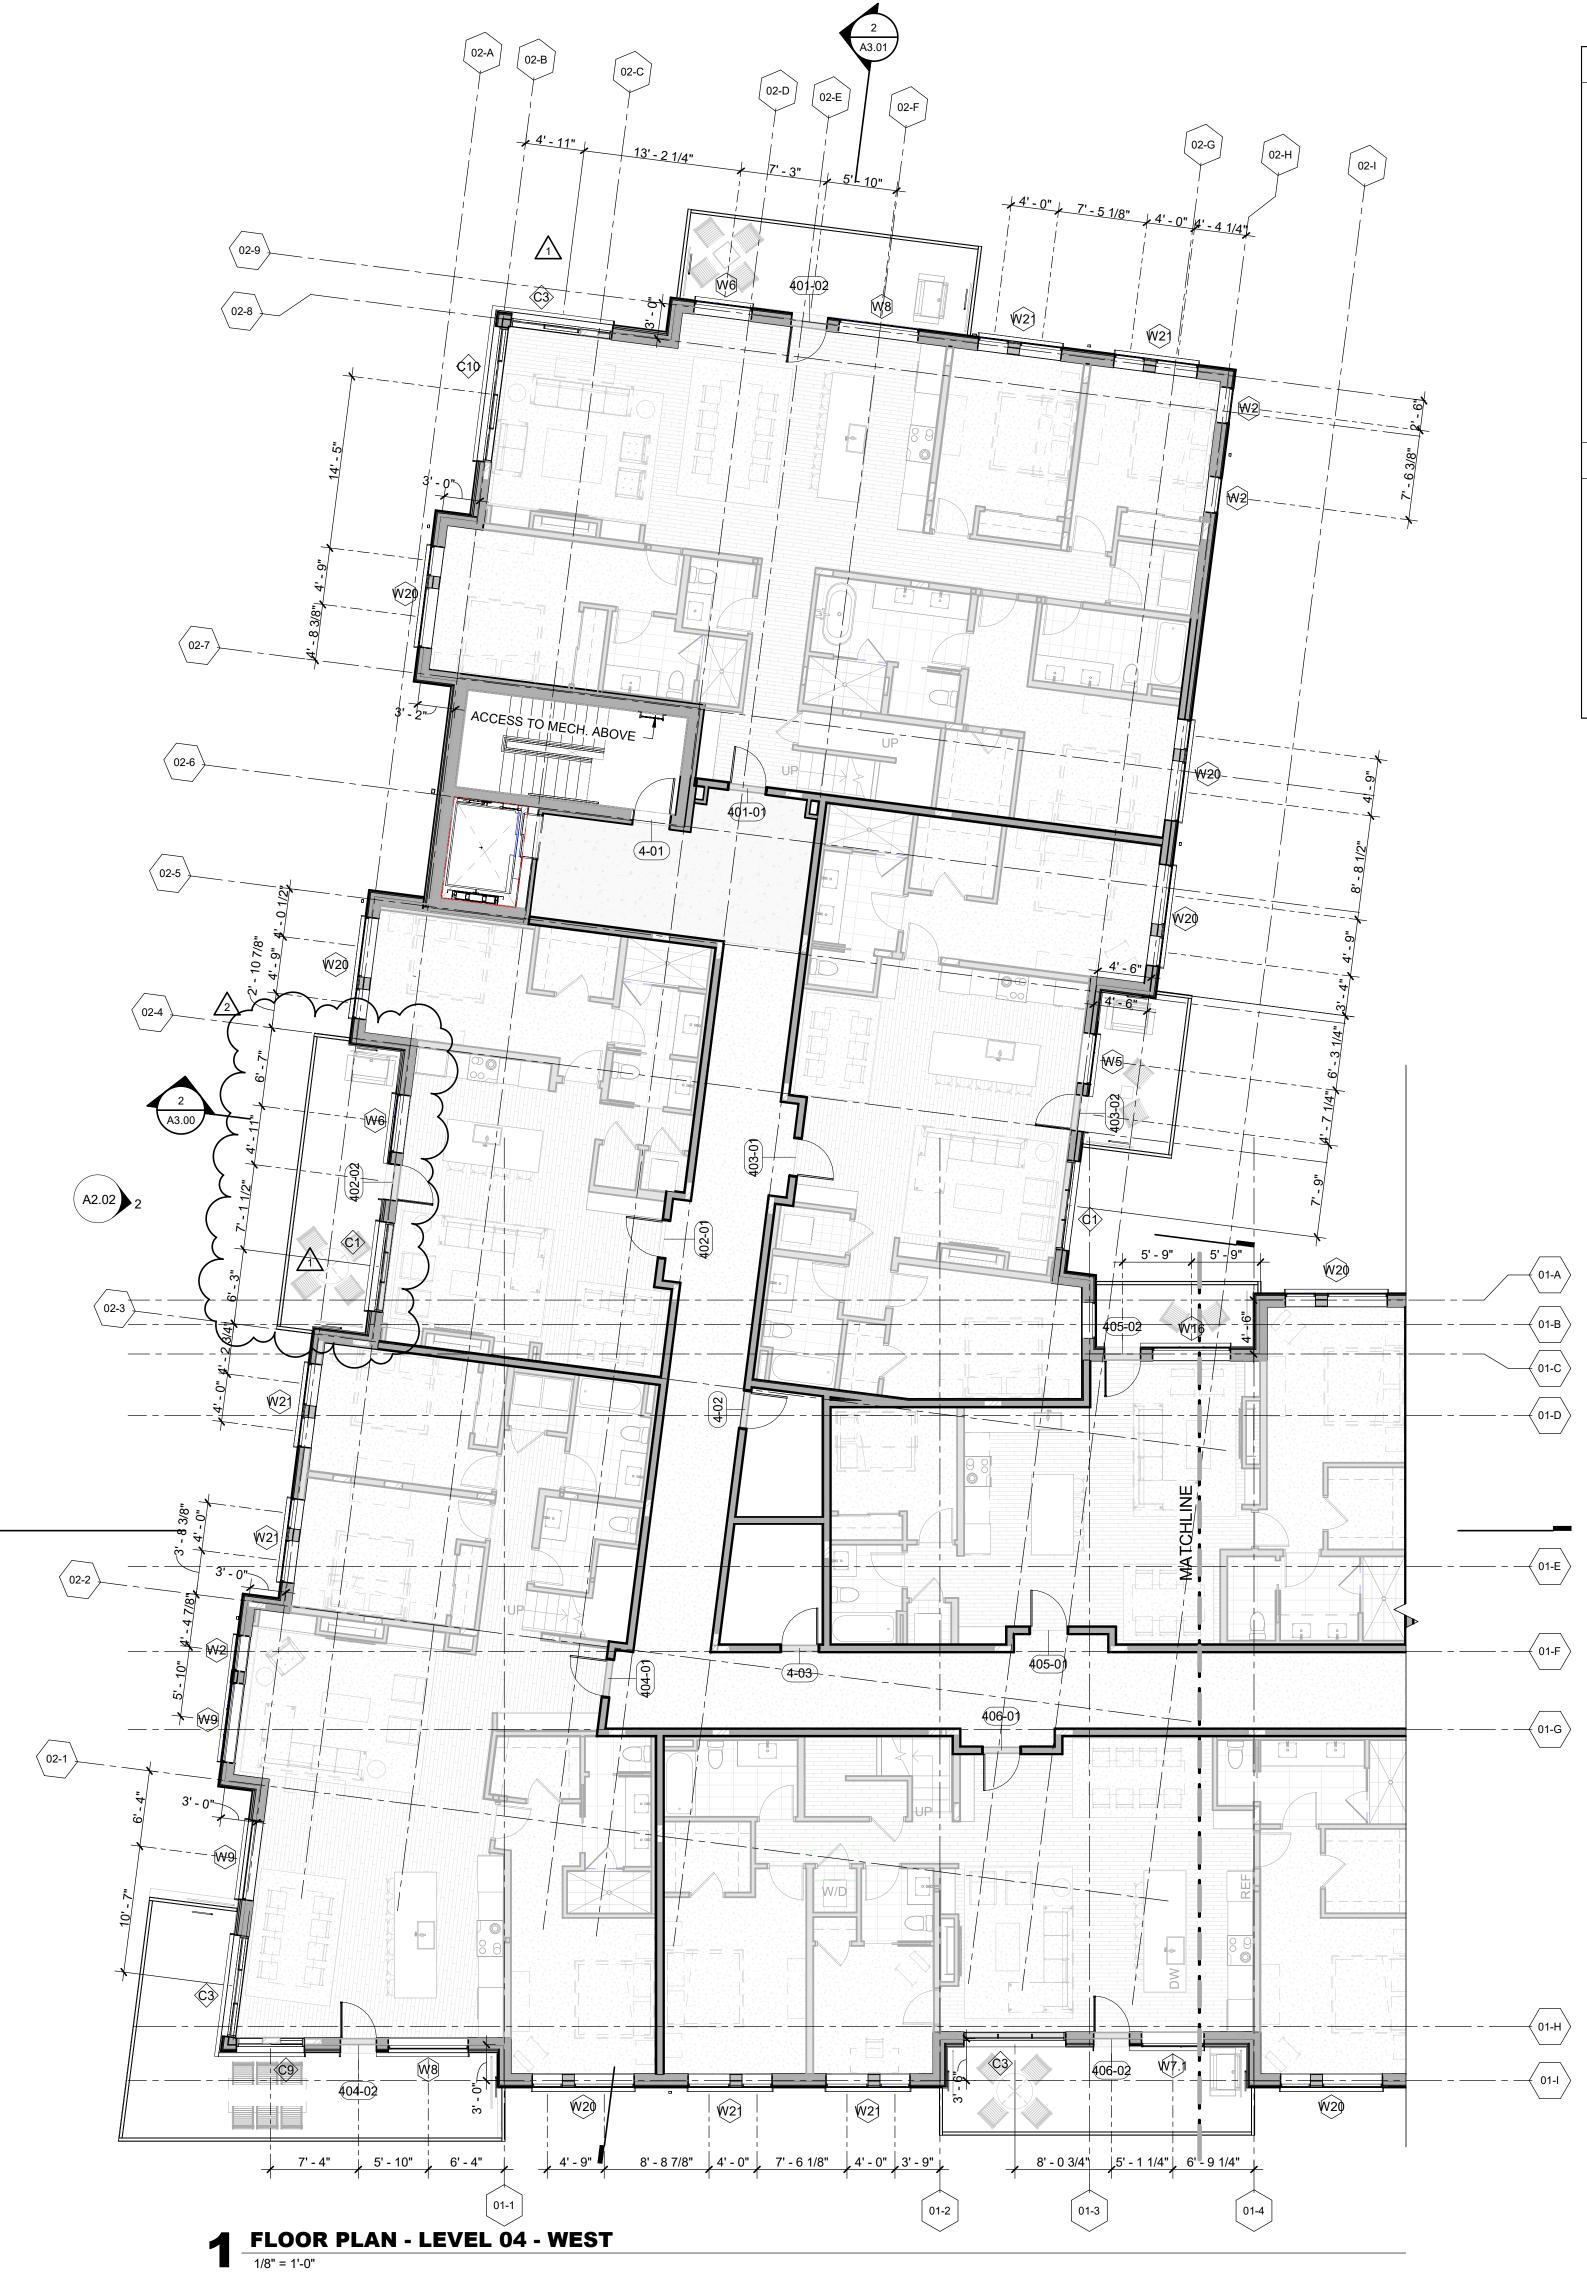
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SHEET NO.

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SNOWMELT

RIDGEVENT

#### OVERALL ROOF - LEGEND

- ASPHALT SHINGLES SNOWGUARD RS-TR ASSEMBLY
- EPDM ROOFING RS-FR ASSEMBLY
- ROOF BALLAST

RS-CR ASSEMBLY

**GREEN ROOF** RS-GC / RS-GU ASSEMBLIES

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TOWN STAMP

**359** Design


3630 OSAGE STREET DENVER, CO 80211 720.512.3437

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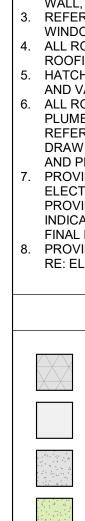
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	RFI #154	07.03.24
ROJECT		20019
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**FLOOR PLAN - LEVEL 04 - EAST** 1/8" = 1'-0"




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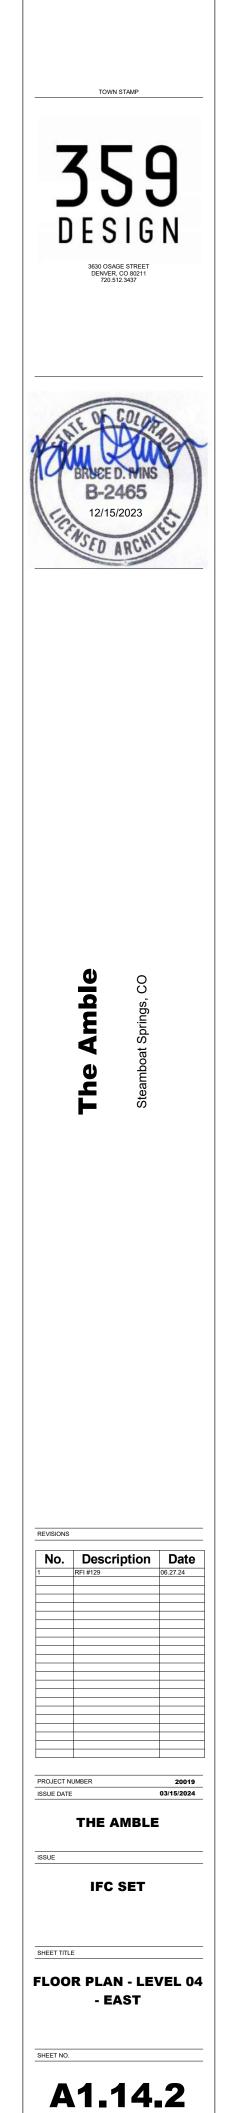
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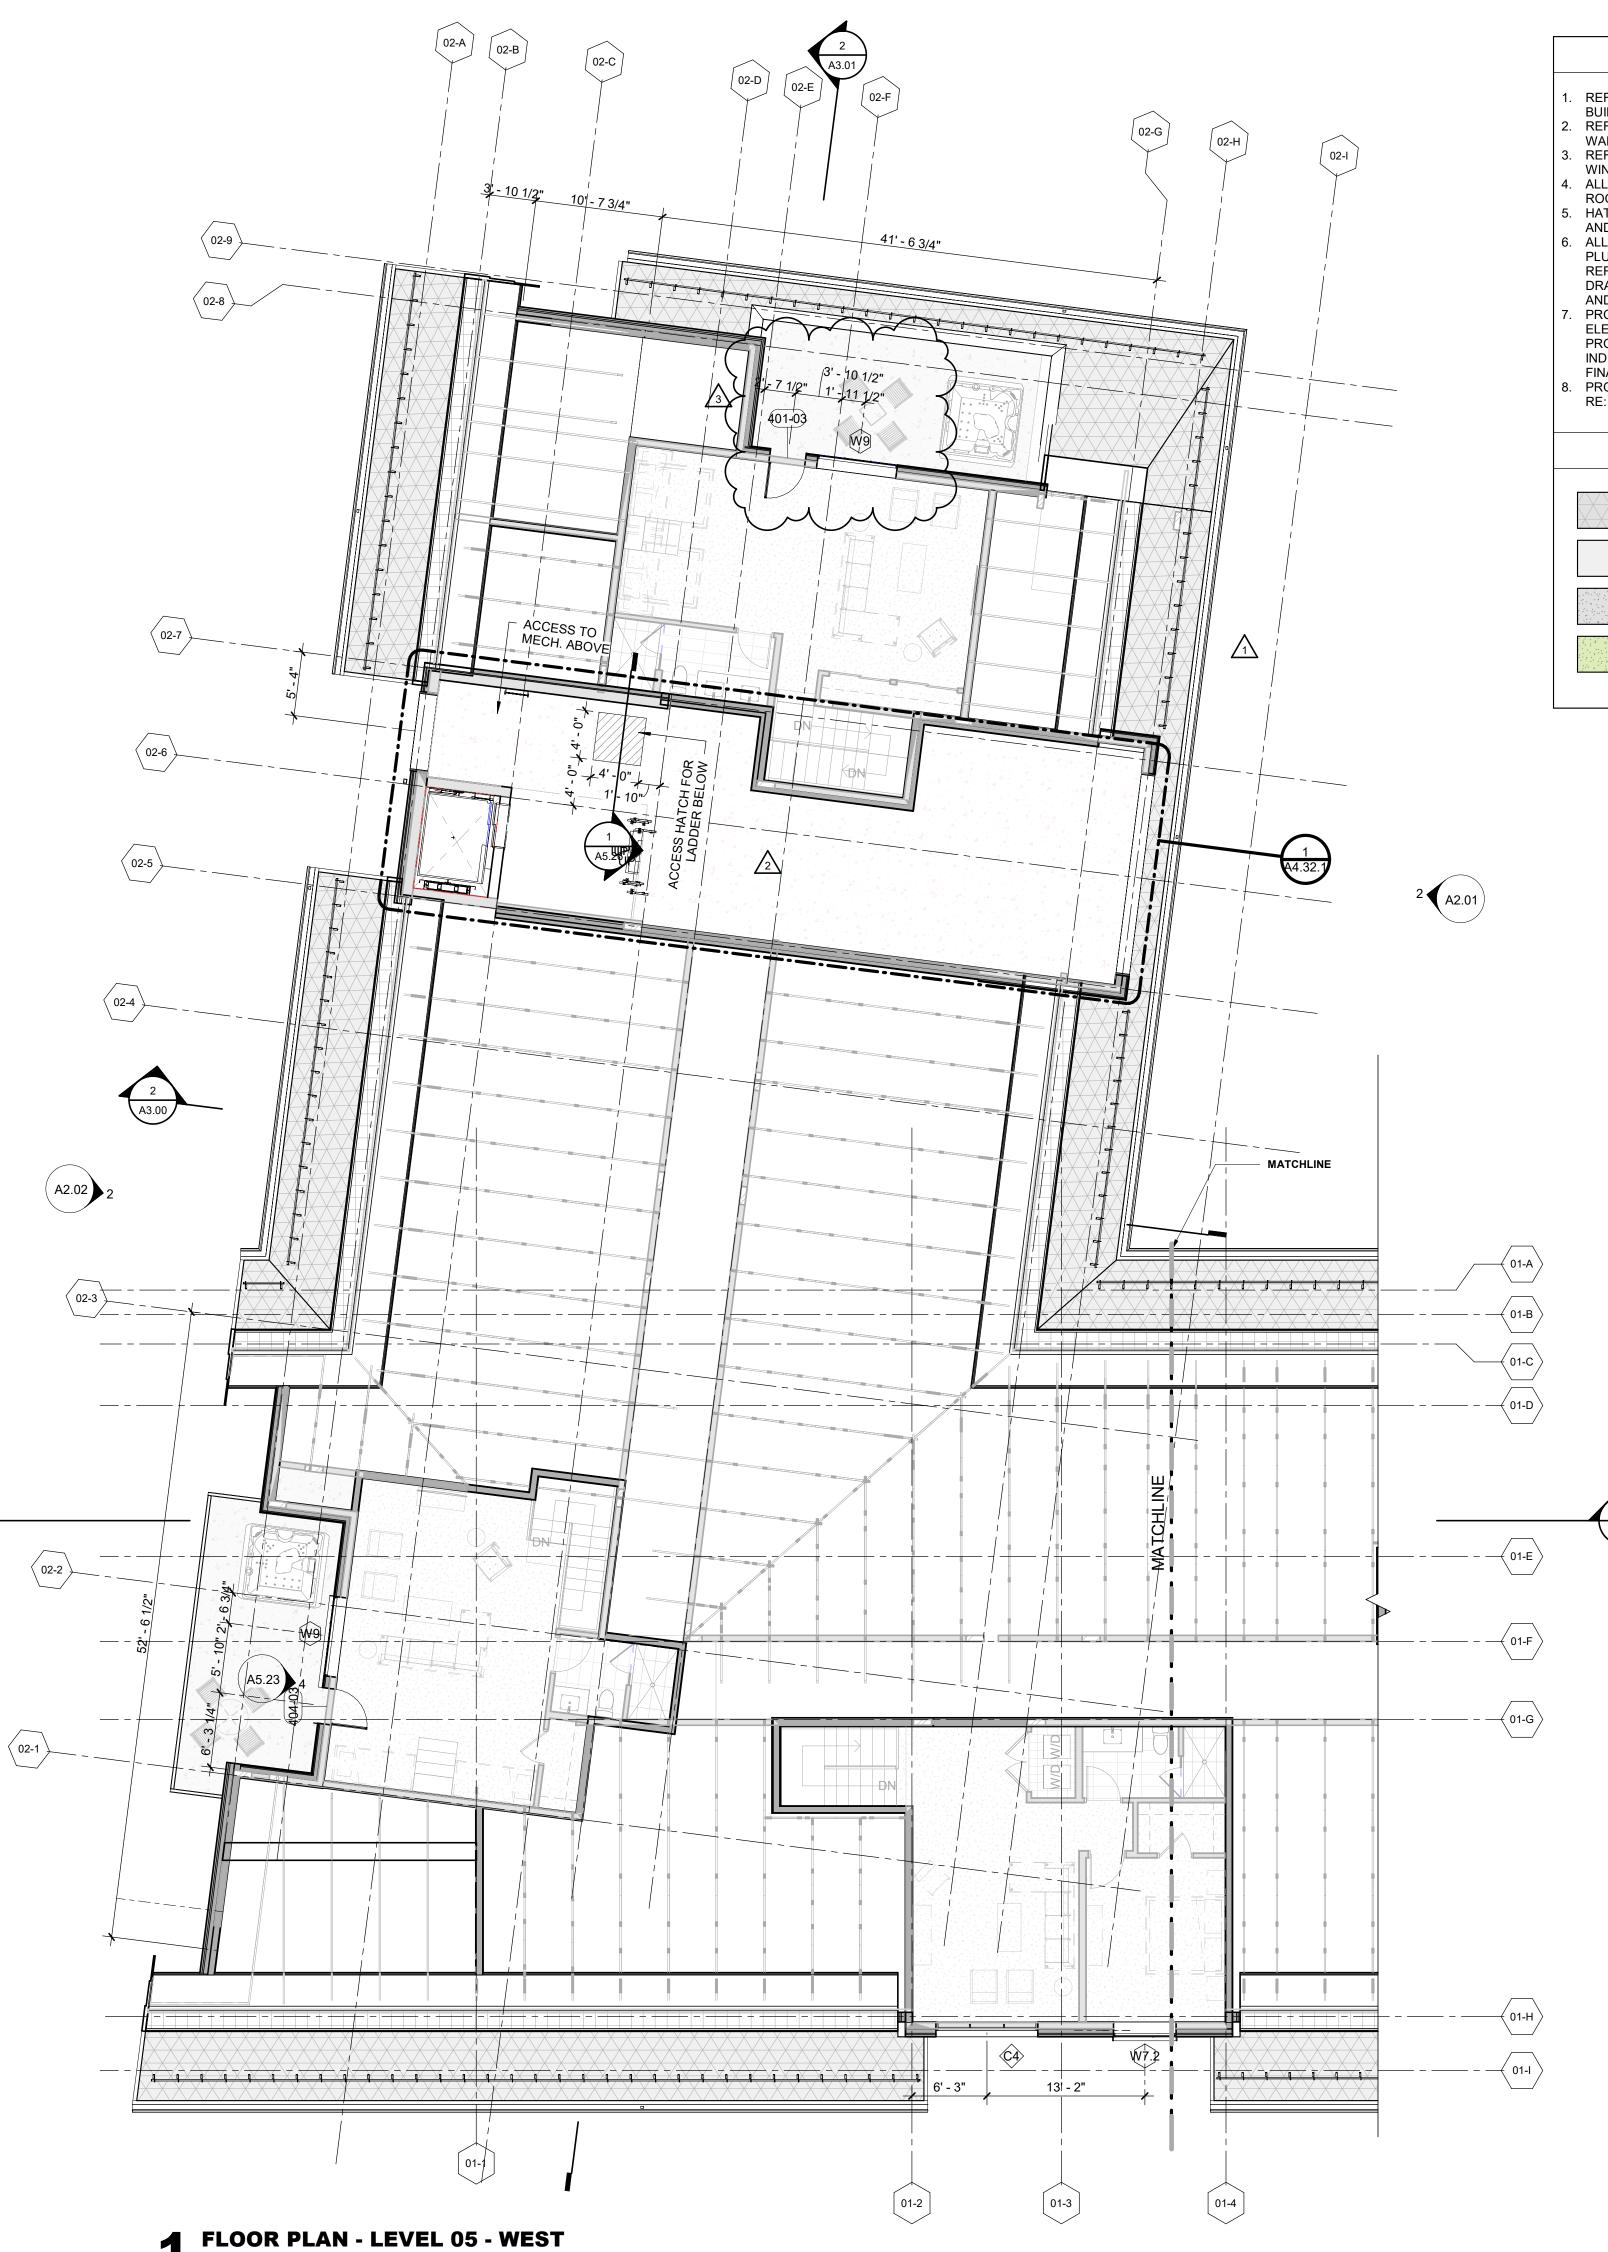
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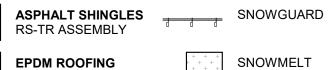


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SNOWMELT

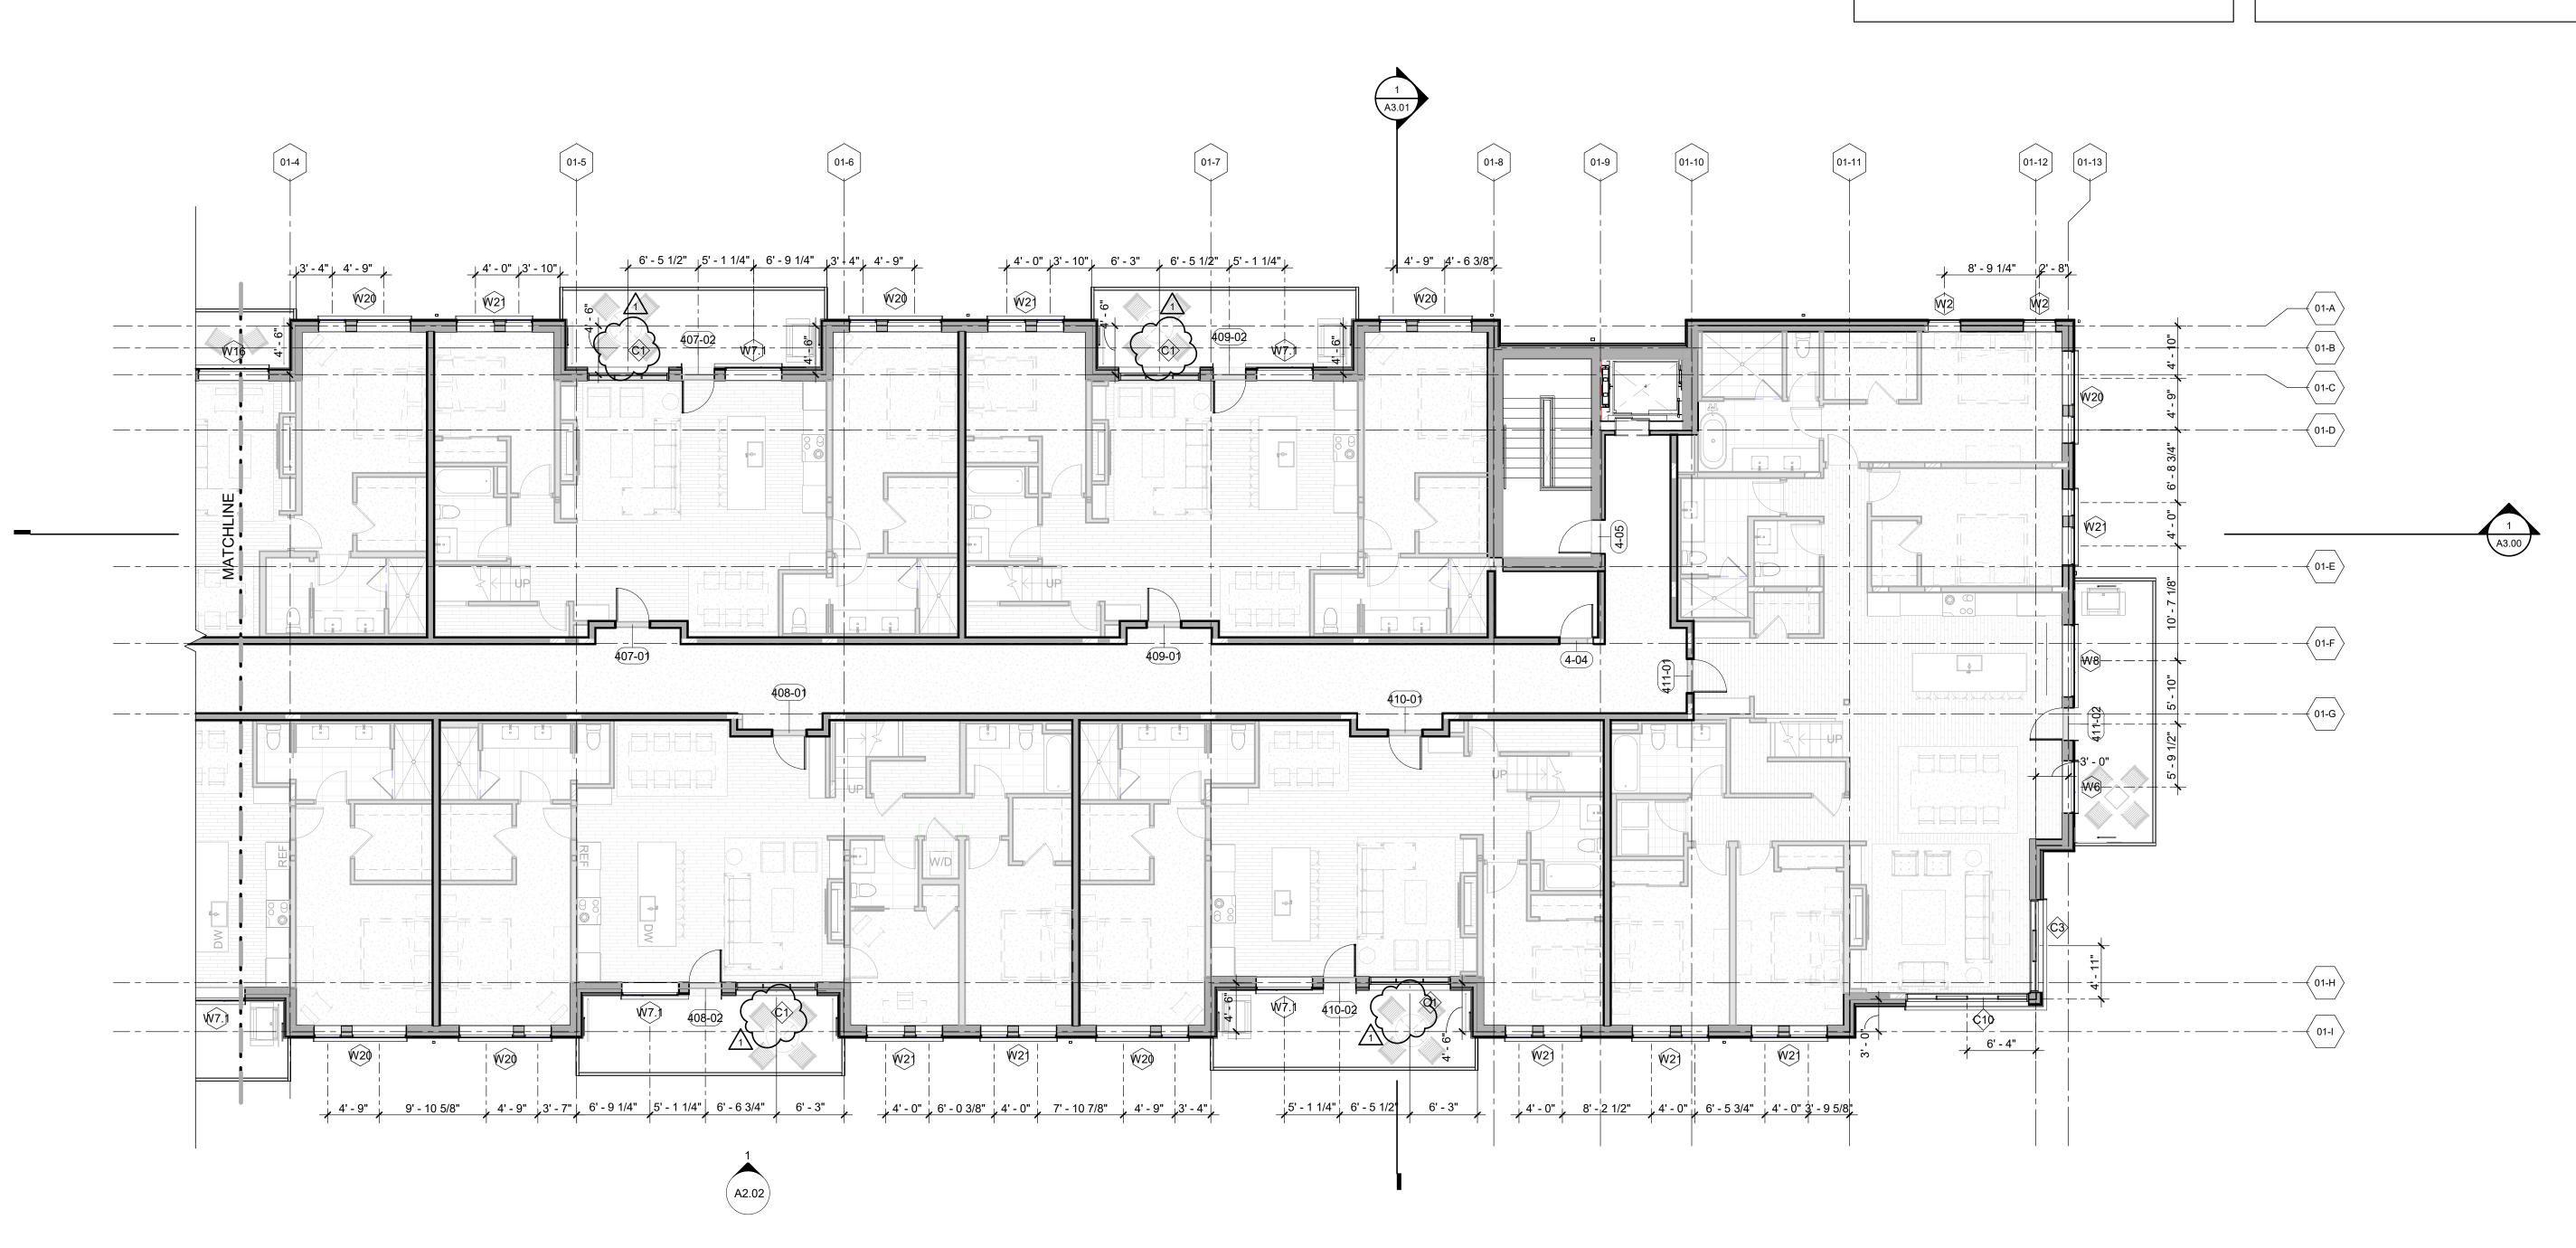RIDGEVENT

#### ROOF BALLAST RS-CR ASSEMBLY

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TOWN STAMP

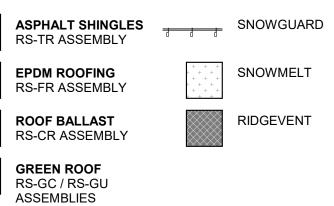**359** Design


3630 OSAGE STREET DENVER, CO 80211 720.512.3437

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12/15/2023

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**FLOOR PLAN - LEVEL 05 - EAST** 1/8" = 1'-0"


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PROVIDE WALKWAY PROTECTION TO MAJOR MECHANICAL, ELECTRICAL, AND PLUMBING EQUIPMENT AS REQUIRED TO PROVIDE SERVICE ACCESS. WALKWAY PROTECTION IS INDICATED AS A GENERAL LAYOUT AND MAY NOT SHOW FINAL LOCATIONS OF ALL EQUIPMENT. PROVIDE SNOW MELT AT ALL GUTTERS & DOWNSPOUTS. RE: ELECTRICAL

## OVERALL ROOF - LEGEND

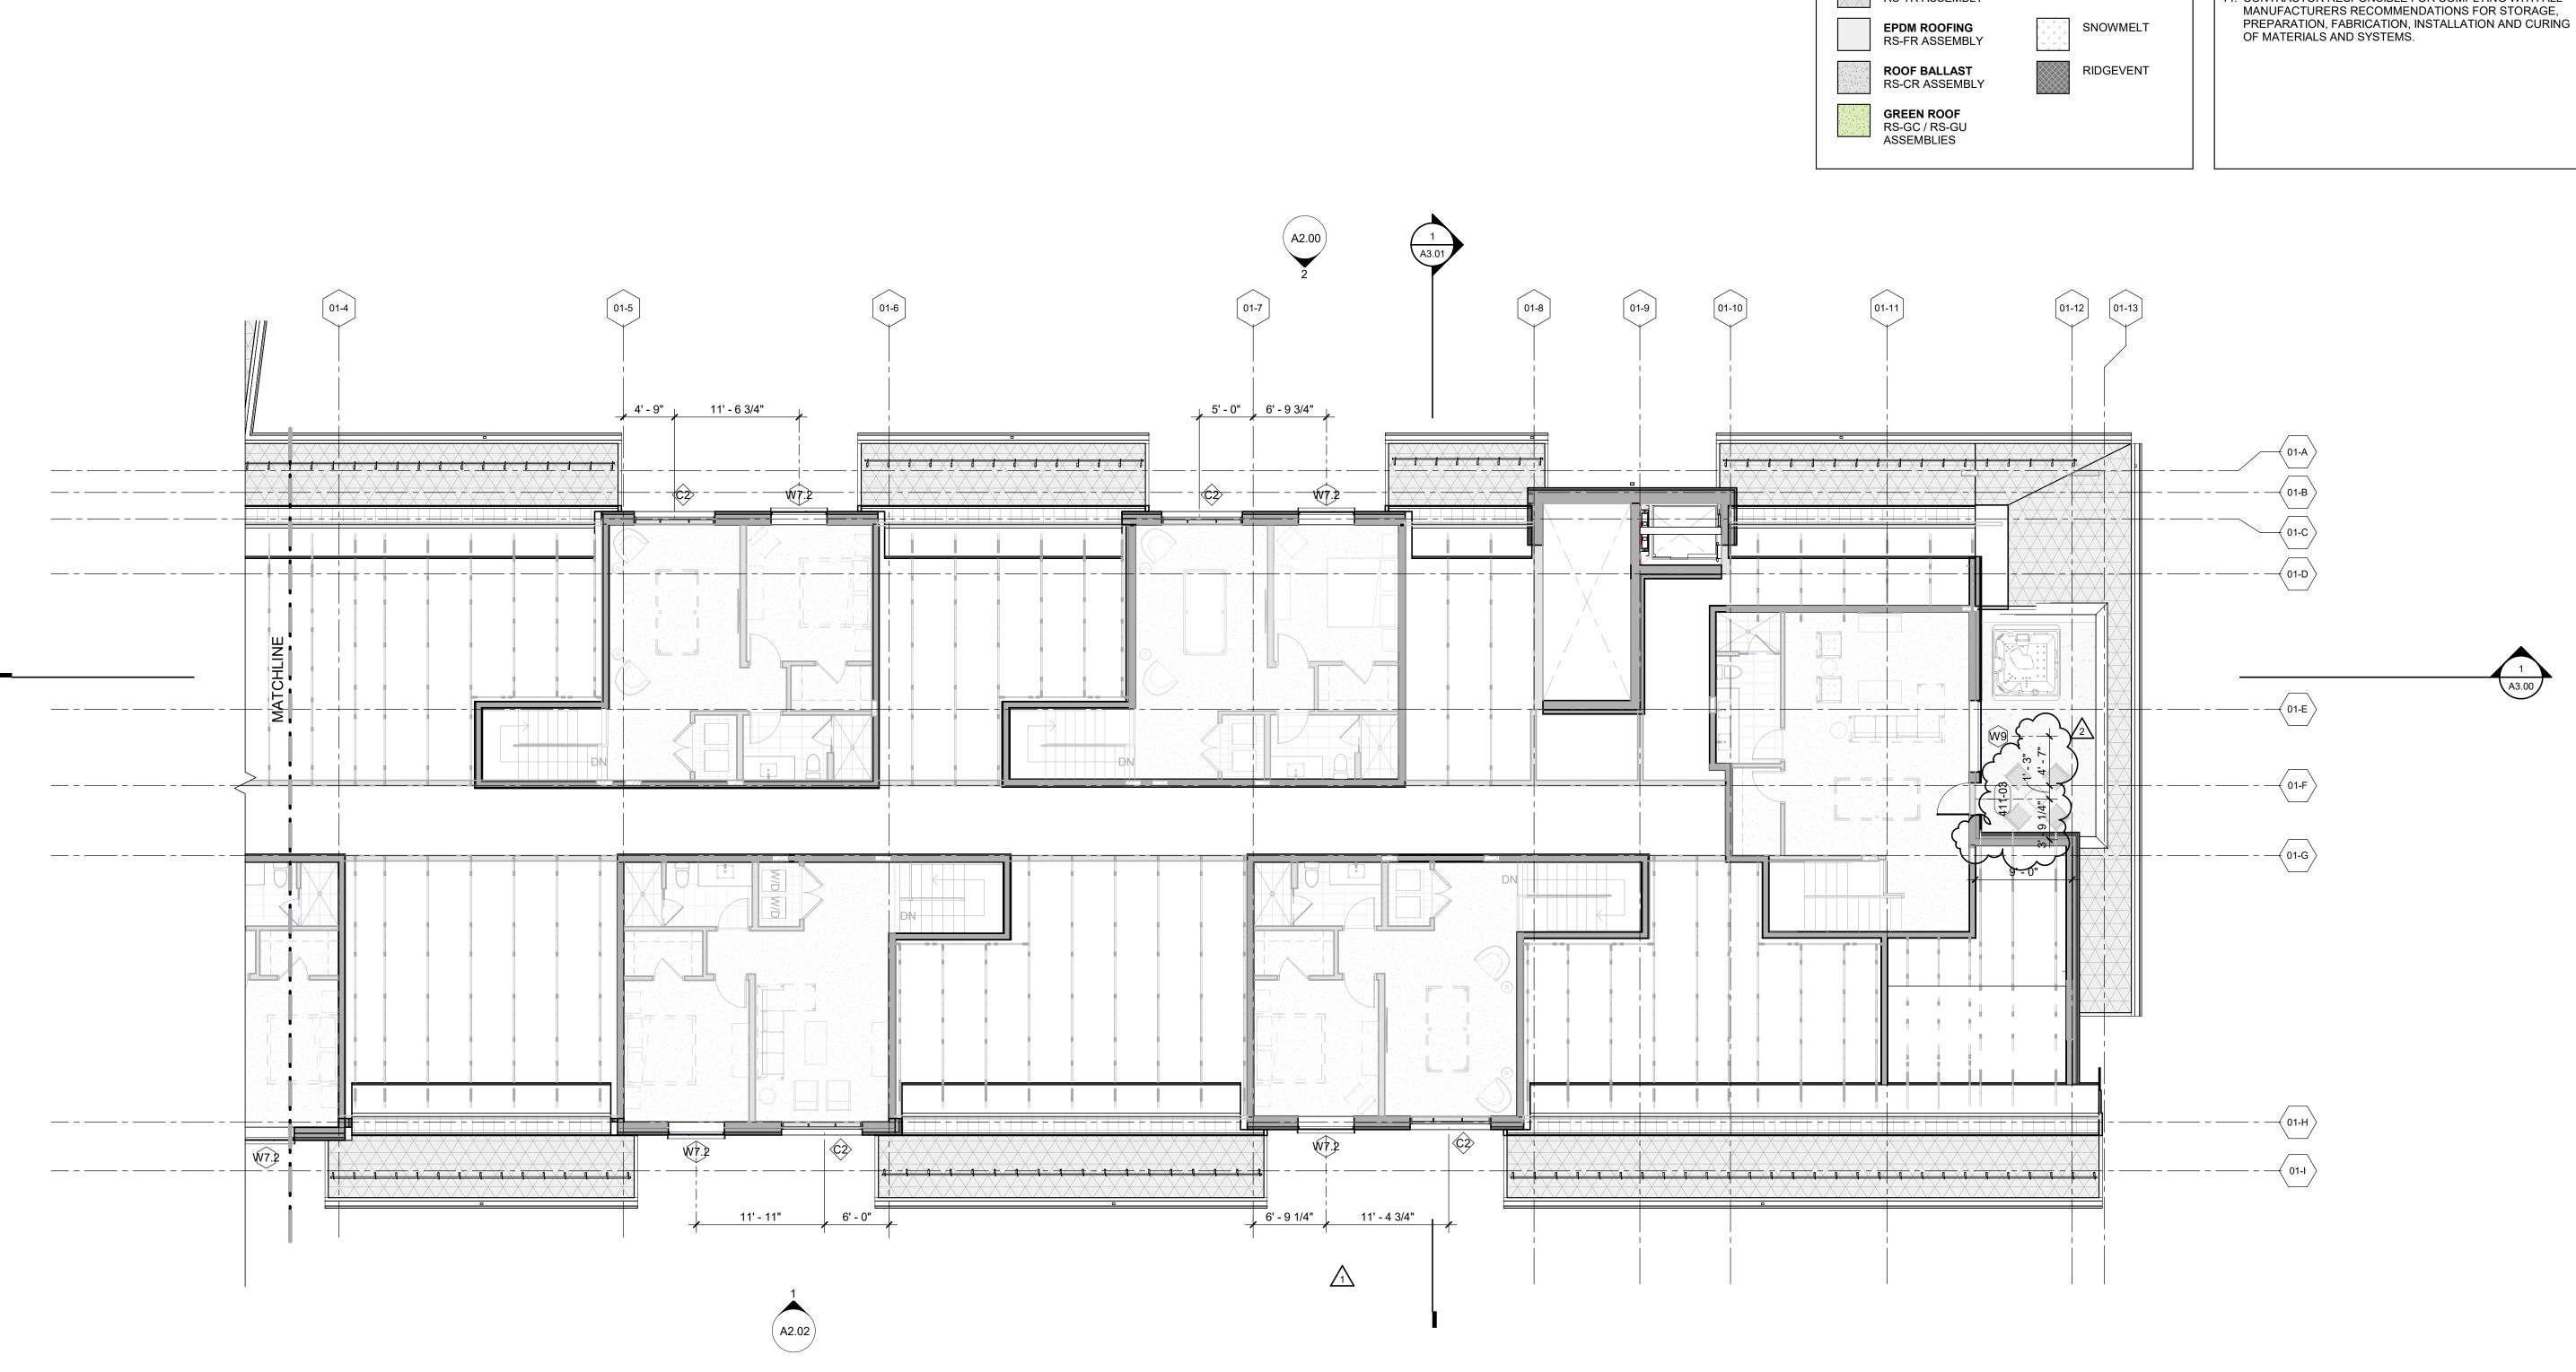

## **OVERALL PLAN - GENERAL NOTES**

- REFER TO G0.2X SHEETS FOR EXTERIOR AND INTERIOR BUILDING ENCLOSURE ASSEMBLIES.
- REFER TO A1.0X SHEETS FOR EXTERIOR WALL, DEMISING WALL, AND CORRIDOR WALL TYPES AND LOCATIONS.
- REFER TO A1.1X SHEETS FOR INTERIOR AND EXTERIOR WINDOW/DOOR TAGS WITH UNIT BACKGROUNDS. REFER TO A6.0X SHEETS FOR INTERIOR AND EXTERIOR
- WINDOW/DOOR SCHEDULES AND LEGENDS. ALIGN WALLS WHERE THEY APPEAR TO ALIGN, U.N.O.
- THE INSIDE FACE OF DOOR JAMBS SHALL BE 4" FROM
- ADJACENT WALL OR FINISHED COLUMN, U.N.O. SWING CLEARANCE AT UNIT ENTRY SHALL BE 18" MIN. FROM FINISH FACE OF ADJACENT SURFACE.
- ALL DIMENSIONS ARE TO FACE OF STUD, GRID LINE, OR FACE OF CONCRETE, U.N.O.
- ELECTRICAL METER AND SERVICE TO BE MOUNTED AT GARAGE LEVEL, COORDINATE METER AND PANEL
- LOCATION WITH OWNER. 0. ELECTRICAL CONTRACTOR SHALL PROVIDE DESIGN BUILD SECURITY SYSTEM, CORD. WITH OWNER.
- 1. WATER PIPES RUNNING NEXT TO OR WITHIN EXTERIOR WALLS TO BE INSULATED W/ 2" MIN CLOSED CELL INSULATION.
- 2. CONTRACTOR SHALL COORDINATE ALL MEANS, METHODS, SEQUENCES PROCEDURES AND SCHEDULES OF ALL CONSTRUCTION ACTIVITIES AND OPERATIONS FOR THE CONSTRUCTION OF THE PROJECT. 13. CONTRACTOR RESPONSIBLE FOR OBTAINING AND
- COMPLYING WITH ALL PERMITS. 4. CONTRACTOR RESPONSIBLE FOR COMPLYING WITH ALL

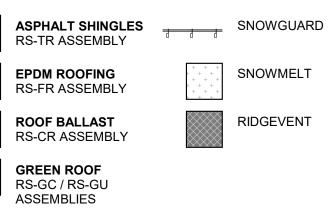TOWN STAMP **359** Design 3630 OSAGE STREET DENVER, CO 80211 720.512.3437 B-2465 12/15/2023 LO ARC mble No. Description Date PROJECT NUMBE ISSUE DATE THE AMBLE

IFC SET

SHEET TITLE FLOOR PLAN - LEVEL 05 - EAST

A1.15.2





REFER TO G0.2X SHEETS FOR EXTERIOR AND INTERIOR

BUILDING ENCLOSURE ASSEMBLIES. REFER TO A1.0X SHEETS FOR EXTERIOR WALL, DEMISING WALL, AND CORRIDOR WALL TYPES AND LOCATIONS. REFER TO A1.1X SHEETS FOR INTERIOR AND EXTERIOR WINDOW/DOOR TAGS WITH UNIT BACKGROUNDS. ALL ROOFS LABELED AS [NO SLOPE] SHALL BE EPDM ROOFING, SLOPED AT 1/4" = 1' - 0" U.N.O. HATCHING INDICATES LOCATIONS OF SNOW MELT EAVE AND VALLEY PANELS, RE: ELECTRICAL DRAWINGS. ALL ROOFTOP MECHANICAL, ELECTRICAL, AND/OR PLUMBING EQUIPMENT SHOWN FOR REFERENCE ONLY. REFER TO MECHANICAL, ELECTRICAL, AND/OR PLUMBING DRAWINGS AND SPECIFICATIONS FOR SPECIFIC DESIGN

AND PRODUCT INFORMATION. PROVIDE WALKWAY PROTECTION TO MAJOR MECHANICAL, ELECTRICAL, AND PLUMBING EQUIPMENT AS REQUIRED TO PROVIDE SERVICE ACCESS. WALKWAY PROTECTION IS INDICATED AS A GENERAL LAYOUT AND MAY NOT SHOW FINAL LOCATIONS OF ALL EQUIPMENT. PROVIDE SNOW MELT AT ALL GUTTERS & DOWNSPOUTS. RE: ELECTRICAL

SNOWMELT

RIDGEVENT

#### OVERALL ROOF - LEGEND

- ASPHALT SHINGLES SNOWGUARD RS-TR ASSEMBLY
- EPDM ROOFING

RS-FR ASSEMBLY ROOF BALLAST

RS-CR ASSEMBLY


**GREEN ROOF** RS-GC / RS-GU ASSEMBLIES

- **OVERALL PLAN GENERAL NOTES**
- REFER TO G0.2X SHEETS FOR EXTERIOR AND INTERIOR BUILDING ENCLOSURE ASSEMBLIES.
- REFER TO A1.0X SHEETS FOR EXTERIOR WALL, DEMISING WALL, AND CORRIDOR WALL TYPES AND LOCATIONS.
- REFER TO A1.1X SHEETS FOR INTERIOR AND EXTERIOR WINDOW/DOOR TAGS WITH UNIT BACKGROUNDS. REFER TO A6.0X SHEETS FOR INTERIOR AND EXTERIOR
- WINDOW/DOOR SCHEDULES AND LEGENDS. ALIGN WALLS WHERE THEY APPEAR TO ALIGN, U.N.O.
- THE INSIDE FACE OF DOOR JAMBS SHALL BE 4" FROM ADJACENT WALL OR FINISHED COLUMN, U.N.O.
- SWING CLEARANCE AT UNIT ENTRY SHALL BE 18" MIN. FROM FINISH FACE OF ADJACENT SURFACE.
- ALL DIMENSIONS ARE TO FACE OF STUD, GRID LINE, OR FACE OF CONCRETE, U.N.O. ELECTRICAL METER AND SERVICE TO BE MOUNTED AT
- GARAGE LEVEL, COORDINATE METER AND PANEL LOCATION WITH OWNER. 0. ELECTRICAL CONTRACTOR SHALL PROVIDE DESIGN BUILD
- SECURITY SYSTEM, CORD. WITH OWNER. . WATER PIPES RUNNING NEXT TO OR WITHIN EXTERIOR WALLS TO BE INSULATED W/ 2" MIN CLOSED CELL
- INSULATION. 2. CONTRACTOR SHALL COORDINATE ALL MEANS, METHODS, SEQUENCES PROCEDURES AND SCHEDULES OF ALL CONSTRUCTION ACTIVITIES AND OPERATIONS FOR THE CONSTRUCTION OF THE PROJECT.
- 13. CONTRACTOR RESPONSIBLE FOR OBTAINING AND COMPLYING WITH ALL PERMITS. 4. CONTRACTOR RESPONSIBLE FOR COMPLYING WITH ALL
- MANUFACTURERS RECOMMENDATIONS FOR STORAGE, PREPARATION, FABRICATION, INSTALLATION AND CURING OF MATERIALS AND SYSTEMS.


359 Design 3630 OSAGE STREET DENVER, CO 80211 720.512.3437 B-2465 12/15/2023 CD ARG Ω

TOWN STAMP

No.	Description	Date
	IFC SET RFI #76	03.15.24 05.31.24
	1	1
	UMBER	20019
JE DATE		03/15/2024
JE		
	IFC SET	
	⊧ OF PLAN - W	EST

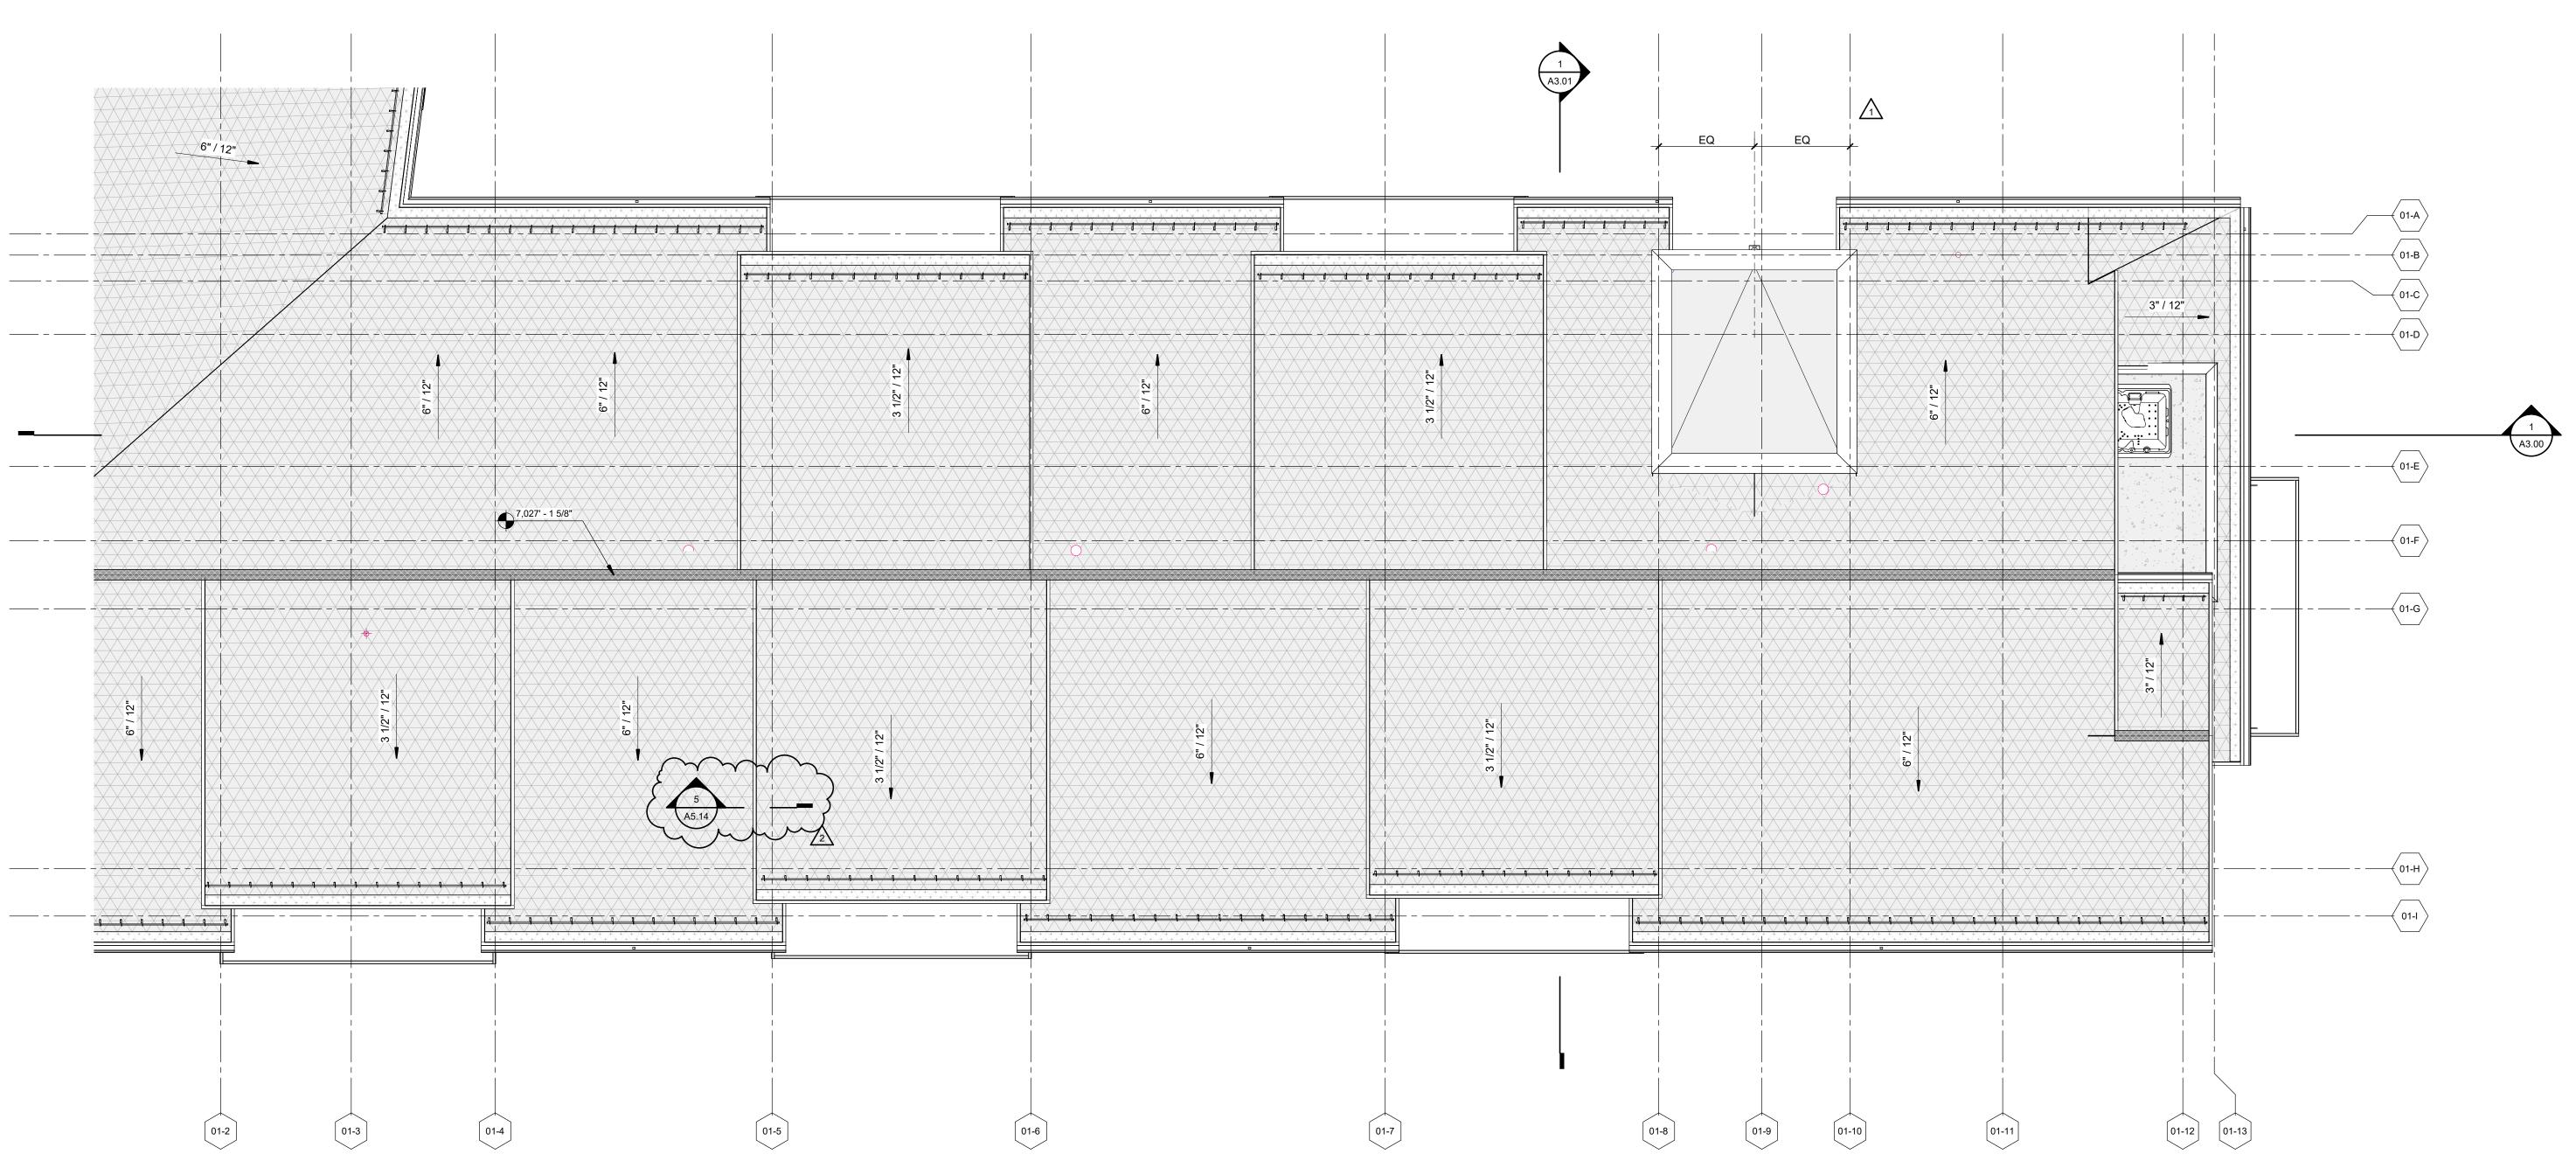

**ROOF PLAN EAST** 1/8" = 1'-0"

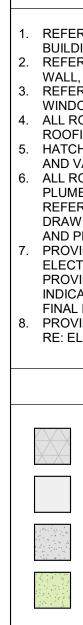


### **OVERALL ROOF - GENERAL NOTES**

REFER TO G0.2X SHEETS FOR EXTERIOR AND INTERIOR

BUILDING ENCLOSURE ASSEMBLIES.
REFER TO A1.0X SHEETS FOR EXTERIOR WALL, DEMISING WALL, AND CORRIDOR WALL TYPES AND LOCATIONS.
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### OVERALL ROOF - LEGEND



# OVERALL PLAN - GENERAL NOTES

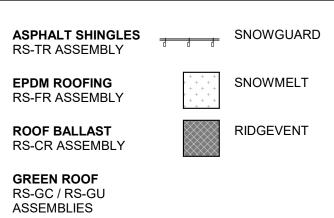- 1. REFER TO G0.2X SHEETS FOR EXTERIOR AND INTERIOR BUILDING ENCLOSURE ASSEMBLIES.
- 2. REFER TO A1.0X SHEETS FOR EXTERIOR WALL, DEMISING WALL, AND CORRIDOR WALL TYPES AND LOCATIONS.
- REFER TO A1.1X SHEETS FOR INTERIOR AND EXTERIOR WINDOW/DOOR TAGS WITH UNIT BACKGROUNDS.
   REFER TO A6.0X SHEETS FOR INTERIOR AND EXTERIOR
- WINDOW/DOOR SCHEDULES AND LEGENDS. 5. ALIGN WALLS WHERE THEY APPEAR TO ALIGN, U.N.O.
- . THE INSIDE FACE OF DOOR JAMBS SHALL BE 4" FROM ADJACENT WALL OR FINISHED COLUMN, U.N.O.
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- ELECTRICAL METER AND SERVICE TO BE MOUNTED AT GARAGE LEVEL, COORDINATE METER AND PANEL
- LOCATION WITH OWNER. 0. ELECTRICAL CONTRACTOR SHALL PROVIDE DESIGN BUILD SECURITY SYSTEM, CORD. WITH OWNER.
- 11. WATER PIPES RUNNING NEXT TO OR WITHIN EXTERIOR WALLS TO BE INSULATED W/ 2" MIN CLOSED CELL INSULATION.
- CONTRACTOR SHALL COORDINATE ALL MEANS, METHODS, SEQUENCES PROCEDURES AND SCHEDULES OF ALL CONSTRUCTION ACTIVITIES AND OPERATIONS FOR THE CONSTRUCTION OF THE PROJECT.
   CONTRACTOR RESPONSIBLE FOR OBTAINING AND
- COMPLYING WITH ALL PERMITS. 14. CONTRACTOR RESPONSIBLE FOR COMPLYING WITH ALL MANUFACTURERS RECOMMENDATIONS FOR STORAGE,
- PREPARATION, FABRICATION, INSTALLATION AND CURING OF MATERIALS AND SYSTEMS.

TOWN STAMP 359 Design 3630 OSAGE STREET DENVER, CO 80211 720.512.3437 B-2465 12/15/2023 ED ARC ble Am No. Description Date

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PROJECT NUMBE


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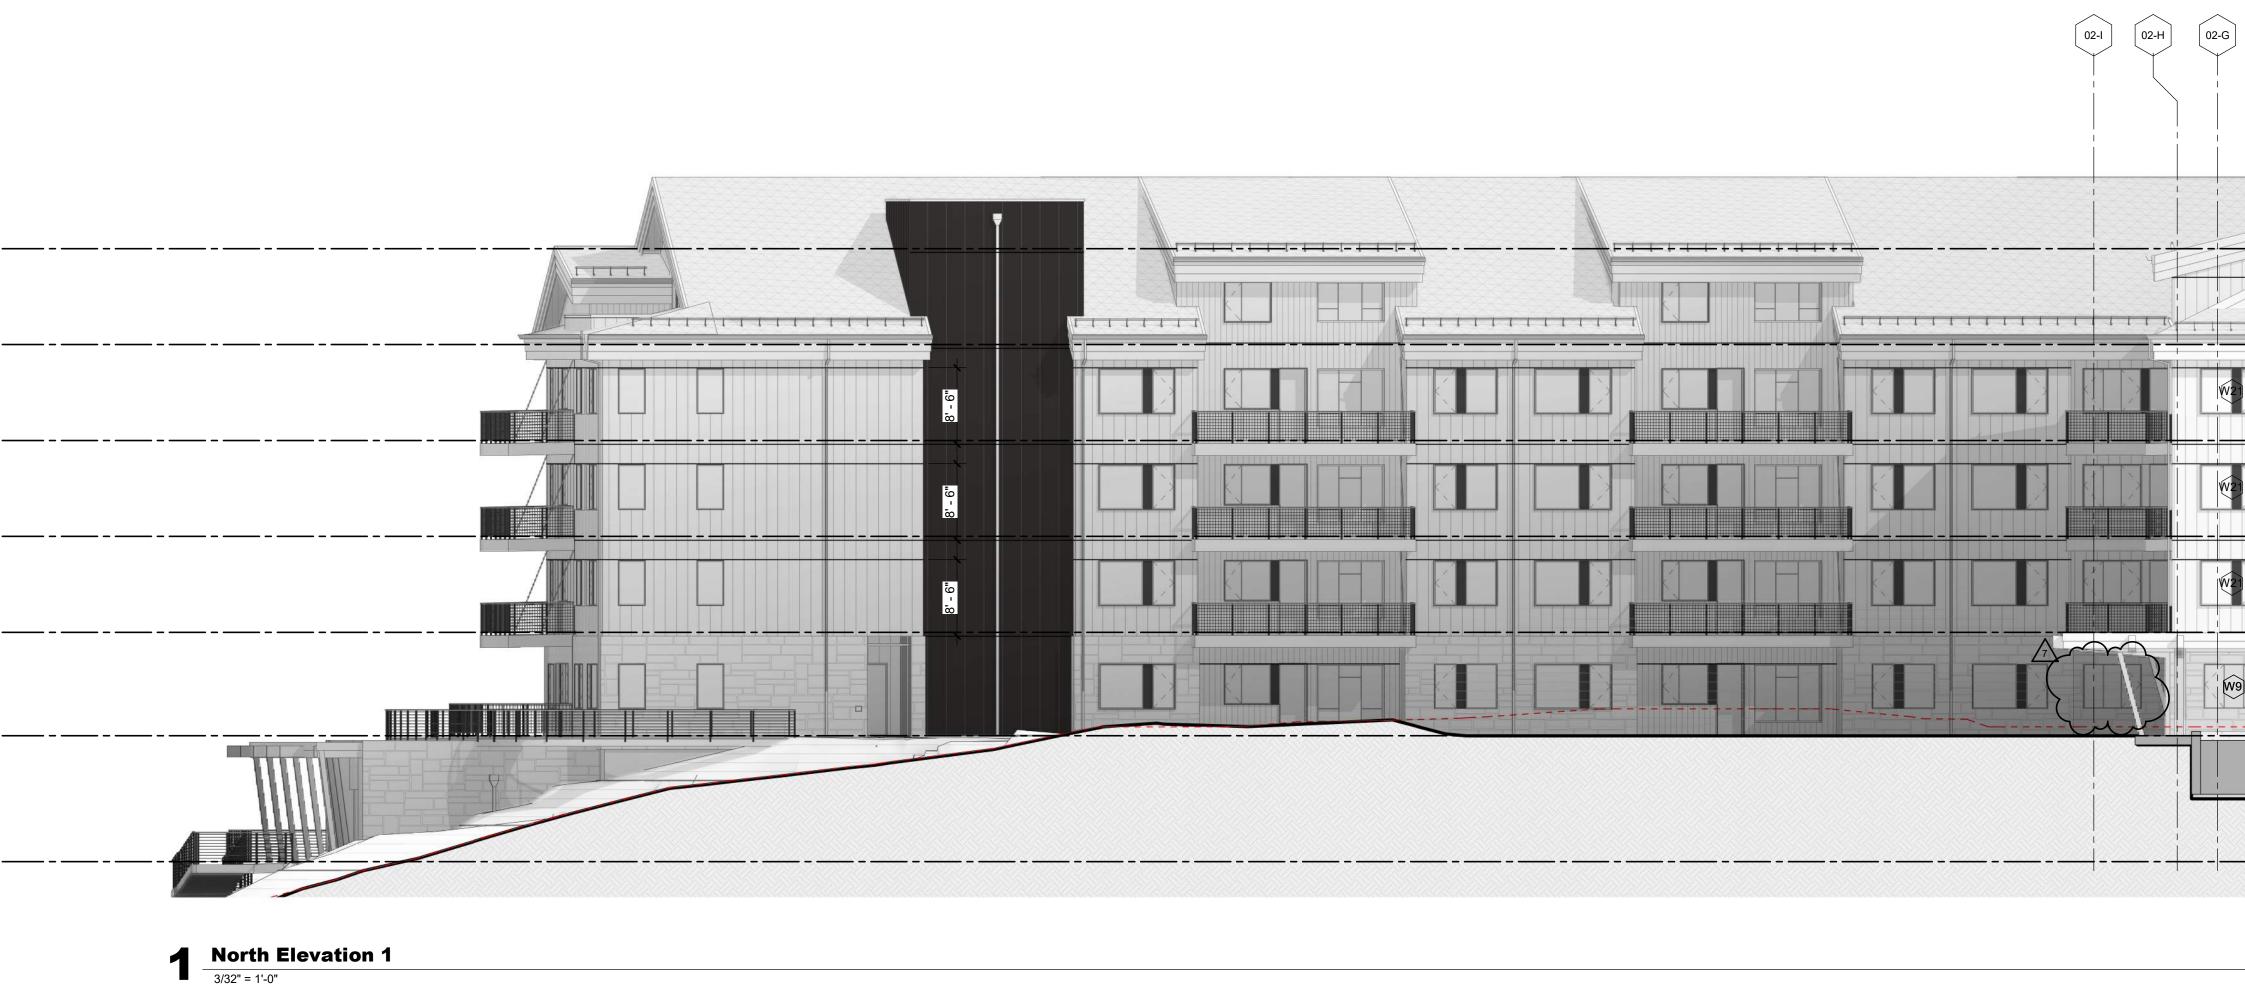
SHEET TITLE

ROOF PLAN - EAST


A1.16.2

	Keynote Legend
07.01	EXTERIOR SLATE CLADDING, SEE MATERIAL LEGEND
07.02	EXTERIOR WOOD SIDING, SEE MATERIAL LEGEND
07.03	EXTERIOR ALUMINUM SIDING, SEE MATERIAL LEGEND
07.05	METAL PANEL SIDING, SEE MATERIAL LEGEND
07.06	ASPHALT SHINGLE ROOFING, SEE MATERIAL LEGEND
07.08	FIBER CEMENT STEPPED FACIA,       EP-01
07.09	SCUPPER AND DOWNSPOUT W/ HEAT TRACE, RE: ELEC.
07.11	SNOW GUARD
∆ <sup>07.13</sup>	FIBER CEMENT BEAM & COLUMN WRAPS, EP-02
D27	
D28	
D29	



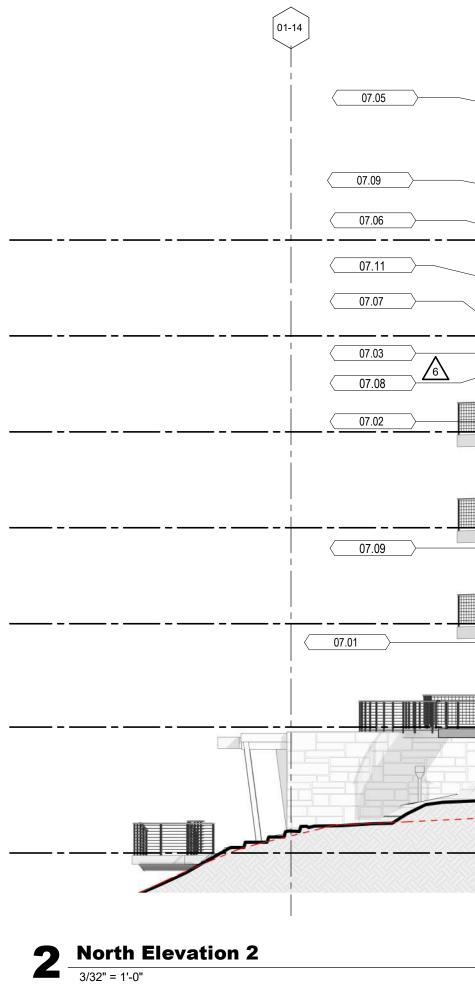


01-13 01-12	01-11	01-9 01-8 1 A3.01	01-7	0	1-6
				07.03	
					W7.2
	10'-8"				
	2' -2" 8' - 6"	¥V20		W21 W20	V(7,) D-14
	2 - 2" 8 - 6"	ýv20	W7.1 D-14 C1	<u>(v21</u> <u>(v2</u> )	W7.1 D-14
		W20	W7.1 D-14) C1	(vi21) (vi20)	W(7.) D-12
	<u>D-16</u>		W(7.) D-14C1	W21 W20	W7.1 D-14
	EXISTING TOPOGRAPHY				     

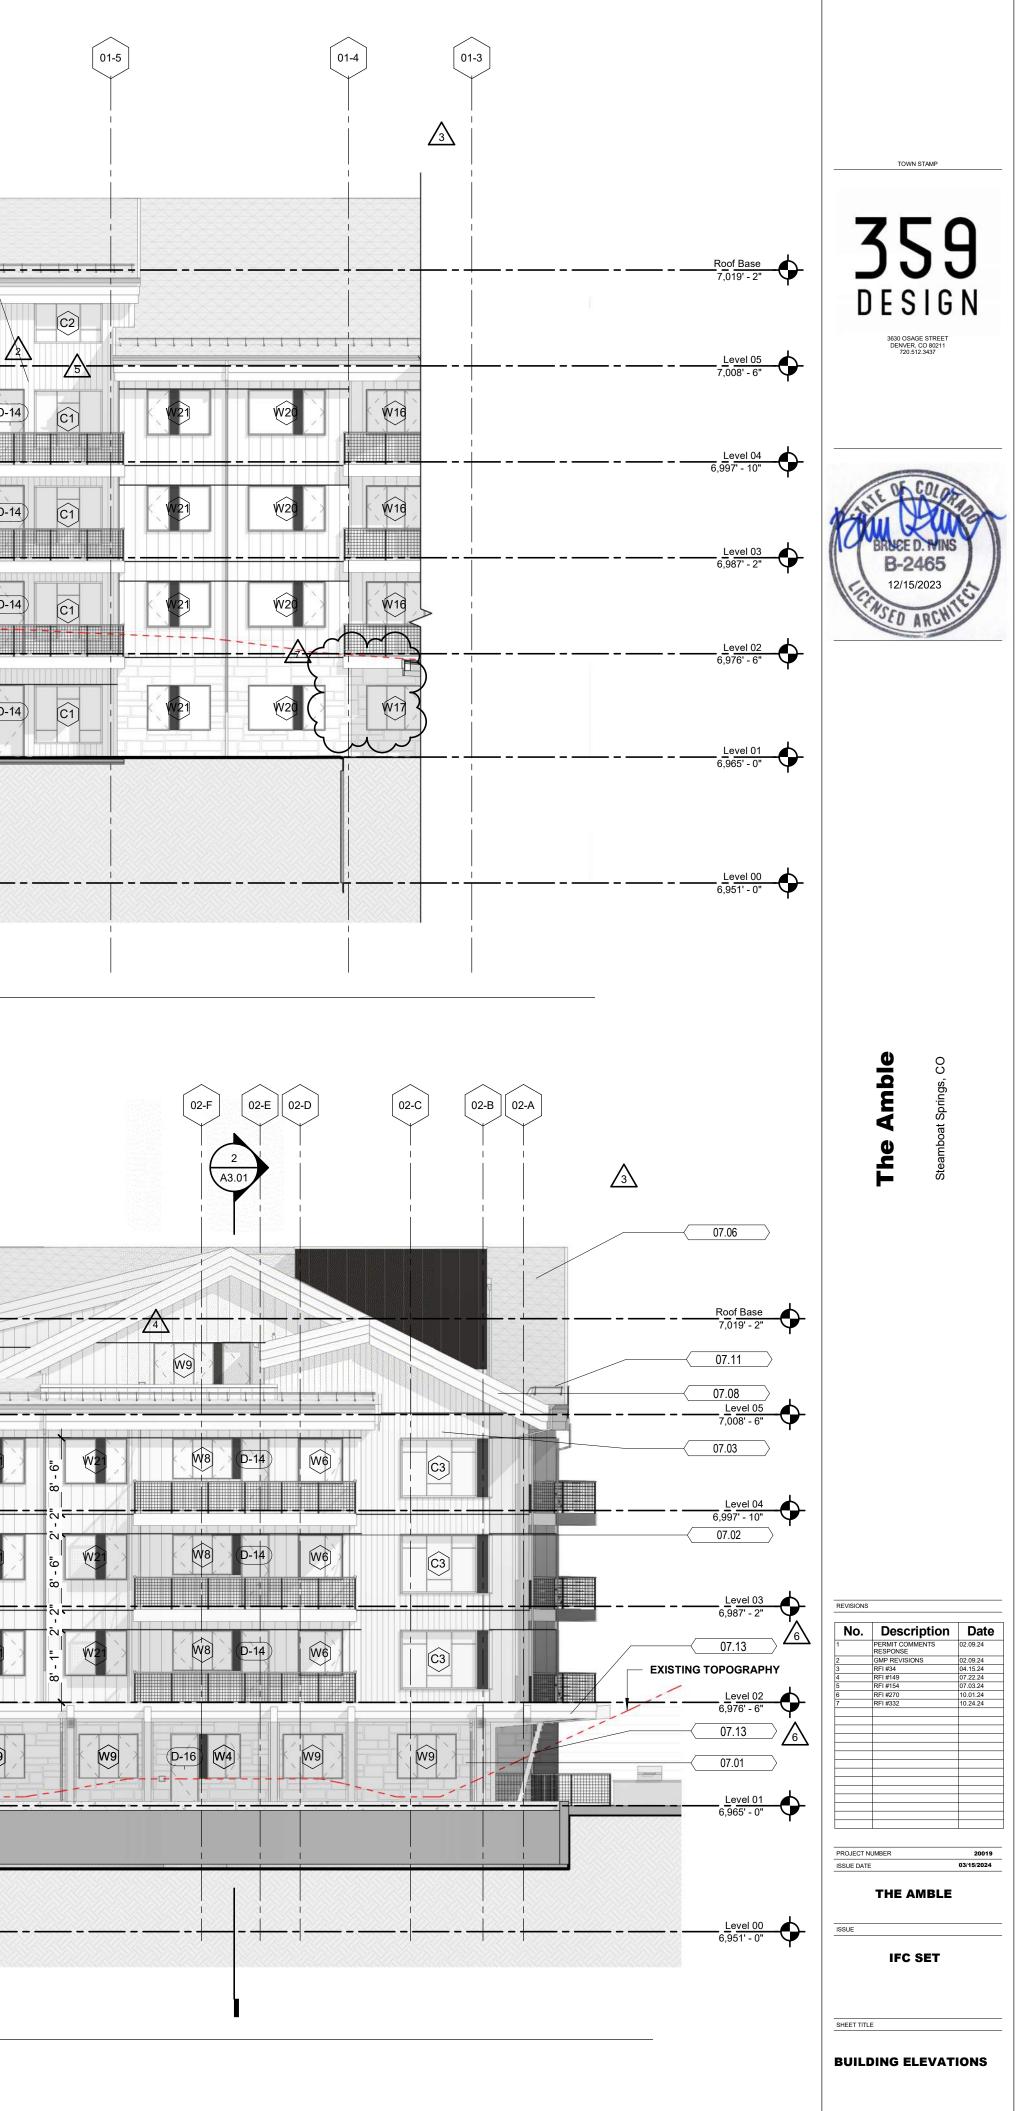




SHEET NO.

	Keynote Legend
07.01	EXTERIOR SLATE CLADDING, SEE MATERIAL LEGEND
07.02	EXTERIOR WOOD SIDING, SEE MATERIAL LEGEND
07.03	EXTERIOR ALUMINUM SIDING, SE MATERIAL LEGEND
07.05	METAL PANEL SIDING, SEE MATERIAL LEGEND
07.06	ASPHALT SHINGLE ROOFING, SEE MATERIAL LEGEND
07.08 Z	FIBER CEMENT STEPPED FACIA,
07.09	SCUPPER AND DOWNSPOUT W/ HEAT TRACE, RE: ELEC.
07.11	SNOW GUARD
07.13	FIBER CEMENT BEAM & COLUMN

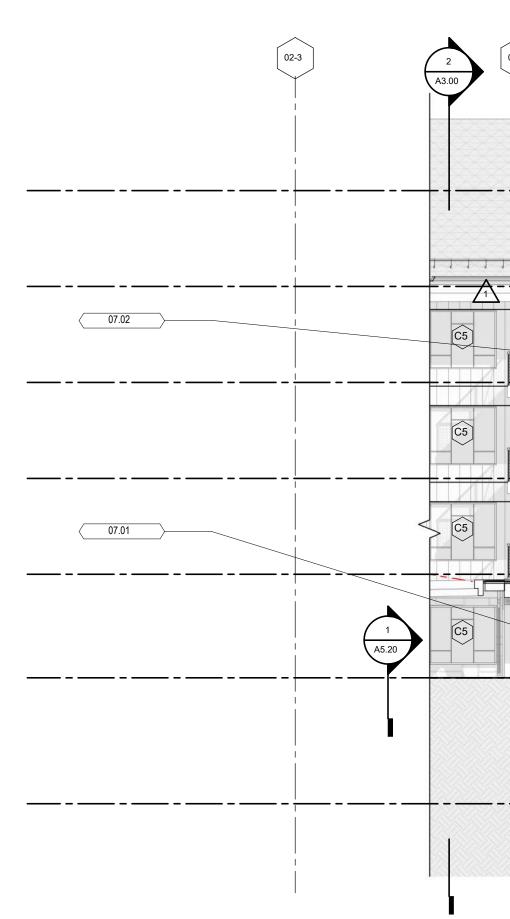



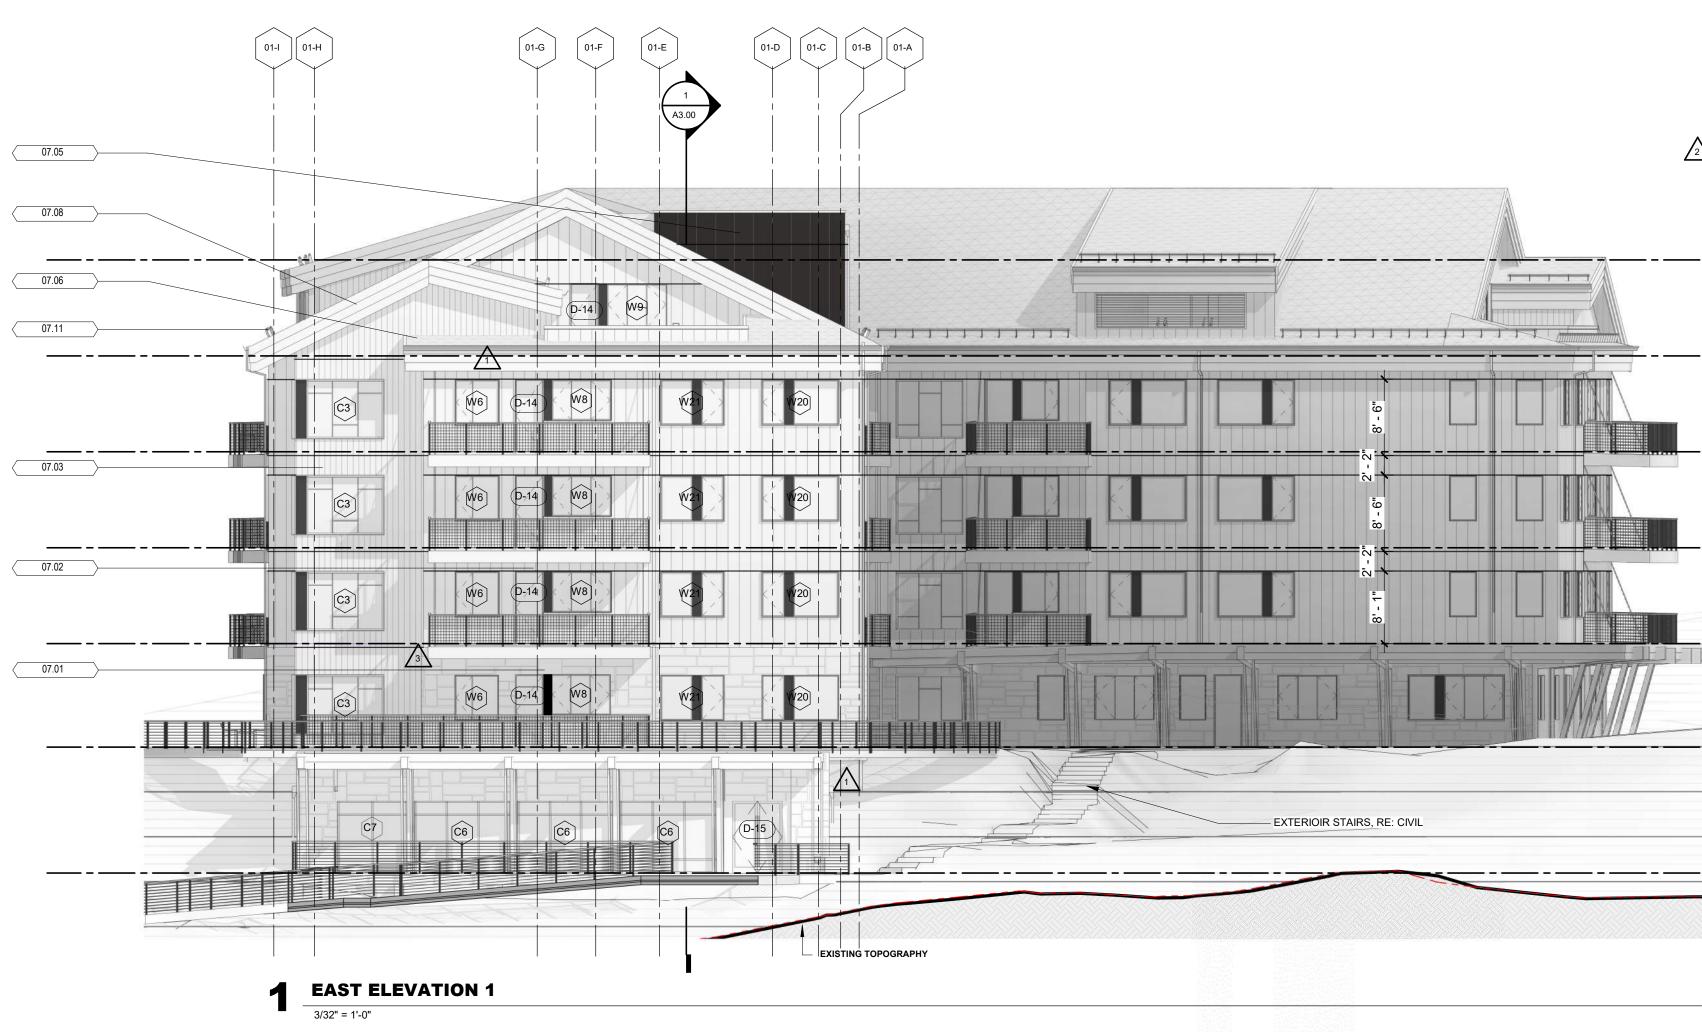




 — – <u>Roof Base</u> 7,019' - 2"		TOWN STAMP 355 DESIGN
 Level 05 7,008' - 6"		DESIGI 3630 OSAGE STREET DENVER, CO 80211 720.512.3437
 Level 04 6,997" - 10"		OF COL
Level 03 6,987' - 2"		BRSCE D. WINS B-2465 12/15/2023
		TERINSED ARCHITE
		Ble Br co
		The Amble Steamboat Springs, CO
 ——————————————————————————————————————		
 Level 04 6,997' - 10"		
 <u>Level 03</u> 6,987' - 2"		No.         Description           1         GMP REVISIONS         0           2         RFI #34         0           3         RFI #154         0           4         RFI #270         1
Level 02 6,976' - 6"		
Level 01 6,965' - 0"		PROJECT NUMBER ISSUE DATE 02
Level 00 6,951' - 0"		IFC SET
		BUILDING ELEVATIONS
		SHEET NO.





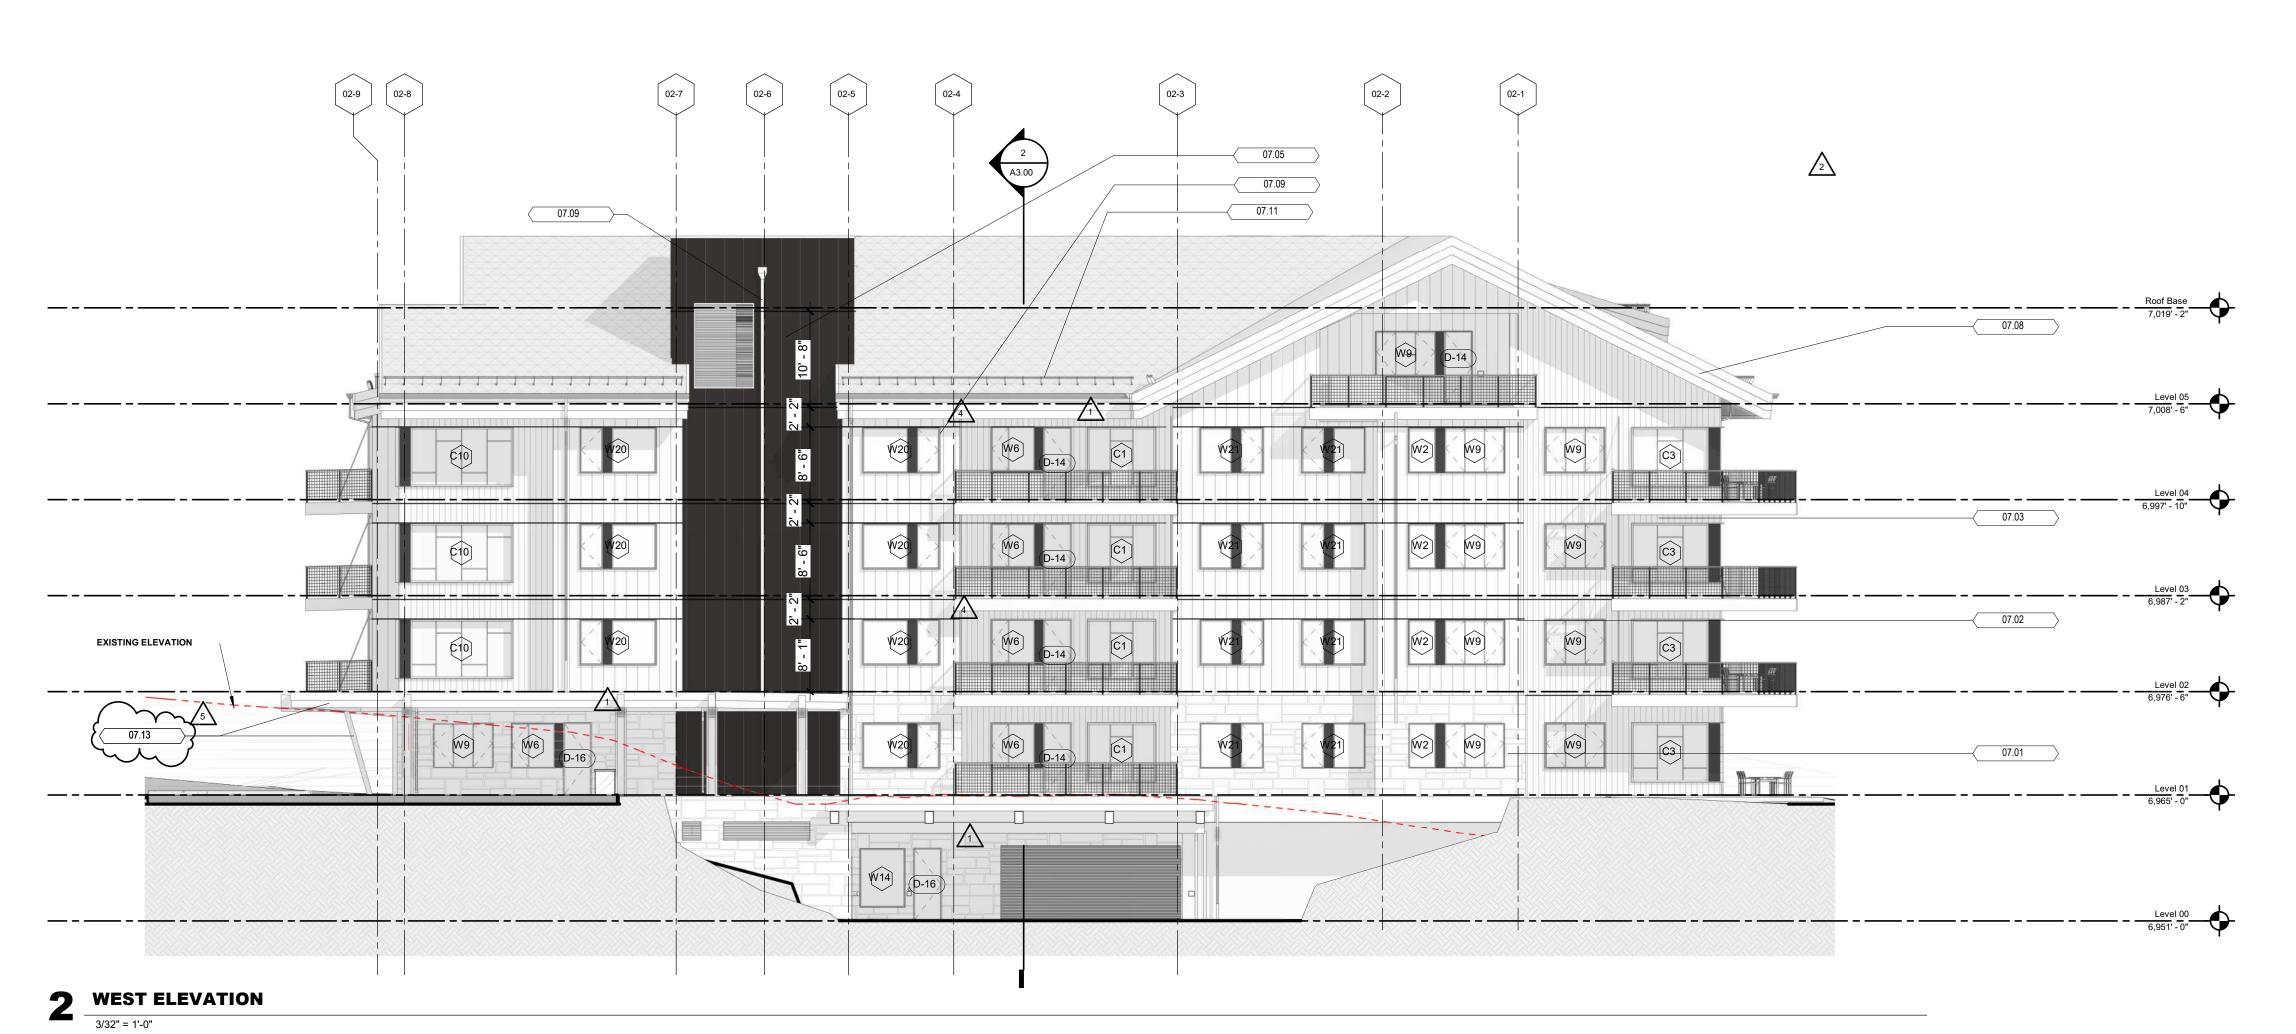

	Keynote Legend
[	
07.01	EXTERIOR SLATE CLADDING, SEE MATERIAL LEGEND
07.02	EXTERIOR WOOD SIDING, SEE MATERIAL LEGEND
07.03	EXTERIOR ALUMINUM SIDING, SEE MATERIAL LEGEND
07.05	METAL PANEL SIDING, SEE MATERIAL LEGEND
07.06	ASPHALT SHINGLE ROOFING, SEE MATERIAL LEGEND
07.08	FIBER CEMENT STEPPED FACIA,
07.09	SCUPPER AND DOWNSPOUT W/ HEAT TRACE, RE: ELEC.
07.11	SNOW GUARD
	FIBER CEMENT BEAM & COLUMN WRAPS, EP-02








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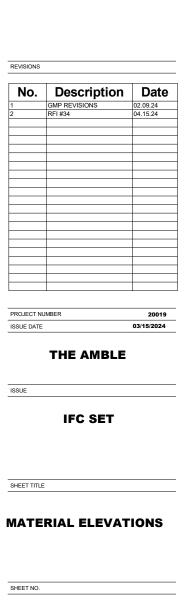


**EAST MATERIAL ELEVATION 1** 3/32" = 1'-0"





The Amble

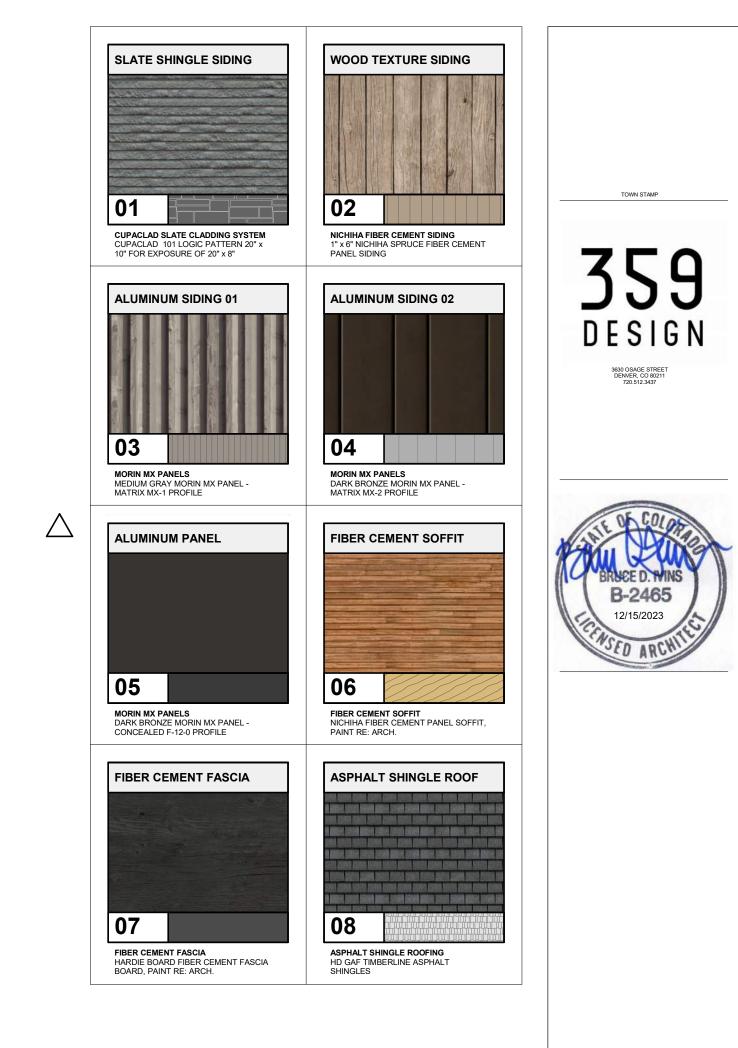

A2.11







A2.'	12
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SHEET NO.


Keynote Legend		
05.01	METAL HOG WIRE RAILING	
07.01	EXTERIOR SLATE CLADDING, SEE MATERIAL LEGEND	
07.02	EXTERIOR WOOD SIDING, SEE MATERIAL LEGEND	
07.03	EXTERIOR ALUMINUM SIDING, SEE MATERIAL LEGEND	
07.05	METAL PANEL SIDING, SEE MATERIAL LEGEND	
07.06	ASPHALT SHINGLE ROOFING, SEE MATERIAL LEGEND	
07.08	FIBER CEMENT STEPPED FACIA	
07.09	SCUPPER AND DOWNSPOUT W/ HEAT TRACE, RE: ELEC.	
07.11	SNOW GUARD	
D27	<varies></varies>	
D28		
D29		




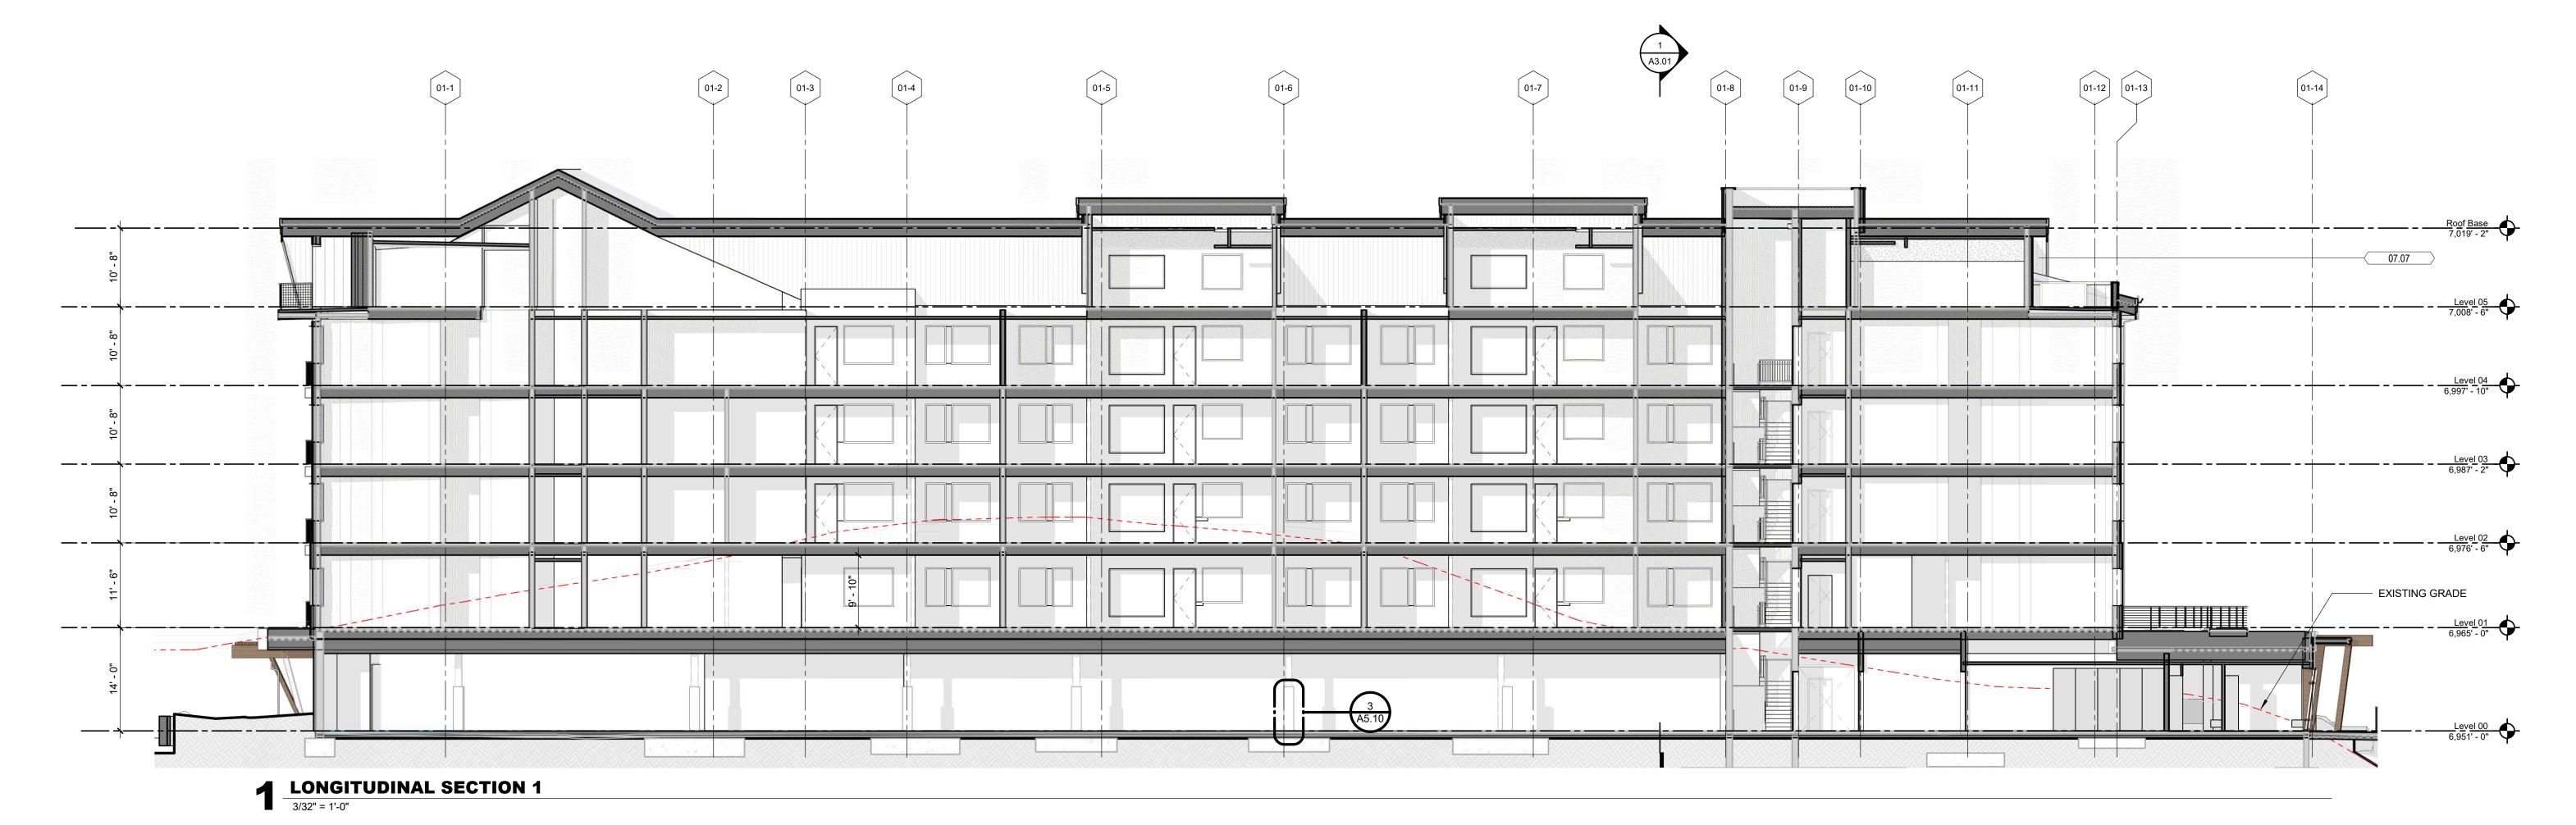

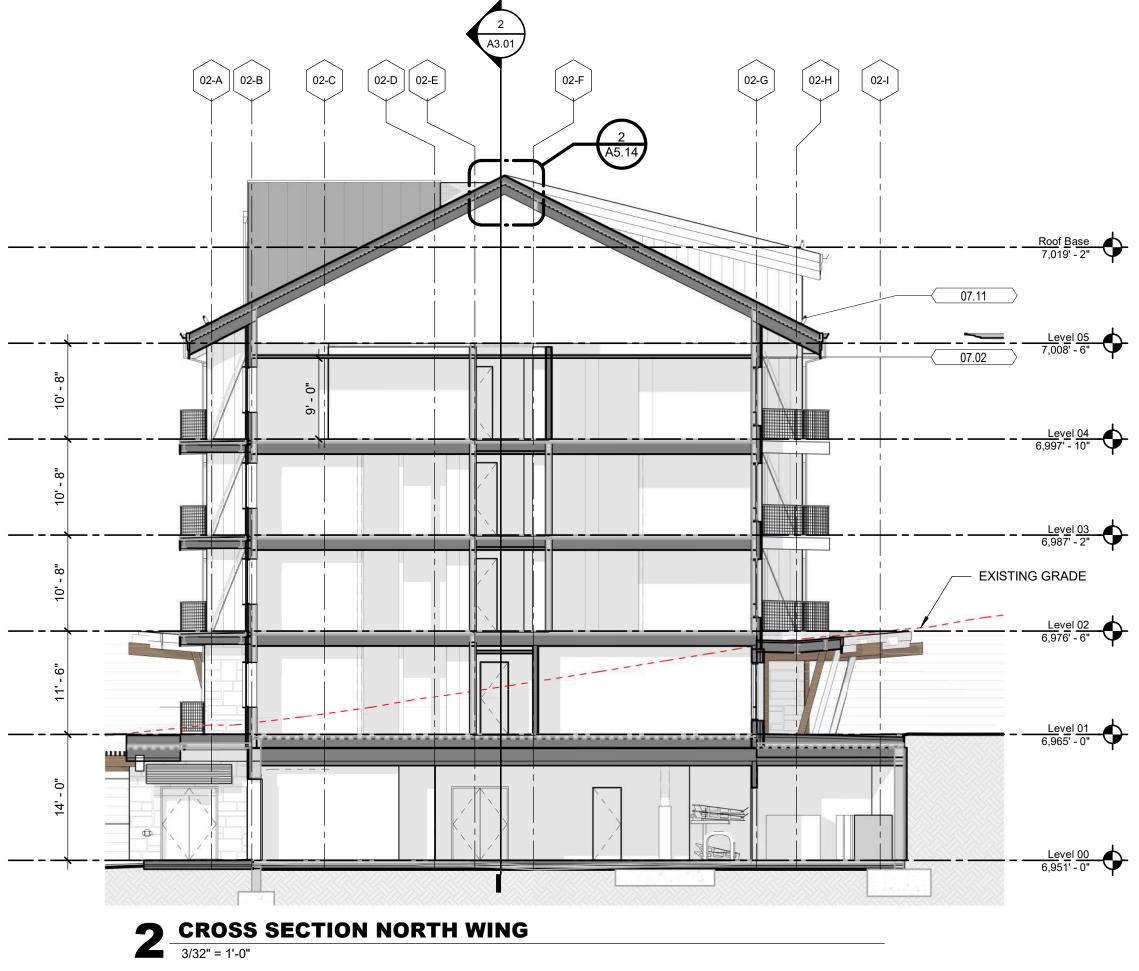



Keynote Legend			
05.01	METAL HOG WIRE RAILING		
07.01	EXTERIOR SLATE CLADDING, SEE MATERIAL LEGEND		
07.02	EXTERIOR WOOD SIDING, SEE MATERIAL LEGEND		
07.03	EXTERIOR ALUMINUM SIDING, SEE MATERIAL LEGEND		
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07.09	SCUPPER AND DOWNSPOUT W/ HEAT TRACE, RE: ELEC.		
07.11	SNOW GUARD		
D27	<varies></varies>		
D28			
D29			

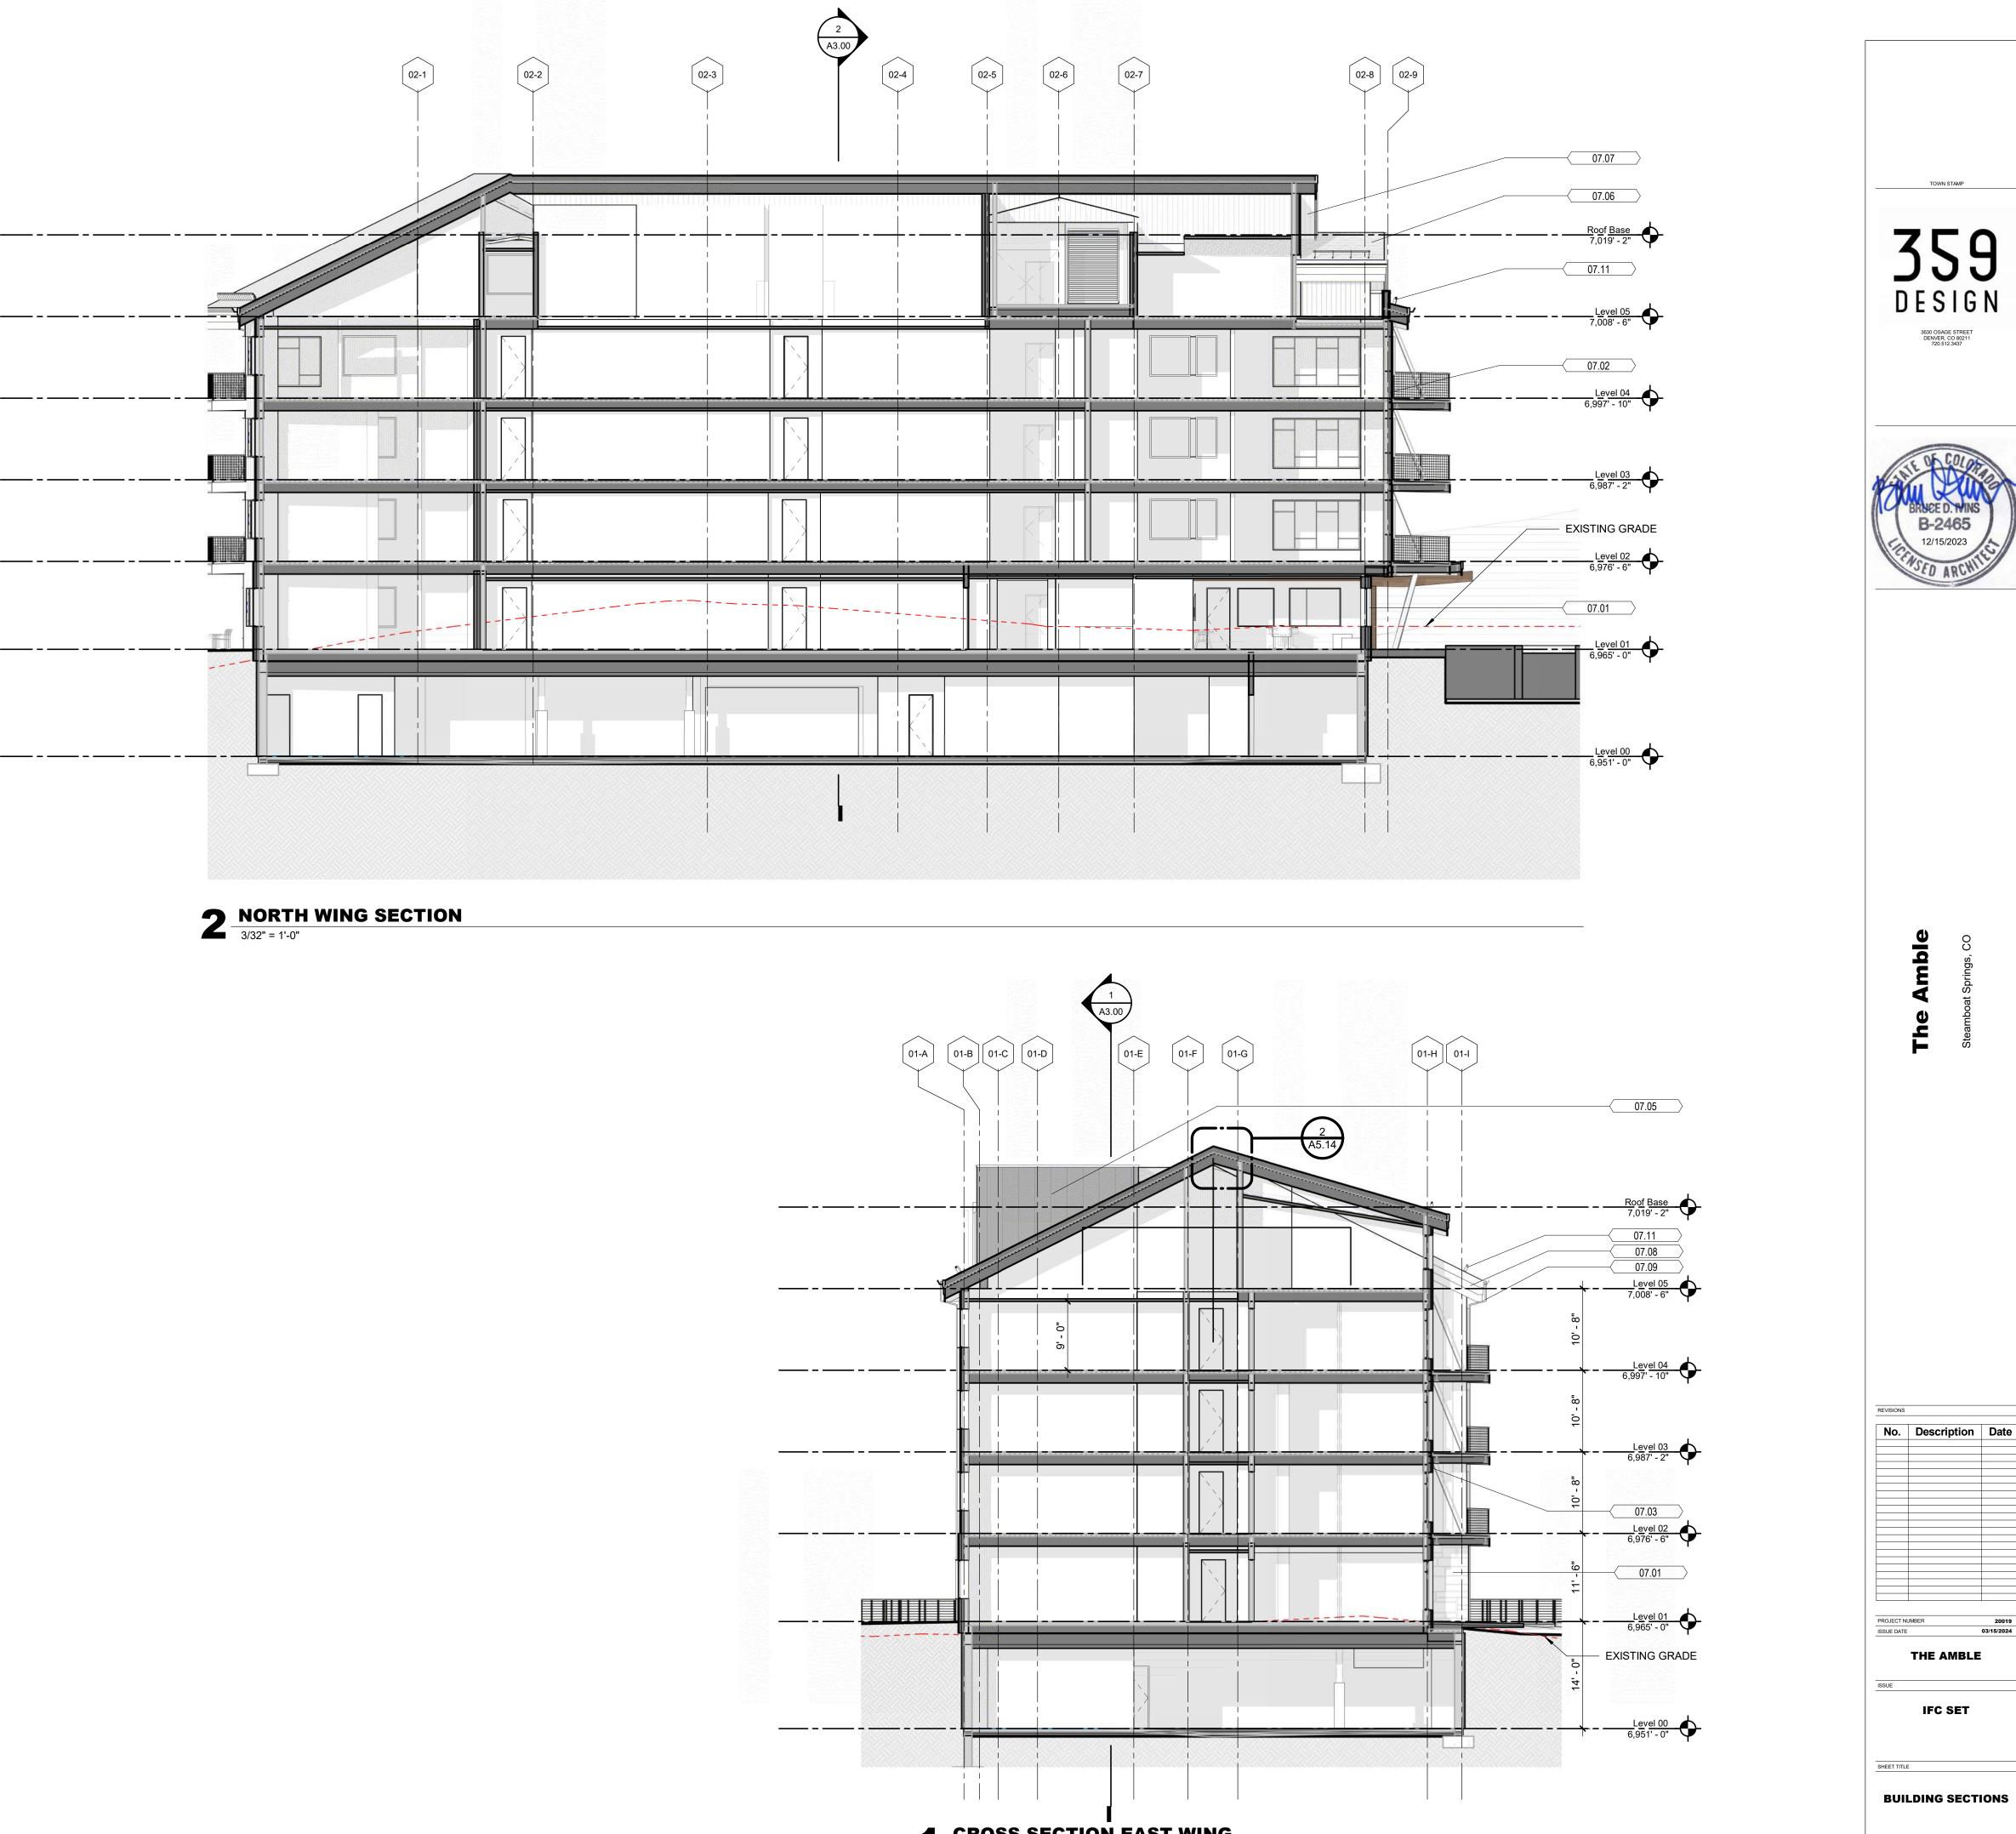


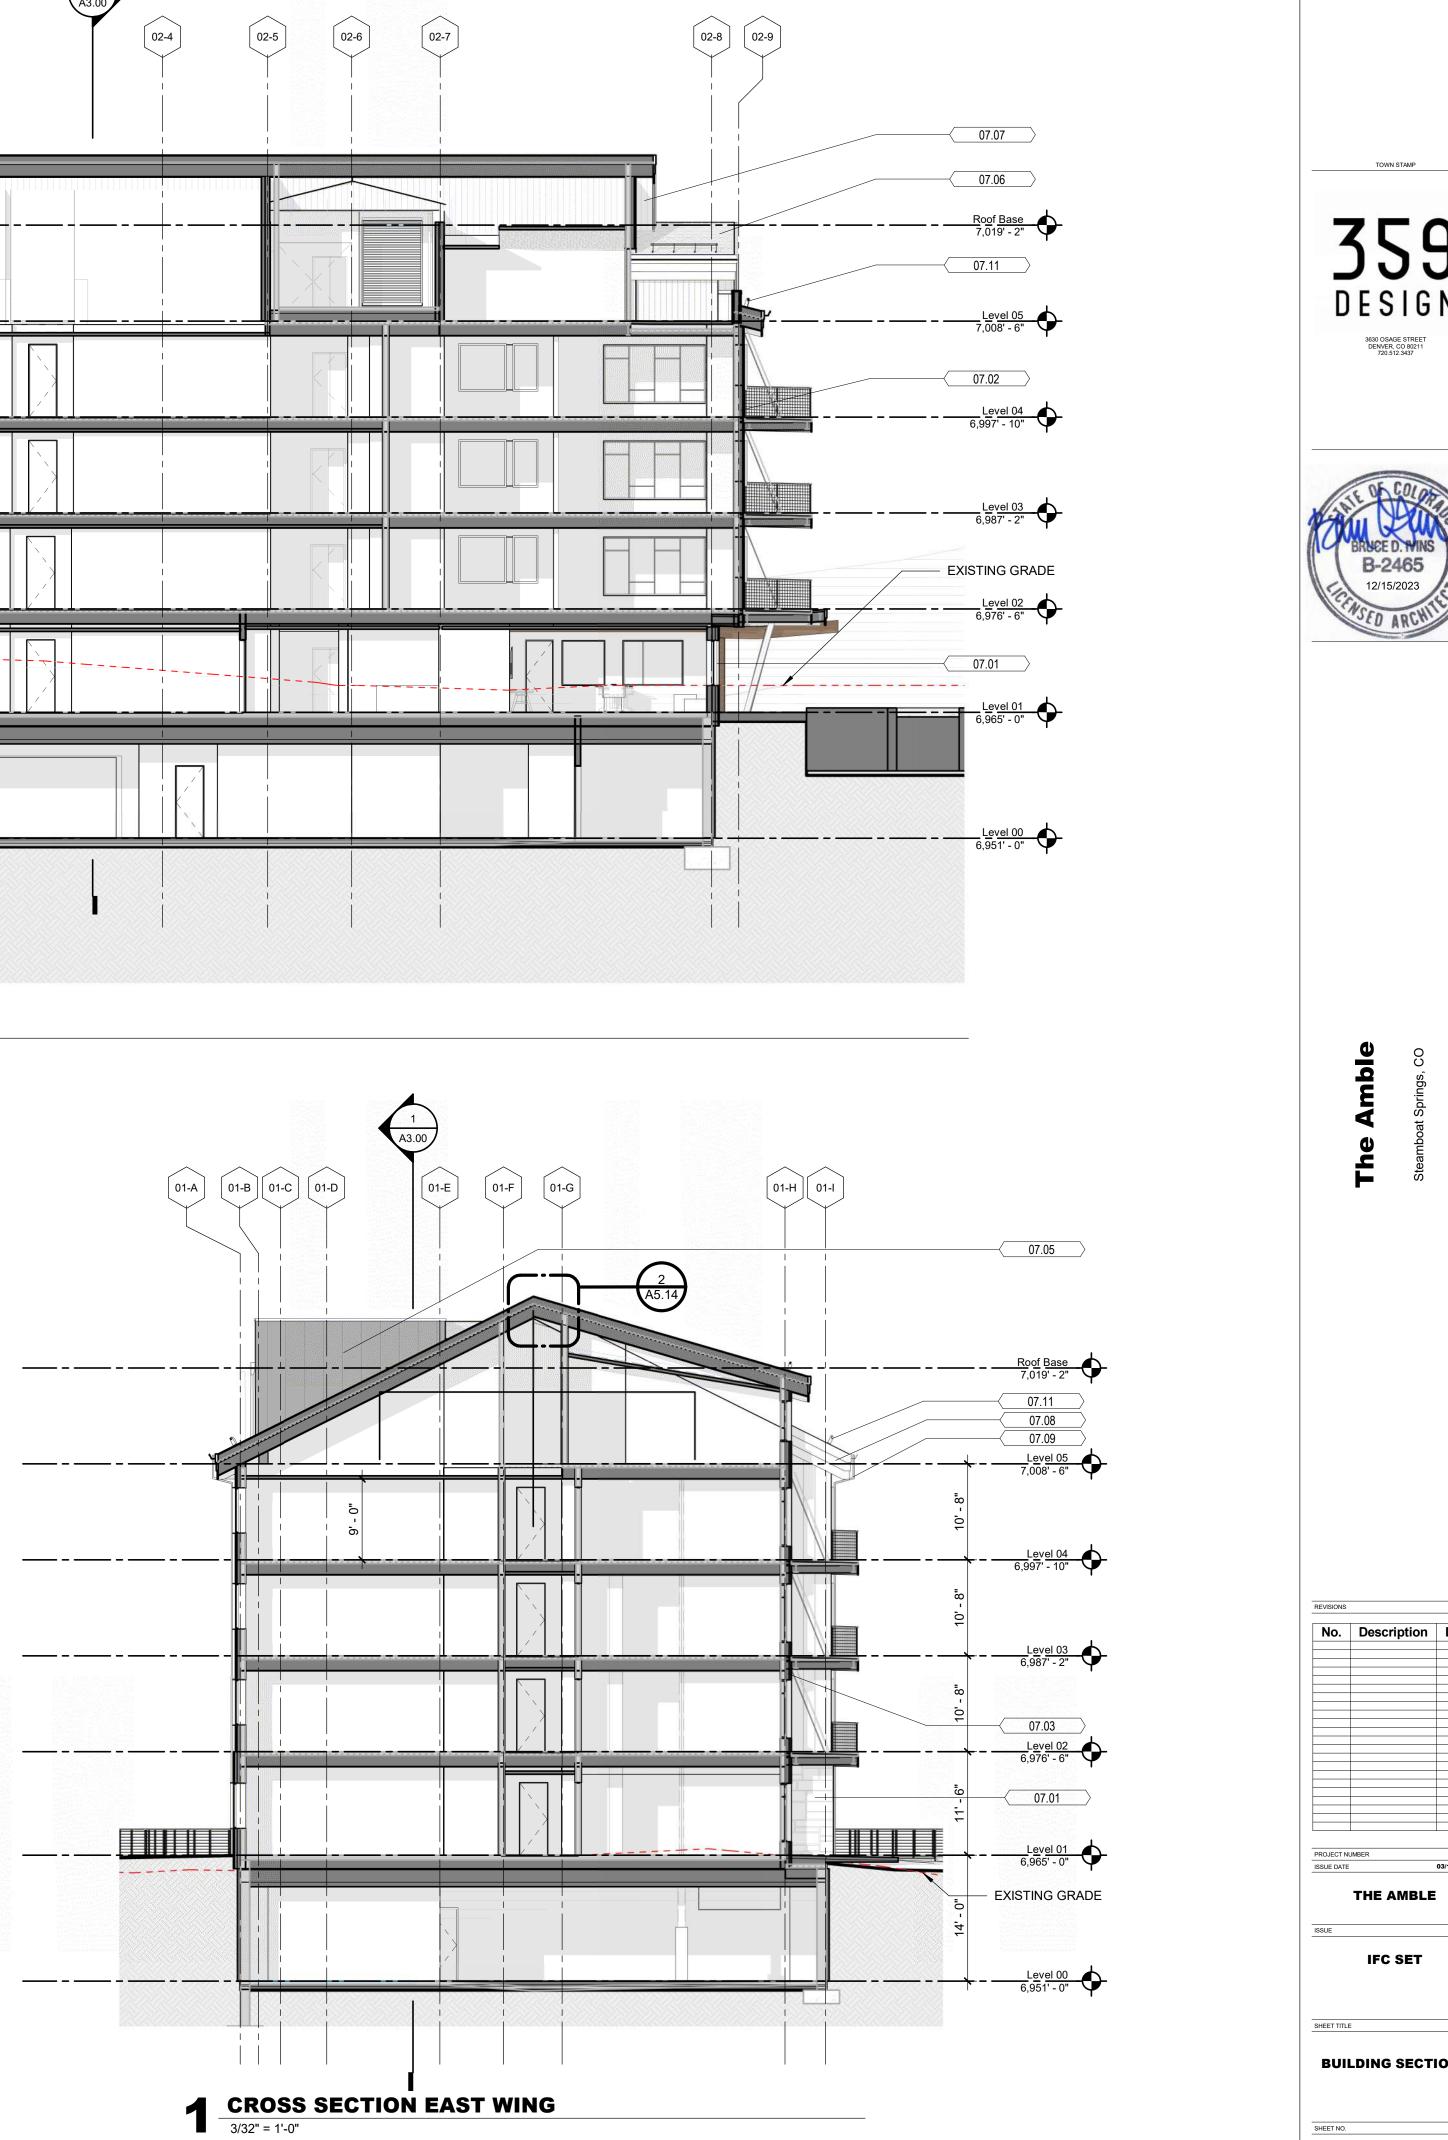

A3.01

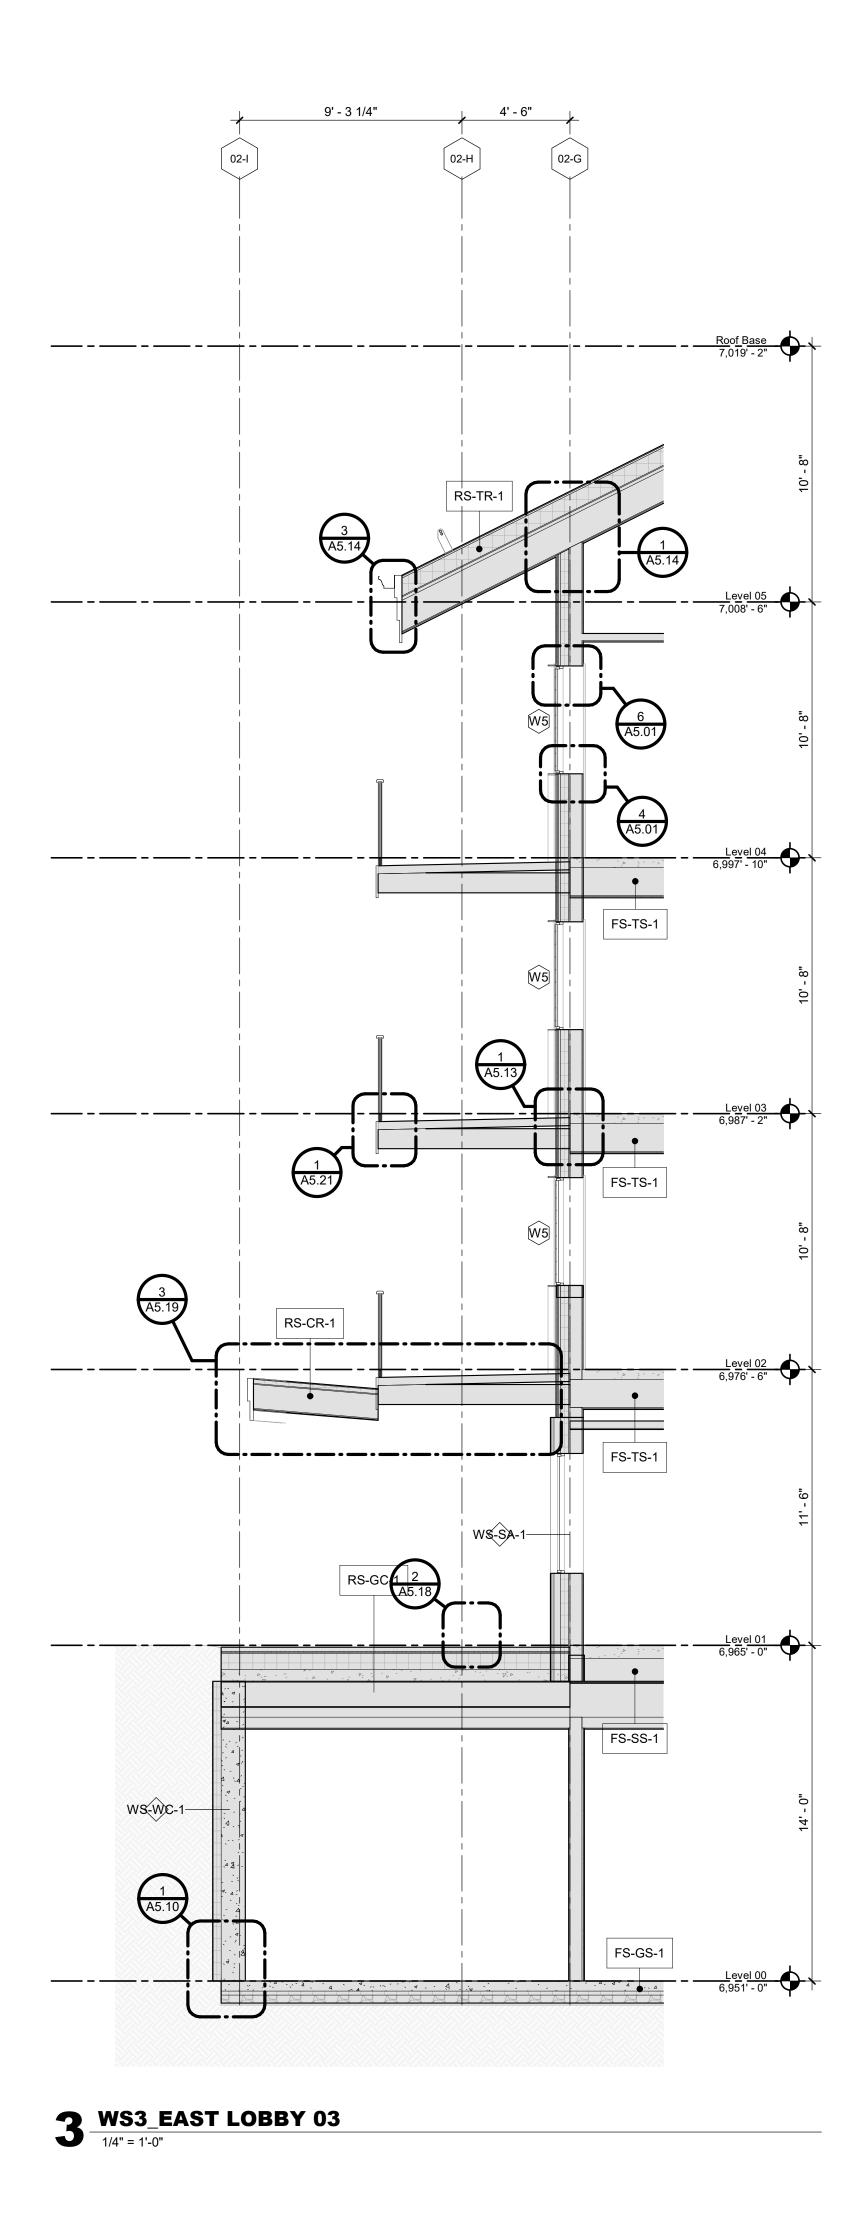

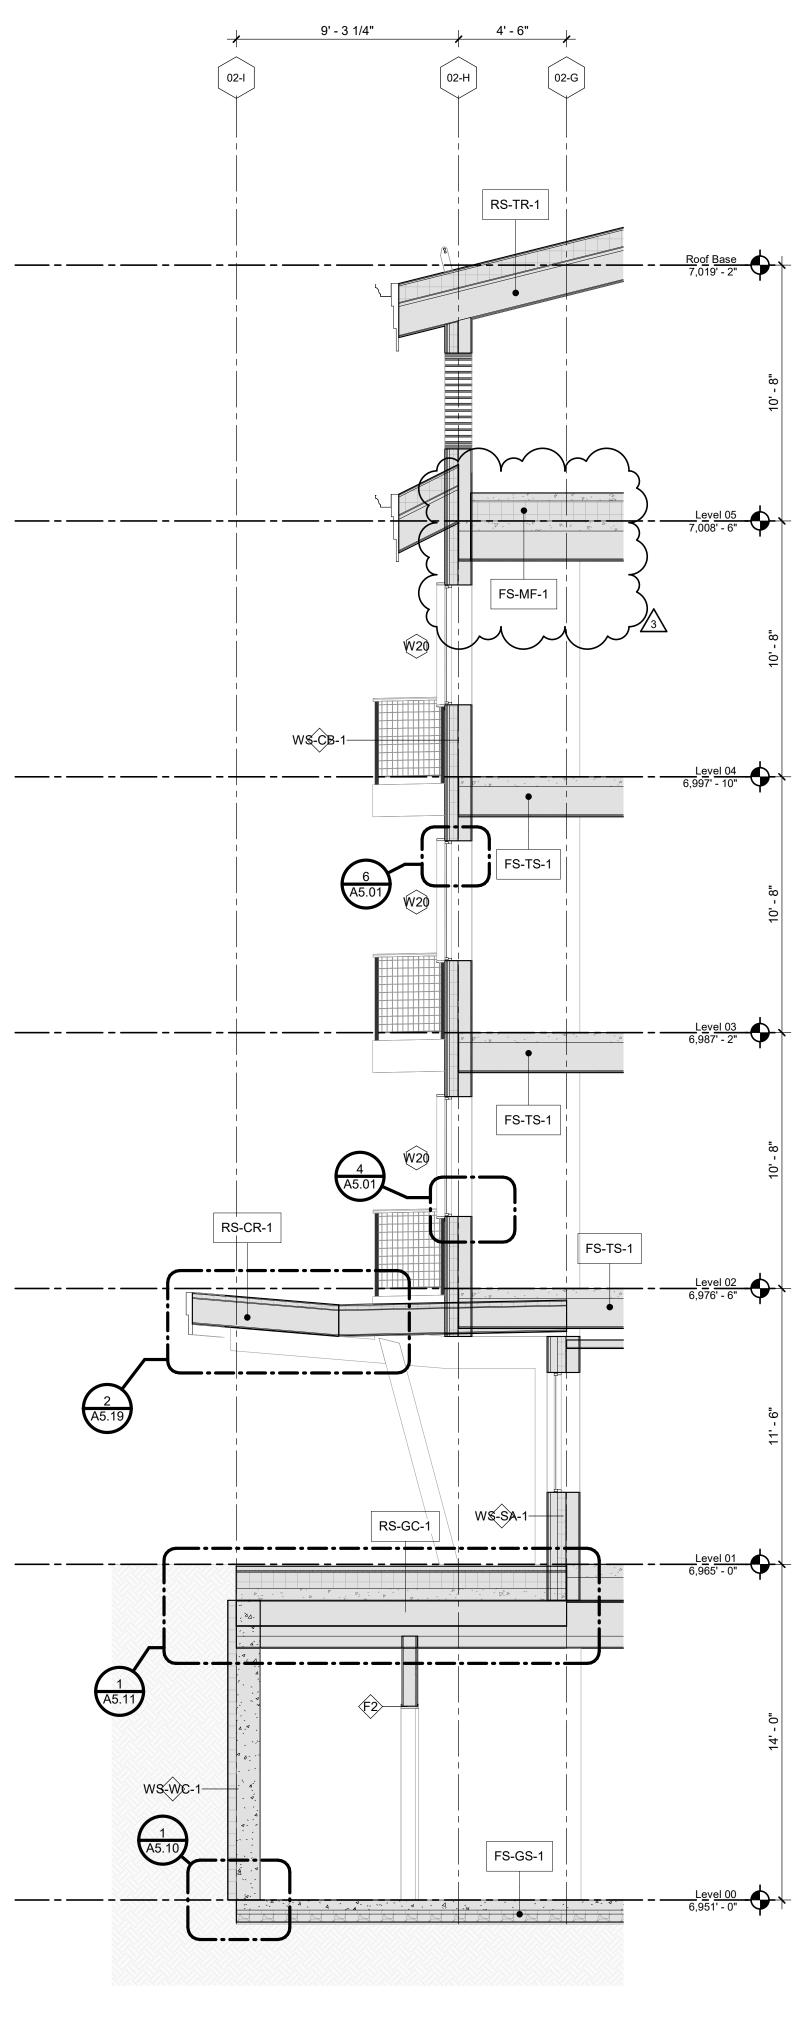

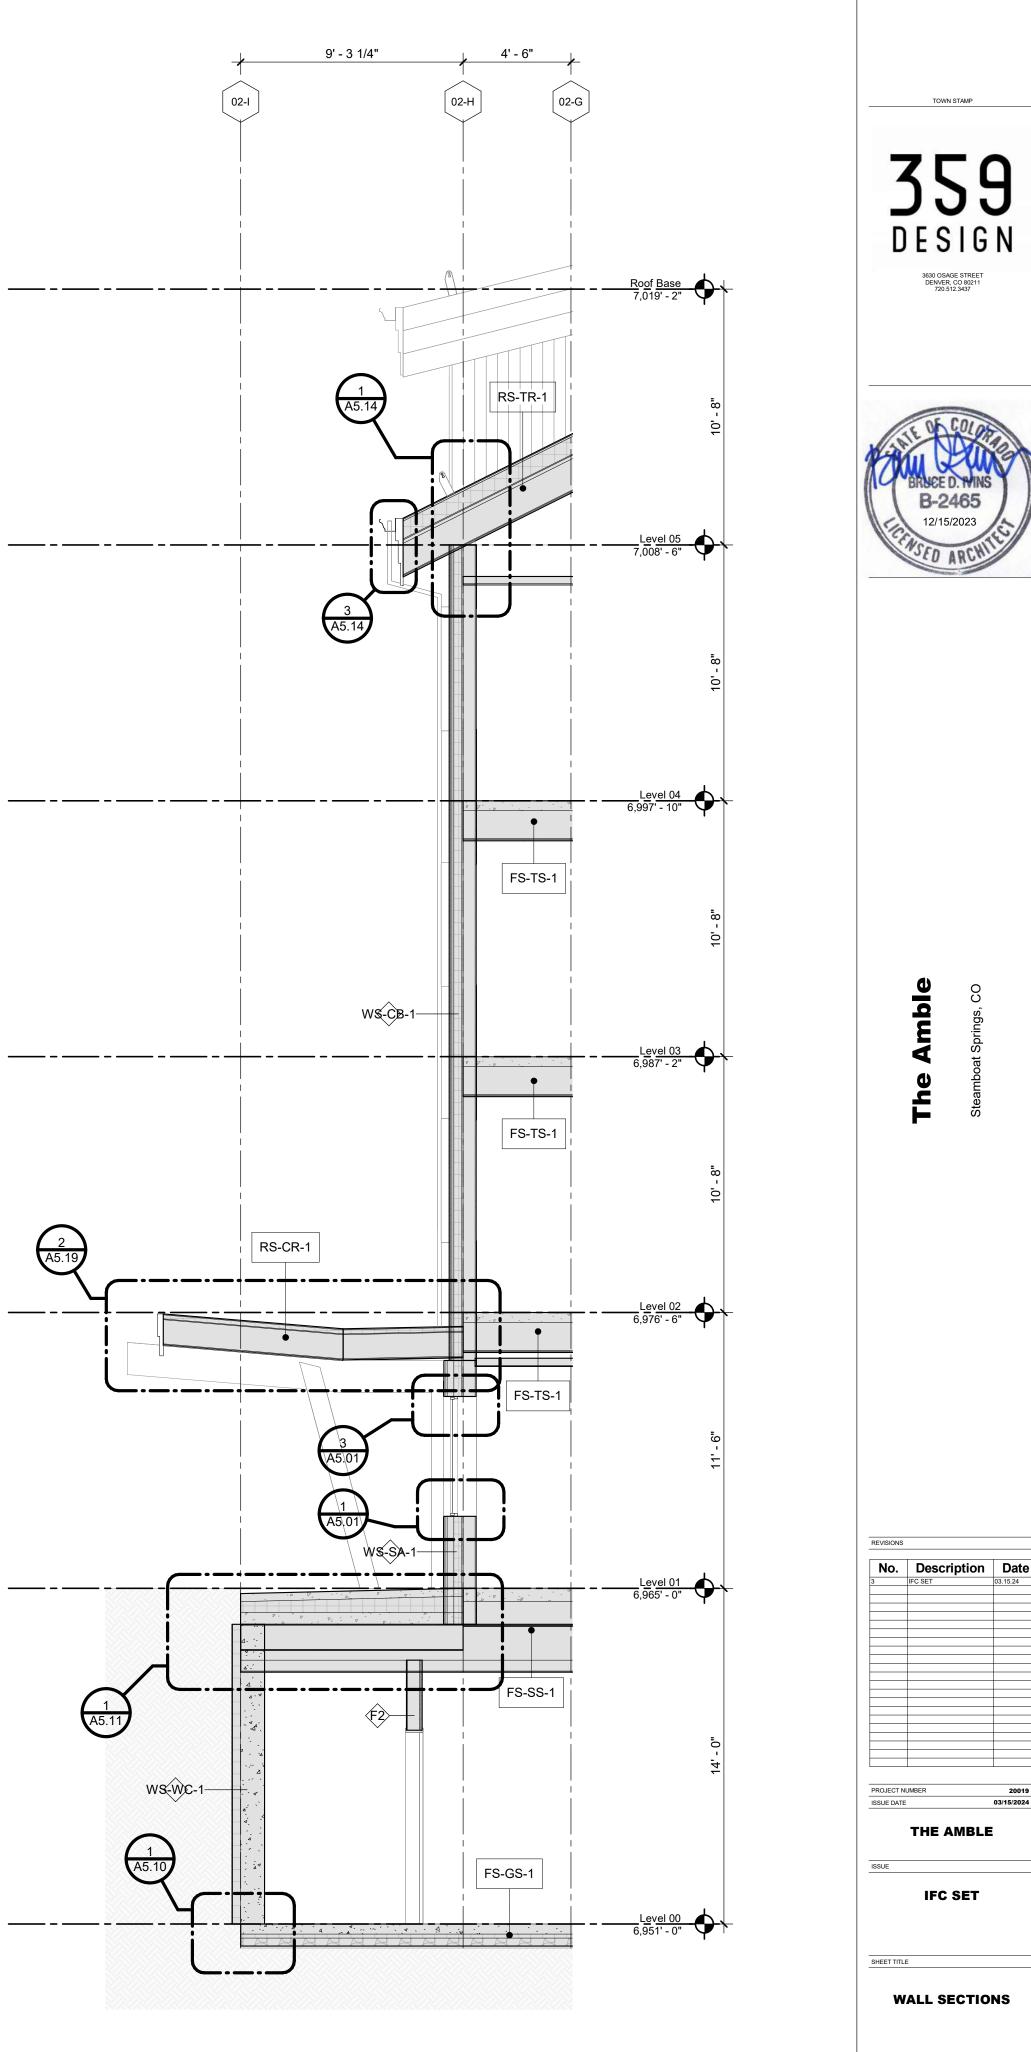

TOWN STAMP

3630 OSAGE STREET DENVER, CO 80211 720.512.3437

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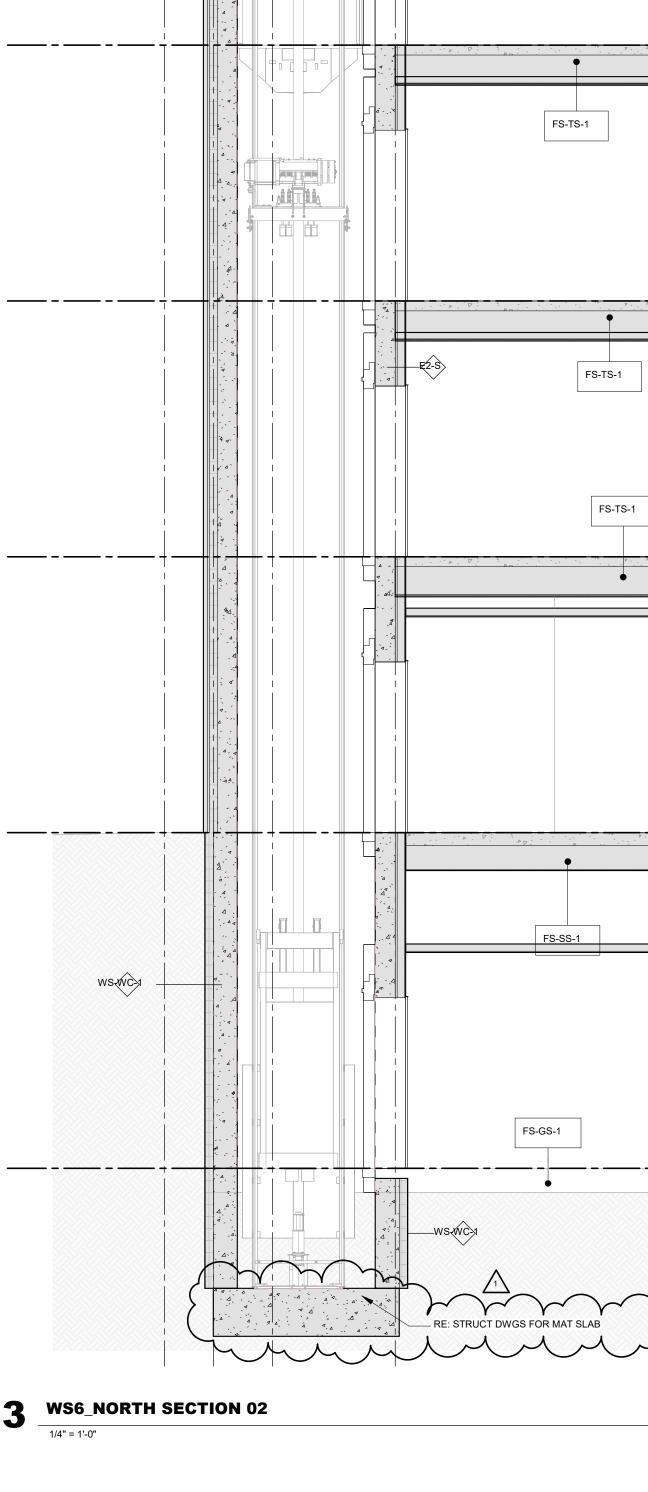
03/15/2024

IFC SET

A3.10

SHEET NO.

**WS1\_EAST LOBBY 01** 1/4" = 1'-0"



2' - 0 1/2"

01-A

WS-WM-

01-B

2' - 5 1/2" 5' - 1 1/2"

01-D

12' - 7"

RS-FL-1

•


2 A5.24

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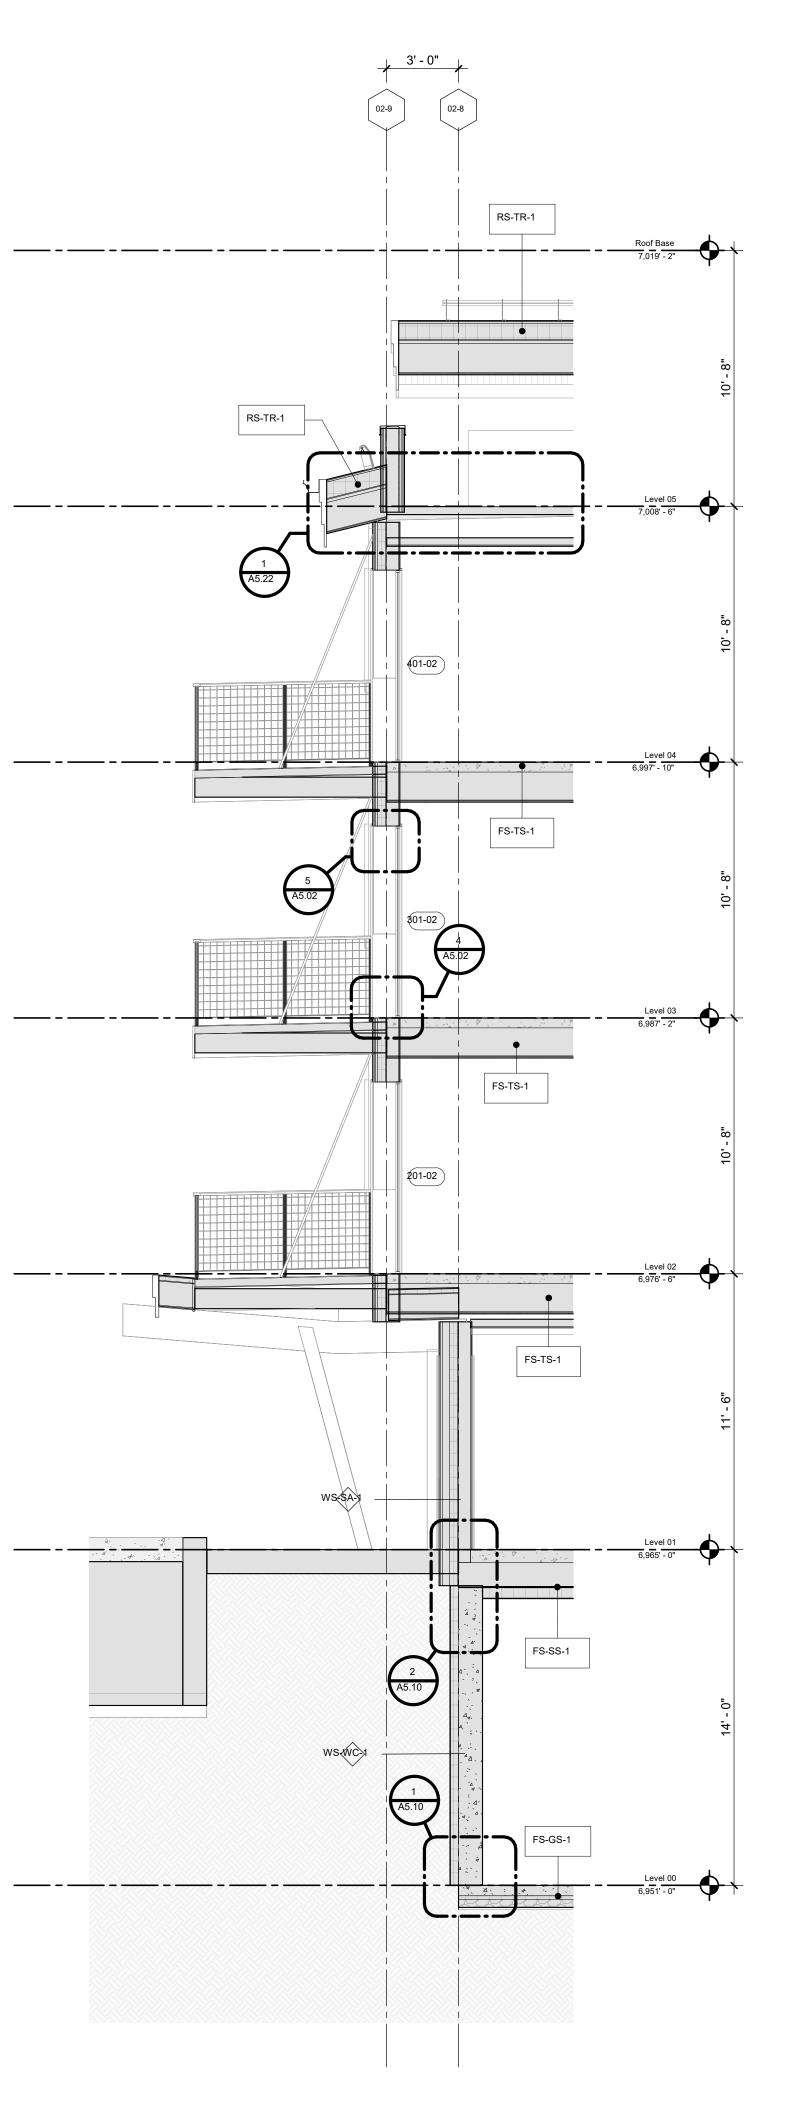
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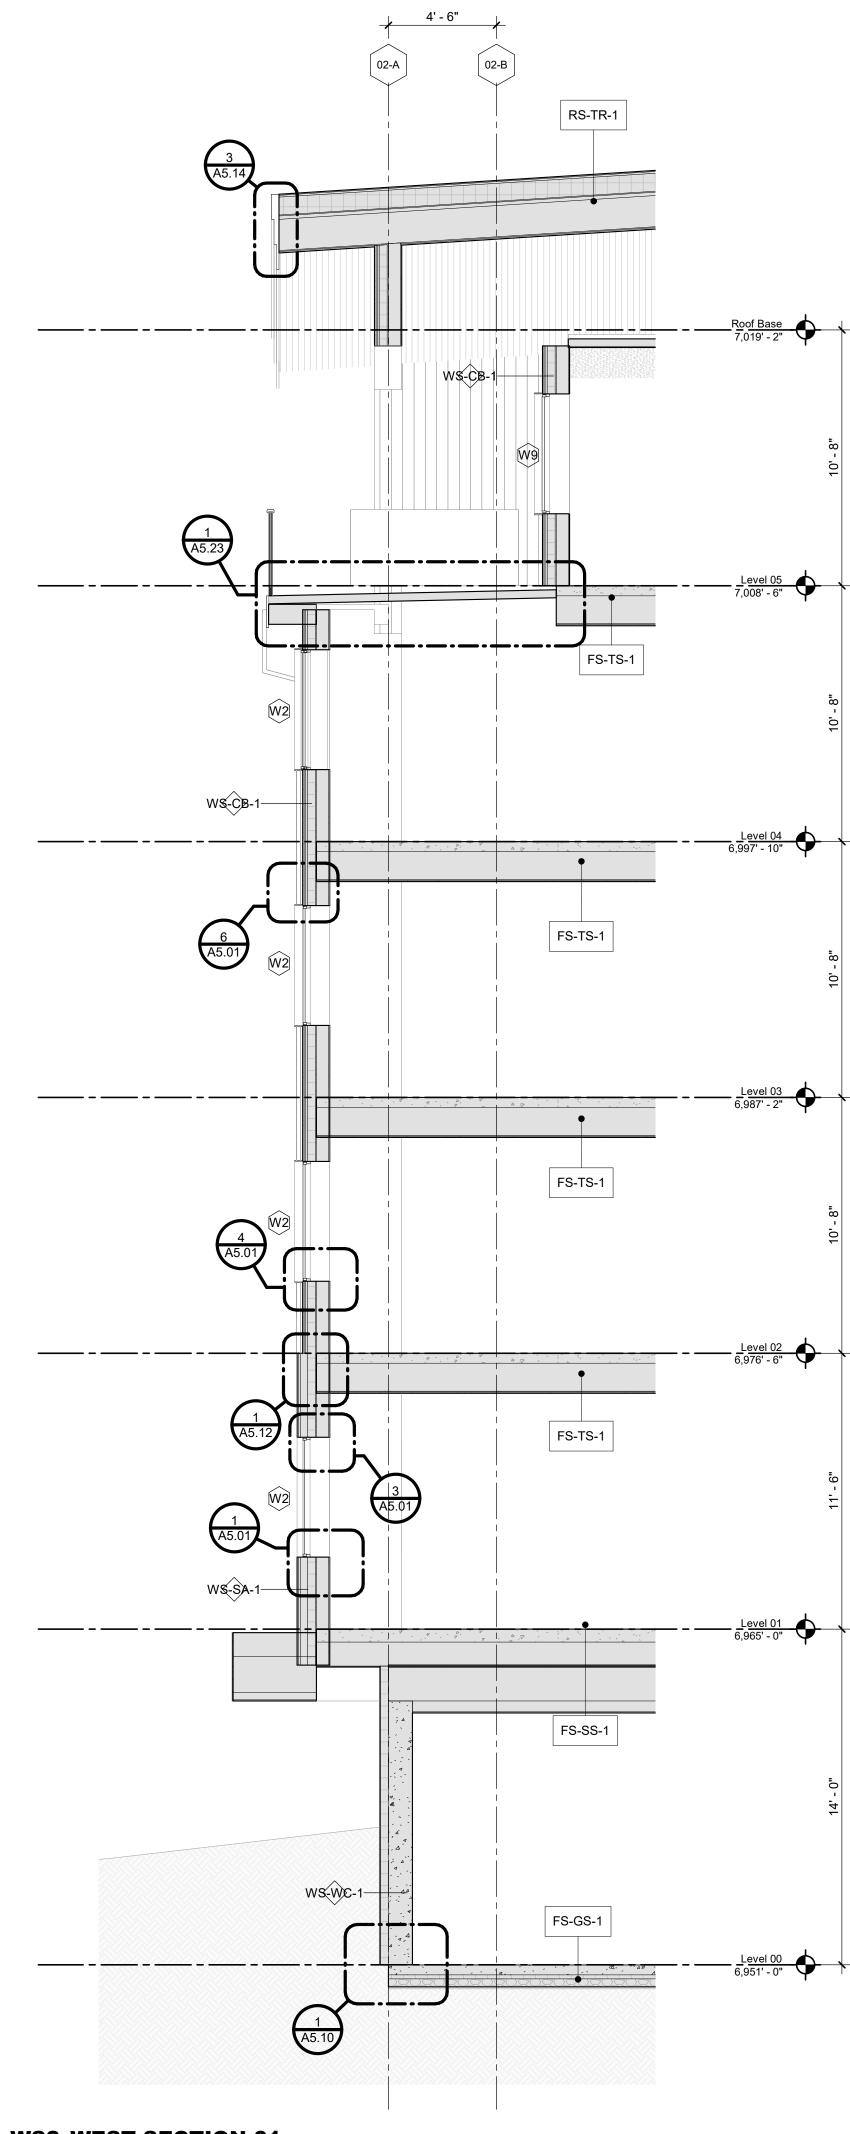
#### WS5\_NORTH SECTION 01 2

1/4" = 1'-0"




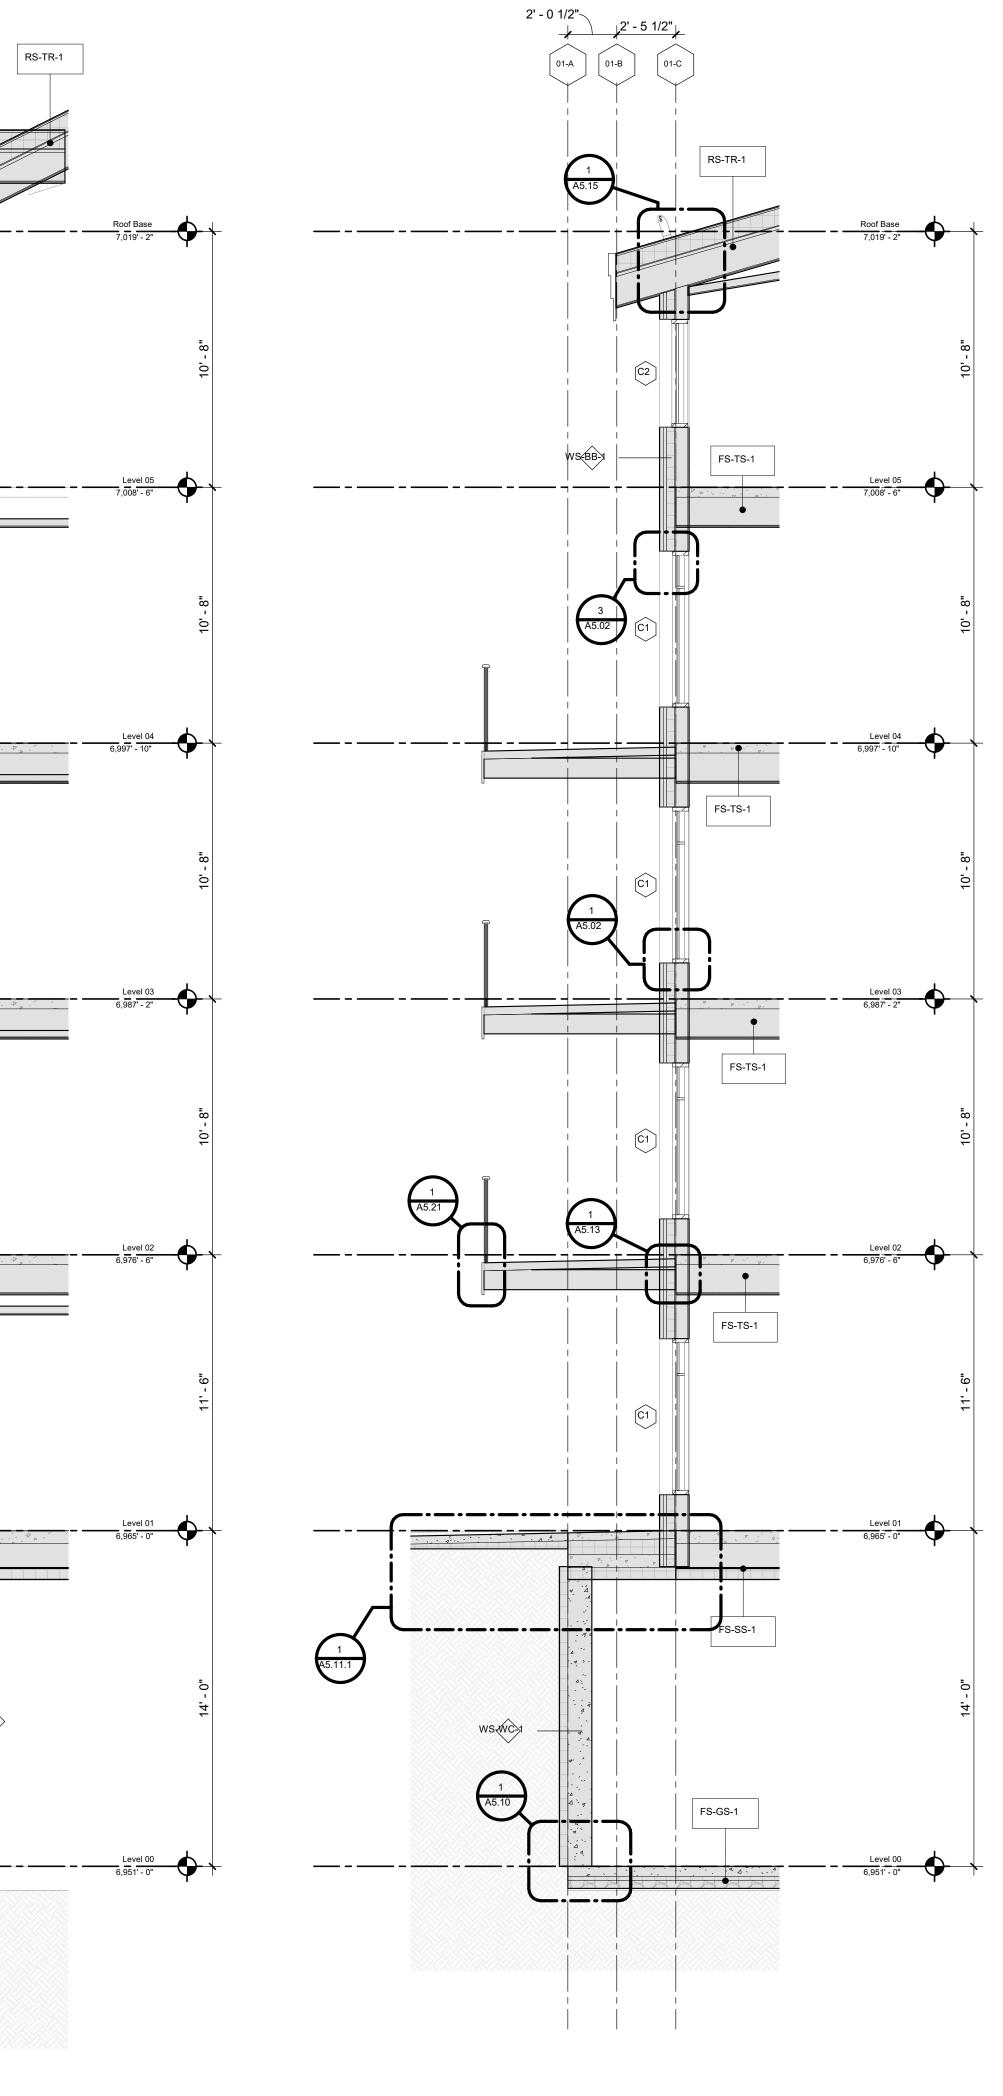



WS4\_North Lobby 01






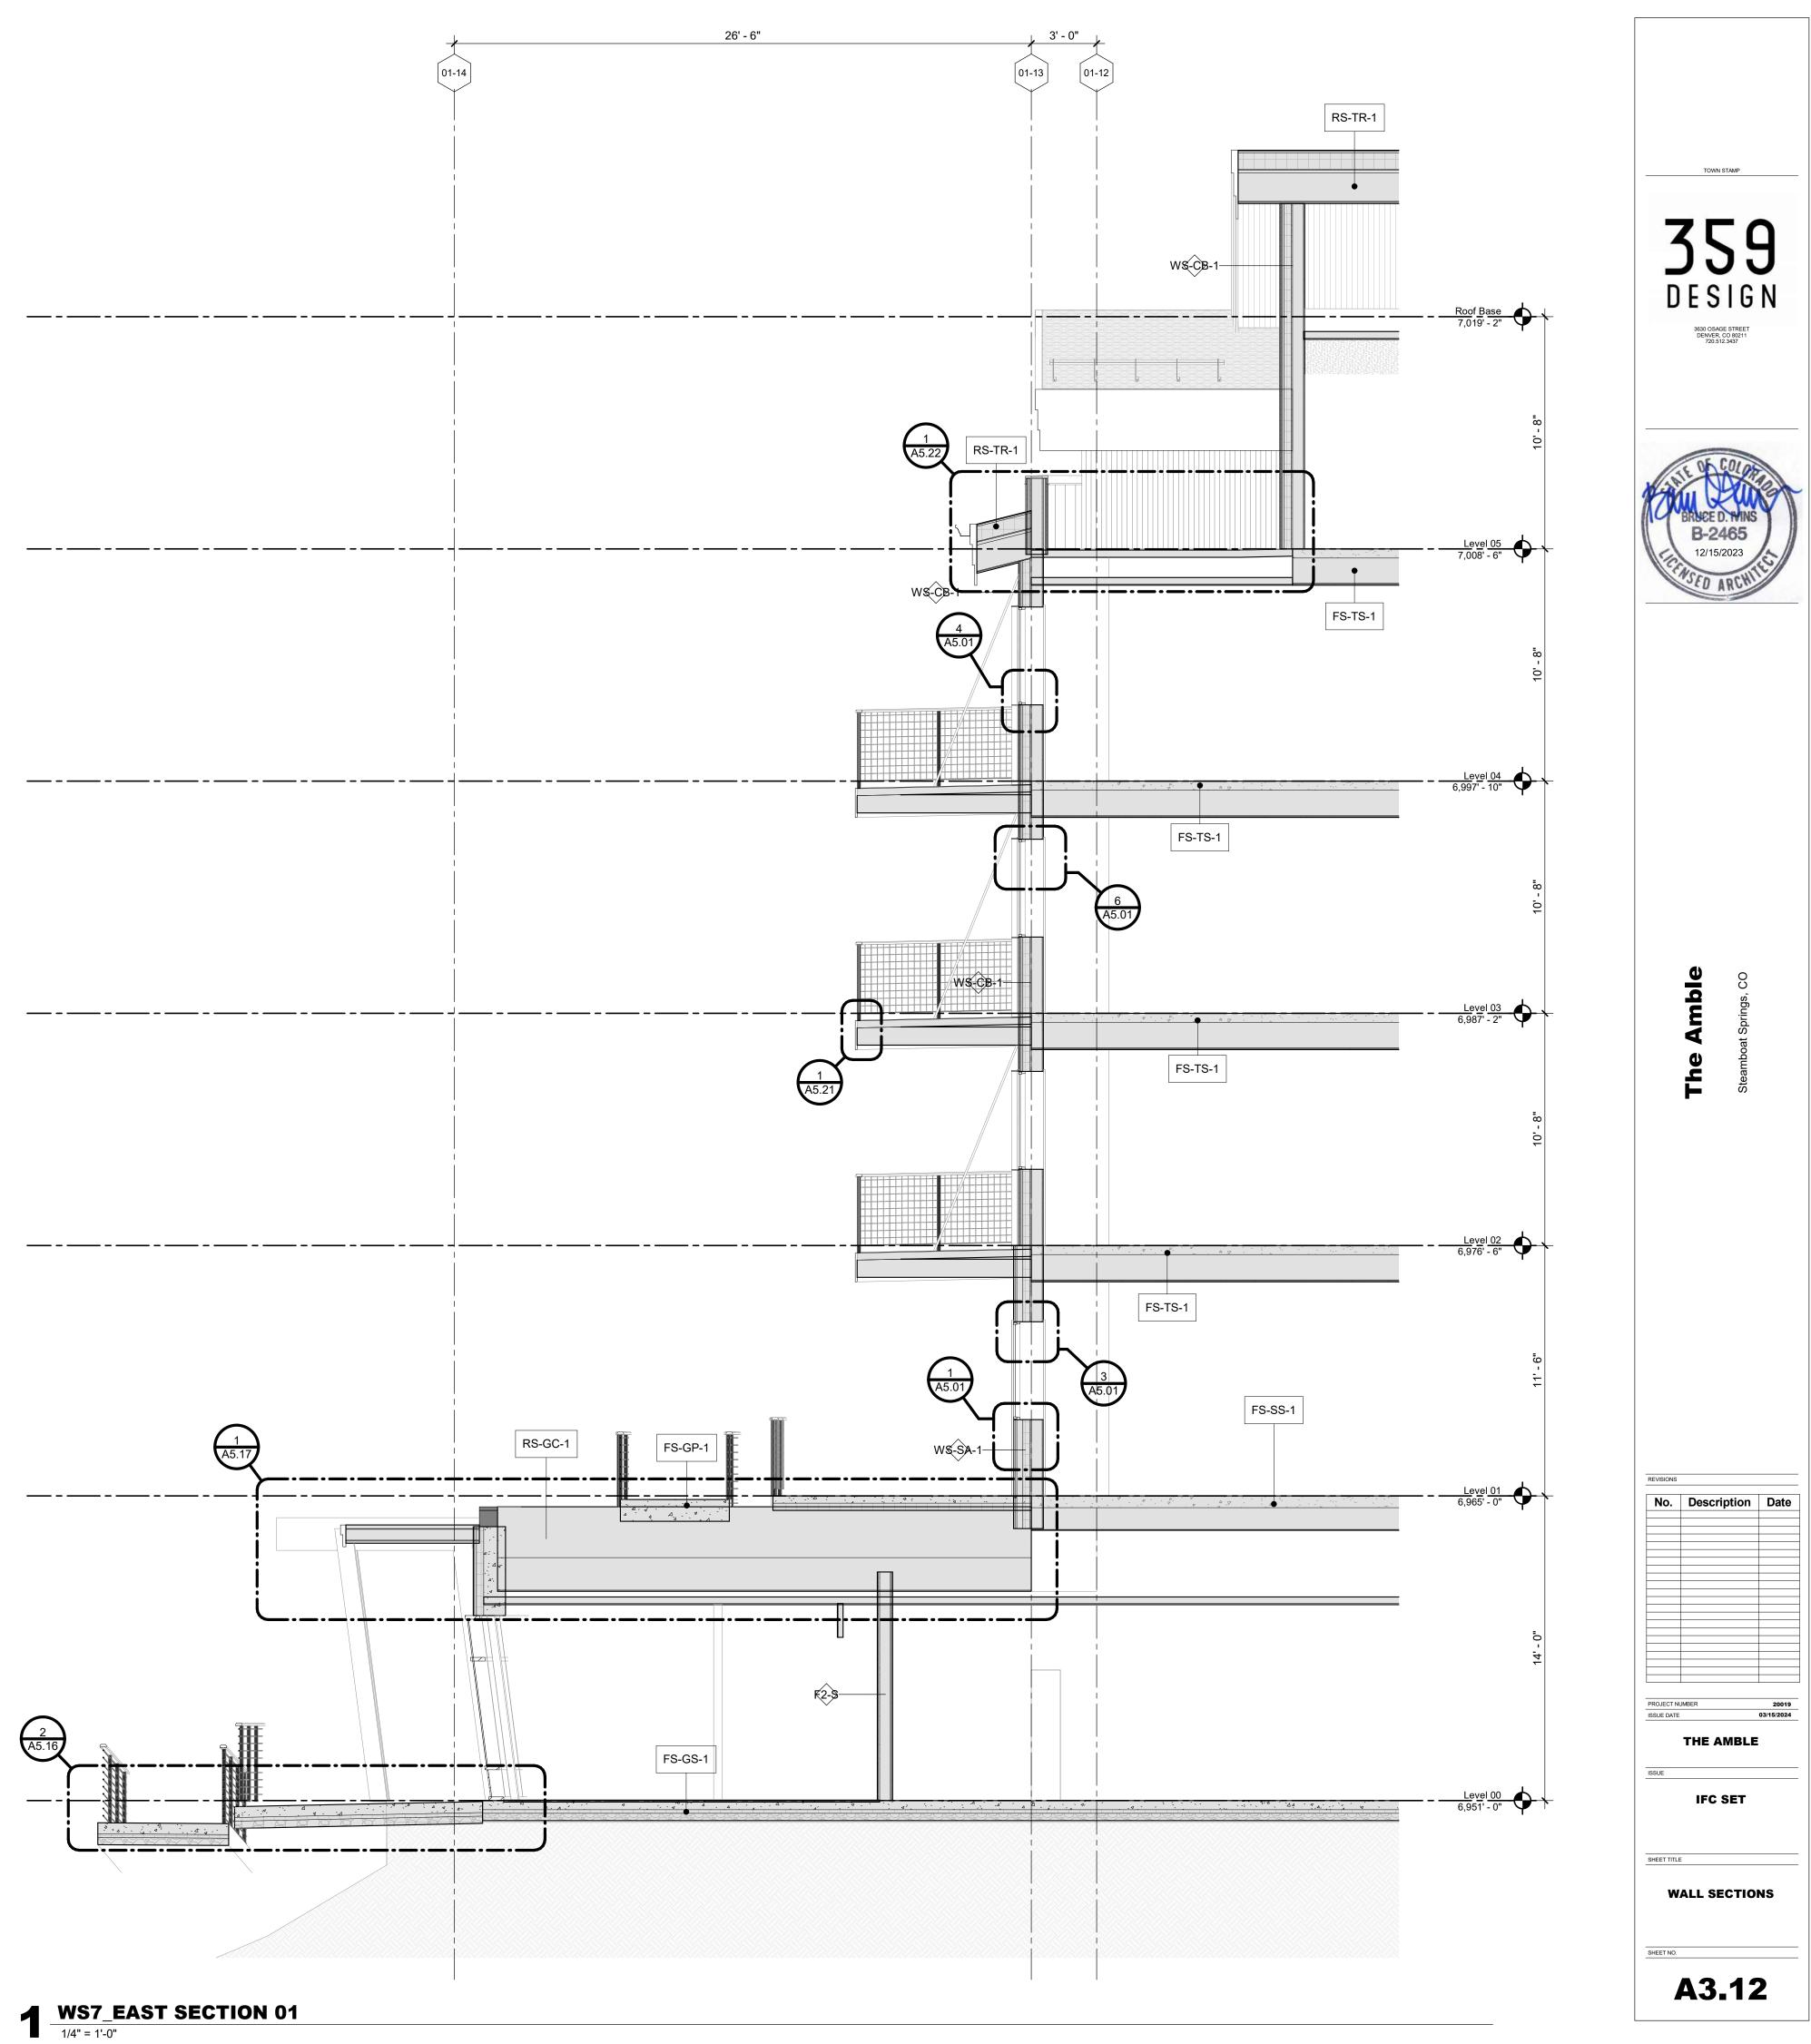


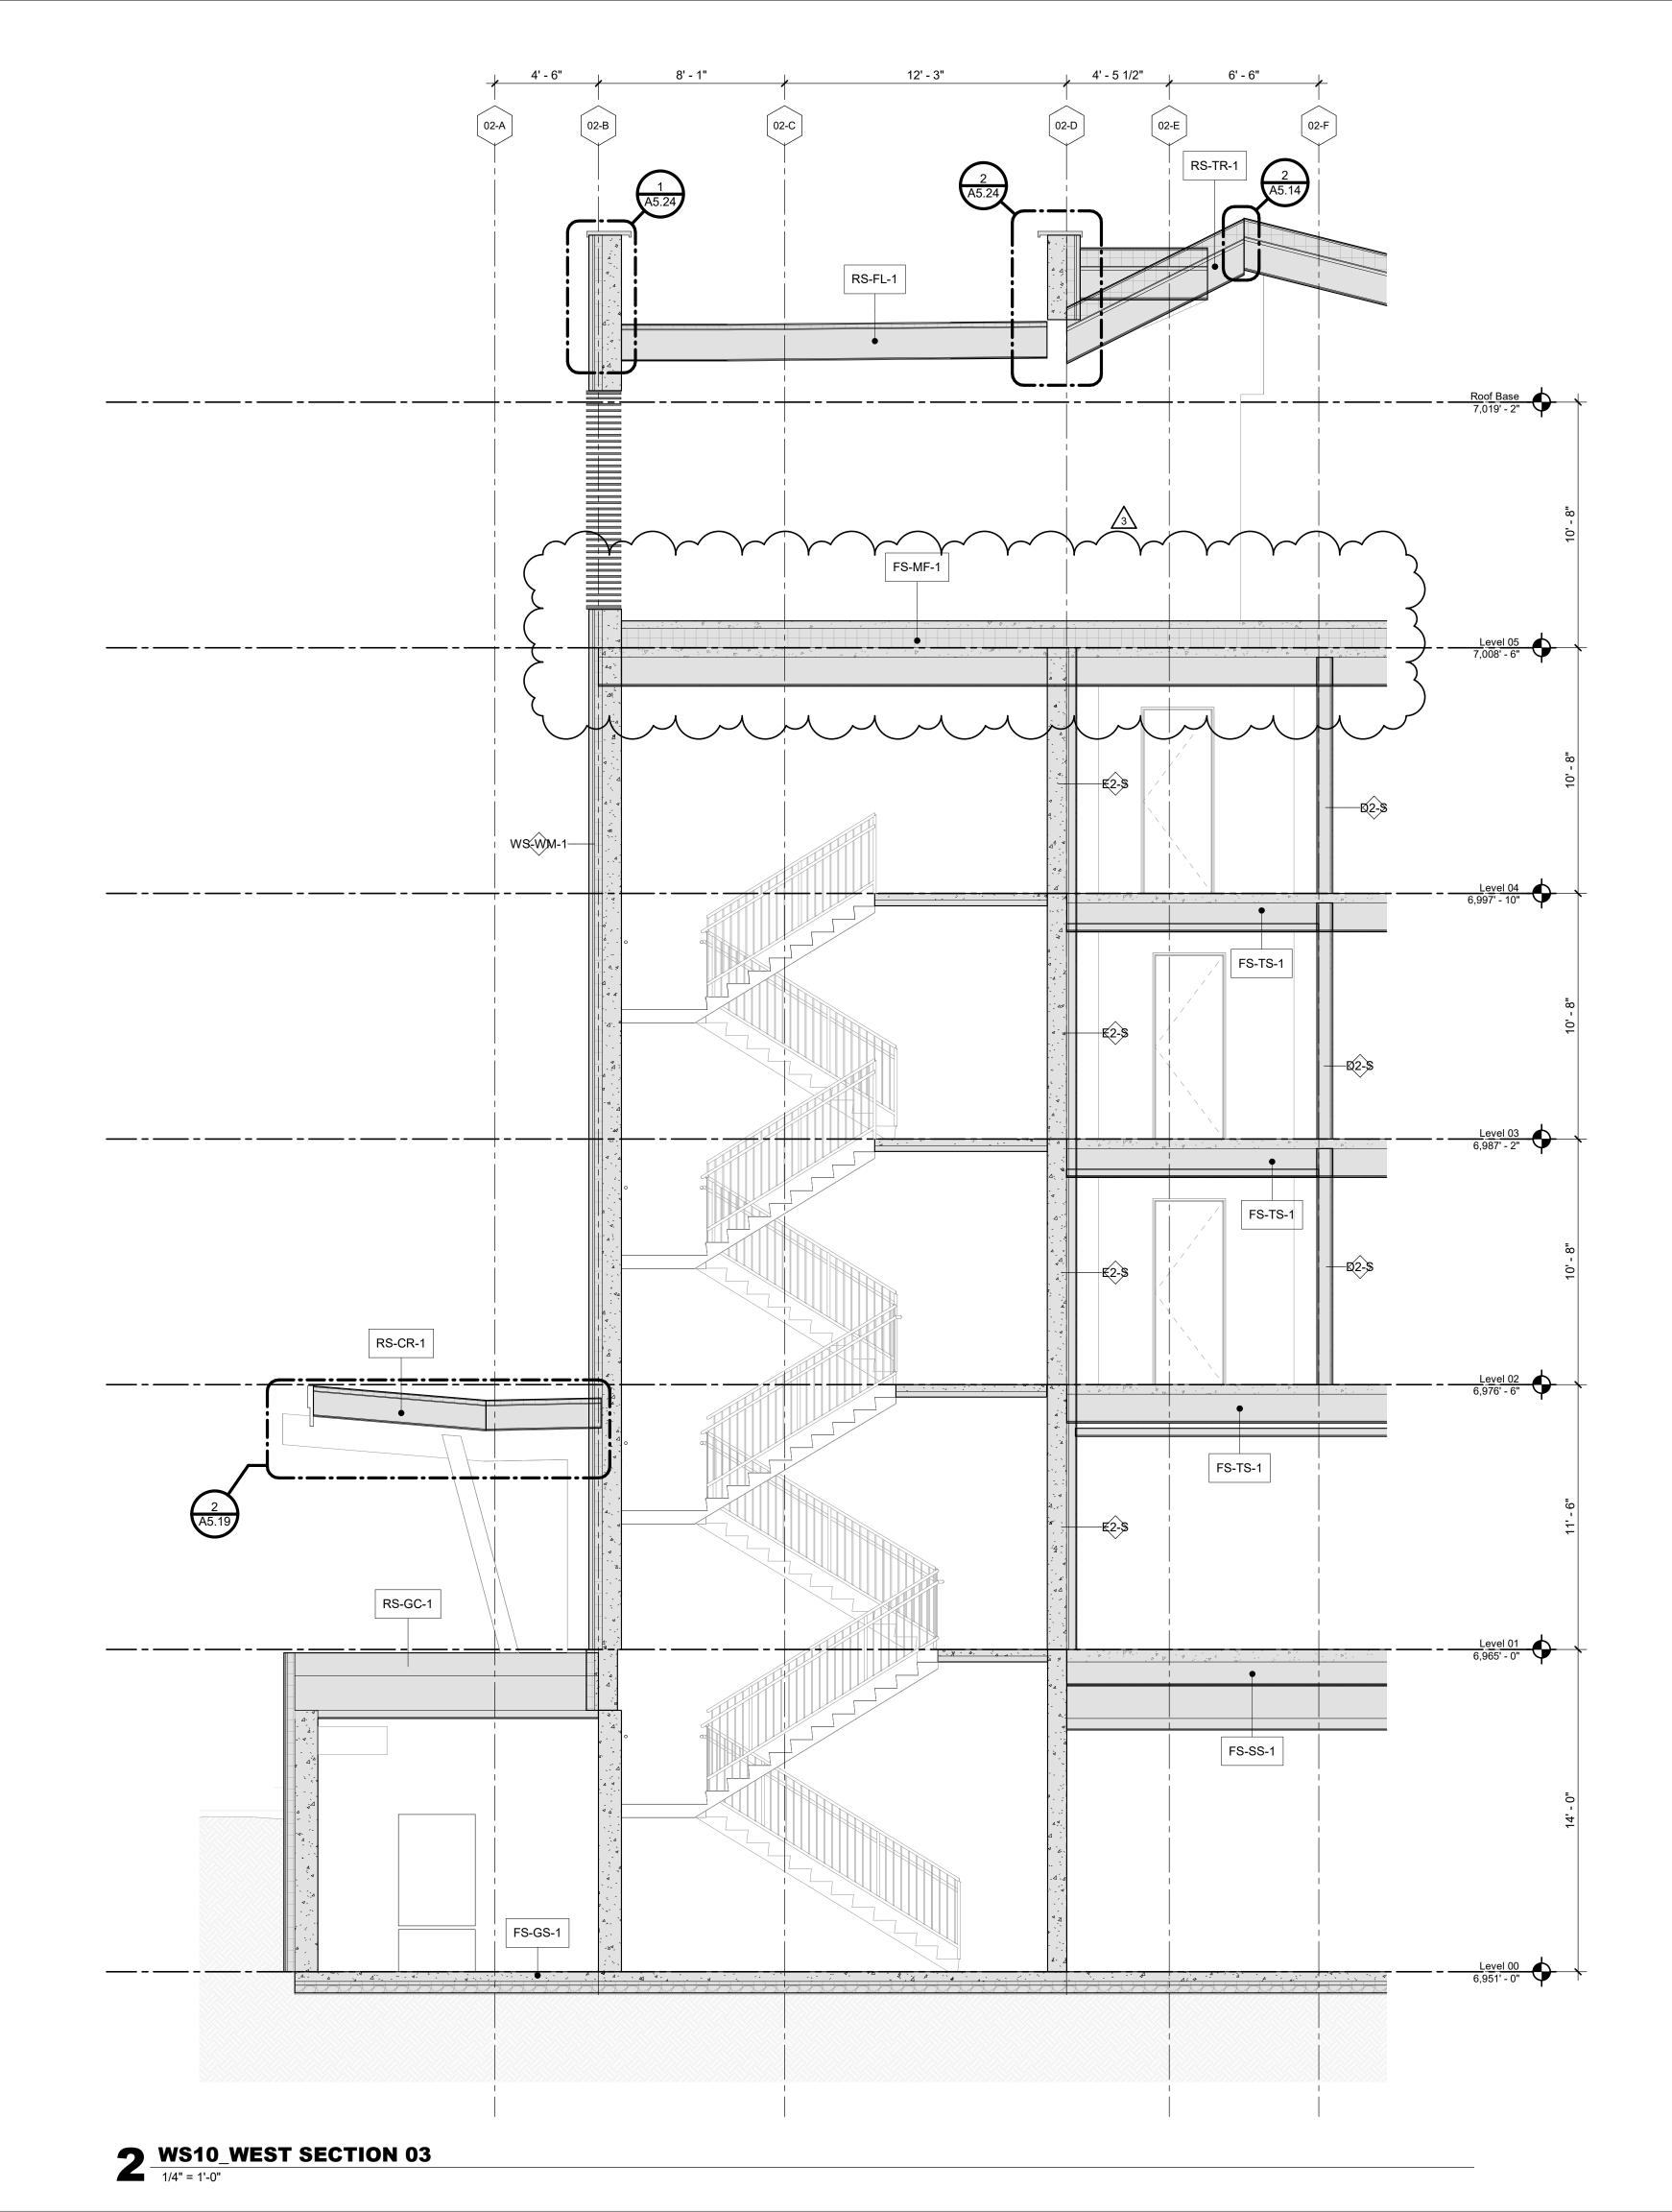

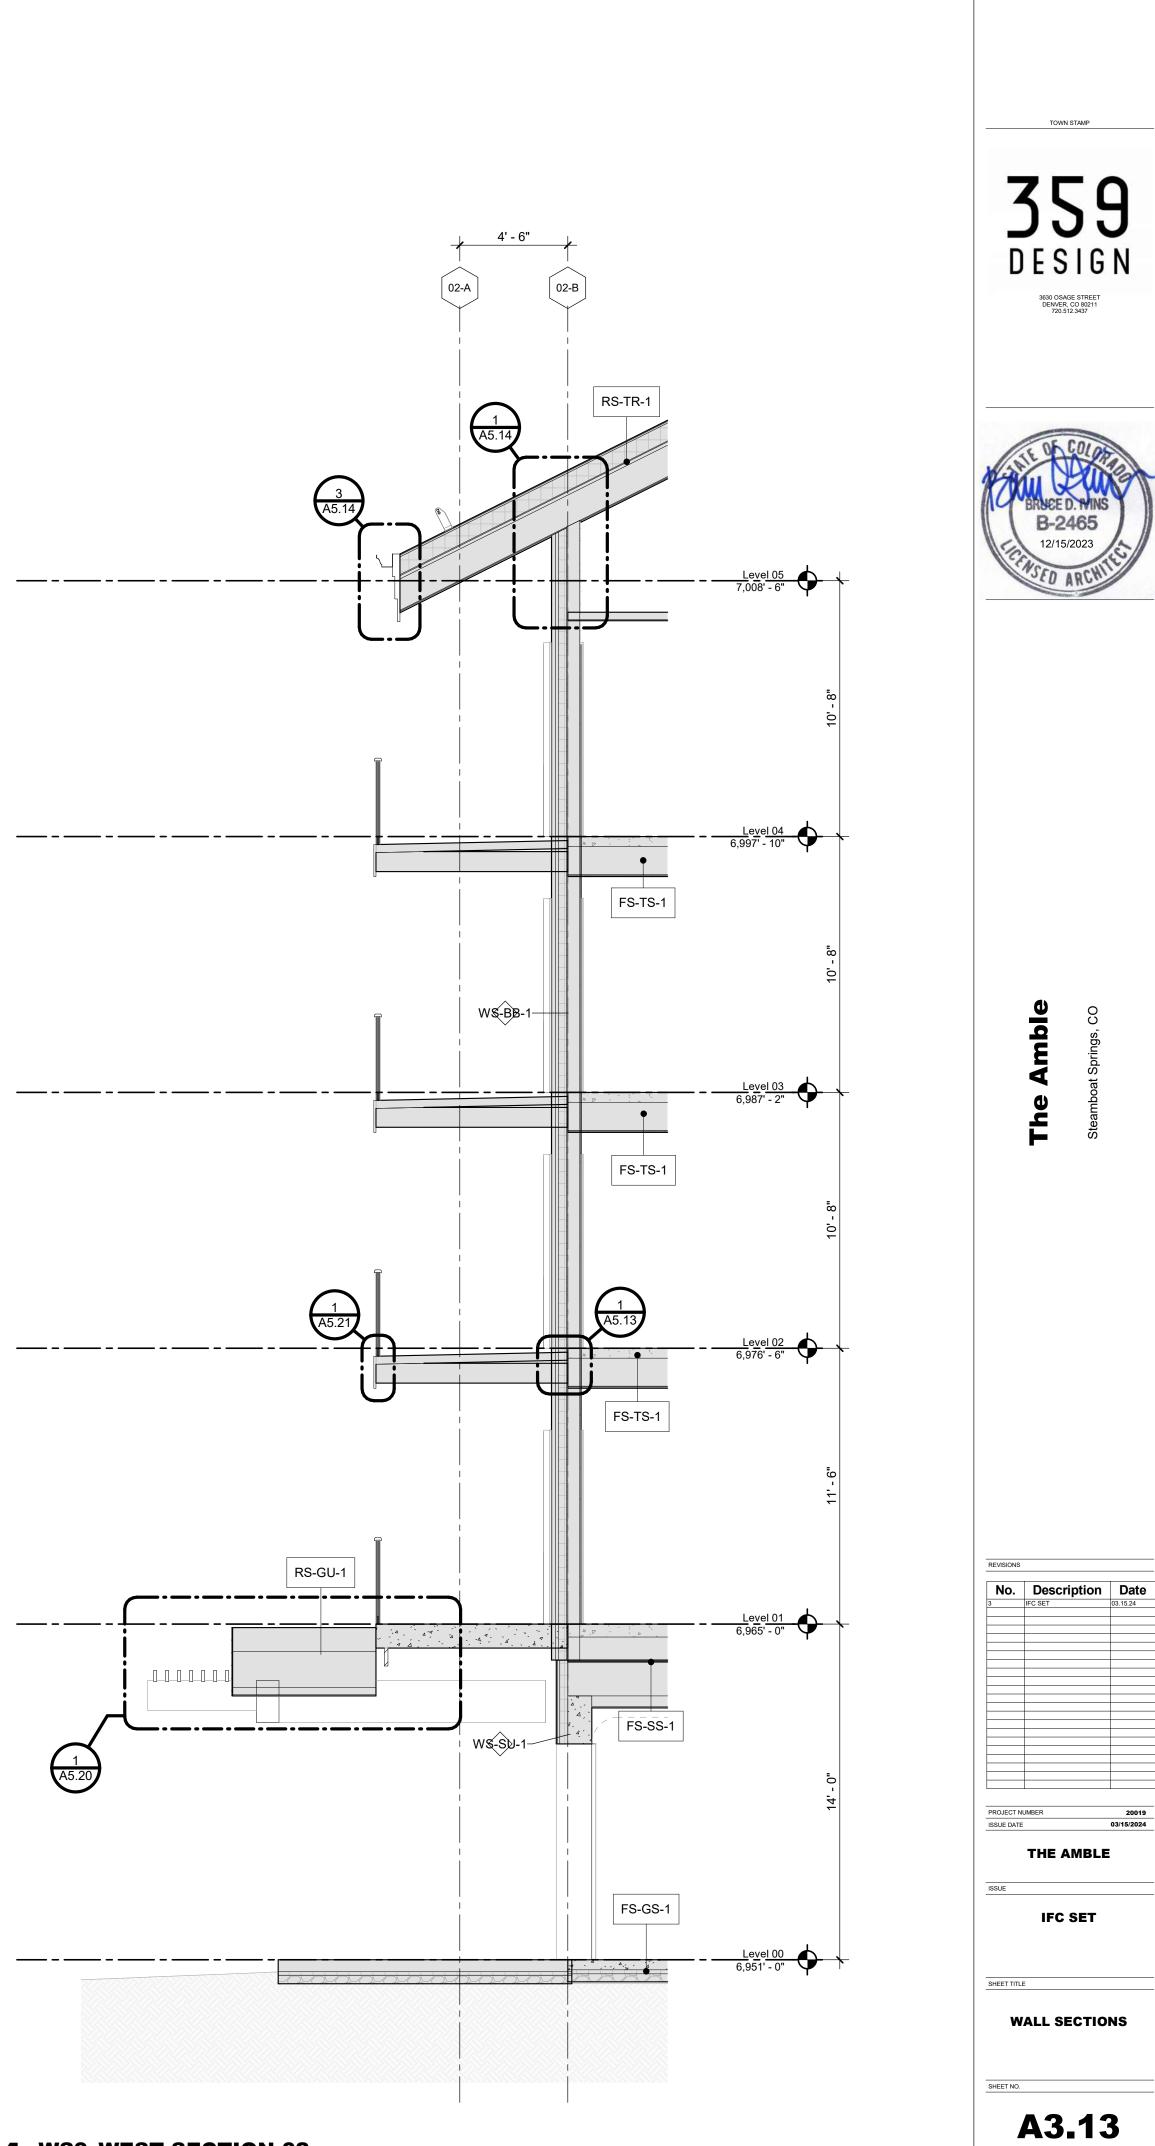


**WS9\_WEST SECTION 02** 1/4" = 1'-0"

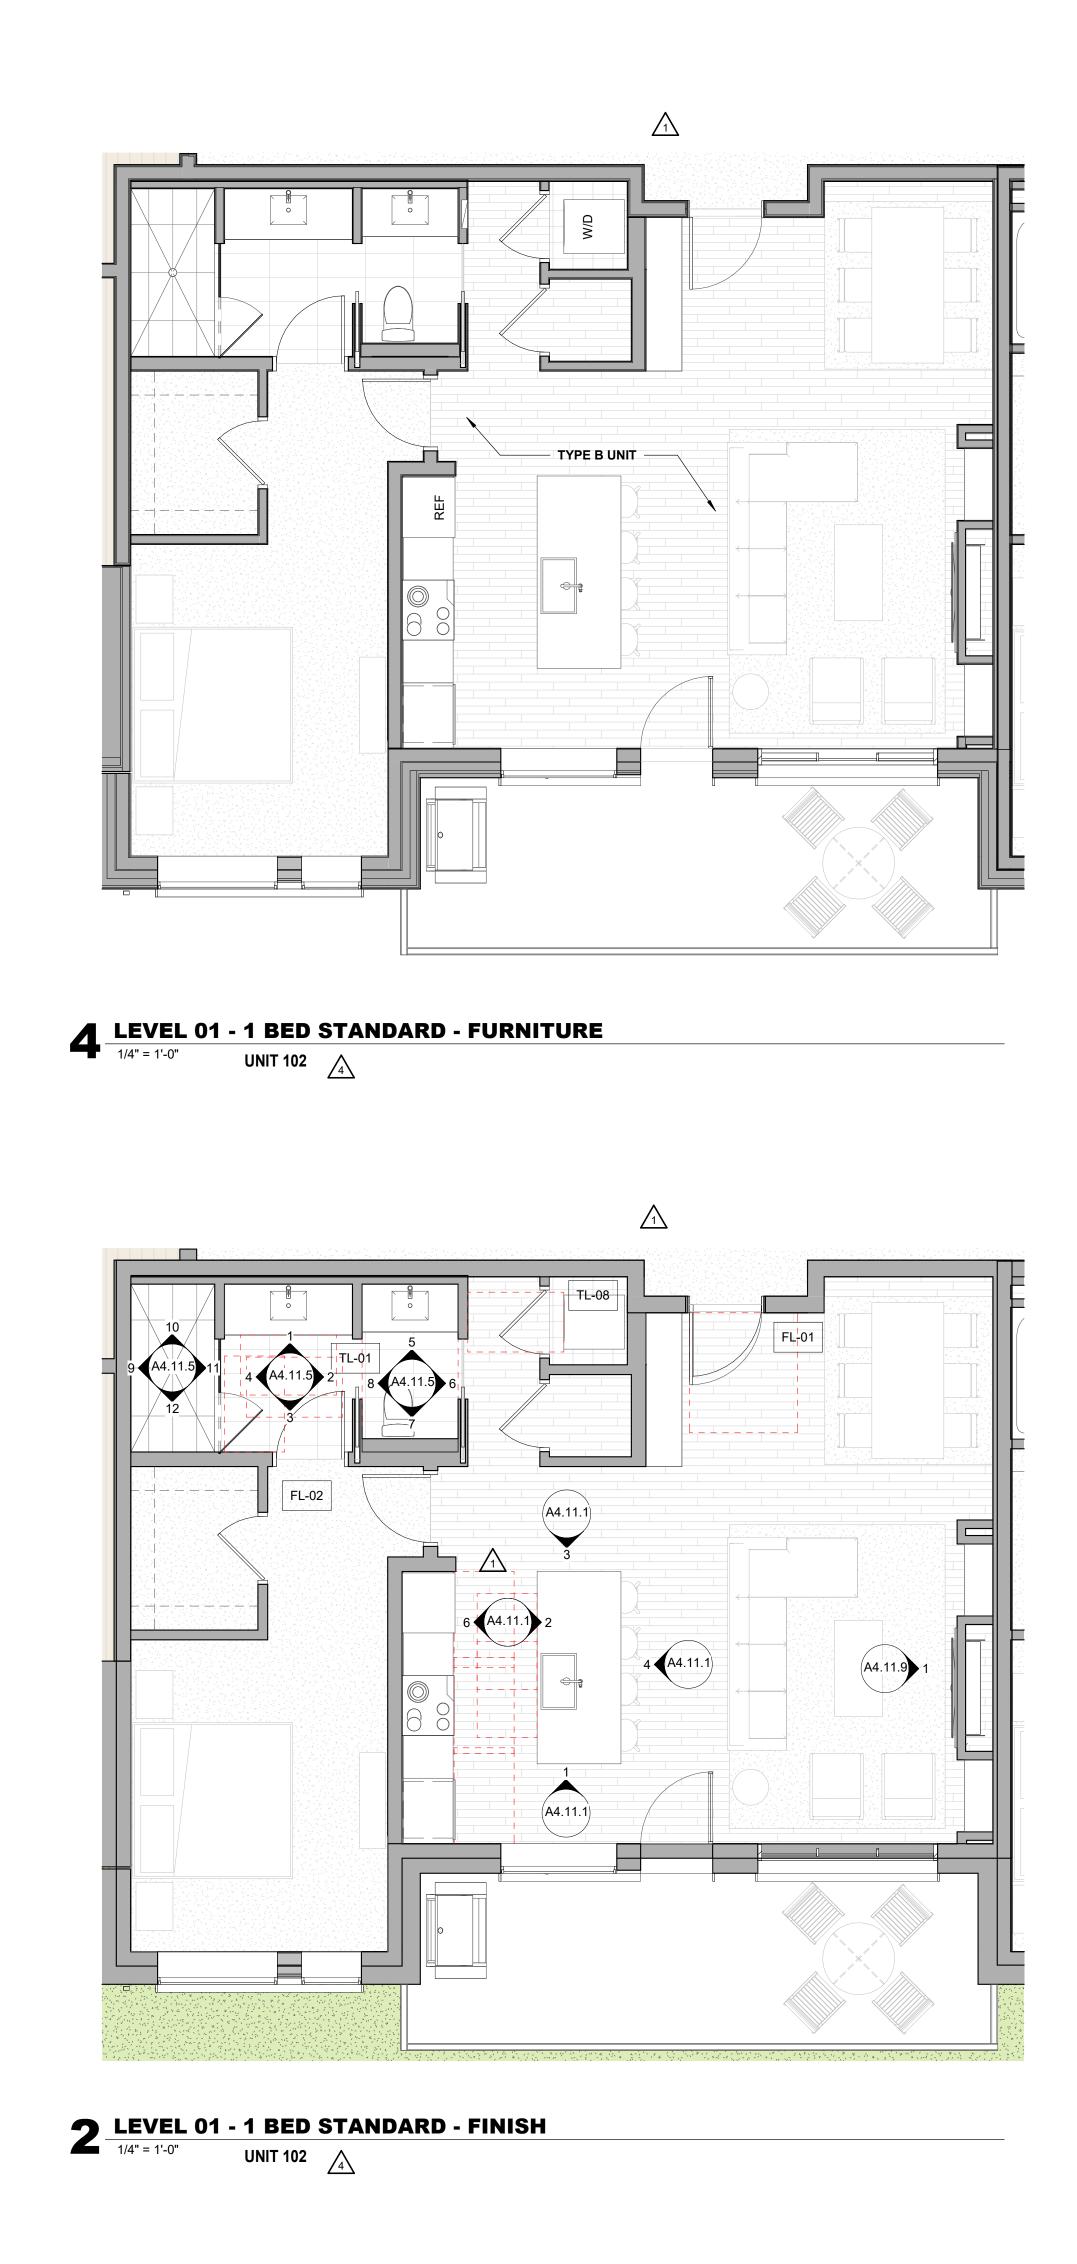

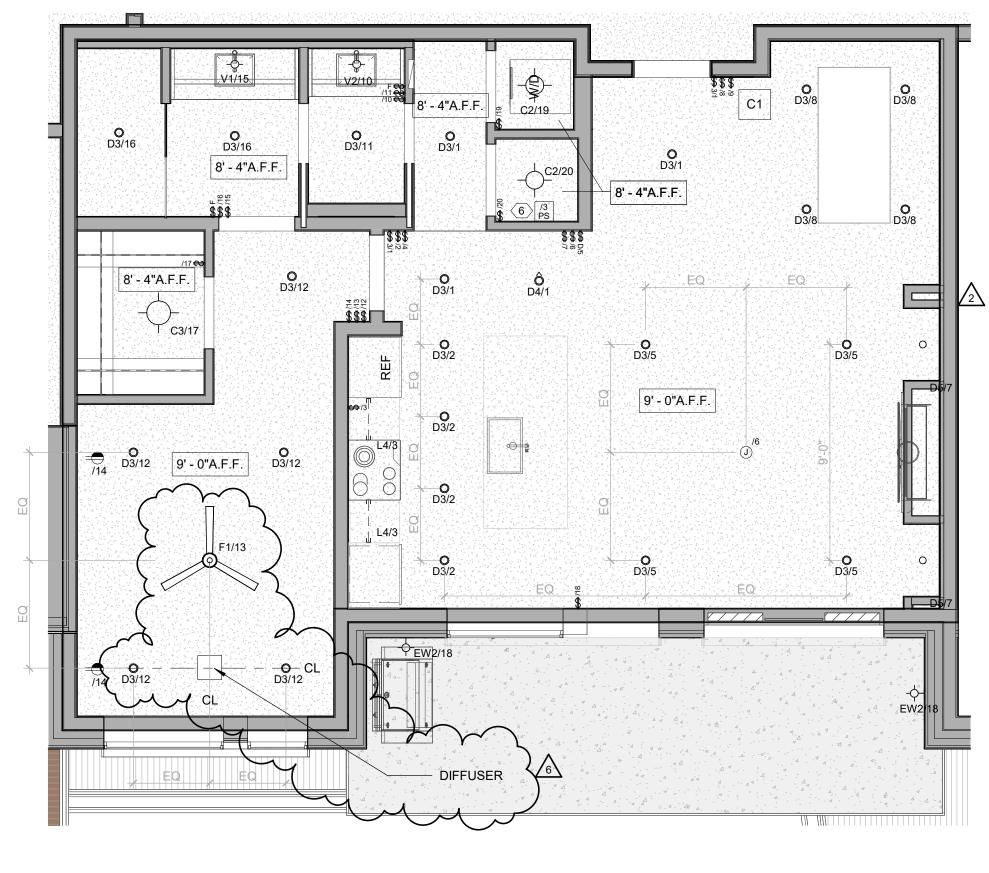



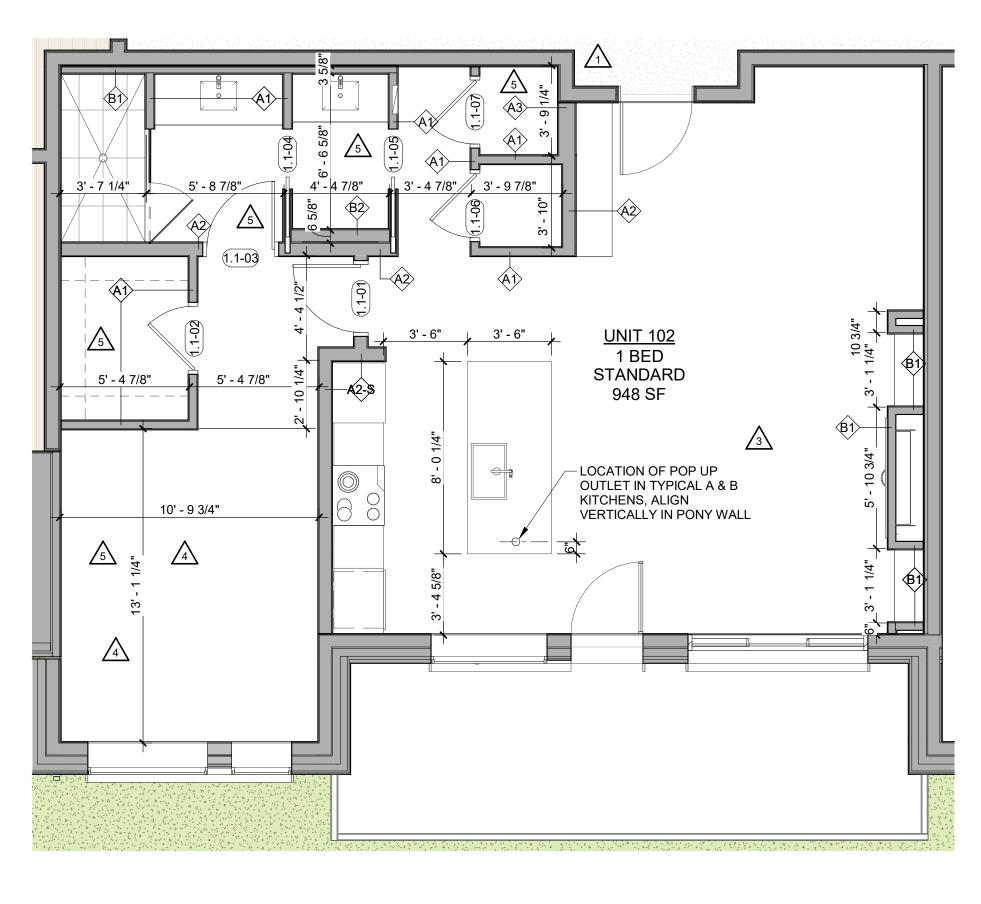

**LEVEL 01 - 1 BED STANDARD - DIMENSION** 

UNIT 102

1/4" = 1'-0"

### ENLARGED FLOOR PLAN - GENERAL NOTES

- 1. REFER TO G0.2X SHEETS FOR EXTERIOR AND INTERIOR BUILDING ENCLOSURE ASSEMBLIES.
- REFER TO A1.0X SHEETS FOR EXTERIOR WALL, DEMISING WALL, AND CORRIDOR WALL TYPES AND LOCATIONS.
   REFER TO A1.1X SHEETS FOR INTERIOR AND EXTERIOR WINDOW/DOOR TAGS WITH UNIT BACKGROUNDS FOR
- REFERENCE. 4. ALIGN WALLS WHERE THEY APPEAR TO ALIGN, U.N.O.
- 5. THE INSIDE FACE OF DOOR JAMBS SHALL BE 4" FROM ADJACENT WALL OR FINISHED COLUMN, U.N.O.
- B. PROVIDE BLOCKING FOR ALL WALL MOUNTED EQUIPMENT AND ACCESSORIES.
- THE CENTERLINE OF ALL RESIDENTIAL TOILETS SHALL BE
- LOCATED 18" OFF OF FINISH FACE OF WALL, U.N.O. SWING CLEARANCE AT UNIT ENTRY SHALL BE 18" MIN.
- FROM FINISH FACE OF ADJACENT SURFACE. ALL DIMENSIONS ARE TO FACE OF STUD, GRID LINE, OR FACE OF CONCRETE, U.N.O.
- 10. WHERE "CLEAR" IS CALLED OUT ON A DIMENSION, PROVIDE DIMENSION FROM FACE OF FINISH TO FACE OF FINISH.
- FURNITURE IS NOT IN CONTRACT, U.N.O., AND IS SHOWN FOR DIAGRAMATIC PURPOSES ONLY.
   CONSULTANT MODELS SHOWN FOR REFERENCE ONLY.

### ENLARGED FLOOR PLAN - LEGEND

	CARPET RE: FINISH SCHED.		RUBBER (F7) RE LANDSCAPE
	TILE RE: FINISH SCHED.		CONCRETE (F8) RE: LANDSCAPE
	WOOD - UNIT RE: FINISH SCHED.		<b>PAVERS (F9)</b> RE: LANDSCAPE
	WOOD - PUBLIC RE: FINISH SCHED.		
4 - 4 	POLISHED CONC. (F5.1) INTERIOR		
	SEALED CONC. (F5.2) INTERIOR		
	HERRINGBONE TILE (F6) RE: FINISH SCHED.		
ENI	ARGED FLOOR PLAN - (	CLEARA	NCE NOTES
	FLOOR CLEARANCE		
Α	DOOR CLEARANCE, 54" X	60"	
В	APPLIANCE CLEARANCE,	30" X 48"	
С	CLEAR FLOOR CLEARANC	E, 30" X	48"


- D VANITY CLEARANCE, 30" X 48"
- E TOILET CLEARANCE, 48" X 56" OR ADA 60" X 56"
- F SHOWER/TUB CLEARANCE, 30" X 48" (B)
- G TURN AROUND CLEARANCE
- GRAB BAR BLOCKING REQ. AT TOILET WALL WHERE APPLICABLE

### ENLARGED RCP - GENERAL NOTES

- ALL UNIT CEILINGS SHALL BE 9' 0" A.F.F. U.N.O. REFER TO ENLARGED RCP'S FOR COMMON AREA CEILING HEIGHTS.
   IN THE CASE OF MINOR DISCREPANCIES BETWEEN MEP
- AND ARCHITECTURAL DOCUMENTS ON THE LOCATION OF CEILING MOUNTED COMPONENTS, THE ARCHITECTURAL RCP'S GOVERN. IN THE CASE OF MAJOR DISCREPANCIES, THE ARCHITECT SHALL BE NOTIFIED AS SOON AS THE DISCREPANCY IS DISCOVERED PRIOR TO PROCEEDING WITH THE WORK.
- 3. REFERENCE MECHANICAL AND ELECTRICAL DRAWINGS FOR MOUNTING LOCATIONS OF ITEMS WHERE NO CEILING IS REQUIRED OR INDICATED.
- 4. COORDINATE ALL TRADES INVOLVED IN THE CEILING WORK TO ENSURE CLEARANCE FOR FIXTURES, DUCTS, PIPING, CEILING SUSPENSION SYSTEMS, ETC. NECESSARY TO MAINTAIN CEILING HEIGHTS NOTED.
- LIGHTS, DIFFUSERS, EXIT SIGNS, SMOKE DETECTORS, SPEAKERS, STROBES, AND MISC. DEVICES SHALL BE CENTERED IN THE CEILING WHERE THEY OCCUR, U.N.O.
   FIRE PROTECTION SCOPE SHALL BE DESIGN-BUILD. ALL
- CORRIDOR SPRINKLER HEADS SHALL BE ALIGNED IN THE SAME LOCATION PARALLEL TO THE WALL WITHIN EACH SPECIFIC CEILING CONSTRUCTION.
- 7. SMOKE ALARMS SHALL BE PROVIDED IN ALL BEDROOMS, OUTSIDE OF ALL BEDROOMS, AND ON EACH FLOOR AS REQUIRED. CARBON MONOXIDE DETECTORS SHALL BE INSTALLED OUTSIDE OF ALL BEDROOMS. SMOKE ALARMS AND CO DETECTORS SHALL BE HARDWIRED AND HAVE BATTERY BACKUP.
- 8. ACCESS DOOR LOCATIONS IN GYPSUM BOARD CEILINGS ARE INDICATED ON RCP'S ONLY WHERE ARCHITECTURALLY SIGNIFICANT. REFERENCE SPECIFICATIONS AND MEP DRAWINGS FOR OTHER ACCESS DOOR LOCATIONS.
- 9. UNLESS PREFINISHED TO MATCH ADJACENT SURFACE, PAINT MECHANICAL GRILLS, DIFFUSERS, ACCESS PANELS, AND OTHER EQUIPMENT TO MATCH ADJACENT SURFACE.
   10. EXIT SIGNS ARE SHOWN ON RCP'S ONLY WHERE
- EXIT SIGNS ARE SHOWN ON RCF S ONLY WHERE LOCATIONS ARE ARCHITECTURALLY SIGNIFICANT.
   PROVIDE UL-CLASSIFIED LIGHT FIXTURES OR ENCLOSURES IN RATED FLOOR/CEILING ASSEMBLIES IN
- ACCORDANCE WITH IBC CHAPTER 7. 12. REFER TO LIGHTING PLANS FOR EXACT FIXTURE TYPES AND LOCATIONS. FIXTURES SHOWN HERE ARE
- REFERENCED AND SHOWN FOR GENERAL ALIGNMENT.


(	<b>GWB (C1)</b> INTERIOR	$\rightarrow$	SLOPE CEILING AS NOTED
	T&G CEILING (C2) INTERIOR	0	CEILING MOUNTED LIGHT FIXTURE
	FIBER-CEMENT SOFFIT (C3) - EXTERIOR	+ + + + + + + + + + + + + + + + + + + +	VINYL SCRIM CLG - Interior
	ACCESS PANEL		ACCOUSTIC VINYL Tile CLG - Interioi

TOWN STAMP	
BRUCE D. MAR B-2465 12/15/2023	inter a
The Amble Steamboat Springs, CO	
REVISIONS         No.       Description         1       IFC SET         2       RFI #103         4       ASI 004         5       RFI #183         6       RFI #223.1         0       0         1       0         0       0         0       0         0       0         0       0         0       0         0       0         0       0         0 <td< th=""><th>03.15.24 06.14.24 08.07.24 08.02.24 10.16.24 20019 03/15/2024 .E - 1 NDARD -</th></td<>	03.15.24 06.14.24 08.07.24 08.02.24 10.16.24 20019 03/15/2024 .E - 1 NDARD -
SHEET NO.	.1

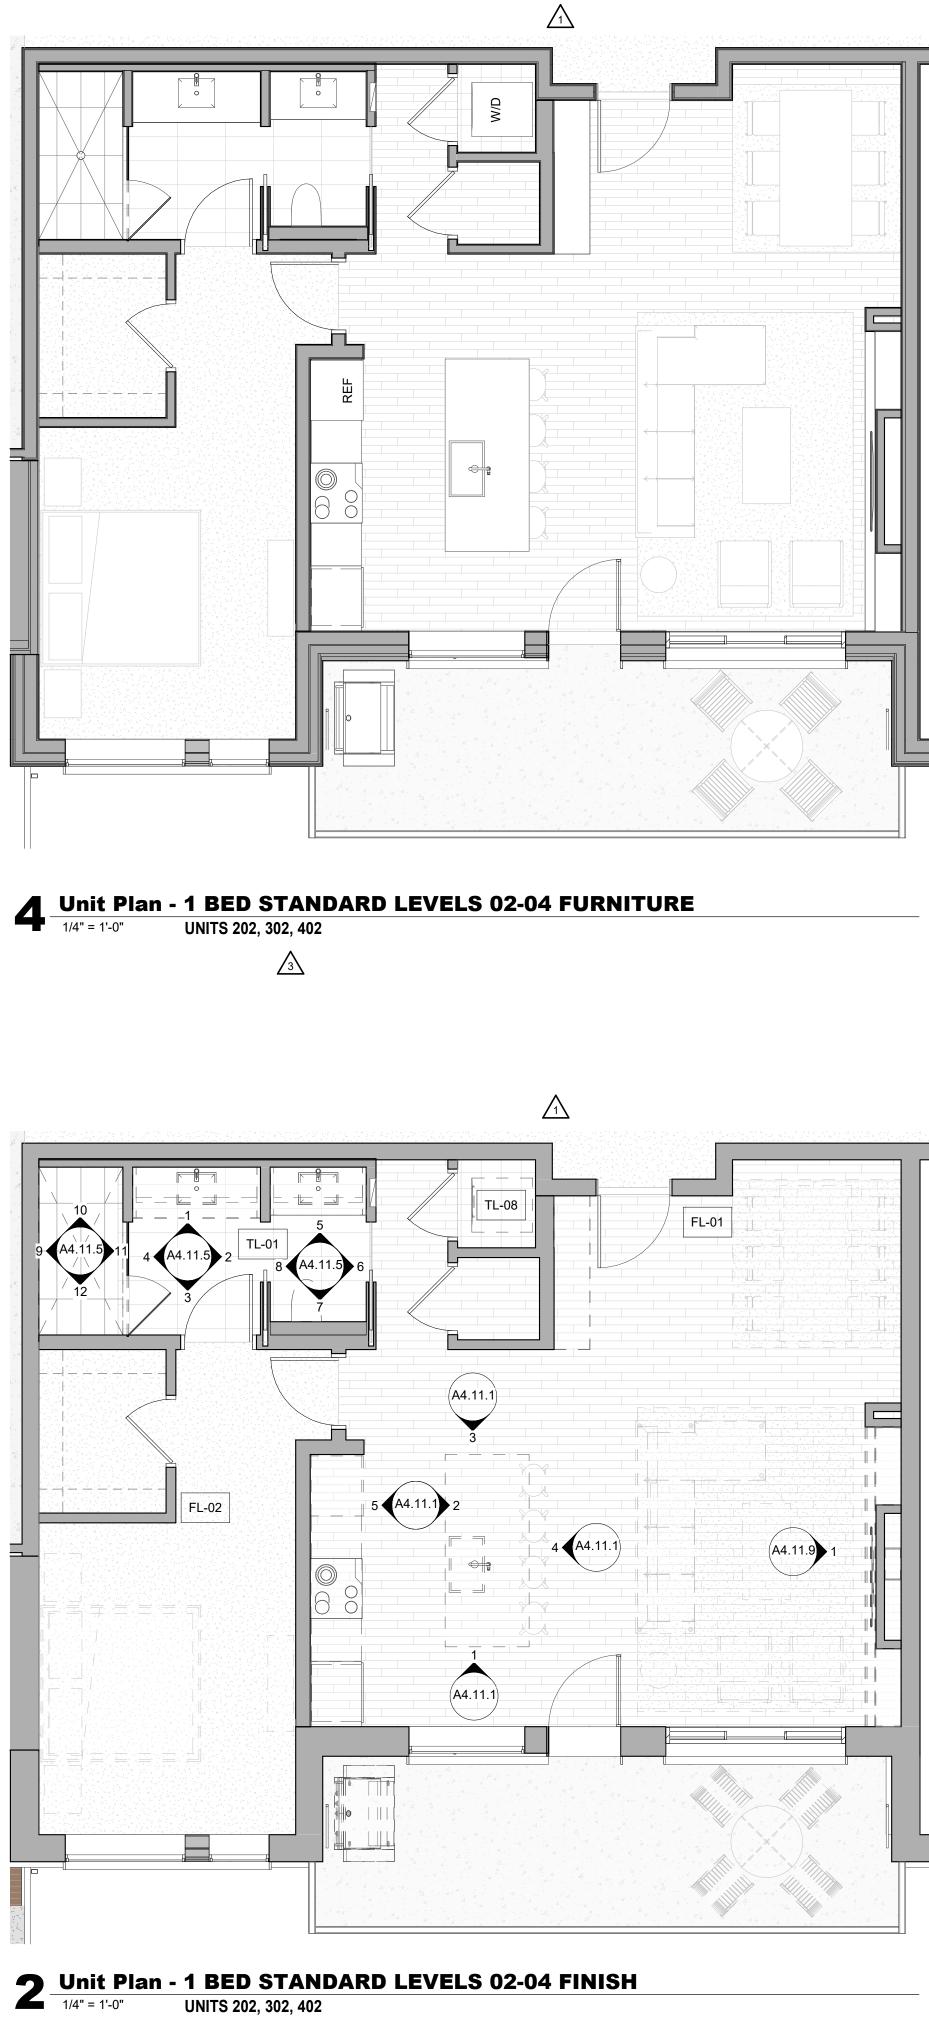



**1** Unit Plan - 1 BED STANDARD LEVELS 02-04 RCP **5** <u>1/4" = 1'-0"</u> UNITS 202, 302, 402  $\sqrt{3}$ 

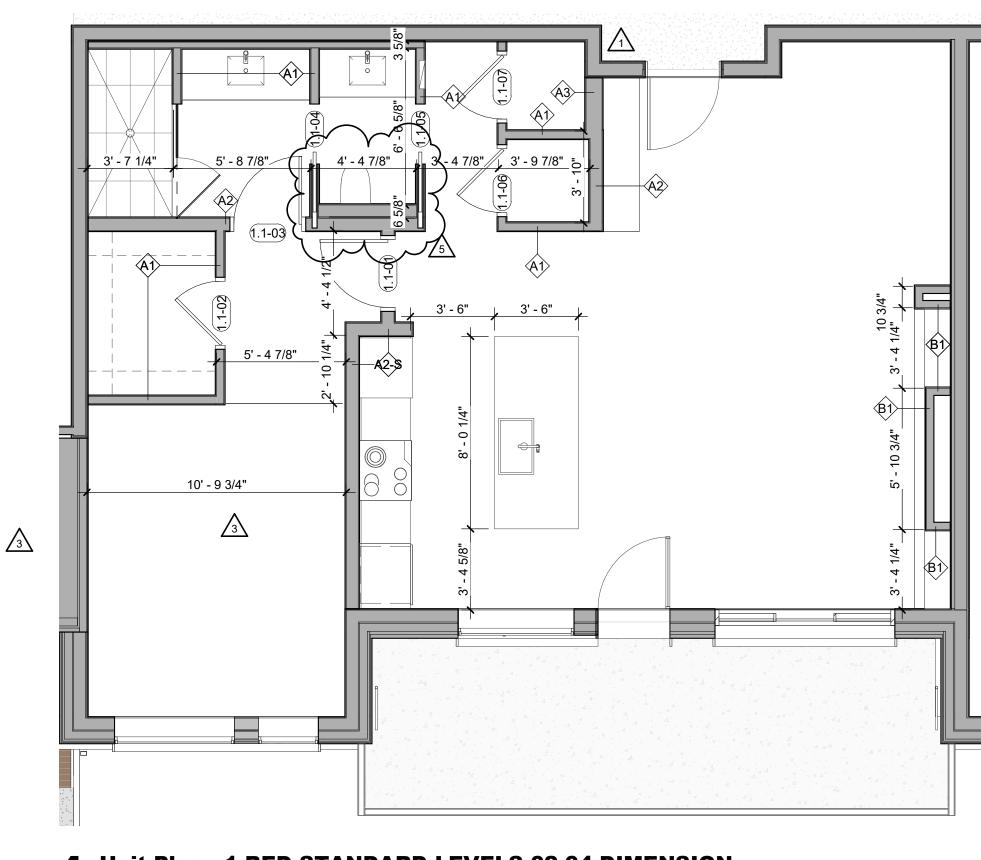


Unit Plan - 1 BED STANDARD LEVELS 02-04 DIMENSION UNITS 202, 302, 402 1/4" = 1'-0"

**ENLARGED FLOOR PLAN - GENERAL NOTES** 

- REFER TO G0.2X SHEETS FOR EXTERIOR AND INTERIOR BUILDING ENCLOSURE ASSEMBLIES.
- REFER TO A1.0X SHEETS FOR EXTERIOR WALL, DEMISING WALL, AND CORRIDOR WALL TYPES AND LOCATIONS. REFER TO A1.1X SHEETS FOR INTERIOR AND EXTERIOR
- WINDOW/DOOR TAGS WITH UNIT BACKGROUNDS FOR REFERENCE. ALIGN WALLS WHERE THEY APPEAR TO ALIGN, U.N.O.
- THE INSIDE FACE OF DOOR JAMBS SHALL BE 4" FROM ADJACENT WALL OR FINISHED COLUMN, U.N.O.
- PROVIDE BLOCKING FOR ALL WALL MOUNTED EQUIPMENT AND ACCESSORIES.
- THE CENTERLINE OF ALL RESIDENTIAL TOILETS SHALL BE
- LOCATED 18" OFF OF FINISH FACE OF WALL, U.N.O. SWING CLEARANCE AT UNIT ENTRY SHALL BE 18" MIN.
- FROM FINISH FACE OF ADJACENT SURFACE. ALL DIMENSIONS ARE TO FACE OF STUD, GRID LINE, OR
- FACE OF CONCRETE, U.N.O. 10. WHERE "CLEAR" IS CALLED OUT ON A DIMENSION, PROVIDE DIMENSION FROM FACE OF FINISH TO FACE OF
- FINISH 11. FURNITURE IS NOT IN CONTRACT, U.N.O., AND IS SHOWN
- FOR DIAGRAMATIC PURPOSES ONLY. 12. CONSULTANT MODELS SHOWN FOR REFERENCE ONLY.

### ENLARGED FLOOR PLAN - LEGEND

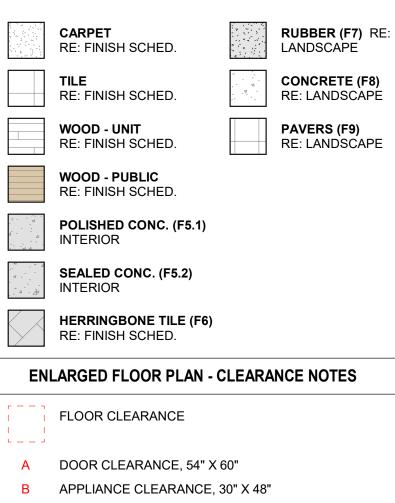

- C CLEAR FLOOR CLEARANCE, 30" X 48"
- D VANITY CLEARANCE, 30" X 48"
- E TOILET CLEARANCE, 48" X 56" OR ADA 60" X 56"
- F SHOWER/TUB CLEARANCE, 30" X 48" (B)
- G TURN AROUND CLEARANCE

WALL WHERE APPLICABLE


GRAB BAR BLOCKING REQ. AT TOILET


### ENLARGED RCP - GENERAL NOTES

- ALL UNIT CEILINGS SHALL BE 9' 0" A.F.F. U.N.O. REFER TO ENLARGED RCP'S FOR COMMON AREA CEILING HEIGHTS.
- IN THE CASE OF MINOR DISCREPANCIES BETWEEN MEP AND ARCHITECTURAL DOCUMENTS ON THE LOCATION OF CEILING MOUNTED COMPONENTS, THE ARCHITECTURAL RCP'S GOVERN. IN THE CASE OF MAJOR DISCREPANCIES, THE ARCHITECT SHALL BE NOTIFIED AS SOON AS THE DISCREPANCY IS DISCOVERED PRIOR TO PROCEEDING WITH THE WORK.
- REFERENCE MECHANICAL AND ELECTRICAL DRAWINGS FOR MOUNTING LOCATIONS OF ITEMS WHERE NO CEILING IS REQUIRED OR INDICATED.
- COORDINATE ALL TRADES INVOLVED IN THE CEILING WORK TO ENSURE CLEARANCE FOR FIXTURES, DUCTS, PIPING, CEILING SUSPENSION SYSTEMS, ETC. NECESSARY TO MAINTAIN CEILING HEIGHTS NOTED.
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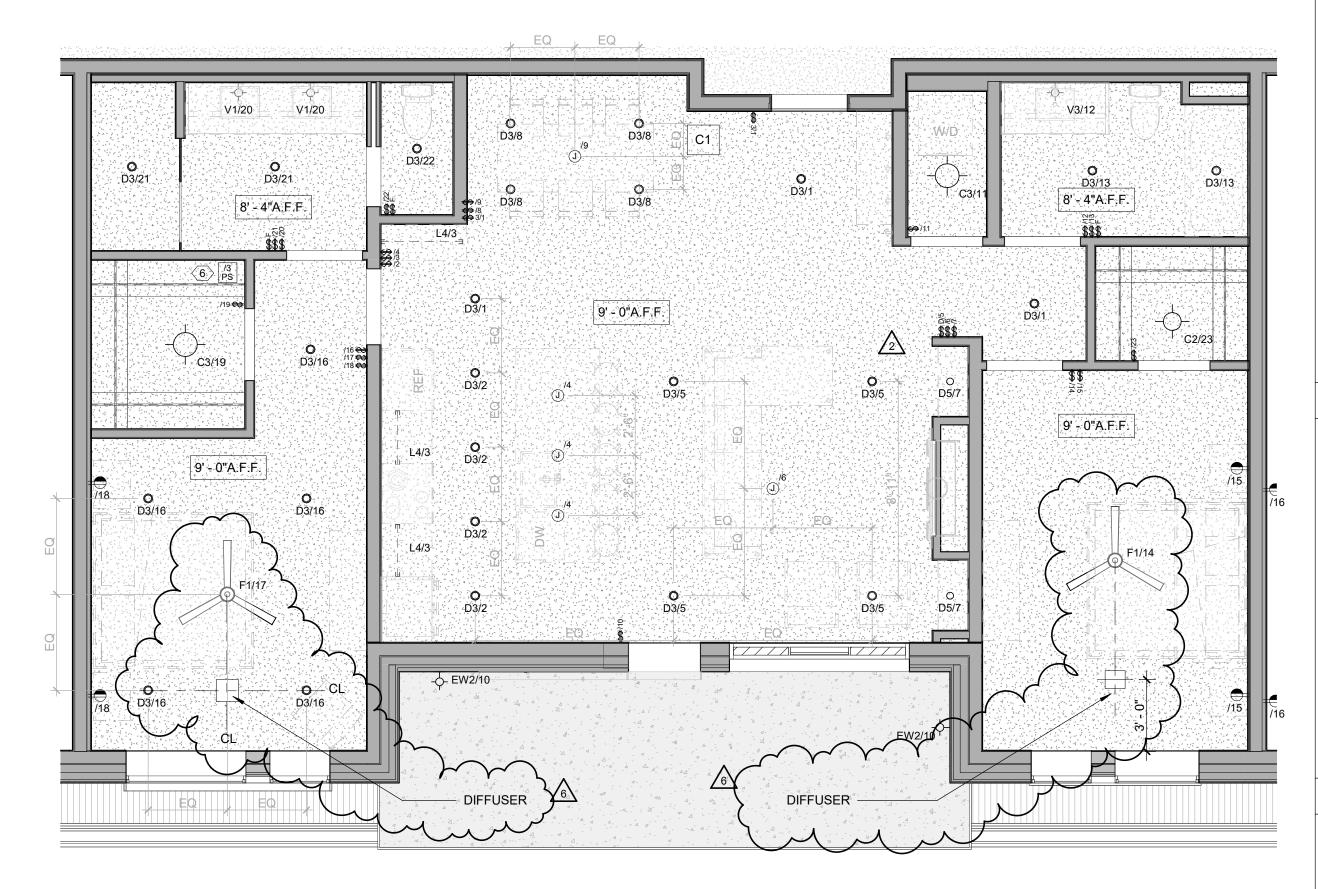
$\begin{array}{cccccccccccccccccccccccccccccccccccc$	<b>GWB (C1)</b> INTERIOR	$\rightarrow$	SLOPE CEILING AS NOTED
	T&G CEILING (C2) INTERIOR	0	CEILING MOUNTED LIGHT FIXTURE
	FIBER-CEMENT SOFFIT (C3) - EXTERIOR	+ + + + + + + + + + + + + + + + + + + +	VINYL SCRIM CLG - Interior
	ACCESS PANEL		ACOUSTIC VINYL Tile CLG - Interiof


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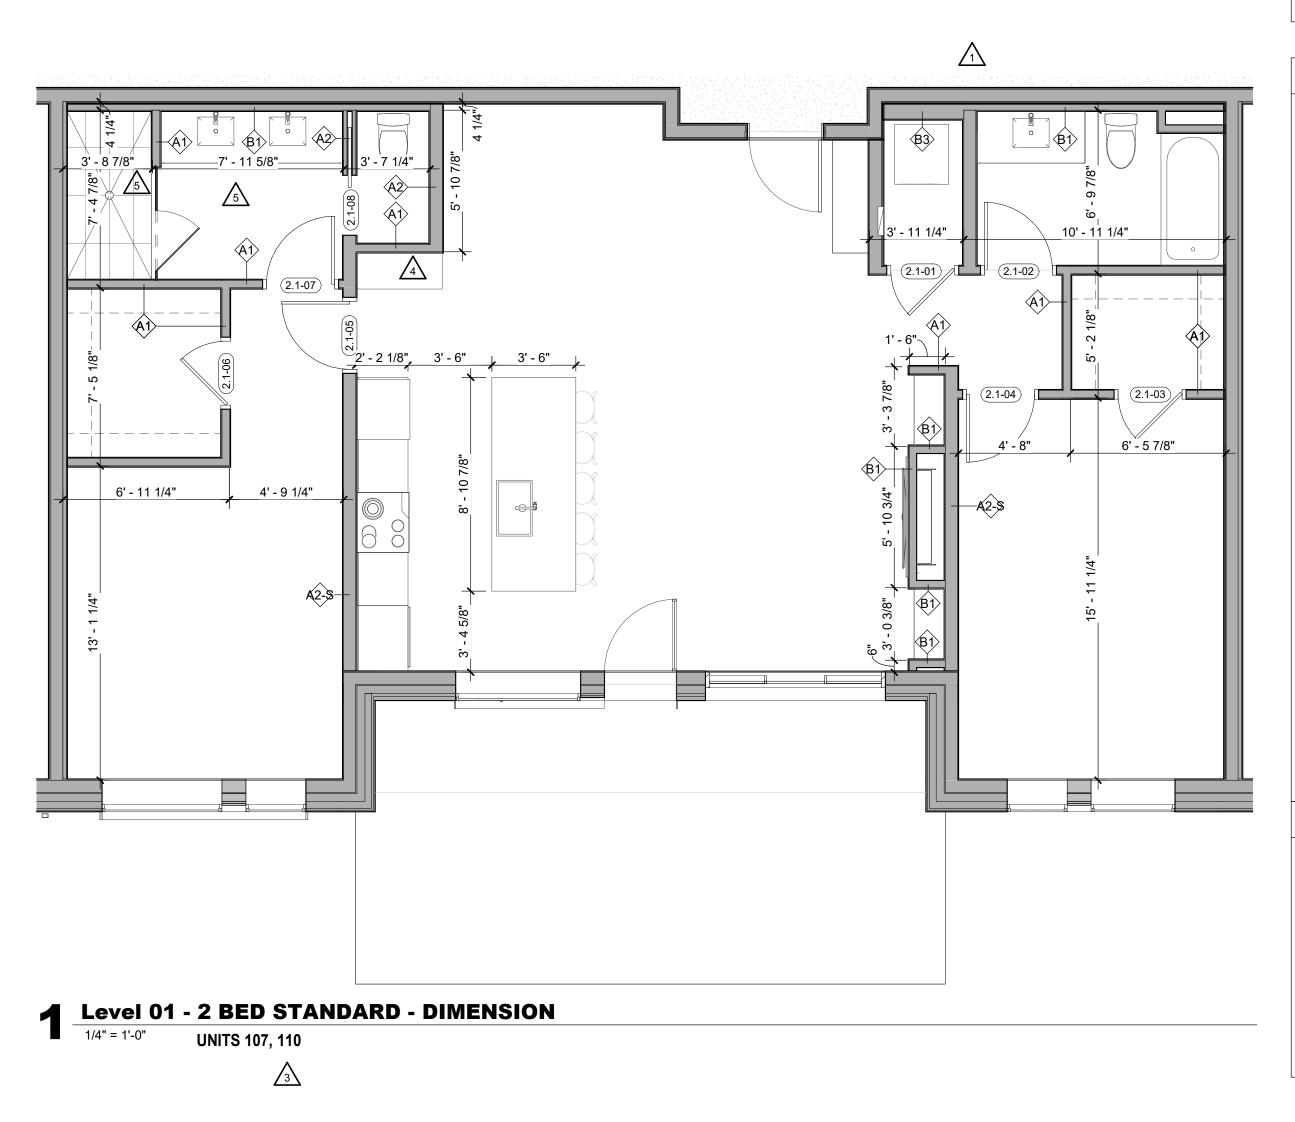


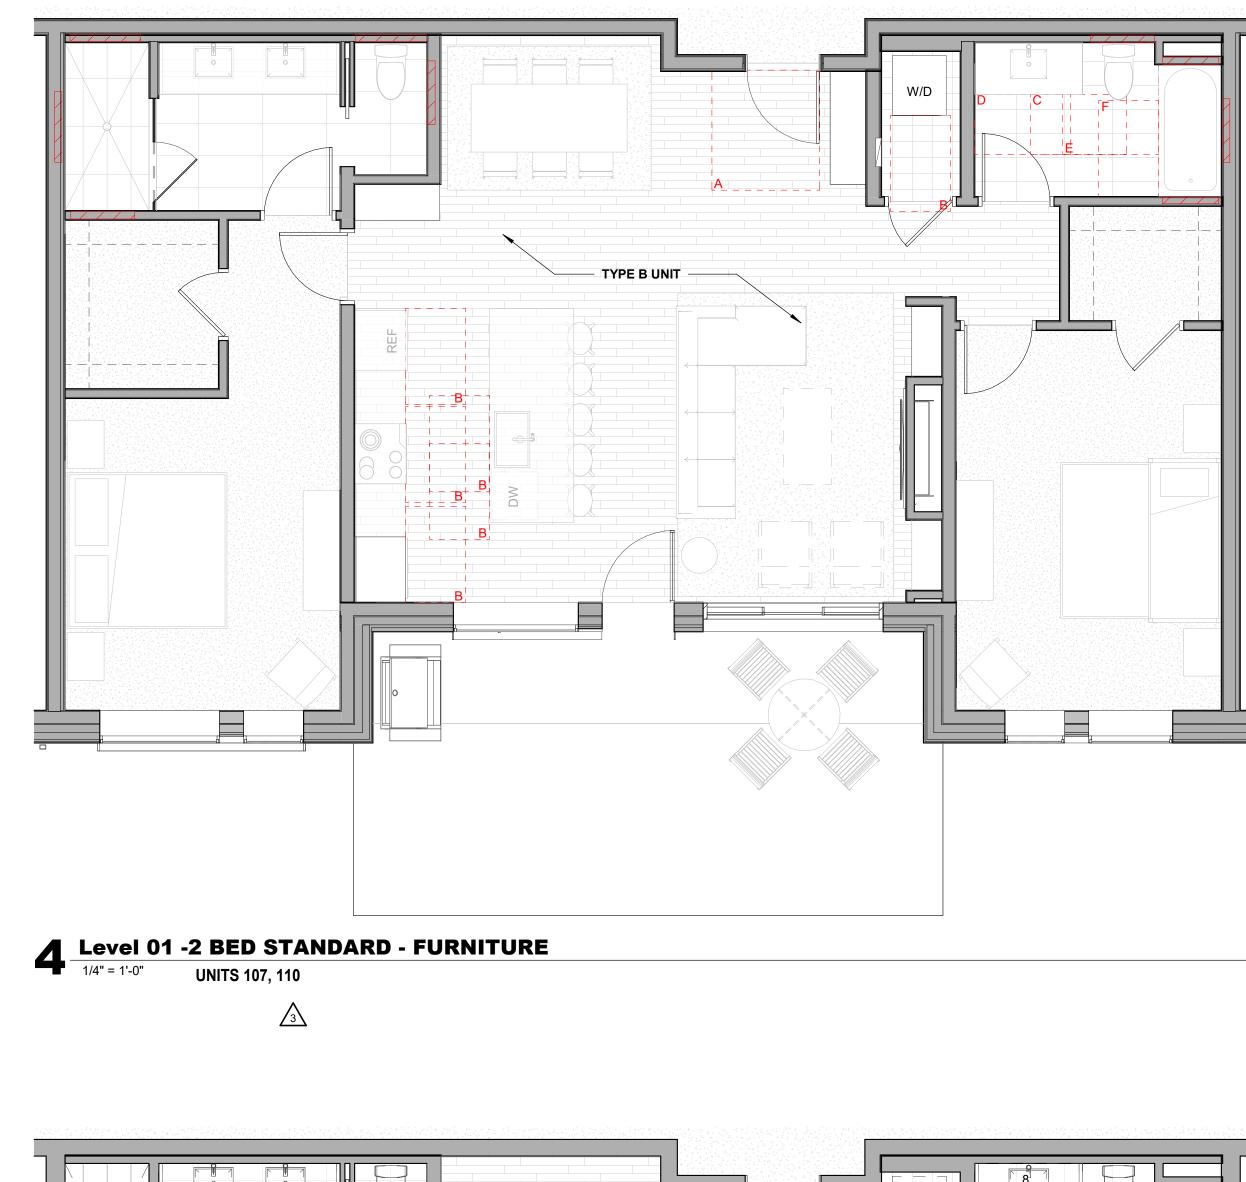

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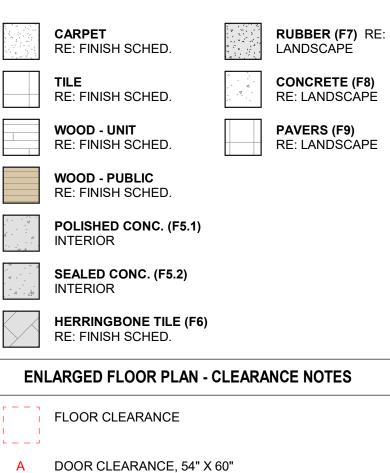


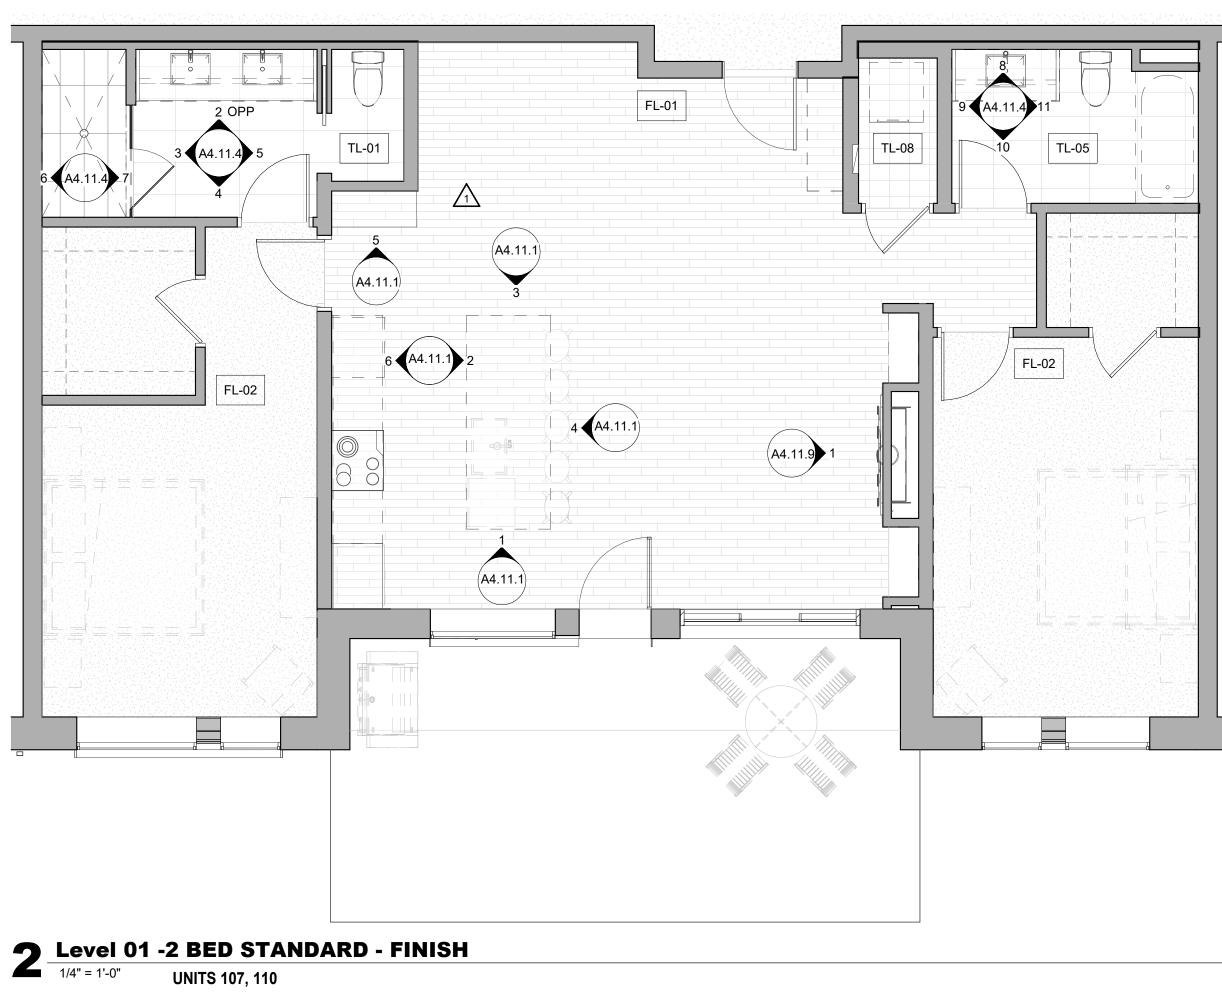

### **ENLARGED FLOOR PLAN - GENERAL NOTES**
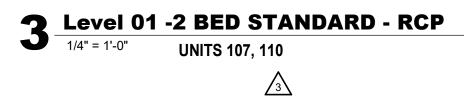
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- BUILDING ENCLOSURE ASSEMBLIES. REFER TO A1.0X SHEETS FOR EXTERIOR WALL, DEMISING
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### ENLARGED FLOOR PLAN - LEGEND




- B APPLIANCE CLEARANCE, 30" X 48"
- C CLEAR FLOOR CLEARANCE, 30" X 48"
- D VANITY CLEARANCE, 30" X 48"
- E TOILET CLEARANCE, 48" X 56" OR ADA 60" X 56"
- F SHOWER/TUB CLEARANCE, 30" X 48" (B)
- G TURN AROUND CLEARANCE
- GRAB BAR BLOCKING REQ. AT TOILET WALL WHERE APPLICABLE

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2 Level 01 - 2 BED STANDARD TYPE A-FINISH 1/4" = 1'-0" UNITS 109

**UNITS 109** 


▲ Level 01 - 2 BED STANDARD TYPE A-DIMENSION 1/4" = 1'-0" **UNITS 109** 
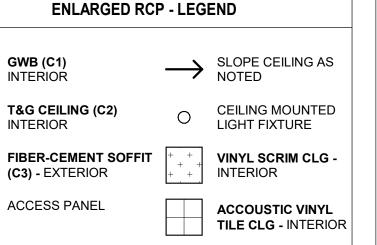
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### **ENLARGED FLOOR PLAN - GENERAL NOTES**

- REFER TO G0.2X SHEETS FOR EXTERIOR AND INTERIOR
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- ALIGN WALLS WHERE THEY APPEAR TO ALIGN, U.N.O. THE INSIDE FACE OF DOOR JAMBS SHALL BE 4" FROM
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- PROVIDE BLOCKING FOR ALL WALL MOUNTED EQUIPMENT AND ACCESSORIES.
- THE CENTERLINE OF ALL RESIDENTIAL TOILETS SHALL BE LOCATED 18" OFF OF FINISH FACE OF WALL, U.N.O.
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- ALL DIMENSIONS ARE TO FACE OF STUD, GRID LINE, OR FACE OF CONCRETE, U.N.O.
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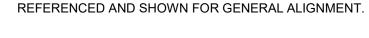
### ENLARGED FLOOR PLAN - LEGEND



- A DOOR CLEARANCE, 54" X 60"
- B APPLIANCE CLEARANCE, 30" X 48"
- C CLEAR FLOOR CLEARANCE, 30" X 48"
- D VANITY CLEARANCE, 30" X 48"
- E TOILET CLEARANCE, 48" X 56" OR ADA 60" X 56"
- F SHOWER/TUB CLEARANCE, 30" X 48" (B)
- G TURN AROUND CLEARANCE
- GRAB BAR BLOCKING REQ. AT TOILET WALL WHERE APPLICABLE
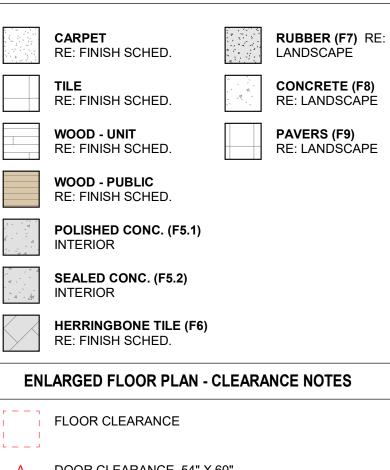
### ENLARGED RCP - GENERAL NOTES


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- SMOKE ALARMS SHALL BE PROVIDED IN ALL BEDROOMS, OUTSIDE OF ALL BEDROOMS, AND ON EACH FLOOR AS REQUIRED. CARBON MONOXIDE DETECTORS SHALL BE INSTALLED OUTSIDE OF ALL BEDROOMS. SMOKE ALARMS AND CO DETECTORS SHALL BE HARDWIRED AND HAVE BATTERY BACKUP.
- ACCESS DOOR LOCATIONS IN GYPSUM BOARD CEILINGS ARE INDICATED ON RCP'S ONLY WHERE ARCHITECTURALLY SIGNIFICANT. REFERENCE SPECIFICATIONS AND MEP DRAWINGS FOR OTHER ACCESS DOOR LOCATIONS.
- UNLESS PREFINISHED TO MATCH ADJACENT SURFACE, PAINT MECHANICAL GRILLS, DIFFUSERS, ACCESS PANELS, AND OTHER EQUIPMENT TO MATCH ADJACENT SURFACE. 10. EXIT SIGNS ARE SHOWN ON RCP'S ONLY WHERE
- LOCATIONS ARE ARCHITECTURALLY SIGNIFICANT. 11. PROVIDE UL-CLASSIFIED LIGHT FIXTURES OR ENCLOSURES IN RATED FLOOR/CEILING ASSEMBLIES IN
- ACCORDANCE WITH IBC CHAPTER 7. 12. REFER TO LIGHTING PLANS FOR EXACT FIXTURE TYPES AND LOCATIONS. FIXTURES SHOWN HERE ARE



- (17) - (17) - (17) - (17) - (17) - (17) - (17)	<b>GWB (C1)</b> INTERIOR	$\rightarrow$	SLOPE CEILING AS NOTED
	<b>T&amp;G CEILING (C2)</b> INTERIOR	0	CEILING MOUNTED LIGHT FIXTURE
	FIBER-CEMENT SOFFIT (C3) - EXTERIOR	+ + + + + +	VINYL SCRIM CLG - INTERIOR
	ACCESS PANEL		ACCOUSTIC VINYL TILE CLG - INTERIO


<b>35</b> DES	stamp <b>599</b> IGN co 80211 i23437
BASEE B-2 12/15	
The Amble	Steamboat Springs, CO
No.         Descr           1         IFC SET           2         RFI #110           3         RFI #110           4         ASI 001           5         ASI 004           6         RFI #219           7         RFI #214	iption Date 03.15.24 06.14.24 06.24.24 07.28.24 08.07.24 08.07.24 08.08.24 08.21.24

No.	Description	Date
1	IFC SET	03.15.24
2	RFI #110	06.14.24
3	RFI #119	06.24.24
4 5	ASI 001 ASI 004	07.26.24 08.07.24
6	RFI #219	08.08.24
7	RFI #214	08.21.24
8	RFI #223.1	10.16.24
	1	
PROJECT N		20019
ISSUE DATE		03/15/2024
IOOOL DATE	-	00/10/2024
ISSUE		
	IFC SET	
SHEET TITL	E	
	UNIT PLAN - ROOM STANI TYPE A	_
	TTPEA	
SHEET NO.		
A	4.02	.2

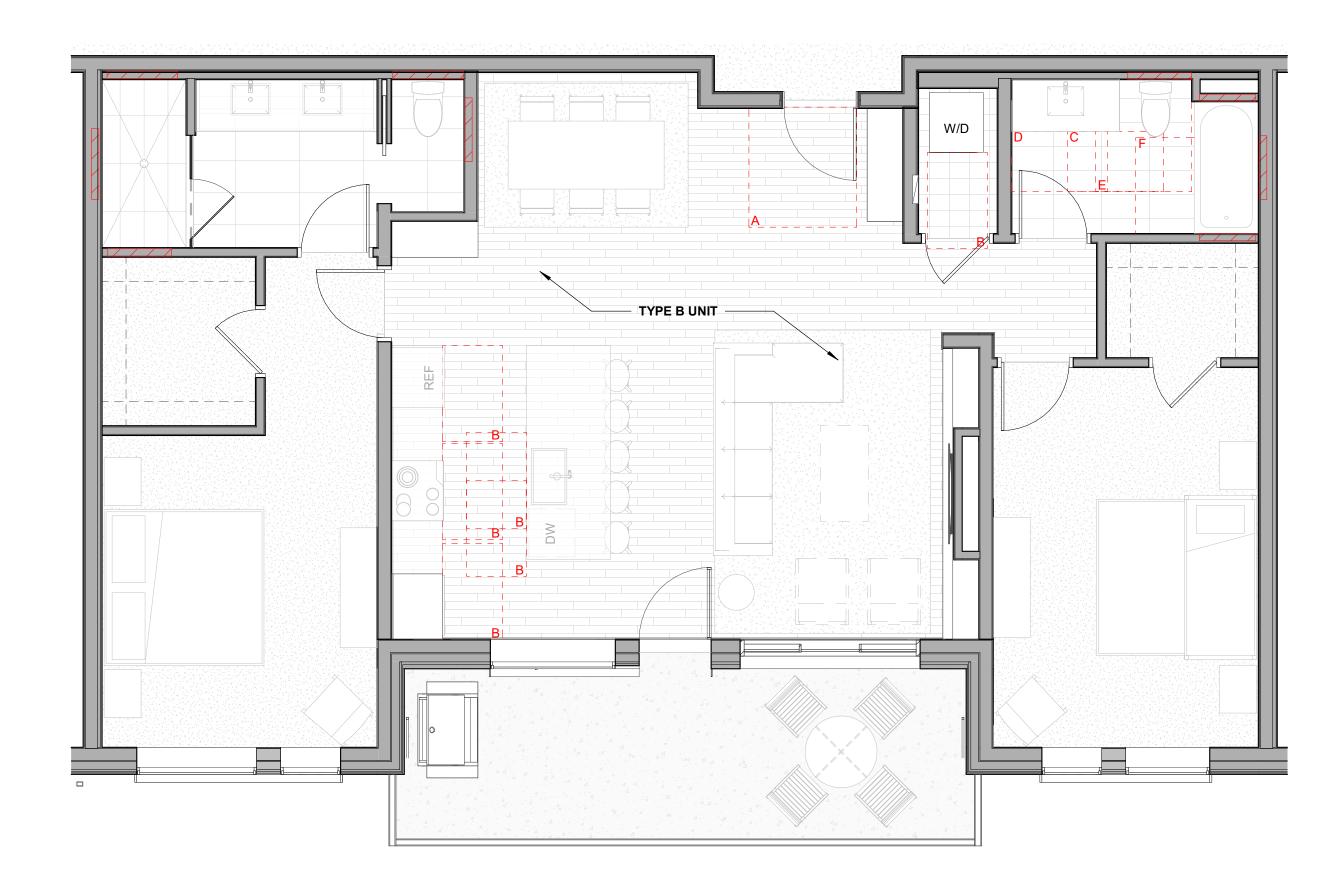

**4** Level 02-03 - 2 BEDROOM STANDARD-FURNITURE


UNITS 207, 210, 307, 310  $\sqrt{3}$ 

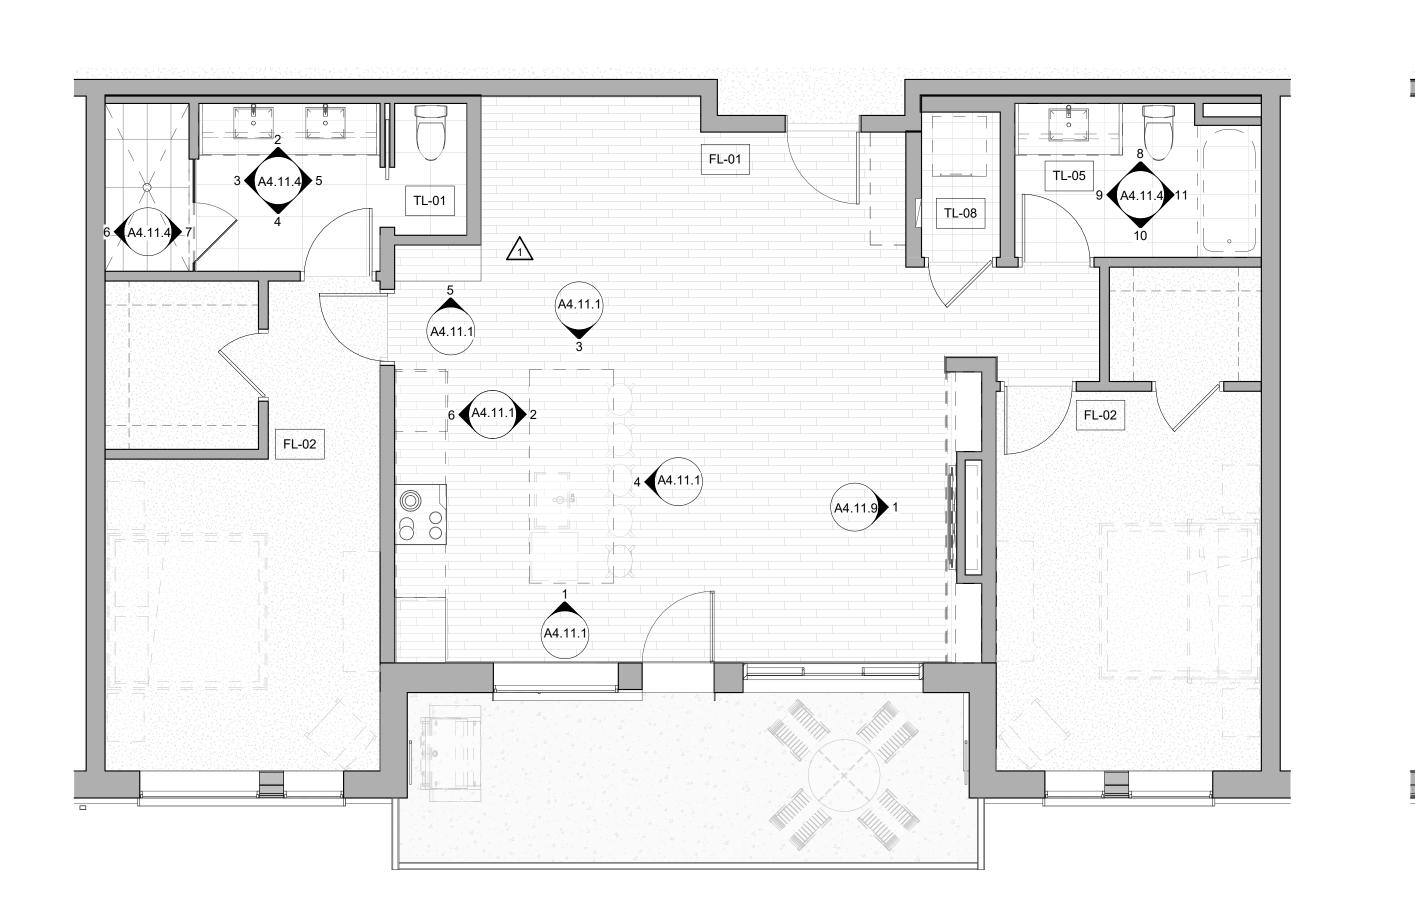


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(A4.11.4)



**3** Level 02-03 - 2 BEDROOM STANDARD-RCP UNITS 207, 210, 307, 310

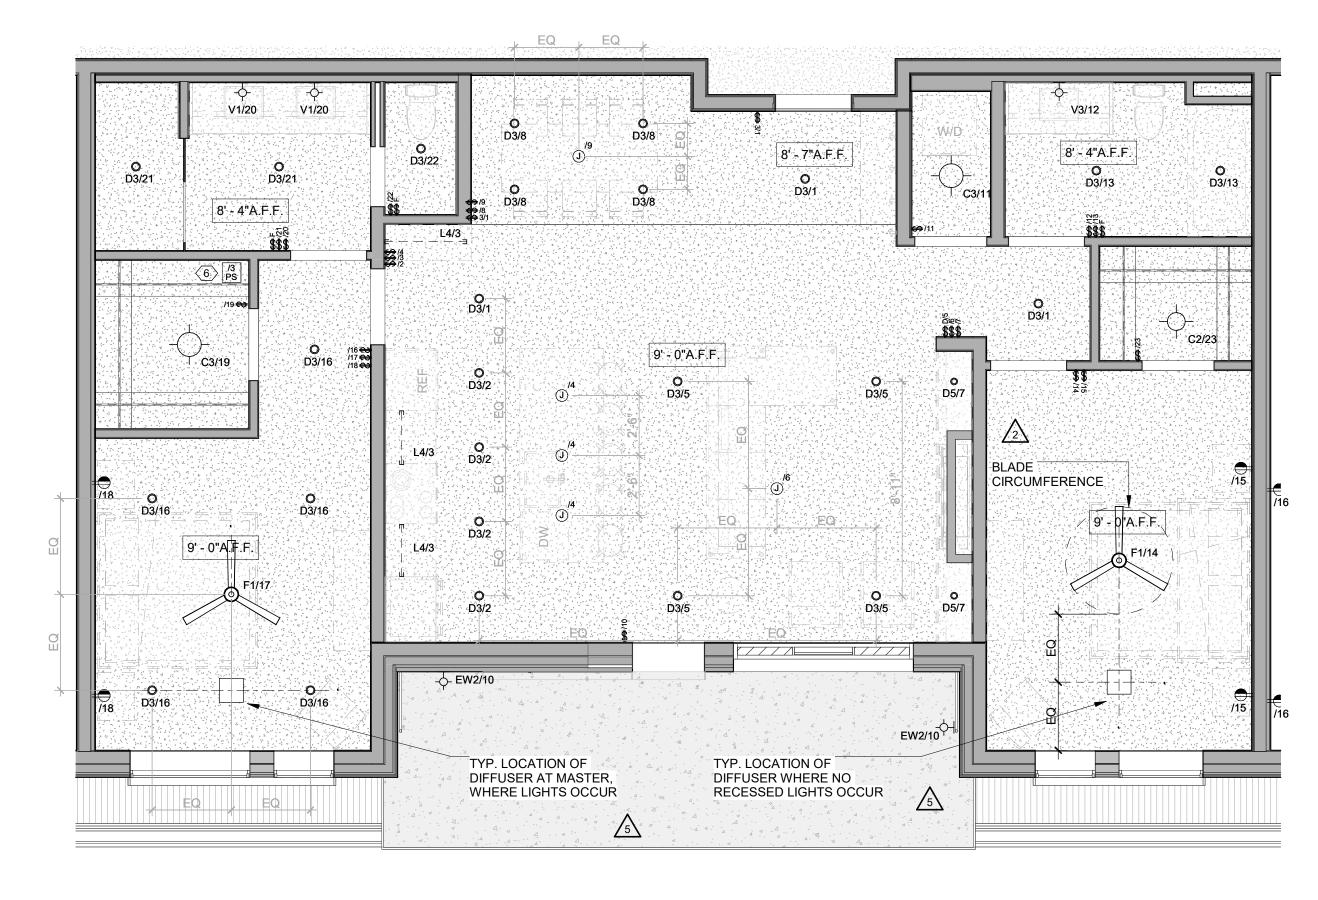

### ENLARGED FLOOR PLAN - GENERAL NOTES

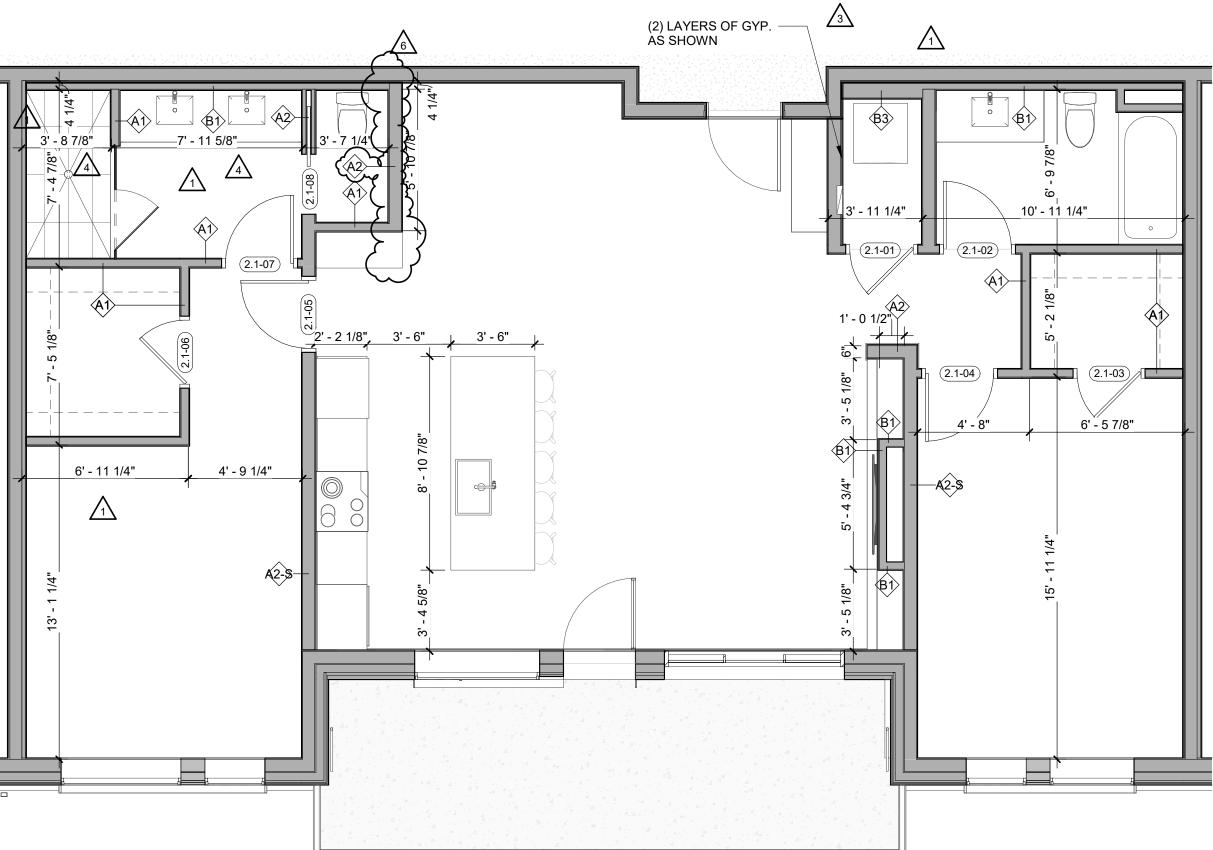- REFER TO G0.2X SHEETS FOR EXTERIOR AND INTERIOR BUILDING ENCLOSURE ASSEMBLIES. REFER TO A1.0X SHEETS FOR EXTERIOR WALL, DEMISING WALL, AND CORRIDOR WALL TYPES AND LOCATIONS.
- REFER TO A1.1X SHEETS FOR INTERIOR AND EXTERIOR WINDOW/DOOR TAGS WITH UNIT BACKGROUNDS FOR REFERENCE.
- ALIGN WALLS WHERE THEY APPEAR TO ALIGN, U.N.O. THE INSIDE FACE OF DOOR JAMBS SHALL BE 4" FROM ADJACENT WALL OR FINISHED COLUMN, U.N.O.
- PROVIDE BLOCKING FOR ALL WALL MOUNTED EQUIPMENT AND ACCESSORIES.
- THE CENTERLINE OF ALL RESIDENTIAL TOILETS SHALL BE LOCATED 18" OFF OF FINISH FACE OF WALL, U.N.O.
- SWING CLEARANCE AT UNIT ENTRY SHALL BE 18" MIN. FROM FINISH FACE OF ADJACENT SURFACE.
- ALL DIMENSIONS ARE TO FACE OF STUD, GRID LINE, OR
- FACE OF CONCRETE, U.N.O. 0. WHERE "CLEAR" IS CALLED OUT ON A DIMENSION, PROVIDE DIMENSION FROM FACE OF FINISH TO FACE OF
- FINISH.
- 11. FURNITURE IS NOT IN CONTRACT, U.N.O., AND IS SHOWN FOR DIAGRAMATIC PURPOSES ONLY.
- 12. CONSULTANT MODELS SHOWN FOR REFERENCE ONLY.

### ENLARGED FLOOR PLAN - LEGEND

	<b>CARPET</b> RE: FINISH SCHED.		RUBBER (F7) RE LANDSCAPE
	<b>TILE</b> RE: FINISH SCHED.		CONCRETE (F8) RE: LANDSCAPE
	WOOD - UNIT RE: FINISH SCHED.		PAVERS (F9) RE: LANDSCAPE
	WOOD - PUBLIC RE: FINISH SCHED.		
4 - 4 - 4	POLISHED CONC. (F5.1) INTERIOR		
	SEALED CONC. (F5.2) INTERIOR		
	HERRINGBONE TILE (F6) RE: FINISH SCHED.		
ENL	ARGED FLOOR PLAN - CLI	EARANC	E NOTES
	FLOOR CLEARANCE		


- L \_ \_ J A DOOR CLEARANCE, 54" X 60"
- B APPLIANCE CLEARANCE, 30" X 48"
- C CLEAR FLOOR CLEARANCE, 30" X 48"
- D VANITY CLEARANCE, 30" X 48"
- E TOILET CLEARANCE, 48" X 56" OR ADA 60" X 56"
- F SHOWER/TUB CLEARANCE, 30" X 48" (B)  $\triangle$
- G TURN AROUND CLEARANCE
- GRAB BAR BLOCKING REQ. AT TOILET
- WALL WHERE APPLICABLE

### ENLARGED RCP - GENERAL NOTES

- ALL UNIT CEILINGS SHALL BE 9' 0" A.F.F. U.N.O. REFER TO ENLARGED RCP'S FOR COMMON AREA CEILING HEIGHTS.
- IN THE CASE OF MINOR DISCREPANCIES BETWEEN MEP AND ARCHITECTURAL DOCUMENTS ON THE LOCATION OF CEILING MOUNTED COMPONENTS, THE ARCHITECTURAL RCP'S GOVERN. IN THE CASE OF MAJOR DISCREPANCIES, THE ARCHITECT SHALL BE NOTIFIED AS SOON AS THE DISCREPANCY IS DISCOVERED PRIOR TO PROCEEDING WITH THE WORK.
- REFERENCE MECHANICAL AND ELECTRICAL DRAWINGS FOR MOUNTING LOCATIONS OF ITEMS WHERE NO CEILING IS REQUIRED OR INDICATED.
- COORDINATE ALL TRADES INVOLVED IN THE CEILING WORK TO ENSURE CLEARANCE FOR FIXTURES, DUCTS, PIPING, CEILING SUSPENSION SYSTEMS, ETC. NECESSARY TO MAINTAIN CEILING HEIGHTS NOTED.
- LIGHTS, DIFFUSERS, EXIT SIGNS, SMOKE DETECTORS, SPEAKERS, STROBES, AND MISC. DEVICES SHALL BE CENTERED IN THE CEILING WHERE THEY OCCUR, U.N.O. FIRE PROTECTION SCOPE SHALL BE DESIGN-BUILD. ALL CORRIDOR SPRINKLER HEADS SHALL BE ALIGNED IN THE
- SAME LOCATION PARALLEL TO THE WALL WITHIN EACH SPECIFIC CEILING CONSTRUCTION. SMOKE ALARMS SHALL BE PROVIDED IN ALL BEDROOMS,
- OUTSIDE OF ALL BEDROOMS, AND ON EACH FLOOR AS REQUIRED. CARBON MONOXIDE DETECTORS SHALL BE INSTALLED OUTSIDE OF ALL BEDROOMS. SMOKE ALARMS AND CO DETECTORS SHALL BE HARDWIRED AND HAVE BATTERY BACKUP.
- ACCESS DOOR LOCATIONS IN GYPSUM BOARD CEILINGS ARE INDICATED ON RCP'S ONLY WHERE ARCHITECTURALLY SIGNIFICANT. REFERENCE SPECIFICATIONS AND MEP DRAWINGS FOR OTHER ACCESS DOOR LOCATIONS.
- UNLESS PREFINISHED TO MATCH ADJACENT SURFACE, PAINT MECHANICAL GRILLS, DIFFUSERS, ACCESS PANELS, AND OTHER EQUIPMENT TO MATCH ADJACENT SURFACE.
- 10. EXIT SIGNS ARE SHOWN ON RCP'S ONLY WHERE LOCATIONS ARE ARCHITECTURALLY SIGNIFICANT. 11. PROVIDE UL-CLASSIFIED LIGHT FIXTURES OR
- ENCLOSURES IN RATED FLOOR/CEILING ASSEMBLIES IN


ACCORDANCE WITH IBC CHAPTER 7. REFER TO LIGHTING PLANS FOR EXACT FIXTURE TYPES AND LOCATIONS. FIXTURES SHOWN HERE ARE REFERENCED AND SHOWN FOR GENERAL ALIGNMENT.				
	ENLARGED RCP	LEGENI	)	
	<b>GWB (C1)</b> INTERIOR	$\rightarrow$	SLOPE CEILING AS NOTED	
	T&G CEILING (C2) INTERIOR	0	CEILING MOUNTED LIGHT FIXTURE	
	FIBER-CEMENT SOFFIT (C3) - EXTERIOR	+ + + + + + + + + + + + + + + + + + + +	VINYL SCRIM CLG - INTERIOR	
	ACCESS PANEL		ACOUSTIC VINYL TILE CLG - INTERIOR	


TOWN STAMP TABLE STAND
T20.512.3437
<b>The Amble</b> Steamboat Springs, CO
IFC SET SHEET TITLE UNIT PLAN - 2 BEDROOM STANDARD - LEVELS 02-03 SHEET NO.

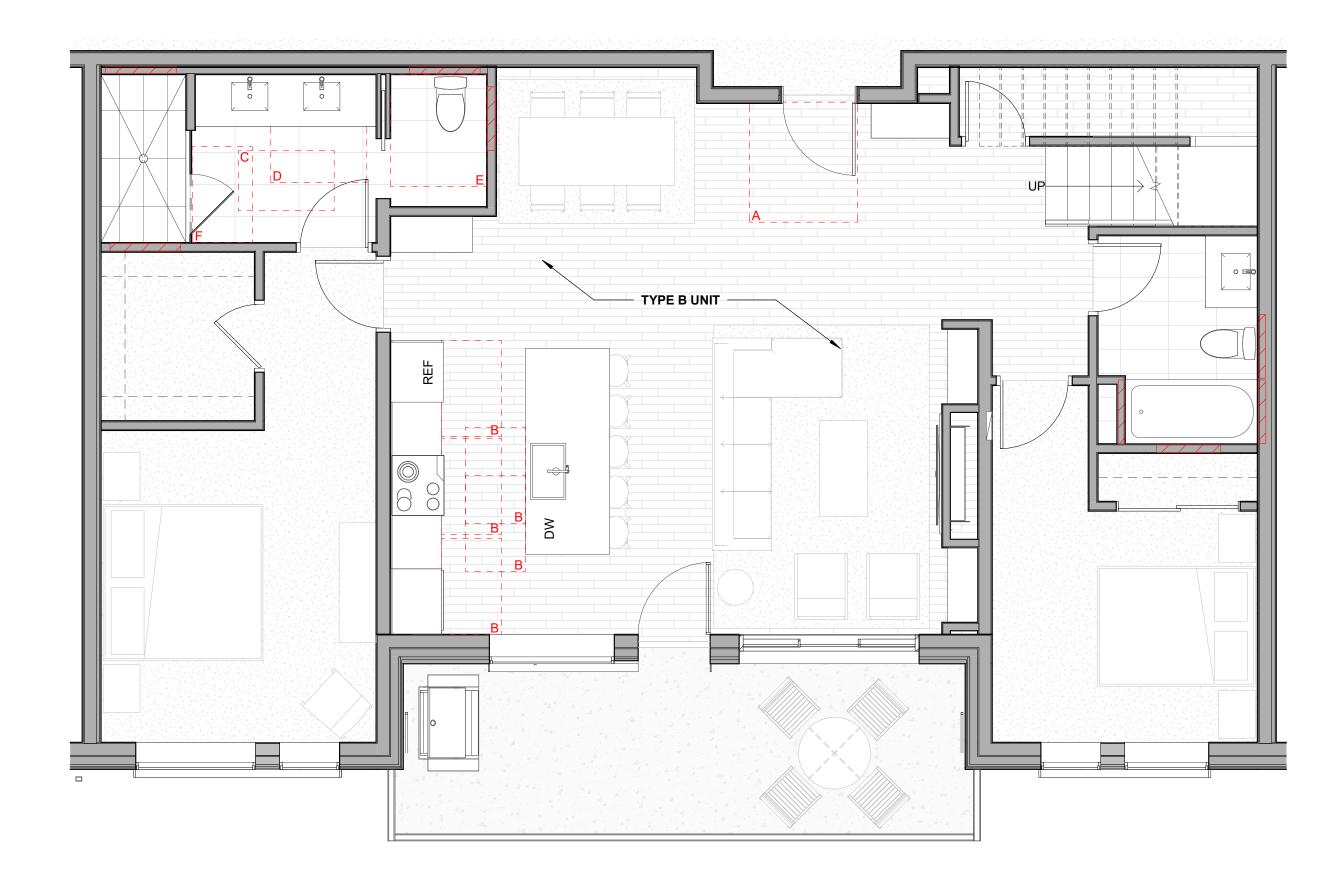


4 Level 04 - 2 BEDROOM STANDARD FURNITURE 1/4" = 1'-0" UNITS 407, 410

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3 Level 04 - 2 BEDROOM STANDARD RCP 1/4" = 1'-0" UNITS 407, 410

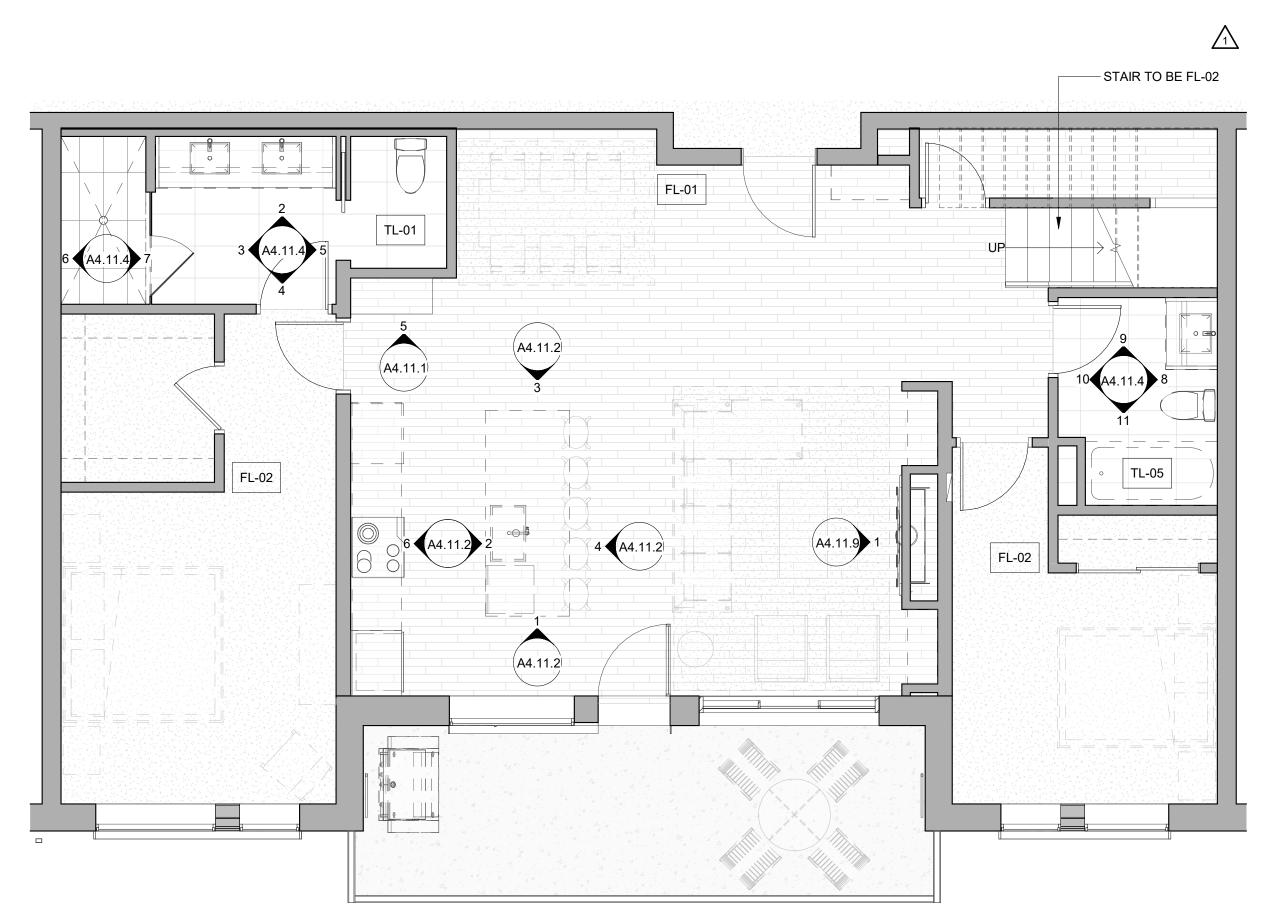


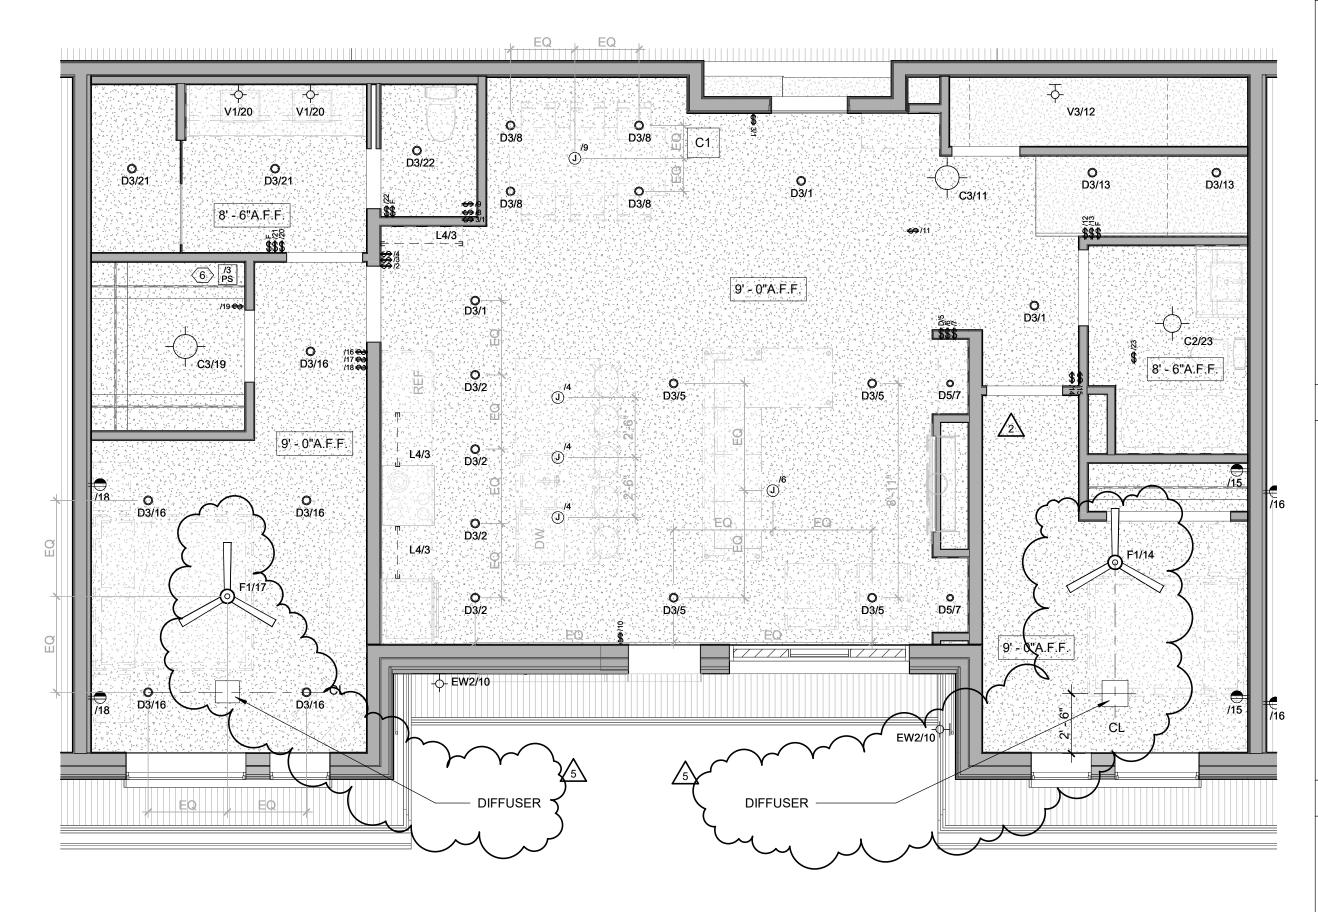/3/

### ENLARGED FLOOR PLAN - GENERAL NOTES

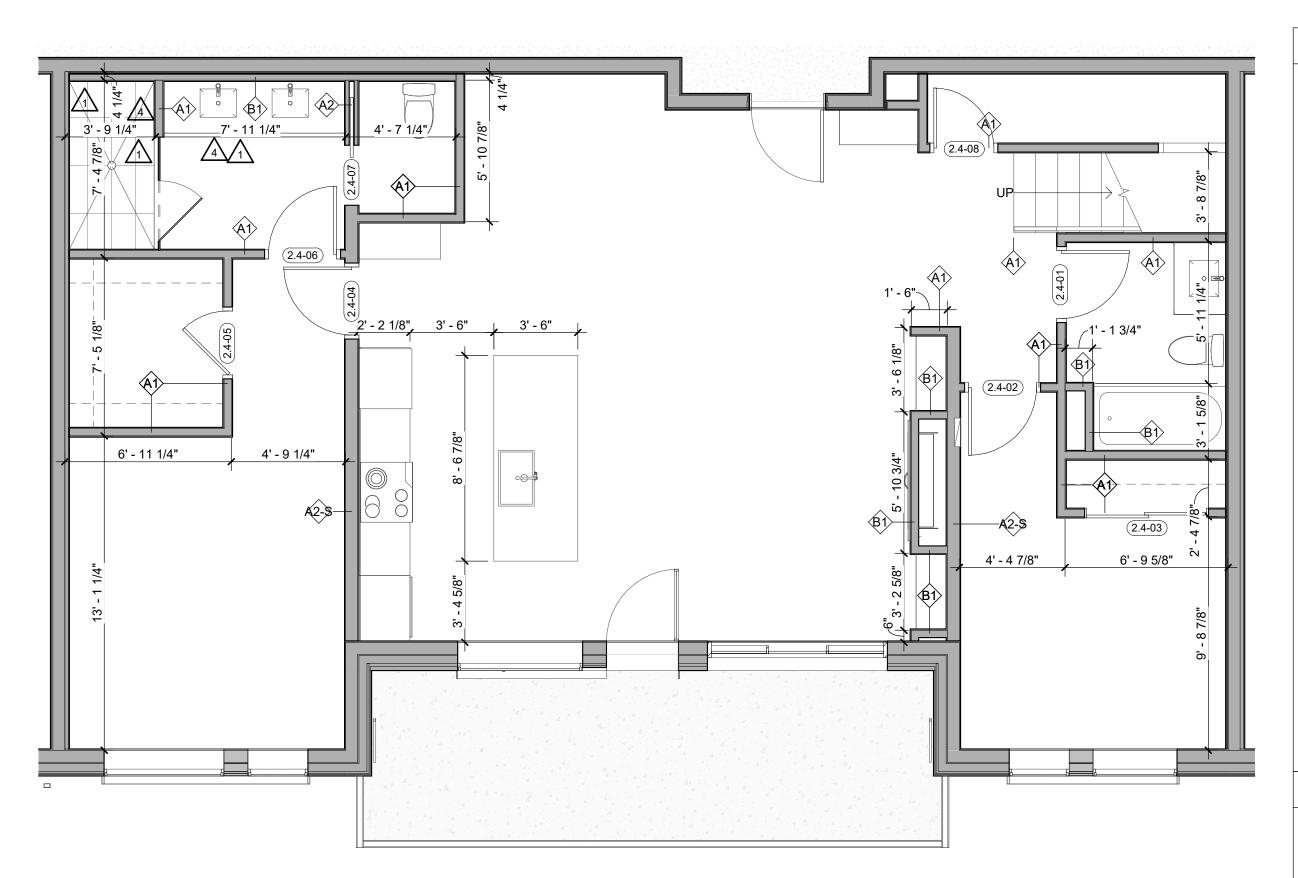- REFER TO G0.2X SHEETS FOR EXTERIOR AND INTERIOR
- BUILDING ENCLOSURE ASSEMBLIES. 2. REFER TO A1.0X SHEETS FOR EXTERIOR WALL, DEMISING WALL, AND CORRIDOR WALL TYPES AND LOCATIONS.
- REFER TO A1.1X SHEETS FOR INTERIOR AND EXTERIOR WINDOW/DOOR TAGS WITH UNIT BACKGROUNDS FOR REFERENCE.
- ALIGN WALLS WHERE THEY APPEAR TO ALIGN, U.N.O.
   THE INSIDE FACE OF DOOR JAMBS SHALL BE 4" FROM
- ADJACENT WALL OR FINISHED COLUMN, U.N.O. 6. PROVIDE BLOCKING FOR ALL WALL MOUNTED EQUIPMENT
- AND ACCESSORIES.
- THE CENTERLINE OF ALL RESIDENTIAL TOILETS SHALL BE LOCATED 18" OFF OF FINISH FACE OF WALL, U.N.O.
   SWING CLEARANCE AT UNIT ENTRY SHALL BE 18" MIN.
- FROM FINISH FACE OF ADJACENT SURFACE. ALL DIMENSIONS ARE TO FACE OF STUD, GRID LINE, OR
- FACE OF CONCRETE, U.N.O. 10. WHERE "CLEAR" IS CALLED OUT ON A DIMENSION, PROVIDE DIMENSION FROM FACE OF FINISH TO FACE OF
- FINISH. 11. FURNITURE IS NOT IN CONTRACT, U.N.O., AND IS SHOWN
- FOR DIAGRAMATIC PURPOSES ONLY. 12. CONSULTANT MODELS SHOWN FOR REFERENCE ONLY.

### ENLARGED FLOOR PLAN - LEGEND

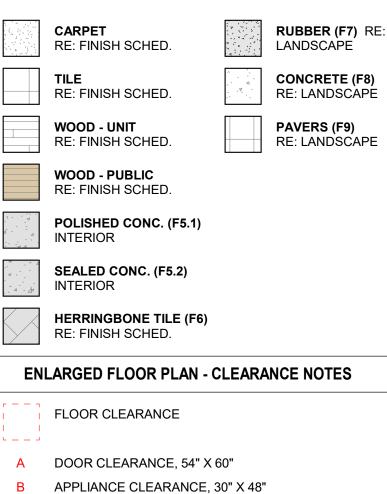

- APPLIANCE CLEARANCE, 30" X 48"
- C CLEAR FLOOR CLEARANCE, 30" X 48"
- D VANITY CLEARANCE, 30" X 48"
- E TOILET CLEARANCE, 48" X 56" OR ADA 60" X 56"
- F SHOWER/TUB CLEARANCE, 30" X 48" (B)
- G TURN AROUND CLEARANCE
- GRAB BAR BLOCKING REQ. AT TOILET WALL WHERE APPLICABLE

### ENLARGED RCP - GENERAL NOTES

- 1. ALL UNIT CEILINGS SHALL BE 9' 0" A.F.F. U.N.O. REFER TO ENLARGED RCP'S FOR COMMON AREA CEILING HEIGHTS.
- 2. IN THE CASE OF MINOR DISCREPANCIES BETWEEN MEP AND ARCHITECTURAL DOCUMENTS ON THE LOCATION OF CEILING MOUNTED COMPONENTS, THE ARCHITECTURAL RCP'S GOVERN. IN THE CASE OF MAJOR DISCREPANCIES, THE ARCHITECT SHALL BE NOTIFIED AS SOON AS THE DISCREPANCY IS DISCOVERED PRIOR TO PROCEEDING WITH THE WORK.
- 3. REFERENCE MECHANICAL AND ELECTRICAL DRAWINGS FOR MOUNTING LOCATIONS OF ITEMS WHERE NO CEILING IS REQUIRED OR INDICATED.
- 4. COORDINATE ALL TRADES INVOLVED IN THE CEILING WORK TO ENSURE CLEARANCE FOR FIXTURES, DUCTS, PIPING, CEILING SUSPENSION SYSTEMS, ETC. NECESSARY TO MAINTAIN CEILING HEIGHTS NOTED.
- LIGHTS, DIFFUSERS, EXIT SIGNS, SMOKE DETECTORS, SPEAKERS, STROBES, AND MISC. DEVICES SHALL BE CENTERED IN THE CEILING WHERE THEY OCCUR, U.N.O.
   FIRE PROTECTION SCOPE SHALL BE DESIGN-BUILD. ALL
- CORRIDOR SPRINKLER HEADS SHALL BE ALIGNED IN THE SAME LOCATION PARALLEL TO THE WALL WITHIN EACH SPECIFIC CEILING CONSTRUCTION.
  7. SMOKE ALARMS SHALL BE PROVIDED IN ALL BEDROOMS,
- OUTSIDE OF ALL BEDROOMS, AND ON EACH FLOOR AS REQUIRED. CARBON MONOXIDE DETECTORS SHALL BE INSTALLED OUTSIDE OF ALL BEDROOMS. SMOKE ALARMS AND CO DETECTORS SHALL BE HARDWIRED AND HAVE BATTERY BACKUP.
- 8. ACCESS DOOR LOCATIONS IN GYPSUM BOARD CEILINGS ARE INDICATED ON RCP'S ONLY WHERE ARCHITECTURALLY SIGNIFICANT. REFERENCE SPECIFICATIONS AND MEP DRAWINGS FOR OTHER ACCESS DOOR LOCATIONS.
- UNLESS PREFINISHED TO MATCH ADJACENT SURFACE, PAINT MECHANICAL GRILLS, DIFFUSERS, ACCESS PANELS, AND OTHER EQUIPMENT TO MATCH ADJACENT SURFACE.
   EXIT SIGNS ARE SHOWN ON RCP'S ONLY WHERE
- LOCATIONS ARE ARCHITECTURALLY SIGNIFICANT. 1. PROVIDE UL-CLASSIFIED LIGHT FIXTURES OR ENCLOSURES IN RATED FLOOR/CEILING ASSEMBLIES IN
- ACCORDANCE WITH IBC CHAPTER 7.
  12. REFER TO LIGHTING PLANS FOR EXACT FIXTURE TYPES AND LOCATIONS. FIXTURES SHOWN HERE ARE

REFERENCED AND SHOWN FOR GENERAL ALIGNMENT.

REVISIONS		
No.	Description	Date
1 2	IFC SET RFI #110	03.15.24 06.14.24
3 4	ASI 004 RFI #232	08.07.24 09.17.24
5	RFI #223.1	10.16.24
		+
PROJECT N	JMBER	2001
ISSUE DATE		03/15/202
	THE AMBLE	E
ISSUE		
	IFC SET	
	JNIT PLAN - COOM STANI LEVEL 04	
SHEET NO.		

TOWN STAMP

359

DESIGN

3630 OSAGE STREET DENVER, CO 80211 720.512.3437

**B-2465** 

12/15/2023

ED ARC

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GWB (C1) INTERIOR

INTERIOR

T&G CEILING (C2)

(C3) - EXTERIOR

ACCESS PANEL

FIBER-CEMENT SOFFIT

 $\longrightarrow \underset{\mathsf{NOTED}}{\mathsf{SLOPE CEILING AS}}$ 


INTERIOR

CEILING MOUNTED

VINYL SCRIM CLG -

ACCOUSTIC VINYL TILE CLG - INTERIOR


LIGHT FIXTURE

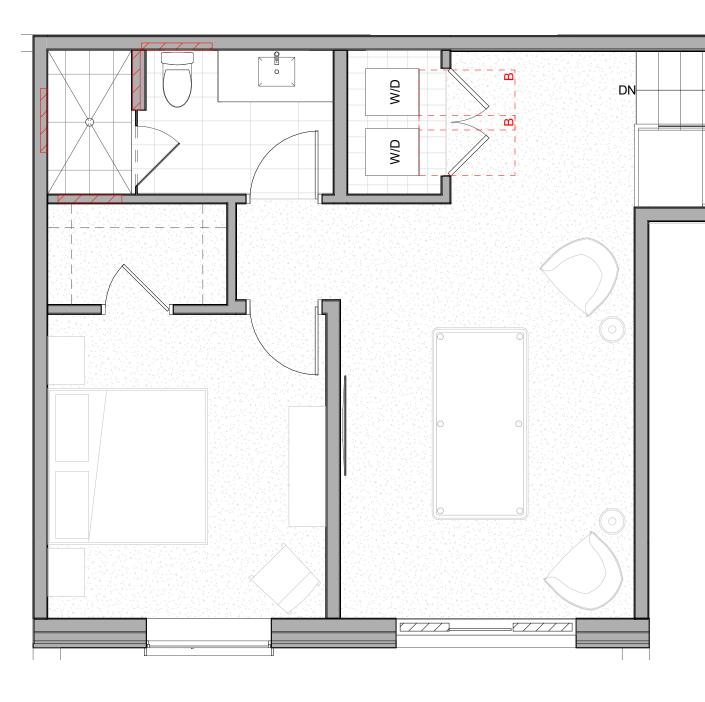




LEVEL 05 - 2 BED STANDARD LOFT FURNITURE


UNITS 407, 409, 410  $\sqrt{3}$ 

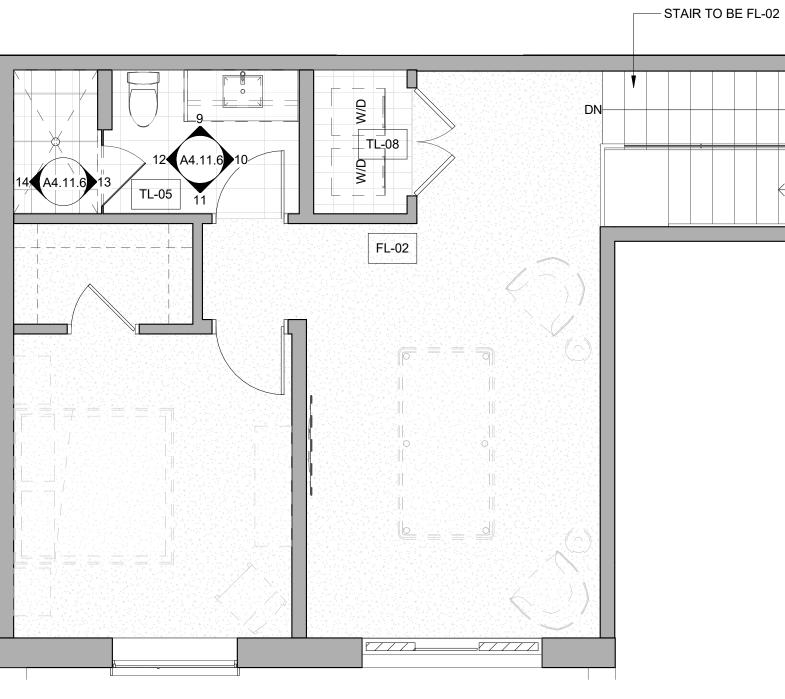






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**LEVEL 05 - 2 BED STANDARD DIMENSIONS** UNITS 407, 409, 410 1/4" = 1'-0"  $\sqrt{3}$ 
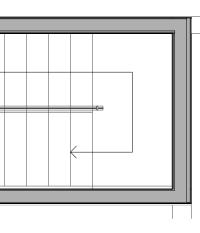
### **ENLARGED FLOOR PLAN - GENERAL NOTES**

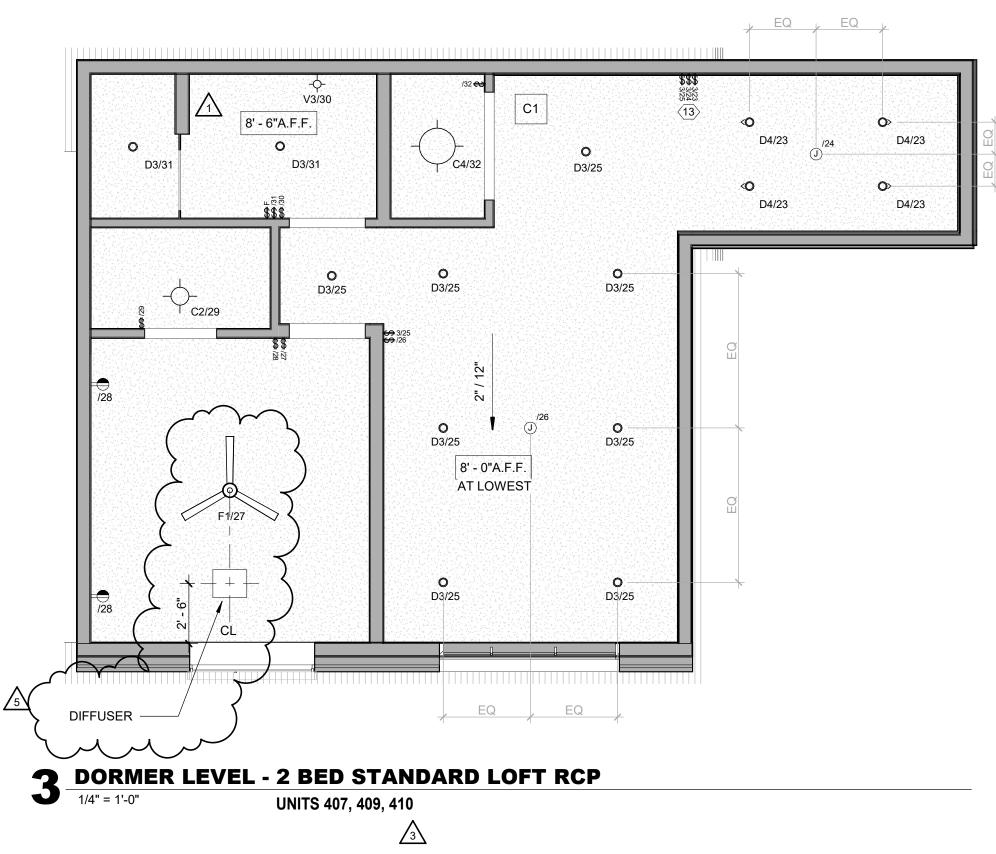- REFER TO G0.2X SHEETS FOR EXTERIOR AND INTERIOR BUILDING ENCLOSURE ASSEMBLIES.
- REFER TO A1.0X SHEETS FOR EXTERIOR WALL, DEMISING WALL, AND CORRIDOR WALL TYPES AND LOCATIONS. REFER TO A1.1X SHEETS FOR INTERIOR AND EXTERIOR WINDOW/DOOR TAGS WITH UNIT BACKGROUNDS FOR
- REFERENCE. ALIGN WALLS WHERE THEY APPEAR TO ALIGN, U.N.O.
- THE INSIDE FACE OF DOOR JAMBS SHALL BE 4" FROM ADJACENT WALL OR FINISHED COLUMN, U.N.O.
- PROVIDE BLOCKING FOR ALL WALL MOUNTED EQUIPMENT AND ACCESSORIES.
- THE CENTERLINE OF ALL RESIDENTIAL TOILETS SHALL BE LOCATED 18" OFF OF FINISH FACE OF WALL, U.N.O.
- SWING CLEARANCE AT UNIT ENTRY SHALL BE 18" MIN. FROM FINISH FACE OF ADJACENT SURFACE.
- ALL DIMENSIONS ARE TO FACE OF STUD, GRID LINE, OR FACE OF CONCRETE, U.N.O. 10. WHERE "CLEAR" IS CALLED OUT ON A DIMENSION,
- PROVIDE DIMENSION FROM FACE OF FINISH TO FACE OF FINISH. 11. FURNITURE IS NOT IN CONTRACT, U.N.O., AND IS SHOWN
- FOR DIAGRAMATIC PURPOSES ONLY. 12. CONSULTANT MODELS SHOWN FOR REFERENCE ONLY.
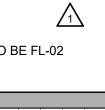
### ENLARGED FLOOR PLAN - LEGEND

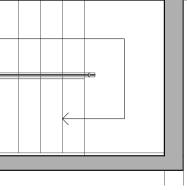	CARPET RE: FINISH SCHED.		RUBBER (F7) RE LANDSCAPE
	<b>TILE</b> RE: FINISH SCHED.		CONCRETE (F8) Re: Landscape
	WOOD - UNIT RE: FINISH SCHED.		<b>PAVERS (F9)</b> RE: LANDSCAPE
	WOOD - PUBLIC RE: FINISH SCHED.		
4 - 4 	POLISHED CONC. (F5.1) INTERIOR		
	SEALED CONC. (F5.2) INTERIOR		
	HERRINGBONE TILE (F6) RE: FINISH SCHED.		
ENI	ARGED FLOOR PLAN - C	CLEARA	NCE NOTES
	FLOOR CLEARANCE		

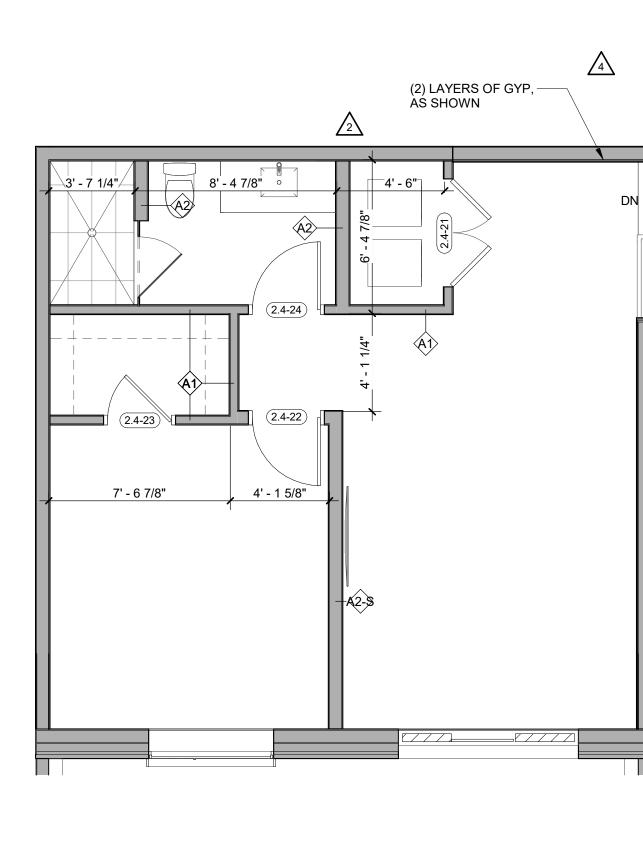
- A DOOR CLEARANCE, 54" X 60" B APPLIANCE CLEARANCE, 30" X 48"
- C CLEAR FLOOR CLEARANCE, 30" X 48"
- D VANITY CLEARANCE, 30" X 48"
- E TOILET CLEARANCE, 48" X 56" OR ADA 60" X 56"
- F SHOWER/TUB CLEARANCE, 30" X 48" (B)
- G TURN AROUND CLEARANCE
- GRAB BAR BLOCKING REQ. AT TOILET WALL WHERE APPLICABLE

### ENLARGED RCP - GENERAL NOTES


- ALL UNIT CEILINGS SHALL BE 9' 0" A.F.F. U.N.O. REFER TO ENLARGED RCP'S FOR COMMON AREA CEILING HEIGHTS.
- IN THE CASE OF MINOR DISCREPANCIES BETWEEN MEP AND ARCHITECTURAL DOCUMENTS ON THE LOCATION OF CEILING MOUNTED COMPONENTS, THE ARCHITECTURAL RCP'S GOVERN. IN THE CASE OF MAJOR DISCREPANCIES, THE ARCHITECT SHALL BE NOTIFIED AS SOON AS THE DISCREPANCY IS DISCOVERED PRIOR TO PROCEEDING WITH THE WORK.
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- ACCESS DOOR LOCATIONS IN GYPSUM BOARD CEILINGS ARE INDICATED ON RCP'S ONLY WHERE ARCHITECTURALLY SIGNIFICANT. REFERENCE SPECIFICATIONS AND MEP DRAWINGS FOR OTHER
- ACCESS DOOR LOCATIONS. UNLESS PREFINISHED TO MATCH ADJACENT SURFACE, PAINT MECHANICAL GRILLS, DIFFUSERS, ACCESS PANELS, AND OTHER EQUIPMENT TO MATCH ADJACENT SURFACE.
- 10. EXIT SIGNS ARE SHOWN ON RCP'S ONLY WHERE LOCATIONS ARE ARCHITECTURALLY SIGNIFICANT. 11. PROVIDE UL-CLASSIFIED LIGHT FIXTURES OR
- ENCLOSURES IN RATED FLOOR/CEILING ASSEMBLIES IN ACCORDANCE WITH IBC CHAPTER 7. 12. REFER TO LIGHTING PLANS FOR EXACT FIXTURE TYPES AND LOCATIONS. FIXTURES SHOWN HERE ARE
- REFERENCED AND SHOWN FOR GENERAL ALIGNMENT.

<b>GWB (C1)</b> INTERIOR	$\rightarrow$	SLOPE CEILING AS NOTED
T&G CEILING (C2) INTERIOR	0	CEILING MOUNTED LIGHT FIXTURE
FIBER-CEMENT SOFFIT (C3) - EXTERIOR	+ + + + + + + + + + + + + + + + + + + +	VINYL SCRIM CLG - INTERIOR
ACCESS PANEL		ACCOUSTIC VINYL TILE CLG - INTERIOR

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BRSCED. WINS B-2465 12/15/2023
The Amble         Steamboat Springs, CO
IFC SET IFC SET SHEET TITLE UNIT PLAN - 2 BEDROOM STANDARD - LEVEL 05 SHEET NO.

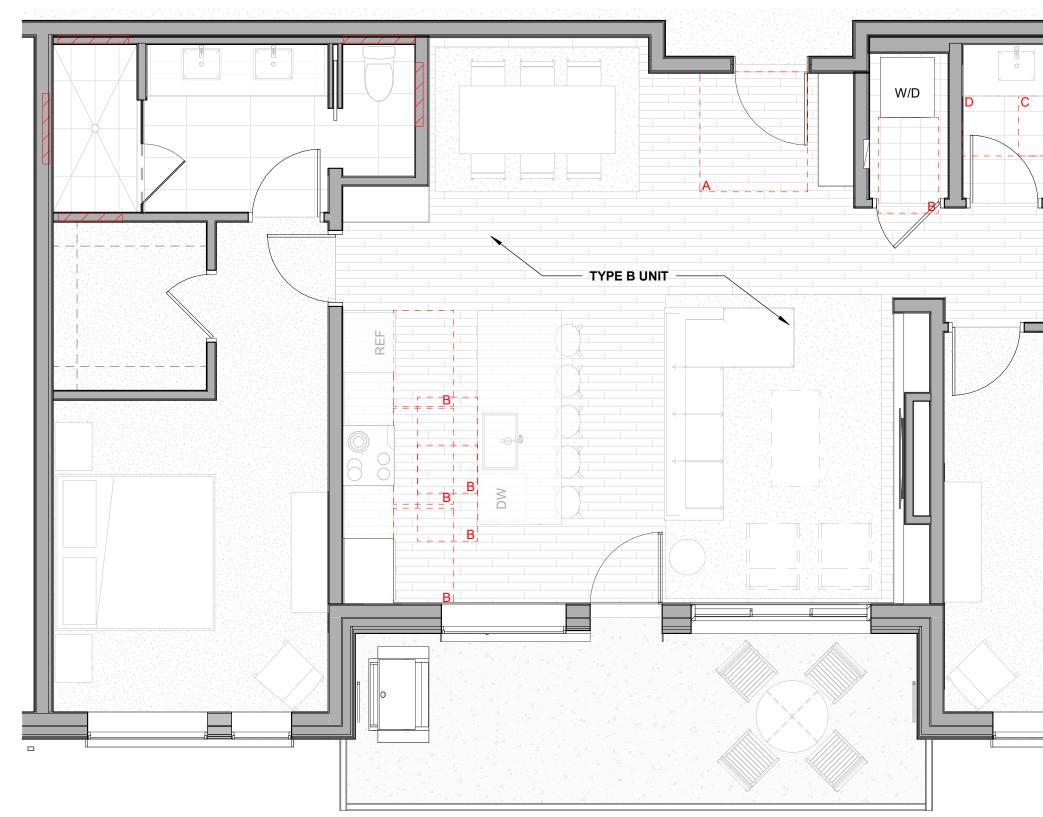





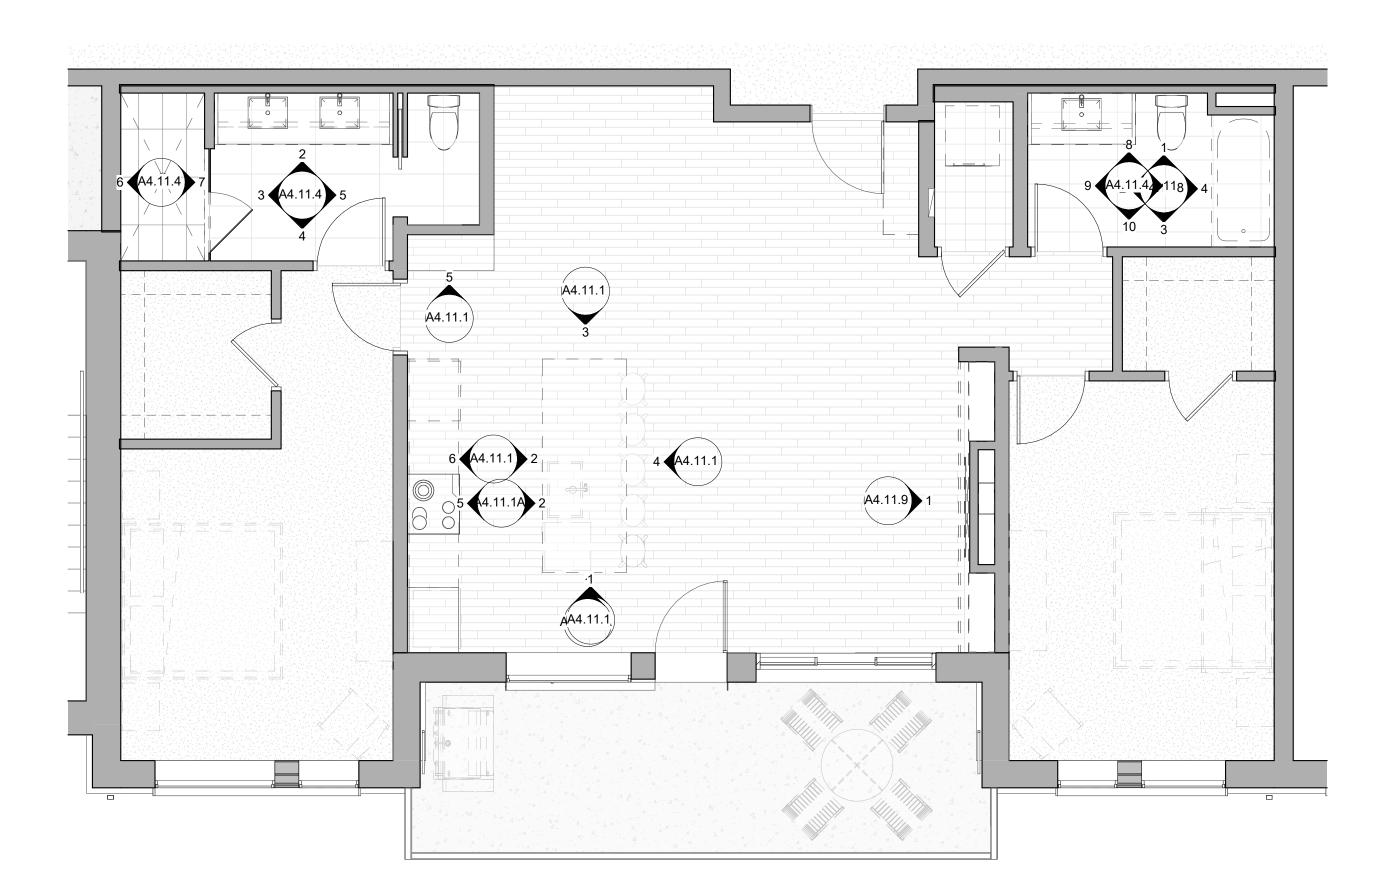


# 2 Level 02 - 2 BEDROOM STANDARD-FINISH 1/4" = 1'-0" UNIT 209

UNIT 209

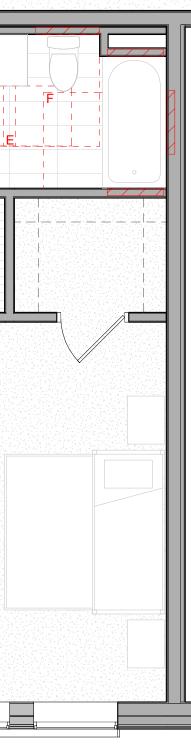

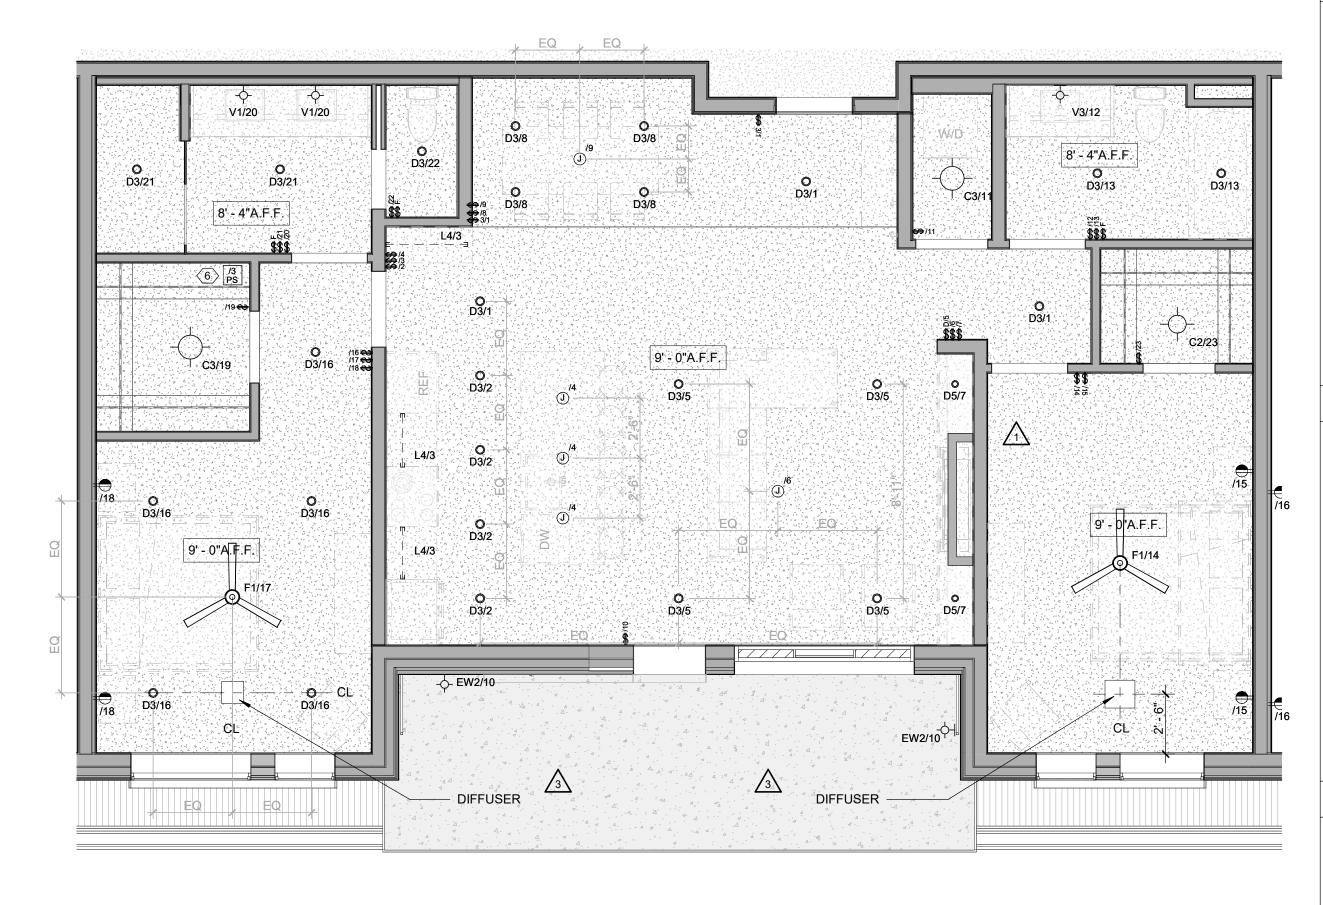


# 3 Level 02 - 2 BEDROOM STANDARD-RCP 1/4" = 1'-0" UNIT 209 **UNIT 209**

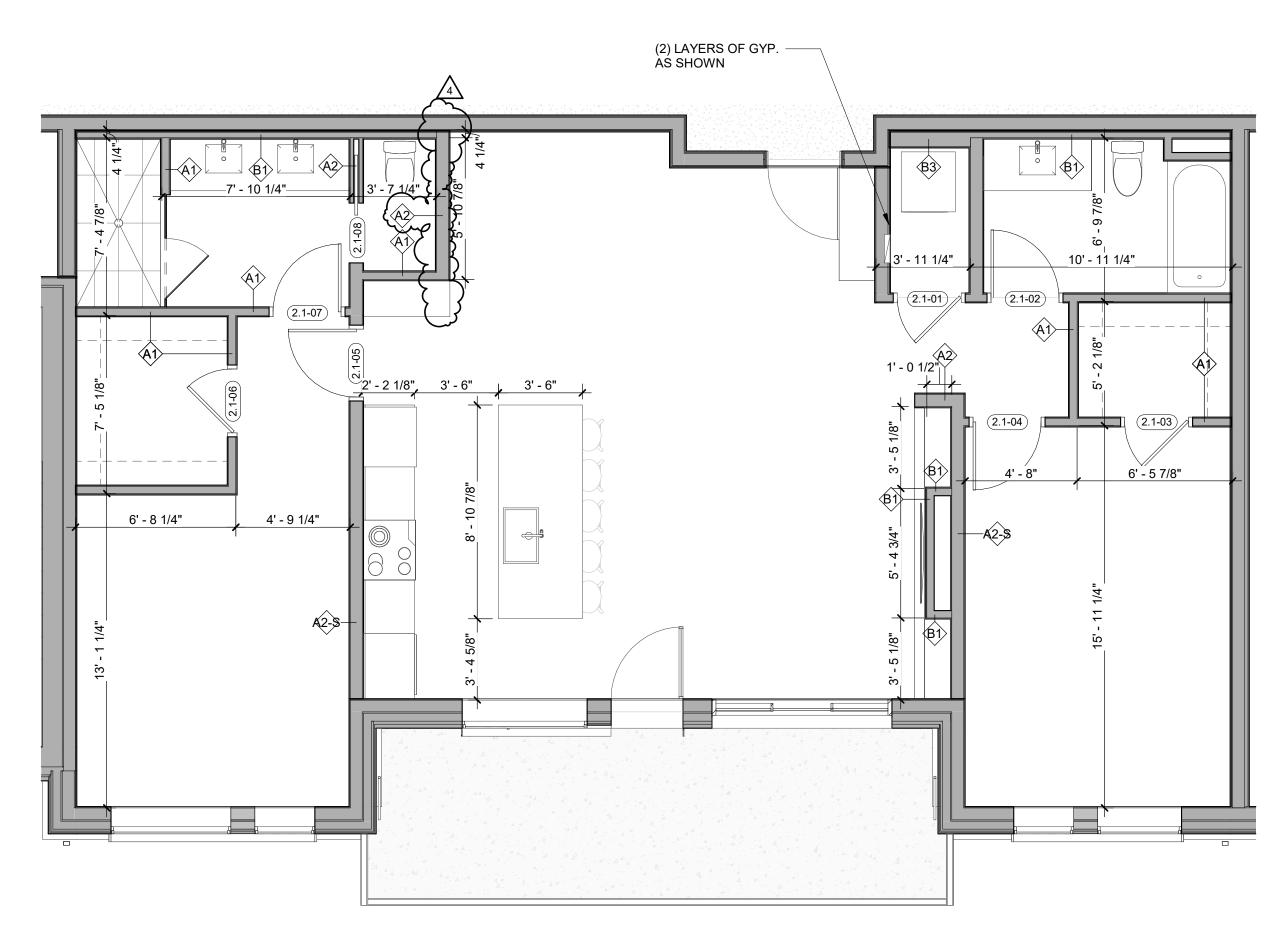

### ENLARGED FLOOR PLAN - GENERAL NOTES

- REFER TO G0.2X SHEETS FOR EXTERIOR AND INTERIOR BUILDING ENCLOSURE ASSEMBLIES. REFER TO A1.0X SHEETS FOR EXTERIOR WALL, DEMISING WALL, AND CORRIDOR WALL TYPES AND LOCATIONS.
- REFER TO A1.1X SHEETS FOR INTERIOR AND EXTERIOR WINDOW/DOOR TAGS WITH UNIT BACKGROUNDS FOR REFERENCE.
- ALIGN WALLS WHERE THEY APPEAR TO ALIGN, U.N.O. THE INSIDE FACE OF DOOR JAMBS SHALL BE 4" FROM
- ADJACENT WALL OR FINISHED COLUMN, U.N.O. PROVIDE BLOCKING FOR ALL WALL MOUNTED EQUIPMENT AND ACCESSORIES.
- THE CENTERLINE OF ALL RESIDENTIAL TOILETS SHALL BE
- LOCATED 18" OFF OF FINISH FACE OF WALL, U.N.O. SWING CLEARANCE AT UNIT ENTRY SHALL BE 18" MIN.
- FROM FINISH FACE OF ADJACENT SURFACE. ALL DIMENSIONS ARE TO FACE OF STUD, GRID LINE, OR
- FACE OF CONCRETE, U.N.O. 10. WHERE "CLEAR" IS CALLED OUT ON A DIMENSION,
- PROVIDE DIMENSION FROM FACE OF FINISH TO FACE OF FINISH.
- 11. FURNITURE IS NOT IN CONTRACT, U.N.O., AND IS SHOWN FOR DIAGRAMATIC PURPOSES ONLY.
- 12. CONSULTANT MODELS SHOWN FOR REFERENCE ONLY.

### ENLARGED FLOOR PLAN - LEGEND

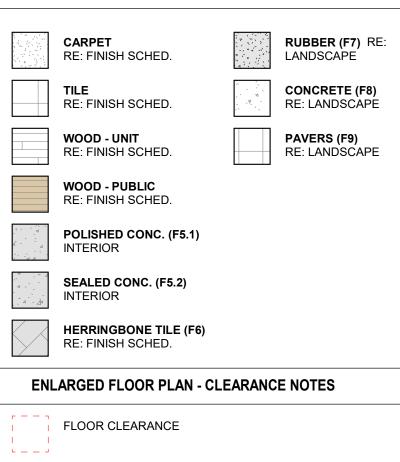


- A DOOR CLEARANCE, 54" X 60"
- B APPLIANCE CLEARANCE, 30" X 48"
- C CLEAR FLOOR CLEARANCE, 30" X 48"
- D VANITY CLEARANCE, 30" X 48"
- E TOILET CLEARANCE, 48" X 56" OR ADA 60" X 56"
- F SHOWER/TUB CLEARANCE, 30" X 48" (B)  $\triangle$
- G TURN AROUND CLEARANCE
- GRAB BAR BLOCKING REQ. AT TOILET WALL WHERE APPLICABLE

### ENLARGED RCP - GENERAL NOTES


- ALL UNIT CEILINGS SHALL BE 9' 0" A.F.F. U.N.O. REFER TO ENLARGED RCP'S FOR COMMON AREA CEILING HEIGHTS.
- IN THE CASE OF MINOR DISCREPANCIES BETWEEN MEP AND ARCHITECTURAL DOCUMENTS ON THE LOCATION OF CEILING MOUNTED COMPONENTS, THE ARCHITECTURAL RCP'S GOVERN. IN THE CASE OF MAJOR DISCREPANCIES, THE ARCHITECT SHALL BE NOTIFIED AS SOON AS THE DISCREPANCY IS DISCOVERED PRIOR TO PROCEEDING WITH THE WORK.
- REFERENCE MECHANICAL AND ELECTRICAL DRAWINGS FOR MOUNTING LOCATIONS OF ITEMS WHERE NO CEILING IS REQUIRED OR INDICATED.
- COORDINATE ALL TRADES INVOLVED IN THE CEILING WORK TO ENSURE CLEARANCE FOR FIXTURES, DUCTS, PIPING, CEILING SUSPENSION SYSTEMS, ETC. NECESSARY TO MAINTAIN CEILING HEIGHTS NOTED.
- LIGHTS, DIFFUSERS, EXIT SIGNS, SMOKE DETECTORS, SPEAKERS, STROBES, AND MISC. DEVICES SHALL BE CENTERED IN THE CEILING WHERE THEY OCCUR, U.N.O. FIRE PROTECTION SCOPE SHALL BE DESIGN-BUILD. ALL CORRIDOR SPRINKLER HEADS SHALL BE ALIGNED IN THE
- SAME LOCATION PARALLEL TO THE WALL WITHIN EACH SPECIFIC CEILING CONSTRUCTION. SMOKE ALARMS SHALL BE PROVIDED IN ALL BEDROOMS,
- OUTSIDE OF ALL BEDROOMS, AND ON EACH FLOOR AS REQUIRED. CARBON MONOXIDE DETECTORS SHALL BE INSTALLED OUTSIDE OF ALL BEDROOMS. SMOKE ALARMS AND CO DETECTORS SHALL BE HARDWIRED AND HAVE BATTERY BACKUP.
- ACCESS DOOR LOCATIONS IN GYPSUM BOARD CEILINGS ARE INDICATED ON RCP'S ONLY WHERE ARCHITECTURALLY SIGNIFICANT. REFERENCE SPECIFICATIONS AND MEP DRAWINGS FOR OTHER ACCESS DOOR LOCATIONS.
- UNLESS PREFINISHED TO MATCH ADJACENT SURFACE, PAINT MECHANICAL GRILLS, DIFFUSERS, ACCESS PANELS, AND OTHER EQUIPMENT TO MATCH ADJACENT SURFACE.
- 10. EXIT SIGNS ARE SHOWN ON RCP'S ONLY WHERE LOCATIONS ARE ARCHITECTURALLY SIGNIFICANT. 11. PROVIDE UL-CLASSIFIED LIGHT FIXTURES OR
- ENCLOSURES IN RATED FLOOR/CEILING ASSEMBLIES IN

REFER	RDANCE WITH IBC CHAPTER TO LIGHTING PLANS FOR E OCATIONS. FIXTURES SHOV RENCED AND SHOWN FOR (	EXACT FIX	ARE	
	ENLARGED RCP -	LEGENI	D	
$\begin{array}{cccc} & \rightarrow & \sqrt{2} \\ & \rightarrow & \sqrt{2} \\ & \gamma & \gamma & \gamma & \gamma \\ & \gamma & \gamma & \gamma & \gamma \\ & \gamma & \gamma$	<b>GWB (C1)</b> INTERIOR	$\rightarrow$	SLOPE CEILING AS NOTED	
	T&G CEILING (C2) INTERIOR	0	CEILING MOUNTED LIGHT FIXTURE	
	FIBER-CEMENT SOFFIT (C3) - EXTERIOR	+ + + + + + + + + + + + + + + + + + + +	VINYL SCRIM CLG - INTERIOR	
	ACCESS PANEL		ACOUSTIC VINYL TILE CLG - INTERIOR	


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<b>The Amble</b> Steamboat Springs, CO
REVISIONS         No.       Description       Date         1       06 14 24       08 07 24         3       01 62 24       01 62 24         4       RFI #339       11 13 24         4       Gatta and and and and and and and and and an
SHEET TITLE UNIT PLAN - 2 BEDROOM STANDARD - LEVELS 02 UNIT 209 SHEET NO.

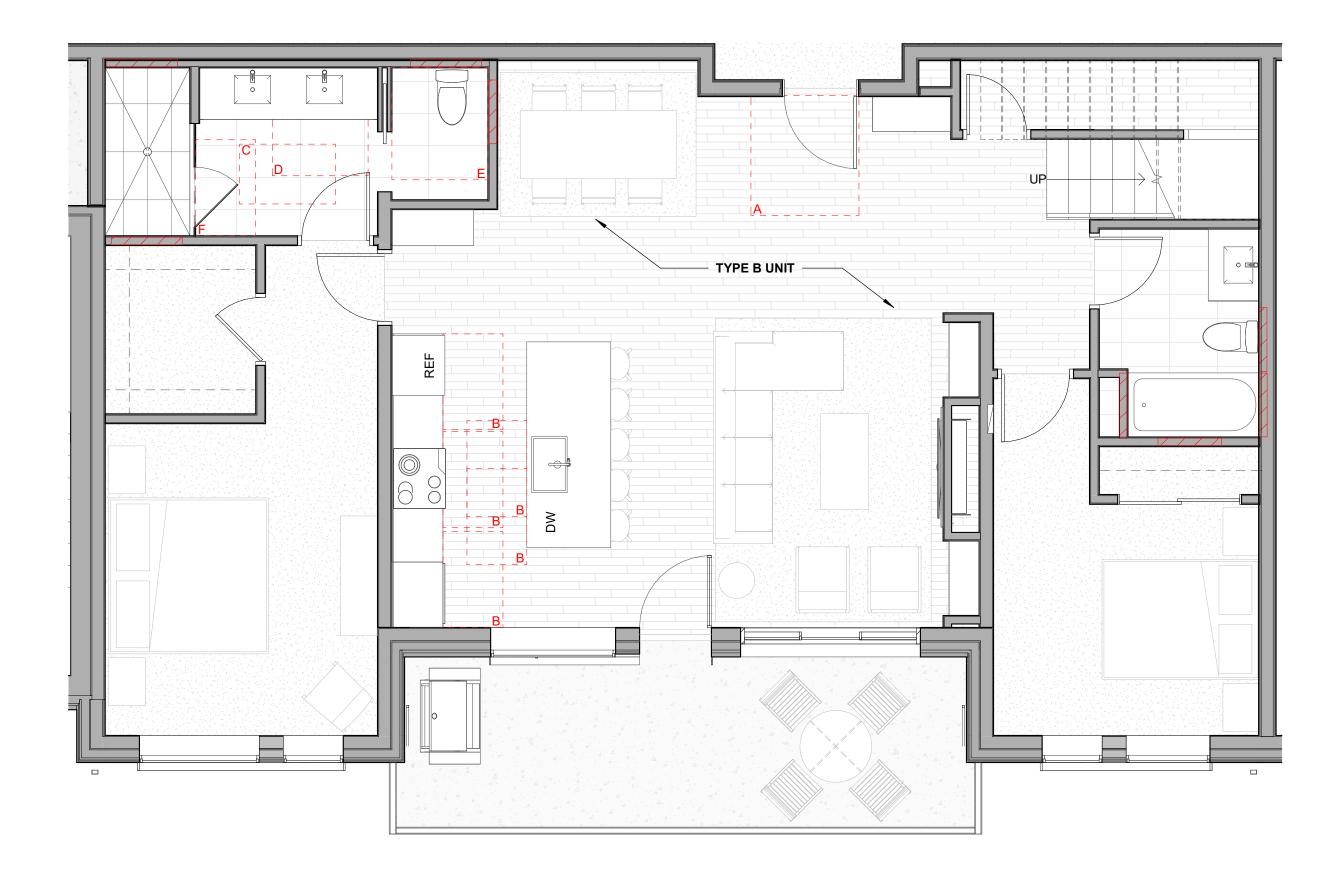



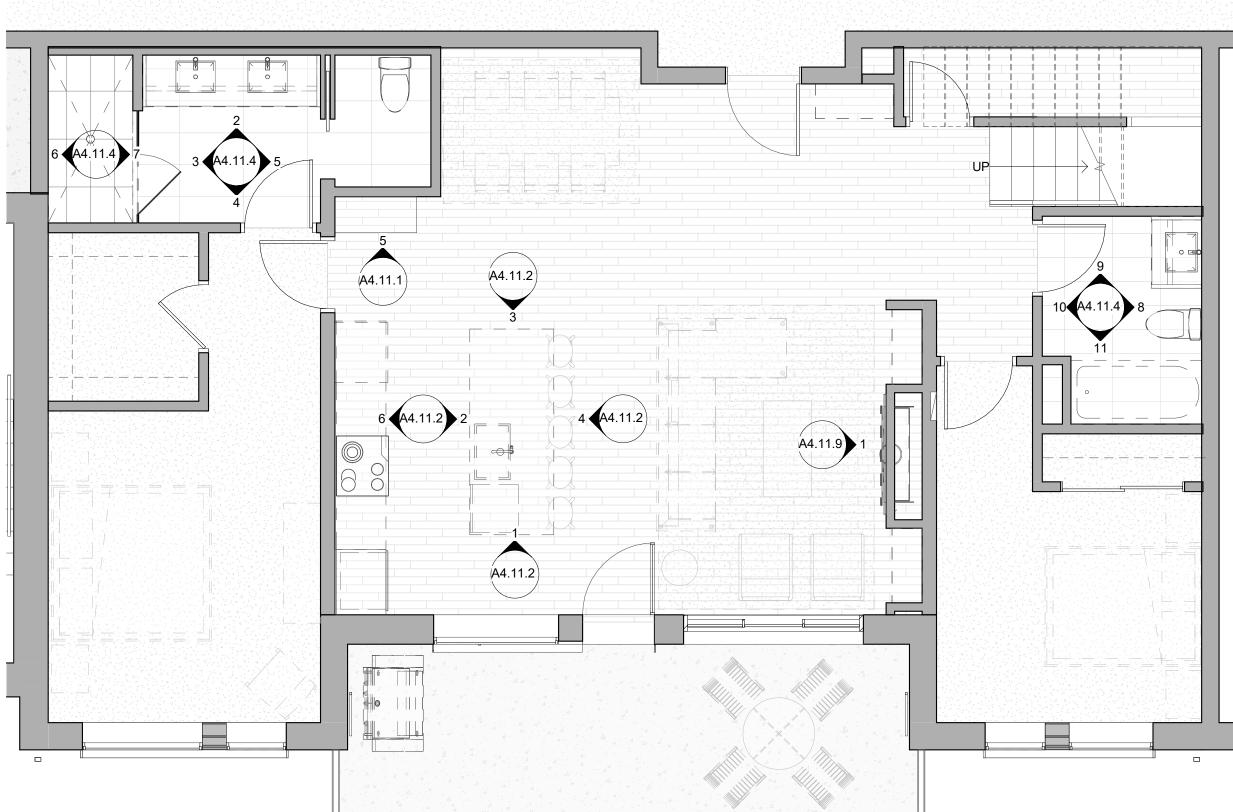


# SEE 3/A4.02.4 FOR UNIT RCP

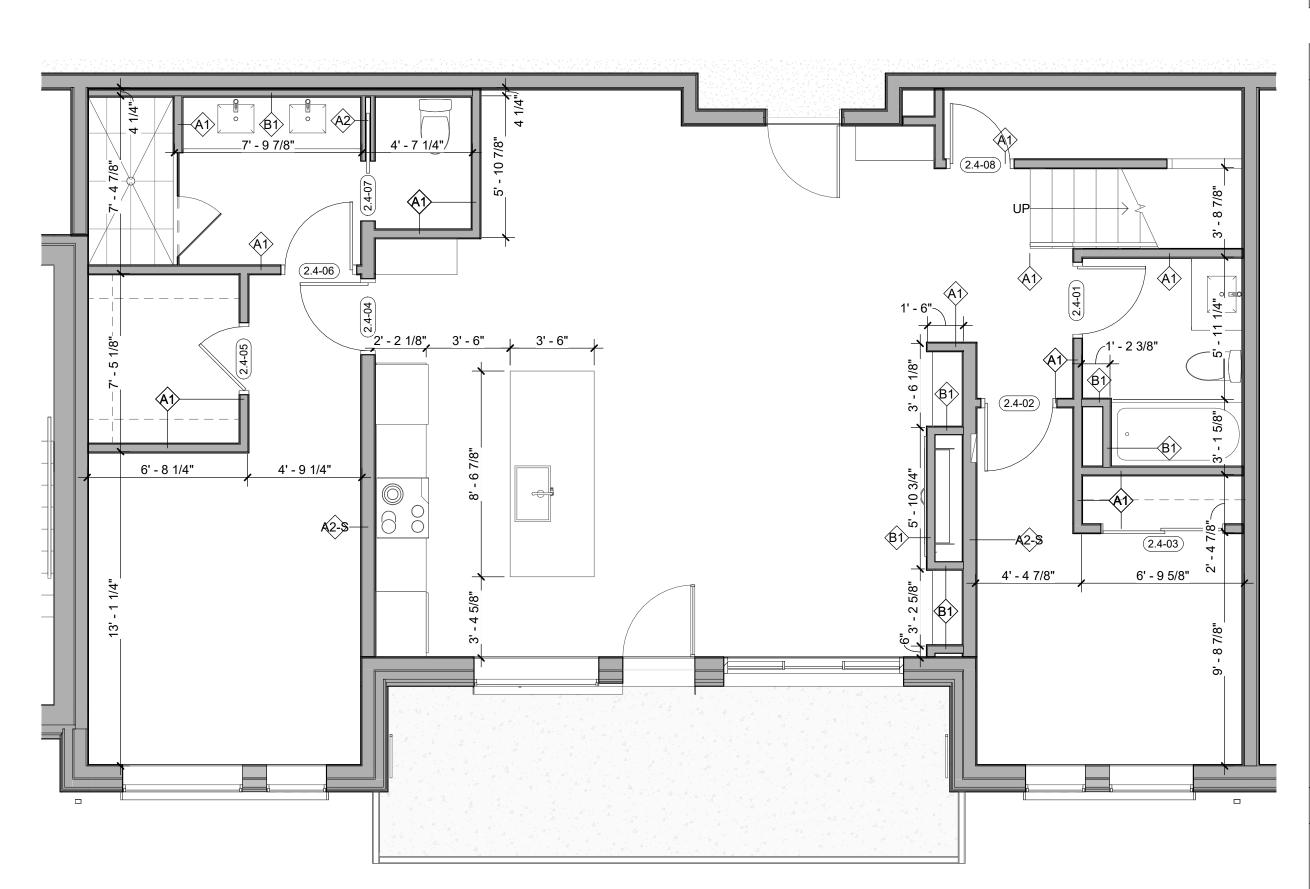

### ENLARGED FLOOR PLAN - GENERAL NOTES

- . REFER TO G0.2X SHEETS FOR EXTERIOR AND INTERIOR
- BUILDING ENCLOSURE ASSEMBLIES. 2. REFER TO A1.0X SHEETS FOR EXTERIOR WALL, DEMISING
- WALL, AND CORRIDOR WALL TYPES AND LOCATIONS.
  REFER TO A1.1X SHEETS FOR INTERIOR AND EXTERIOR WINDOW/DOOR TAGS WITH UNIT BACKGROUNDS FOR REFERENCE.
- 4. ALIGN WALLS WHERE THEY APPEAR TO ALIGN, U.N.O.
- 5. THE INSIDE FACE OF DOOR JAMBS SHALL BE 4" FROM ADJACENT WALL OR FINISHED COLUMN, U.N.O.
- 6. PROVIDE BLOCKING FOR ALL WALL MOUNTED EQUIPMENT AND ACCESSORIES.
- 7. THE CENTERLINE OF ALL RESIDENTIAL TOILETS SHALL BE
- LOCATED 18" OFF OF FINISH FACE OF WALL, U.N.O. 8. SWING CLEARANCE AT UNIT ENTRY SHALL BE 18" MIN.
- FROM FINISH FACE OF ADJACENT SURFACE. 9. ALL DIMENSIONS ARE TO FACE OF STUD, GRID LINE, OR
- 9. ALL DIMENSIONS ARE TO FACE OF STUD, GRID LINE, OR FACE OF CONCRETE, U.N.O.
  10. WHERE "CLEAR" IS CALLED OUT ON A DIMENSION,
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- FOR DIAGRAMATIC PURPOSES ONLY. 12. CONSULTANT MODELS SHOWN FOR REFERENCE ONLY.

### ENLARGED FLOOR PLAN - LEGEND

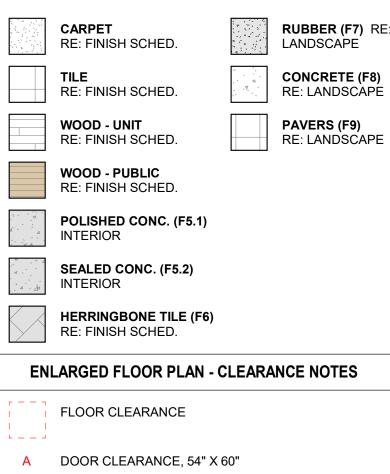

- A DOOR CLEARANCE, 34 X 80
  B APPLIANCE CLEARANCE, 30" X 48"
  C CLEAR FLOOR CLEARANCE, 30" X 48"
  D VANITY CLEARANCE, 30" X 48"
- E TOILET CLEARANCE, 48" X 56" OR ADA 60" X 56"
- F SHOWER/TUB CLEARANCE, 30" X 48" (B)
  G TURN AROUND CLEARANCE
- GRAB BAR BLOCKING REQ. AT TOILET WALL WHERE APPLICABLE

### ENLARGED RCP - GENERAL NOTES

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- 2. IN THE CASE OF MINOR DISCREPANCIES BETWEEN MEP AND ARCHITECTURAL DOCUMENTS ON THE LOCATION OF CEILING MOUNTED COMPONENTS, THE ARCHITECTURAL RCP'S GOVERN. IN THE CASE OF MAJOR DISCREPANCIES, THE ARCHITECT SHALL BE NOTIFIED AS SOON AS THE DISCREPANCY IS DISCOVERED PRIOR TO PROCEEDING WITH THE WORK.
- 3. REFERENCE MECHANICAL AND ELECTRICAL DRAWINGS FOR MOUNTING LOCATIONS OF ITEMS WHERE NO CEILING IS REQUIRED OR INDICATED.
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  12. REFER TO LIGHTING PLANS FOR EXACT FIXTURE TYPES AND LOCATIONS. FIXTURES SHOWN HERE ARE

REFERENCED AND SHOWN FOR GENERAL ALIGNMENT.

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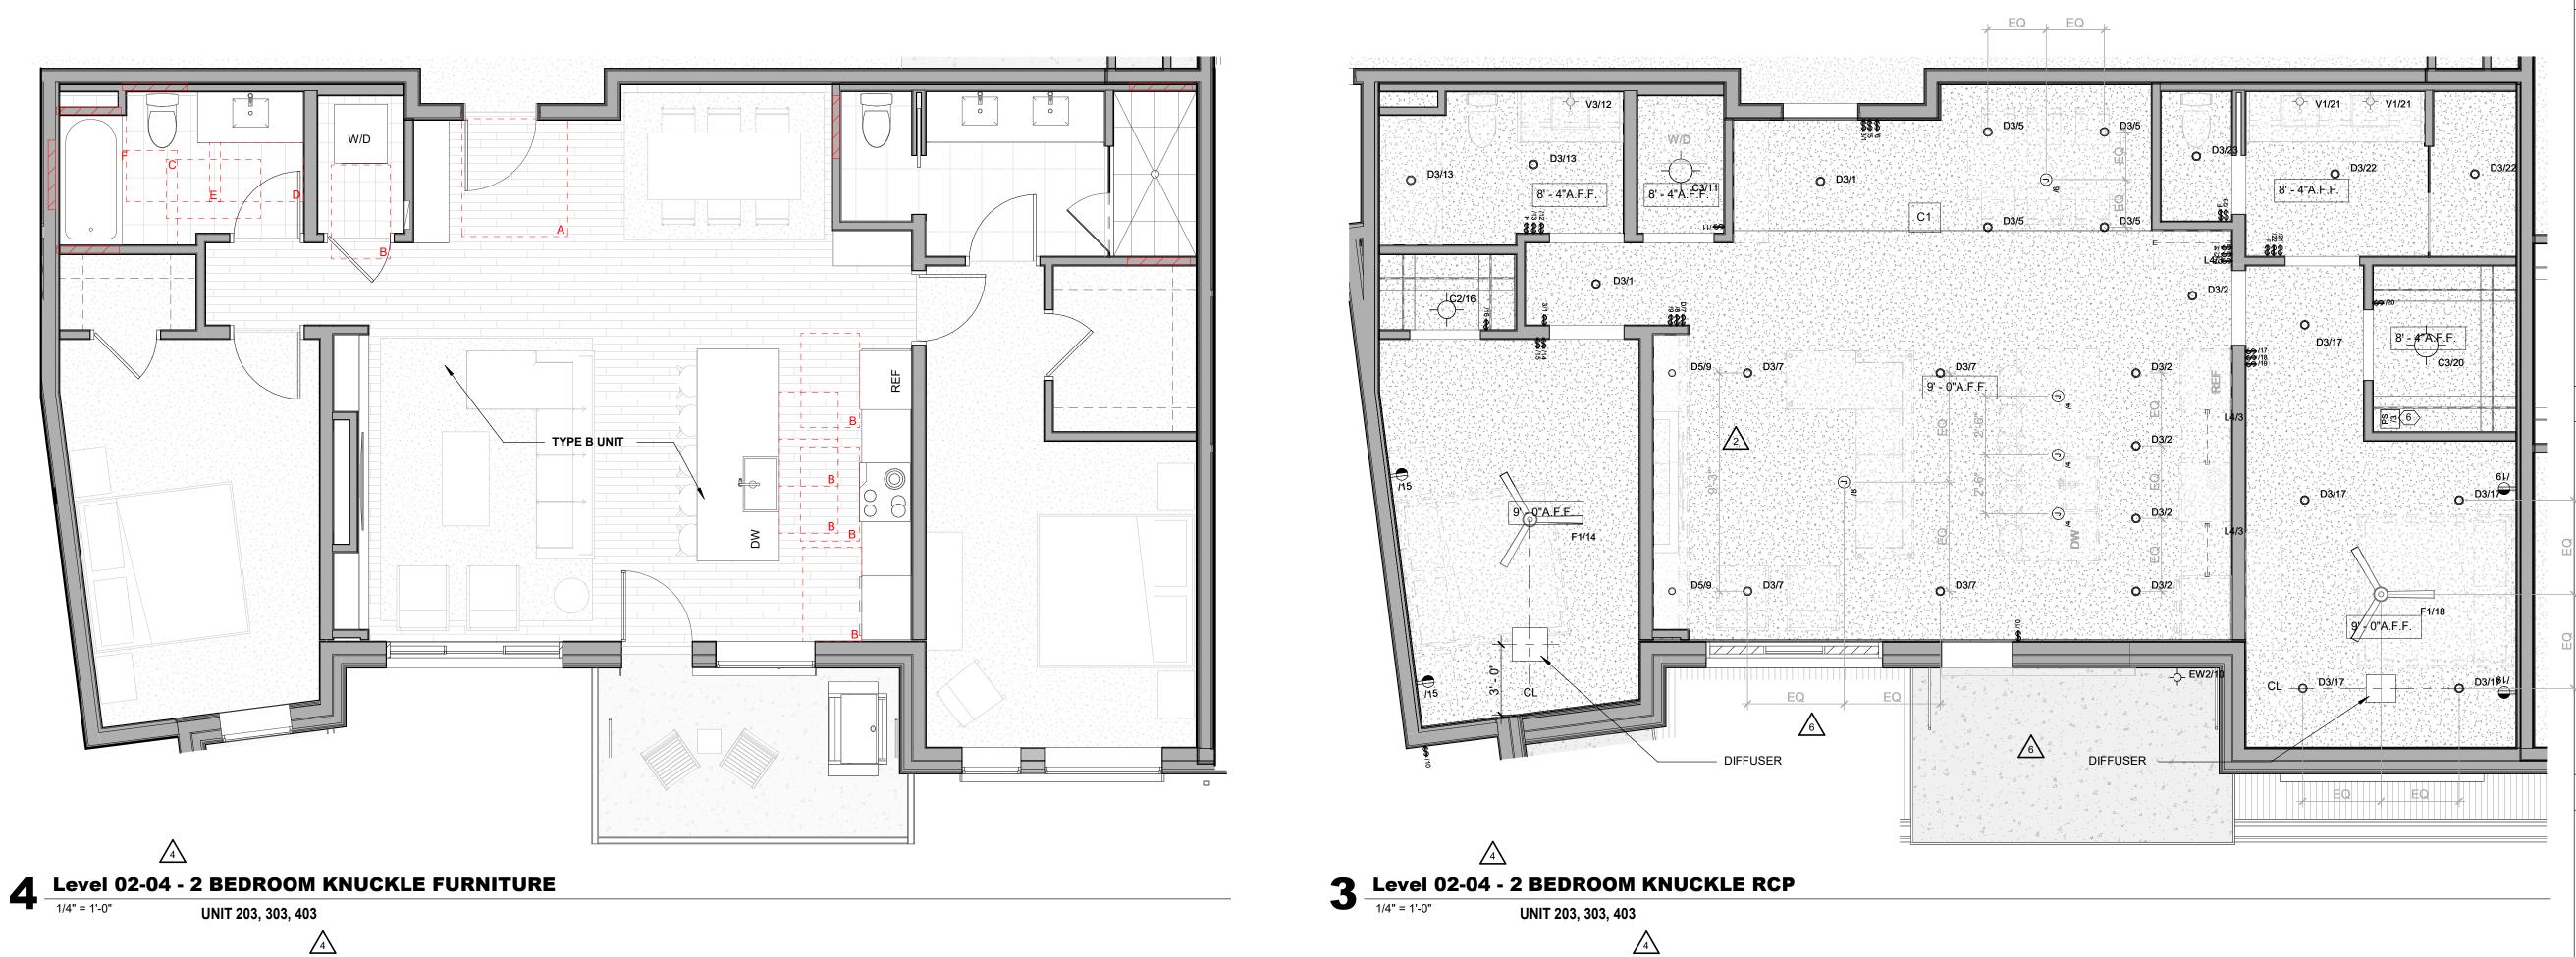
3630 OSAGE STREET DENVER, CO 80211 720.512.3437


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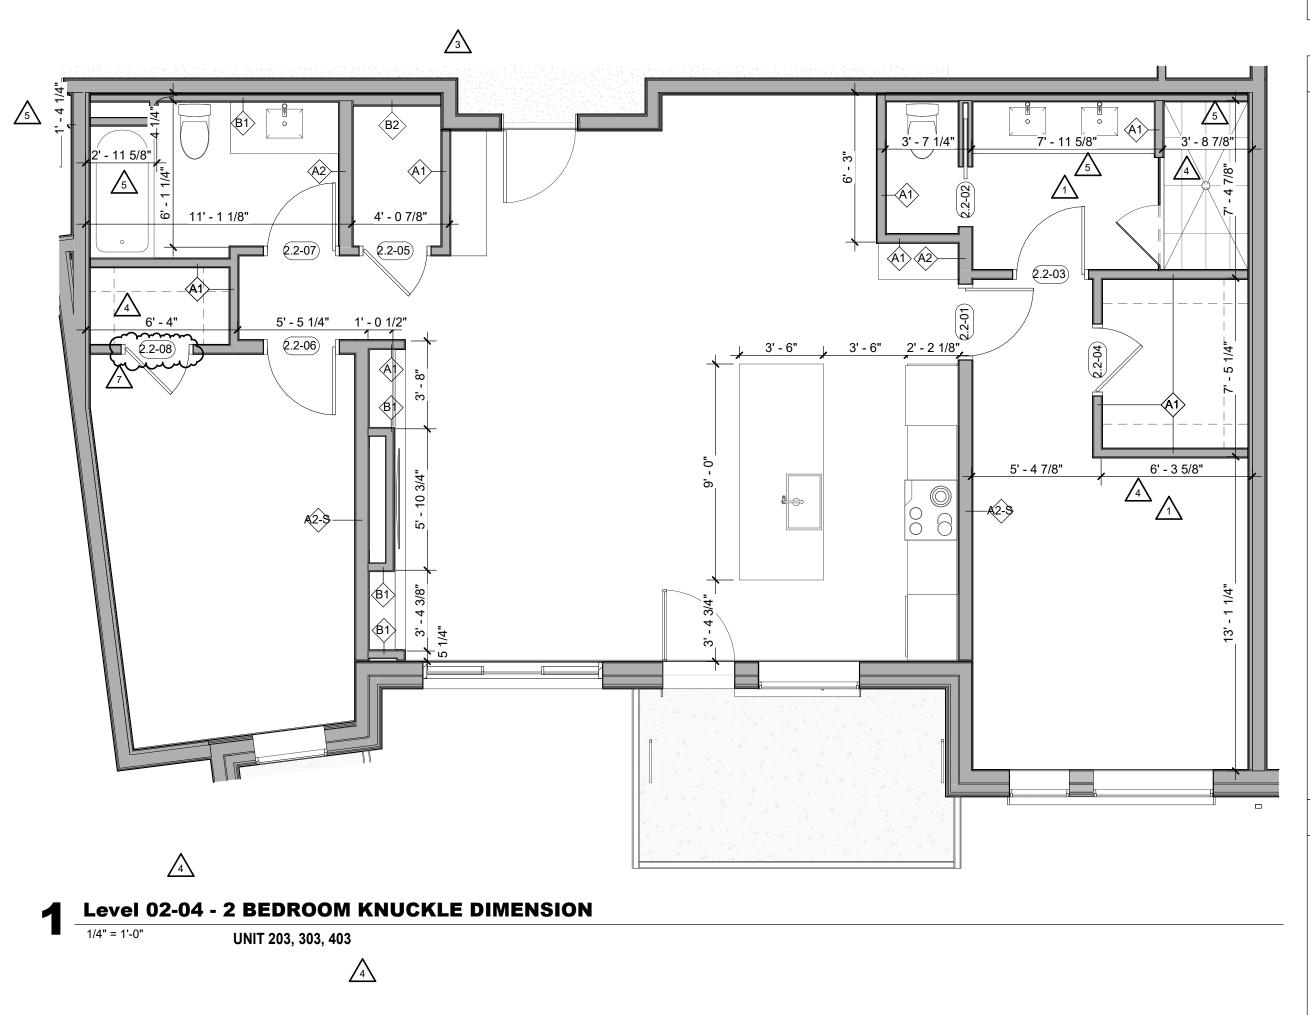
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### ENLARGED RCP - LEGEND







- REFER TO G0.2X SHEETS FOR EXTERIOR AND INTERIOR BUILDING ENCLOSURE ASSEMBLIES. REFER TO A1.0X SHEETS FOR EXTERIOR WALL, DEMISING WALL, AND CORRIDOR WALL TYPES AND LOCATIONS.
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### ENLARGED FLOOR PLAN - LEGEND

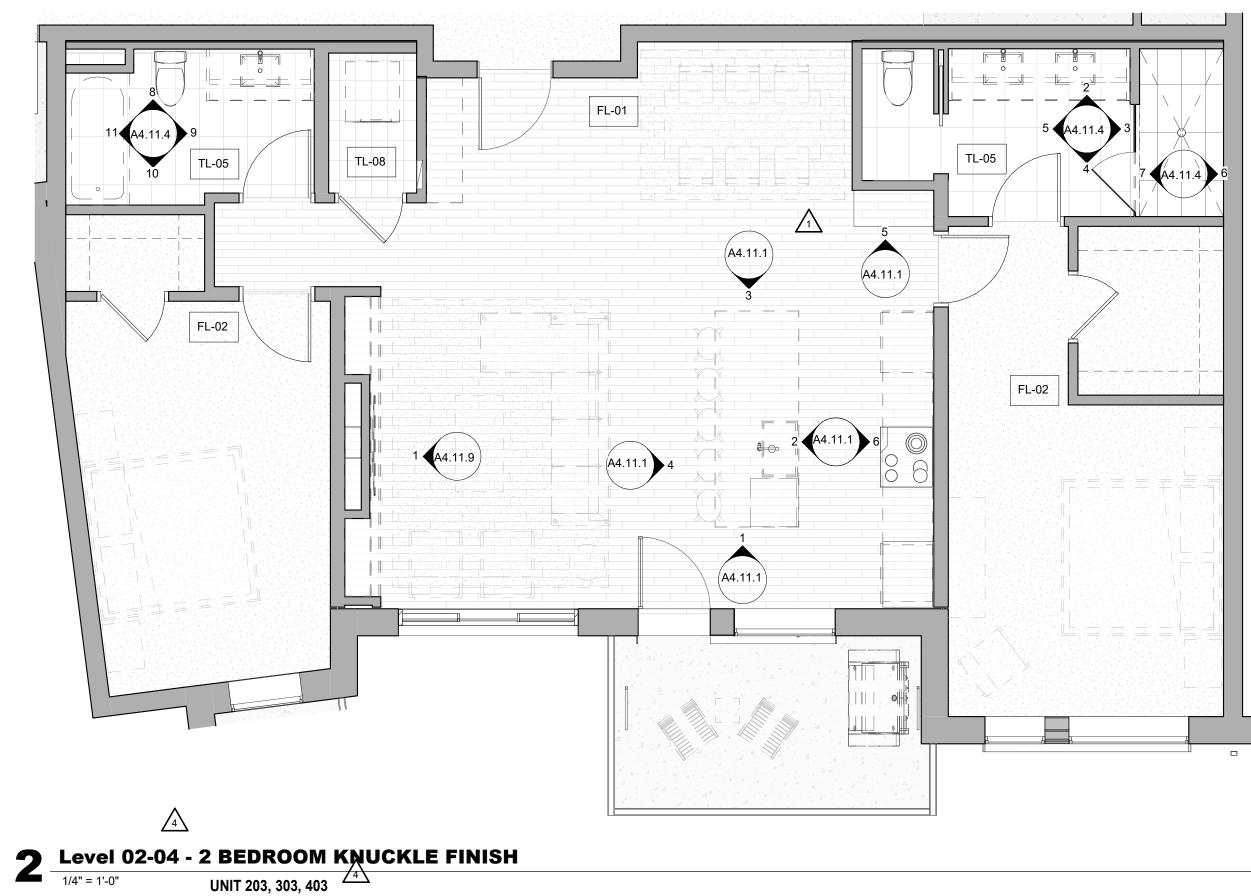- RUBBER (F7) RE: CARPET RE: FINISH SCHED. LANDSCAPE CONCRETE (F8) TILE RE: FINISH SCHED. RE: LANDSCAPE WOOD - UNIT PAVERS (F9) RE: FINISH SCHED. RE: LANDSCAPE WOOD - PUBLIC RE: FINISH SCHED. POLISHED CONC. (F5.1) INTERIOR SEALED CONC. (F5.2) INTERIOR HERRINGBONE TILE (F6) RE: FINISH SCHED. ENLARGED FLOOR PLAN - CLEARANCE NOTES FLOOR CLEARANCE \_ \_\_ \_ \_
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	The /	Steamboat	
REVISIONS		ption	Date
<b>No.</b> 1 2 3	Descri IFC SET RFI #110 RFI #125	ption	<b>Date</b> 03.15.24 06.14.24 06.24.24
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<b>No.</b> 1 2 3 4 5 6	Descri           IFC SET           RFI #110           RFI #125           ASI 004           RFI #232           RFI #223.1	ption	03.15.24 06.14.24 06.24.24 08.07.24 09.17.24 10.16.24
<b>No.</b> 1 2 3 4 5 6	Descri           IFC SET           RFI #110           RFI #125           ASI 004           RFI #232           RFI #223.1	ption	03.15.24 06.14.24 06.24.24 08.07.24 09.17.24 10.16.24
<b>No.</b> 1 2 3 4 5 6	Descri           IFC SET           RFI #110           RFI #125           ASI 004           RFI #232           RFI #223.1	ption	03.15.24 06.14.24 06.24.24 08.07.24 09.17.24 10.16.24
<b>No.</b> 1 2 3 4 5 6	Descri           IFC SET           RFI #110           RFI #125           ASI 004           RFI #232           RFI #223.1	ption	03.15.24 06.14.24 06.24.24 08.07.24 09.17.24 10.16.24
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No.           1           2           3           4           5           6           7	Descri           IFC 8ET           RFI #10           RFI #125           ASI 004           RFI #232           RFI #232           RFI #232.1           RFI #367		03.15.24 06.14.24 06.02.424 08.07.24 09.17.24 12.04.24 12.04.24
No.           1           2           3           4           5           6           7	Descri IFC 8ET RFI #110 RFI #125 ASI 004 RFI #232 RFI #232 RFI #367		03.15.24 06.14.24 06.24.24 08.07.24 09.17.24 10.16.24 12.04.24 12.04.24
No.           1           2           3           4           5           6           7	Descri           IFC SET           RFI #125           ASI 004           RFI #125           ASI 004           RFI #232           RFI #232           RFI #232           RFI #232           RFI #232           RFI #232           ASI 004           RFI #232           RFI #232           NUMBER           E	MBLE	03.15.24 06.14.24 06.24.24 08.07.24 09.17.24 10.16.24 12.04.24 12.04.24
No.           1           2           3           4           5           6           7	Descri           IFC 8ET           RFI #10           RFI #125           ASI 004           RFI #232           RFI #232           RFI #232.1           RFI #367	MBLE	03.15.24 06.14.24 06.24.24 08.07.24 09.17.24 10.16.24 12.04.24 12.04.24
No.           1           2           3           4           5           6           7	Descri           IFC SET           RFI #125           ASI 004           RFI #125           ASI 004           RFI #232           RFI #232           RFI #232           RFI #232           RFI #232           RFI #232           ASI 004           RFI #232           RFI #232           NUMBER           E           THE AI           IFC \$	MBLE	03.15.24 06.14.24 06.24.24 08.07.24 09.17.24 10.16.24 12.04.24 12.04.24

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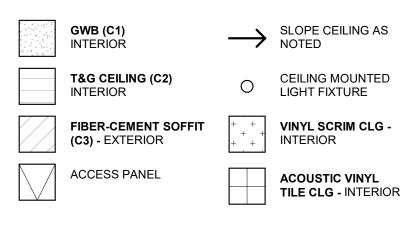
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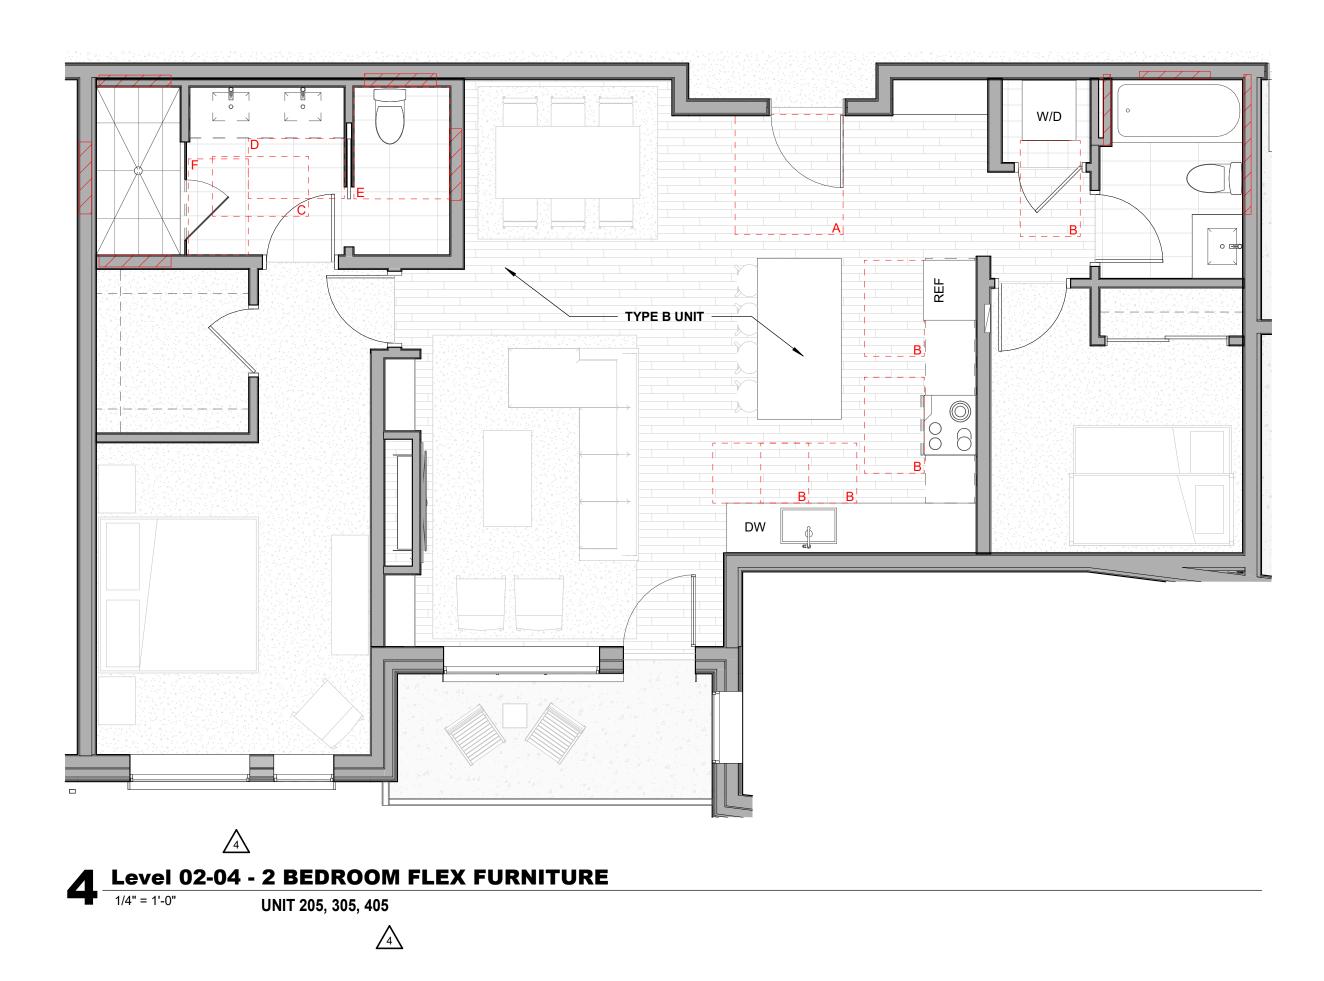
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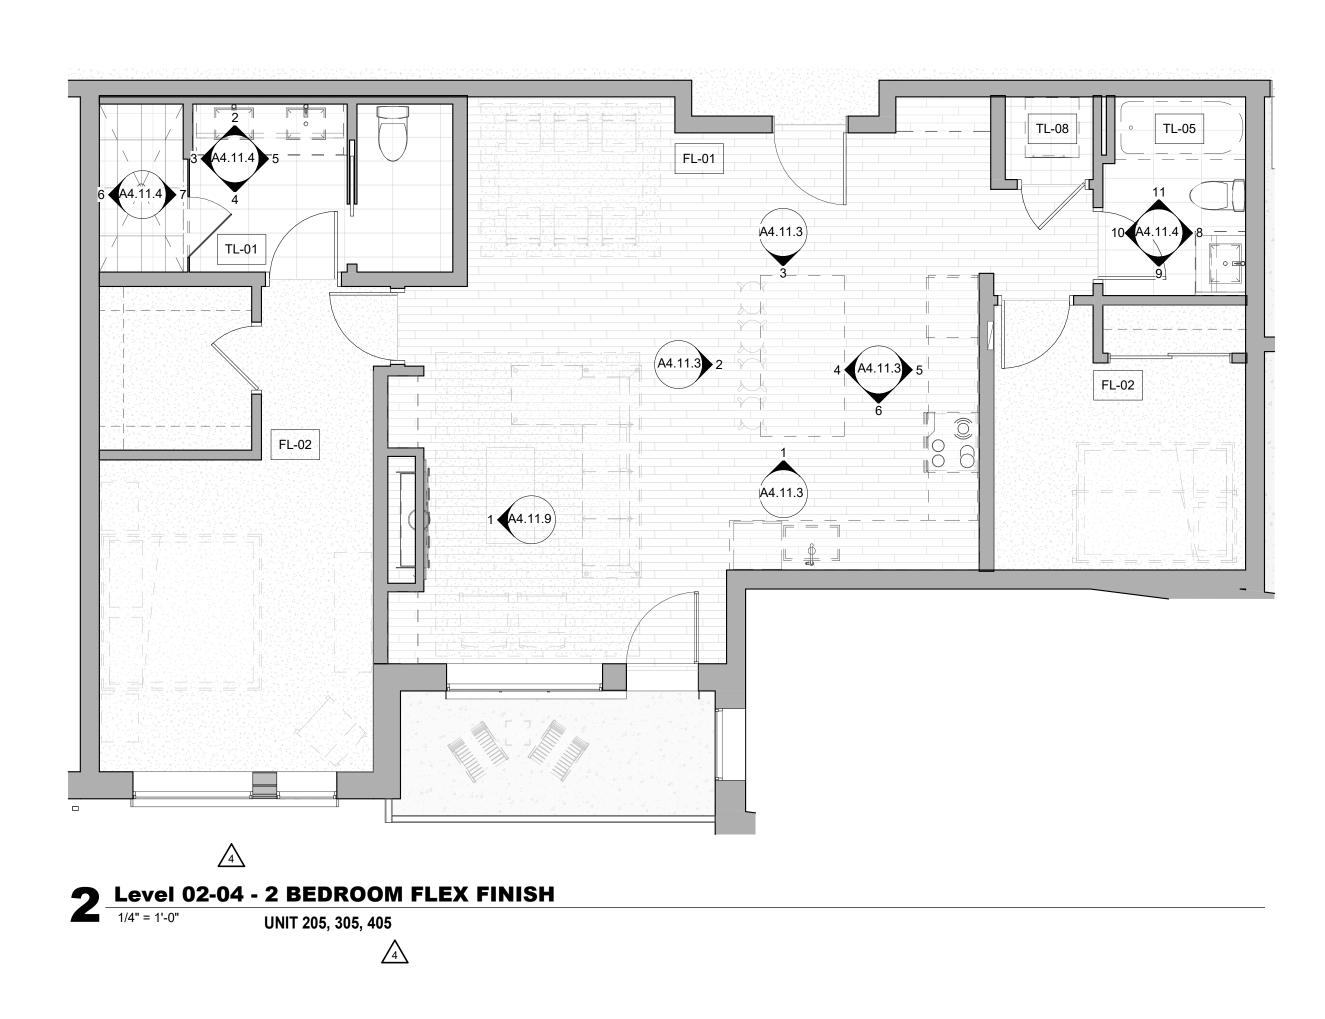
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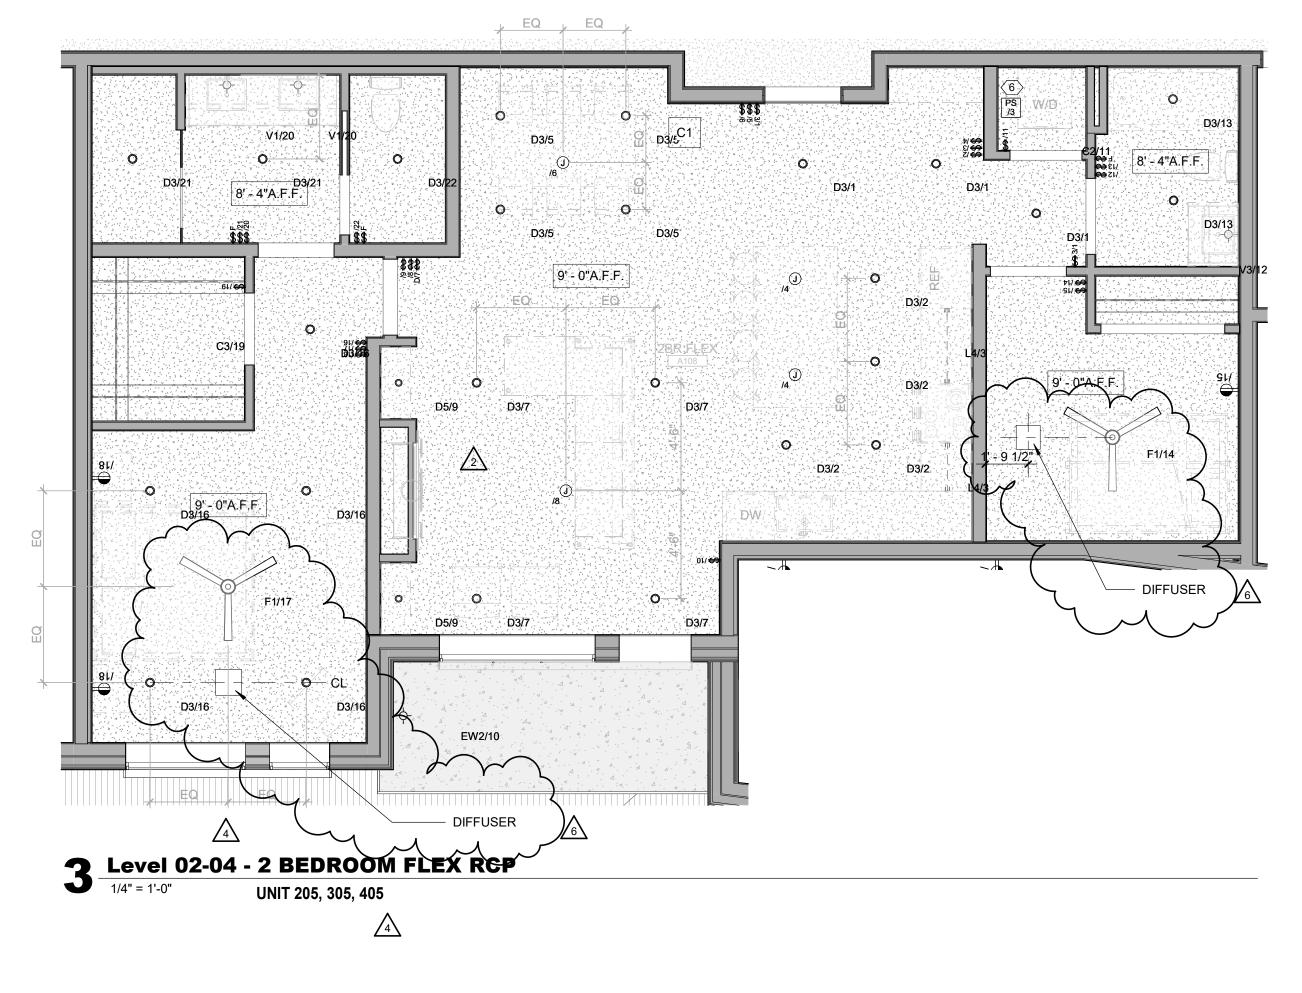
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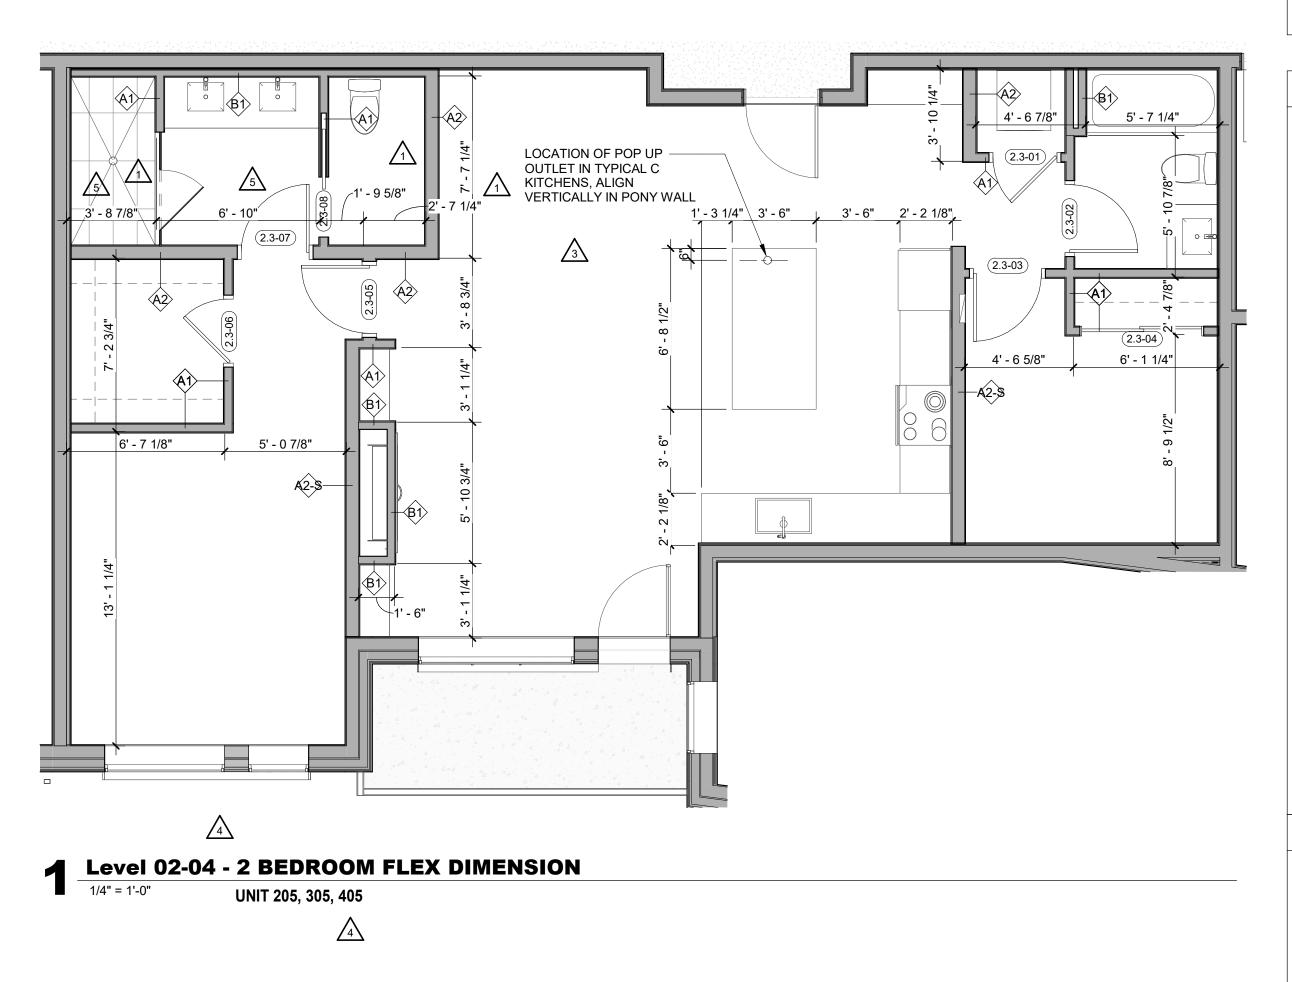


REQ. AT TOILET BLE	









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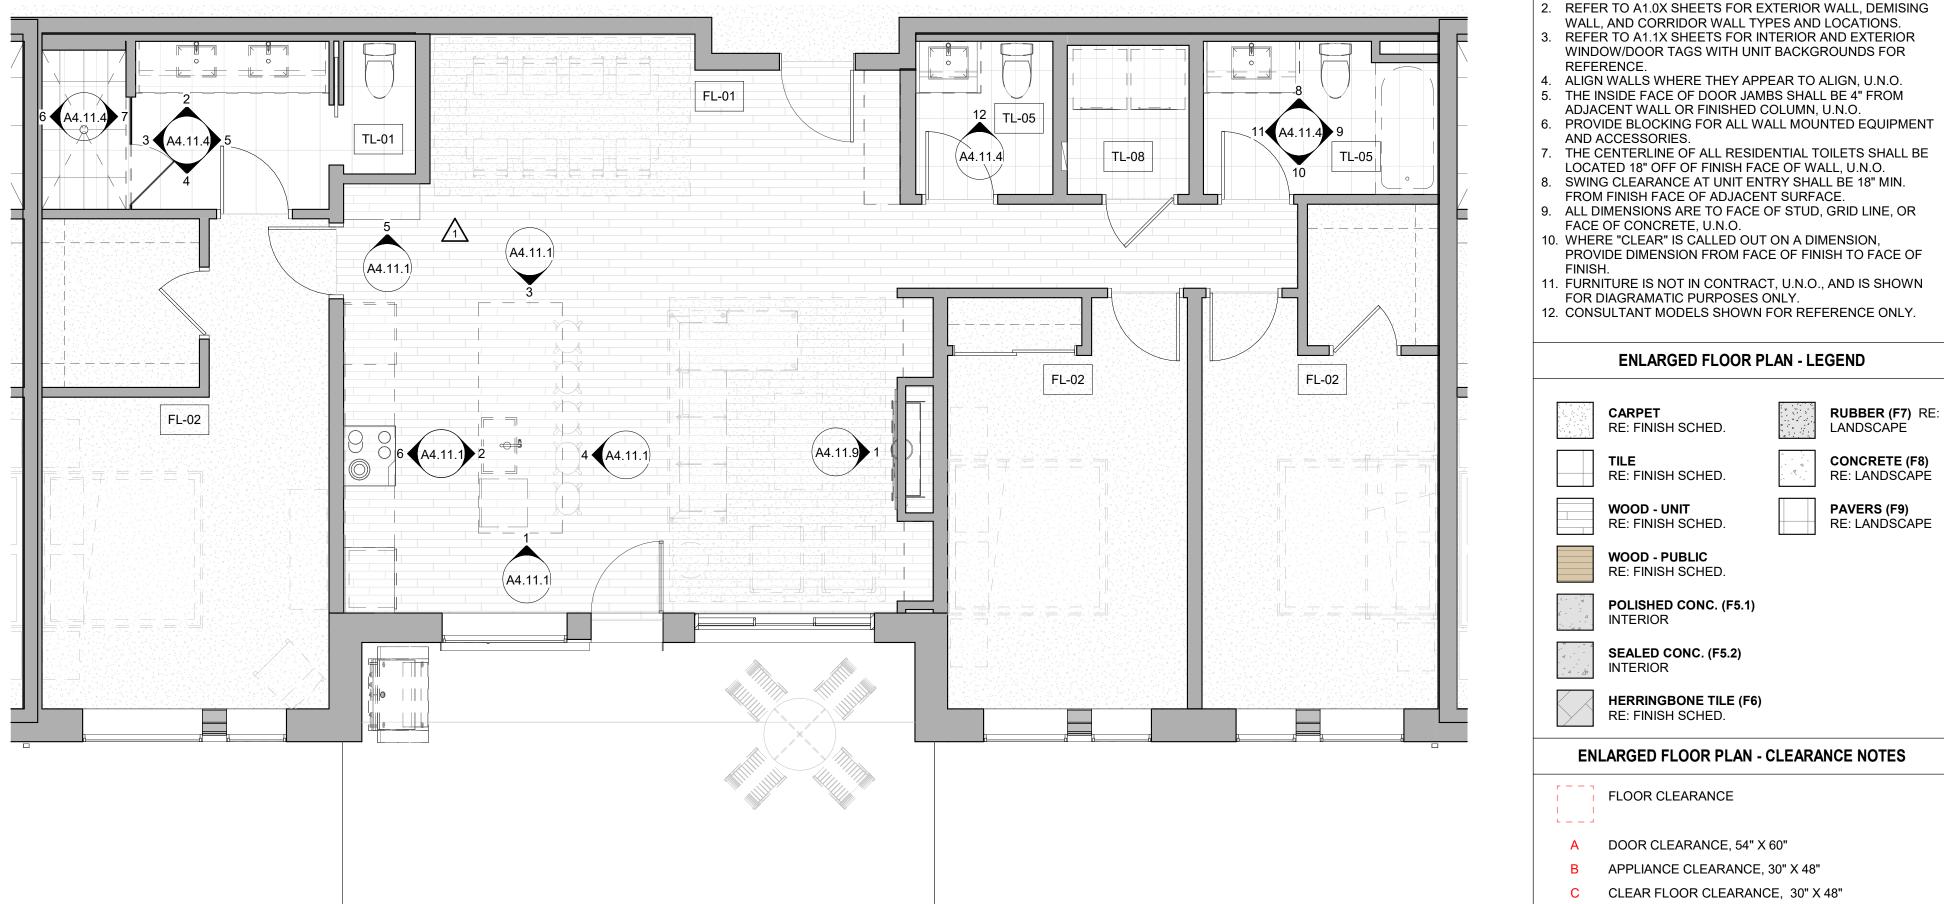
- RUBBER (F7) RE: CARPET RE: FINISH SCHED. LANDSCAPE CONCRETE (F8) TILE RE: FINISH SCHED. RE: LANDSCAPE PAVERS (F9) WOOD - UNIT RE: FINISH SCHED. RE: LANDSCAPE WOOD - PUBLIC RE: FINISH SCHED. POLISHED CONC. (F5.1) INTERIOR SEALED CONC. (F5.2) INTERIOR HERRINGBONE TILE (F6) RE: FINISH SCHED. ENLARGED FLOOR PLAN - CLEARANCE NOTES FLOOR CLEARANCE L \_ \_ J
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### ENLARGED RCP - GENERAL NOTES

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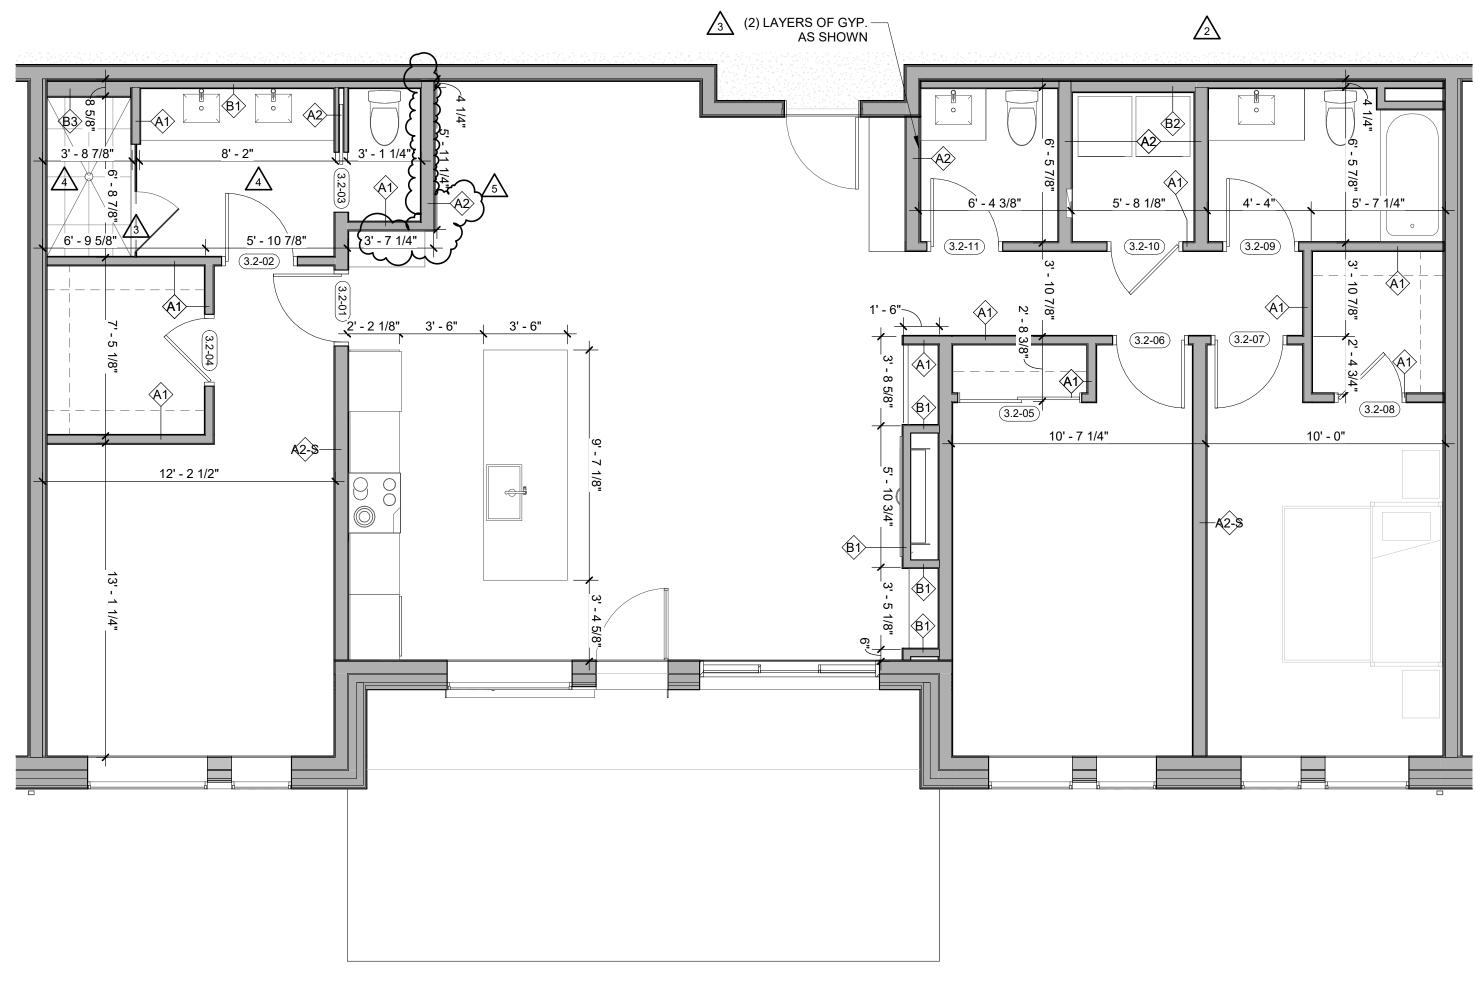
<b>GWB (C1)</b> INTERIOR	$\rightarrow$	SLOPE CEILING AS NOTED
<b>T&amp;G CEILING (C2)</b> INTERIOR	0	CEILING MOUNTED LIGHT FIXTURE
FIBER-CEMENT SOFFIT (C3) - EXTERIOR	+ + + + + +	VINYL SCRIM CLG - INTERIOR
ACCESS PANEL		ACCOUSTIC VINYL TILE CLG - INTERIOR
	INTERÌOR <b>T&amp;G CEILING (C2)</b> INTERIOR <b>FIBER-CEMENT SOFFIT</b> <b>(C3)</b> - EXTERIOR	INTERIOR T&G CEILING (C2) INTERIOR FIBER-CEMENT SOFFIT (C3) - EXTERIOR + + + + + +

BRSCED. WINS B-2465 12/15/2023
The Amble         Steamboat Springs, CO
REVISIONS           No.         Description         Date           1         IFC SET         03.15.24           2         RFI #110         06.14.24           3         RFI #232         09.17.24           6         RFI #232         09.17.24           6         RFI #232.1         10.16.24           0         10.15.24         10.15.24           1         0.15.24         10.15.24           2         RFI #232.1         10.16.24           1         0.15.24         10.15.24           1         0.15.24         10.15.24           1         0.15.24         10.15.24           1         0.15.24         10.15.24           1         0.15.24         10.15.24           1         0.15.24         10.15.24           1         0.15.24         10.15.24           1         0.15.24         10.15.24           1         0.15.24         10.15.24           1         0.15.24         10.15.24           1         0.15.24         10.15.24           1         0.115/2024         11.11/21
IFC SET IFC SET UNIT PLAN - 2 BEDROOM FLEX - LEVEL 02-04



**1** Level 01 - 3 BED FLEX FINISH 1/4" = 1'-0" **UNIT 108** 

 $\sqrt{3}$ 



Level 01 - 3 BED FLEX DIMENSION 1/4" = 1'-0" **UNIT 108** 

- REFER TO G0.2X SHEETS FOR EXTERIOR AND INTERIOR BUILDING ENCLOSURE ASSEMBLIES.

- D VANITY CLEARANCE, 30" X 48"
- E TOILET CLEARANCE, 48" X 56" OR ADA 60" X 56"
- F SHOWER/TUB CLEARANCE, 30" X 48" (B)
- G TURN AROUND CLEARANCE
- GRAB BAR BLOCKING REQ. AT TOILET WALL WHERE APPLICABLE

### ENLARGED RCP - GENERAL NOTES

- ALL UNIT CEILINGS SHALL BE 9' 0" A.F.F. U.N.O. REFER TO ENLARGED RCP'S FOR COMMON AREA CEILING HEIGHTS.
- IN THE CASE OF MINOR DISCREPANCIES BETWEEN MEP AND ARCHITECTURAL DOCUMENTS ON THE LOCATION OF CEILING MOUNTED COMPONENTS, THE ARCHITECTURAL RCP'S GOVERN. IN THE CASE OF MAJOR DISCREPANCIES, THE ARCHITECT SHALL BE NOTIFIED AS SOON AS THE DISCREPANCY IS DISCOVERED PRIOR TO PROCEEDING WITH THE WORK.
- REFERENCE MECHANICAL AND ELECTRICAL DRAWINGS FOR MOUNTING LOCATIONS OF ITEMS WHERE NO CEILING IS REQUIRED OR INDICATED.
- COORDINATE ALL TRADES INVOLVED IN THE CEILING WORK TO ENSURE CLEARANCE FOR FIXTURES, DUCTS, PIPING, CEILING SUSPENSION SYSTEMS, ETC. NECESSARY TO MAINTAIN CEILING HEIGHTS NOTED.
- LIGHTS, DIFFUSERS, EXIT SIGNS, SMOKE DETECTORS, SPEAKERS, STROBES, AND MISC. DEVICES SHALL BE CENTERED IN THE CEILING WHERE THEY OCCUR, U.N.O. FIRE PROTECTION SCOPE SHALL BE DESIGN-BUILD. ALL
- CORRIDOR SPRINKLER HEADS SHALL BE ALIGNED IN THE SAME LOCATION PARALLEL TO THE WALL WITHIN EACH SPECIFIC CEILING CONSTRUCTION.
- SMOKE ALARMS SHALL BE PROVIDED IN ALL BEDROOMS, OUTSIDE OF ALL BEDROOMS, AND ON EACH FLOOR AS REQUIRED. CARBON MONOXIDE DETECTORS SHALL BE INSTALLED OUTSIDE OF ALL BEDROOMS. SMOKE ALARMS AND CO DETECTORS SHALL BE HARDWIRED AND HAVE BATTERY BACKUP.
- ACCESS DOOR LOCATIONS IN GYPSUM BOARD CEILINGS ARE INDICATED ON RCP'S ONLY WHERE ARCHITECTURALLY SIGNIFICANT. REFERENCE SPECIFICATIONS AND MEP DRAWINGS FOR OTHER ACCESS DOOR LOCATIONS.
- UNLESS PREFINISHED TO MATCH ADJACENT SURFACE, PAINT MECHANICAL GRILLS, DIFFUSERS, ACCESS PANELS, AND OTHER EQUIPMENT TO MATCH ADJACENT SURFACE. 10. EXIT SIGNS ARE SHOWN ON RCP'S ONLY WHERE
- LOCATIONS ARE ARCHITECTURALLY SIGNIFICANT. 1. PROVIDE UL-CLASSIFIED LIGHT FIXTURES OR ENCLOSURES IN RATED FLOOR/CEILING ASSEMBLIES IN
- ACCORDANCE WITH IBC CHAPTER 7. 12. REFER TO LIGHTING PLANS FOR EXACT FIXTURE TYPES AND LOCATIONS. FIXTURES SHOWN HERE ARE
- REFERENCED AND SHOWN FOR GENERAL ALIGNMENT.

### ENLARGED RCP - LEGEND $\longrightarrow \underset{\mathsf{NOTED}}{\mathsf{SLOPE CEILING AS}}$ GWB (C1) INTERIOR T&G CEILING (C2) CEILING MOUNTED 0 LIGHT FIXTURE INTERIOR

VINYL SCRIM CLG -


INTERIOR

ACCESS PANEL


(C3) - EXTERIOR

FIBER-CEMENT SOFFIT

<b>35</b> D E S	stamp	
BASE BASE 12/15	15.10	
The Amble	Steamboat Springs, CO	
No.         Descr           1         IFC SET           2         RFI #125           3         ASI 004           4         RFI #232           5         RFI #214.1	iption Date 03.15.24 06.24.24 08.07.24 09.17.24 09.18.24	
ISSUE IFC SHEET TITLE UNIT P BEDROOM F	20019 03/15/2024 AMBLE SET SET	

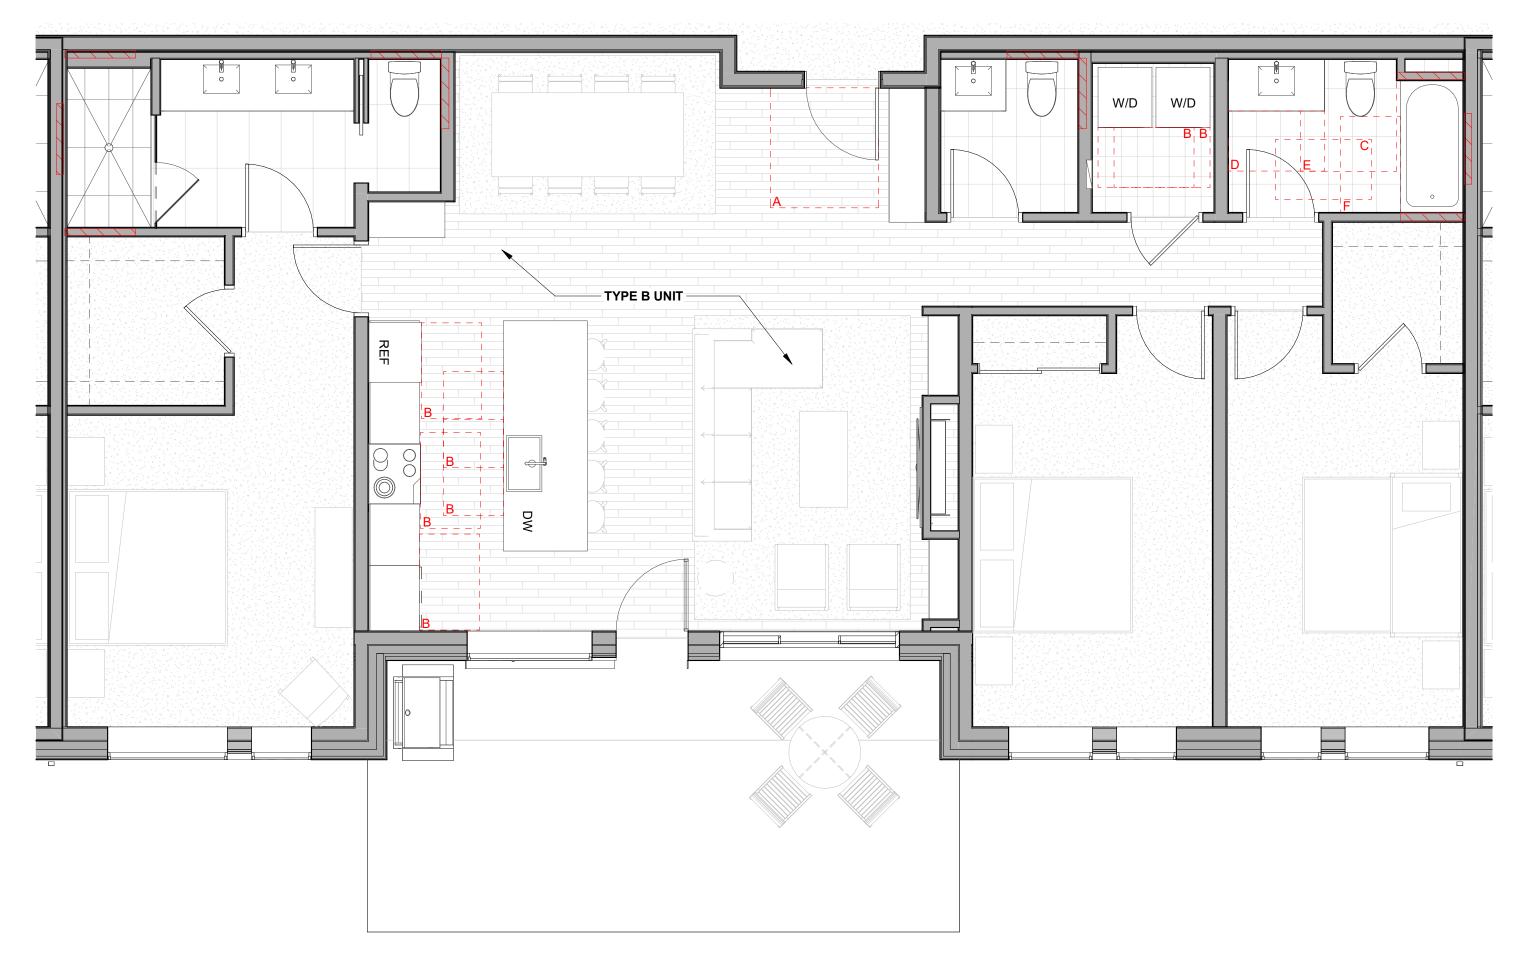




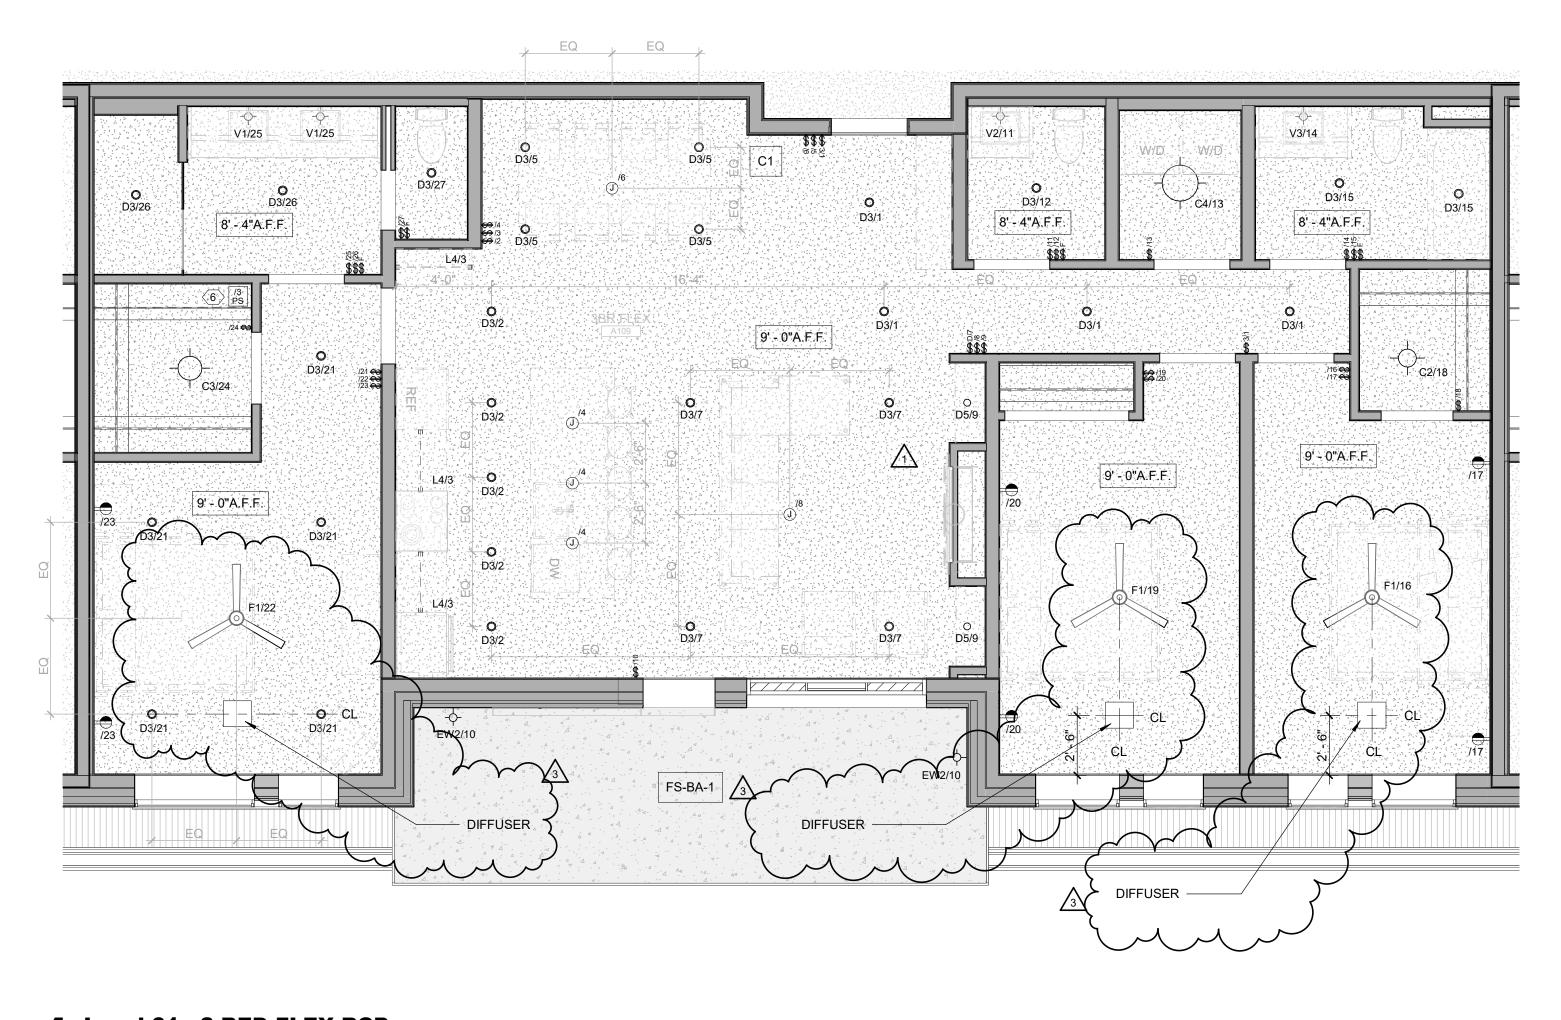

- REFER TO G0.2X SHEETS FOR EXTERIOR AND INTERIOR BUILDING ENCLOSURE ASSEMBLIES.
- REFER TO A1.0X SHEETS FOR EXTERIOR WALL, DEMISING WALL, AND CORRIDOR WALL TYPES AND LOCATIONS. REFER TO A1.1X SHEETS FOR INTERIOR AND EXTERIOR WINDOW/DOOR TAGS WITH UNIT BACKGROUNDS FOR
- REFERENCE. ALIGN WALLS WHERE THEY APPEAR TO ALIGN, U.N.O.
- THE INSIDE FACE OF DOOR JAMBS SHALL BE 4" FROM ADJACENT WALL OR FINISHED COLUMN, U.N.O.
- PROVIDE BLOCKING FOR ALL WALL MOUNTED EQUIPMENT
- AND ACCESSORIES. THE CENTERLINE OF ALL RESIDENTIAL TOILETS SHALL BE
- LOCATED 18" OFF OF FINISH FACE OF WALL, U.N.O. SWING CLEARANCE AT UNIT ENTRY SHALL BE 18" MIN.
- FROM FINISH FACE OF ADJACENT SURFACE. ALL DIMENSIONS ARE TO FACE OF STUD, GRID LINE, OR
- FACE OF CONCRETE, U.N.O. 10. WHERE "CLEAR" IS CALLED OUT ON A DIMENSION, PROVIDE DIMENSION FROM FACE OF FINISH TO FACE OF
- FINISH. 11. FURNITURE IS NOT IN CONTRACT, U.N.O., AND IS SHOWN FOR DIAGRAMATIC PURPOSES ONLY.
- 12. CONSULTANT MODELS SHOWN FOR REFERENCE ONLY.

### ENLARGED FLOOR PLAN - LEGEND

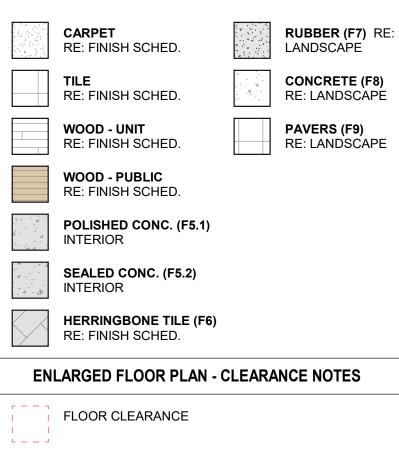


- A DOOR CLEARANCE, 54" X 60"
- B APPLIANCE CLEARANCE, 30" X 48"
- C CLEAR FLOOR CLEARANCE, 30" X 48"
- D VANITY CLEARANCE, 30" X 48"
- E TOILET CLEARANCE, 48" X 56" OR ADA 60" X 56"
- F SHOWER/TUB CLEARANCE, 30" X 48" (B)
- G TURN AROUND CLEARANCE
- GRAB BAR BLOCKING REQ. AT TOILET WALL WHERE APPLICABLE

### ENLARGED RCP - GENERAL NOTES


- ALL UNIT CEILINGS SHALL BE 9' 0" A.F.F. U.N.O. REFER TO ENLARGED RCP'S FOR COMMON AREA CEILING HEIGHTS.
- IN THE CASE OF MINOR DISCREPANCIES BETWEEN MEP AND ARCHITECTURAL DOCUMENTS ON THE LOCATION OF CEILING MOUNTED COMPONENTS, THE ARCHITECTURAL RCP'S GOVERN. IN THE CASE OF MAJOR DISCREPANCIES, THE ARCHITECT SHALL BE NOTIFIED AS SOON AS THE DISCREPANCY IS DISCOVERED PRIOR TO PROCEEDING WITH THE WORK.
- REFERENCE MECHANICAL AND ELECTRICAL DRAWINGS FOR MOUNTING LOCATIONS OF ITEMS WHERE NO CEILING IS REQUIRED OR INDICATED.
- COORDINATE ALL TRADES INVOLVED IN THE CEILING WORK TO ENSURE CLEARANCE FOR FIXTURES, DUCTS, PIPING, CEILING SUSPENSION SYSTEMS, ETC. NECESSARY TO MAINTAIN CEILING HEIGHTS NOTED.
- LIGHTS, DIFFUSERS, EXIT SIGNS, SMOKE DETECTORS, SPEAKERS, STROBES, AND MISC. DEVICES SHALL BE CENTERED IN THE CEILING WHERE THEY OCCUR, U.N.O.
- FIRE PROTECTION SCOPE SHALL BE DESIGN-BUILD. ALL CORRIDOR SPRINKLER HEADS SHALL BE ALIGNED IN THE SAME LOCATION PARALLEL TO THE WALL WITHIN EACH SPECIFIC CEILING CONSTRUCTION.
- SMOKE ALARMS SHALL BE PROVIDED IN ALL BEDROOMS, OUTSIDE OF ALL BEDROOMS, AND ON EACH FLOOR AS REQUIRED. CARBON MONOXIDE DETECTORS SHALL BE INSTALLED OUTSIDE OF ALL BEDROOMS. SMOKE ALARMS AND CO DETECTORS SHALL BE HARDWIRED AND HAVE BATTERY BACKUP.
- ACCESS DOOR LOCATIONS IN GYPSUM BOARD CEILINGS ARE INDICATED ON RCP'S ONLY WHERE ARCHITECTURALLY SIGNIFICANT. REFERENCE SPECIFICATIONS AND MEP DRAWINGS FOR OTHER
- ACCESS DOOR LOCATIONS. UNLESS PREFINISHED TO MATCH ADJACENT SURFACE, PAINT MECHANICAL GRILLS, DIFFUSERS, ACCESS PANELS, AND OTHER EQUIPMENT TO MATCH ADJACENT SURFACE.
- 10. EXIT SIGNS ARE SHOWN ON RCP'S ONLY WHERE LOCATIONS ARE ARCHITECTURALLY SIGNIFICANT. 1. PROVIDE UL-CLASSIFIED LIGHT FIXTURES OR
- ENCLOSURES IN RATED FLOOR/CEILING ASSEMBLIES IN ACCORDANCE WITH IBC CHAPTER 7. 12. REFER TO LIGHTING PLANS FOR EXACT FIXTURE TYPES AND LOCATIONS. FIXTURES SHOWN HERE ARE
- REFERENCED AND SHOWN FOR GENERAL ALIGNMENT.

<b>GWB (C1)</b> INTERIOR	$\rightarrow$	SLOPE CEILING AS NOTED
<b>T&amp;G CEILING (C2)</b> INTERIOR	0	CEILING MOUNTED LIGHT FIXTURE
FIBER-CEMENT SOFFIT (C3) - EXTERIOR	+ + + + + +	VINYL SCRIM CLG - INTERIOR
ACCESS PANEL		ACCOUSTIC VINYL Tile CLG - Interio
	INTERIOR <b>T&amp;G CEILING (C2)</b> INTERIOR <b>FIBER-CEMENT SOFFIT</b> <b>(C3)</b> - EXTERIOR	INTERIOR T&G CEILING (C2) INTERIOR FIBER-CEMENT SOFFIT (C3) - EXTERIOR (C2) (C

<text><text></text></text>
BRUCE D. MINS B-2465 12/15/2023
The Amble         Steamboat Springs, CO
REVISIONS         No.       Description       Date         1       06.14.24       06.07.24         2       ASI 004       06.07.24         3       RFI #223.1       10.16.24         4       06.07.24       10.16.24         4       01.016.24       04.012         10       01.16.24       04.012         10       01.16.24       04.012         10       01.16.24       04.012         10       01.16.24       04.012         10       01.16.24       04.012         10       01.16.24       04.012         10       01.16.24       04.012         10       01.16.24       04.012         10       01.16.24       04.014         10       01.016.24       04.014         10       01.016.24       04.014         10       01.016.24       04.014         10       01.016.24       04.014         10       01.016.24       04.014         10       01.016.24       04.014         10       01.016.24       04.014         10       01.016.24       04.014         10       01.016.24       04.0
SHEET TITLE UNIT PLAN - 3 BEDROOM FLEX - LEVEL 01 SHEET NO.

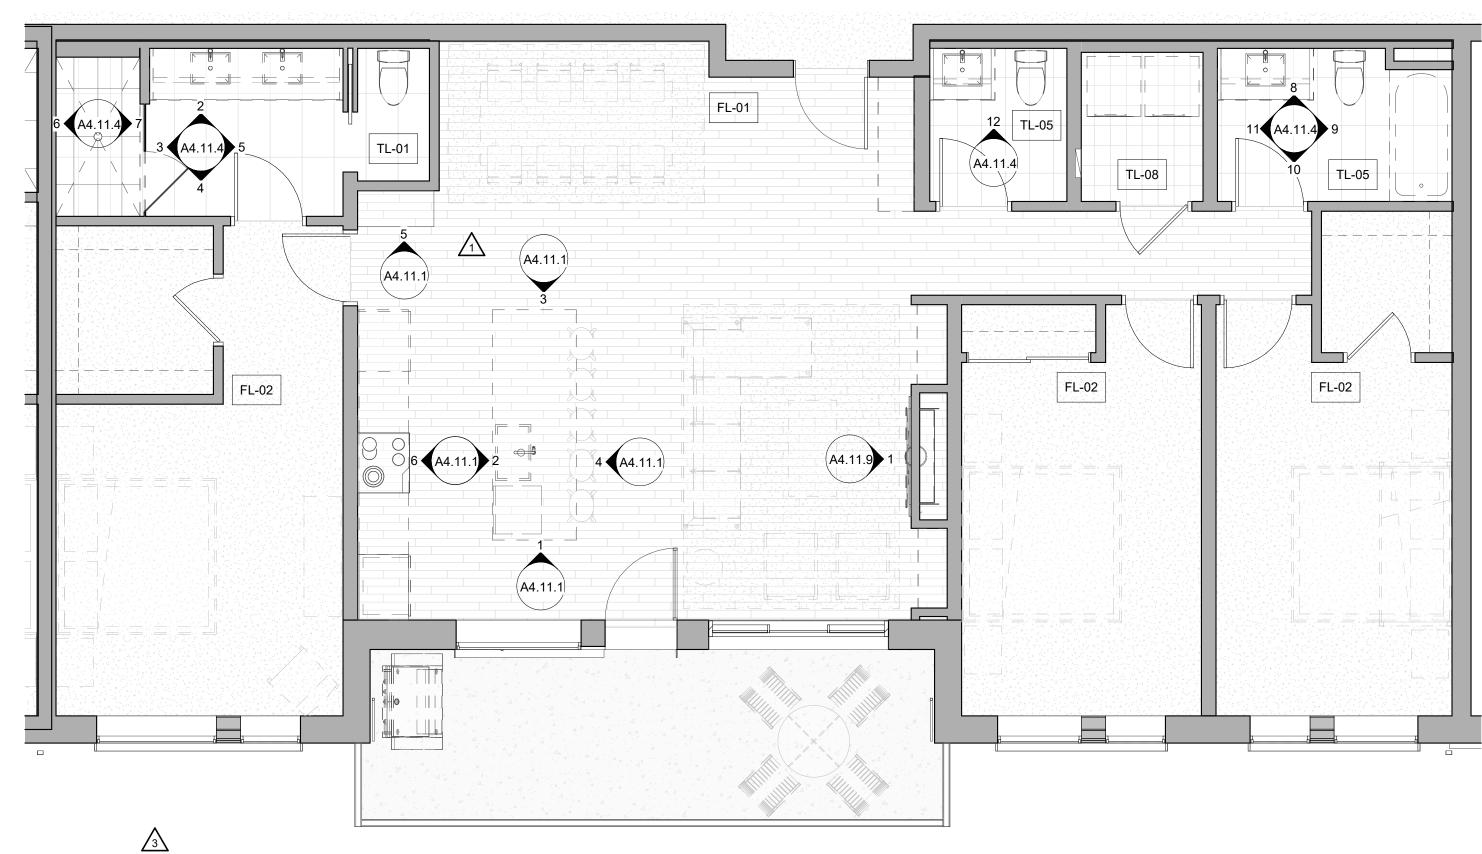




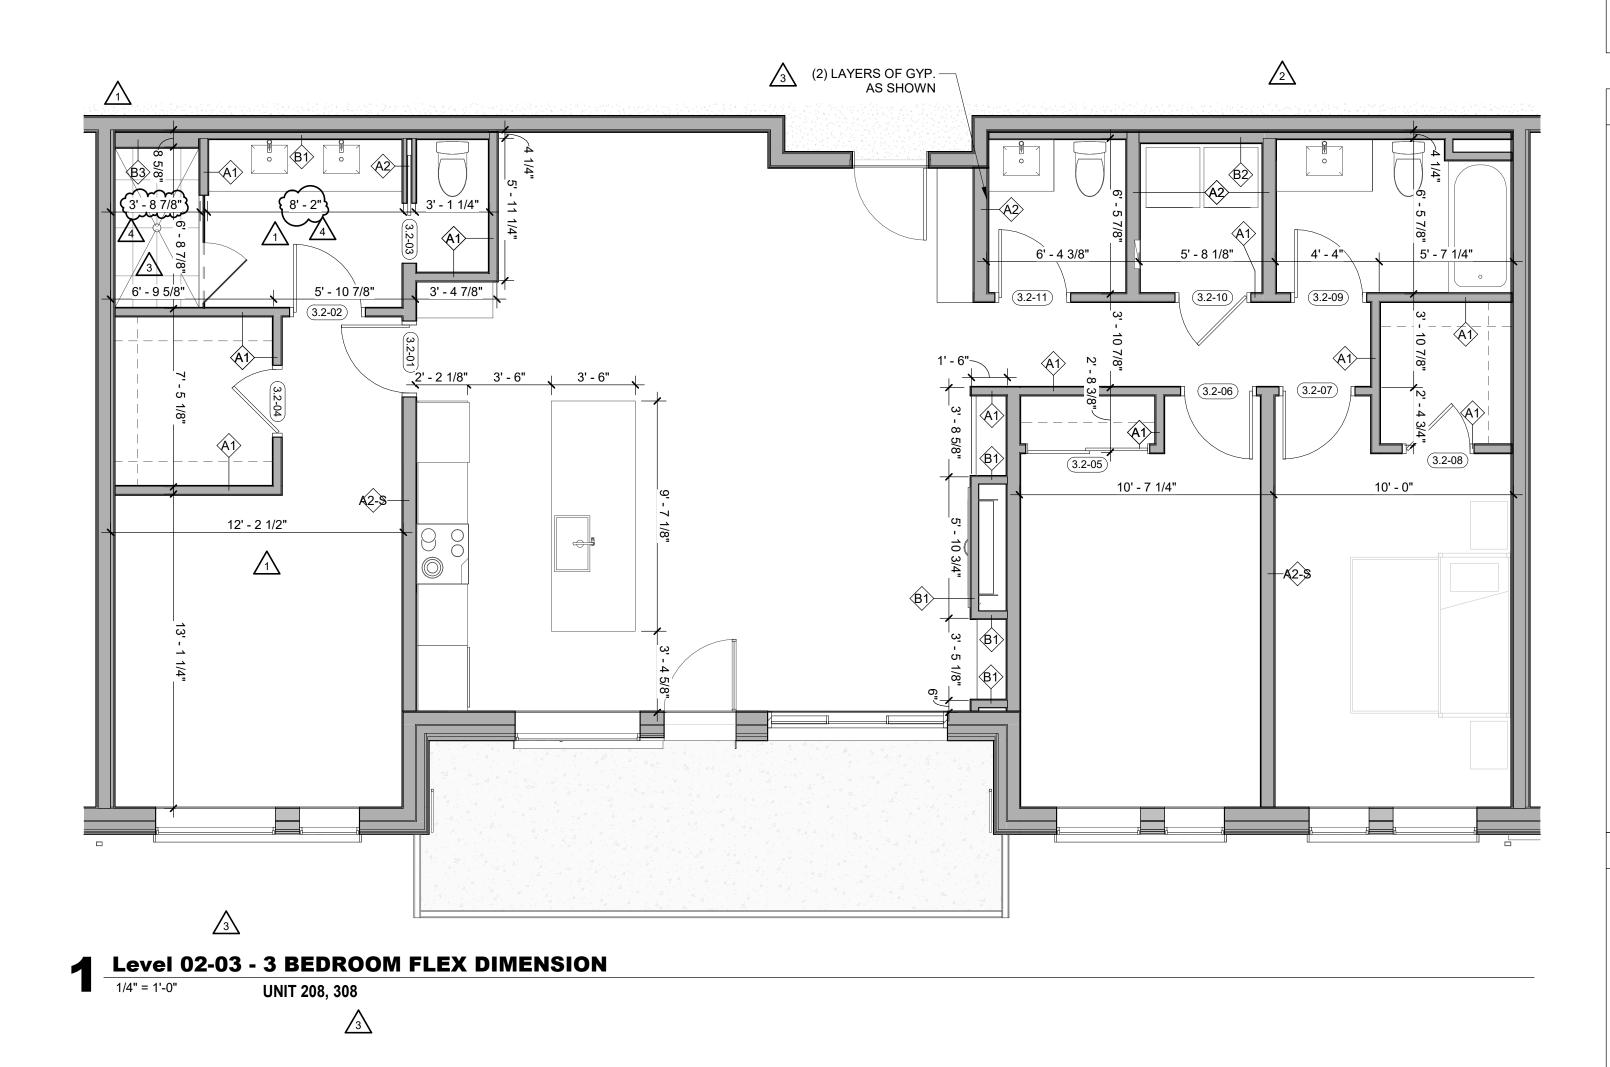

- . REFER TO G0.2X SHEETS FOR EXTERIOR AND INTERIOR BUILDING ENCLOSURE ASSEMBLIES.
- REFER TO A1.0X SHEETS FOR EXTERIOR WALL, DEMISING WALL, AND CORRIDOR WALL TYPES AND LOCATIONS.
   REFER TO A1.1X SHEETS FOR INTERIOR AND EXTERIOR
- WINDOW/DOOR TAGS WITH UNIT BACKGROUNDS FOR REFERENCE. 4. ALIGN WALLS WHERE THEY APPEAR TO ALIGN, U.N.O.
- 5. THE INSIDE FACE OF DOOR JAMBS SHALL BE 4" FROM ADJACENT WALL OR FINISHED COLUMN, U.N.O.
- 6. PROVIDE BLOCKING FOR ALL WALL MOUNTED EQUIPMENT
- AND ACCESSORIES. 7. THE CENTERLINE OF ALL RESIDENTIAL TOILETS SHALL BE
- LOCATED 18" OFF OF FINISH FACE OF WALL, U.N.O. 3. SWING CLEARANCE AT UNIT ENTRY SHALL BE 18" MIN.
- FROM FINISH FACE OF ADJACENT SURFACE. ALL DIMENSIONS ARE TO FACE OF STUD, GRID LINE, OR
- FACE OF CONCRETE, U.N.O.10. WHERE "CLEAR" IS CALLED OUT ON A DIMENSION, PROVIDE DIMENSION FROM FACE OF FINISH TO FACE OF
- FINISH. 11. FURNITURE IS NOT IN CONTRACT, U.N.O., AND IS SHOWN
- FOR DIAGRAMATIC PURPOSES ONLY. 12. CONSULTANT MODELS SHOWN FOR REFERENCE ONLY.

### ENLARGED FLOOR PLAN - LEGEND

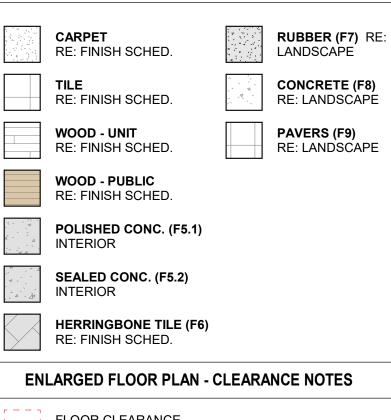

### FLOOR CLEARANCE

A DOOR CLEARANCE, 54" X 60"


- B APPLIANCE CLEARANCE, 30" X 48"
- C CLEAR FLOOR CLEARANCE, 30" X 48"
- D VANITY CLEARANCE, 30" X 48"
- E TOILET CLEARANCE, 48" X 56" OR ADA 60" X 56"
- F SHOWER/TUB CLEARANCE, 30" X 48" (B)
- G TURN AROUND CLEARANCE
- GRAB BAR BLOCKING REQ. AT TOILET WALL WHERE APPLICABLE

### ENLARGED RCP - GENERAL NOTES


- 1. ALL UNIT CEILINGS SHALL BE 9' 0" A.F.F. U.N.O. REFER TO ENLARGED RCP'S FOR COMMON AREA CEILING HEIGHTS.
- 2. IN THE CASE OF MINOR DISCREPANCIES BETWEEN MEP AND ARCHITECTURAL DOCUMENTS ON THE LOCATION OF CEILING MOUNTED COMPONENTS, THE ARCHITECTURAL RCP'S GOVERN. IN THE CASE OF MAJOR DISCREPANCIES, THE ARCHITECT SHALL BE NOTIFIED AS SOON AS THE DISCREPANCY IS DISCOVERED PRIOR TO PROCEEDING WITH THE WORK.
- 3. REFERENCE MECHANICAL AND ELECTRICAL DRAWINGS FOR MOUNTING LOCATIONS OF ITEMS WHERE NO CEILING IS REQUIRED OR INDICATED.
- 4. COORDINATE ALL TRADES INVOLVED IN THE CEILING WORK TO ENSURE CLEARANCE FOR FIXTURES, DUCTS, PIPING, CEILING SUSPENSION SYSTEMS, ETC. NECESSARY TO MAINTAIN CEILING HEIGHTS NOTED.
- LIGHTS, DIFFUSERS, EXIT SIGNS, SMOKE DETECTORS, SPEAKERS, STROBES, AND MISC. DEVICES SHALL BE CENTERED IN THE CEILING WHERE THEY OCCUR, U.N.O.
   FIRE PROTECTION SCOPE SHALL BE DESIGN-BUILD. ALL
- CORRIDOR SPRINKLER HEADS SHALL BE ALIGNED IN THE SAME LOCATION PARALLEL TO THE WALL WITHIN EACH SPECIFIC CEILING CONSTRUCTION.
- 7. SMOKE ALARMS SHALL BE PROVIDED IN ALL BEDROOMS, OUTSIDE OF ALL BEDROOMS, AND ON EACH FLOOR AS REQUIRED. CARBON MONOXIDE DETECTORS SHALL BE INSTALLED OUTSIDE OF ALL BEDROOMS. SMOKE ALARMS AND CO DETECTORS SHALL BE HARDWIRED AND HAVE BATTERY BACKUP.
- 8. ACCESS DOOR LOCATIONS IN GYPSUM BOARD CEILINGS ARE INDICATED ON RCP'S ONLY WHERE ARCHITECTURALLY SIGNIFICANT. REFERENCE SPECIFICATIONS AND MEP DRAWINGS FOR OTHER ACCESS DOOR LOCATIONS.
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   EXIT SIGNS ARE SHOWN ON RCP'S ONLY WHERE
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GWB (C1) INTERIOR	$\rightarrow$	SLOPE CEILING AS NOTED
T&G CEILING (C2) INTERIOR	0	CEILING MOUNTED LIGHT FIXTURE
FIBER-CEMENT SOFFIT (C3) - EXTERIOR	+ + + + + + + + + + + + + + + + + + + +	VINYL SCRIM CLG - INTERIOR
ACCESS PANEL		

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BRUCE D. MINS B-2465 12/15/2023
The Amble         Steamboat Springs, CO
No.         Description         Date           1         IFC SET         03.15.24           2         RFI #125         06.24.24           3         ASI 004         08.07.24           4         RFI #232         09.17.24           -         -         -           -         -         -           -         -         -           -         -         -
PROJECT NUMBER 2019 ISSUE DATE 03/15/2024 THE AMBLE
SHEET TITLE UNIT PLAN - 3 BEDROOM FLEX - LEVELS 02-03 SHEET NO.



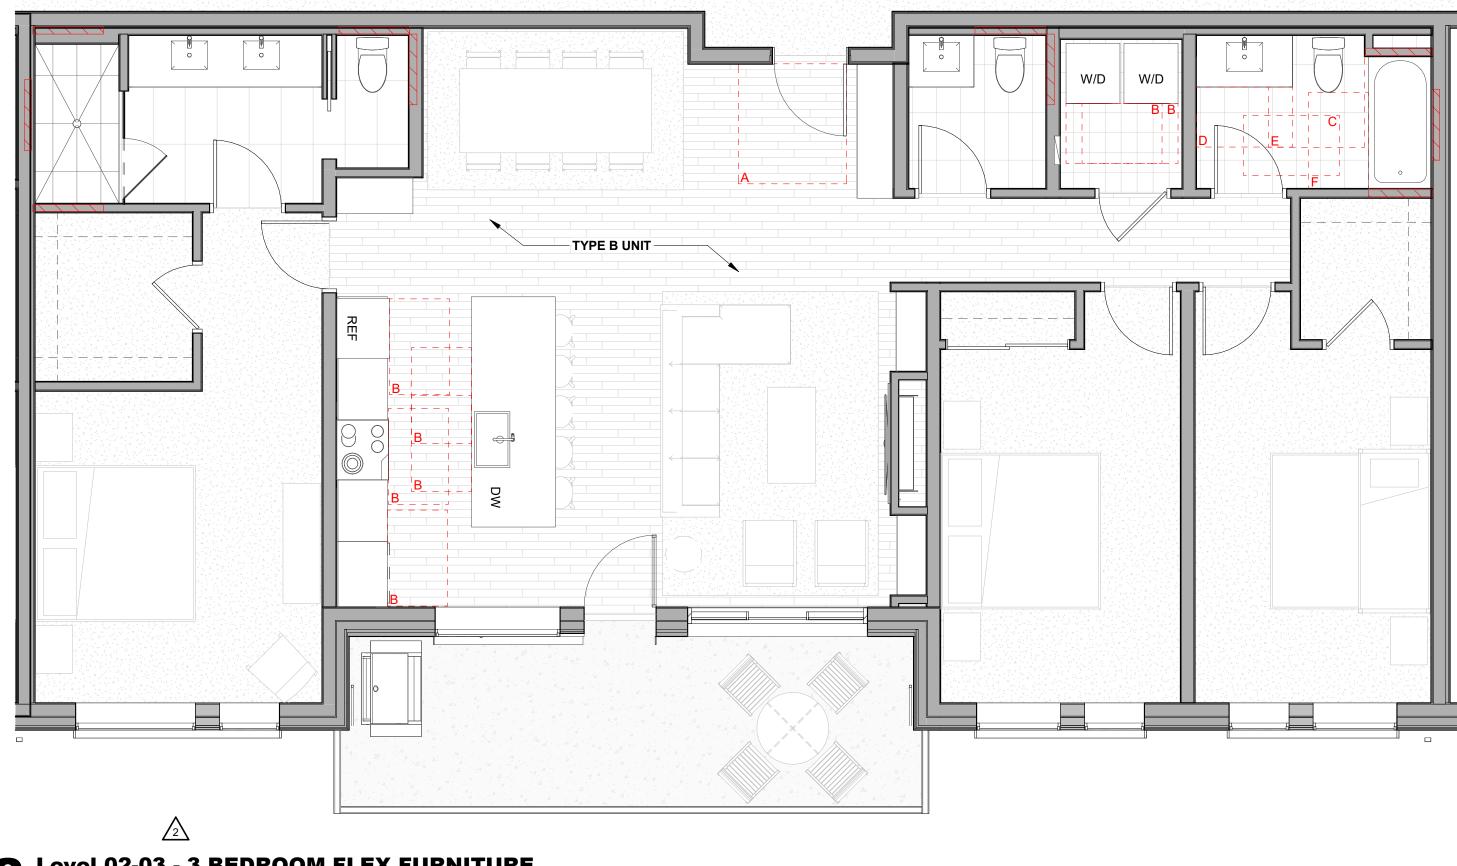

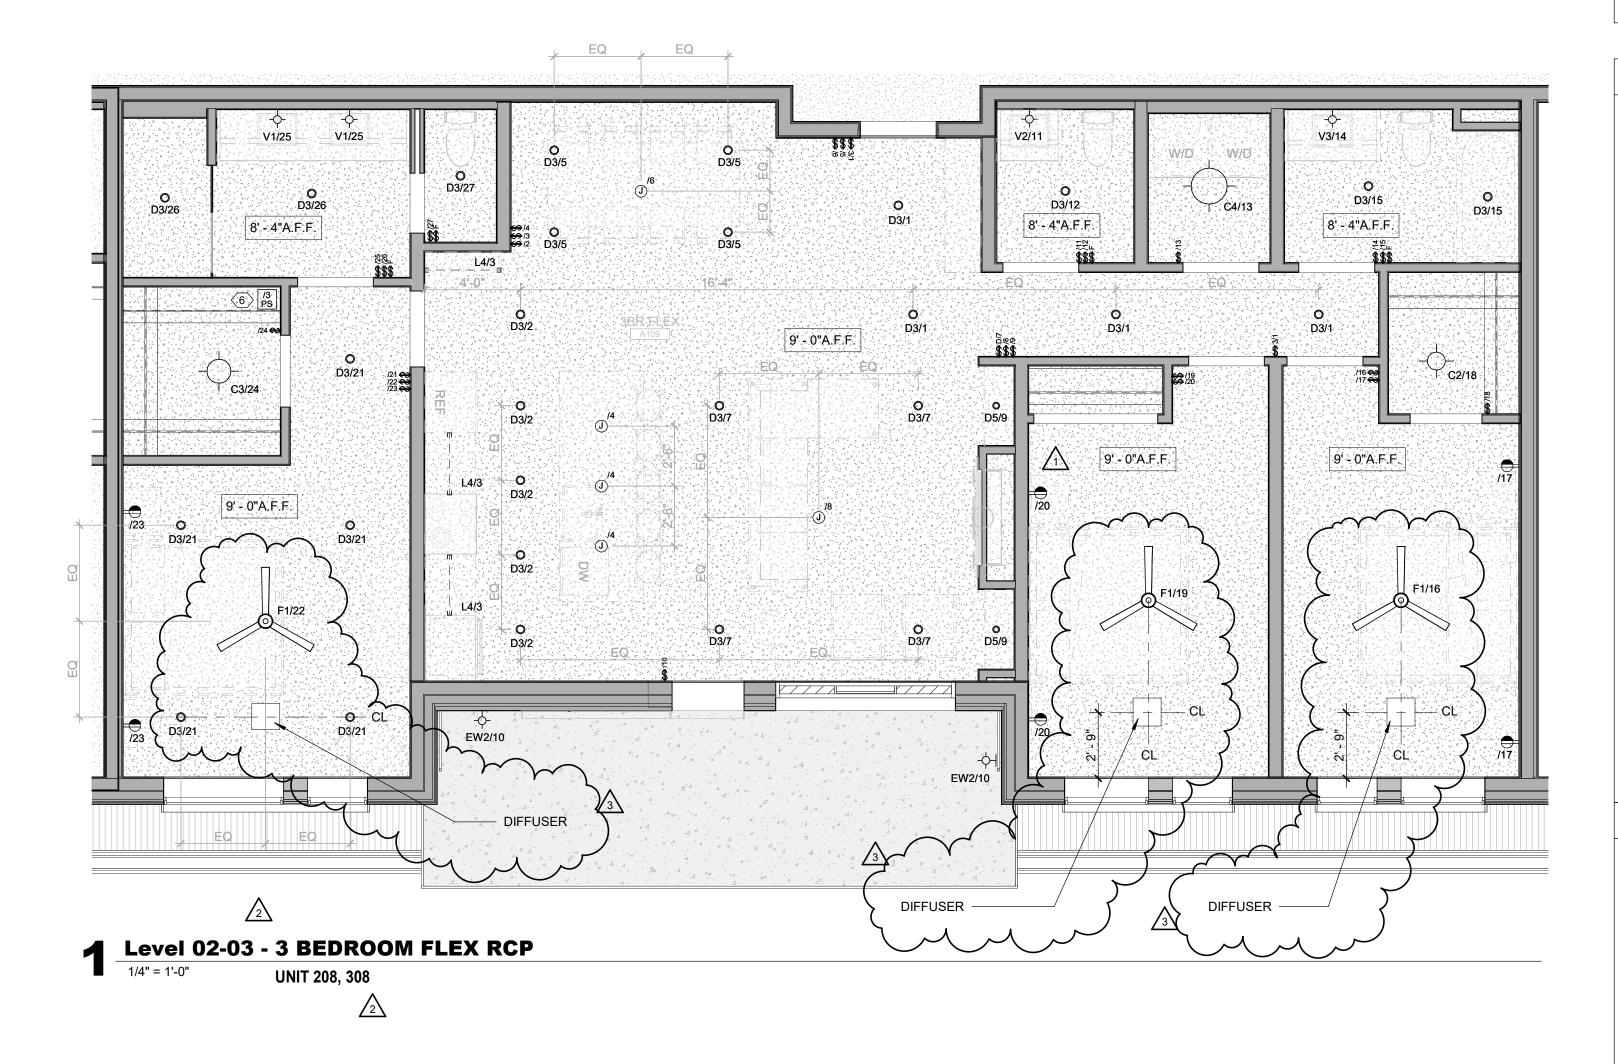


REFER TO G0.2X SHEETS FOR EXTERIOR AND INTERIOR

BUILDING ENCLOSURE ASSEMBLIES.

- 2. REFER TO A1.0X SHEETS FOR EXTERIOR WALL, DEMISING WALL, AND CORRIDOR WALL TYPES AND LOCATIONS.
- REFER TO A1.1X SHEETS FOR INTERIOR AND EXTERIOR WINDOW/DOOR TAGS WITH UNIT BACKGROUNDS FOR REFERENCE.
   ALIGN WALLS WHERE THEY APPEAR TO ALIGN, U.N.O.
- 5. THE INSIDE FACE OF DOOR JAMBS SHALL BE 4" FROM
- ADJACENT WALL OR FINISHED COLUMN, U.N.O. 6. PROVIDE BLOCKING FOR ALL WALL MOUNTED EQUIPMENT
- AND ACCESSORIES. 7. THE CENTERLINE OF ALL RESIDENTIAL TOILETS SHALL BE
- LOCATED 18" OFF OF FINISH FACE OF WALL, U.N.O. 8. SWING CLEARANCE AT UNIT ENTRY SHALL BE 18" MIN.
- FROM FINISH FACE OF ADJACENT SURFACE. 9. ALL DIMENSIONS ARE TO FACE OF STUD, GRID LINE, OR
- FACE OF CONCRETE, U.N.O. 10. WHERE "CLEAR" IS CALLED OUT ON A DIMENSION, PROVIDE DIMENSION FROM FACE OF FINISH TO FACE OF
- FINISH. 11. FURNITURE IS NOT IN CONTRACT, U.N.O., AND IS SHOWN
- FOR DIAGRAMATIC PURPOSES ONLY. 12. CONSULTANT MODELS SHOWN FOR REFERENCE ONLY.

### ENLARGED FLOOR PLAN - LEGEND

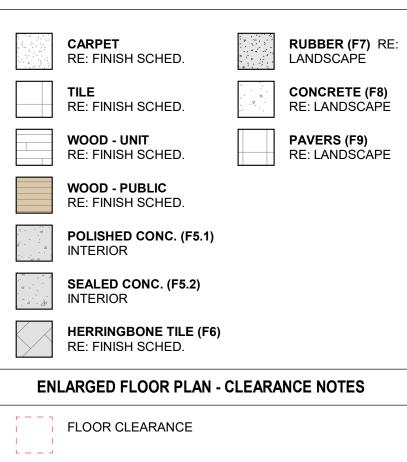


- A DOOR CLEARANCE, 54" X 60"
- B APPLIANCE CLEARANCE, 30" X 48"
- C CLEAR FLOOR CLEARANCE, 30" X 48"
- D VANITY CLEARANCE, 30" X 48"
- E TOILET CLEARANCE, 48" X 56" OR ADA 60" X 56"
- F SHOWER/TUB CLEARANCE, 30" X 48" (B)
- G TURN AROUND CLEARANCE
- GRAB BAR BLOCKING REQ. AT TOILET WALL WHERE APPLICABLE

### ENLARGED RCP - GENERAL NOTES


- 1. ALL UNIT CEILINGS SHALL BE 9' 0" A.F.F. U.N.O. REFER TO ENLARGED RCP'S FOR COMMON AREA CEILING HEIGHTS.
- 2. IN THE CASE OF MINOR DISCREPANCIES BETWEEN MEP AND ARCHITECTURAL DOCUMENTS ON THE LOCATION OF CEILING MOUNTED COMPONENTS, THE ARCHITECTURAL RCP'S GOVERN. IN THE CASE OF MAJOR DISCREPANCIES, THE ARCHITECT SHALL BE NOTIFIED AS SOON AS THE DISCREPANCY IS DISCOVERED PRIOR TO PROCEEDING WITH THE WORK.
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- 4. COORDINATE ALL TRADES INVOLVED IN THE CEILING WORK TO ENSURE CLEARANCE FOR FIXTURES, DUCTS, PIPING, CEILING SUSPENSION SYSTEMS, ETC. NECESSARY TO MAINTAIN CEILING HEIGHTS NOTED.
- 5. LIGHTS, DIFFUSERS, EXIT SIGNS, SMOKE DETECTORS, SPEAKERS, STROBES, AND MISC. DEVICES SHALL BE CENTERED IN THE CEILING WHERE THEY OCCUR, U.N.O.
- 6. FIRE PROTECTION SCOPE SHALL BE DESIGN-BUILD. ALL CORRIDOR SPRINKLER HEADS SHALL BE ALIGNED IN THE SAME LOCATION PARALLEL TO THE WALL WITHIN EACH SPECIFIC CEILING CONSTRUCTION.
- 7. SMOKE ALARMS SHALL BE PROVIDED IN ALL BEDROOMS, OUTSIDE OF ALL BEDROOMS, AND ON EACH FLOOR AS REQUIRED. CARBON MONOXIDE DETECTORS SHALL BE INSTALLED OUTSIDE OF ALL BEDROOMS. SMOKE ALARMS AND CO DETECTORS SHALL BE HARDWIRED AND HAVE BATTERY BACKUP.
- 8. ACCESS DOOR LOCATIONS IN GYPSUM BOARD CEILINGS ARE INDICATED ON RCP'S ONLY WHERE ARCHITECTURALLY SIGNIFICANT. REFERENCE SPECIFICATIONS AND MEP DRAWINGS FOR OTHER
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   PROVIDE UL-CLASSIFIED LIGHT FIXTURES OR
- ENCLOSURES IN RATED FLOOR/CEILING ASSEMBLIES IN ACCORDANCE WITH IBC CHAPTER 7.12. REFER TO LIGHTING PLANS FOR EXACT FIXTURE TYPES AND LOCATIONS. FIXTURES SHOWN HERE ARE
- REFERENCED AND SHOWN FOR GENERAL ALIGNMENT.

<b>GWB (C1)</b> INTERIOR	$\rightarrow$	SLOPE CEILING AS NOTED
<b>T&amp;G CEILING (C2)</b> INTERIOR	0	CEILING MOUNTED LIGHT FIXTURE
FIBER-CEMENT SOFFIT (C3) - EXTERIOR	+ + + + + +	VINYL SCRIM CLG - Interior
ACCESS PANEL		ACCOUSTIC VINYL
		TILE CLG - INTERIOF

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BRUCE D. MINS B-2465 12/15/2023
The Amble         Steamboat Springs, CO
IFC SET IFC SET SHEET TITLE UNIT PLAN - 3 BEDROOM FLEX - LEVELS 02-03 SHEET NO.

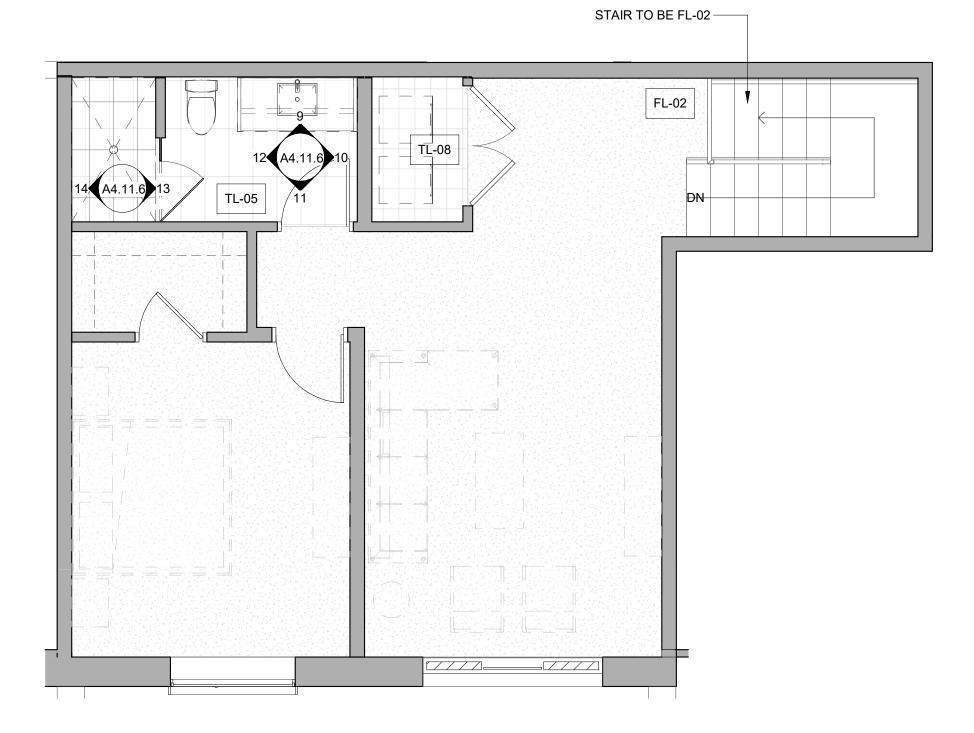




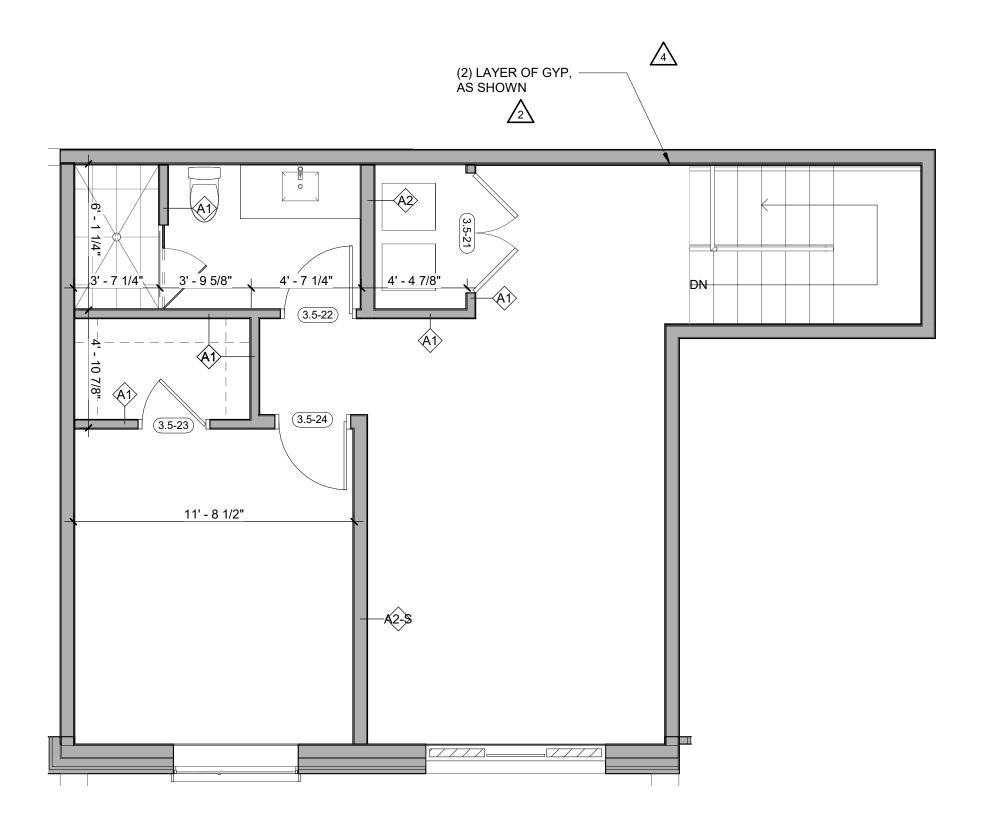


**3 LEVEL 05 - 3 BED FLEX DIMENSION** 1/4" = 1'-0" UNIT 408

**UNIT 408** 

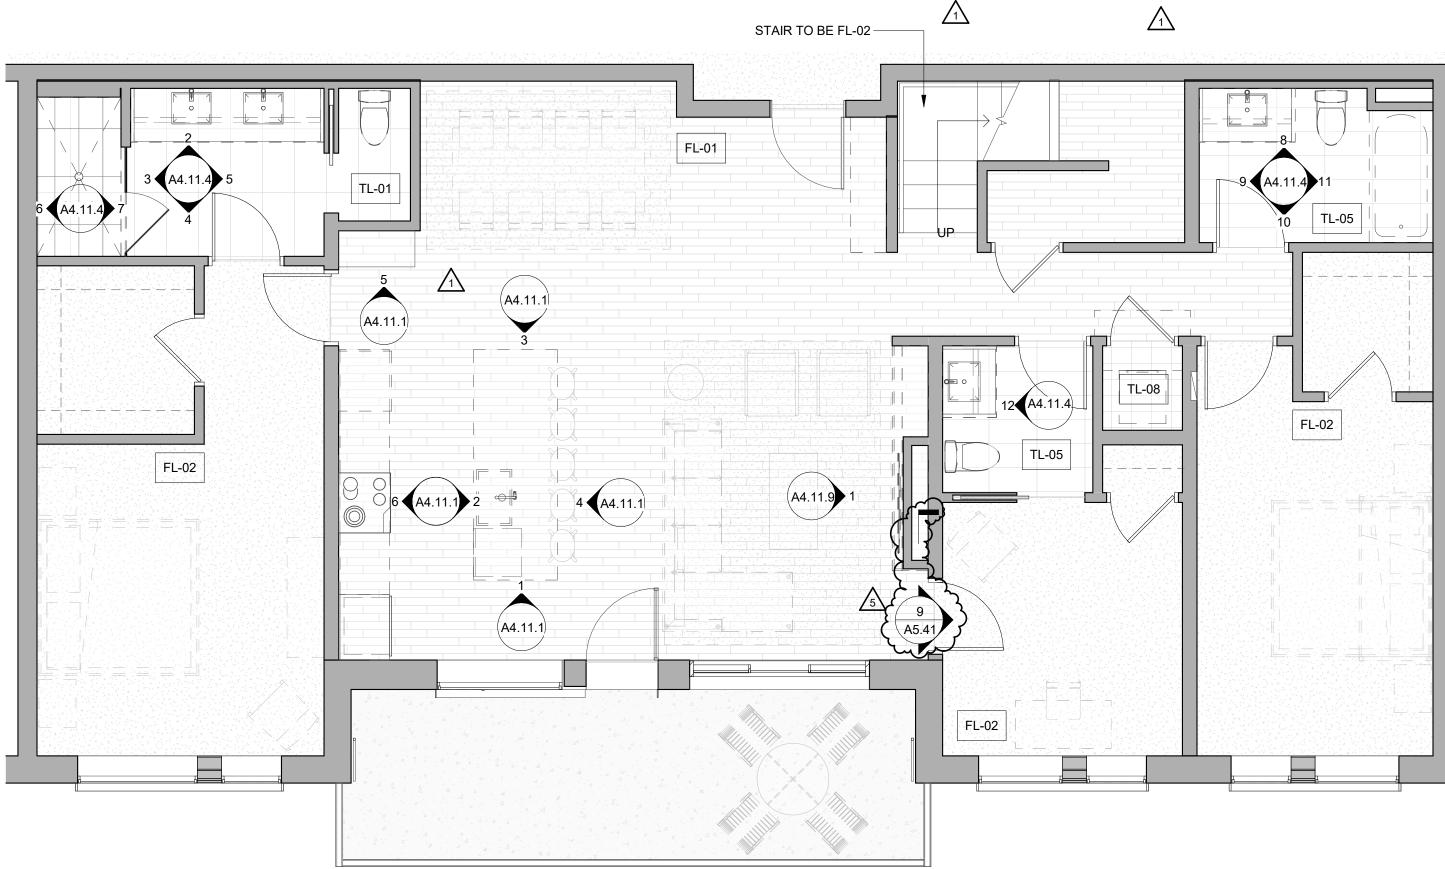

Level 04 - 3 BEDROOM FLEX FINISH 1/4" = 1'-0" **UNIT 408** 

 $\sqrt{3}$ 

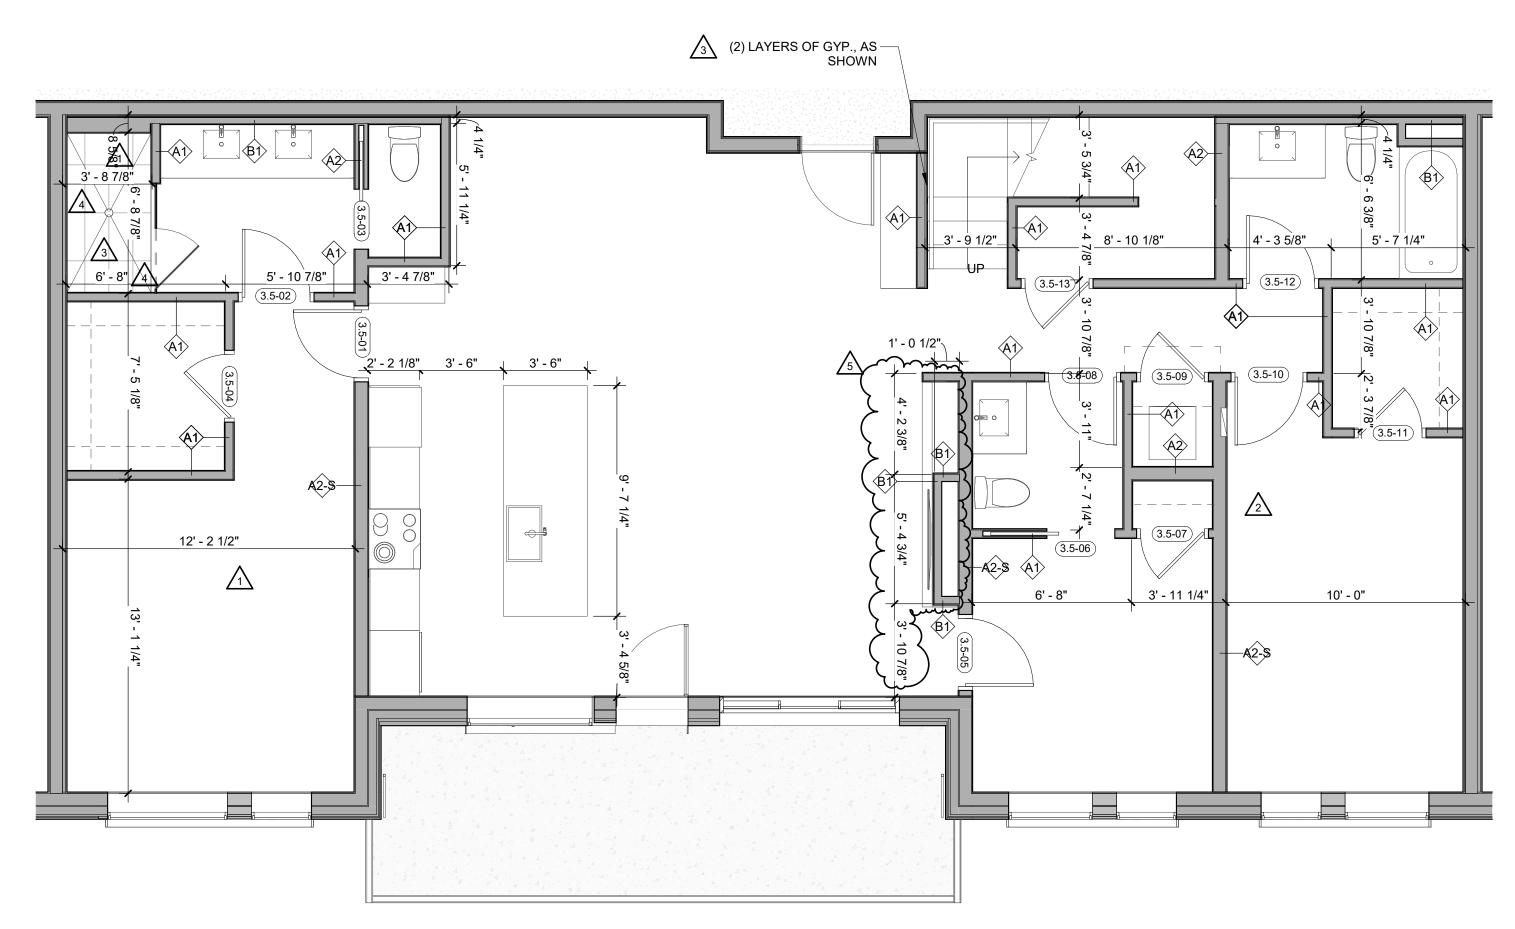


Level 04 - 3 BEDROOM FLEX DIMENSION **Level 0** 1/4" = 1'-0"

UNIT 408

### **ENLARGED FLOOR PLAN - GENERAL NOTES**

- REFER TO G0.2X SHEETS FOR EXTERIOR AND INTERIOR BUILDING ENCLOSURE ASSEMBLIES.
- REFER TO A1.0X SHEETS FOR EXTERIOR WALL, DEMISING WALL, AND CORRIDOR WALL TYPES AND LOCATIONS. REFER TO A1.1X SHEETS FOR INTERIOR AND EXTERIOR WINDOW/DOOR TAGS WITH UNIT BACKGROUNDS FOR
- REFERENCE. ALIGN WALLS WHERE THEY APPEAR TO ALIGN, U.N.O.
- THE INSIDE FACE OF DOOR JAMBS SHALL BE 4" FROM ADJACENT WALL OR FINISHED COLUMN, U.N.O.
- PROVIDE BLOCKING FOR ALL WALL MOUNTED EQUIPMENT AND ACCESSORIES.
- THE CENTERLINE OF ALL RESIDENTIAL TOILETS SHALL BE LOCATED 18" OFF OF FINISH FACE OF WALL, U.N.O.
- SWING CLEARANCE AT UNIT ENTRY SHALL BE 18" MIN. FROM FINISH FACE OF ADJACENT SURFACE.
- ALL DIMENSIONS ARE TO FACE OF STUD, GRID LINE, OR FACE OF CONCRETE, U.N.O.
- 10. WHERE "CLEAR" IS CALLED OUT ON A DIMENSION, PROVIDE DIMENSION FROM FACE OF FINISH TO FACE OF FINISH
- 11. FURNITURE IS NOT IN CONTRACT, U.N.O., AND IS SHOWN FOR DIAGRAMATIC PURPOSES ONLY. 12. CONSULTANT MODELS SHOWN FOR REFERENCE ONLY.

### ENLARGED FLOOR PLAN - LEGEND

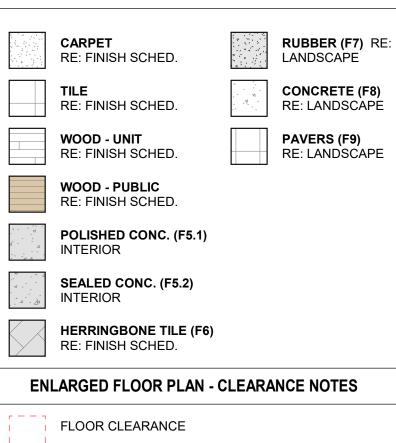

A DOOR CLEARANCE, 54" X 60"

- B APPLIANCE CLEARANCE, 30" X 48"
- C CLEAR FLOOR CLEARANCE, 30" X 48"
- D VANITY CLEARANCE, 30" X 48"
- E TOILET CLEARANCE, 48" X 56" OR ADA 60" X 56"
- F SHOWER/TUB CLEARANCE, 30" X 48" (B)
- G TURN AROUND CLEARANCE
- GRAB BAR BLOCKING REQ. AT TOILET WALL WHERE APPLICABLE

### ENLARGED RCP - GENERAL NOTES


- ALL UNIT CEILINGS SHALL BE 9' 0" A.F.F. U.N.O. REFER TO ENLARGED RCP'S FOR COMMON AREA CEILING HEIGHTS.
- IN THE CASE OF MINOR DISCREPANCIES BETWEEN MEP AND ARCHITECTURAL DOCUMENTS ON THE LOCATION OF CEILING MOUNTED COMPONENTS, THE ARCHITECTURAL RCP'S GOVERN. IN THE CASE OF MAJOR DISCREPANCIES, THE ARCHITECT SHALL BE NOTIFIED AS SOON AS THE DISCREPANCY IS DISCOVERED PRIOR TO PROCEEDING WITH THE WORK.
- REFERENCE MECHANICAL AND ELECTRICAL DRAWINGS FOR MOUNTING LOCATIONS OF ITEMS WHERE NO CEILING IS REQUIRED OR INDICATED.
- COORDINATE ALL TRADES INVOLVED IN THE CEILING WORK TO ENSURE CLEARANCE FOR FIXTURES, DUCTS, PIPING, CEILING SUSPENSION SYSTEMS, ETC. NECESSARY TO MAINTAIN CEILING HEIGHTS NOTED.
- LIGHTS, DIFFUSERS, EXIT SIGNS, SMOKE DETECTORS, SPEAKERS, STROBES, AND MISC. DEVICES SHALL BE CENTERED IN THE CEILING WHERE THEY OCCUR, U.N.O. FIRE PROTECTION SCOPE SHALL BE DESIGN-BUILD. ALL
- CORRIDOR SPRINKLER HEADS SHALL BE ALIGNED IN THE SAME LOCATION PARALLEL TO THE WALL WITHIN EACH SPECIFIC CEILING CONSTRUCTION. SMOKE ALARMS SHALL BE PROVIDED IN ALL BEDROOMS,
- OUTSIDE OF ALL BEDROOMS, AND ON EACH FLOOR AS REQUIRED. CARBON MONOXIDE DETECTORS SHALL BE INSTALLED OUTSIDE OF ALL BEDROOMS. SMOKE ALARMS AND CO DETECTORS SHALL BE HARDWIRED AND HAVE BATTERY BACKUP.
- ACCESS DOOR LOCATIONS IN GYPSUM BOARD CEILINGS ARE INDICATED ON RCP'S ONLY WHERE ARCHITECTURALLY SIGNIFICANT. REFERENCE SPECIFICATIONS AND MEP DRAWINGS FOR OTHER ACCESS DOOR LOCATIONS.
- UNLESS PREFINISHED TO MATCH ADJACENT SURFACE, PAINT MECHANICAL GRILLS, DIFFUSERS, ACCESS PANELS, AND OTHER EQUIPMENT TO MATCH ADJACENT SURFACE. 10. EXIT SIGNS ARE SHOWN ON RCP'S ONLY WHERE
- LOCATIONS ARE ARCHITECTURALLY SIGNIFICANT. 1. PROVIDE UL-CLASSIFIED LIGHT FIXTURES OR ENCLOSURES IN RATED FLOOR/CEILING ASSEMBLIES IN
- ACCORDANCE WITH IBC CHAPTER 7. 12. REFER TO LIGHTING PLANS FOR EXACT FIXTURE TYPES AND LOCATIONS. FIXTURES SHOWN HERE ARE REFERENCED AND SHOWN FOR GENERAL ALIGNMENT.

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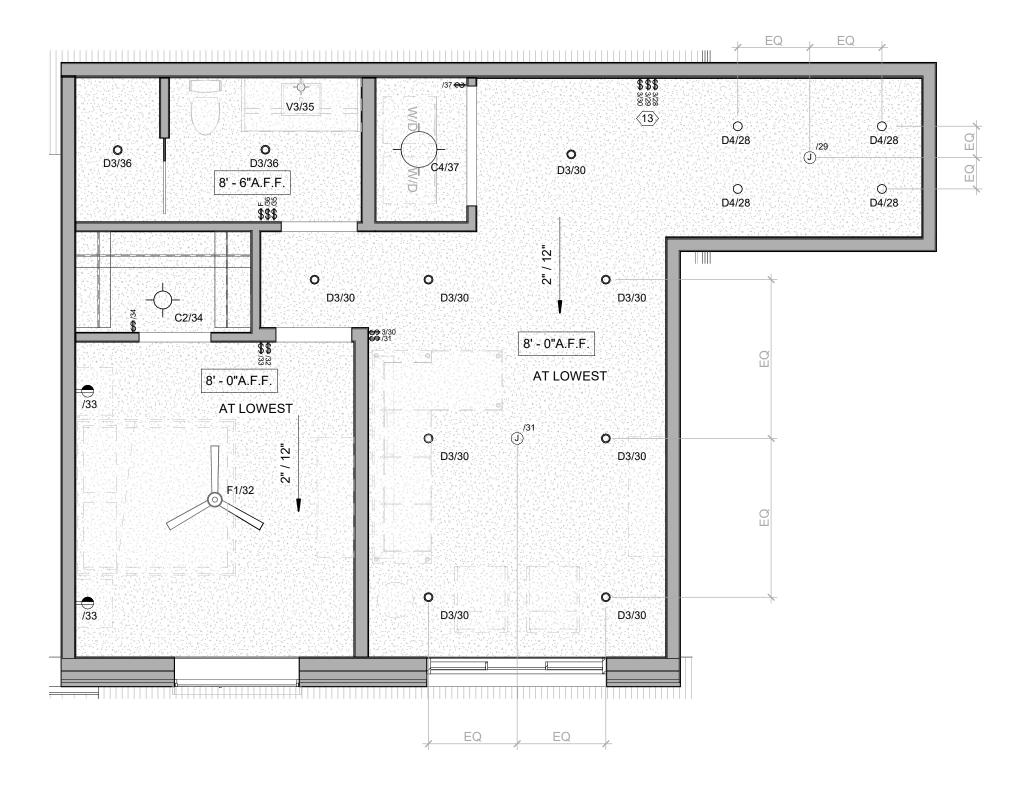
- 1	<b>GWB (C1)</b> INTERIOR	$\rightarrow$	SLOPE CEILING AS NOTED
	T&G CEILING (C2) INTERIOR	0	CEILING MOUNTED LIGHT FIXTURE
	FIBER-CEMENT SOFFIT (C3) - EXTERIOR	+ + + + + + + + + + + + + + + + + + + +	VINYL SCRIM CLG - Interior
	ACCESS PANEL		ACOUSTIC VINYL Tile Clg - Interio

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The Amble	Steamboat Springs, CO

No.	Description	Date
	IFC SET	03.15.24
	RFI #125	06.24.24
	ASI 004	08.07.24
	RFI #232 RFI #241	09.17.24
PROJECT N		20019
SSUE		
	IFC SET	
SHEET TITI	E	
	UNIT PLAN - ROOM FLEX -	-
DEDL	04	




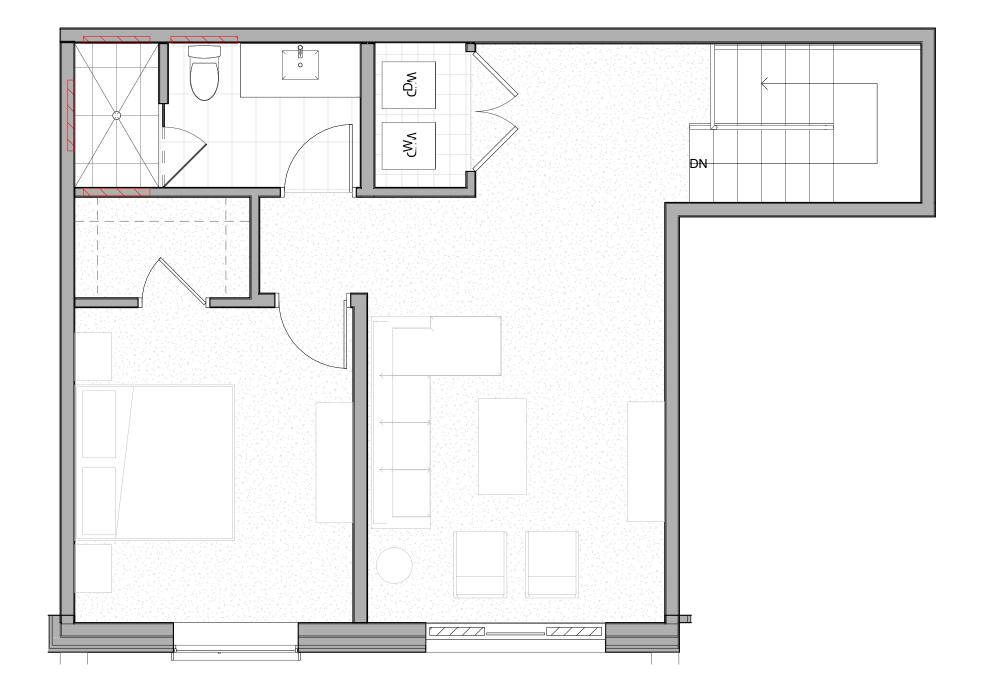






2

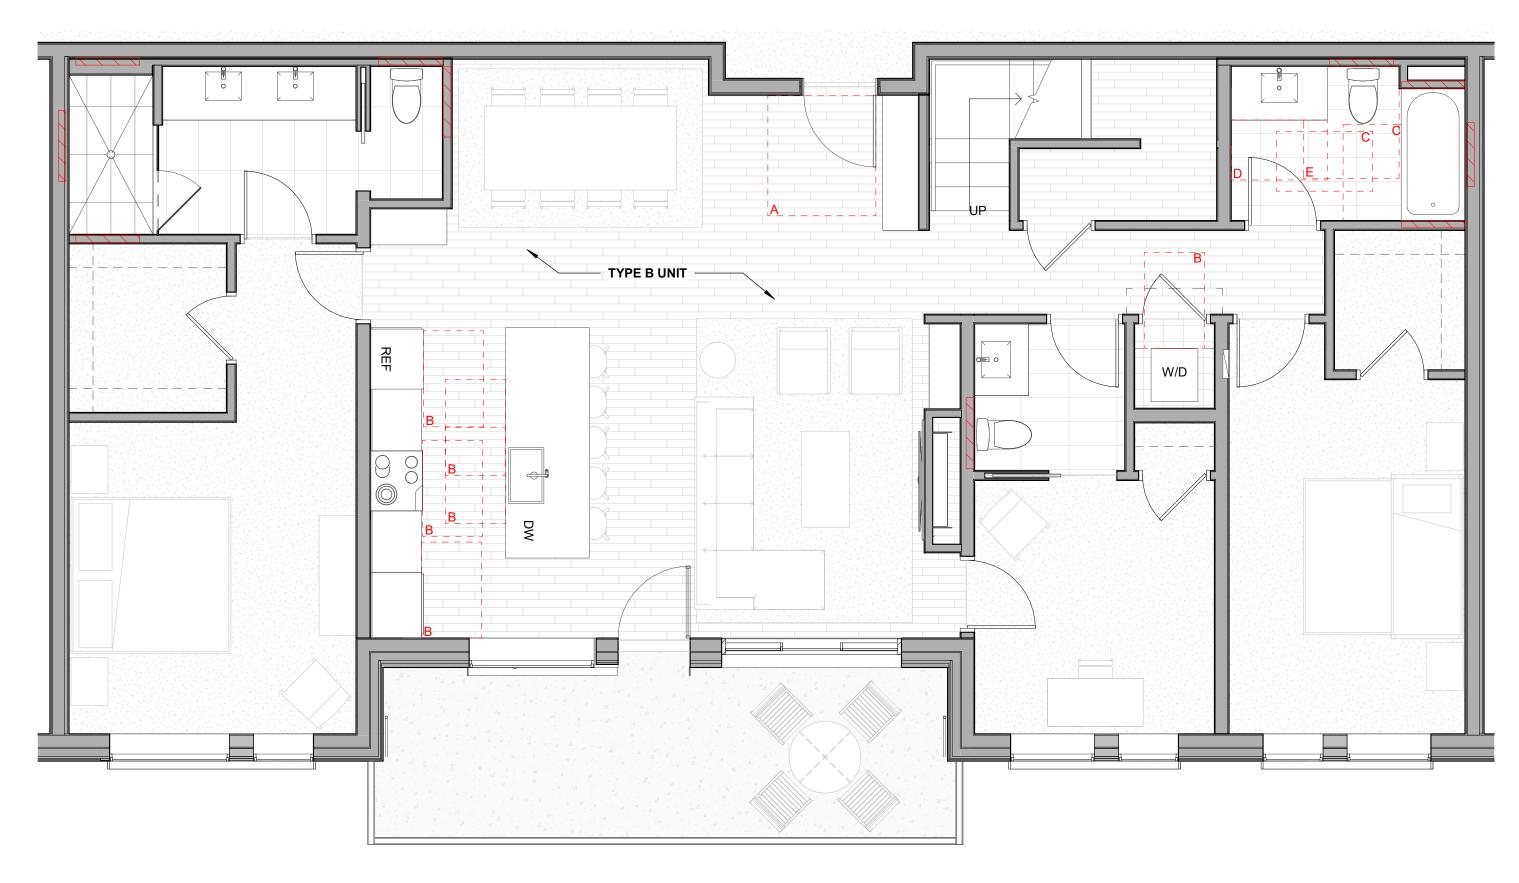

2 Level 04 - 3 BEDROOM FLEX FURNITURE 1/4" = 1'-0" UNIT 408

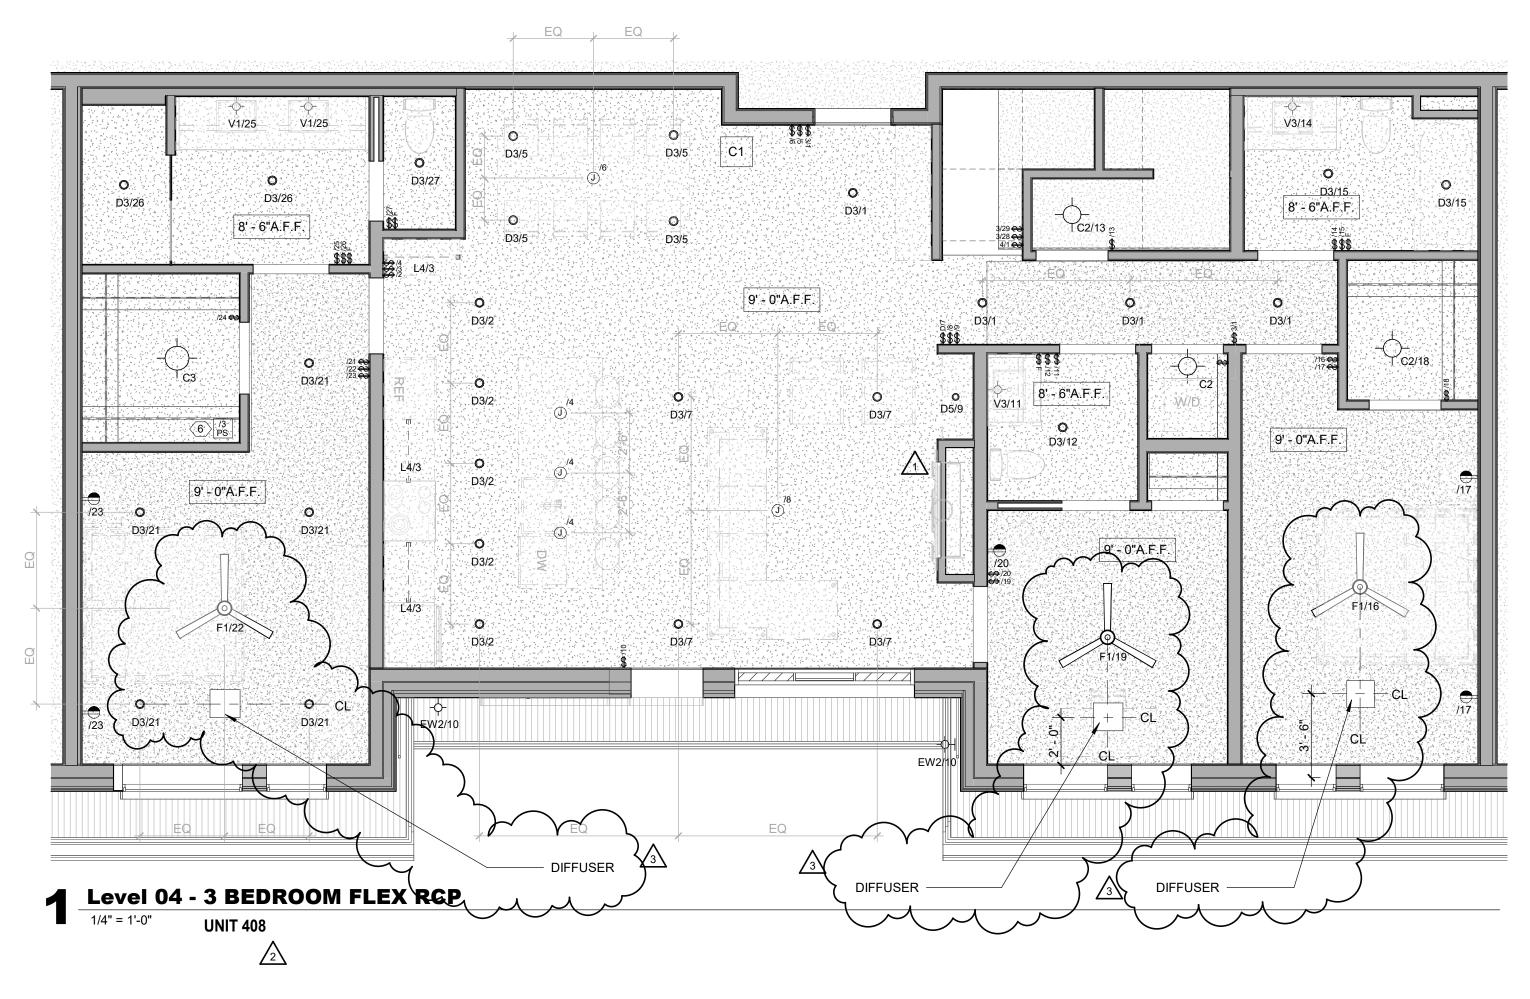

- . REFER TO G0.2X SHEETS FOR EXTERIOR AND INTERIOR BUILDING ENCLOSURE ASSEMBLIES.
- REFER TO A1.0X SHEETS FOR EXTERIOR WALL, DEMISING WALL, AND CORRIDOR WALL TYPES AND LOCATIONS.
   REFER TO A1.1X SHEETS FOR INTERIOR AND EXTERIOR
- WINDOW/DOOR TAGS WITH UNIT BACKGROUNDS FOR REFERENCE. 4. ALIGN WALLS WHERE THEY APPEAR TO ALIGN, U.N.O.
- 5. THE INSIDE FACE OF DOOR JAMBS SHALL BE 4" FROM ADJACENT WALL OR FINISHED COLUMN, U.N.O.
- 6. PROVIDE BLOCKING FOR ALL WALL MOUNTED EQUIPMENT
- AND ACCESSORIES. 7. THE CENTERLINE OF ALL RESIDENTIAL TOILETS SHALL BE
- LOCATED 18" OFF OF FINISH FACE OF WALL, U.N.O. 3. SWING CLEARANCE AT UNIT ENTRY SHALL BE 18" MIN.
- FROM FINISH FACE OF ADJACENT SURFACE.
  ALL DIMENSIONS ARE TO FACE OF STUD, GRID LINE, OR FACE OF CONCRETE, U.N.O.
- WHERE "CLEAR" IS CALLED OUT ON A DIMENSION, PROVIDE DIMENSION FROM FACE OF FINISH TO FACE OF
- FINISH. 11. FURNITURE IS NOT IN CONTRACT, U.N.O., AND IS SHOWN FOR DIAGRAMATIC PURPOSES ONLY. 12. CONSULTANT MODELS SHOWN FOR REFERENCE ONLY.



- RUBBER (F7) RE: CARPET RE: FINISH SCHED. LANDSCAPE CONCRETE (F8) TILE RE: LANDSCAPE RE: FINISH SCHED. PAVERS (F9) WOOD - UNIT RE: LANDSCAPE RE: FINISH SCHED. WOOD - PUBLIC RE: FINISH SCHED. POLISHED CONC. (F5.1) INTERIOR SEALED CONC. (F5.2) INTERIOR HERRINGBONE TILE (F6) RE: FINISH SCHED. ENLARGED FLOOR PLAN - CLEARANCE NOTES FLOOR CLEARANCE
- A DOOR CLEARANCE, 54" X 60"
- B APPLIANCE CLEARANCE, 30" X 48"
- C CLEAR FLOOR CLEARANCE, 30" X 48"
- D VANITY CLEARANCE, 30" X 48"
- E TOILET CLEARANCE, 48" X 56" OR ADA 60" X 56"
- F SHOWER/TUB CLEARANCE, 30" X 48" (B)
- G TURN AROUND CLEARANCE
- GRAB BAR BLOCKING REQ. AT TOILET WALL WHERE APPLICABLE


### ENLARGED RCP - GENERAL NOTES

- 1. ALL UNIT CEILINGS SHALL BE 9' 0" A.F.F. U.N.O. REFER TO ENLARGED RCP'S FOR COMMON AREA CEILING HEIGHTS.
- 2. IN THE CASE OF MINOR DISCREPANCIES BETWEEN MEP AND ARCHITECTURAL DOCUMENTS ON THE LOCATION OF CEILING MOUNTED COMPONENTS, THE ARCHITECTURAL RCP'S GOVERN. IN THE CASE OF MAJOR DISCREPANCIES, THE ARCHITECT SHALL BE NOTIFIED AS SOON AS THE DISCREPANCY IS DISCOVERED PRIOR TO PROCEEDING WITH THE WORK.
- 3. REFERENCE MECHANICAL AND ELECTRICAL DRAWINGS FOR MOUNTING LOCATIONS OF ITEMS WHERE NO CEILING IS REQUIRED OR INDICATED.
- 4. COORDINATE ALL TRADES INVOLVED IN THE CEILING WORK TO ENSURE CLEARANCE FOR FIXTURES, DUCTS, PIPING, CEILING SUSPENSION SYSTEMS, ETC. NECESSARY TO MAINTAIN CEILING HEIGHTS NOTED.
- LIGHTS, DIFFUSERS, EXIT SIGNS, SMOKE DETECTORS, SPEAKERS, STROBES, AND MISC. DEVICES SHALL BE CENTERED IN THE CEILING WHERE THEY OCCUR, U.N.O.
   FIRE PROTECTION SCOPE SHALL BE DESIGN-BUILD. ALL
- CORRIDOR SPRINKLER HEADS SHALL BE ALIGNED IN THE SAME LOCATION PARALLEL TO THE WALL WITHIN EACH SPECIFIC CEILING CONSTRUCTION.
- 7. SMOKE ALARMS SHALL BE PROVIDED IN ALL BEDROOMS, OUTSIDE OF ALL BEDROOMS, AND ON EACH FLOOR AS REQUIRED. CARBON MONOXIDE DETECTORS SHALL BE INSTALLED OUTSIDE OF ALL BEDROOMS. SMOKE ALARMS AND CO DETECTORS SHALL BE HARDWIRED AND HAVE BATTERY BACKUP.
- 8. ACCESS DOOR LOCATIONS IN GYPSUM BOARD CEILINGS ARE INDICATED ON RCP'S ONLY WHERE ARCHITECTURALLY SIGNIFICANT. REFERENCE SPECIFICATIONS AND MEP DRAWINGS FOR OTHER
- ACCESS DOOR LOCATIONS.
  9. UNLESS PREFINISHED TO MATCH ADJACENT SURFACE, PAINT MECHANICAL GRILLS, DIFFUSERS, ACCESS PANELS, AND OTHER EQUIPMENT TO MATCH ADJACENT SURFACE.
- EXIT SIGNS ARE SHOWN ON RCP'S ONLY WHERE LOCATIONS ARE ARCHITECTURALLY SIGNIFICANT.
   PROVIDE UL-CLASSIFIED LIGHT FIXTURES OR
- ENCLOSURES IN RATED FLOOR/CEILING ASSEMBLIES IN ACCORDANCE WITH IBC CHAPTER 7.12. REFER TO LIGHTING PLANS FOR EXACT FIXTURE TYPES AND LOCATIONS. FIXTURES SHOWN HERE ARE
- REFERENCED AND SHOWN FOR GENERAL ALIGNMENT.

<b>GWB (C1)</b> INTERIOR	$\rightarrow$	SLOPE CEILING AS NOTED
T&G CEILING (C2) INTERIOR	0	CEILING MOUNTED LIGHT FIXTURE
FIBER-CEMENT SOFFIT (C3) - EXTERIOR	+ + + + + + + + + + + + + + + + + + + +	VINYL SCRIM CLG - Interior
ACCESS PANEL		ACCOUSTIC VINYL TILE CLG - INTERIOF


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	The Amble	Steamboat Springs, CO	
REVISIONS	RFI #110 ASI 004 RFI #223.1	06. 08.	Date 14.24 07.24 16.24
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2 Level 01 - 3 BED STANDARD FINISH 1/4" = 1'-0" UNIT 106 UNIT 106


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Level 01 - 3 BED STANDARD DIMENSION 1/4" = 1'-0"

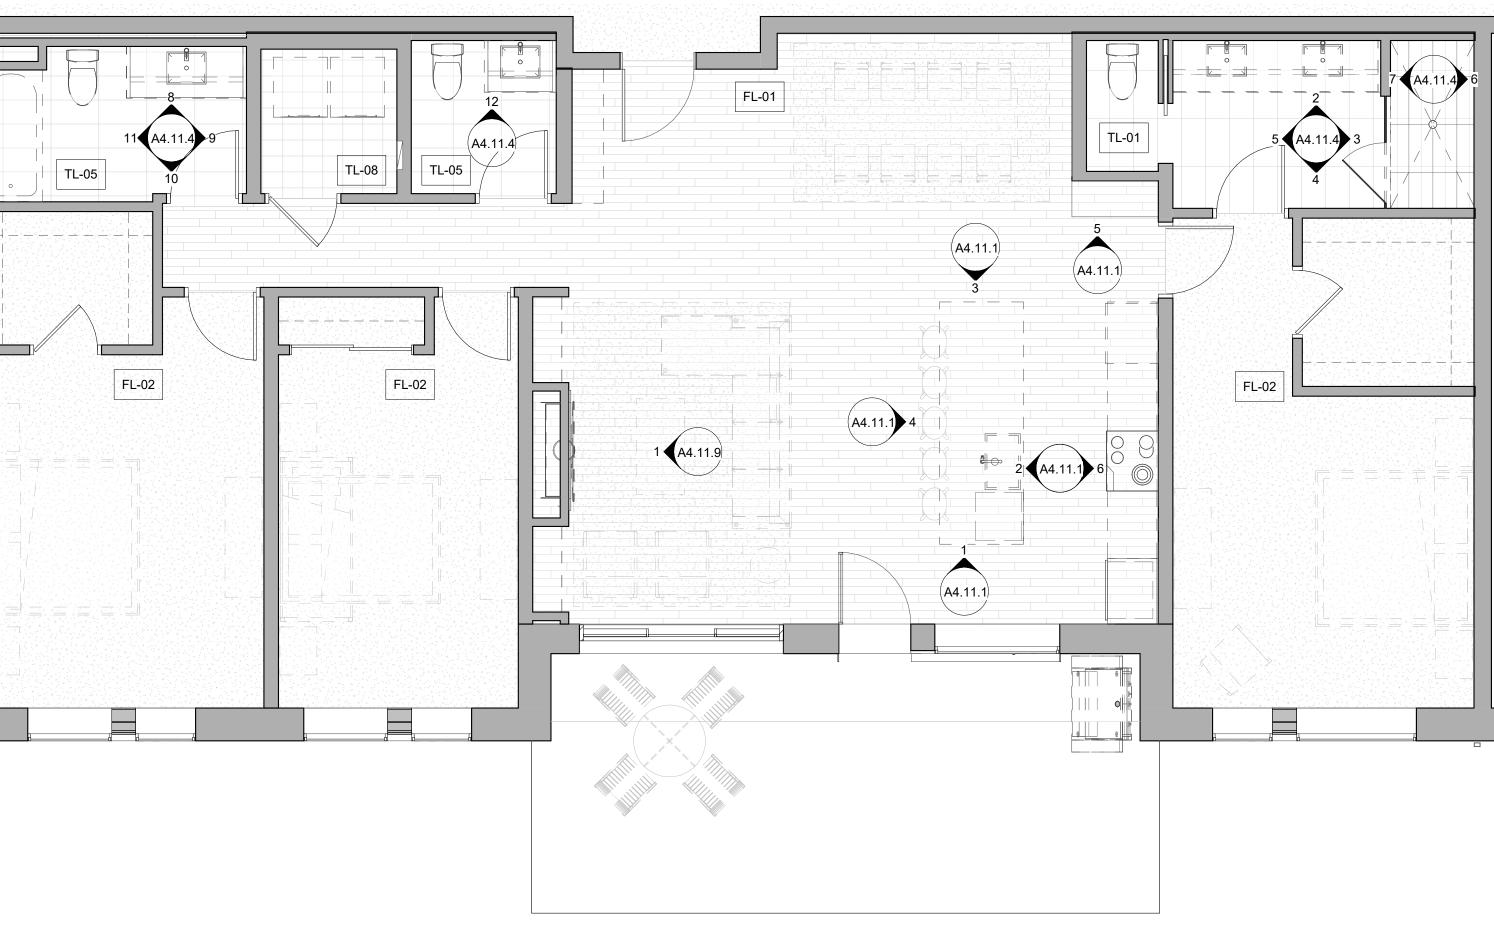- REFER TO G0.2X SHEETS FOR EXTERIOR AND INTERIOR
- BUILDING ENCLOSURE ASSEMBLIES. REFER TO A1.0X SHEETS FOR EXTERIOR WALL, DEMISING WALL, AND CORRIDOR WALL TYPES AND LOCATIONS.
- REFER TO A1.1X SHEETS FOR INTERIOR AND EXTERIOR WINDOW/DOOR TAGS WITH UNIT BACKGROUNDS FOR REFERENCE.
- ALIGN WALLS WHERE THEY APPEAR TO ALIGN, U.N.O. THE INSIDE FACE OF DOOR JAMBS SHALL BE 4" FROM
- ADJACENT WALL OR FINISHED COLUMN, U.N.O. PROVIDE BLOCKING FOR ALL WALL MOUNTED EQUIPMENT
- AND ACCESSORIES.
- THE CENTERLINE OF ALL RESIDENTIAL TOILETS SHALL BE LOCATED 18" OFF OF FINISH FACE OF WALL, U.N.O. SWING CLEARANCE AT UNIT ENTRY SHALL BE 18" MIN.
- FROM FINISH FACE OF ADJACENT SURFACE. ALL DIMENSIONS ARE TO FACE OF STUD, GRID LINE, OR
- FACE OF CONCRETE, U.N.O. 10. WHERE "CLEAR" IS CALLED OUT ON A DIMENSION,
- PROVIDE DIMENSION FROM FACE OF FINISH TO FACE OF FINISH. 11. FURNITURE IS NOT IN CONTRACT, U.N.O., AND IS SHOWN
- FOR DIAGRAMATIC PURPOSES ONLY. 12. CONSULTANT MODELS SHOWN FOR REFERENCE ONLY.

### ENLARGED FLOOR PLAN - LEGEND

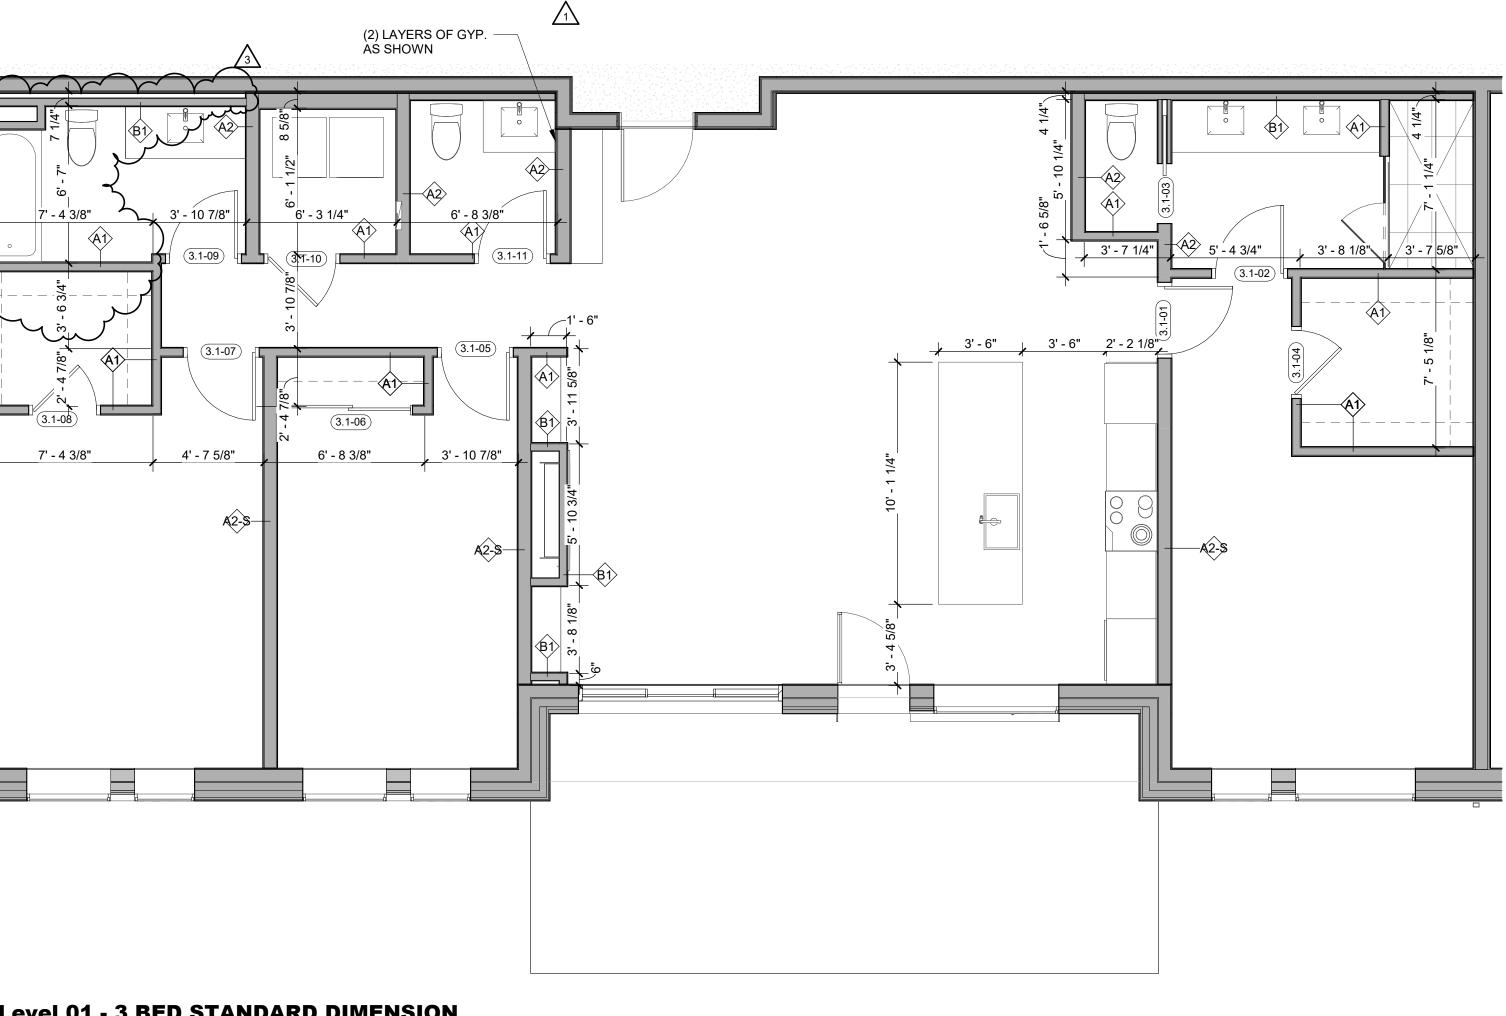

- A DOOR CLEARANCE, 54" X 60"
- B APPLIANCE CLEARANCE, 30" X 48"
- C CLEAR FLOOR CLEARANCE, 30" X 48"
- D VANITY CLEARANCE, 30" X 48"
- E TOILET CLEARANCE, 48" X 56" OR ADA 60" X 56"
- F SHOWER/TUB CLEARANCE, 30" X 48" (B)
- G TURN AROUND CLEARANCE
- GRAB BAR BLOCKING REQ. AT TOILET WALL WHERE APPLICABLE
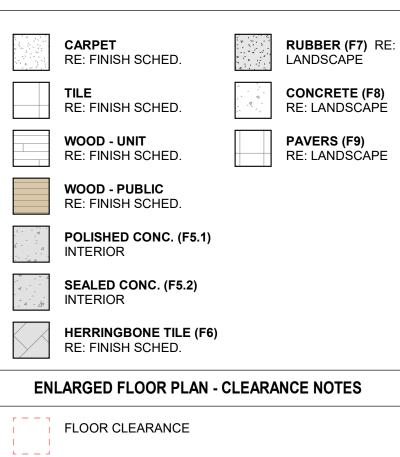
### ENLARGED RCP - GENERAL NOTES

- ALL UNIT CEILINGS SHALL BE 9' 0" A.F.F. U.N.O. REFER TO ENLARGED RCP'S FOR COMMON AREA CEILING HEIGHTS.
- IN THE CASE OF MINOR DISCREPANCIES BETWEEN MEP AND ARCHITECTURAL DOCUMENTS ON THE LOCATION OF CEILING MOUNTED COMPONENTS, THE ARCHITECTURAL RCP'S GOVERN. IN THE CASE OF MAJOR DISCREPANCIES, THE ARCHITECT SHALL BE NOTIFIED AS SOON AS THE DISCREPANCY IS DISCOVERED PRIOR TO PROCEEDING WITH THE WORK.
- REFERENCE MECHANICAL AND ELECTRICAL DRAWINGS FOR MOUNTING LOCATIONS OF ITEMS WHERE NO CEILING IS REQUIRED OR INDICATED.
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- LIGHTS, DIFFUSERS, EXIT SIGNS, SMOKE DETECTORS, SPEAKERS, STROBES, AND MISC. DEVICES SHALL BE CENTERED IN THE CEILING WHERE THEY OCCUR, U.N.O. FIRE PROTECTION SCOPE SHALL BE DESIGN-BUILD. ALL
- CORRIDOR SPRINKLER HEADS SHALL BE ALIGNED IN THE SAME LOCATION PARALLEL TO THE WALL WITHIN EACH SPECIFIC CEILING CONSTRUCTION.
- SMOKE ALARMS SHALL BE PROVIDED IN ALL BEDROOMS, OUTSIDE OF ALL BEDROOMS, AND ON EACH FLOOR AS REQUIRED. CARBON MONOXIDE DETECTORS SHALL BE INSTALLED OUTSIDE OF ALL BEDROOMS. SMOKE ALARMS AND CO DETECTORS SHALL BE HARDWIRED AND HAVE BATTERY BACKUP.
- ACCESS DOOR LOCATIONS IN GYPSUM BOARD CEILINGS ARE INDICATED ON RCP'S ONLY WHERE ARCHITECTURALLY SIGNIFICANT. REFERENCE SPECIFICATIONS AND MEP DRAWINGS FOR OTHER
- ACCESS DOOR LOCATIONS. UNLESS PREFINISHED TO MATCH ADJACENT SURFACE, PAINT MECHANICAL GRILLS, DIFFUSERS, ACCESS PANELS, AND OTHER EQUIPMENT TO MATCH ADJACENT SURFACE.
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- ACCORDANCE WITH IBC CHAPTER 7. 12. REFER TO LIGHTING PLANS FOR EXACT FIXTURE TYPES AND LOCATIONS. FIXTURES SHOWN HERE ARE
- REFERENCED AND SHOWN FOR GENERAL ALIGNMENT.

GWB (C1) INTERIOR

INTERIOR

T&G CEILING (C2)

(C3) - EXTERIOR

ACCESS PANEL

FIBER-CEMENT SOFFIT

ENLARGED RCP - LEGEND

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 $\longrightarrow \underset{\mathsf{NOTED}}{\mathsf{SLOPE CEILING AS}}$ 

INTERIOR

CEILING MOUNTED

VINYL SCRIM CLG -

LIGHT FIXTURE

REVISIONS	8	
No.	Description	Date
1	IFC SET ASI 004	03.15.24
2 3	RFI #214	08.07.24
PROJECT I		20019
SSUE DAT	E	03/15/2024
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SSUE		
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	UNIT PLAN - ROOM STANI LEVEL 01	-

TOWN STAMP

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DESIGN

3630 OSAGE STREET DENVER, CO 80211 720.512.3437


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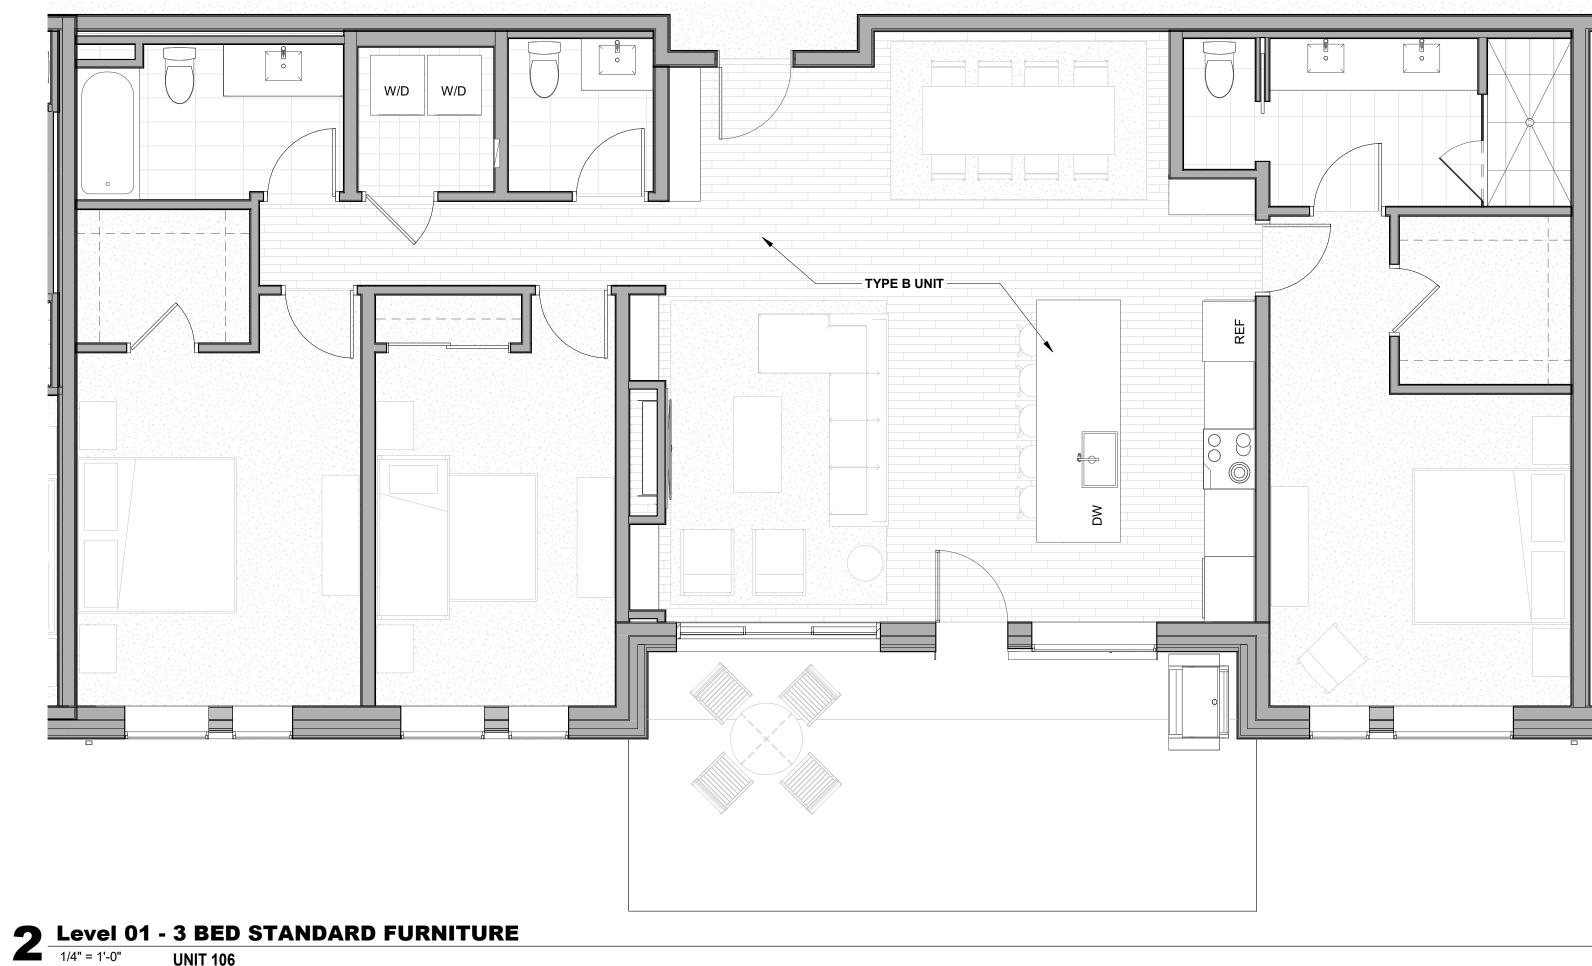
**UNIT 106** 


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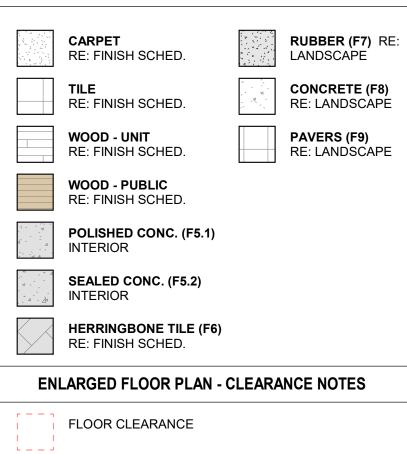
# Level 01 - 3 BED STANDARD RCP

**UNIT 106** 2

### **ENLARGED FLOOR PLAN - GENERAL NOTES**

- REFER TO G0.2X SHEETS FOR EXTERIOR AND INTERIOR BUILDING ENCLOSURE ASSEMBLIES.
- REFER TO A1.0X SHEETS FOR EXTERIOR WALL, DEMISING WALL, AND CORRIDOR WALL TYPES AND LOCATIONS. REFER TO A1.1X SHEETS FOR INTERIOR AND EXTERIOR
- WINDOW/DOOR TAGS WITH UNIT BACKGROUNDS FOR REFERENCE. ALIGN WALLS WHERE THEY APPEAR TO ALIGN, U.N.O.
- THE INSIDE FACE OF DOOR JAMBS SHALL BE 4" FROM ADJACENT WALL OR FINISHED COLUMN, U.N.O.
- PROVIDE BLOCKING FOR ALL WALL MOUNTED EQUIPMENT
- AND ACCESSORIES. THE CENTERLINE OF ALL RESIDENTIAL TOILETS SHALL BE
- LOCATED 18" OFF OF FINISH FACE OF WALL, U.N.O. SWING CLEARANCE AT UNIT ENTRY SHALL BE 18" MIN.
- FROM FINISH FACE OF ADJACENT SURFACE. ALL DIMENSIONS ARE TO FACE OF STUD, GRID LINE, OR
- FACE OF CONCRETE, U.N.O. 10. WHERE "CLEAR" IS CALLED OUT ON A DIMENSION, PROVIDE DIMENSION FROM FACE OF FINISH TO FACE OF
- FINISH. 11. FURNITURE IS NOT IN CONTRACT, U.N.O., AND IS SHOWN FOR DIAGRAMATIC PURPOSES ONLY.
- 12. CONSULTANT MODELS SHOWN FOR REFERENCE ONLY.
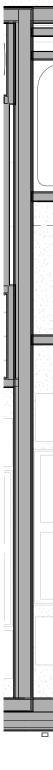
### ENLARGED FLOOR PLAN - LEGEND

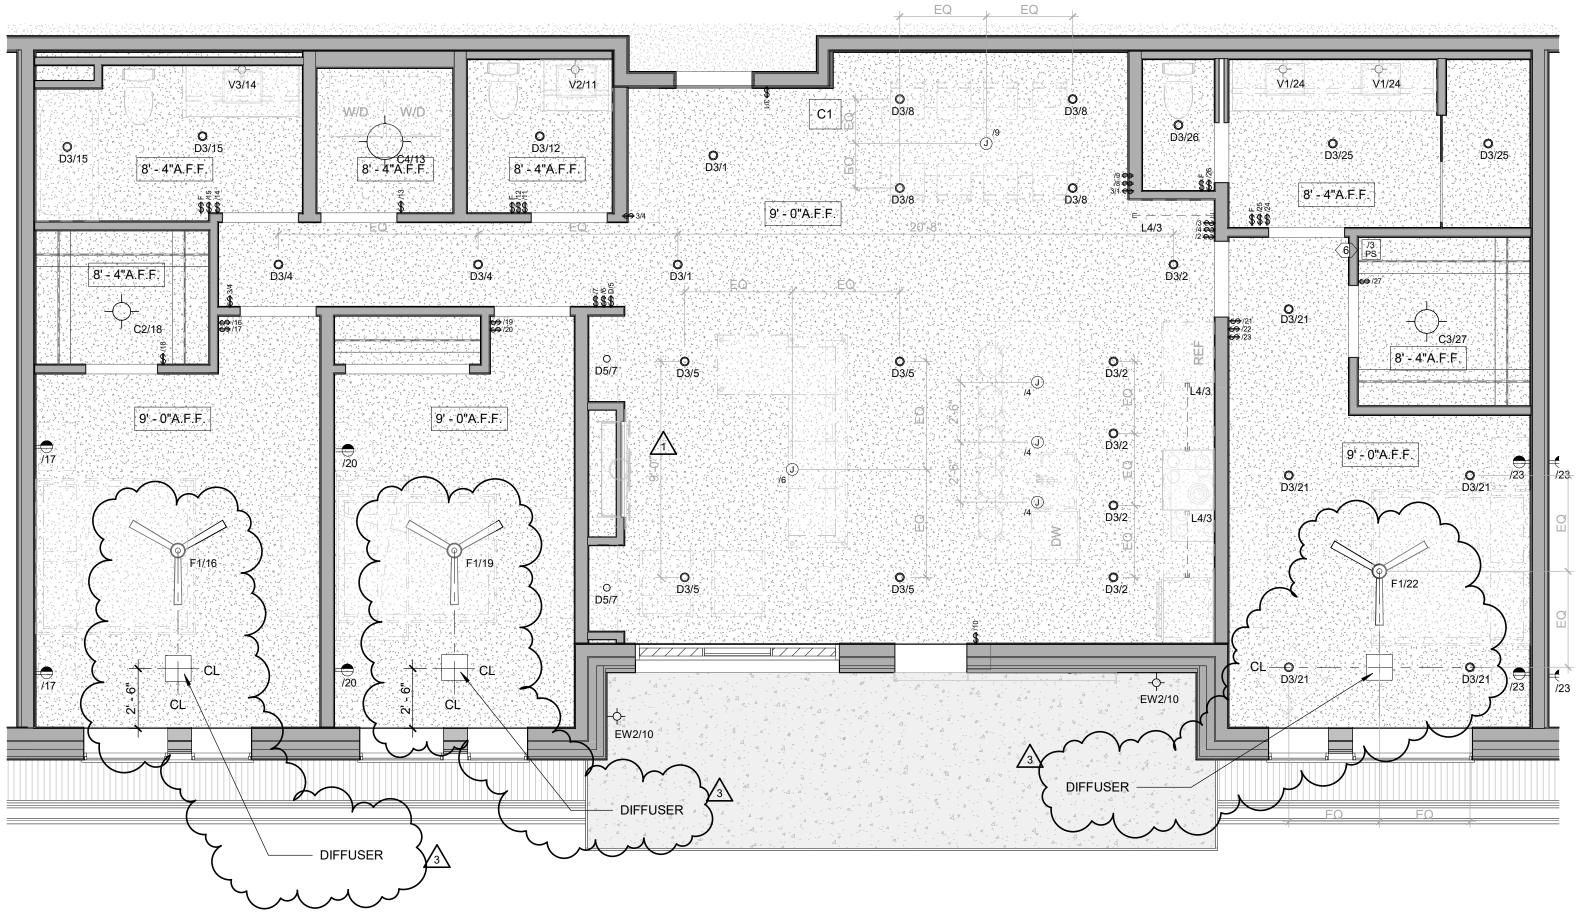

- A DOOR CLEARANCE, 54" X 60"
- B APPLIANCE CLEARANCE, 30" X 48"
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- D VANITY CLEARANCE, 30" X 48"
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- G TURN AROUND CLEARANCE
- GRAB BAR BLOCKING REQ. AT TOILET WALL WHERE APPLICABLE

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- SMOKE ALARMS SHALL BE PROVIDED IN ALL BEDROOMS, OUTSIDE OF ALL BEDROOMS, AND ON EACH FLOOR AS REQUIRED. CARBON MONOXIDE DETECTORS SHALL BE INSTALLED OUTSIDE OF ALL BEDROOMS. SMOKE ALARMS AND CO DETECTORS SHALL BE HARDWIRED AND HAVE BATTERY BACKUP.
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<b>GWB (C1)</b> INTERIOR	$\rightarrow$	SLOPE CEILING AS NOTED
<b>T&amp;G CEILING (C2)</b> INTERIOR	0	CEILING MOUNTED LIGHT FIXTURE
FIBER-CEMENT SOFFIT (C3) - EXTERIOR	+ + + + + + + + + + + + + + + + + + + +	VINYL SCRIM CLG - Interior
ACCESS PANEL		ACCOUSTIC VINYL TILE CLG - INTERIOR

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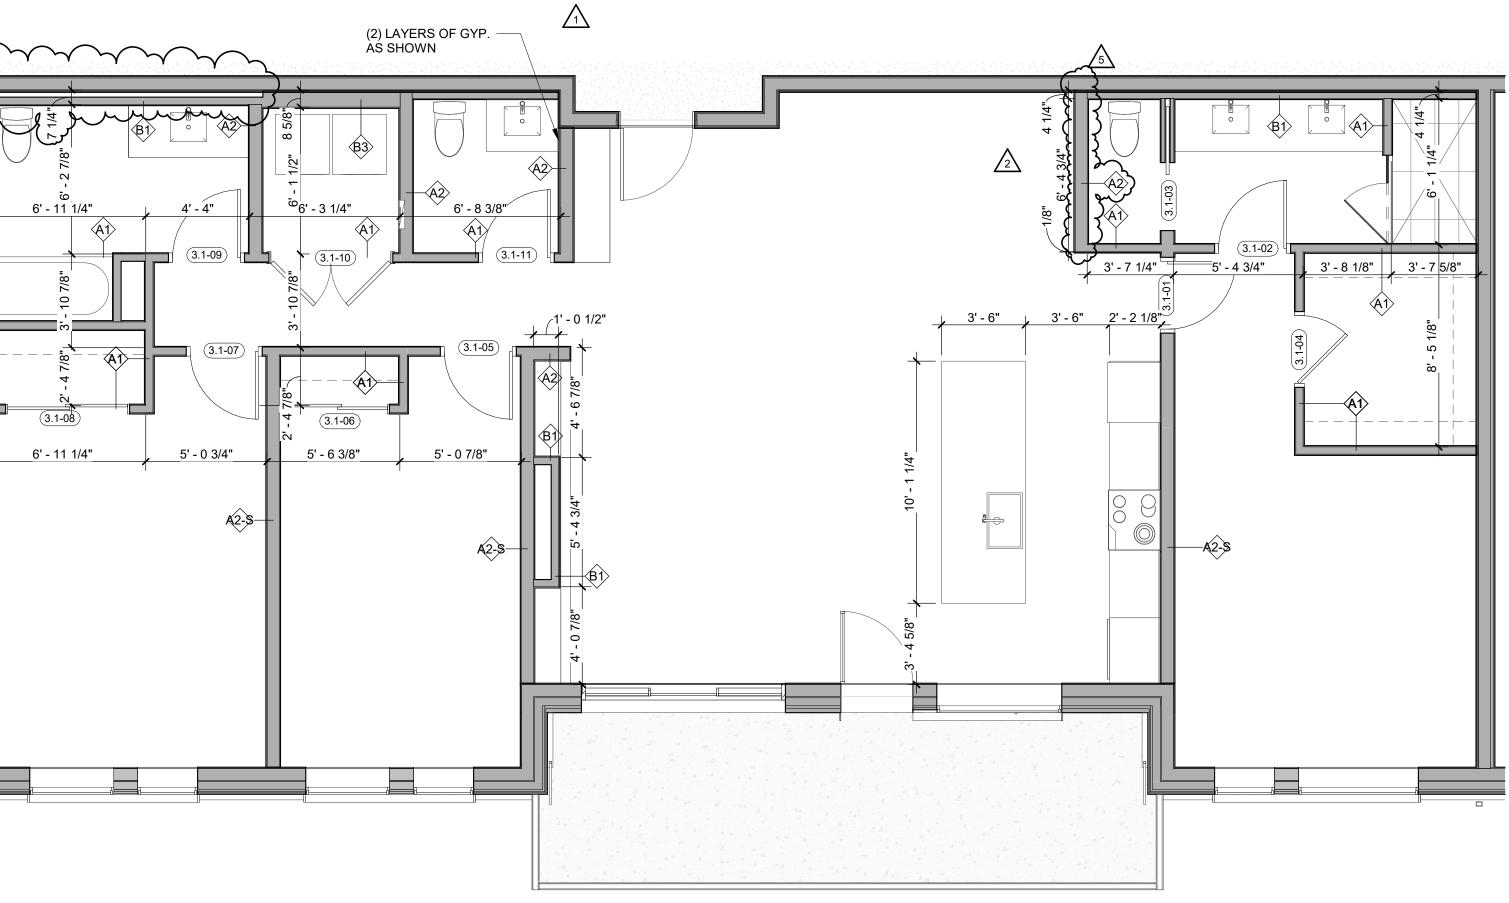


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2 Level 02 - 3 BEDROOM STANDARD TYPE A - FINISH 1/4" = 1'-0" UNIT 206

UNIT 206 4



 
 Level 02 - 3 BEDROOM STANDARD TYPE A - DIMENSION

 1/4" = 1'-0"
 UNIT 206
 **UNIT 206** 

### ENLARGED FLOOR PLAN - GENERAL NOTES

- REFER TO G0.2X SHEETS FOR EXTERIOR AND INTERIOR BUILDING ENCLOSURE ASSEMBLIES. REFER TO A1.0X SHEETS FOR EXTERIOR WALL, DEMISING WALL, AND CORRIDOR WALL TYPES AND LOCATIONS.
- REFER TO A1.1X SHEETS FOR INTERIOR AND EXTERIOR WINDOW/DOOR TAGS WITH UNIT BACKGROUNDS FOR REFERENCE.
- ALIGN WALLS WHERE THEY APPEAR TO ALIGN, U.N.O. THE INSIDE FACE OF DOOR JAMBS SHALL BE 4" FROM
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- THE CENTERLINE OF ALL RESIDENTIAL TOILETS SHALL BE LOCATED 18" OFF OF FINISH FACE OF WALL, U.N.O.
- SWING CLEARANCE AT UNIT ENTRY SHALL BE 18" MIN.
- FROM FINISH FACE OF ADJACENT SURFACE. ALL DIMENSIONS ARE TO FACE OF STUD, GRID LINE, OR
- FACE OF CONCRETE, U.N.O. 10. WHERE "CLEAR" IS CALLED OUT ON A DIMENSION, PROVIDE DIMENSION FROM FACE OF FINISH TO FACE OF
- FINISH. 11. FURNITURE IS NOT IN CONTRACT, U.N.O., AND IS SHOWN
- FOR DIAGRAMATIC PURPOSES ONLY. 12. CONSULTANT MODELS SHOWN FOR REFERENCE ONLY.

### ENLARGED FLOOR PLAN - LEGEND

	CARPET RE: FINISH SCHED.		<b>RUBBER (F7)</b> RE: LANDSCAPE
	<b>TILE</b> RE: FINISH SCHED.		CONCRETE (F8) RE: LANDSCAPE
	WOOD - UNIT RE: FINISH SCHED.		<b>PAVERS (F9)</b> RE: LANDSCAPE
	WOOD - PUBLIC RE: FINISH SCHED.		
d - d	POLISHED CONC. (F5.1) INTERIOR		
	SEALED CONC. (F5.2) INTERIOR		
	HERRINGBONE TILE (F6) RE: FINISH SCHED.		
ENL	ARGED FLOOR PLAN - CL	EARANC	E NOTES


- FLOOR CLEARANCE
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- C CLEAR FLOOR CLEARANCE, 30" X 48"
- D VANITY CLEARANCE, 30" X 48"
- E TOILET CLEARANCE, 48" X 56" OR ADA 60" X 56"  $\triangle$
- F SHOWER/TUB CLEARANCE, 30" X 48" (B) G TURN AROUND CLEARANCE
- GRAB BAR BLOCKING REQ. AT TOILET WALL WHERE APPLICABLE


### ENLARGED RCP - GENERAL NOTES


- ALL UNIT CEILINGS SHALL BE 9' 0" A.F.F. U.N.O. REFER TO ENLARGED RCP'S FOR COMMON AREA CEILING HEIGHTS.
- IN THE CASE OF MINOR DISCREPANCIES BETWEEN MEP AND ARCHITECTURAL DOCUMENTS ON THE LOCATION OF CEILING MOUNTED COMPONENTS, THE ARCHITECTURAL RCP'S GOVERN. IN THE CASE OF MAJOR DISCREPANCIES, THE ARCHITECT SHALL BE NOTIFIED AS SOON AS THE DISCREPANCY IS DISCOVERED PRIOR TO PROCEEDING WITH THE WORK.
- REFERENCE MECHANICAL AND ELECTRICAL DRAWINGS FOR MOUNTING LOCATIONS OF ITEMS WHERE NO CEILING IS REQUIRED OR INDICATED.
- COORDINATE ALL TRADES INVOLVED IN THE CEILING WORK TO ENSURE CLEARANCE FOR FIXTURES, DUCTS, PIPING, CEILING SUSPENSION SYSTEMS, ETC. NECESSARY TO MAINTAIN CEILING HEIGHTS NOTED.
- LIGHTS, DIFFUSERS, EXIT SIGNS, SMOKE DETECTORS, SPEAKERS, STROBES, AND MISC. DEVICES SHALL BE CENTERED IN THE CEILING WHERE THEY OCCUR, U.N.O. FIRE PROTECTION SCOPE SHALL BE DESIGN-BUILD. ALL
- CORRIDOR SPRINKLER HEADS SHALL BE ALIGNED IN THE SAME LOCATION PARALLEL TO THE WALL WITHIN EACH SPECIFIC CEILING CONSTRUCTION. SMOKE ALARMS SHALL BE PROVIDED IN ALL BEDROOMS,
- OUTSIDE OF ALL BEDROOMS, AND ON EACH FLOOR AS REQUIRED. CARBON MONOXIDE DETECTORS SHALL BE INSTALLED OUTSIDE OF ALL BEDROOMS. SMOKE ALARMS AND CO DETECTORS SHALL BE HARDWIRED AND HAVE BATTERY BACKUP.
- ACCESS DOOR LOCATIONS IN GYPSUM BOARD CEILINGS ARE INDICATED ON RCP'S ONLY WHERE ARCHITECTURALLY SIGNIFICANT. REFERENCE SPECIFICATIONS AND MEP DRAWINGS FOR OTHER
- ACCESS DOOR LOCATIONS. UNLESS PREFINISHED TO MATCH ADJACENT SURFACE, PAINT MECHANICAL GRILLS, DIFFUSERS, ACCESS PANELS, AND OTHER EQUIPMENT TO MATCH ADJACENT SURFACE.
- 10. EXIT SIGNS ARE SHOWN ON RCP'S ONLY WHERE LOCATIONS ARE ARCHITECTURALLY SIGNIFICANT.
- 12 F

ROVIDE UL-CLASSIFIED LIGHT FIXTURES OR NCLOSURES IN RATED FLOOR/CEILING ASSEMBLIES IN CCORDANCE WITH IBC CHAPTER 7. EFER TO LIGHTING PLANS FOR EXACT FIXTURE TYPES ND LOCATIONS. FIXTURES SHOWN HERE ARE EFERENCED AND SHOWN FOR GENERAL ALIGNMENT.				
	ENLARGED RCP	- LEGENI	0	
× (,,_,, 2 ''' - , , -) - ,	<b>GWB (C1)</b> INTERIOR	$\rightarrow$	SLOPE CEILING AS NOTED	
	T&G CEILING (C2) INTERIOR	0	CEILING MOUNTED LIGHT FIXTURE	
	FIBER-CEMENT SOFFIT (C3) - EXTERIOR	+ + + + + + + + + + + + + + + + + + + +	VINYL SCRIM CLG - INTERIOR	
	ACCESS PANEL		ACOUSTIC VINYL TILE CLG - INTERIOR	

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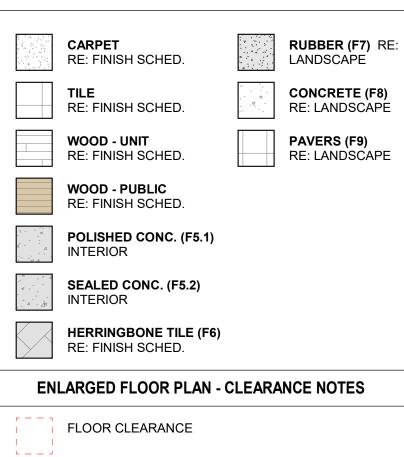
2 Level 02 - 3 BEDROOM STANDARD TYPE A - FURNITURE 1/4" = 1'-0" UNIT 206 **UNIT 206** 

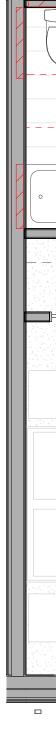Level 02 - 3 BEDROOM STANDARD TYPE A - RCP 1/4" = 1'-0" UNIT 206

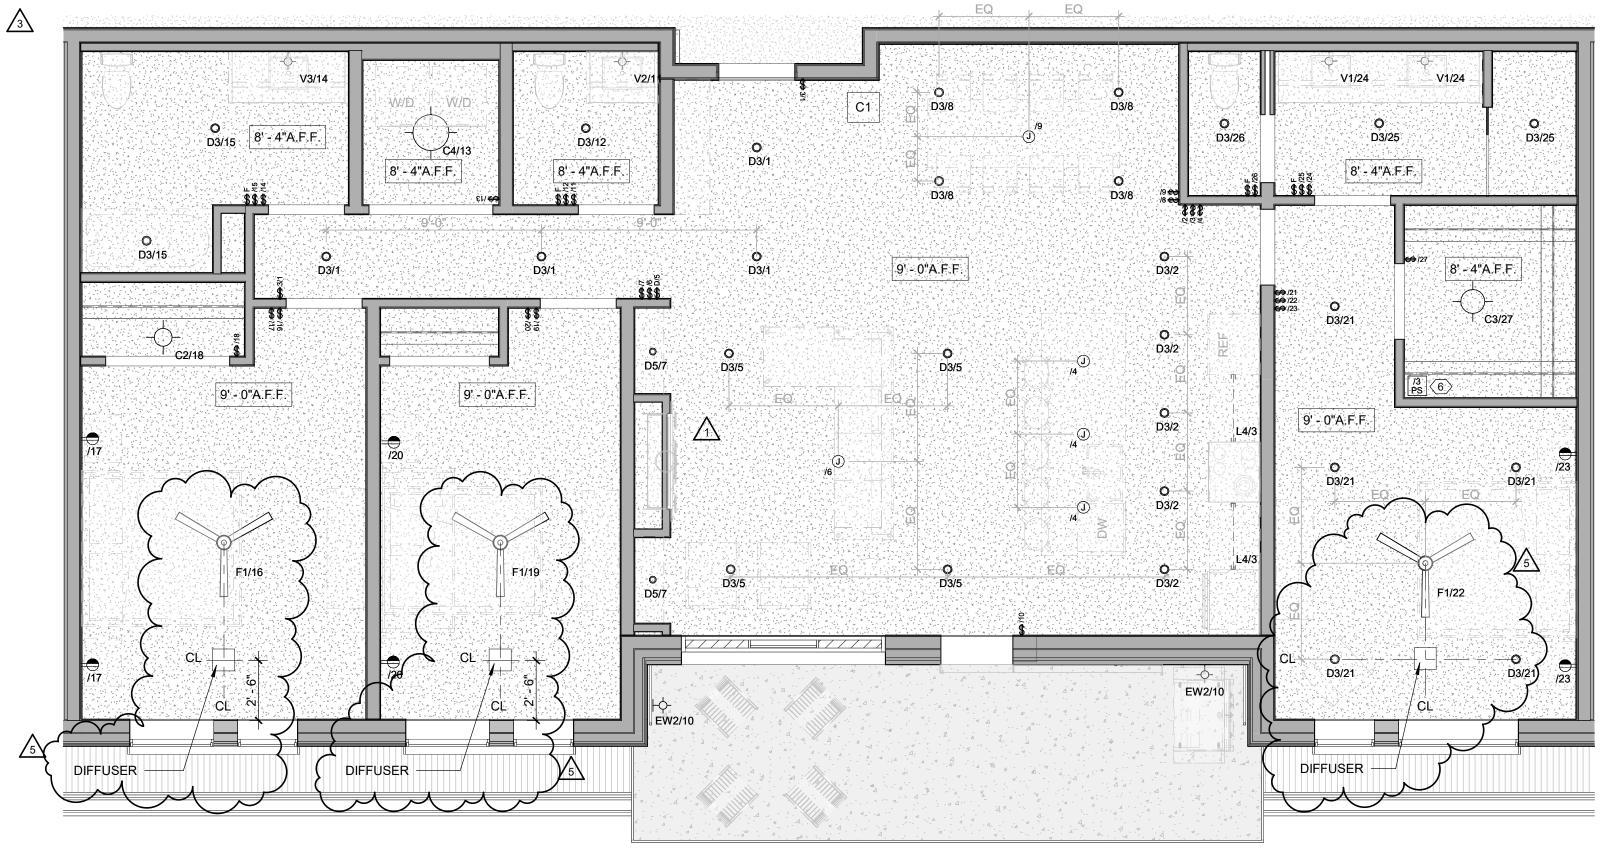UNIT 206

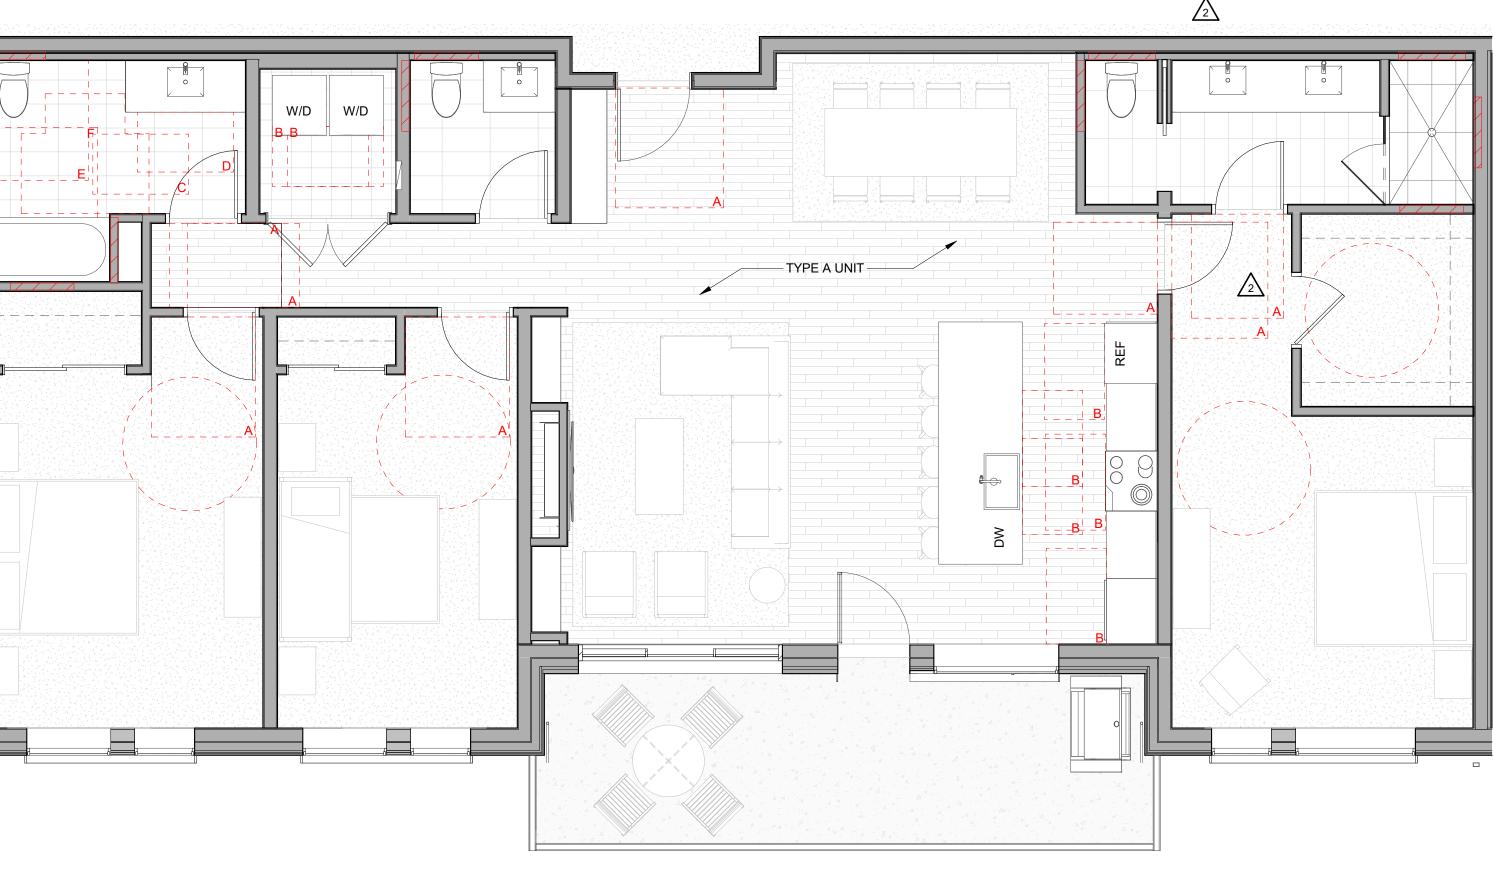- REFER TO G0.2X SHEETS FOR EXTERIOR AND INTERIOR
- BUILDING ENCLOSURE ASSEMBLIES. REFER TO A1.0X SHEETS FOR EXTERIOR WALL, DEMISING WALL, AND CORRIDOR WALL TYPES AND LOCATIONS.
- REFER TO A1.1X SHEETS FOR INTERIOR AND EXTERIOR WINDOW/DOOR TAGS WITH UNIT BACKGROUNDS FOR REFERENCE.
- ALIGN WALLS WHERE THEY APPEAR TO ALIGN, U.N.O. THE INSIDE FACE OF DOOR JAMBS SHALL BE 4" FROM
- ADJACENT WALL OR FINISHED COLUMN, U.N.O. PROVIDE BLOCKING FOR ALL WALL MOUNTED EQUIPMENT
- AND ACCESSORIES.
- THE CENTERLINE OF ALL RESIDENTIAL TOILETS SHALL BE LOCATED 18" OFF OF FINISH FACE OF WALL, U.N.O.
- SWING CLEARANCE AT UNIT ENTRY SHALL BE 18" MIN. FROM FINISH FACE OF ADJACENT SURFACE.
- ALL DIMENSIONS ARE TO FACE OF STUD, GRID LINE, OR FACE OF CONCRETE, U.N.O. 10. WHERE "CLEAR" IS CALLED OUT ON A DIMENSION,
- PROVIDE DIMENSION FROM FACE OF FINISH TO FACE OF FINISH.
- 11. FURNITURE IS NOT IN CONTRACT, U.N.O., AND IS SHOWN FOR DIAGRAMATIC PURPOSES ONLY. 12. CONSULTANT MODELS SHOWN FOR REFERENCE ONLY.

### ENLARGED FLOOR PLAN - LEGEND



- A DOOR CLEARANCE, 54" X 60"
- B APPLIANCE CLEARANCE, 30" X 48"
- C CLEAR FLOOR CLEARANCE, 30" X 48"
- D VANITY CLEARANCE, 30" X 48"
- E TOILET CLEARANCE, 48" X 56" OR ADA 60" X 56"
- F SHOWER/TUB CLEARANCE, 30" X 48" (B)
- G TURN AROUND CLEARANCE
- GRAB BAR BLOCKING REQ. AT TOILET WALL WHERE APPLICABLE

### ENLARGED RCP - GENERAL NOTES


- ALL UNIT CEILINGS SHALL BE 9' 0" A.F.F. U.N.O. REFER TO ENLARGED RCP'S FOR COMMON AREA CEILING HEIGHTS.
- IN THE CASE OF MINOR DISCREPANCIES BETWEEN MEP AND ARCHITECTURAL DOCUMENTS ON THE LOCATION OF CEILING MOUNTED COMPONENTS, THE ARCHITECTURAL RCP'S GOVERN. IN THE CASE OF MAJOR DISCREPANCIES, THE ARCHITECT SHALL BE NOTIFIED AS SOON AS THE DISCREPANCY IS DISCOVERED PRIOR TO PROCEEDING WITH THE WORK.
- REFERENCE MECHANICAL AND ELECTRICAL DRAWINGS FOR MOUNTING LOCATIONS OF ITEMS WHERE NO CEILING IS REQUIRED OR INDICATED.
- COORDINATE ALL TRADES INVOLVED IN THE CEILING WORK TO ENSURE CLEARANCE FOR FIXTURES, DUCTS, PIPING, CEILING SUSPENSION SYSTEMS, ETC. NECESSARY TO MAINTAIN CEILING HEIGHTS NOTED.
- LIGHTS, DIFFUSERS, EXIT SIGNS, SMOKE DETECTORS, SPEAKERS, STROBES, AND MISC. DEVICES SHALL BE CENTERED IN THE CEILING WHERE THEY OCCUR, U.N.O.
- FIRE PROTECTION SCOPE SHALL BE DESIGN-BUILD. ALL CORRIDOR SPRINKLER HEADS SHALL BE ALIGNED IN THE SAME LOCATION PARALLEL TO THE WALL WITHIN EACH SPECIFIC CEILING CONSTRUCTION.
- SMOKE ALARMS SHALL BE PROVIDED IN ALL BEDROOMS, OUTSIDE OF ALL BEDROOMS, AND ON EACH FLOOR AS REQUIRED. CARBON MONOXIDE DETECTORS SHALL BE INSTALLED OUTSIDE OF ALL BEDROOMS. SMOKE ALARMS AND CO DETECTORS SHALL BE HARDWIRED AND HAVE BATTERY BACKUP.
- ACCESS DOOR LOCATIONS IN GYPSUM BOARD CEILINGS ARE INDICATED ON RCP'S ONLY WHERE ARCHITECTURALLY SIGNIFICANT. REFERENCE SPECIFICATIONS AND MEP DRAWINGS FOR OTHER
- ACCESS DOOR LOCATIONS. UNLESS PREFINISHED TO MATCH ADJACENT SURFACE, PAINT MECHANICAL GRILLS, DIFFUSERS, ACCESS PANELS, AND OTHER EQUIPMENT TO MATCH ADJACENT SURFACE.
- 10. EXIT SIGNS ARE SHOWN ON RCP'S ONLY WHERE LOCATIONS ARE ARCHITECTURALLY SIGNIFICANT. 1. PROVIDE UL-CLASSIFIED LIGHT FIXTURES OR
- ENCLOSURES IN RATED FLOOR/CEILING ASSEMBLIES IN ACCORDANCE WITH IBC CHAPTER 7. 12. REFER TO LIGHTING PLANS FOR EXACT FIXTURE TYPES AND LOCATIONS. FIXTURES SHOWN HERE ARE
- REFERENCED AND SHOWN FOR GENERAL ALIGNMENT.

ENLARGED RCP - LEGEND

<b>GWB (C1)</b> INTERIOR	$\rightarrow$	SLOPE CEILING AS NOTED
 T&G CEILING (C2) INTERIOR	0	CEILING MOUNTED LIGHT FIXTURE
FIBER-CEMENT SOFFIT (C3) - EXTERIOR	+ + + + + + + + + + + + + + + + + + + +	VINYL SCRIM CLG - Interior
ACCESS PANEL		ACCOUSTIC VINYL TILE CLG - INTERIOF


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2 Level 03 - 3 BEDROOM STANDARD-FINISH 1/4" = 1'-0" UNIT 306

**UNIT 306** 2

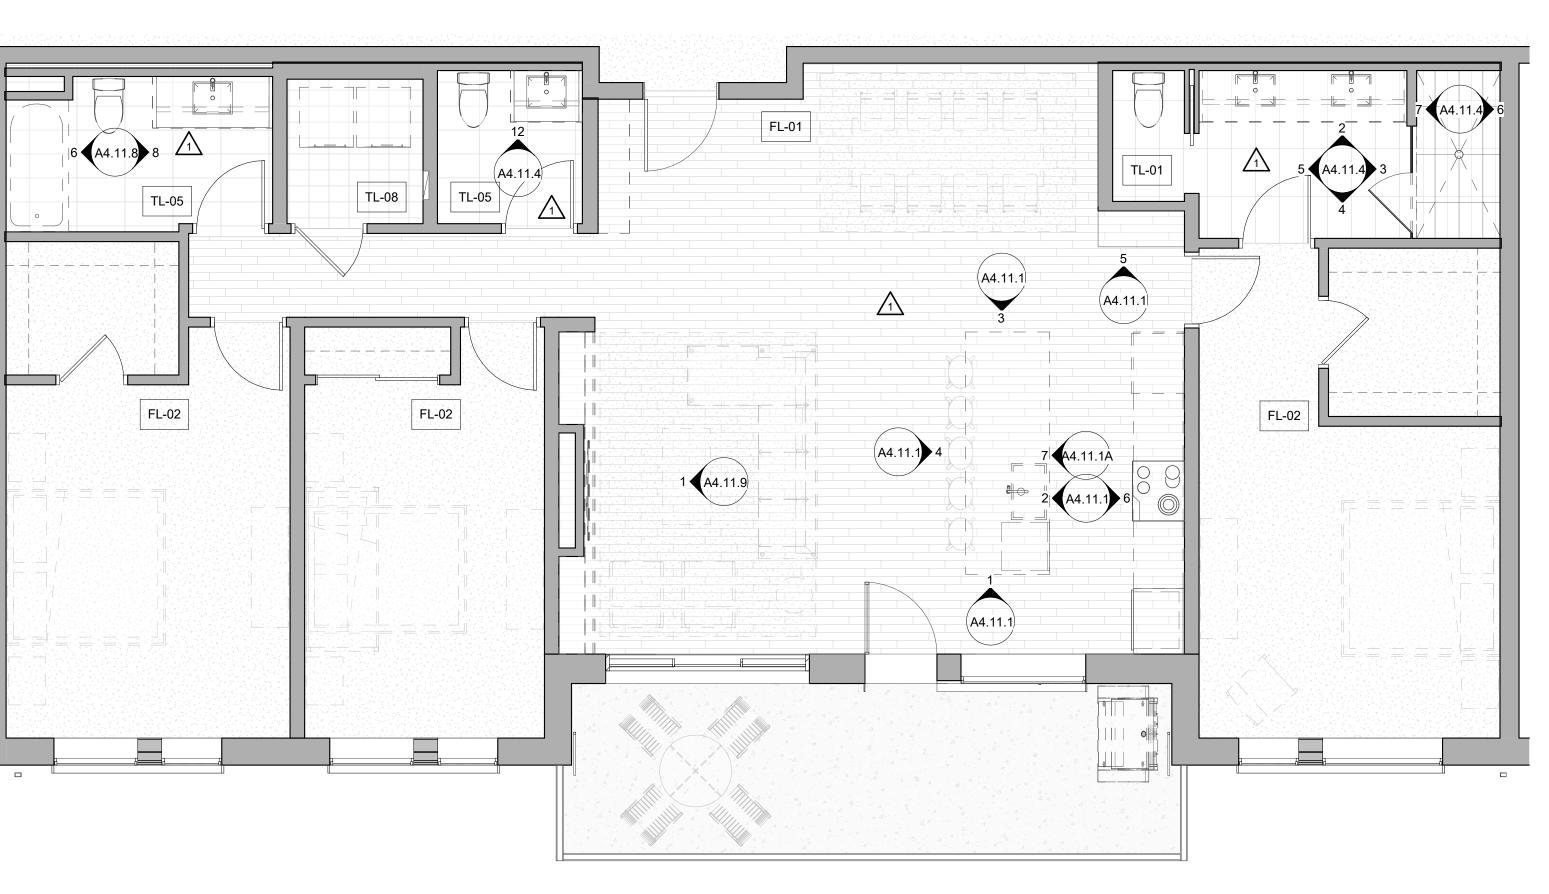


Level 03 - 3 BEDROOM STANDARD-DIMENSION 1/4" = 1'-0"
UNIT 306

**UNIT 306** 2
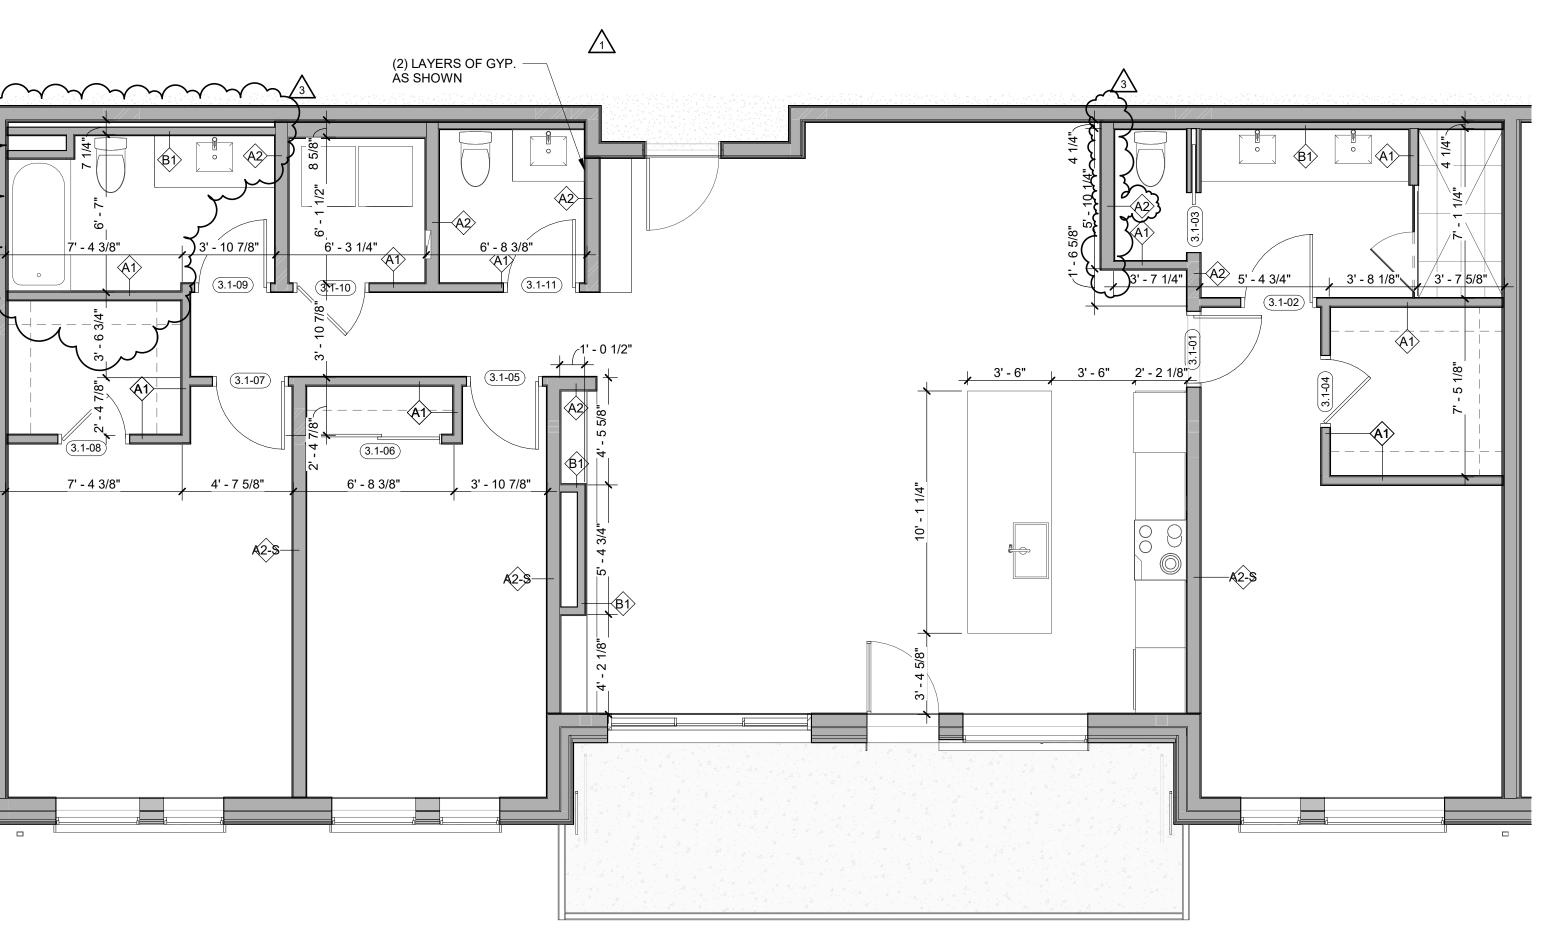
### ENLARGED FLOOR PLAN - GENERAL NOTES

- REFER TO G0.2X SHEETS FOR EXTERIOR AND INTERIOR BUILDING ENCLOSURE ASSEMBLIES. REFER TO A1.0X SHEETS FOR EXTERIOR WALL, DEMISING WALL, AND CORRIDOR WALL TYPES AND LOCATIONS.
- REFER TO A1.1X SHEETS FOR INTERIOR AND EXTERIOR WINDOW/DOOR TAGS WITH UNIT BACKGROUNDS FOR REFERENCE.
- ALIGN WALLS WHERE THEY APPEAR TO ALIGN, U.N.O. THE INSIDE FACE OF DOOR JAMBS SHALL BE 4" FROM ADJACENT WALL OR FINISHED COLUMN, U.N.O.
- PROVIDE BLOCKING FOR ALL WALL MOUNTED EQUIPMENT AND ACCESSORIES.
- THE CENTERLINE OF ALL RESIDENTIAL TOILETS SHALL BE LOCATED 18" OFF OF FINISH FACE OF WALL, U.N.O.
- SWING CLEARANCE AT UNIT ENTRY SHALL BE 18" MIN. FROM FINISH FACE OF ADJACENT SURFACE.
- ALL DIMENSIONS ARE TO FACE OF STUD, GRID LINE, OR
- FACE OF CONCRETE, U.N.O. 10. WHERE "CLEAR" IS CALLED OUT ON A DIMENSION, PROVIDE DIMENSION FROM FACE OF FINISH TO FACE OF
- FINISH. 11. FURNITURE IS NOT IN CONTRACT, U.N.O., AND IS SHOWN
- FOR DIAGRAMATIC PURPOSES ONLY.
- 12. CONSULTANT MODELS SHOWN FOR REFERENCE ONLY.

### ENLARGED FLOOR PLAN - LEGEND

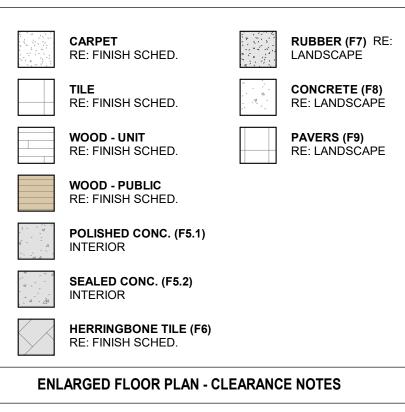


- FLOOR CLEARANCE
- A DOOR CLEARANCE, 54" X 60"
- B APPLIANCE CLEARANCE, 30" X 48"
- C CLEAR FLOOR CLEARANCE, 30" X 48"
- D VANITY CLEARANCE, 30" X 48" E TOILET CLEARANCE, 48" X 56" OR ADA 60" X 56"
- F SHOWER/TUB CLEARANCE, 30" X 48" (B)  $\bigtriangleup$
- G TURN AROUND CLEARANCE
- GRAB BAR BLOCKING REQ. AT TOILET
- WALL WHERE APPLICABLE

### ENLARGED RCP - GENERAL NOTES


- ALL UNIT CEILINGS SHALL BE 9' 0" A.F.F. U.N.O. REFER TO ENLARGED RCP'S FOR COMMON AREA CEILING HEIGHTS.
- IN THE CASE OF MINOR DISCREPANCIES BETWEEN MEP AND ARCHITECTURAL DOCUMENTS ON THE LOCATION OF CEILING MOUNTED COMPONENTS, THE ARCHITECTURAL RCP'S GOVERN. IN THE CASE OF MAJOR DISCREPANCIES, THE ARCHITECT SHALL BE NOTIFIED AS SOON AS THE DISCREPANCY IS DISCOVERED PRIOR TO PROCEEDING WITH THE WORK.
- REFERENCE MECHANICAL AND ELECTRICAL DRAWINGS FOR MOUNTING LOCATIONS OF ITEMS WHERE NO CEILING IS REQUIRED OR INDICATED.
- COORDINATE ALL TRADES INVOLVED IN THE CEILING WORK TO ENSURE CLEARANCE FOR FIXTURES, DUCTS, PIPING, CEILING SUSPENSION SYSTEMS, ETC. NECESSARY TO MAINTAIN CEILING HEIGHTS NOTED.
- LIGHTS, DIFFUSERS, EXIT SIGNS, SMOKE DETECTORS, SPEAKERS, STROBES, AND MISC. DEVICES SHALL BE CENTERED IN THE CEILING WHERE THEY OCCUR, U.N.O. FIRE PROTECTION SCOPE SHALL BE DESIGN-BUILD. ALL
- CORRIDOR SPRINKLER HEADS SHALL BE ALIGNED IN THE SAME LOCATION PARALLEL TO THE WALL WITHIN EACH SPECIFIC CEILING CONSTRUCTION. SMOKE ALARMS SHALL BE PROVIDED IN ALL BEDROOMS,
- OUTSIDE OF ALL BEDROOMS, AND ON EACH FLOOR AS REQUIRED. CARBON MONOXIDE DETECTORS SHALL BE INSTALLED OUTSIDE OF ALL BEDROOMS. SMOKE ALARMS AND CO DETECTORS SHALL BE HARDWIRED AND HAVE BATTERY BACKUP.
- ACCESS DOOR LOCATIONS IN GYPSUM BOARD CEILINGS ARE INDICATED ON RCP'S ONLY WHERE ARCHITECTURALLY SIGNIFICANT. REFERENCE SPECIFICATIONS AND MEP DRAWINGS FOR OTHER
- ACCESS DOOR LOCATIONS. UNLESS PREFINISHED TO MATCH ADJACENT SURFACE, PAINT MECHANICAL GRILLS, DIFFUSERS, ACCESS PANELS, AND OTHER EQUIPMENT TO MATCH ADJACENT SURFACE.
- 10. EXIT SIGNS ARE SHOWN ON RCP'S ONLY WHERE LOCATIONS ARE ARCHITECTURALLY SIGNIFICANT.
- 11. PROVIDE UL-CLASSIFIED LIGHT FIXTURES OR ΕN AC 12. RE
- A١ RF


ICLOSURES IN RATED FLOOR/CEILING ASSEMBLIES IN CORDANCE WITH IBC CHAPTER 7. FER TO LIGHTING PLANS FOR EXACT FIXTURE TYPES ID LOCATIONS. FIXTURES SHOWN HERE ARE FERENCED AND SHOWN FOR GENERAL ALIGNMENT.			
	ENLARGED RCP	- LEGENI	ס
()_( 2 - () -) - () - () - () - () - () - ()	<b>GWB (C1)</b> INTERIOR	$\rightarrow$	SLOPE CEILING AS NOTED
	<b>T&amp;G CEILING (C2)</b> INTERIOR	0	CEILING MOUNTED LIGHT FIXTURE
	FIBER-CEMENT SOFFIT (C3) - EXTERIOR	+ + + + + + + + + + + + + + + + + + + +	VINYL SCRIM CLG - Interior
	ACCESS PANEL		ACOUSTIC VINYL TILE CLG - INTERIOR

BRSCE D. WINS B-2465 12/15/2023
<b>The Amble</b> Stamboat Springs, CO
REVISIONS         No.       Description       Date         1       15.24       03.15.24         2       03.15.24       03.15.24         3       RFI #339       11.13.24         1       11.13.24       11.13.24         1       Description       Date         2       RFI #339       11.13.24         1       Description       Date         2       NFI #339       11.13.24         1       Description       Date         2       NET       31.13.24         1       Description       Date         2       NET       31.13.24         1       Description       Date         2       NE       31.13.24         2       Description       Date         2
SHEET TITLE UNIT PLAN - 3 BEDROOM STANDARD - LEVEL 03 SHEET NO.

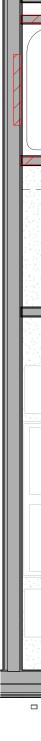




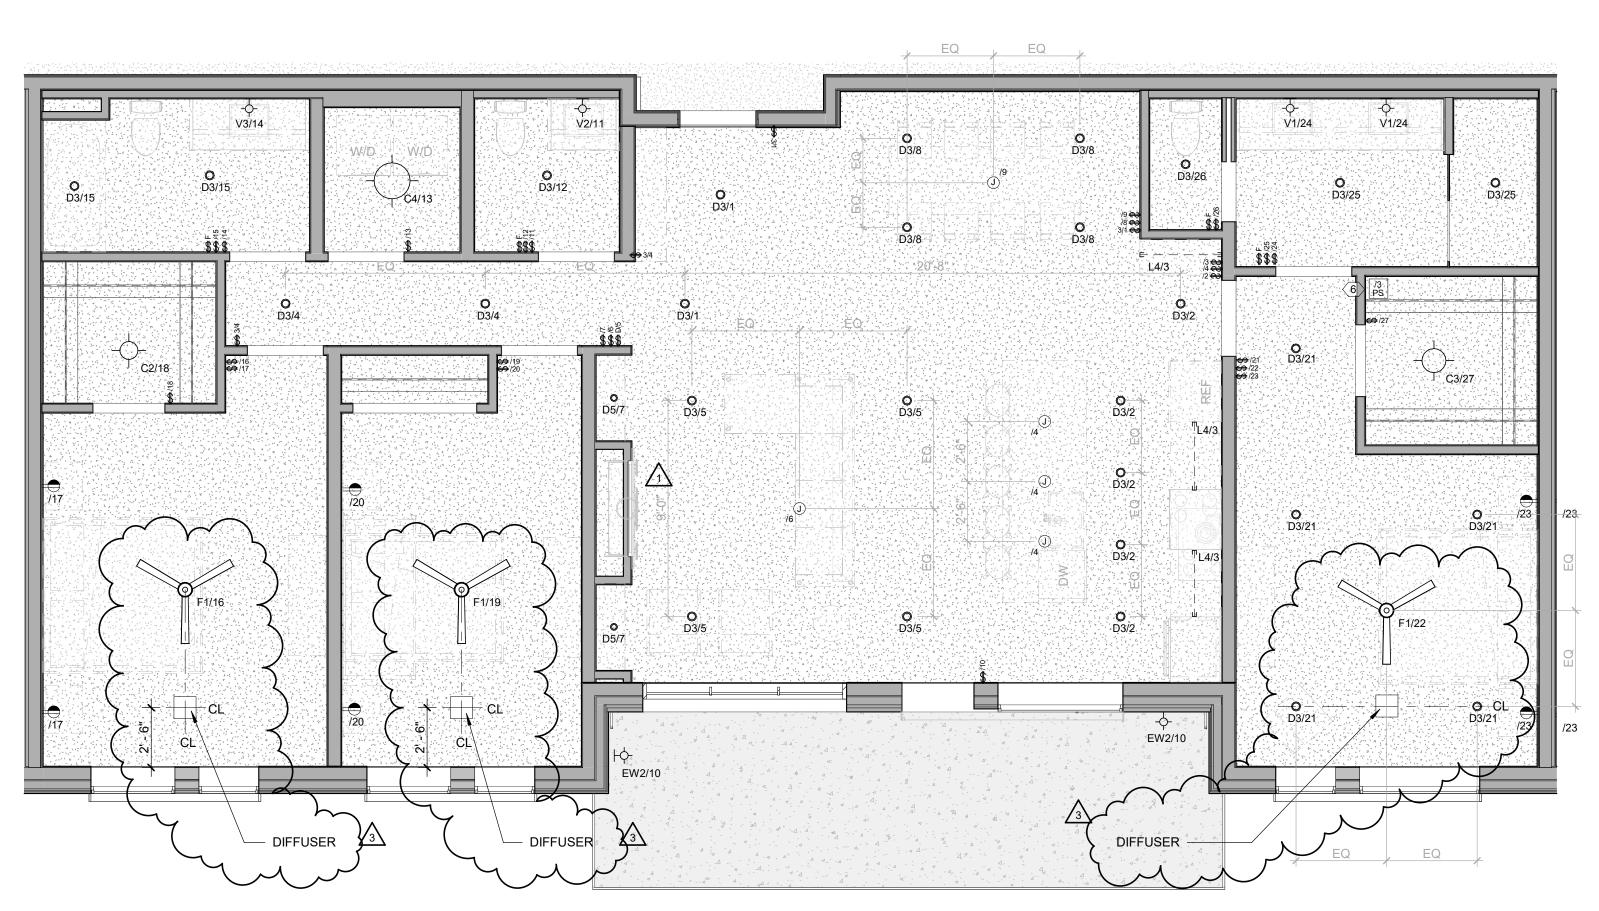

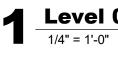



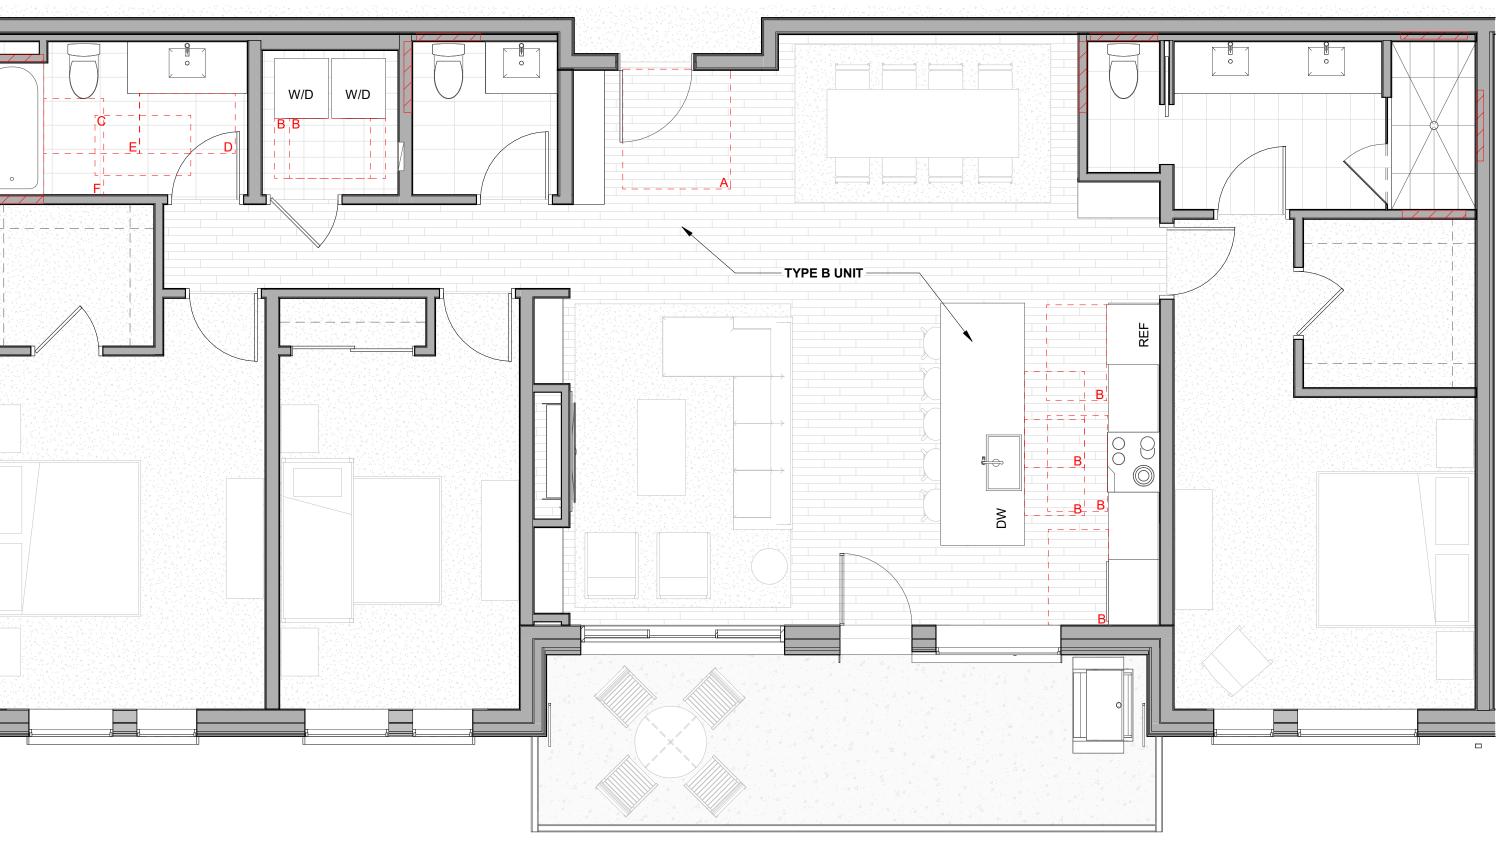


2 Level 03 - 3 BEDROOM STANDARD-FURNITURE 1/4" = 1'-0" UNIT 306 **UNIT 306** 

Level 03 - 3 BEDROOM STANDARD-RCP **UNIT 306** 

- REFER TO G0.2X SHEETS FOR EXTERIOR AND INTERIOR BUILDING ENCLOSURE ASSEMBLIES.
- REFER TO A1.0X SHEETS FOR EXTERIOR WALL, DEMISING WALL, AND CORRIDOR WALL TYPES AND LOCATIONS. REFER TO A1.1X SHEETS FOR INTERIOR AND EXTERIOR WINDOW/DOOR TAGS WITH UNIT BACKGROUNDS FOR
- REFERENCE. ALIGN WALLS WHERE THEY APPEAR TO ALIGN, U.N.O.
- THE INSIDE FACE OF DOOR JAMBS SHALL BE 4" FROM ADJACENT WALL OR FINISHED COLUMN, U.N.O.
- PROVIDE BLOCKING FOR ALL WALL MOUNTED EQUIPMENT AND ACCESSORIES.
- THE CENTERLINE OF ALL RESIDENTIAL TOILETS SHALL BE
- LOCATED 18" OFF OF FINISH FACE OF WALL, U.N.O. SWING CLEARANCE AT UNIT ENTRY SHALL BE 18" MIN.
- FROM FINISH FACE OF ADJACENT SURFACE. ALL DIMENSIONS ARE TO FACE OF STUD, GRID LINE, OR FACE OF CONCRETE, U.N.O.
- 10. WHERE "CLEAR" IS CALLED OUT ON A DIMENSION, PROVIDE DIMENSION FROM FACE OF FINISH TO FACE OF FINISH.
- 11. FURNITURE IS NOT IN CONTRACT, U.N.O., AND IS SHOWN FOR DIAGRAMATIC PURPOSES ONLY. 12. CONSULTANT MODELS SHOWN FOR REFERENCE ONLY.

### ENLARGED FLOOR PLAN - LEGEND

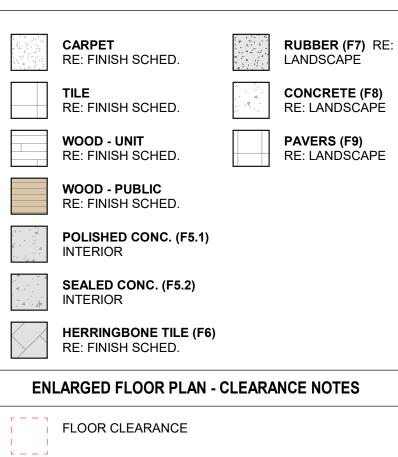


- A DOOR CLEARANCE, 54" X 60"
- B APPLIANCE CLEARANCE, 30" X 48"
- C CLEAR FLOOR CLEARANCE, 30" X 48"
- D VANITY CLEARANCE, 30" X 48"
- E TOILET CLEARANCE, 48" X 56" OR ADA 60" X 56"
- F SHOWER/TUB CLEARANCE, 30" X 48" (B)
- G TURN AROUND CLEARANCE
- GRAB BAR BLOCKING REQ. AT TOILET WALL WHERE APPLICABLE

### ENLARGED RCP - GENERAL NOTES


- ALL UNIT CEILINGS SHALL BE 9' 0" A.F.F. U.N.O. REFER TO ENLARGED RCP'S FOR COMMON AREA CEILING HEIGHTS.
- IN THE CASE OF MINOR DISCREPANCIES BETWEEN MEP AND ARCHITECTURAL DOCUMENTS ON THE LOCATION OF CEILING MOUNTED COMPONENTS, THE ARCHITECTURAL RCP'S GOVERN. IN THE CASE OF MAJOR DISCREPANCIES, THE ARCHITECT SHALL BE NOTIFIED AS SOON AS THE DISCREPANCY IS DISCOVERED PRIOR TO PROCEEDING WITH THE WORK.
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- COORDINATE ALL TRADES INVOLVED IN THE CEILING WORK TO ENSURE CLEARANCE FOR FIXTURES, DUCTS, PIPING, CEILING SUSPENSION SYSTEMS, ETC. NECESSARY TO MAINTAIN CEILING HEIGHTS NOTED.
- LIGHTS, DIFFUSERS, EXIT SIGNS, SMOKE DETECTORS, SPEAKERS, STROBES, AND MISC. DEVICES SHALL BE CENTERED IN THE CEILING WHERE THEY OCCUR, U.N.O.
- FIRE PROTECTION SCOPE SHALL BE DESIGN-BUILD. ALL CORRIDOR SPRINKLER HEADS SHALL BE ALIGNED IN THE SAME LOCATION PARALLEL TO THE WALL WITHIN EACH SPECIFIC CEILING CONSTRUCTION.
- SMOKE ALARMS SHALL BE PROVIDED IN ALL BEDROOMS, OUTSIDE OF ALL BEDROOMS, AND ON EACH FLOOR AS REQUIRED. CARBON MONOXIDE DETECTORS SHALL BE INSTALLED OUTSIDE OF ALL BEDROOMS. SMOKE ALARMS AND CO DETECTORS SHALL BE HARDWIRED AND HAVE BATTERY BACKUP.
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- 10. EXIT SIGNS ARE SHOWN ON RCP'S ONLY WHERE LOCATIONS ARE ARCHITECTURALLY SIGNIFICANT. I. PROVIDE UL-CLASSIFIED LIGHT FIXTURES OR
- ENCLOSURES IN RATED FLOOR/CEILING ASSEMBLIES IN ACCORDANCE WITH IBC CHAPTER 7. 12. REFER TO LIGHTING PLANS FOR EXACT FIXTURE TYPES AND LOCATIONS. FIXTURES SHOWN HERE ARE
- REFERENCED AND SHOWN FOR GENERAL ALIGNMENT.

<b>GWB (C1)</b> INTERIOR	$\rightarrow$	SLOPE CEILING AS NOTED
T&G CEILING (C2) INTERIOR	0	CEILING MOUNTED LIGHT FIXTURE
FIBER-CEMENT SOFFIT	+ + + +	VINYL SCRIM CLG -
(C3) - EXTERIOR	+ +	INTERIOR
(C3) - EXTERIOR	+ +	ACCOUSTIC VINYL TILE CLG - INTERIOF

D	<b>35</b> E S	STAMP	<b>)</b>
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	The Amble	Steamboat Springs, CO	
REVISIONS	Descr RFI#110 ASI 004 RFI#223.1	06	Date 3.14.24 3.07.24 3.07.24 3.16.24
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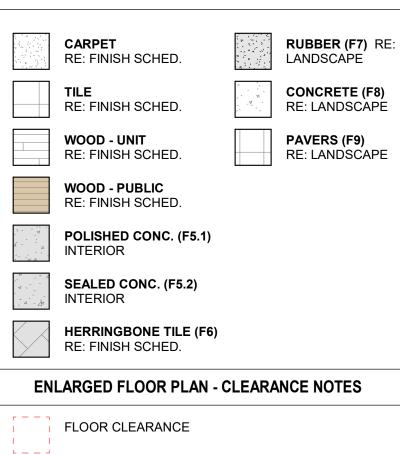


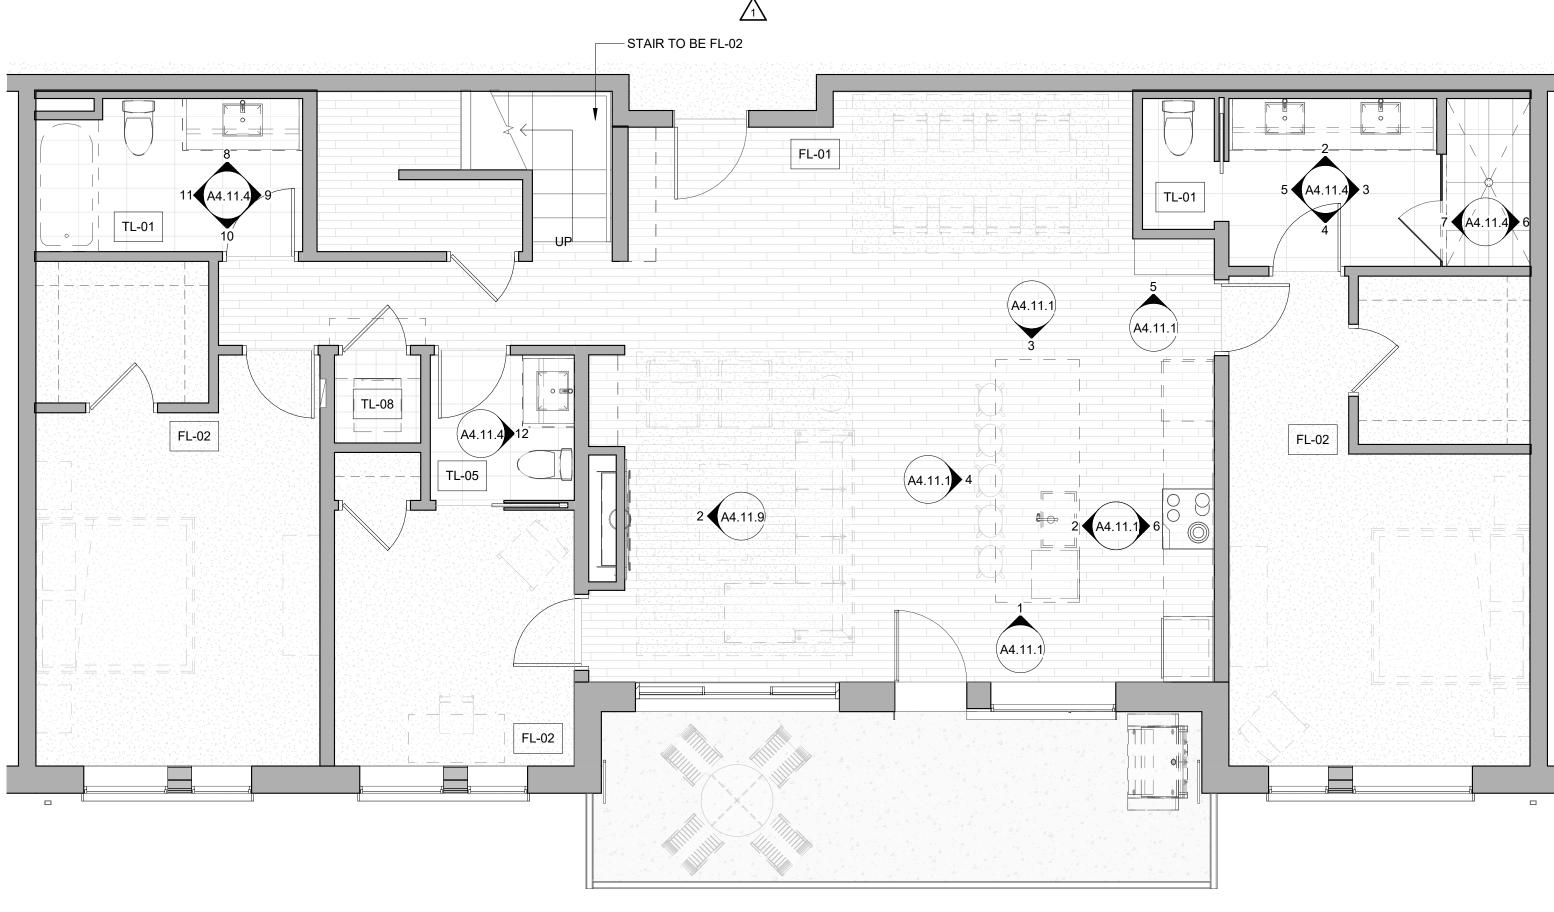Level 04 - 3 BEDROOM STANDARD DIMENSION

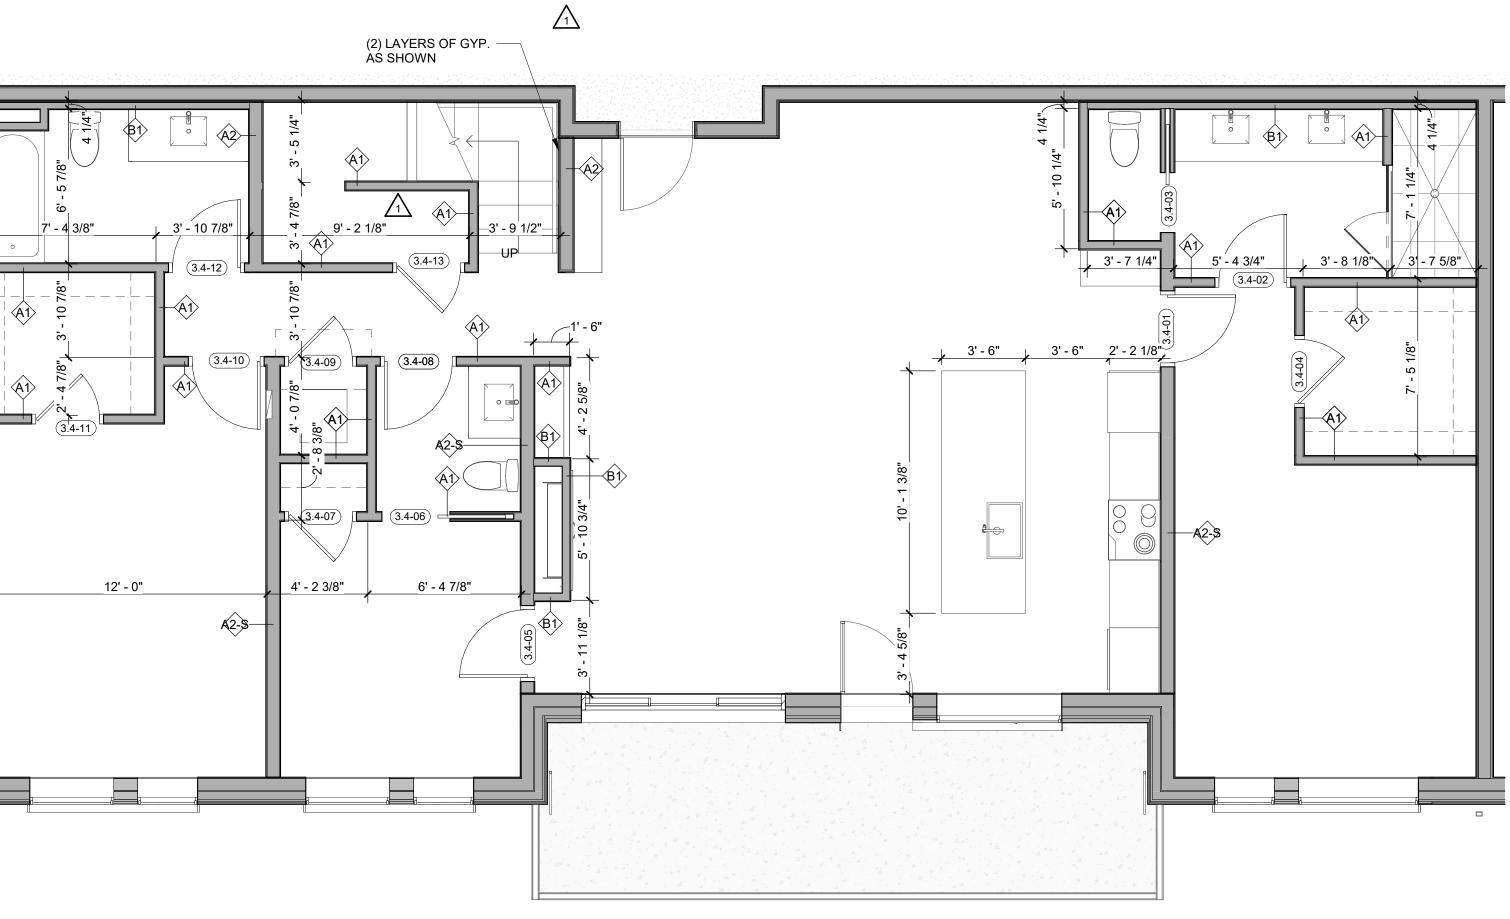

- REFER TO G0.2X SHEETS FOR EXTERIOR AND INTERIOR
- BUILDING ENCLOSURE ASSEMBLIES. REFER TO A1.0X SHEETS FOR EXTERIOR WALL, DEMISING WALL, AND CORRIDOR WALL TYPES AND LOCATIONS.
- REFER TO A1.1X SHEETS FOR INTERIOR AND EXTERIOR WINDOW/DOOR TAGS WITH UNIT BACKGROUNDS FOR REFERENCE.
- ALIGN WALLS WHERE THEY APPEAR TO ALIGN, U.N.O. THE INSIDE FACE OF DOOR JAMBS SHALL BE 4" FROM
- ADJACENT WALL OR FINISHED COLUMN, U.N.O. PROVIDE BLOCKING FOR ALL WALL MOUNTED EQUIPMENT
- AND ACCESSORIES.
- THE CENTERLINE OF ALL RESIDENTIAL TOILETS SHALL BE LOCATED 18" OFF OF FINISH FACE OF WALL, U.N.O. SWING CLEARANCE AT UNIT ENTRY SHALL BE 18" MIN.
- FROM FINISH FACE OF ADJACENT SURFACE. ALL DIMENSIONS ARE TO FACE OF STUD, GRID LINE, OR
- FACE OF CONCRETE, U.N.O. 10. WHERE "CLEAR" IS CALLED OUT ON A DIMENSION,
- PROVIDE DIMENSION FROM FACE OF FINISH TO FACE OF FINISH 11. FURNITURE IS NOT IN CONTRACT, U.N.O., AND IS SHOWN
- FOR DIAGRAMATIC PURPOSES ONLY. 12. CONSULTANT MODELS SHOWN FOR REFERENCE ONLY.

### ENLARGED FLOOR PLAN - LEGEND



- A DOOR CLEARANCE, 54" X 60"
- B APPLIANCE CLEARANCE, 30" X 48"
- C CLEAR FLOOR CLEARANCE, 30" X 48"
- D VANITY CLEARANCE, 30" X 48"
- E TOILET CLEARANCE, 48" X 56" OR ADA 60" X 56"
- F SHOWER/TUB CLEARANCE, 30" X 48" (B)  $\bigtriangleup$
- G TURN AROUND CLEARANCE
- GRAB BAR BLOCKING REQ. AT TOILET
- WALL WHERE APPLICABLE

### ENLARGED RCP - GENERAL NOTES

- ALL UNIT CEILINGS SHALL BE 9' 0" A.F.F. U.N.O. REFER TO ENLARGED RCP'S FOR COMMON AREA CEILING HEIGHTS.
- IN THE CASE OF MINOR DISCREPANCIES BETWEEN MEP AND ARCHITECTURAL DOCUMENTS ON THE LOCATION OF CEILING MOUNTED COMPONENTS, THE ARCHITECTURAL RCP'S GOVERN. IN THE CASE OF MAJOR DISCREPANCIES, THE ARCHITECT SHALL BE NOTIFIED AS SOON AS THE DISCREPANCY IS DISCOVERED PRIOR TO PROCEEDING WITH THE WORK.
- REFERENCE MECHANICAL AND ELECTRICAL DRAWINGS FOR MOUNTING LOCATIONS OF ITEMS WHERE NO CEILING IS REQUIRED OR INDICATED.
- COORDINATE ALL TRADES INVOLVED IN THE CEILING WORK TO ENSURE CLEARANCE FOR FIXTURES, DUCTS, PIPING, CEILING SUSPENSION SYSTEMS, ETC. NECESSARY TO MAINTAIN CEILING HEIGHTS NOTED.
- LIGHTS, DIFFUSERS, EXIT SIGNS, SMOKE DETECTORS, SPEAKERS, STROBES, AND MISC. DEVICES SHALL BE CENTERED IN THE CEILING WHERE THEY OCCUR, U.N.O. FIRE PROTECTION SCOPE SHALL BE DESIGN-BUILD. ALL
- CORRIDOR SPRINKLER HEADS SHALL BE ALIGNED IN THE SAME LOCATION PARALLEL TO THE WALL WITHIN EACH SPECIFIC CEILING CONSTRUCTION.
- SMOKE ALARMS SHALL BE PROVIDED IN ALL BEDROOMS, OUTSIDE OF ALL BEDROOMS, AND ON EACH FLOOR AS REQUIRED. CARBON MONOXIDE DETECTORS SHALL BE INSTALLED OUTSIDE OF ALL BEDROOMS. SMOKE ALARMS AND CO DETECTORS SHALL BE HARDWIRED AND HAVE BATTERY BACKUP.
- ACCESS DOOR LOCATIONS IN GYPSUM BOARD CEILINGS ARE INDICATED ON RCP'S ONLY WHERE ARCHITECTURALLY SIGNIFICANT. REFERENCE SPECIFICATIONS AND MEP DRAWINGS FOR OTHER
- ACCESS DOOR LOCATIONS. UNLESS PREFINISHED TO MATCH ADJACENT SURFACE, PAINT MECHANICAL GRILLS, DIFFUSERS, ACCESS PANELS, AND OTHER EQUIPMENT TO MATCH ADJACENT SURFACE.
- 10. EXIT SIGNS ARE SHOWN ON RCP'S ONLY WHERE LOCATIONS ARE ARCHITECTURALLY SIGNIFICANT. 11. PROVIDE UL-CLASSIFIED LIGHT FIXTURES OR ENCLOSURES IN RATED FLOOR/CEILING ASSEMBLIES IN
- ACCORDANCE WITH IBC CHAPTER 7. 12. REFER TO LIGHTING PLANS FOR EXACT FIXTURE TYPES AND LOCATIONS. FIXTURES SHOWN HERE ARE
- REFERENCED AND SHOWN FOR GENERAL ALIGNMENT.

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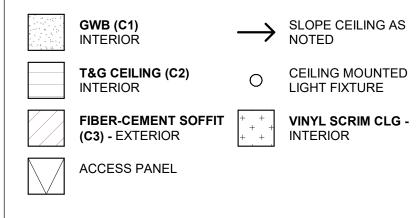
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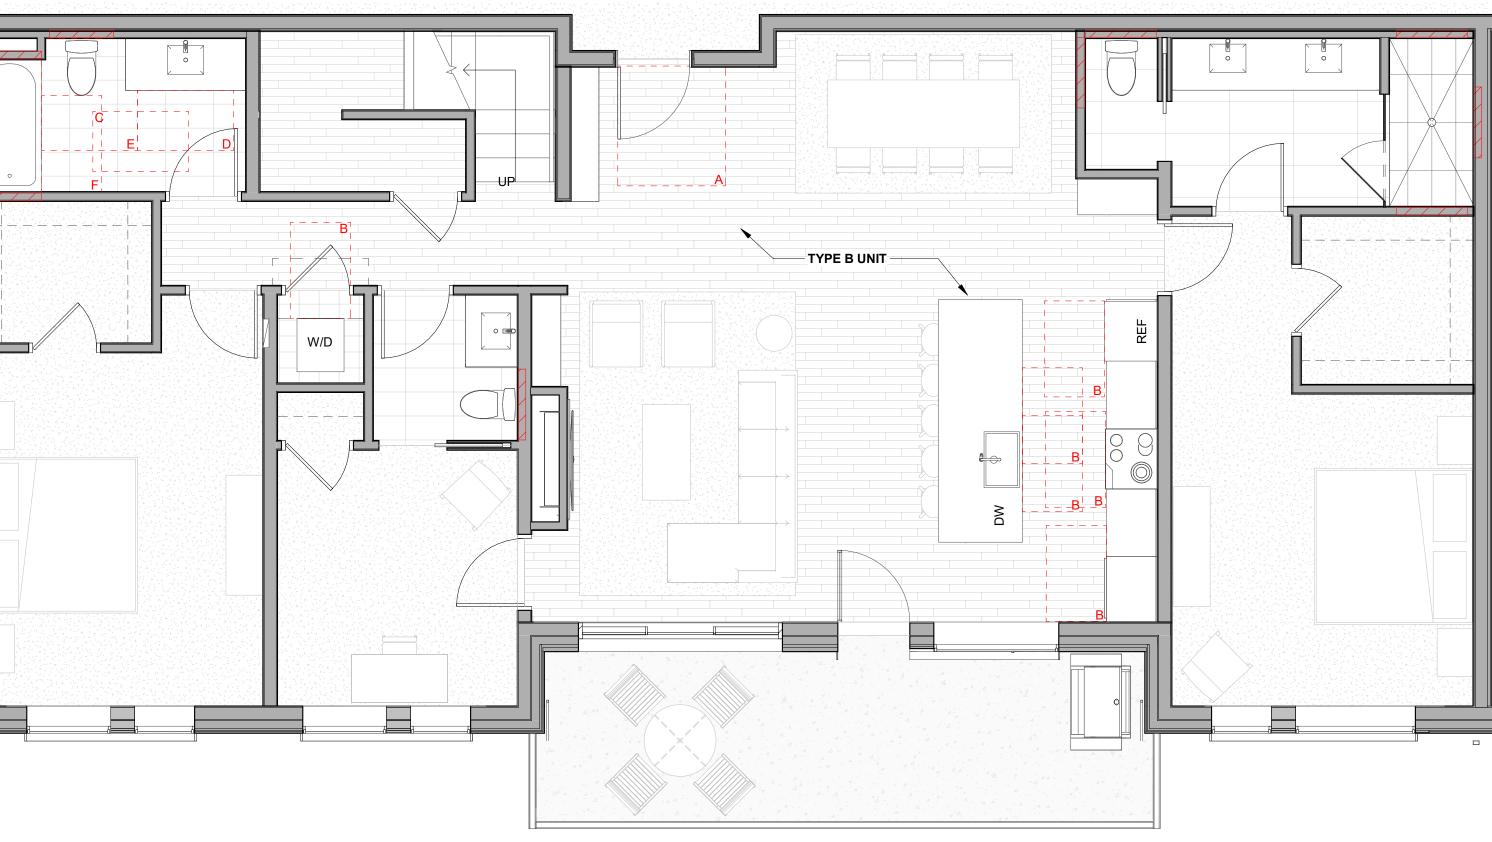














2 Level 04 - 3 BEDROOM STANDARD FURNITURE 1/4" = 1'-0" UNIT 406

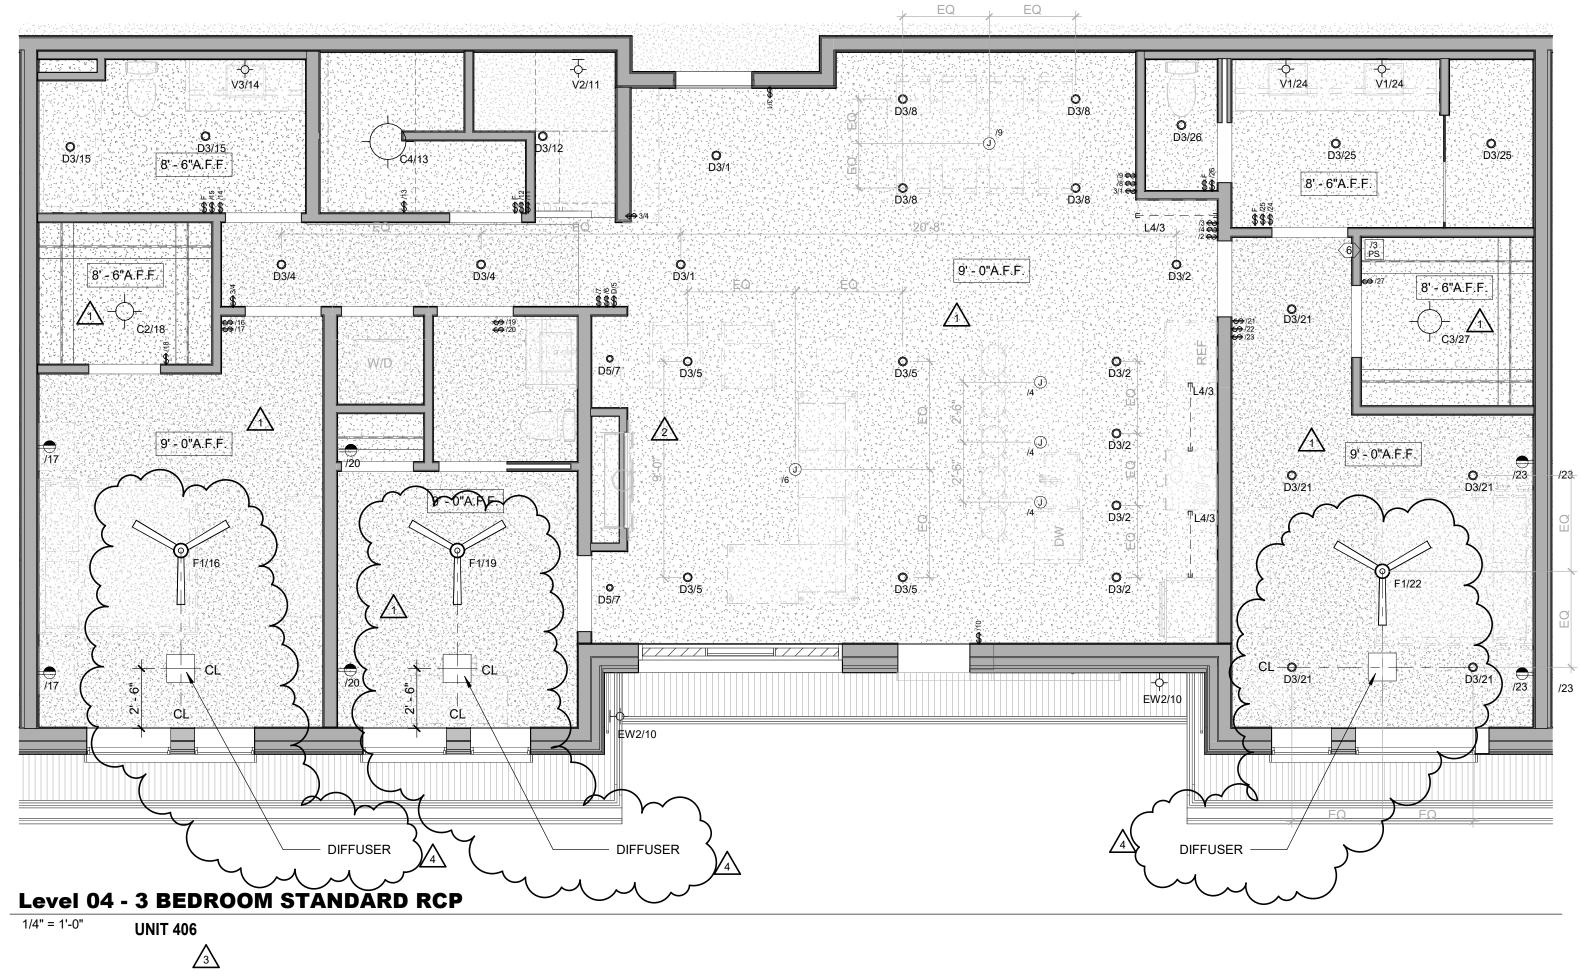

- REFER TO G0.2X SHEETS FOR EXTERIOR AND INTERIOR BUILDING ENCLOSURE ASSEMBLIES.
- REFER TO A1.0X SHEETS FOR EXTERIOR WALL, DEMISING WALL, AND CORRIDOR WALL TYPES AND LOCATIONS.
- REFER TO A1.1X SHEETS FOR INTERIOR AND EXTERIOR WINDOW/DOOR TAGS WITH UNIT BACKGROUNDS FOR REFERENCE. ALIGN WALLS WHERE THEY APPEAR TO ALIGN, U.N.O.
- THE INSIDE FACE OF DOOR JAMBS SHALL BE 4" FROM
- ADJACENT WALL OR FINISHED COLUMN, U.N.O. PROVIDE BLOCKING FOR ALL WALL MOUNTED EQUIPMENT
- AND ACCESSORIES. THE CENTERLINE OF ALL RESIDENTIAL TOILETS SHALL BE
- LOCATED 18" OFF OF FINISH FACE OF WALL, U.N.O. SWING CLEARANCE AT UNIT ENTRY SHALL BE 18" MIN.
- FROM FINISH FACE OF ADJACENT SURFACE. ALL DIMENSIONS ARE TO FACE OF STUD, GRID LINE, OR
- FACE OF CONCRETE, U.N.O. 10. WHERE "CLEAR" IS CALLED OUT ON A DIMENSION, PROVIDE DIMENSION FROM FACE OF FINISH TO FACE OF
- FINISH. 11. FURNITURE IS NOT IN CONTRACT, U.N.O., AND IS SHOWN
- FOR DIAGRAMATIC PURPOSES ONLY. 12. CONSULTANT MODELS SHOWN FOR REFERENCE ONLY.

### ENLARGED FLOOR PLAN - LEGEND

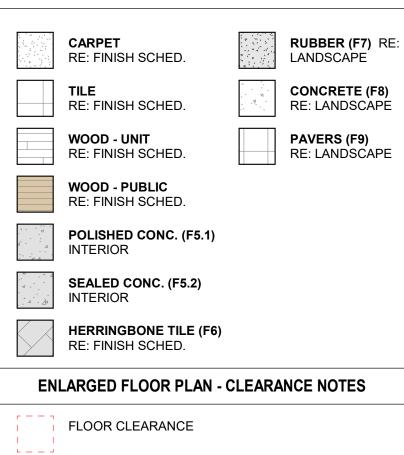

- A DOOR CLEARANCE, 54" X 60"
- B APPLIANCE CLEARANCE, 30" X 48"
- C CLEAR FLOOR CLEARANCE, 30" X 48"
- D VANITY CLEARANCE, 30" X 48"
- E TOILET CLEARANCE, 48" X 56" OR ADA 60" X 56"
- F SHOWER/TUB CLEARANCE, 30" X 48" (B)
- G TURN AROUND CLEARANCE
- GRAB BAR BLOCKING REQ. AT TOILET WALL WHERE APPLICABLE

### ENLARGED RCP - GENERAL NOTES

- ALL UNIT CEILINGS SHALL BE 9' 0" A.F.F. U.N.O. REFER TO ENLARGED RCP'S FOR COMMON AREA CEILING HEIGHTS.
- IN THE CASE OF MINOR DISCREPANCIES BETWEEN MEP AND ARCHITECTURAL DOCUMENTS ON THE LOCATION OF CEILING MOUNTED COMPONENTS, THE ARCHITECTURAL RCP'S GOVERN. IN THE CASE OF MAJOR DISCREPANCIES, THE ARCHITECT SHALL BE NOTIFIED AS SOON AS THE DISCREPANCY IS DISCOVERED PRIOR TO PROCEEDING WITH THE WORK.
- REFERENCE MECHANICAL AND ELECTRICAL DRAWINGS FOR MOUNTING LOCATIONS OF ITEMS WHERE NO CEILING IS REQUIRED OR INDICATED.
- COORDINATE ALL TRADES INVOLVED IN THE CEILING WORK TO ENSURE CLEARANCE FOR FIXTURES, DUCTS, PIPING, CEILING SUSPENSION SYSTEMS, ETC. NECESSARY TO MAINTAIN CEILING HEIGHTS NOTED.
- LIGHTS, DIFFUSERS, EXIT SIGNS, SMOKE DETECTORS, SPEAKERS, STROBES, AND MISC. DEVICES SHALL BE CENTERED IN THE CEILING WHERE THEY OCCUR, U.N.O. FIRE PROTECTION SCOPE SHALL BE DESIGN-BUILD. ALL
- CORRIDOR SPRINKLER HEADS SHALL BE ALIGNED IN THE SAME LOCATION PARALLEL TO THE WALL WITHIN EACH SPECIFIC CEILING CONSTRUCTION.
- SMOKE ALARMS SHALL BE PROVIDED IN ALL BEDROOMS, OUTSIDE OF ALL BEDROOMS, AND ON EACH FLOOR AS REQUIRED. CARBON MONOXIDE DETECTORS SHALL BE INSTALLED OUTSIDE OF ALL BEDROOMS. SMOKE ALARMS AND CO DETECTORS SHALL BE HARDWIRED AND HAVE BATTERY BACKUP.
- ACCESS DOOR LOCATIONS IN GYPSUM BOARD CEILINGS ARE INDICATED ON RCP'S ONLY WHERE ARCHITECTURALLY SIGNIFICANT. REFERENCE SPECIFICATIONS AND MEP DRAWINGS FOR OTHER
- ACCESS DOOR LOCATIONS. UNLESS PREFINISHED TO MATCH ADJACENT SURFACE, PAINT MECHANICAL GRILLS, DIFFUSERS, ACCESS PANELS, AND OTHER EQUIPMENT TO MATCH ADJACENT SURFACE.
- 10. EXIT SIGNS ARE SHOWN ON RCP'S ONLY WHERE LOCATIONS ARE ARCHITECTURALLY SIGNIFICANT. I. PROVIDE UL-CLASSIFIED LIGHT FIXTURES OR
- ENCLOSURES IN RATED FLOOR/CEILING ASSEMBLIES IN ACCORDANCE WITH IBC CHAPTER 7. 12. REFER TO LIGHTING PLANS FOR EXACT FIXTURE TYPES AND LOCATIONS. FIXTURES SHOWN HERE ARE
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ENLARGED RCP - LEGEND


<b>GWB (C1)</b> INTERIOR	$\rightarrow$	SLOPE CEILING AS NOTED
T&G CEILING (C2) INTERIOR	0	CEILING MOUNTED LIGHT FIXTURE
FIBER-CEMENT SOFFIT (C3) - EXTERIOR	+ + + + + + + + + + + + + + + + + + + +	VINYL SCRIM CLG - INTERIOR
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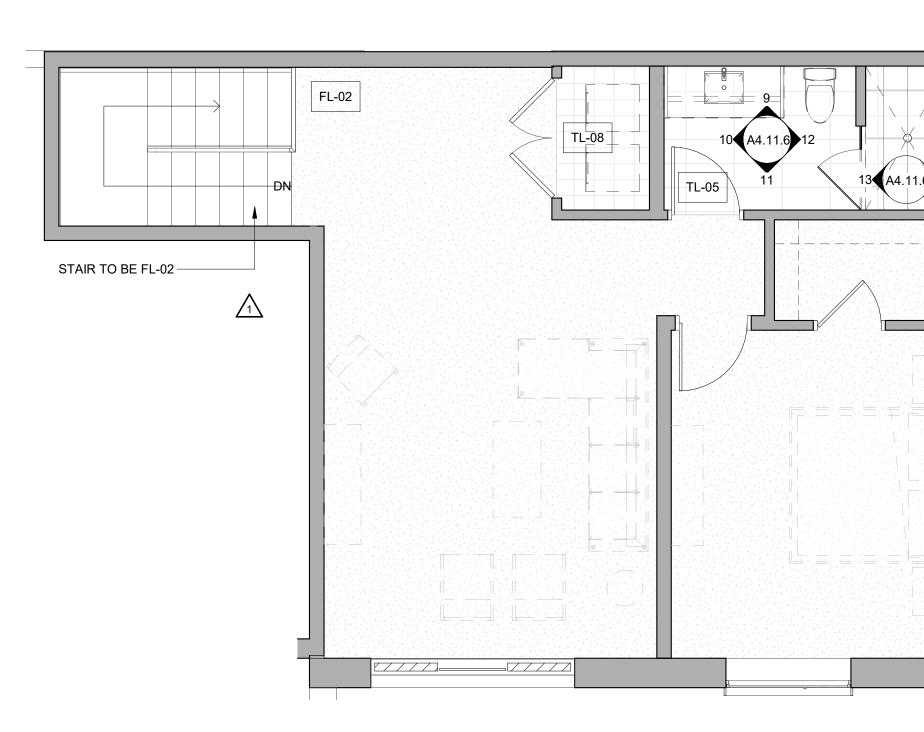
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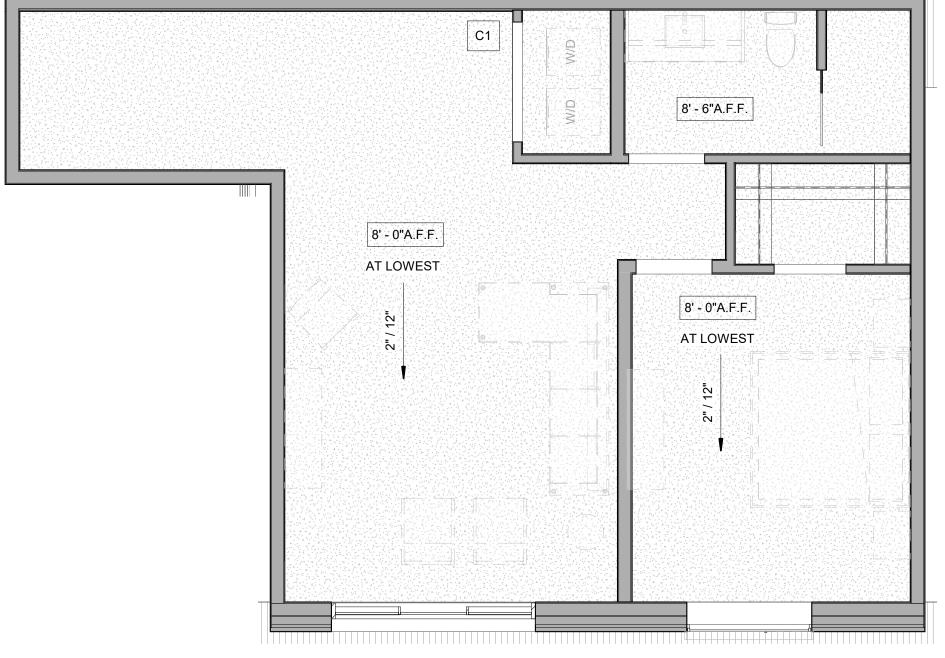
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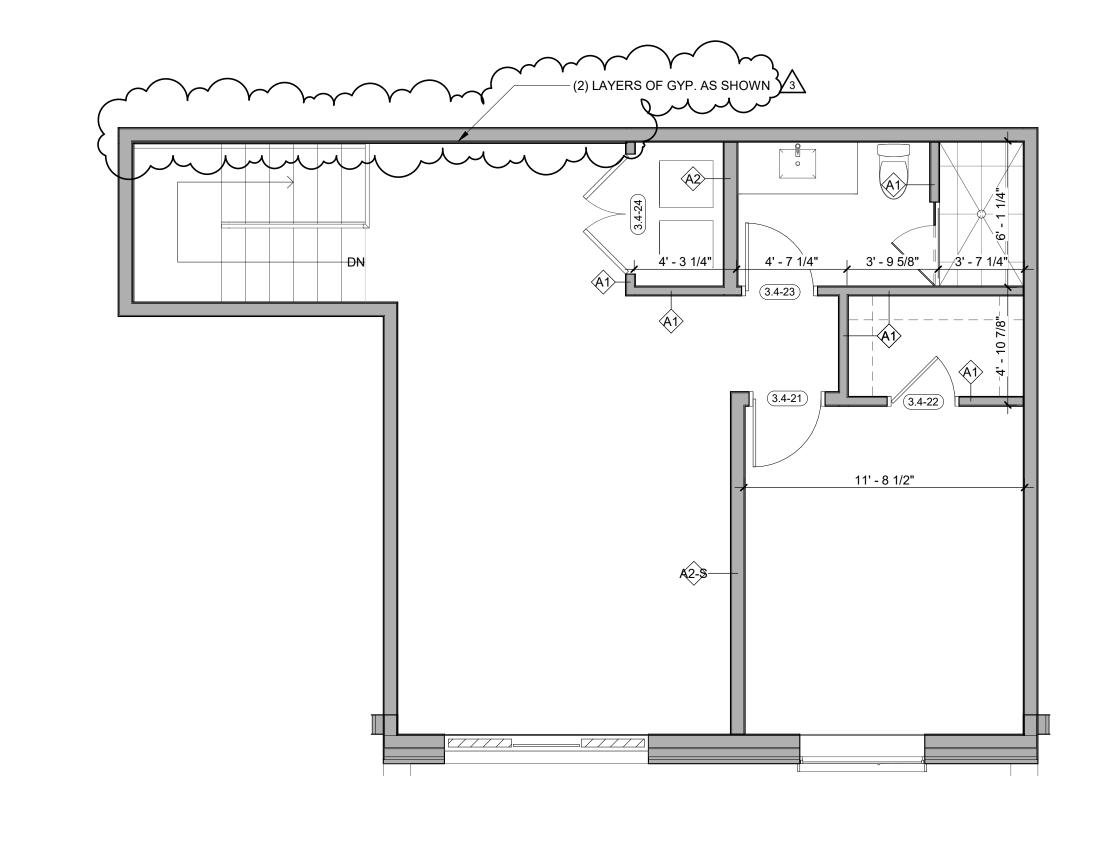








**3 DORMER LEVEL - 3 BED STANDARD LOFT RCP** 1/4" = 1'-0" UNIT 406 UNIT 406

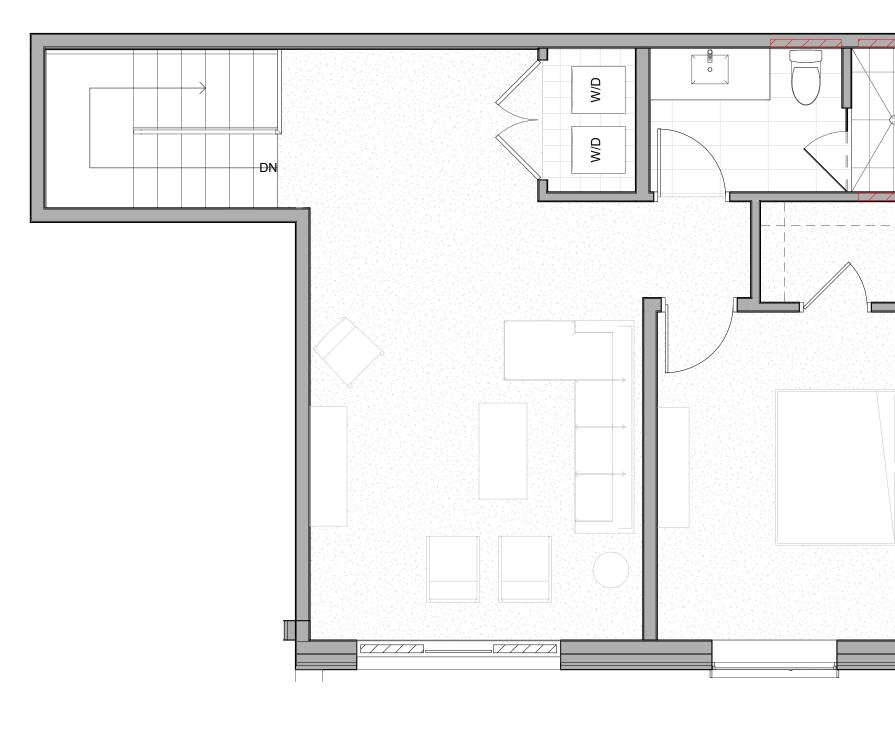



UNIT 406

### **ENLARGED FLOOR PLAN - GENERAL NOTES**

- REFER TO G0.2X SHEETS FOR EXTERIOR AND INTERIOR
- BUILDING ENCLOSURE ASSEMBLIES. REFER TO A1.0X SHEETS FOR EXTERIOR WALL, DEMISING
- WALL, AND CORRIDOR WALL TYPES AND LOCATIONS. REFER TO A1.1X SHEETS FOR INTERIOR AND EXTERIOR WINDOW/DOOR TAGS WITH UNIT BACKGROUNDS FOR
- REFERENCE. ALIGN WALLS WHERE THEY APPEAR TO ALIGN, U.N.O.
- THE INSIDE FACE OF DOOR JAMBS SHALL BE 4" FROM 5 ADJACENT WALL OR FINISHED COLUMN, U.N.O.
- PROVIDE BLOCKING FOR ALL WALL MOUNTED EQUIPMENT AND ACCESSORIES.

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3630 OSAGE STREET DENVER, CO 80211 720.512.3437

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RFI #232

- THE CENTERLINE OF ALL RESIDENTIAL TOILETS SHALL BE
- LOCATED 18" OFF OF FINISH FACE OF WALL, U.N.O. SWING CLEARANCE AT UNIT ENTRY SHALL BE 18" MIN.
- FROM FINISH FACE OF ADJACENT SURFACE. ALL DIMENSIONS ARE TO FACE OF STUD, GRID LINE, OR
- FACE OF CONCRETE, U.N.O. 10. WHERE "CLEAR" IS CALLED OUT ON A DIMENSION,
- PROVIDE DIMENSION FROM FACE OF FINISH TO FACE OF FINISH. 11. FURNITURE IS NOT IN CONTRACT, U.N.O., AND IS SHOWN
- FOR DIAGRAMATIC PURPOSES ONLY. 12. CONSULTANT MODELS SHOWN FOR REFERENCE ONLY.

### ENLARGED FLOOR PLAN - LEGEND


	CARPET RE: FINISH SCHED.		RUBBER (F7) RI Landscape
	<b>TILE</b> RE: FINISH SCHED.		CONCRETE (F8) RE: LANDSCAPE
	WOOD - UNIT RE: FINISH SCHED.		<b>PAVERS (F9)</b> RE: LANDSCAPE
	WOOD - PUBLIC RE: FINISH SCHED.		
	POLISHED CONC. (F5.1) INTERIOR		
	SEALED CONC. (F5.2) INTERIOR		
	HERRINGBONE TILE (F6) RE: FINISH SCHED.		
ENI	ARGED FLOOR PLAN - (	CLEARA	NCE NOTES
	FLOOR CLEARANCE		

A DOOR CLEARANCE, 54" X 60" B APPLIANCE CLEARANCE, 30" X 48" C CLEAR FLOOR CLEARANCE, 30" X 48" D VANITY CLEARANCE, 30" X 48" E TOILET CLEARANCE, 48" X 56" OR ADA 60" X 56"  $\bigtriangleup$ F SHOWER/TUB CLEARANCE, 30" X 48" (B) G TURN AROUND CLEARANCE GRAB BAR BLOCKING REQ. AT TOILET WALL WHERE APPLICABLE

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- ALL UNIT CEILINGS SHALL BE 9' 0" A.F.F. U.N.O. REFER TO ENLARGED RCP'S FOR COMMON AREA CEILING HEIGHTS.
- IN THE CASE OF MINOR DISCREPANCIES BETWEEN MEP AND ARCHITECTURAL DOCUMENTS ON THE LOCATION OF CEILING MOUNTED COMPONENTS, THE ARCHITECTURAL RCP'S GOVERN. IN THE CASE OF MAJOR DISCREPANCIES, THE ARCHITECT SHALL BE NOTIFIED AS SOON AS THE DISCREPANCY IS DISCOVERED PRIOR TO PROCEEDING WITH THE WORK.
- REFERENCE MECHANICAL AND ELECTRICAL DRAWINGS FOR MOUNTING LOCATIONS OF ITEMS WHERE NO CEILING IS REQUIRED OR INDICATED.
- COORDINATE ALL TRADES INVOLVED IN THE CEILING WORK TO ENSURE CLEARANCE FOR FIXTURES, DUCTS, PIPING, CEILING SUSPENSION SYSTEMS, ETC. NECESSARY TO MAINTAIN CEILING HEIGHTS NOTED.
- LIGHTS, DIFFUSERS, EXIT SIGNS, SMOKE DETECTORS, SPEAKERS, STROBES, AND MISC. DEVICES SHALL BE CENTERED IN THE CEILING WHERE THEY OCCUR, U.N.O. FIRE PROTECTION SCOPE SHALL BE DESIGN-BUILD. ALL
- CORRIDOR SPRINKLER HEADS SHALL BE ALIGNED IN THE SAME LOCATION PARALLEL TO THE WALL WITHIN EACH SPECIFIC CEILING CONSTRUCTION. SMOKE ALARMS SHALL BE PROVIDED IN ALL BEDROOMS,
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- ACCESS DOOR LOCATIONS IN GYPSUM BOARD CEILINGS ARE INDICATED ON RCP'S ONLY WHERE ARCHITECTURALLY SIGNIFICANT. REFERENCE SPECIFICATIONS AND MEP DRAWINGS FOR OTHER ACCESS DOOR LOCATIONS.
- UNLESS PREFINISHED TO MATCH ADJACENT SURFACE, PAINT MECHANICAL GRILLS, DIFFUSERS, ACCESS PANELS, AND OTHER EQUIPMENT TO MATCH ADJACENT SURFACE.
- 10. EXIT SIGNS ARE SHOWN ON RCP'S ONLY WHERE LOCATIONS ARE ARCHITECTURALLY SIGNIFICANT. 11. PROVIDE UL-CLASSIFIED LIGHT FIXTURES OR
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- REFERENCED /

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SLOPE CEILING AS NOTED	SHEET TITLE
CEILING MOUNTED LIGHT FIXTURE	UNIT PLAN - 3 BEDROOM STANDARD -
VINYL SCRIM CLG - INTERIOR	LEVEL 05
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	NERAL ALIGNMENT.         EGEND         →       SLOPE CEILING AS NOTED         →       CEILING MOUNTED LIGHT FIXTURE         →       VINYL SCRIM CLG -

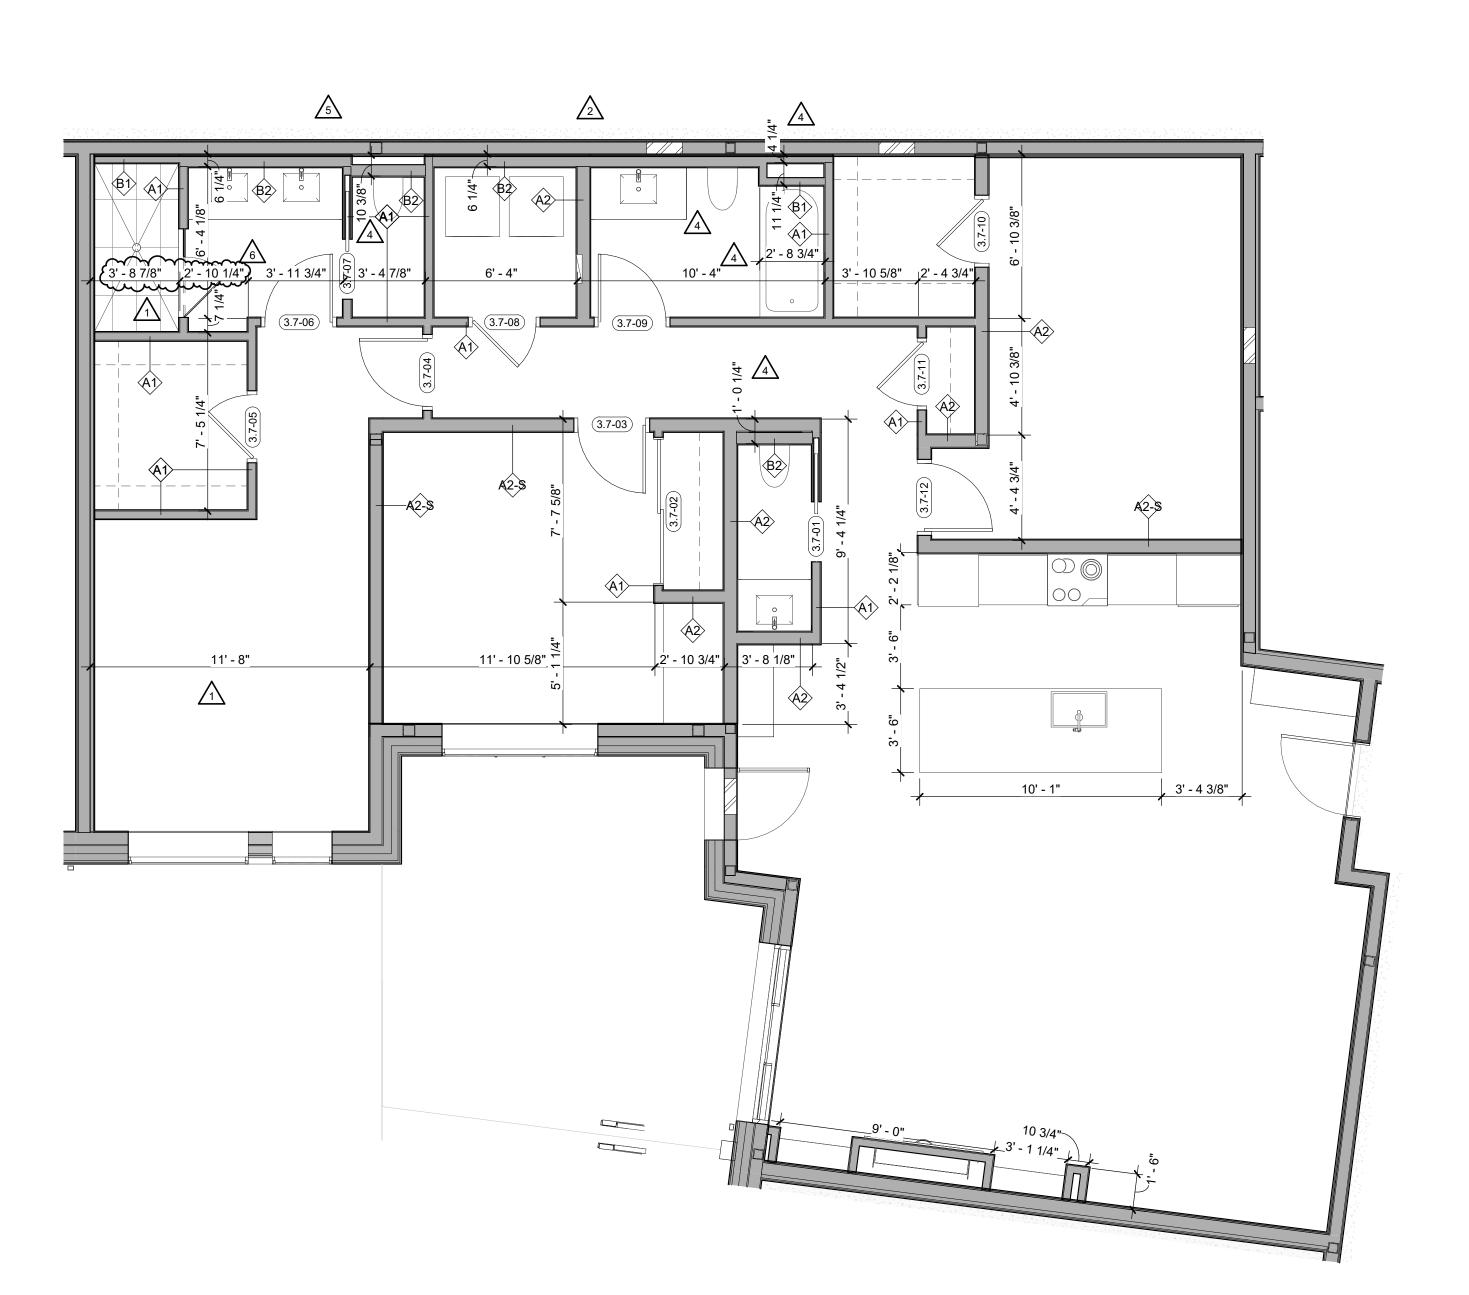


# Level 01 - 3 BED KNUCKLE DIMENSION 1/4" = 1'-0" UNIT 105

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### ENLARGED FLOOR PLAN - GENERAL NOTES

- . REFER TO G0.2X SHEETS FOR EXTERIOR AND INTERIOR
- BUILDING ENCLOSURE ASSEMBLIES. 2. REFER TO A1.0X SHEETS FOR EXTERIOR WALL, DEMISING
- WALL, AND CORRIDOR WALL TYPES AND LOCATIONS.3. REFER TO A1.1X SHEETS FOR INTERIOR AND EXTERIOR WINDOW/DOOR TAGS WITH UNIT BACKGROUNDS FOR
- REFERENCE. 4. ALIGN WALLS WHERE THEY APPEAR TO ALIGN, U.N.O.
- 5. THE INSIDE FACE OF DOOR JAMBS SHALL BE 4" FROM ADJACENT WALL OR FINISHED COLUMN, U.N.O.
- 6. PROVIDE BLOCKING FOR ALL WALL MOUNTED EQUIPMENT AND ACCESSORIES.
- 7. THE CENTERLINE OF ALL RESIDENTIAL TOILETS SHALL BE
- LOCATED 18" OFF OF FINISH FACE OF WALL, U.N.O. 8. SWING CLEARANCE AT UNIT ENTRY SHALL BE 18" MIN.
- FROM FINISH FACE OF ADJACENT SURFACE. 9. ALL DIMENSIONS ARE TO FACE OF STUD, GRID LINE, OR
- FACE OF CONCRETE, U.N.O. 10. WHERE "CLEAR" IS CALLED OUT ON A DIMENSION, PROVIDE DIMENSION FROM FACE OF FINISH TO FACE OF
- FINISH. 11. FURNITURE IS NOT IN CONTRACT, U.N.O., AND IS SHOWN
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### ENLARGED FLOOR PLAN - LEGEND



- A DOOR CLEARANCE, 54" X 60"
  B APPLIANCE CLEARANCE, 30" X 48"
  C CLEAR FLOOR CLEARANCE, 30" X 48"
  D VANITY CLEARANCE, 30" X 48"
  E TOILET CLEARANCE, 48" X 56" OR ADA 60" X 56"
  F SHOWER/TUB CLEARANCE, 30" X 48" (B)
  G TURN AROUND CLEARANCE
- GRAB BAR BLOCKING REQ. AT TOILET WALL WHERE APPLICABLE
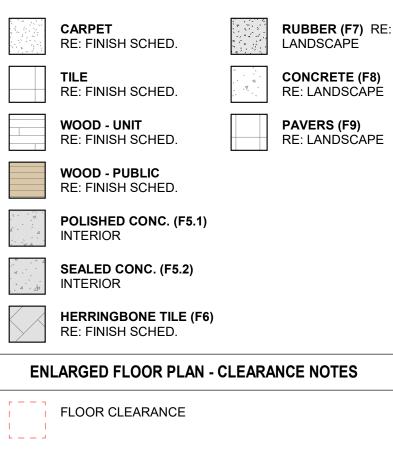
### ENLARGED RCP - GENERAL NOTES

- 1. ALL UNIT CEILINGS SHALL BE 9' 0" A.F.F. U.N.O. REFER TO ENLARGED RCP'S FOR COMMON AREA CEILING HEIGHTS.
- 2. IN THE CASE OF MINOR DISCREPANCIES BETWEEN MEP AND ARCHITECTURAL DOCUMENTS ON THE LOCATION OF CEILING MOUNTED COMPONENTS, THE ARCHITECTURAL RCP'S GOVERN. IN THE CASE OF MAJOR DISCREPANCIES, THE ARCHITECT SHALL BE NOTIFIED AS SOON AS THE DISCREPANCY IS DISCOVERED PRIOR TO PROCEEDING WITH THE WORK.
- 3. REFERENCE MECHANICAL AND ELECTRICAL DRAWINGS FOR MOUNTING LOCATIONS OF ITEMS WHERE NO CEILING IS REQUIRED OR INDICATED.
- 4. COORDINATE ALL TRADES INVOLVED IN THE CEILING WORK TO ENSURE CLEARANCE FOR FIXTURES, DUCTS, PIPING, CEILING SUSPENSION SYSTEMS, ETC. NECESSARY TO MAINTAIN CEILING HEIGHTS NOTED.
- LIGHTS, DIFFUSERS, EXIT SIGNS, SMOKE DETECTORS, SPEAKERS, STROBES, AND MISC. DEVICES SHALL BE CENTERED IN THE CEILING WHERE THEY OCCUR, U.N.O.
   FIRE PROTECTION SCOPE SHALL BE DESIGN-BUILD. ALL
- CORRIDOR SPRINKLER HEADS SHALL BE ALIGNED IN THE SAME LOCATION PARALLEL TO THE WALL WITHIN EACH SPECIFIC CEILING CONSTRUCTION.
  7. SMOKE ALARMS SHALL BE PROVIDED IN ALL BEDROOMS,
- OUTSIDE OF ALL BEDROOMS, AND ON EACH FLOOR AS REQUIRED. CARBON MONOXIDE DETECTORS SHALL BE INSTALLED OUTSIDE OF ALL BEDROOMS. SMOKE ALARMS AND CO DETECTORS SHALL BE HARDWIRED AND HAVE BATTERY BACKUP.
- 8. ACCESS DOOR LOCATIONS IN GYPSUM BOARD CEILINGS ARE INDICATED ON RCP'S ONLY WHERE ARCHITECTURALLY SIGNIFICANT. REFERENCE SPECIFICATIONS AND MEP DRAWINGS FOR OTHER ACCESS DOOR LOCATIONS.
- UNLESS PREFINISHED TO MATCH ADJACENT SURFACE, PAINT MECHANICAL GRILLS, DIFFUSERS, ACCESS PANELS, AND OTHER EQUIPMENT TO MATCH ADJACENT SURFACE.
   EXIT SIGNS ARE SHOWN ON RCP'S ONLY WHERE
- LOCATIONS ARE ARCHITECTURALLY SIGNIFICANT. 11. PROVIDE UL-CLASSIFIED LIGHT FIXTURES OR
- ENCLOSURES IN RATED FLOOR/CEILING ASSEMBLIES IN ACCORDANCE WITH IBC CHAPTER 7.12. REFER TO LIGHTING PLANS FOR EXACT FIXTURE TYPES AND LOCATIONS. FIXTURES SHOWN HERE ARE
- REFERENCED AND SHOWN FOR GENERAL ALIGNMENT.

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<b>No.</b>	Description	<b>Date</b> 03.15.24
2 3	RFI #125 ASI 004	06.24.24 08.07.24
5	RFI #183 RFI #214	08.02.24 08.21.24 09.17.24
6	RFI #232	09.17.24
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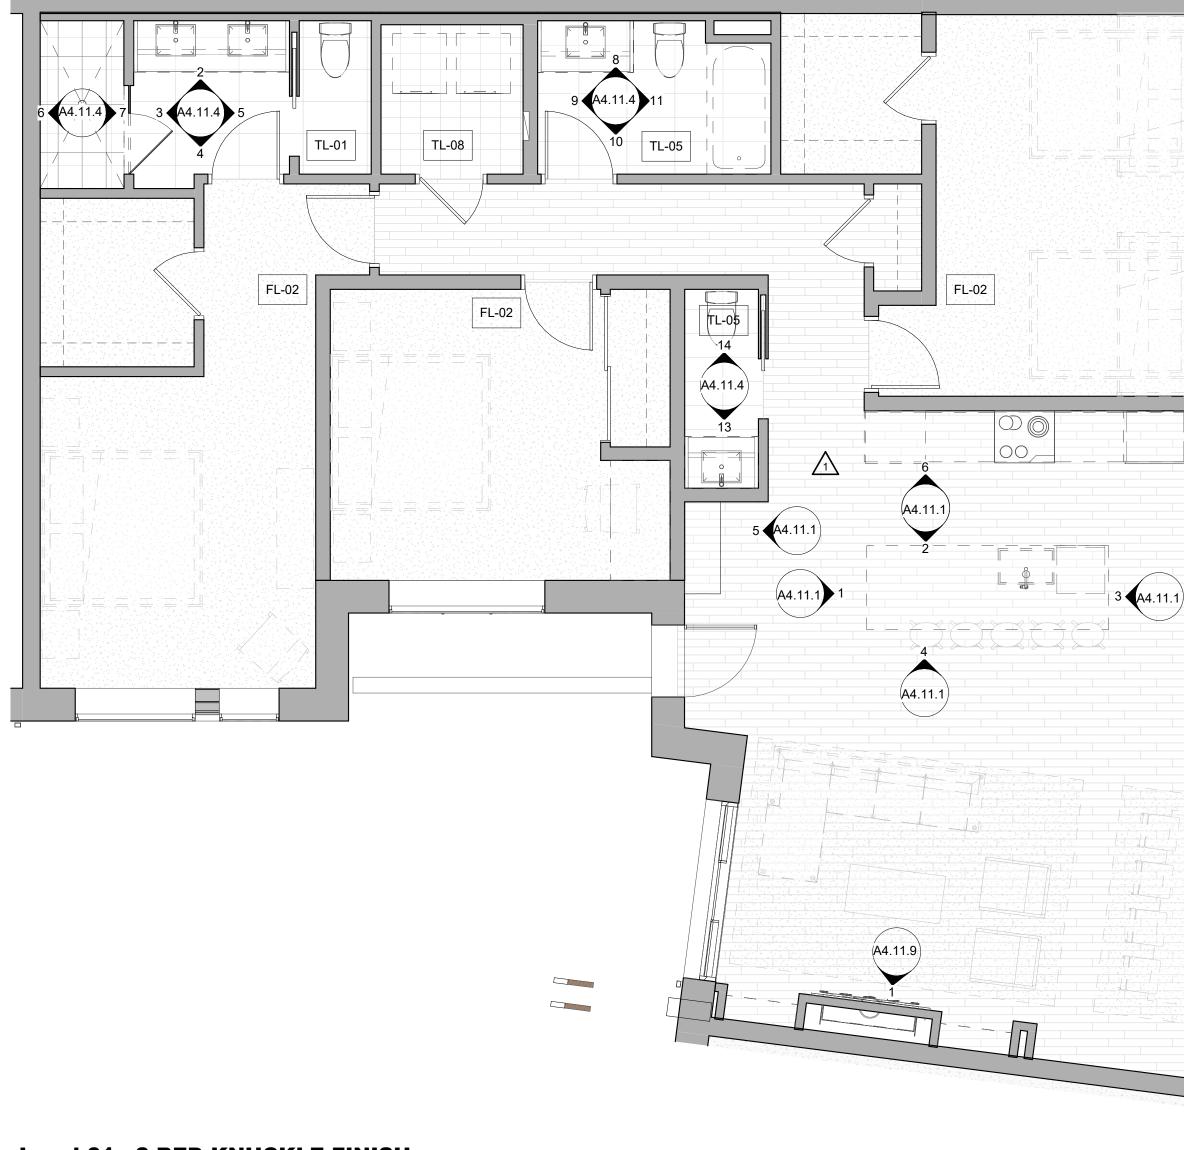
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**Level 01 - 3 BED KNUCKLE FINISH UNIT 105** 

### **ENLARGED FLOOR PLAN - GENERAL NOTES**

- REFER TO G0.2X SHEETS FOR EXTERIOR AND INTERIOR
- BUILDING ENCLOSURE ASSEMBLIES. REFER TO A1.0X SHEETS FOR EXTERIOR WALL, DEMISING
- WALL, AND CORRIDOR WALL TYPES AND LOCATIONS. REFER TO A1.1X SHEETS FOR INTERIOR AND EXTERIOR WINDOW/DOOR TAGS WITH UNIT BACKGROUNDS FOR REFERENCE.
- ALIGN WALLS WHERE THEY APPEAR TO ALIGN, U.N.O.
- 5. THE INSIDE FACE OF DOOR JAMBS SHALL BE 4" FROM ADJACENT WALL OR FINISHED COLUMN, U.N.O.
- PROVIDE BLOCKING FOR ALL WALL MOUNTED EQUIPMENT AND ACCESSORIES.
- THE CENTERLINE OF ALL RESIDENTIAL TOILETS SHALL BE LOCATED 18" OFF OF FINISH FACE OF WALL, U.N.O.
- SWING CLEARANCE AT UNIT ENTRY SHALL BE 18" MIN.
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- 10. WHERE "CLEAR" IS CALLED OUT ON A DIMENSION, PROVIDE DIMENSION FROM FACE OF FINISH TO FACE OF FINISH.
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- 12. CONSULTANT MODELS SHOWN FOR REFERENCE ONLY.

### ENLARGED FLOOR PLAN - LEGEND

$\begin{array}{cccccccccccccccccccccccccccccccccccc$	CARPET RE: FINISH SCHED.		RUBBER (F7) RE LANDSCAPE
	<b>TILE</b> RE: FINISH SCHED.		CONCRETE (F8) RE: LANDSCAPE
	<b>WOOD - UNIT</b> RE: FINISH SCHED.		<b>PAVERS (F9)</b> RE: LANDSCAPE
	WOOD - PUBLIC RE: FINISH SCHED.		
	POLISHED CONC. (F5.1) INTERIOR		
	SEALED CONC. (F5.2) INTERIOR		
	HERRINGBONE TILE (F6) RE: FINISH SCHED.		
ENI	LARGED FLOOR PLAN - (	CLEARA	NCE NOTES
	FLOOR CLEARANCE		

- A DOOR CLEARANCE, 54" X 60" B APPLIANCE CLEARANCE, 30" X 48" C CLEAR FLOOR CLEARANCE, 30" X 48" D VANITY CLEARANCE, 30" X 48" E TOILET CLEARANCE, 48" X 56" OR ADA 60" X 56" F SHOWER/TUB CLEARANCE, 30" X 48" (B) G TURN AROUND CLEARANCE
- GRAB BAR BLOCKING REQ. AT TOILET WALL WHERE APPLICABLE

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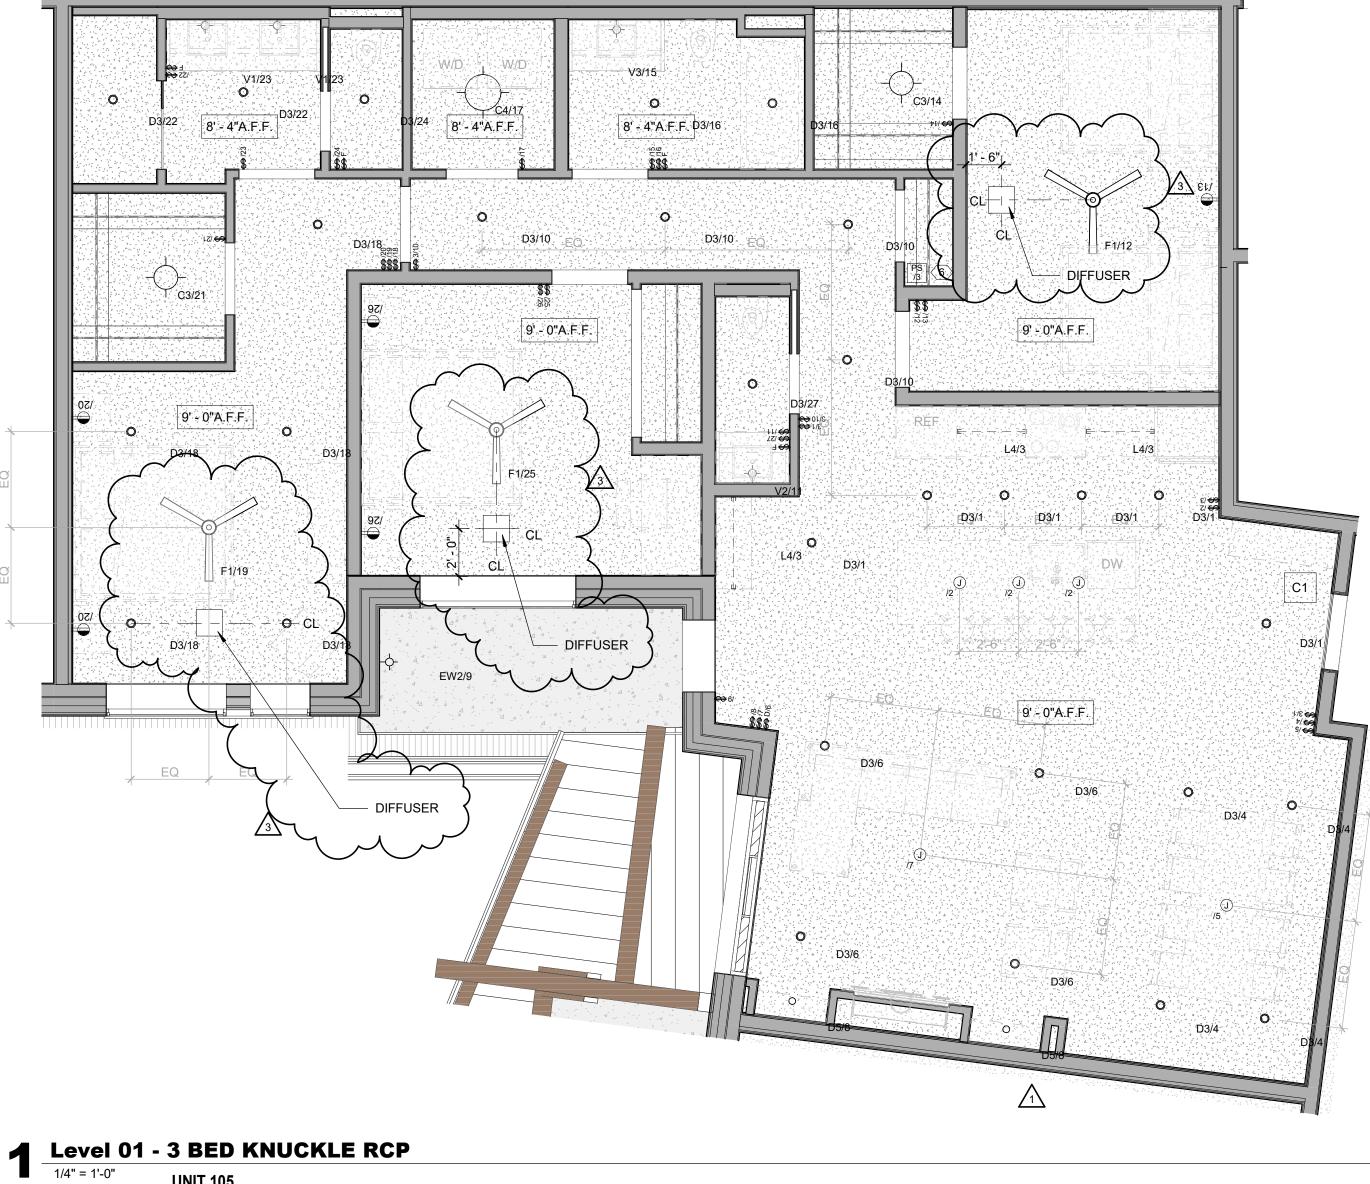
- OUTSIDE OF ALL BEDROOMS, AND ON EACH FLOOR AS REQUIRED. CARBON MONOXIDE DETECTORS SHALL BE INSTALLED OUTSIDE OF ALL BEDROOMS. SMOKE ALARMS AND CO DETECTORS SHALL BE HARDWIRED AND HAVE BATTERY BACKUP.
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### ENLARGED RCP - LEGEND

<b>GWB (C1)</b> INTERIOR	$\rightarrow$	SLOPE CEILING AS NOTED
T&G CEILING (C2) INTERIOR	0	CEILING MOUNTED LIGHT FIXTURE
FIBER-CEMENT SOFFIT (C3) - EXTERIOR	+ + + + + +	VINYL SCRIM CLG - INTERIOR

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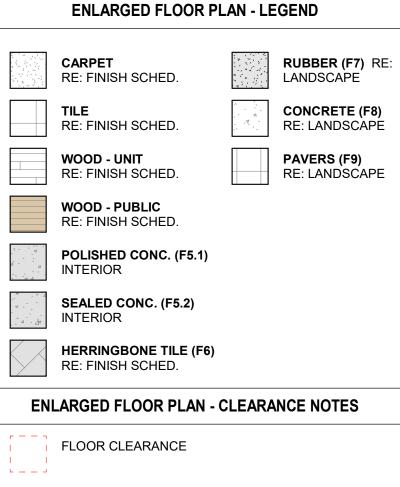
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# UNIT 105

### ENLARGED FLOOR PLAN - GENERAL NOTES

- 1. REFER TO G0.2X SHEETS FOR EXTERIOR AND INTERIOR
- BUILDING ENCLOSURE ASSEMBLIES.2. REFER TO A1.0X SHEETS FOR EXTERIOR WALL, DEMISING
- WALL, AND CORRIDOR WALL TYPES AND LOCATIONS.
  REFER TO A1.1X SHEETS FOR INTERIOR AND EXTERIOR WINDOW/DOOR TAGS WITH UNIT BACKGROUNDS FOR REFERENCE.
- 4. ALIGN WALLS WHERE THEY APPEAR TO ALIGN, U.N.O.
- 5. THE INSIDE FACE OF DOOR JAMBS SHALL BE 4" FROM ADJACENT WALL OR FINISHED COLUMN, U.N.O.
- 6. PROVIDE BLOCKING FOR ALL WALL MOUNTED EQUIPMENT AND ACCESSORIES.
- 7. THE CENTERLINE OF ALL RESIDENTIAL TOILETS SHALL BE LOCATED 18" OFF OF FINISH FACE OF WALL, U.N.O.
- B. SWING CLEARANCE AT UNIT ENTRY SHALL BE 18" MIN.
- FROM FINISH FACE OF ADJACENT SURFACE. 9. ALL DIMENSIONS ARE TO FACE OF STUD, GRID LINE, OR FACE OF CONCRETE, U.N.O.
- 10. WHERE "CLEAR" IS CALLED OUT ON A DIMENSION, PROVIDE DIMENSION FROM FACE OF FINISH TO FACE OF FINISH.
- FURNITURE IS NOT IN CONTRACT, U.N.O., AND IS SHOWN FOR DIAGRAMATIC PURPOSES ONLY.
   CONSULTANT MODELS SHOWN FOR REFERENCE ONLY.



- A DOOR CLEARANCE, 54" X 60"
  B APPLIANCE CLEARANCE, 30" X 48"
  C CLEAR FLOOR CLEARANCE, 30" X 48"
  D VANITY CLEARANCE, 30" X 48"
  E TOILET CLEARANCE, 48" X 56" OR ADA 60" X 56"
  F SHOWER/TUB CLEARANCE, 30" X 48" (B)
  G TURN AROUND CLEARANCE
- GRAB BAR BLOCKING REQ. AT TOILET WALL WHERE APPLICABLE

### ENLARGED RCP - GENERAL NOTES

- 1. ALL UNIT CEILINGS SHALL BE 9' 0" A.F.F. U.N.O. REFER TO ENLARGED RCP'S FOR COMMON AREA CEILING HEIGHTS.
- 2. IN THE CASE OF MINOR DISCREPANCIES BETWEEN MEP AND ARCHITECTURAL DOCUMENTS ON THE LOCATION OF CEILING MOUNTED COMPONENTS, THE ARCHITECTURAL RCP'S GOVERN. IN THE CASE OF MAJOR DISCREPANCIES, THE ARCHITECT SHALL BE NOTIFIED AS SOON AS THE DISCREPANCY IS DISCOVERED PRIOR TO PROCEEDING WITH THE WORK.
- 3. REFERENCE MECHANICAL AND ELECTRICAL DRAWINGS FOR MOUNTING LOCATIONS OF ITEMS WHERE NO CEILING IS REQUIRED OR INDICATED.
- 4. COORDINATE ALL TRADES INVOLVED IN THE CEILING WORK TO ENSURE CLEARANCE FOR FIXTURES, DUCTS, PIPING, CEILING SUSPENSION SYSTEMS, ETC. NECESSARY TO MAINTAIN CEILING HEIGHTS NOTED.
- LIGHTS, DIFFUSERS, EXIT SIGNS, SMOKE DETECTORS, SPEAKERS, STROBES, AND MISC. DEVICES SHALL BE CENTERED IN THE CEILING WHERE THEY OCCUR, U.N.O.
   FIRE PROTECTION SCOPE SHALL BE DESIGN-BUILD. ALL
- CORRIDOR SPRINKLER HEADS SHALL BE ALIGNED IN THE SAME LOCATION PARALLEL TO THE WALL WITHIN EACH SPECIFIC CEILING CONSTRUCTION.
  7. SMOKE ALARMS SHALL BE PROVIDED IN ALL BEDROOMS,
- OUTSIDE OF ALL BEDROOMS, AND ON EACH FLOOR AS REQUIRED. CARBON MONOXIDE DETECTORS SHALL BE INSTALLED OUTSIDE OF ALL BEDROOMS. SMOKE ALARMS AND CO DETECTORS SHALL BE HARDWIRED AND HAVE BATTERY BACKUP.
- 8. ACCESS DOOR LOCATIONS IN GYPSUM BOARD CEILINGS ARE INDICATED ON RCP'S ONLY WHERE ARCHITECTURALLY SIGNIFICANT. REFERENCE SPECIFICATIONS AND MEP DRAWINGS FOR OTHER ACCESS DOOR LOCATIONS.
- UNLESS PREFINISHED TO MATCH ADJACENT SURFACE, PAINT MECHANICAL GRILLS, DIFFUSERS, ACCESS PANELS, AND OTHER EQUIPMENT TO MATCH ADJACENT SURFACE.
   EXIT SIGNS ARE SHOWN ON RCP'S ONLY WHERE
- LOCATIONS ARE ARCHITECTURALLY SIGNIFICANT. 11. PROVIDE UL-CLASSIFIED LIGHT FIXTURES OR
- ENCLOSURES IN RATED FLOOR/CEILING ASSEMBLIES IN ACCORDANCE WITH IBC CHAPTER 7.12. REFER TO LIGHTING PLANS FOR EXACT FIXTURE TYPES AND LOCATIONS. FIXTURES SHOWN HERE ARE
- REFERENCED AND SHOWN FOR GENERAL ALIGNMENT.

 <b>GWB (C1)</b> INTERIOR	$\rightarrow$	SLOPE CEILING AS NOTED
T&G CEILING (C2) INTERIOR	0	CEILING MOUNTED LIGHT FIXTURE
FIBER-CEMENT SOFFIT (C3) - EXTERIOR	+ + + + + + + + + + + + + + + + + + + +	VINYL SCRIM CLG - INTERIOR
ACCESS PANEL		ACCOUSTIC VINYL TILE CLG - INTERIOF

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# **1** Level 01 - 3 BED KNUCKLE FURNITURE

### **ENLARGED FLOOR PLAN - GENERAL NOTES**

- REFER TO G0.2X SHEETS FOR EXTERIOR AND INTERIOR
- BUILDING ENCLOSURE ASSEMBLIES. REFER TO A1.0X SHEETS FOR EXTERIOR WALL, DEMISING
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- ALIGN WALLS WHERE THEY APPEAR TO ALIGN, U.N.O. 5. THE INSIDE FACE OF DOOR JAMBS SHALL BE 4" FROM
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- PROVIDE BLOCKING FOR ALL WALL MOUNTED EQUIPMENT AND ACCESSORIES.
- THE CENTERLINE OF ALL RESIDENTIAL TOILETS SHALL BE
- LOCATED 18" OFF OF FINISH FACE OF WALL, U.N.O. SWING CLEARANCE AT UNIT ENTRY SHALL BE 18" MIN.
- FROM FINISH FACE OF ADJACENT SURFACE. ALL DIMENSIONS ARE TO FACE OF STUD, GRID LINE, OR
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- PROVIDE DIMENSION FROM FACE OF FINISH TO FACE OF FINISH. 11. FURNITURE IS NOT IN CONTRACT, U.N.O., AND IS SHOWN
- FOR DIAGRAMATIC PURPOSES ONLY. 12. CONSULTANT MODELS SHOWN FOR REFERENCE ONLY.

### ENLARGED FLOOR PLAN - LEGEND

	CARPET RE: FINISH SCHED.		RUBBER (F7) RE LANDSCAPE
	<b>TILE</b> RE: FINISH SCHED.	· · · · · · · · · · · · · · · · · · ·	CONCRETE (F8) RE: LANDSCAPE
	<b>WOOD - UNIT</b> RE: FINISH SCHED.		<b>PAVERS (F9)</b> RE: LANDSCAPE
	WOOD - PUBLIC RE: FINISH SCHED.		
	POLISHED CONC. (F5.1) INTERIOR		
	SEALED CONC. (F5.2) INTERIOR		
	HERRINGBONE TILE (F6) RE: FINISH SCHED.		
ENI	LARGED FLOOR PLAN - (	CLEARA	NCE NOTES
	FLOOR CLEARANCE		


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- GRAB BAR BLOCKING REQ. AT TOILET WALL WHERE APPLICABLE


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$\begin{array}{cccccccccccccccccccccccccccccccccccc$	<b>GWB (C1)</b> INTERIOR	$\rightarrow$	SLOPE CEILING AS NOTED
	T&G CEILING (C2) INTERIOR	0	CEILING MOUNTED LIGHT FIXTURE
	FIBER-CEMENT SOFFIT (C3) - EXTERIOR	+ + + + + + + + + + + + + + + + + + + +	VINYL SCRIM CLG - INTERIOR

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1/4" = 1'-0" UNIT 104

UNIT 104

Level 01 - 3 BED CORNER DIMENSION
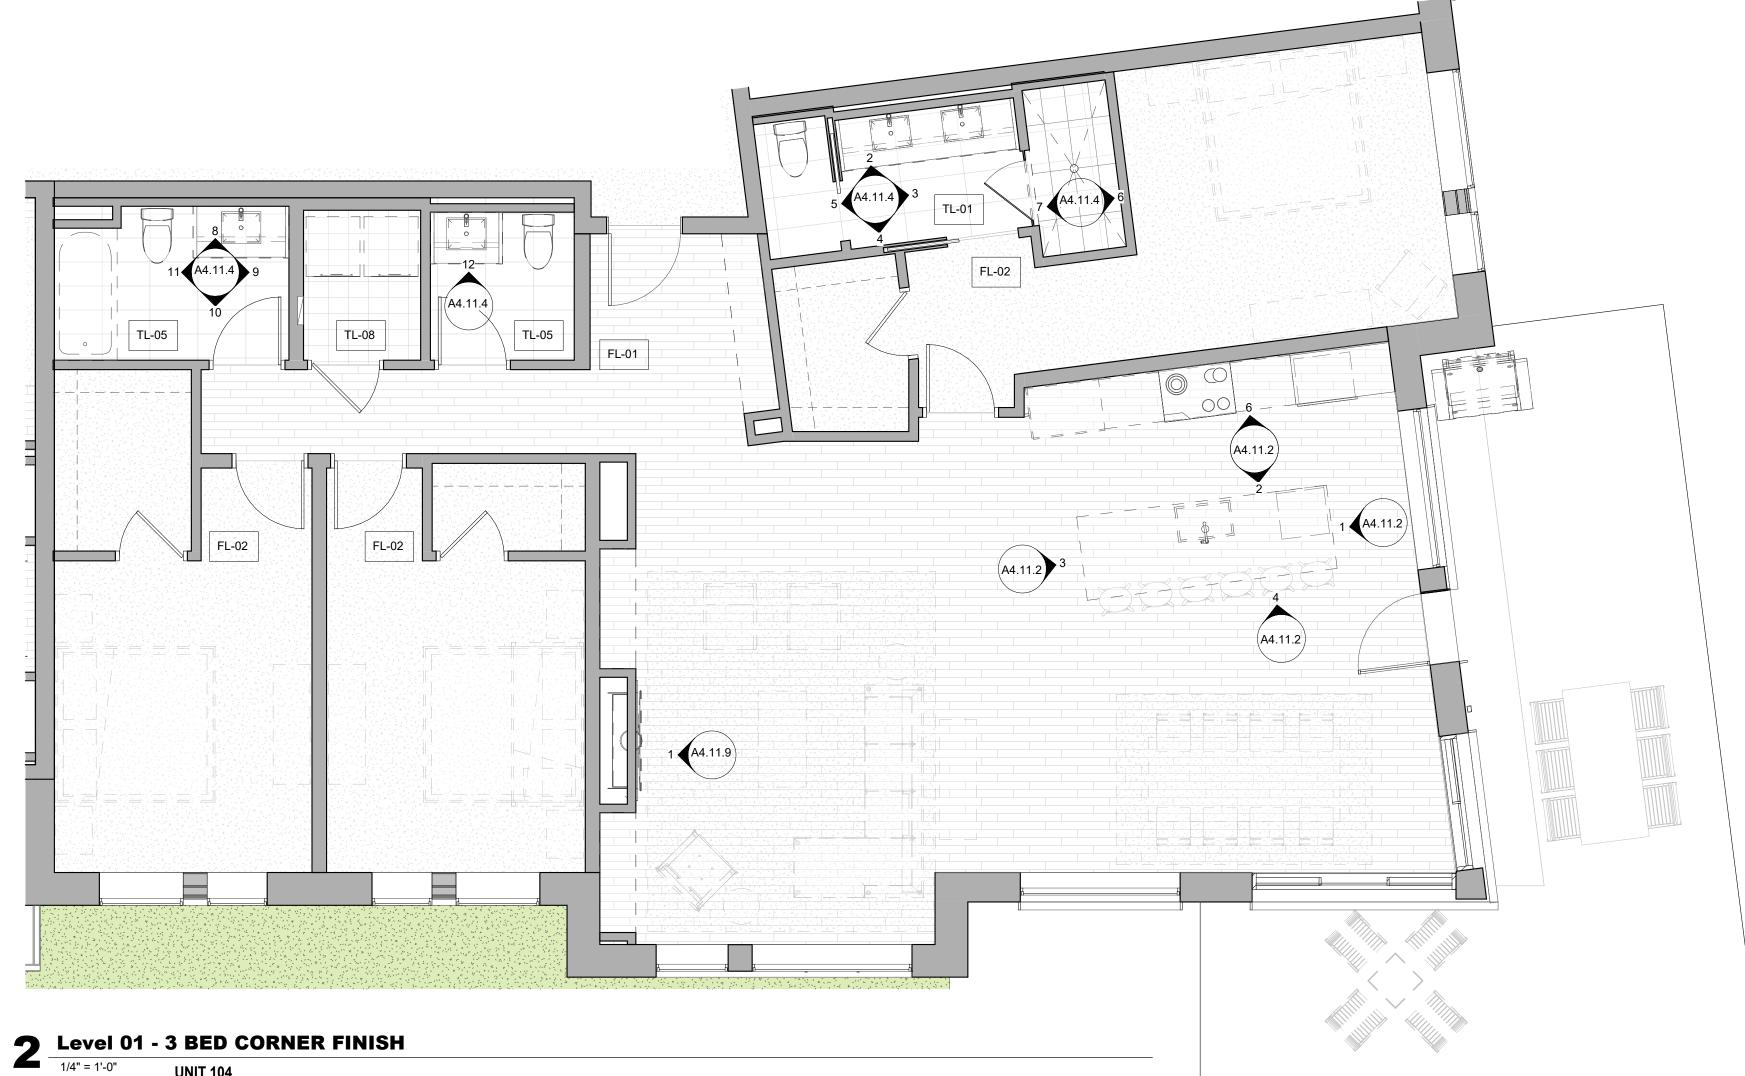
### ENLARGED FLOOR PLAN - GENERAL NOTES

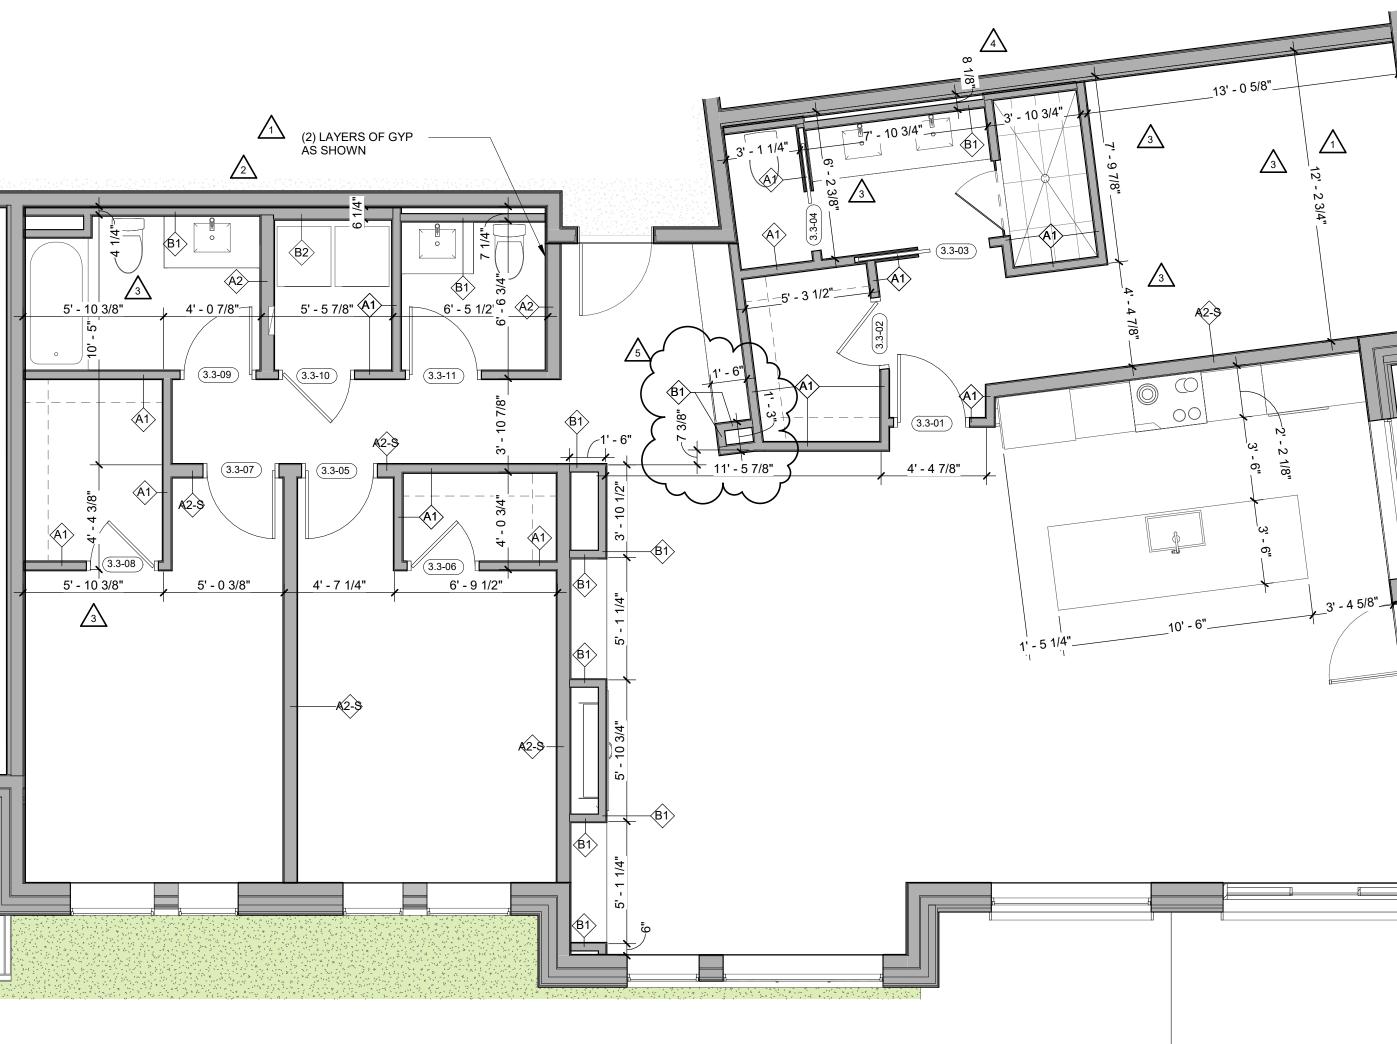- REFER TO G0.2X SHEETS FOR EXTERIOR AND INTERIOR BUILDING ENCLOSURE ASSEMBLIES. REFER TO A1.0X SHEETS FOR EXTERIOR WALL, DEMISING
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### ENLARGED FLOOR PLAN - LEGEND

	<b>CARPET</b> RE: FINISH SCHED.		RUBBER (F7) RE: LANDSCAPE
	<b>TILE</b> RE: FINISH SCHED.		CONCRETE (F8) RE: LANDSCAPE
	WOOD - UNIT RE: FINISH SCHED.		<b>Pavers (F9)</b> Re: Landscape
	WOOD - PUBLIC RE: FINISH SCHED.		
1 - 4 - 4	POLISHED CONC. (F5.1) INTERIOR		
	SEALED CONC. (F5.2) INTERIOR		
$\searrow$	HERRINGBONE TILE (F6) RE: FINISH SCHED.		
ENL	ARGED FLOOR PLAN - CL	EARANC	E NOTES
·	FLOOR CLEARANCE		

- A DOOR CLEARANCE, 54" X 60"
- B APPLIANCE CLEARANCE, 30" X 48"
- C CLEAR FLOOR CLEARANCE, 30" X 48"
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- 10. EXIT SIGNS ARE SH LOCATIONS ARE AF
- 11. PROVIDE UL-CLASS ENCLOSURES IN RA
- ACCORDANCE WIT 12. REFER TO LIGHTIN AND LOCATIONS. F REFERENCED AND

MECHANICAL GRILLS, DIFF THER EQUIPMENT TO MAT IGNS ARE SHOWN ON RCP TONS ARE ARCHITECTURA DE UL-CLASSIFIED LIGHT F OSURES IN RATED FLOOR/( RDANCE WITH IBC CHAPTE TO LIGHTING PLANS FOR OCATIONS. FIXTURES SHO ENCED AND SHOWN FOR	CH ADJAC "S ONLY V LLY SIGNI IXTURES CEILING A R 7. EXACT FI, WN HERE	CENT SURFACE. VHERE FICANT. OR SSEMBLIES IN XTURE TYPES ARE	PROJECT	
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ENLARGED RCP	- LEGEN	D		IFC SET
<b>GWB (C1)</b> INTERIOR	$\rightarrow$	SLOPE CEILING AS NOTED		
<b>T&amp;G CEILING (C2)</b> INTERIOR	0	CEILING MOUNTED LIGHT FIXTURE		UNIT PLAN - 3 DROOM CORNER -
FIBER-CEMENT SOFFIT (C3) - EXTERIOR	+ + + + + + + + + + + + + + + + + + +	VINYL SCRIM CLG - Interior		LEVEL 01
ACCESS PANEL		ACOUSTIC VINYL TILE CLG - INTERIOR		4.08.1

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TOWN STAMP

**359** Design

3630 OSAGE STREET DENVER, CO 80211 720.512.3437

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	IFC SET	03.15.24
	RFI #125	06.24.24
	ASI 004	08.07.24
	RFI #214	08.21.24
	RFI #388	01.06.25
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### **ENLARGED FLOOR PLAN - GENERAL NOTES**

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	<b>TILE</b> RE: FINISH SCHED.	· · · · · · · · · · · · · · · · · · ·	CONCRETE (F8) Re: Landscape
	WOOD - UNIT RE: FINISH SCHED.		<b>Pavers (F9)</b> Re: Landscape
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á - a	POLISHED CONC. (F5.1) INTERIOR		
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ENI	ARGED FLOOR PLAN - (	CLEARA	NCE NOTES
	FLOOR CLEARANCE		
А	DOOR CLEARANCE, 54" X	60"	
<b>D</b>			

- B APPLIANCE CLEARANCE, 30" X 48"
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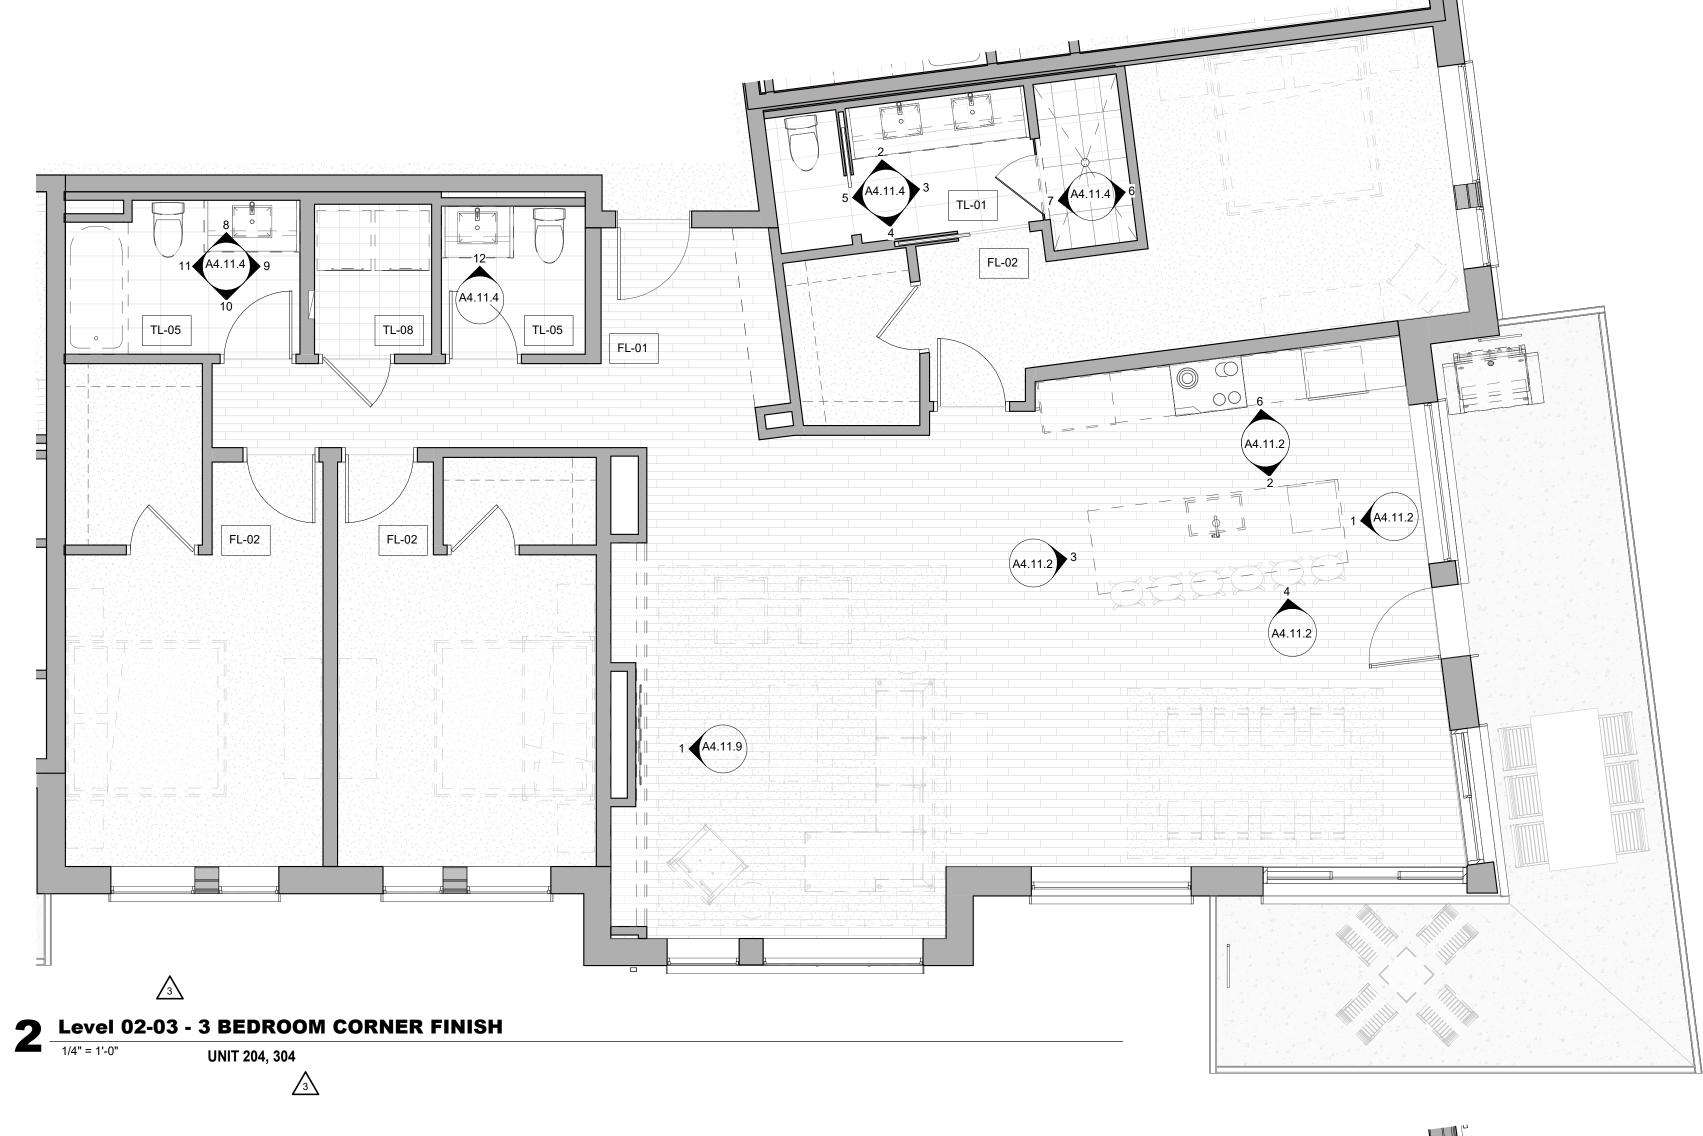
ENLARGED RCP - LEGEND


- 1 - 1 - 1 - 1 - 1 - 1 - 1 - 1 - 1 - 1	<b>GWB (C1)</b> INTERIOR	$\rightarrow$	SLOPE CEILING AS NOTED
	<b>T&amp;G CEILING (C2)</b> INTERIOR	0	CEILING MOUNTED
	FIBER-CEMENT SOFFIT (C3) - EXTERIOR	+ + + + + + + + + + + + + + + + + + + +	VINYL SCRIM CLG INTERIOR
$\square$	ACCESS PANEL		ACCOUSTIC VINYL Tile Clg - Interio

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The Amble	Steamboat Springs, CO
No.         Descr           1         RFI #110           2         RFI #132           3         ASI 004           4         RFI #223.1           -         -           -         -           -         -           -         -           -         -           -         -           -         -           -         -           -         -	iption         Date           06:14:24         07:31:24           08:07:24         10:16:24           10         10
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- FROM FINISH FACE OF ADJACENT SURFACE. ALL DIMENSIONS ARE TO FACE OF STUD, GRID LINE, OR
- FACE OF CONCRETE, U.N.O. 10. WHERE "CLEAR" IS CALLED OUT ON A DIMENSION,
- PROVIDE DIMENSION FROM FACE OF FINISH TO FACE OF FINISH.
- 11. FURNITURE IS NOT IN CONTRACT, U.N.O., AND IS SHOWN FOR DIAGRAMATIC PURPOSES ONLY.
- 12. CONSULTANT MODELS SHOWN FOR REFERENCE ONLY.

### ENLARGED FLOOR PLAN - LEGEND

	CARPET RE: FINISH SCHED.		RUBBER (F7) RE: LANDSCAPE
	<b>TILE</b> RE: FINISH SCHED.		CONCRETE (F8) RE: LANDSCAPE
	WOOD - UNIT RE: FINISH SCHED.		<b>Pavers (F9)</b> Re: Landscape
	WOOD - PUBLIC RE: FINISH SCHED.		
4 - 4 4 - 4	POLISHED CONC. (F5.1) INTERIOR		
	SEALED CONC. (F5.2) INTERIOR		
	HERRINGBONE TILE (F6) RE: FINISH SCHED.		
ENL	ARGED FLOOR PLAN - CLI	EARANC	E NOTES
	FLOOR CLEARANCE		
Α	DOOR CLEARANCE, 54" X 60	n	
В	APPLIANCE CLEARANCE, 30	" X 48"	

- C CLEAR FLOOR CLEARANCE, 30" X 48"
- D VANITY CLEARANCE, 30" X 48"
- E TOILET CLEARANCE, 48" X 56" OR ADA 60" X 56"  $\triangle$
- F SHOWER/TUB CLEARANCE, 30" X 48" (B) G TURN AROUND CLEARANCE
- GRAB BAR BLOCKING REQ. AT TOILET
- WALL WHERE APPLICABLE
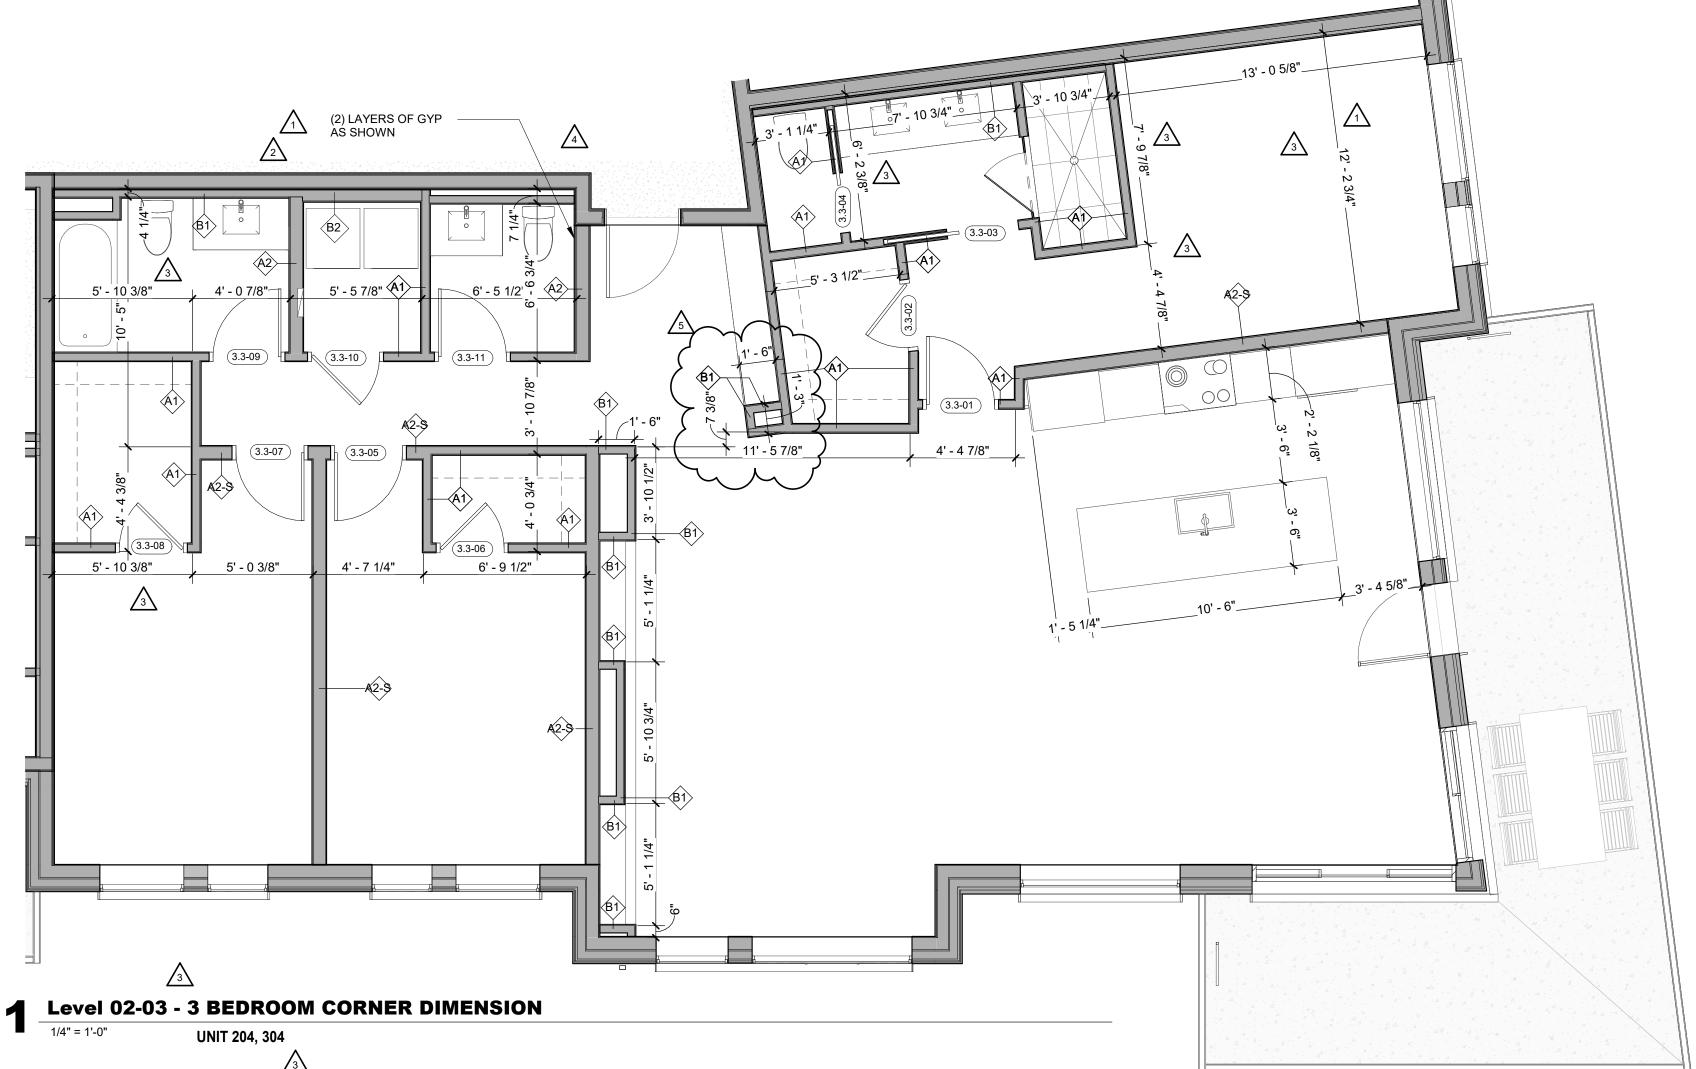
### ENLARGED RCP - GENERAL NOTES

- ALL UNIT CEILINGS SHALL BE 9' 0" A.F.F. U.N.O. REFER TO ENLARGED RCP'S FOR COMMON AREA CEILING HEIGHTS.
- IN THE CASE OF MINOR DISCREPANCIES BETWEEN MEP AND ARCHITECTURAL DOCUMENTS ON THE LOCATION OF CEILING MOUNTED COMPONENTS, THE ARCHITECTURAL RCP'S GOVERN. IN THE CASE OF MAJOR DISCREPANCIES, THE ARCHITECT SHALL BE NOTIFIED AS SOON AS THE DISCREPANCY IS DISCOVERED PRIOR TO PROCEEDING
- WITH THE WORK. REFERENCE MECHANICAL AND ELECTRICAL DRAWINGS FOR MOUNTING LOCATIONS OF ITEMS WHERE NO CEILING IS REQUIRED OR INDICATED.
- COORDINATE ALL TRADES INVOLVED IN THE CEILING WORK TO ENSURE CLEARANCE FOR FIXTURES, DUCTS, PIPING, CEILING SUSPENSION SYSTEMS, ETC. NECESSARY TO MAINTAIN CEILING HEIGHTS NOTED.
- LIGHTS, DIFFUSERS, EXIT SIGNS, SMOKE DETECTORS, SPEAKERS, STROBES, AND MISC. DEVICES SHALL BE CENTERED IN THE CEILING WHERE THEY OCCUR, U.N.O. FIRE PROTECTION SCOPE SHALL BE DESIGN-BUILD. ALL
- CORRIDOR SPRINKLER HEADS SHALL BE ALIGNED IN THE SAME LOCATION PARALLEL TO THE WALL WITHIN EACH SPECIFIC CEILING CONSTRUCTION.
- SMOKE ALARMS SHALL BE PROVIDED IN ALL BEDROOMS, OUTSIDE OF ALL BEDROOMS, AND ON EACH FLOOR AS REQUIRED. CARBON MONOXIDE DETECTORS SHALL BE INSTALLED OUTSIDE OF ALL BEDROOMS. SMOKE ALARMS AND CO DETECTORS SHALL BE HARDWIRED AND HAVE BATTERY BACKUP.
- ACCESS DOOR LOCATIONS IN GYPSUM BOARD CEILINGS ARE INDICATED ON RCP'S ONLY WHERE ARCHITECTURALLY SIGNIFICANT. REFERENCE SPECIFICATIONS AND MEP DRAWINGS FOR OTHER
- ACCESS DOOR LOCATIONS. UNLESS PREFINISHED TO MATCH ADJACENT SURFACE, PAINT MECHANICAL GRILLS, DIFFUSERS, ACCESS PANELS, AND OTHER EQUIPMENT TO MATCH ADJACENT SURFACE.
- 10. EXIT SIGNS ARE SHOWN ON RCP'S ONLY WHERE LOCATIONS ARE ARCHITECTURALLY SIGNIFICANT.
- 11. PROVIDE UL-CLASSIFIED LIGHT FIXTURES OR ENCLOSURES IN RATED FLOOR/CEILING ASSEMBLIES IN

REFER	RDANCE WITH IBC CHAPTER TO LIGHTING PLANS FOR I OCATIONS. FIXTURES SHOV RENCED AND SHOWN FOR (	EXACT FI) WN HERE	ARE	
	ENLARGED RCP -	LEGENI	ס	
	<b>GWB (C1)</b> INTERIOR	$\rightarrow$	SLOPE CEILING AS NOTED	
	<b>T&amp;G CEILING (C2)</b> INTERIOR	0	CEILING MOUNTED LIGHT FIXTURE	
	FIBER-CEMENT SOFFIT (C3) - EXTERIOR	+ + + + + + + + + + + + + + + + + + + +	VINYL SCRIM CLG - INTERIOR	
	ACCESS PANEL		ACOUSTIC VINYL TILE CLG - INTERIOR	

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BRNCE D. WINS B-2465 12/15/2023
The Amble         Steamboat Springs, CO
IFC SET SHEET TITLE UNIT PLAN - 3 BEDROOM CORNER - LEVELS 02-03 SHEET NO. BHEET NO.





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### **ENLARGED FLOOR PLAN - GENERAL NOTES**

- REFER TO G0.2X SHEETS FOR EXTERIOR AND INTERIOR BUILDING ENCLOSURE ASSEMBLIES.
- REFER TO A1.0X SHEETS FOR EXTERIOR WALL, DEMISING WALL, AND CORRIDOR WALL TYPES AND LOCATIONS.
- REFER TO A1.1X SHEETS FOR INTERIOR AND EXTERIOR WINDOW/DOOR TAGS WITH UNIT BACKGROUNDS FOR REFERENCE.
- ALIGN WALLS WHERE THEY APPEAR TO ALIGN, U.N.O. 5. THE INSIDE FACE OF DOOR JAMBS SHALL BE 4" FROM
- ADJACENT WALL OR FINISHED COLUMN, U.N.O. PROVIDE BLOCKING FOR ALL WALL MOUNTED EQUIPMENT
- AND ACCESSORIES. THE CENTERLINE OF ALL RESIDENTIAL TOILETS SHALL BE
- LOCATED 18" OFF OF FINISH FACE OF WALL, U.N.O. SWING CLEARANCE AT UNIT ENTRY SHALL BE 18" MIN.
- FROM FINISH FACE OF ADJACENT SURFACE. ALL DIMENSIONS ARE TO FACE OF STUD, GRID LINE, OR
- FACE OF CONCRETE, U.N.O. 10. WHERE "CLEAR" IS CALLED OUT ON A DIMENSION,
- PROVIDE DIMENSION FROM FACE OF FINISH TO FACE OF FINISH 11. FURNITURE IS NOT IN CONTRACT, U.N.O., AND IS SHOWN
- FOR DIAGRAMATIC PURPOSES ONLY. 12. CONSULTANT MODELS SHOWN FOR REFERENCE ONLY.

### ENLARGED FLOOR PLAN - LEGEND

	CARPET RE: FINISH SCHED.		RUBBER (F7) RE LANDSCAPE			
	<b>TILE</b> RE: FINISH SCHED.		CONCRETE (F8) RE: LANDSCAPE			
	WOOD - UNIT RE: FINISH SCHED.		<b>PAVERS (F9)</b> RE: LANDSCAPE			
	WOOD - PUBLIC RE: FINISH SCHED.					
	POLISHED CONC. (F5.1) INTERIOR					
	SEALED CONC. (F5.2) INTERIOR					
	HERRINGBONE TILE (F6) RE: FINISH SCHED.					
ENI	ARGED FLOOR PLAN - (	CLEARA	NCE NOTES			
	FLOOR CLEARANCE					
А	DOOR CLEARANCE, 54" X 60"					
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C						

- C CLEAR FLOOR CLEARANCE, 30" X 48"
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### ENLARGED RCP - GENERAL NOTES

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- IN THE CASE OF MINOR DISCREPANCIES BETWEEN MEP AND ARCHITECTURAL DOCUMENTS ON THE LOCATION OF CEILING MOUNTED COMPONENTS, THE ARCHITECTURAL RCP'S GOVERN. IN THE CASE OF MAJOR DISCREPANCIES, THE ARCHITECT SHALL BE NOTIFIED AS SOON AS THE DISCREPANCY IS DISCOVERED PRIOR TO PROCEEDING WITH THE WORK.
- REFERENCE MECHANICAL AND ELECTRICAL DRAWINGS FOR MOUNTING LOCATIONS OF ITEMS WHERE NO CEILING IS REQUIRED OR INDICATED.
- COORDINATE ALL TRADES INVOLVED IN THE CEILING WORK TO ENSURE CLEARANCE FOR FIXTURES, DUCTS, PIPING, CEILING SUSPENSION SYSTEMS, ETC. NECESSARY TO MAINTAIN CEILING HEIGHTS NOTED.
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- ACCESS DOOR LOCATIONS IN GYPSUM BOARD CEILINGS ARE INDICATED ON RCP'S ONLY WHERE ARCHITECTURALLY SIGNIFICANT. REFERENCE SPECIFICATIONS AND MEP DRAWINGS FOR OTHER ACCESS DOOR LOCATIONS.
- UNLESS PREFINISHED TO MATCH ADJACENT SURFACE, PAINT MECHANICAL GRILLS, DIFFUSERS, ACCESS PANELS, AND OTHER EQUIPMENT TO MATCH ADJACENT SURFACE.
- 10. EXIT SIGNS ARE SHOWN ON RCP'S ONLY WHERE LOCATIONS ARE ARCHITECTURALLY SIGNIFICANT. 11. PROVIDE UL-CLASSIFIED LIGHT FIXTURES OR
- ENCLOSURES IN RATED FLOOR/CEILING ASSEMBLIES IN ACCORDANCE WITH IBC CHAPTER 7. 12. REFER TO LIGHTING PLANS FOR EXACT FIXTURE TYPES AND LOCATIONS. FIXTURES SHOWN HERE ARE
- REFERENCED AND SHOWN FOR GENERAL ALIGNMENT.

ENLARGED RCP - LEGEND

(* * (* *) (* *) (* *) (* *) (* *) (* *)	<b>GWB (C1)</b> INTERIOR	$\rightarrow$	SLOPE CEILING AS NOTED
	<b>T&amp;G CEILING (C2)</b> INTERIOR	0	CEILING MOUNTED LIGHT FIXTURE
	FIBER-CEMENT SOFFIT	+ +	VINYL SCRIM CLG -
	(C3) - EXTERIOR	+ + +	INTERIOR

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	BASE B-	CO ED.WINS 2465 15/2023 ARCW	
	The Amble	Steamboat Springs, CO	
REVISIONS No. 1 2 3	RFI #110 ASI 004 RFI #223.1	cription	Date 06.14.24 08.07.24 10.16.24
ISSUE DATE	THE	AMBLE C SET	03/15/2024

UNIT PLAN - 3
<b>BEDROOM CORNER -</b>
<b>LEVELS 02-03</b>

A4.08.4

SHEET TITLE

SHEET NO.