### **GENERAL NOTES**

- 1. THESE PLANS SHALL NOT BE UTILIZED FOR CONSTRUCTION OR PERMITTING UNLESS STATED FOR SUCH USE IN THE TITLE BLOCK.
- 2. DRAWINGS ARE INTENDED TO BE PRINTED ON 24" X 36" PAPER. PRINTING THESE DRAWINGS AT A DIFFERENT SIZE WILL IMPACT THE SCALE. VERIFY THE GRAPHIC SCALE BEFORE REFERENCING ANY MEASUREMENTS ON THESE SHEETS. THE RECIPIENT OF THESE DRAWINGS SHALL BE RESPONSIBLE FOR ANY ERRORS RESULTING FROM INCORRECT PRINTING, COPYING, OR ANY OTHER CHANGES THAT ALTER THE SCALE OF THE DRAWINGS.
- 3. VERIFY ALL PLAN DIMENSIONS PRIOR TO START OF CONSTRUCTION. NOTIFY THE OWNER'S REPRESENTATIVE TO ADDRESS ANY QUESTIONS OR CLARIFY ANY DISCREPANCIES.
- 4. WRITTEN DIMENSIONS TAKE PRECEDENCE OVER SCALED DIMENSIONS.
- 5. SUBMIT A CHANGE ORDER FOR APPROVAL FOR ANY CHANGES TO WORK SCOPE RESULTING FROM FIELD CONDITIONS OR DIRECTION BY OWNER'S REPRESENTATIVE WHICH REQUIRE ADDITIONAL COST TO THE OWNER PRIOR TO PERFORMANCE OF WORK
- 6. THE CONTRACTOR SHALL PROVIDE A STAKED LAYOUT OF ALL SITE IMPROVEMENTS FOR INSPECTION BY THE OWNER'S REPRESENTATIVE AND MAKE MODIFICATIONS AS REQUIRED. ALL LAYOUT INFORMATION IS AVAILABLE IN DIGITAL FORMAT FOR USE BY THE CONTRACTOR.
- 7. IF A GEOTECHNICAL SOILS REPORT IS NOT AVAILABLE AT THE TIME OF CONSTRUCTION, NORRIS DESIGN RECOMMENDS A REPORT BE AUTHORIZED BY THE OWNER AND THAT ALL RECOMMENDATIONS OF THE REPORT ARE FOLLOWED DURING CONSTRUCTION. THE CONTRACTOR SHALL USE THESE CONTRACT DOCUMENTS AS A BASIS FOR THE BID. IF THE OWNER ELECTS TO PROVIDE A GEOTECHNICAL REPORT, THE CONTRACTOR SHALL REVIEW THE REPORT AND SUBMIT AN APPROPRIATE CHANGE ORDER TO THE OWNER'S REPRESENTATIVE IF ADDITIONAL COSTS ARE REQUESTED.
- 8. CONTRACTOR SHALL CONFIRM THAT SITE CONDITIONS ARE SIMILAR TO THE PLANS, WITHIN TOLERANCES STATED IN THE CONTRACT DOCUMENTS, AND SATISFACTORY TO THE CONTRACTOR PRIOR TO START OF WORK. SHOULD SITE CONDITIONS BE DIFFERENT THAN REPRESENTED ON THE PLANS OR UNSATISFACTORY TO THE CONTRACTOR, THE CONTRACTOR SHALL CONTACT THE OWNER'S REPRESENTATIVE FOR CLARIFICATION AND FURTHER DIRECTION.
- 9. CONTRACTOR IS RESPONSIBLE TO PAY FOR, AND OBTAIN, ANY REQUIRED APPLICATIONS, PERMITTING, LICENSES, INSPECTIONS AND METERS ASSOCIATED WITH WORK
- 10. THE CONTRACTOR SHALL BE RESPONSIBLE FOR ANY FINES OR PENALTIES ASSESSED TO THE OWNER RELATING TO ANY VIOLATIONS OR NON-CONFORMANCE WITH THE PLANS SPECIFICATIONS, CONTRACT DOCUMENTS, JURISDICTIONAL CODES, AND REGULATORY **AGENCIES**
- 11. THE CONTRACTOR SHALL BE RESPONSIBLE FOR COORDINATION OF ALL UTILITY LOCATES PRIOR TO ANY EXCAVATION. REFER TO ENGINEERING UTILITY PLANS FOR ALL PROPOSED UTILITY LOCATIONS AND DETAILS. NOTIFY OWNER'S REPRESENTATIVE IF EXISTING OR PROPOSED UTILITIES INTERFERE WITH THE ABILITY TO PERFORM WORK.
- 12. UNLESS IDENTIFIED ON THE PLANS FOR DEMOLITION OR REMOVAL, THE CONTRACTOR IS RESPONSIBLE FOR THE COST TO REPAIR UTILITIES, ADJACENT OR EXISTING LANDSCAPE, ADJACENT OR EXISTING PAVING, OR ANY PUBLIC AND PRIVATE PROPERTY THAT IS DAMAGED BY THE CONTRACTOR OR THEIR SUBCONTRACTOR'S OPERATIONS DURING INSTALLATION, ESTABLISHMENT OR DURING THE SPECIFIED MAINTENANCE PERIOD. ALL DAMAGES SHALL BE REPAIRED TO PRE-CONSTRUCTION CONDITIONS AS DETERMINED BY THE OWNER'S REPRESENTATIVE. CONTRACTOR SHALL BE RESPONSIBLE FOR LOGGING ANY DAMAGES PRIOR TO START OF CONSTRUCTION AND DURING THE CONTRACT PERIOD.
- 13. ALL WORK SHALL BE CONFINED TO THE AREA WITHIN THE CONSTRUCTION LIMITS AS SHOWN ON THE PLANS. ANY AREAS OR IMPROVEMENTS DISTURBED OUTSIDE THESE LIMITS SHALL BE RETURNED TO THEIR ORIGINAL CONDITION AT THE CONTRACTOR'S EXPENSE. IN THE EVENT THE CONTRACTOR REQUIRES A MODIFICATION TO THE CONSTRUCTION LIMITS, WRITTEN PERMISSION MUST BE OBTAINED FROM THE OWNER'S REPRESENTATIVE PRIOR TO ANY DISTURBANCE OUTSIDE OF THE LIMITS OF WORK.
- 14. THE CONTRACTOR SHALL BE RESPONSIBLE FOR THE REPAIR OF ANY OF THEIR TRENCHES OR **EXCAVATIONS THAT SETTLE.**
- 15. THE CONTRACTOR SHALL BE RESPONSIBLE TO PREPARE AND SUBMIT A TRAFFIC CONTROL PLAN TO THE APPROPRIATE JURISDICTIONAL AGENCIES AND THE OWNER'S REPRESENTATIVE IF THEIR WORK AND OPERATIONS AFFECT OR IMPACT THE PUBLIC RIGHTS-OF-WAY. OBTAIN APPROVAL PRIOR TO ANY WORK WHICH AFFECTS OR IMPACTS THE PUBLIC RIGHTS-OF-WAY. THE CONTRACTOR SHALL BE RESPONSIBLE FOR ANY FINES OR PENALTIES ASSESSED TO THE OWNER RELATING TO THIS REQUIREMENT DURING THE CONTRACT PERIOD.
- SIGHT TRIANGLES AND SIGHT LINES SHALL REMAIN UNOBSTRUCTED BY EQUIPMENT. CONSTRUCTION MATERIALS, PLANT MATERIAL OR ANY OTHER VISUAL OBSTACLE DURING THE CONTRACT PERIOD AND AT MATURITY OF PLANTS PER LOCAL JURISDICTIONAL REQUIREMENTS. NO PLANT MATERIAL OTHER THAN GROUND COVER IS ALLOWED TO BE PLANTED ADJACENT TO FIRE HYDRANTS AS STIPULATED BY JURISDICTIONAL REQUIREMENTS.
- 17. COORDINATE SITE ACCESS, STAGING, STORAGE AND CLEANOUT AREAS WITH OWNER'S REPRESENTATIVE.
- 18. CONTRACTOR IS RESPONSIBLE FOR PROVIDING TEMPORARY SAFETY FENCING AND BARRIERS AROUND ALL IMPROVEMENTS SUCH AS WALLS, PLAY STRUCTURES, EXCAVATIONS, ETC. ASSOCIATED WITH THEIR WORK UNTIL SUCH FACILITIES ARE COMPLETELY INSTALLED PER THE PLANS. SPECIFICATIONS AND MANUFACTURER'S RECOMMENDATIONS.

## LAYOUT NOTES

CHECKED DRAWN BY

- 1. WRITTEN DIMENSIONS WILL TAKE PRECEDENCE OVER SCALED DIMENSIONS. 2. SHOULD SITE CONDITIONS BE DIFFERENT THAN WHAT IS INDICATED ON THE DRAWINGS
- CONTACT THE LANDSCAPE ARCHITECT IMMEDIATELY FOR CLARIFICATION. 3. CURVED WALKS AND CURB EDGES ARE INTENDED TO BE CONSTRUCTED WITH SMOOTH FLOWING CURVES. ANYTHING OTHER THAN SMOOTH FLOWING CURVES WILL BE REJECTED.
- 4. THE CONTRACTOR SHALL OBTAIN, AT HIS EXPENSE, ALL PERMITS WHICH ARE NECESSARY TO PERFORM THE PROPOSED WORK.
- INSPECTION BY THE OWNER'S REPRESENTATIVE AND MAKE MODIFICATIONS AS REQUIRED AT NO ADDITIONAL COST TO THE OWNER. 6. THE CONTRACTOR SHALL INSTALL SLEEVING FOR IRRIGATION IMPROVEMENTS PRIOR TO

5. THE CONTRACTOR SHALL PROVIDE A STAKED LAYOUT OF ALL SITE IMPROVEMENTS FOR

- INSTALLING CONCRETE FLATWORK. REFER TO IRRIGATION PLANS. 7. LAYOUT WALKS, SCORE JOINTS AND PAVING PATTERNS AS CLOSELY AS POSSIBLE TO PLANS,
- DETAILS, AND SPECIFICATIONS. DO NOT DEVIATE FROM PLANS UNLESS SPECIFIC APPROVAL IS OBTAINED FROM THE OWNER'S REPRESENTATIVE.
- 8. ALL WORK SHALL BE CONFINED TO THE AREA WITHIN THE CONSTRUCTION LIMITS AS SHOWN ON THE PLANS. ANY AREAS OR IMPROVEMENTS DISTURBED OUTSIDE THESE LIMITS SHALL BE RETURNED TO THEIR ORIGINAL CONDITION AT THE CONTRACTOR'S EXPENSE. IN THE EVENT THE CONTRACTOR REQUIRES A MODIFICATION TO THE CONSTRUCTION LIMITS, WRITTEN PERMISSION MUST BE OBTAINED FROM THE LANDSCAPE ARCHITECT PRIOR TO ANY
- DISTURBANCE OUTSIDE OF THE LIMITS OF WORK. SEE TECHNICAL SPECIFICATIONS. 9. CONTRACTOR IS RESPONSIBLE FOR PROVIDING TEMPORARY FENCING AROUND ALL PLAY STRUCTURES UNTIL PROPER FALL SURFACE IS COMPLETELY INSTALLED PER MANUFACTURER'S SPECIFICATIONS.
- 10. CONTRACTOR IS RESPONSIBLE FOR SUPERVISING ALL SAFETY SURFACING AND PAVEMENT DURING THE CURING PROCESS.

- 19. CONTRACTOR SHALL BE RESPONSIBLE FOR PROTECTION OF THEIR MATERIAL STOCK PILES AND WORK FROM VANDALISM, EROSION OR UNINTENDED DISTURBANCE DURING THE CONSTRUCTION PERIOD AND UNTIL FINAL ACCEPTANCE IS ISSUED.
- 20. THE CONTRACTOR SHALL KNOW, UNDERSTAND AND ABIDE BY ANY STORM WATER POLLUTION PREVENTION PLAN (SWPPP) ASSOCIATED WITH THE SITE. IF A STORM WATER POLLUTION PREVENTION PLAN IS NOT PROVIDED BY THE OWNER'S REPRESENTATIVE, REQUEST A COPY BEFORE PERFORMANCE OF ANY SITE WORK.
- 21. MAINTAIN ANY STORM WATER MANAGEMENT FACILITIES THAT EXIST ON SITE FOR FULL FUNCTIONALITY. THE CONTRACTOR SHALL INSTALL AND MAINTAIN ANY NEW STORM WATER MANAGEMENT FACILITIES THAT ARE IDENTIFIED IN THE SCOPE OF WORK TO FULL FUNCTIONALITY. THE CONTRACTOR SHALL BE RESPONSIBLE FOR ANY FINES OR PENALTIES ASSESSED TO THE OWNER FOR FAILURE TO MAINTAIN STORM WATER MANAGEMENT FACILITIES DURING THE CONTRACT PERIOD.
- 22. THE CONTRACTOR SHALL PREVENT SEDIMENT, DEBRIS AND ALL OTHER POLLUTANTS FROM EXITING THE SITE OR ENTERING THE STORM SEWER SYSTEM DURING ALL DEMOLITION OR CONSTRUCTION OPERATIONS THAT ARE PART OF THIS PROJECT. THE CONTRACTOR SHALL BE RESPONSIBLE FOR ANY FINES OR PENALTIES ASSESSED TO THE OWNER RELATING TO THESE REQUIREMENTS DURING THEIR CONTRACTED COURSE OF WORK.
- 23. THE CONTRACTOR SHALL BE RESPONSIBLE TO PREVENT ANY IMPACTS TO ADJACENT WATERWAYS, WETLANDS, OR OTHER ENVIRONMENTALLY SENSITIVE AREAS RESULTING FROM WORK DONE AS PART OF THIS PROJECT. THE CONTRACTOR SHALL BE RESPONSIBLE FOR ANY FINES OR PENALTIES ASSESSED TO THE OWNER RELATING TO THESE STANDARDS DURING THEIR CONTRACTED COURSE OF WORK.
- 24. THE CONTRACTOR AND/OR THEIR AUTHORIZED AGENTS SHALL INSURE THAT ALL LOADS OF CONSTRUCTION MATERIAL IMPORTED TO OR EXPORTED FROM THE PROJECT SITE SHALL BE PROPERLY COVERED TO PREVENT LOSS OF MATERIAL DURING TRANSPORT. TRANSPORTATION METHODS ON PUBLIC RIGHT-OF WAYS SHALL CONFORM TO JURISDICTIONAL REQUIREMENTS. THE CONTRACTOR SHALL BE RESPONSIBLE FOR ANY FINES OR PENALTIES ASSESSED TO THE OWNER RELATING TO THESE REQUIREMENTS
- 25. THE CLEANING OF EQUIPMENT IS PROHIBITED AT THE JOB SITE UNLESS AUTHORIZED BY THE OWNER'S REPRESENTATIVE IN A DESIGNATED AREA. THE DISCHARGE OF WATER, WASTE CONCRETE, POLLUTANTS, OR OTHER MATERIALS SHALL ONLY OCCUR IN AREAS DESIGNED FOR SUCH USE AND APPROVED BY THE OWNER'S REPRESENTATIVE.
- 26. THE CLEANING OF CONCRETE EQUIPMENT IS PROHIBITED AT THE JOB SITE EXCEPT IN DESIGNATED CONCRETE WASHOUT AREAS. THE DISCHARGE OF WATER CONTAINING WASTE CONCRETE IN THE STORM SEWER IS PROHIBITED.
- 27. OPEN SPACE SWALES: IF SWALES ARE EXISTING ON SITE AND ARE NOT INTENDED TO BE MODIFIED AS PART OF THE PLANS, THE CONTRACTOR SHALL BE RESPONSIBLE TO MAINTAIN THE CONVEYANCE OF WATER WITHIN THE SWALES DURING THE CONTRACT PERIOD. THE CONTRACTOR SHALL BE RESPONSIBLE FOR ANY DIVERSION OR PUMPING OF WATER IF REQUIRED TO COMPLETE WORK. ANY SWALES DISTURBED BY THE CONTRACTOR SHALL BE REPAIRED/RESTORED TO THEIR ORIGINAL CONDITION. IF THE SWALE NEEDS TO BE DISTURBED OR MODIFIED FOR ANY REASON, THE CONTRACTOR SHALL NOTIFY THE OWNER'S REPRESENTATIVE FOR APPROVAL PRIOR TO DISTURBANCE.
- 28. DETENTION AND WATER QUALITY PONDS: IF DETENTION PONDS AND WATER QUALITY PONDS ARE EXISTING ON SITE AND ARE NOT INTENDED TO BE MODIFIED AS PART OF THE PLANS, THE CONTRACTOR SHALL MINIMIZE DISTURBANCE TO THE PONDS, DRAINAGE STRUCTURES AND SPILLWAYS DURING CONSTRUCTION. ALL PONDS, DRAINAGE STRUCTURES AND SPILLWAYS SHALL BE MAINTAINED IN OPERABLE CONDITIONS AT ALL TIMES. ANY POND OR SPILLWAY AREAS DISTURBED BY THE CONTRACTOR SHALL BE REPAIRED/RESTORED TO THEIR ORIGINAL CONDITION. IF THE POND NEEDS TO BE DISTURBED OR MODIFIED FOR ANY REASON. THE CONTRACTOR SHALL NOTIFY THE OWNER'S REPRESENTATIVE FOR APPROVAL PRIOR TO
- 29. MAINTENANCE ACCESS BENCHES: IF MAINTENANCE BENCHES OR ACCESS ROADS EXIST ON SITE AND ARE NOT INTENDED TO BE MODIFIED AS PART OF THE PLANS, THE CONTRACTOR SHALL MINIMIZE DISTURBANCE TO THE BENCHES OR ACCESS ROADS DURING CONSTRUCTION. ANY BENCHES OR ACCESS ROADS DISTURBED BY THE CONTRACTOR SHALL BE REPAIRED/RESTORED TO THEIR ORIGINAL CONDITION. THE CONTRACTOR SHALL MAINTAIN ACCESS TO ALL EXISTING BENCHES AND ACCESS ROADS DURING THE CONSTRUCTION PERIOD. IF ACCESS NEEDS TO BE BLOCKED FOR ANY REASON. THE CONTRACTOR SHALL NOTIFY THE OWNER'S REPRESENTATIVE FOR APPROVAL PRIOR TO INTERRUPTION OF
- 30. LOCAL, STATE AND FEDERAL JURISDICTIONAL REQUIREMENTS, RESTRICTIONS OR PROCEDURES SHALL SUPERSEDE THESE PLANS, NOTES AND SPECIFICATIONS WHEN MORE STRINGENT. NOTIFY THE OWNER'S REPRESENTATIVE IF CONFLICTS OCCUR.

## **EROSION NOTES**

- 1. THE OWNER, SITE DEVELOPER, CONTRACTOR AND/OR THEIR AUTHORIZED AGENTS SHALL REMOVE ALL SEDIMENT, MUD, AND CONSTRUCTION DEBRIS THAT MAY ACCUMULATE IN THE FLOW LINE AND THE PUBLIC RIGHTS-OF-WAY OF THE CITY OF STEAMBOAT SPRINGS AS A RESULT OF THIS SITE DEVELOPMENT. SAID REMOVAL SHALL BE CONDUCTED IN A TIMELY MANNER.
- 2. THE CONTRACTOR SHALL PREVENT SEDIMENT, DEBRIS AND ALL OTHER POLLUTANTS FROM ENTERING THE STORM SEWER SYSTEM DURING ALL DEMOLITION OR CONSTRUCTION OPERATIONS THAT ARE PART OF THIS PROJECT.
- 3. THE CONTRACTOR SHALL BE HELD RESPONSIBLE FOR REMEDIATION OF ANY ADVERSE IMPACTS TO ADJACENT WATERWAYS, WETLANDS, ETC., RESULTING FROM WORK DONE AS PART OF THIS PROJECT.
- 4. THE DEVELOPER, GENERAL CONTRACTOR, GRADING CONTRACTOR AND/OR THEIR AUTHORIZED AGENTS SHALL INSURE THAT ALL LOADS OF CUT AND FILL MATERIAL IMPORTED TO OR EXPORTED FROM THIS SITE SHALL BE PROPERLY COVERED TO PREVENT LOSS OF MATERIAL DURING TRANSPORT ON PUBLIC RIGHT-OF WAYS.
- 5. THE USE OF REBAR, STEEL STAKES, OR STEEL FENCE POSTS TO STAKE DOWN STRAW OR HAY BALES OR TO SUPPORT SILT FENCING USED AS AN EROSION CONTROL MEASURE IS PROHIBITED.
- 6. THE CLEANING OF CONCRETE TRUCK DELIVERY CHUTES IS PROHIBITED AT THE JOB SITE. THE DISCHARGE OF WATER CONTAINING WASTE CONCRETE TO THE STORM SEWER SYSTEM IS PROHIBITED.
- 7. THE CONTRACTOR SHALL PROTECT ALL STORM SEWER FACILITIES ADJACENT TO ANY LOCATION WHERE PAVEMENT CUTTING OPERATIONS INVOLVING WHEEL CUTTING, SAW CUTTING, OR ABRASIVE WATER JET CUTTING ARE TO TAKE PLACE. THE CONTRACTOR SHALL REMOVE AND PROPERLY DISPOSE OF ALL WASTE PRODUCTS GENERATED BY SAID CUTTING OPERATIONS ON A DAILY BASIS.

### LANDSCAPE NOTES

- 1. THE CONTRACTOR SHALL FOLLOW THE LANDSCAPE PLANS AND SPECIFICATIONS AS CLOSELY AS POSSIBLE. ANY SUBSTITUTION OR ALTERATION SHALL NOT BE ALLOWED WITHOUT APPROVAL OF THE OWNER'S REPRESENTATIVE. OVERALL PLANT QUANTITY AND QUALITY SHALL BE CONSISTENT WITH THE PLANS.
- 2. THE CONTRACTOR IS RESPONSIBLE FOR VERIFYING ALL PLANT QUANTITIES. GRAPHIC QUANTITIES TAKES PRECEDENCE OVER WRITTEN QUANTITIES.
- 3. THE OWNER'S REPRESENTATIVE RESERVES THE RIGHT TO INSPECT AND TAG ALL PLANT MATERIAL PRIOR TO SHIPPING TO THE SITE. IN ALL CASES, THE OWNER'S REPRESENTATIVE MAY REJECT PLANT MATERIAL AT THE SITE IF MATERIAL IS DAMAGED. DISEASED. OR DECLINING IN HEALTH AT THE TIME OF ONSITE INSPECTIONS OR IF THE PLANT MATERIAL DOES NOT MEET THE MINIMUM SPECIFIED STANDARD IDENTIFIED ON THE PLANS AND IN THE SPECIFICATIONS. THE CONTRACTOR SHALL COORDINATE WITH THE OWNER'S REPRESENTATIVE FOR INSPECTION AND APPROVAL OF ALL MATERIALS AND PRODUCTS PRIOR TO INSTALLATION.
- 4. THE OWNER'S REPRESENTATIVE MAY ELECT TO UPSIZE PLANT MATERIAL AT THEIR DISCRETION BASED ON SELECTION, AVAILABILITY, OR TO ENHANCE SPECIFIC AREAS OF THE PROJECT. THE CONTRACTOR SHALL VERIFY PLANT MATERIAL SIZES WITH OWNER'S REPRESENTATIVE PRIOR TO PURCHASING, SHIPPING OR STOCKING OF PLANT MATERIALS. SUBMIT CHANGE ORDER REQUEST TO OWNER'S REPRESENTATIVE FOR APPROVAL IF ADDITIONAL COST IS REQUESTED BY THE CONTRACTOR PRIOR TO INSTALLATION. RE-STOCKING CHARGES WILL NOT BE APPROVED IF THE CONTRACTOR FAILS TO SUBMIT A REQUEST FOR MATERIAL CHANGES.
- 5. THE CONTRACTOR SHALL WARRANTY ALL CONTRACTED WORK AND MATERIALS FOR A PERIOD OF ONE YEAR AFTER SUBSTANTIAL COMPLETION HAS BEEN ISSUED BY THE OWNER'S REPRESENTATIVE FOR THE ENTIRE PROJECT UNLESS OTHERWISE SPECIFIED IN THE CONTRACT DOCUMENTS OR SPECIFICATIONS.
- 6. REFER TO IRRIGATION PLANS FOR LIMITS AND TYPES OF IRRIGATION DESIGNED FOR THE LANDSCAPE. IN NO CASE SHALL IRRIGATION BE EMITTED WITHIN THE MINIMUM DISTANCE FROM BUILDING OR WALL FOUNDATIONS AS STIPULATED IN THE GEOTECHNICAL REPORT ALL IRRIGATION DISTRIBUTION LINES, HEADS AND EMITTERS SHALL BE KEPT OUTSIDE THE MINIMUM DISTANCE AWAY FROM ALL BUILDING AND WALL FOUNDATIONS AS STIPULATED IN THE GEOTECHNICAL REPORT.
- 7. LANDSCAPE MATERIAL LOCATIONS SHALL HAVE PRECEDENCE OVER IRRIGATION MAINLINE AND LATERAL LOCATIONS. COORDINATE INSTALLATION OF IRRIGATION EQUIPMENT SO THAT IT DOES NOT INTERFERE WITH THE PLANTING OF TREES OR OTHER LANDSCAPE
- 8. THE LANDSCAPE CONTRACTOR SHALL BE RESPONSIBLE FOR ENSURING POSITIVE DRAINAGE EXISTS IN ALL LANDSCAPE AREAS. SURFACE DRAINAGE ON LANDSCAPE AREAS SHALL NOT FLOW TOWARD STRUCTURES AND FOUNDATIONS. MAINTAIN SLOPE AWAY FROM FOUNDATIONS PER THE GEOTECHNICAL REPORT RECOMMENDATIONS. ALL LANDSCAPE AREAS BETWEEN WALKS AND CURBS SHALL DRAIN FREELY TO THE CURB UNLESS OTHERWISE IDENTIFIED ON THE GRADING PLAN. IN NO CASE SHALL THE GRADE, TURF THATCH, OR OTHER LANDSCAPE MATERIALS DAM WATER AGAINST WALKS. MINIMUM SLOPES ON LANDSCAPE AREAS SHALL BE 2%; MAXIMUM SLOPE SHALL BE 25% UNLESS SPECIFICALLY IDENTIFIED ON THE PLANS OR APPROVED BY THE OWNER'S REPRESENTATIVE.
- 9. PRIOR TO INSTALLATION OF PLANT MATERIALS, AREAS THAT HAVE BEEN COMPACTED OR DISTURBED BY CONSTRUCTION ACTIVITY SHALL BE THOROUGHLY LOOSENED TO A DEPTH OF 8" - 12" AND AMENDED PER SPECIFICATIONS.
- 10. ALL LANDSCAPED AREAS ARE TO RECEIVE ORGANIC SOIL PREPARATION AS NOTED IN THE TECHNICAL SPECIFICATIONS.
- 11. TREES SHALL NOT BE LOCATED IN DRAINAGE SWALES, DRAINAGE AREAS, OR UTILITY EASEMENTS. CONTACT OWNER'S REPRESENTATIVE FOR RELOCATION OF PLANTS IN QUESTIONABLE AREAS PRIOR TO INSTALLATION.
- 12. THE CENTER OF EVERGREEN TREES SHALL NOT BE PLACED CLOSER THAN 8' AND THE CENTER OF ORNAMENTAL TREES CLOSER THAN 6' FROM A SIDEWALK, STREET OR DRIVE LANE. EVERGREEN TREES SHALL NOT BE LOCATED ANY CLOSER THAN 15' FROM IRRIGATION ROTOR HEADS. NOTIFY OWNER'S REPRESENTATIVE IF TREE LOCATIONS CONFLICT WITH THESE STANDARDS FOR FURTHER DIRECTION.

1. MAINTAIN TREES, SHRUBS, GROUND COVERS AND PLANTS BY PRUNING, CULTIVATING,

REQUIRED TO KEEP TREES AND SHRUBS FREE OF INSECTS AND DISEASE.

REPLACE DAMAGED STAKES AND GUYS AS DIRECTED BY THE OWNER.

WATERING, WEEDING, FERTILIZING, RESTORING PLANTING SAUCERS, TIGHTENING AND

REPAIRING STAKES AND GUY WIRE SUPPORTS. AND RESETTING TO PROPER GRADES OR

VERTICAL POSITION, AS REQUIRED TO ESTABLISH HEALTHY, VIABLE PLANTINGS. SPRAY AS

WATERING: MAINTAIN LARGE ENOUGH WATER BASINS AROUND PLANTS SO THAT ENOUGH WATER CAN BE APPLIED TO ESTABLISH MOISTURE THROUGHOUT ENTIRE ROOT ZONE. UTILIZE

PRUNE AS REQUIRED AT TIME OF PLANTING AND AS NEEDED TO CORRECT DAMAGE.

4. STAKES AND GUY WIRES: INSPECT REGULARLY TO PREVENT GIRDLING OF TRUNKS OR

6. INSECTS AND DISEASE CONTROL: CONTROL INSECTS AND DISEASE AS NECESSARY TO

MULCHES TO REDUCE EVAPORATION AND WATERING FREQUENCY. ALL TREES SHALL BE DRIP

BRANCHES AND TO PREVENT RUBBING WHICH MIGHT CAUSE BARK WOUNDS. REMOVE AND

WEED CONTROL: MAINTAIN TREE AND SHRUB BASINS FREE OF WEEDS AND GRASSES ON A

PREVENT DAMAGE TO THE HEALTH OR APPEARANCE OF PLANTS. USE ONLY APPROVED

MATERIALS AND METHODS. DEAD, DISEASED, AND/OR BEETLE INFESTED TREES MUST BE

REMOVED UPON IMMEDIATE RECEIPT OF WRITTEN OR VERBAL NOTICE TO THE PROPERTY

7. DEAD PLANT MATERIALS SHALL BE REMOVED WITHIN (1) MONTH WITH PLANTING MATERIALS

8. NATURAL LANDSCAPE MATERIALS SUCH AS ROCK, STONE, BARK CHIPS AND SHAVINGS WHICH

NO LONGER COVER THE AREA IN WHICH THEY WERE ORIGINALLY DEPOSITED SHALL BE

REPLENISHED SO THAT THEY AGAIN ACHIEVE FULL COVERAGE TO A MINIMUM DEPTH AS

CONTROL MEASURES APPROPRIATE TO THE AMOUNT OF GROWTH AND/OR SPECIES SHALL BE

1. IN AREAS THAT HAVE BEEN REGRADED AND/OR HAVE EXISTING WEED GROWTH, WEED

2. THROUGHOUT THE GROWING SEASON WEED CONTROL OF NATIVE AREAS SHALL BE

3. HERBICIDE SHALL BE APPLIED BY A LICENSED APPLICATOR OR UNDER THE DIRECT

THAT MEET THE ORIGINAL INTENT OF THE APPROVED LANDSCAPE DESIGN.

WEEKLY BASIS. FREQUENT SOIL CULTIVATION THAT MIGHT DESTROY SHALLOW ROOTS IS NOT

- 13. ALL EVERGREEN TREES SHALL BE FULLY BRANCHED TO THE GROUND AND SHALL NOT EXHIBIT SIGNS OF ACCELERATED GROWTH AS DETERMINED BY THE OWNER'S REPRESENTATIVE.
- 14. ALL TREES ARE TO BE STAKED AND GUYED PER DETAILS FOR A PERIOD OF 3 YEARS. THE CONTRACTOR SHALL BE RESPONSIBLE FOR REMOVING STAKES AT THE END OF 3 YEARS FROM ACCEPTANCE OF LANDSCAPE INSTALLATION BY THE OWNER'S REPRESENTATIVE. OBTAIN APPROVAL BY OWNER'S REPRESENTATIVE PRIOR TO REMOVAL
- 15. ALL TREES INSTALLED ABOVE RETAINING WALLS UTILIZING GEO-GRID MUST BE HAND DUG TO PROTECT GEO-GRID. IF GEO-GRID MUST BE CUT TO INSTALL TREES, APPROVAL MUST BE GIVEN BY OWNER'S REPRESENTATIVE PRIOR TO DOING WORK.
- 16. ALL TREES IN SEED OR TURF AREAS SHALL RECEIVE MULCH RINGS. OBTAIN APPROVAL FROM OWNER'S REPRESENTATIVE FOR ANY TREES THAT WILL NOT BE MULCHED FOR **EXCESSIVE MOISTURE REASONS**
- 17. SHRUB, GROUNDCOVER AND PERENNIAL BEDS ARE TO BE CONTAINED BY BENDA BOARD EDGER. EDGER IS NOT REQUIRED WHEN ADJACENT TO CURBS, WALLS, WALKS OR SOLID FENCES WITHIN 3" OF PRE-MULCHED FINAL GRADE. BENDA BOARD EDGER SHALL NOT BE REQUIRED TO SEPARATE MULCH TYPES UNLESS SPECIFIED ON THE PLANS
- 18. SEE MATERIAL SCHEDULE ON SHEET L-1.01 FOR MULCH TYPE USED FOR SHRUB BEDS. ALL GROUND COVER AND PERENNIAL FLOWER BEDS SHALL BE MULCHED WITH 3" DEPTH SHREDDED BARK LANDSCAPE MULCH. NO WEED CONTROL FABRIC IS REQUIRED IN GROUNDCOVER OR PERENNIAL AREAS.
- 19. AT SEED AREA BOUNDARIES ADJACENT TO EXISTING NATIVE AREAS, OVERLAP ABUTTING NATIVE AREAS BY THE FULL WIDTH OF THE SEEDER.
- 20. EXISTING TURF AREAS THAT ARE DISTURBED DURING CONSTRUCTION, ESTABLISHMENT AND THE MAINTENANCE PERIOD SHALL BE RESTORED WITH NEW SOD TO MATCH EXISTING TURF SPECIES. DISTURBED NATIVE AREAS WHICH ARE TO REMAIN SHALL BE OVER SEEDED AND RESTORED WITH SPECIFIED SEED MIX.
- 21. CONTRACTOR SHALL OVER SEED ALL MAINTENANCE OR SERVICE ACCESS BENCHES AND ROADS WITH SPECIFIED SEED MIX UNLESS OTHERWISE NOTED ON THE PLANS.
- 22. ALL SEEDED SLOPES EXCEEDING 25% IN GRADE (4:1) SHALL RECEIVE EROSION CONTROL BLANKETS. PRIOR TO INSTALLATION, NOTIFY OWNER'S REPRESENTATIVE FOR APPROVAL OF LOCATION AND ANY ADDITIONAL COST IF A CHANGE ORDER IS NECESSARY
- 23. WHEN COMPLETE, ALL GRADES SHALL BE WITHIN +/- 1/8" OF FINISHED GRADES AS SHOWN
- 24. SOFT SURFACE TRAILS NEXT TO MANICURED TURF OR SHRUB BEDS SHALL BE CONTAINED WITH BENDA BOARD EDGER.
- 25. PRIOR TO THE PLACEMENT OF MULCH AND WEED FABRIC, A GRANULAR, PRE-EMERGENT WEED CONTROL AGENT SHALL BE ADDED TO ALL PLANTING BEDS IN ACCORDANCE WITH THE MANUFACTURER'S INSTRUCTION, EXCEPT AROUND ORNAMENTAL GRASSES.
- THE CONTRACTOR IS EXPECTED TO KNOW AND UNDERSTAND THE CITY AND COUNTY SPECIFICATIONS FOR LANDSCAPE AND IRRIGATION. IN CASES OF DISCREPANCIES THE HIGHER OF THE TWO STANDARDS SHALL HAVE PRECEDENCE.
- 27. THE DEVELOPER, HIS SUCCESSORS AND ASSIGNS SHALL BE RESPONSIBLE FOR THE INSTALLATION, MAINTENANCE AND REPLACEMENT OF ALL IMPROVEMENTS SHOWN OR
- INDICATED ON THE APPROVED LANDSCAPE PLAN ON FILE IN THE PLANNING DEPARTMENT 28. ALL TREES, SHRUBS, ORNAMENTAL GRASSES, PERENNIALS AND DESIGNATED AREAS OF \$\(\frac{1}{3}\) NATIVE SEED SHALL BE IRRIGATED. ALL TREES, SHRUBS, ORNAMENTAL GRASSES, AND
- PERENNIALS TO BE DRIP IRRIGATED. ALL SEED AND SOD AREAS TO BE SPRAYED.

  29. TREES PLANTED IN GROUPS OF THREE OR MORE SHALL BE A VARIETY OF SIZES TO MIMIC
- 30. ALL EXISTING TREES SHALL BE PROTECTED AND PRESERVED TO THE EXTENT POSSIBLE 31. PLANT QUANTITIES SHOWN IN SCHEDULE (L-1.1) EXCLUDE LANDSCAPE OUTSIDE LIMIT OF

## **IRRIGATION NOTES**

- 2. ONLY NATIVE SEED/GRASS AREAS TO BE SPRAY IRRIGATED.
- 3. IRRIGATION TIMERS TO BE PROVIDED FOR IRRIGATION SYSTEM
- 4. PRECIPITATION SENSORS TO BE PROVIDED FOR IRRIGATION SYSTEM.

5. ONLY WATER CONSERVING NATIVE SEED MIXES TO BE USED FOR NATIVE GRASS AREAS.

- ALL TREES, SHRUBS, AND PERENNIALS SHALL BE DRIP IRRIGATED.

EAST WEST PARTNERS

1550 WEWATTA ST

DENVER, CO 80202

CONTACT: RYAN STONE

303.319.6172

**NORRIS** 

PEOPLE + PLACEMAKING

NORRIS-DESIGN.COM

**409 MAIN STREET** 

P.O. BOX 2320

FRISCO, CO 80443

P 970.368.7068

SUITE 207

DATE: 03/15/2024 - IFC SET

04/11/2024 - RFI 18 04/11/2024 - RFI 19 06/13/2024 - RFI 85 06/18/2024 - RFI 84

SHEET TITLE: LANDSCAPE **NOTES** 

L-1.00

NATIVE SEED AREAS

REFERENCE WEED CONTROL NOTES ABOVE.

PREFORMED USING A SPOT TREATMENT METHOD.

SUPERVISION OF A LICENSED APPLICATOR.

MAINTENANCE NOTES

IRRIGATED.

PERMITTED.

SPECIFIED.

PROVIDED.

WEED CONTROL

TREES, SHRUBS AND GROUND COVERS

MOW A MINIMUM OF ONCE YEARLY UPON ESTABLISHMENT OF GRASS.

AMENI	TY SCHEDULE											
CODE	DESCRIPTION	PRODUCT NAME	MANUFACTURER	CONTACT	MODEL#	COLOR / FINI	SH	SIZE / DIMENSIONS	DETAIL	NOTES		
S-101	ELECTRI-CHEF RUBY 32-INCH BUILT-IN 5280 WATT ELECTRIC GRILL WITH SINGLE TEMPERATUR CONTROL		APPROVED EQUAL)	,		STAINLESS STEEL		2`-8"	7/L-5.01	INSTALL PER MANUFACTURER SPECIFICATIONS. REFER TO PLANS FOR LOCATION AND QUANTITY.		
S-102	PET WASTE STATION	TE STATION PET WASTE STATION		OVED HTTPS://DOGIPOT.	1003HP-L-DOGIPOT FOREST GRE 10-GALLON S RECEPTACLE STAINLESS S		STEEL TRASH E WITH	15" X 13" X 73" H	N/A	INSTALL PER MANUFACTURER SPECIFICATIONS. REFER TO PLANS FOR LOCATION AND QUANTITY		
S-103	LINEAR PLANTER	RECTANGULAR RIMME ALUMINUM PLANTER	ANOVA OR APPROV	ED HTTPS://WWW.ANO VAFURNISHINGS.C OM/	#PLART242060A	POWDERCO/	LUMINUM, TEXTURED DWDERCOATED FINISH, DLOR: TEXTURED HARCOAL 60"L X 20"W		N/A	INSTALL PER MANUFACTURER SPECIFICATIONS. REFER TO PLANS FOR LOCATION AND QUANTITY.		
S-104	QUARE PLANTER CUBE RIMMED ALUMINUI PLANTER		IUM ANOVA OR APPROVI	ED HTTPS://WWW.ANO VAFURNISHINGS.C OM/	VAFURNISHINGS.C #PLAC3636A		TEXTURED POWDER COAT ALUMINUM FINISH, COLOR: TEXTURED CHARCOAL 36"X36"X36"		N/A	INSTALL PER MANUFACTURER SPECIFICATIONS. REFER TO PLANS FOR LOCATION AND QUANTITY		
S-105	BENCH BANCAL BENCH		LANDSCAPE FORMS APPROVED EQUAL)	(OR HTTPS://WWW.LAN DSCAPEFORMS.CO M	168" BACKED BANCAL	WOOD, POWDERCOAT FINISH 23" X 168" X		23" X 168" X 31" H	/3\ N/A	INSTALL PER MANUFACTURER SPECIFICATIONS. REFER TO PLANS FOR LOCATION AND QUANTITY		
	ACCESS PANEL	ISLAND GRILL DOORS; X 24" DOUBLE DOOR	18" ELECTRI-CHEF (OR APPROVED EQUAL)	HTTPS://WWW.ELE CTRI-CHEF.COM/	N/A	STAINLESS S	STEEL	18" X 24"	7/L-5.01	INSTALL PER MANUFACTURER SPECIFICATIONS. REFER TO PLANS FOR LOCATION AND QUANTITY.		
CODE	CAPE MATERIAL SC DESCRIPTION	HEDULE PRODUCT NAME	MANUFACTURER	CONTACT	COLOR / I	FINISH	SIZE / DIMEN	SIONS	DETAIL	NOTES		
JUDE	DECOMI HON	. NODOOT IN/AIVIL	WATER ACTURER	CONTACT	JOLOK / I		JIZE / DIIVIEIN		PEINIL	INSTALL ABOVE WEED		
M-101	SHRUB BED AREA	WASHINGTON CEDAR MULCH	PIONEER SAND OR LO SUPPLIER (OR APPRO			SHREDDED ORILLA HAIR)	4" MIN. DEPT AREA	H; SEE PLANS FOR	N/A CONTROL FABRIC IN ALL LANDSCAPE BEDS EXCLUDING SURROUNDING PERENNIALS			
M-102	COBBLE	COLORADO RIVER ROCK COBBLE	PIONEER SAND OR LO SUPPLIER (OR APPRO	VED EQUAL) CO.COM/	TONES	/ EARTH	75% 2" TO 4" AND 25% 5-12	DIAMETER COBBLE 2" COBBLE	MAINTAIN POSITIVE DRAINAGE 1/L-5.01, AWAY FROM ALL STRUCTURE REFER TO DETAIL 1 ON SHEET L-5.01		S.	
M-103	BENDA BOARD EDGER	BENDA BOARD EDGER	EPIC PLASTICS (OR AF EQUAL)	ASTICS.COM				OR LENGTH, EDGEF DUCT #: 100059387	6/L-5.00	INSTALL PER MANUFACTURER SPECIFICATION.		
M-104	LANDSCAPE BOULDERS	RIVER ROCK BOULDERS	PIONEER SAND & GRA LOCAL SUPPLIER (OR EQUAL)		OVED HTTPS://WWW.PIONEER   NATURAL		SIZE TO VARY, 50% 2` DIAMETER, 30% 3` DIAMETER, 20% 4` DIAMETER		<sup>'</sup> 2/L-5.01, 5/L-5.01	REFER TO PLAN FOR QUANTITIES, SEE DETAILS FOR INSTALL.		
M-105	GRILL STATION COUNTER TOP	SOKE	DEKTON OR APPROVE	D EQUAL HTTPS://WWW.NO.COM/	HTTPS://WWW.COSENTI NO.COM/ SOKE GRIP+ FINISH		2 CM THICK		7/L-5.01	INSTALL PER MANUFACTURER SPECIFICATIONS. REFER TO PLANS FOR LOCATION.	ER TO	
M-106	WEED CONTROL FABRIC	MIRAFI 140N	MIRAFI (OR APPROVEI	GEO.US/EN-US	AL)  HTTPS://WWW.TENCATE GEO.US/EN-US/PRODUC TS/NONWOVEN-GEOTE XTILES/MIRAFI-MSCAPE  N/A		REFER TO PLAN FOR SIZE AND DIMENSIONS		N/A	INSTALL BELOW LANDSCAPE MULCH IN ALL PLANTING BEDS	3	
M-107	POWDER COAT	BLACK FLAT POWDER COAT DESIGNER PERFORATED,	CARDINAL POWDER C APPROVED EQUAL	CARDINAL POWDER COAT OR APPROVED EQUAL  HTTP://www.c		CARDINAL E300-BK11**		SEE DETAILS FOR METAL TO BE POWDER COATED		REFER TO DETAILS FOR METAL TO BE POWDER COATED	L	
M-108	PERFORATED PANEL	SLOTTED MOIRE 2243, CARBO STEEL, COLD ROLLED, 22 GAUGE, 1/8"X3/4" ROUND-END SLOT, SIDE STAGGERED PAN	APPROVED EQUAL	DR HTTPS://WWW LS.COM/	W.MCNICHO PANELS TO BE POWDER COATED, SE POWDER COAT IN THI SCHEDULE		FRAMED AND TAUGHT, SEE PLANS FOR QUANTITY		Y 2/L-5.02	INSTALL PER MANFACTURER SPECIFICATION		
M-109	STONE VENEER	TO MATCH ARCHITECTURE	STONE VENEER	SIZE OF STON MATCH ARCH SEE DETAILS	ITECTURE, ARCHITE		EXTERIOR FII VENEER, REF	JNTERTOP & SPA NISH TO BE STONE FER TO POOL POOL AND SPA	E STONE REFER TO DETAIL			
PAVEN	IENT SCHEDULE				<u>'</u>				·			
CODE	DESCRIPTION		MANUFACTURER	COLOR / FINISH	SIZE / DIMENSIONS		DETAIL	NOTES				
P-101	ENHANCED CONCRETE PAVING	COLORED CONCRETE	COLORADO HARDSCAPES DR APPROVED EQUAL	SANDSCAPE FINISH,	REFER TO LANDSCA	APE PLANS	REFER TO CIV	'IL PLANS REFER 1	TO CIVIL FOR DE	EPTH AND INSTALLATION DETAILS	S	
P-102	CONCRETE FLATWORK	N/A	I/A	STANDARD GRAY, BROOM	REFER TO CIVIL PLA	ANS	REFER TO CIV	IL PLANS REFER 1		FOR DEPTH AND INSTALLATION		
P-103	POOL DECK PAVING	BASALITE PREMIER SMOOTH PAVERS	BASALITE CONCRETE PRODUCTS OR APPROVED EQUAL	TORINO	60 MM HEIGHT, SIZE RANDOM ASHLAR PA	E VARIES PER ATTERN	6/L-5.01			PLANS FOR PAVER AREA AND		
P-104	SANDSTONE STEPPER	SI ATE STONE	OCAL QUARRY / STONE SUPPLIER OR APPROVED QUAL	BUFF SANDSTONE	2` X 2` X 2"		4/L-5.01	REFER 1	TO LANDSCAPE PLANS FOR LOCATION AND LAYOU			
P-106	PAVER RESTRAINT RAIL	GATOR EDGE RIGID F	ALLIANCE DESIGNER PRODUCTS OR APPROVED EQUAL	STANDARD BLACK	1 PIECE = 8 LF		6/L-5.01	RESTRA NOT AD	REFER TO LANDSCAPE PLANS FOR PAVER AREA, PAV RESTRAINT RAIL TO BE USED TO LOCK IN PAVER AREA NOT ADJACENT TO CONCRETE SLAB, COPING, OR BUILDING, INSTALL PER MANUFACTURER SPECIFICATION			
POOL I	│ FINISH SCHEDULE							BUILDIN			N .	
CODE	DESCRIPTION	PRODUCT NAME	//ANUFACTURER	COLOR / FINISH	SIZE / DIMENSIONS	DETAIL	NOTES			Y NOTES	DETA.	
PD-101	POOL AND SPA PLASTER	IPOOLEINISH I	DIAMOND BRITE OR APPROVED EQUAL	COOL BLUE	N/A	REFER TO POOL SHEETS	REFER TO PO	OL SHEETS FOR PC	OOL   COD   N-10:	1 COBBLE SWALE	3/L-5.0	
PD-102	POOL AND SPA COPING	I BUCKERCE CUDING	IPT OR APPROVED EQUAL	SAGEBRUSH, QUARTZITIC SANDSTONE	14" X 48"	REFER TO POOL SHEETS	REFER TO PO	OL SHEETS FOR PC	FOR POOL N-103 POOL FENCE GATE  WEST OVER STRUCTUR		2/L-5.02 3/L-5.02	
PD-103	POOL AND SPA WATERLINE TILE	I 6" NEPTINE MOON I	IOBLE TILE OR APPROVED EQUAL	NVNM 636 TRITON	6" X 6"	REFER TO POOL SHEETS	REFER TO PO	OL SHEETS FOR PC	FOR POOL N-105 ENTRY DRIVE GREEN ROOF		4/L-5.02	
						0112210			N-10	6 EAST GREEN ROOF	5/L-5.0	

MIDNIGHT,

POWDER-COATED FINISH

BOBE FIRE & WATER

RADIUS SCUPPER

N-108 OUTDOOR KITCHEN

7/L-5.01

REFER TO INSTALL PER MANUFACTURER

SPECIFICATION. REFER TO POOL

CONTRACTOR FOR FURTHER DETAIL.

BH, TA, JS TA, JS, AM

PD-105 POOL SCUPPER

DECIDUOUS TREES BE RI 2 BETULA NIGRA RIVER BIRCH BS 8 PO TR 38 POPULUS TREMULOIDES QUAKING ASPEN BS 8  EVERGREEN TREES PI PU 11 PICEA PUNGENS COLORADO SPRUCE BS 8 PI 10 10 PICEA PUNGENS 'BABY BLUE EYES' BABY BLUE EYES COLORADO BLUE SPRUCE BS 9 PI P6 4 PICEA PUNGENS 'BABY BLUE EYES' BABY BLUE EYES COLORADO BLUE SPRUCE BS 9 PI PP 14 PICEA PUNGENS 'BABY BLUE EYES' BABY BLUE EYES COLORADO BLUE SPRUCE BS 9 PN AR 13 PINUS ARISTATA BRISTLECONE PINE BS 9 PS DO 14 PSEUDOTSUGA MENZIESII DOUGLAS FIR BS 9 PS DO 14 PSEUDOTSUGA MENZIESII DOUGLAS FIR BS 8 ORNAMENTAL TREES AC FL 2 ACER GINNALA 'FLAME' FLAME AMUR MAPLE BS 8 MA SS 6 MALUS X 'SPRING SNOW' SPRING SNOW CRAB APPLE BS 9 PO NM 9 POPULUS TREMULOIDES 'CLUMP FORM' QUAKING ASPEN BS 9 PU VI 12 PRUNUS VIRGINIANA 'SCHUBERT' SCHUBERT CHOKECHERRY BS 8  DECIDUOUS SHRUBS 2-4' SPREAD FA PA 6 FALLUGIA PARADOXA APACHE PLUME	& B 2 2 8 B 2 8 B 8 8 8 8 8 8 8 8 8 8 8 8	SIZE  2.5" CAL.  2.5" CAL.  10` HT.  6` HT.  6` HT.  6` HT.  8` HT.  6` HT.	POLLIN YES						
BE RI 2 BETULA NIGRA RIVER BIRCH B & PO TR 38 POPULUS TREMULOIDES QUAKING ASPEN B & EVERGREEN TREES  PI PU 11 PICEA PUNGENS COLORADO SPRUCE B & PI 10 10 PICEA PUNGENS 'BABY BLUE EYES' BABY BLUE EYES COLORADO BLUE SPRUCE B & PI P6 4 PICEA PUNGENS 'BABY BLUE EYES' BABY BLUE EYES COLORADO BLUE SPRUCE B & PI PP 14 PICEA PUNGENS 'BABY BLUE EYES' BABY BLUE EYES COLORADO BLUE SPRUCE B & PN AR 13 PINUS ARISTATA BRISTLECONE PINE B & PE DU 5 PSEUDOTSUGA MENZIESII DOUGLAS FIR B & PS DO 14 PSEUDOTSUGA MENZIESII DOUGLAS FIR B & CORNAMENTAL TREES  AC FL 2 ACER GINNALA 'FLAME' FLAME' FLAME AMUR MAPLE B & PO NM 9 POPULUS TREMULOIDES 'CLUMP FORM' QUAKING ASPEN B & PU VI 12 PRUNUS VIRGINIANA 'SCHUBERT' SCHUBERT CHOKECHERRY B & EDECIDUOUS SHRUBS 2-4' SPREAD FA PA 6 FALLUGIA PARADOXA APACHE PLUME	& B 2 2 8 8 8 8 8 8 8 8 8 8 8 8 8 8 8 8 8	2.5" CAL. 10` HT. 10` HT. 6` HT. 6` HT. 6` HT. 8` HT.	YES YES YES YES YES YES YES YES						
PO TR 38 POPULUS TREMULOIDES QUAKING ASPEN B 8  EVERGREEN TREES  PI PU 11 PICEA PUNGENS COLORADO SPRUCE B 8  PI 10 10 PICEA PUNGENS 'BABY BLUE EYES' BABY BLUE EYES COLORADO BLUE SPRUCE B 8  PI P6 4 PICEA PUNGENS 'BABY BLUE EYES' BABY BLUE EYES COLORADO BLUE SPRUCE B 8  PI PP 14 PICEA PUNGENS 'BABY BLUE EYES' BABY BLUE EYES COLORADO BLUE SPRUCE B 8  PN AR 13 PINUS ARISTATA BRISTLECONE PINE B 8  PE DU 5 PSEUDOTSUGA MENZIESII DOUGLAS FIR B 8  PS DO 14 PSEUDOTSUGA MENZIESII DOUGLAS FIR B 8  ORNAMENTAL TREES  AC FL 2 ACER GINNALA 'FLAME' FLAME BB 8  MA SS 6 MALUS X 'SPRING SNOW' SPRING SNOW CRAB APPLE B 8  PO NM 9 POPULUS TREMULOIDES 'CLUMP FORM' QUAKING ASPEN B 8  DECIDUOUS SHRUBS 2-4' SPREAD  FA PA 6 FALLUGIA PARADOXA APACHE PLUME CO	& B 2 2 8 8 8 8 8 8 8 8 8 8 8 8 8 8 8 8 8	2.5" CAL. 10` HT. 10` HT. 6` HT. 6` HT. 6` HT. 8` HT.	YES YES YES YES YES YES YES YES						
PI PU 11 PICEA PUNGENS COLORADO SPRUCE B 8 PI 10 10 PICEA PUNGENS 'BABY BLUE EYES' BABY BLUE EYES COLORADO BLUE SPRUCE B 8 PI P6 4 PICEA PUNGENS 'BABY BLUE EYES' BABY BLUE EYES COLORADO BLUE SPRUCE B 8 PI PP 14 PICEA PUNGENS 'BABY BLUE EYES' BABY BLUE EYES COLORADO BLUE SPRUCE B 8 PN AR 13 PINUS ARISTATA BRISTLECONE PINE B 8 PE DU 5 PSEUDOTSUGA MENZIESII DOUGLAS FIR B 8 PS DO 14 PSEUDOTSUGA MENZIESII DOUGLAS FIR B 8 PS DO 14 PSEUDOTSUGA MENZIESII DOUGLAS FIR B 8 PS DO 14 PSEUDOTSUGA MENZIESII DOUGLAS FIR B 8 PS DO NM 9 POPULUS TREMULOIDES 'CLUMP FORM' SPRING SNOW CRAB APPLE B 8 PO NM 9 POPULUS TREMULOIDES 'CLUMP FORM' QUAKING ASPEN B 8 PU VI 12 PRUNUS VIRGINIANA 'SCHUBERT' SCHUBERT CHOKECHERRY B 8 PA 6 FALLUGIA PARADOXA APACHE PLUME	& B 1 6 8 8 8 8 8 8 8 8 8 8 8 8 8 8 8 8 8 8	10` HT. 6` HT. 8` HT. 6` HT. 8` HT.	YES YES YES YES YES YES						
PI 10 10 PICEA PUNGENS 'BABY BLUE EYES' BABY BLUE EYES COLORADO BLUE SPRUCE B 8 PI P6 4 PICEA PUNGENS 'BABY BLUE EYES' BABY BLUE EYES COLORADO BLUE SPRUCE B 8 PI PP 14 PICEA PUNGENS 'BABY BLUE EYES' BABY BLUE EYES COLORADO BLUE SPRUCE B 8 PN AR 13 PINUS ARISTATA BRISTLECONE PINE B 8 PE DU 5 PSEUDOTSUGA MENZIESII DOUGLAS FIR B 8 PS DO 14 PSEUDOTSUGA MENZIESII DOUGLAS FIR B 8 PS DO 14 PSEUDOTSUGA MENZIESII DOUGLAS FIR B 8 PS DOUG	& B 1 6 8 8 8 8 8 8 8 8 8 8 8 8 8 8 8 8 8 8	10` HT. 6` HT. 8` HT. 6` HT. 8` HT.	YES YES YES YES YES YES						
PI PP 14 PICEA PUNGENS 'BABY BLUE EYES' BABY BLUE EYES COLORADO BLUE SPRUCE B 8 PN AR 13 PINUS ARISTATA BRISTLECONE PINE B 8 PE DU 5 PSEUDOTSUGA MENZIESII DOUGLAS FIR B 8 PS DO 14 PSEUDOTSUGA MENZIESII DOUGLAS FIR B 8 PS DO 14 PSEUDOTSUGA MENZIESII DOUGLAS FIR B 8 PS DO 14 PSEUDOTSUGA MENZIESII DOUGLAS FIR B 8 PS DO	& B 8 8 8 8 8 8 8 8 8 8 8 8 8 8 8 8 8 8	8` HT. 6` HT. 6` HT. 8` HT.	YES YES YES YES						
PN AR 13 PINUS ARISTATA BRISTLECONE PINE B 8 PE DU 5 PSEUDOTSUGA MENZIESII DOUGLAS FIR B 8 PS DO 14 PSEUDOTSUGA MENZIESII DOUGLAS FIR B 8  ORNAMENTAL TREES AC FL 2 ACER GINNALA 'FLAME' FLAME AMUR MAPLE B 8 MA SS 6 MALUS X 'SPRING SNOW' SPRING SNOW CRAB APPLE B 8 PO NM 9 POPULUS TREMULOIDES 'CLUMP FORM' QUAKING ASPEN B 8 PU VI 12 PRUNUS VIRGINIANA 'SCHUBERT' SCHUBERT CHOKECHERRY B 8  DECIDUOUS SHRUBS 2-4' SPREAD FA PA 6 FALLUGIA PARADOXA APACHE PLUME CO	& B 6 6 8 8 8 8 8 8 8 8 8 8 8 8 8 8 8 8 8	6` HT. 6` HT. 8` HT. 1.5" CAL.	YES YES YES						
PE DU 5 PSEUDOTSUGA MENZIESII DOUGLAS FIR B 8 8 PS DO 14 PSEUDOTSUGA MENZIESII DOUGLAS FIR B 8 8 PS DO 14 PSEUDOTSUGA MENZIESII DOUGLAS FIR B 8 8 PS DOUGLAS FIR B 8 PS DOUGLAS FIR B 8 8 PS DOUGLAS FIR B 8 8 PS DOUGLAS FIR B 8 PS DOUGLAS FIR B 8 8 PS DOUGLAS FIR	& B 6 8 8 8 8 8 8 8 8 8 8 8 8 8 8 8 8 8 8	6` HT. 8` HT. 1.5" CAL.	YES YES						
ORNAMENTAL TREES  AC FL 2 ACER GINNALA 'FLAME' FLAME AMUR MAPLE B & MA SS 6 MALUS X 'SPRING SNOW' SPRING SNOW CRAB APPLE B & PO NM 9 POPULUS TREMULOIDES 'CLUMP FORM' QUAKING ASPEN B & PU VI 12 PRUNUS VIRGINIANA 'SCHUBERT' SCHUBERT CHOKECHERRY B & DECIDUOUS SHRUBS 2-4` SPREAD FA PA 6 FALLUGIA PARADOXA APACHE PLUME CCC	&B 1 &B 6 &B 6 &B 2	1.5" CAL.	}						
AC FL 2 ACER GINNALA 'FLAME'  MA SS 6 MALUS X `SPRING SNOW`  PO NM 9 POPULUS TREMULOIDES 'CLUMP FORM'  PU VI 12 PRUNUS VIRGINIANA 'SCHUBERT'  DECIDUOUS SHRUBS 2-4` SPREAD FA PA 6 FALLUGIA PARADOXA	&B 6 &B 6 &B 2		\ \ \ \ \VES						
MA SS 6 MALUS X `SPRING SNOW` SPRING SNOW CRAB APPLE B 8 PO NM 9 POPULUS TREMULOIDES 'CLUMP FORM' QUAKING ASPEN B 8 PU VI 12 PRUNUS VIRGINIANA 'SCHUBERT' SCHUBERT CHOKECHERRY B 8  DECIDUOUS SHRUBS 2-4` SPREAD FA PA 6 FALLUGIA PARADOXA APACHE PLUME CO	&B 6 &B 6 &B 2		( VES						
PO NM 9 POPULUS TREMULOIDES 'CLUMP FORM' QUAKING ASPEN B 8 PU VI 12 PRUNUS VIRGINIANA 'SCHUBERT' SCHUBERT CHOKECHERRY B 8  DECIDUOUS SHRUBS 2-4` SPREAD FA PA 6 FALLUGIA PARADOXA APACHE PLUME CO	&B 6 &B 2	•	YES						
DECIDUOUS SHRUBS 2-4` SPREAD FA PA 6 FALLUGIA PARADOXA APACHE PLUME CO		6` HT.	YES						
FA PA 6 FALLUGIA PARADOXA APACHE PLUME CO		2.5" CAL.	YES						
	7 NIT 1	ЦГ	} { } }						
HO DU 6 HOLODISCUS DUMOSUS ROCK SPIREA CO		#5 #5	YES YES						
		<b>#</b> 5	YES						
DECIDUOUS SHRUBS 5-7` SPREAD			}						
		#5	YES						
		#5 #5	YES YES						
	-	#5 #5	YES						
RI AL 1 RIBES ALPINUM ALPINE CURRANT CC	ONT. #	<b>#</b> 5	YES						
		#5 #5	YES YES						
}									
DECIDUOUS SHRUBS 7-9` SPREAD  AM SE 3 AMELANCHIER ALNIFOLIA SERVICEBERRY CC	ONT. #	#5	{ { YES						
		#5 #5	YES						
		#5 #5	YES YES						
EVERGREEN SHRUBS									
AR UV 2 ARCTOSTAPHYLOS UVA-URSI KINNIKINNICK CC		#1	YES						
		#5 #5	YES YES						
	π	. <del>-</del>	}						
ORNAMENTAL GRASSES BO BL 90 BOUTELOUA GRACILIS 'BLONDE AMBITION' BLONDE AMBITION BLUE GRAMA CC	ONT. #	#1	YES						
CL KR 123 CALAMAGROSTIS X ACUTIFLORA 'KARL FOERSTER' KARL FOERSTER FEATHER REED GRASS CC	ONT. #	#1	YES						
		#1 #1	YES						
		#1 #1	YES YES						
		#1	YES						
PERENNIALS MACANGUINE			<b>}</b>						
		#1 #1	YES YES						
		#1 #1	YES						
AS AL 6 ASTER ALPINUS ALPINE ASTER CC	ONT. #	#1	YES						
		#1 #1	YES						
		#1 #1	YES NO						
HO SI 8 HOSTA SIEBOLDIANA 'ELEGANS' ELEGANS HOSTA CO	ONT. #	#1	NO						
		#1 #1	YES						
		#1 #1	YES YES						
PE HU 9 PENSTEMON DIGITALIS 'HUSKER RED' HUSKER RED PENSTEMON CC	ONT. #	#1	YES						
RD AM 23 RUDBECKIA AMPLEXICAULIS BLACK-EYED SUSAN CC	ONT. #	#1	YES						
TEMPORARY  IRRIGATED IRRIGATED ALL			NOTE:						
SHORT DRY GRASS SEED MIXTURE    INTUINING   INTUINING		,	{ MINIMU { MATER						
(83,135 SF = 71.9% TOTAL GROUNDCOVER)		Į	POLLIN AND O						
COMMONINAME 9/ OF TOTAL LIPS DED 1000 S E									
HARD FESCUE, VNS 30% 0.6 LBS.			WILDLII  IN SCHI						
CREEPING RED FESCUE, VNS 30% 0.6 LBS.			SUITAB						
SHEEP FESCUE, MEKLENBERGER 25% 0.5 LBS. CANADA BLUEGRASS, RUBENS 10% 0.2 LBS.			_						
CANBY BLUEGRASS, CANBAR 5% 0.1 LBS.									
TOTAL 100% 2.0 LBS.									
- SLOPES OVER 3:1 SHALL BE HAYED AND TACKIFIED OR NETTED - SPREAD SEED AT A RATE OF 2 LBS PER 1000 SF									
SODITYPE									
SOD TYPE  LIVE PERFORMANCE BLUE TURE ORACO COR EROM ORAFFIC TURE FARMS OR LOCAL APPROVER FOLIAL									
HY-PERFORMANCE BLUE TURF GRASS SOD FROM GRAFF'S TURF FARMS OR LOCAL APPROVED EQUAL  (2,625 SF = 2.3% TOTAL GROUNDCOVER)  (2)									
WILDFLOWER SEED									
ROCKY MOUNTAIN WILDFLOWER MIX BY ARKANSAS VALLEY SEED, 2LBS PER 1000 SF									
8,796 SF = 7.6% TOTAL GROUNDCOVER \(\frac{1}{2}\)									
SHRUB BED									
WASHINGTON CEDAR MULCH BY PIONEER SAND OR LOCAL APPROVED EQUAL, REFER TO MATERIAL SCHEDULE									
(21,025 SF = 18.2% TOTAL GROUNDCOVER) \(\triangle \)									

PEOPLE + PLACEMAKING 409 MAIN STREET SUITE 207 P.O. BOX 2320 FRISCO, CO 80443 P 970.368.7068 NORRIS-DESIGN.COM

POLLINATOR / WILDLIFE ENCOURAGEMENT

NOTE: PER THE CHART ABOVE, A MINIMUM OF 10 PERCENT OF PLANT

AND OVER 98 PERCENT OF PLANT SPECIES ENCOURAGE AND SUPPORT

IN SCHEDULE ARE NATIVE AND

POLLINATOR FRIENDLY PLANT SPECIES


WILDLIFE HABITAT. ALL PLANTS LISTED

SUITABLE FOR THE ALPINE CLIMATE.

MATERIAL IS COMPOSED OF

EAST WEST PARTNERS

1550 WEWATTA ST DENVER, CO 80202 CONTACT: RYAN STONE 303.319.6172

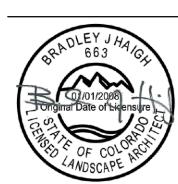

DATE: 03/15/2024 - IFC SET <u>2</u> 04/11/2024 - RFI 18 04/11/2024 - RFI 19

<u>06/13/2024 - RFI 85</u> <u>06/18/2024 - RFI 84</u>

> SHEET TITLE: LANDSCAPE

> SCHEDULES

L-1.01

BH, TA, JS TA, JS, AM




KEY MAP

409 MAIN STREET SUITE 207 P.O. BOX 2320 FRISCO, CO 80443 P 970.368.7068


NORRIS-DESIGN.COM


EAST WEST PARTNERS 1550 WEWATTA ST DENVER, CO 80202 CONTACT: RYAN STONE 303.319.6172

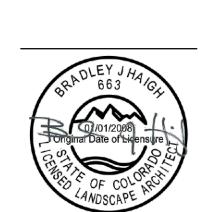



SHEET TITLE:
OVERALL
LANDSCAPE PLAN

L-1.02

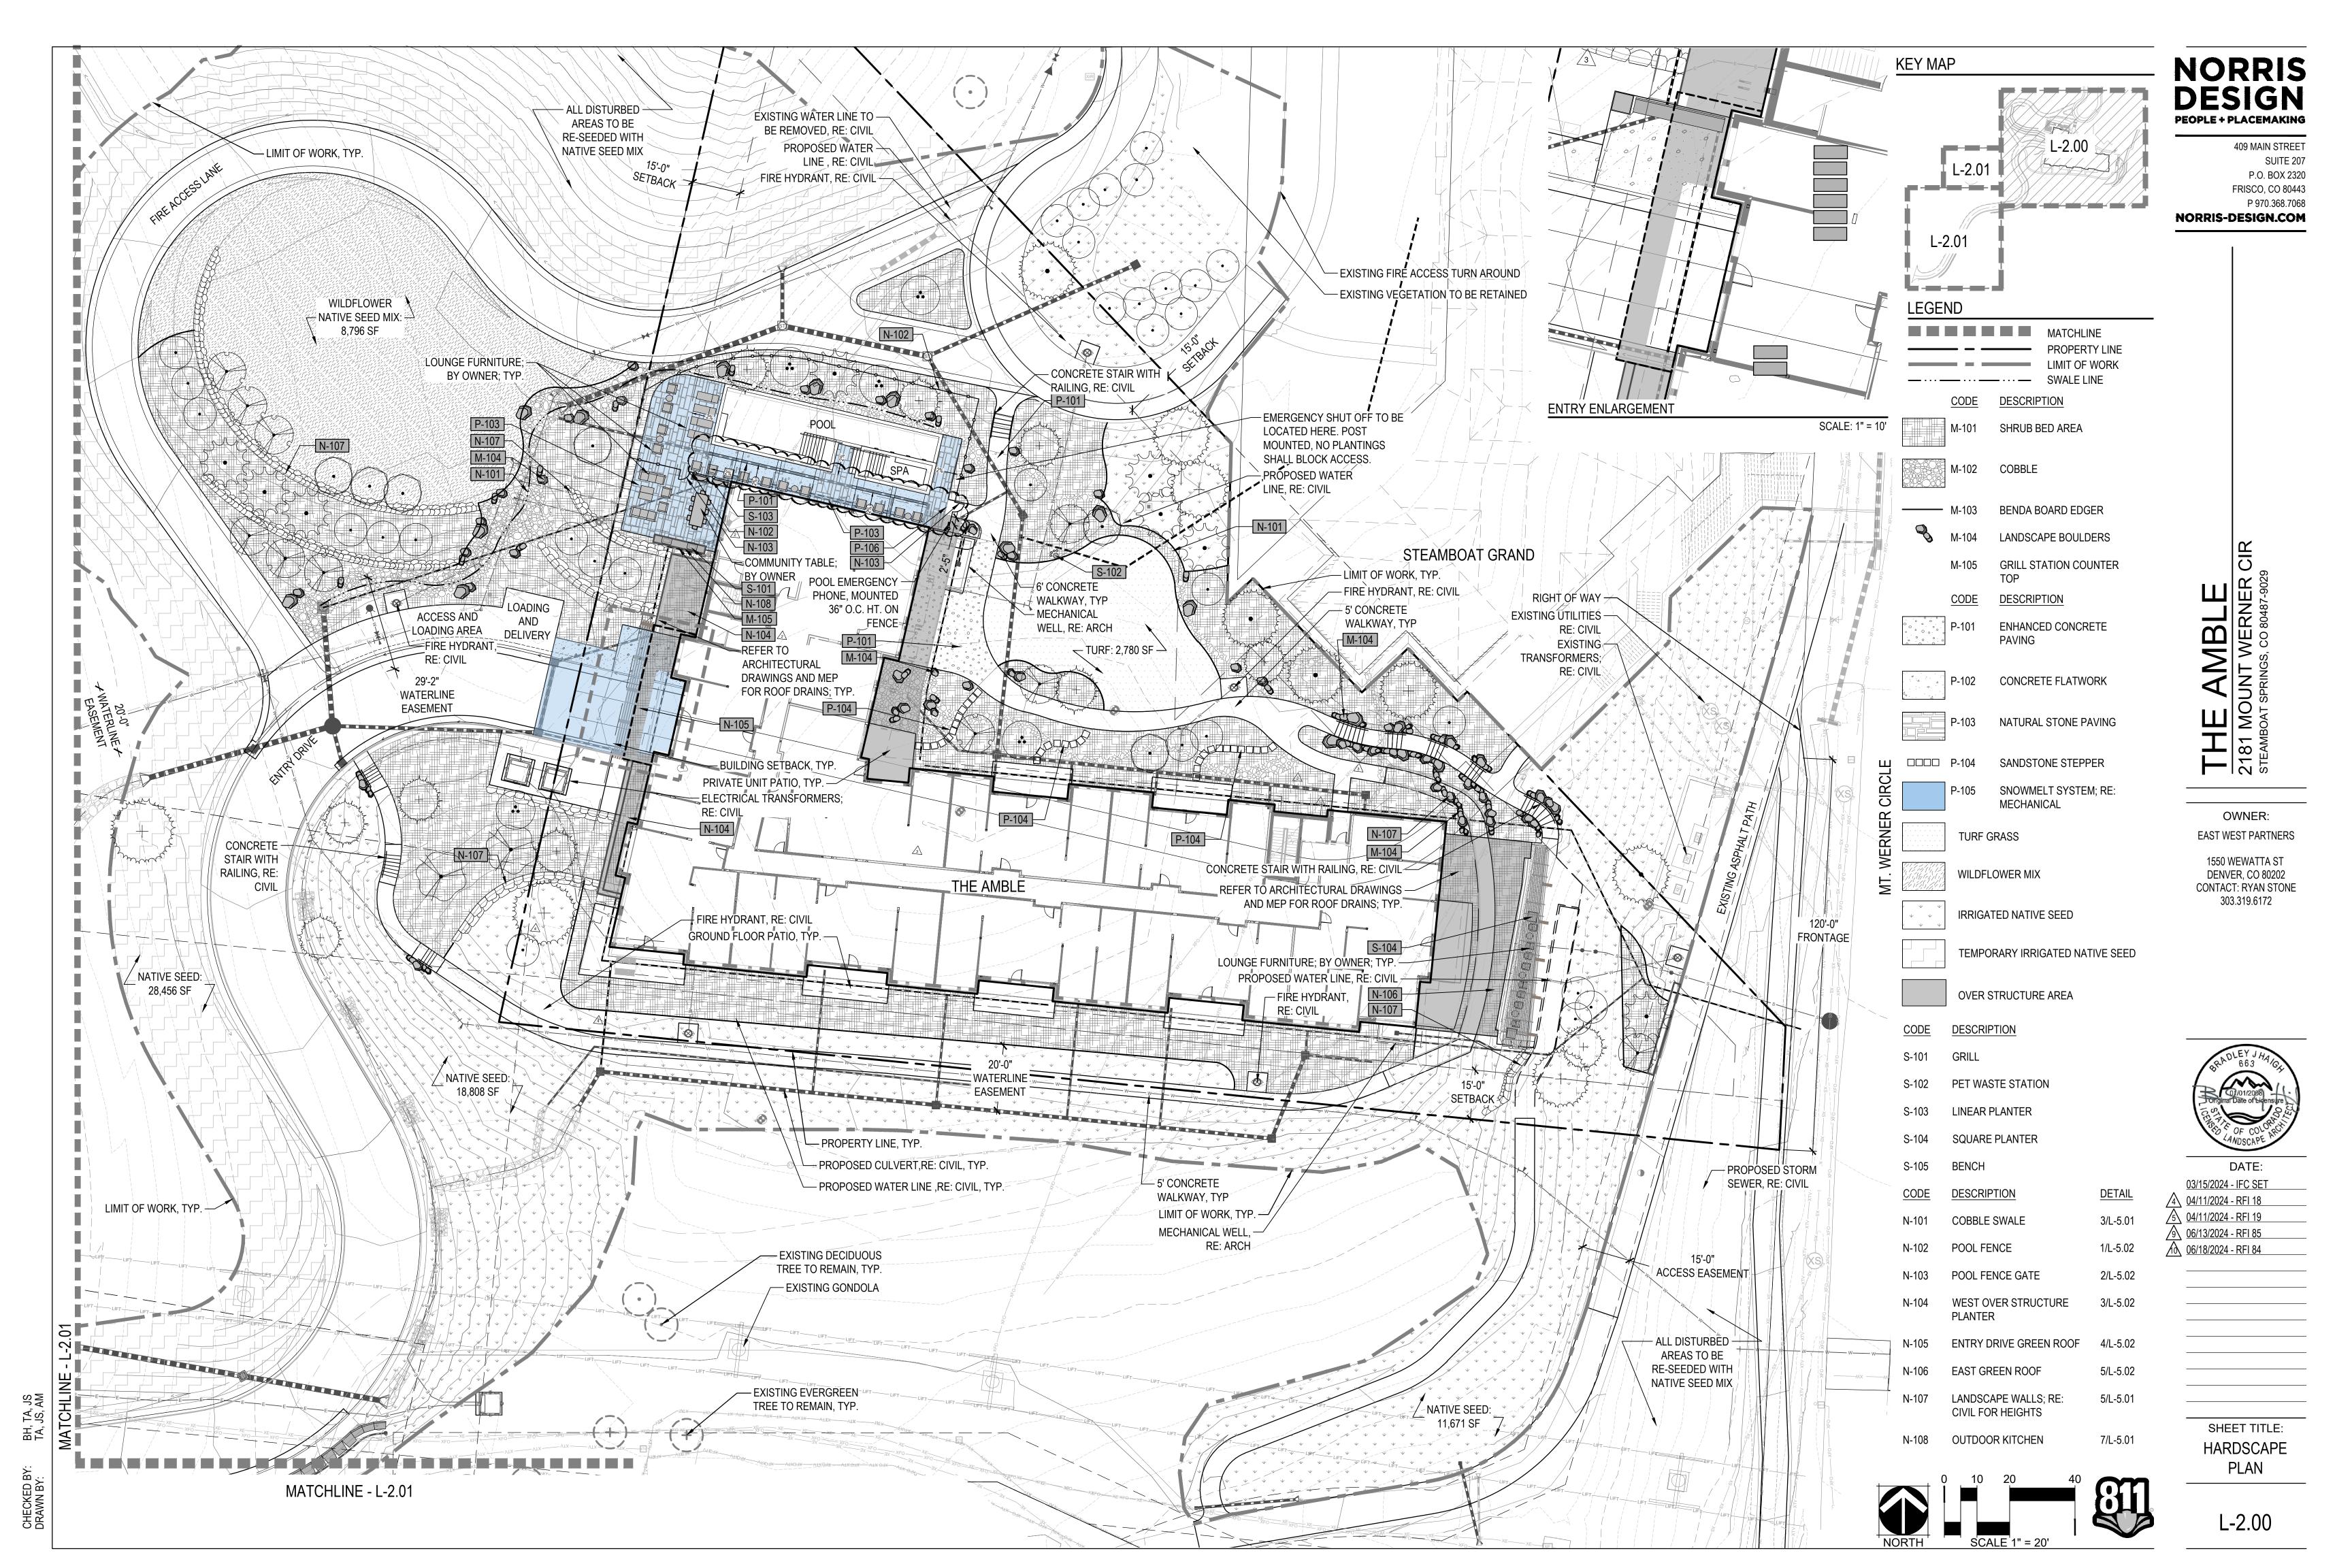

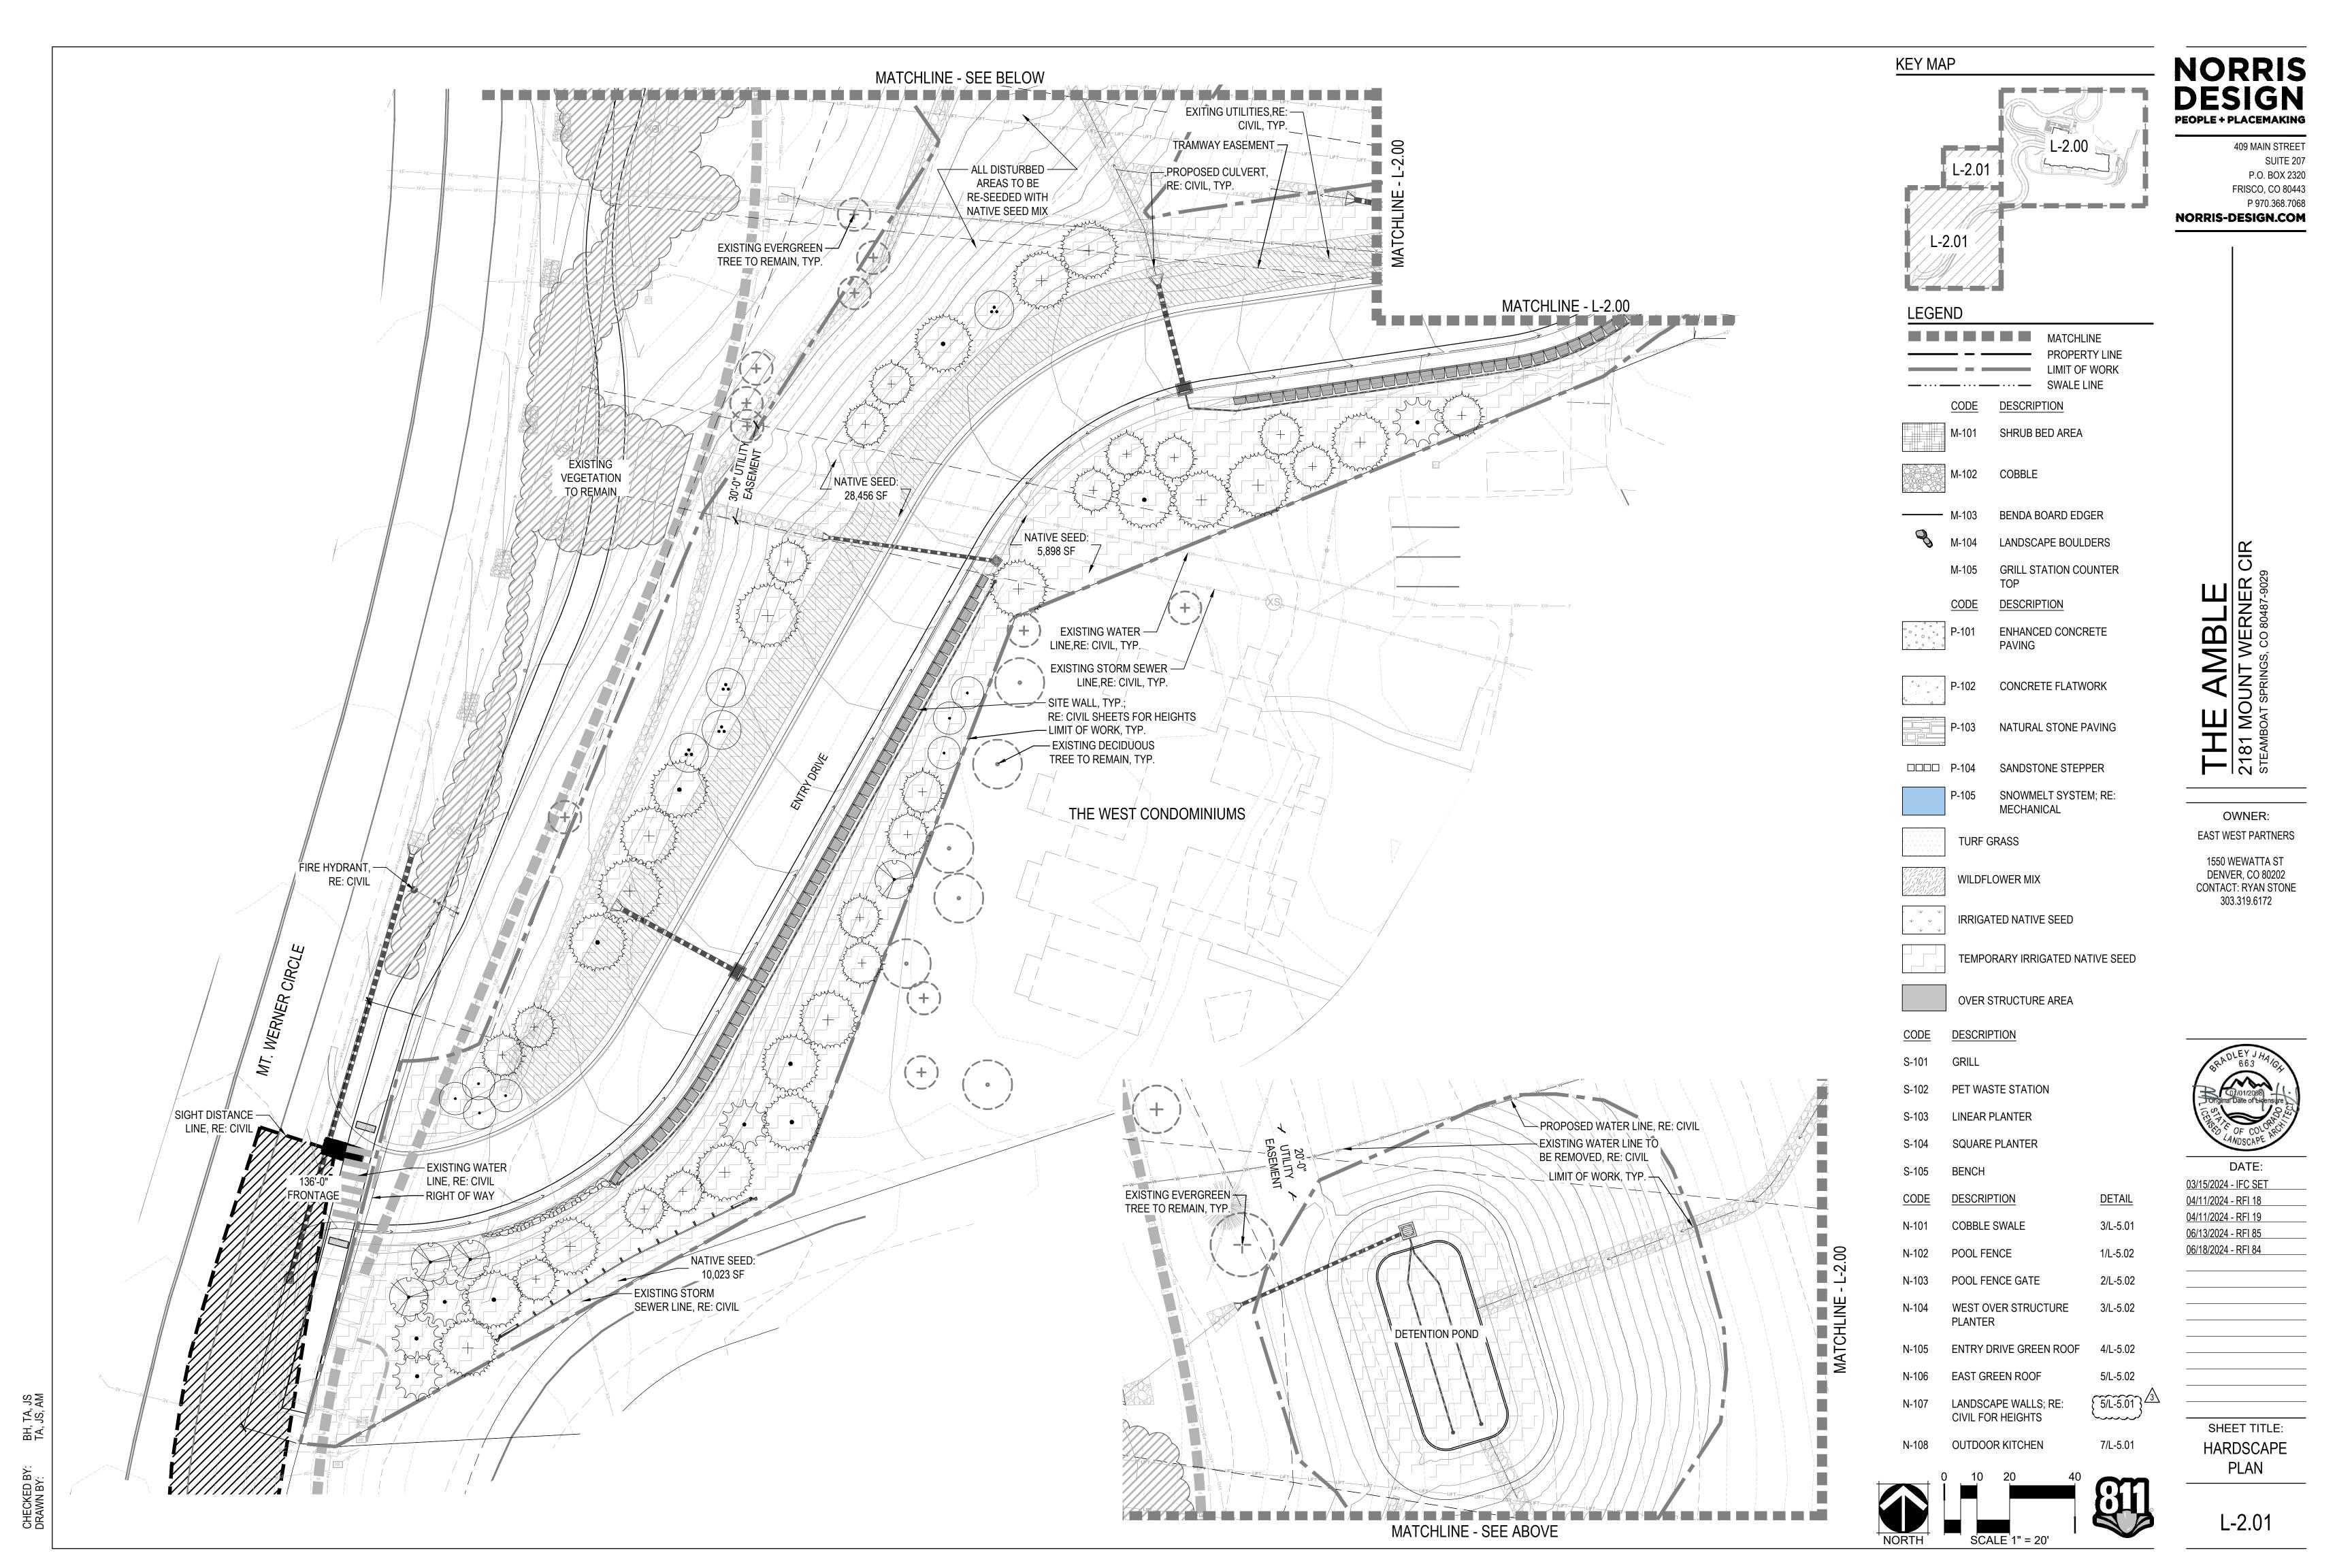

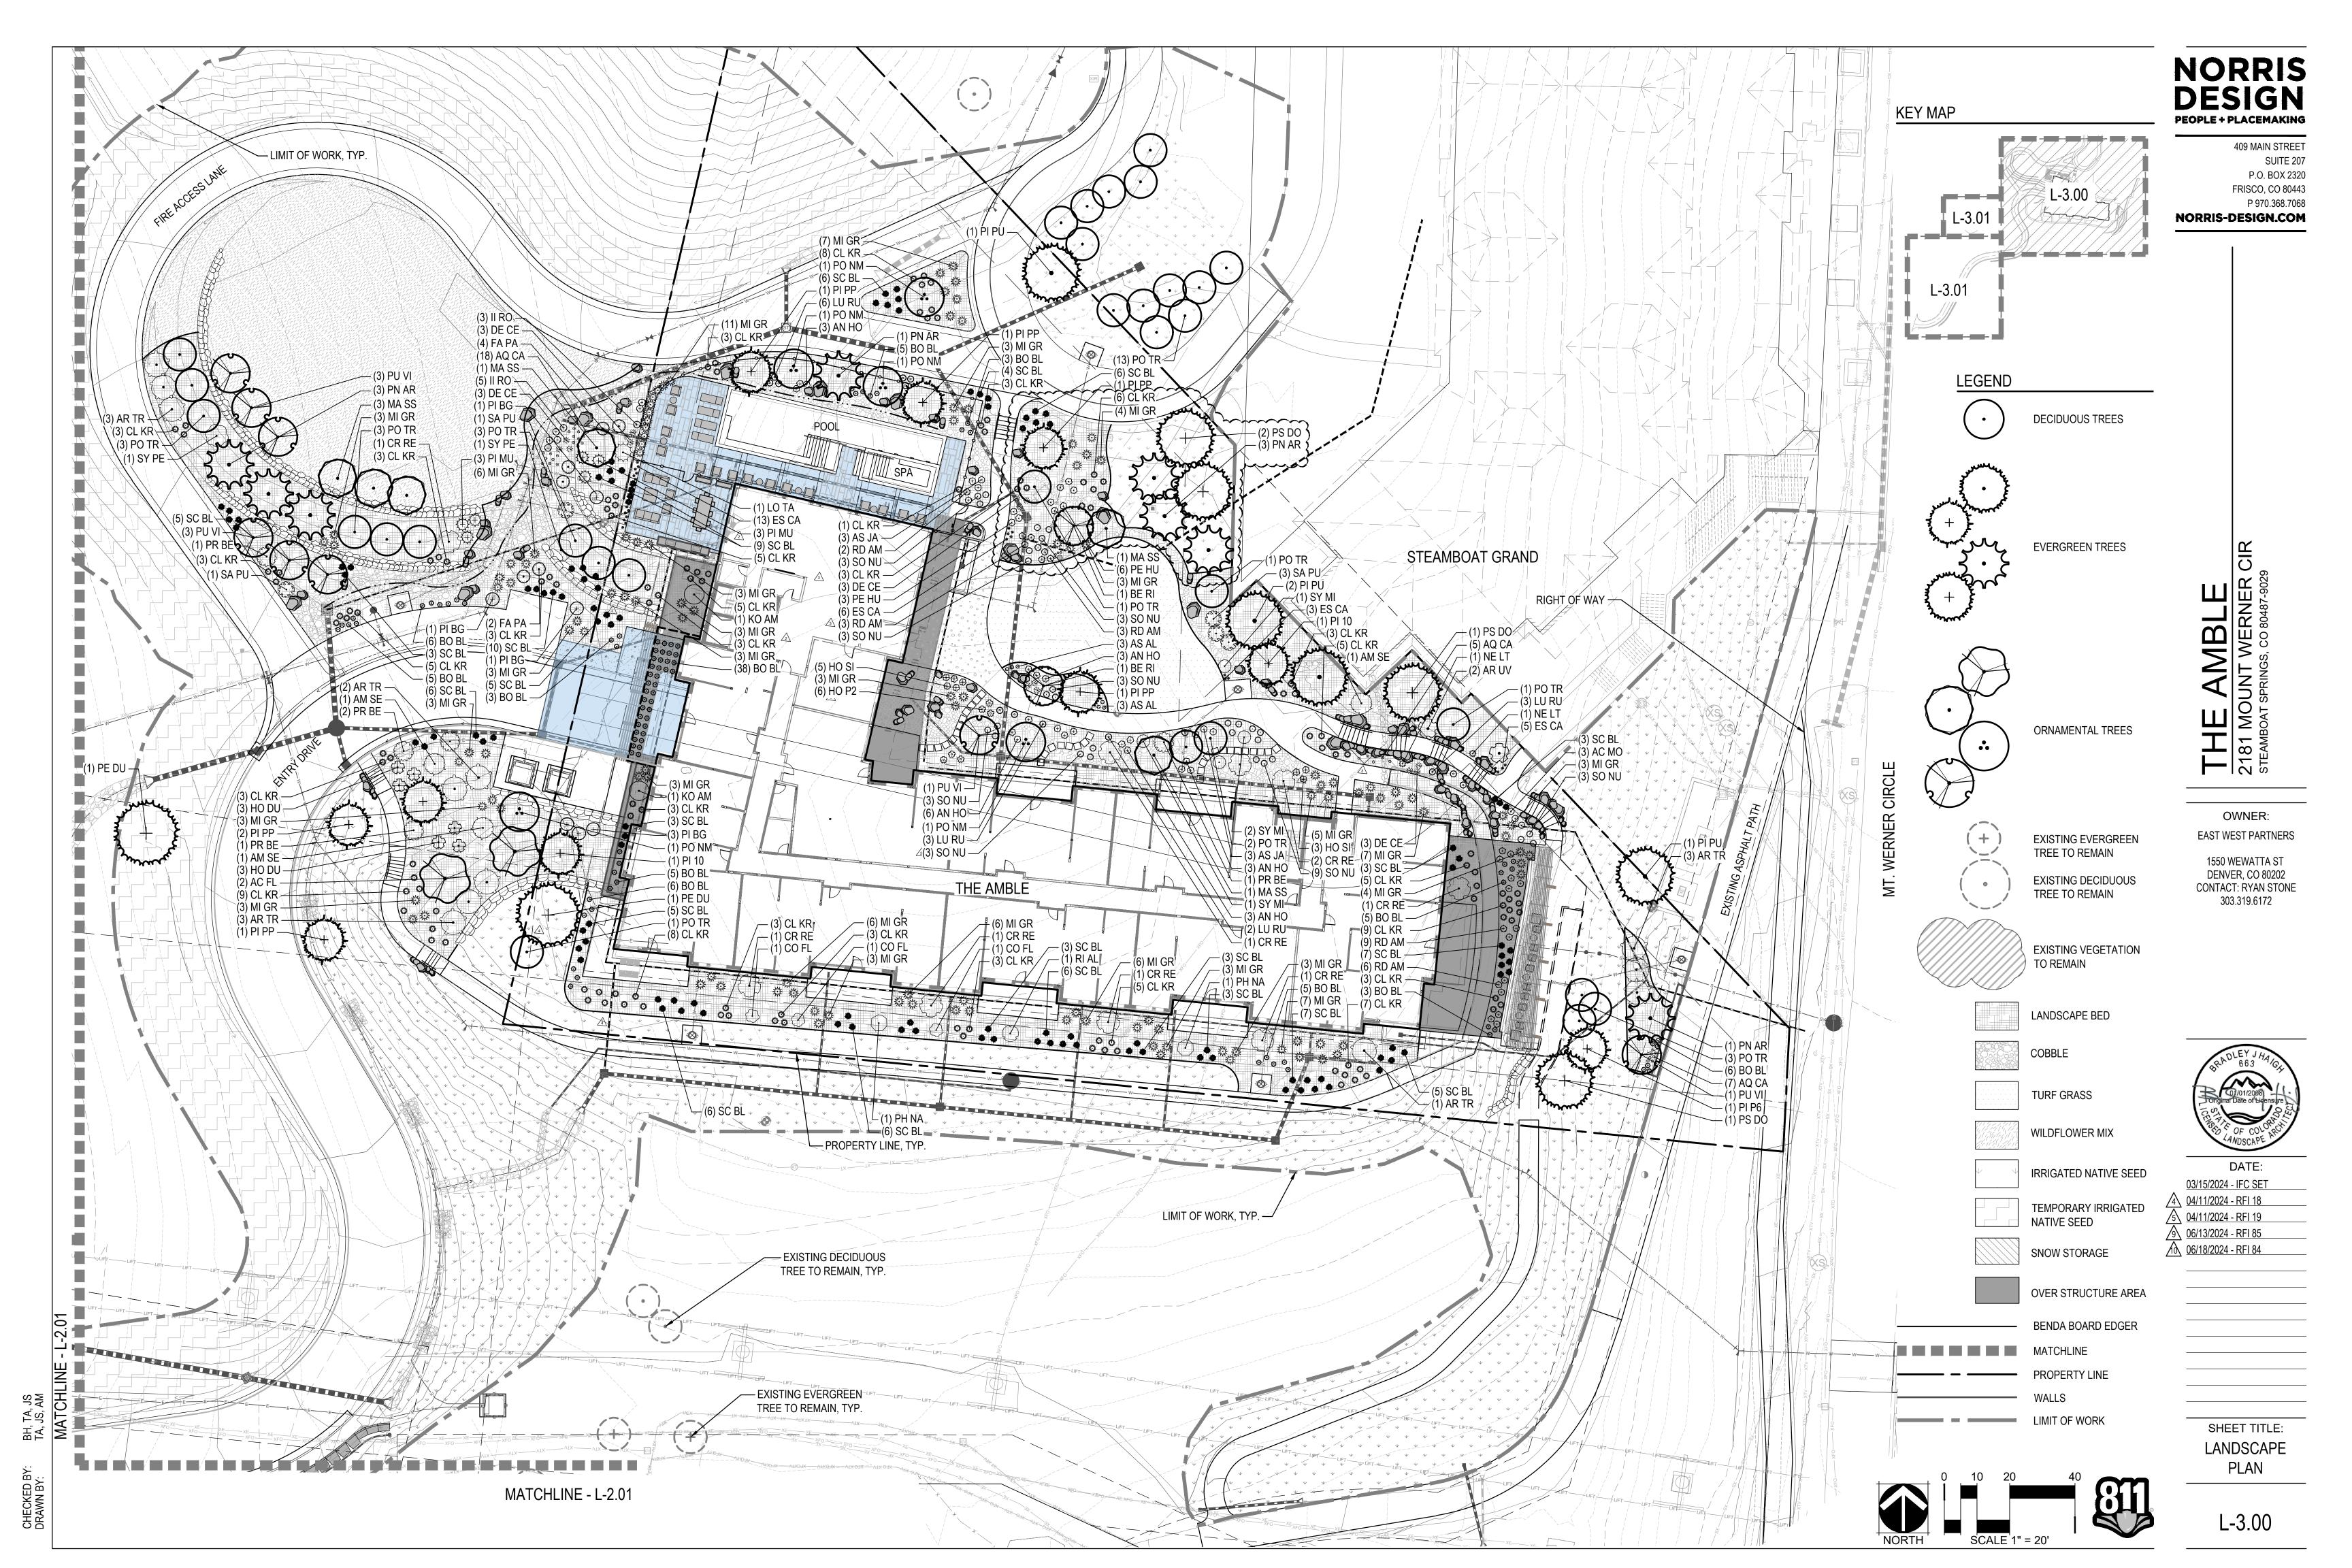

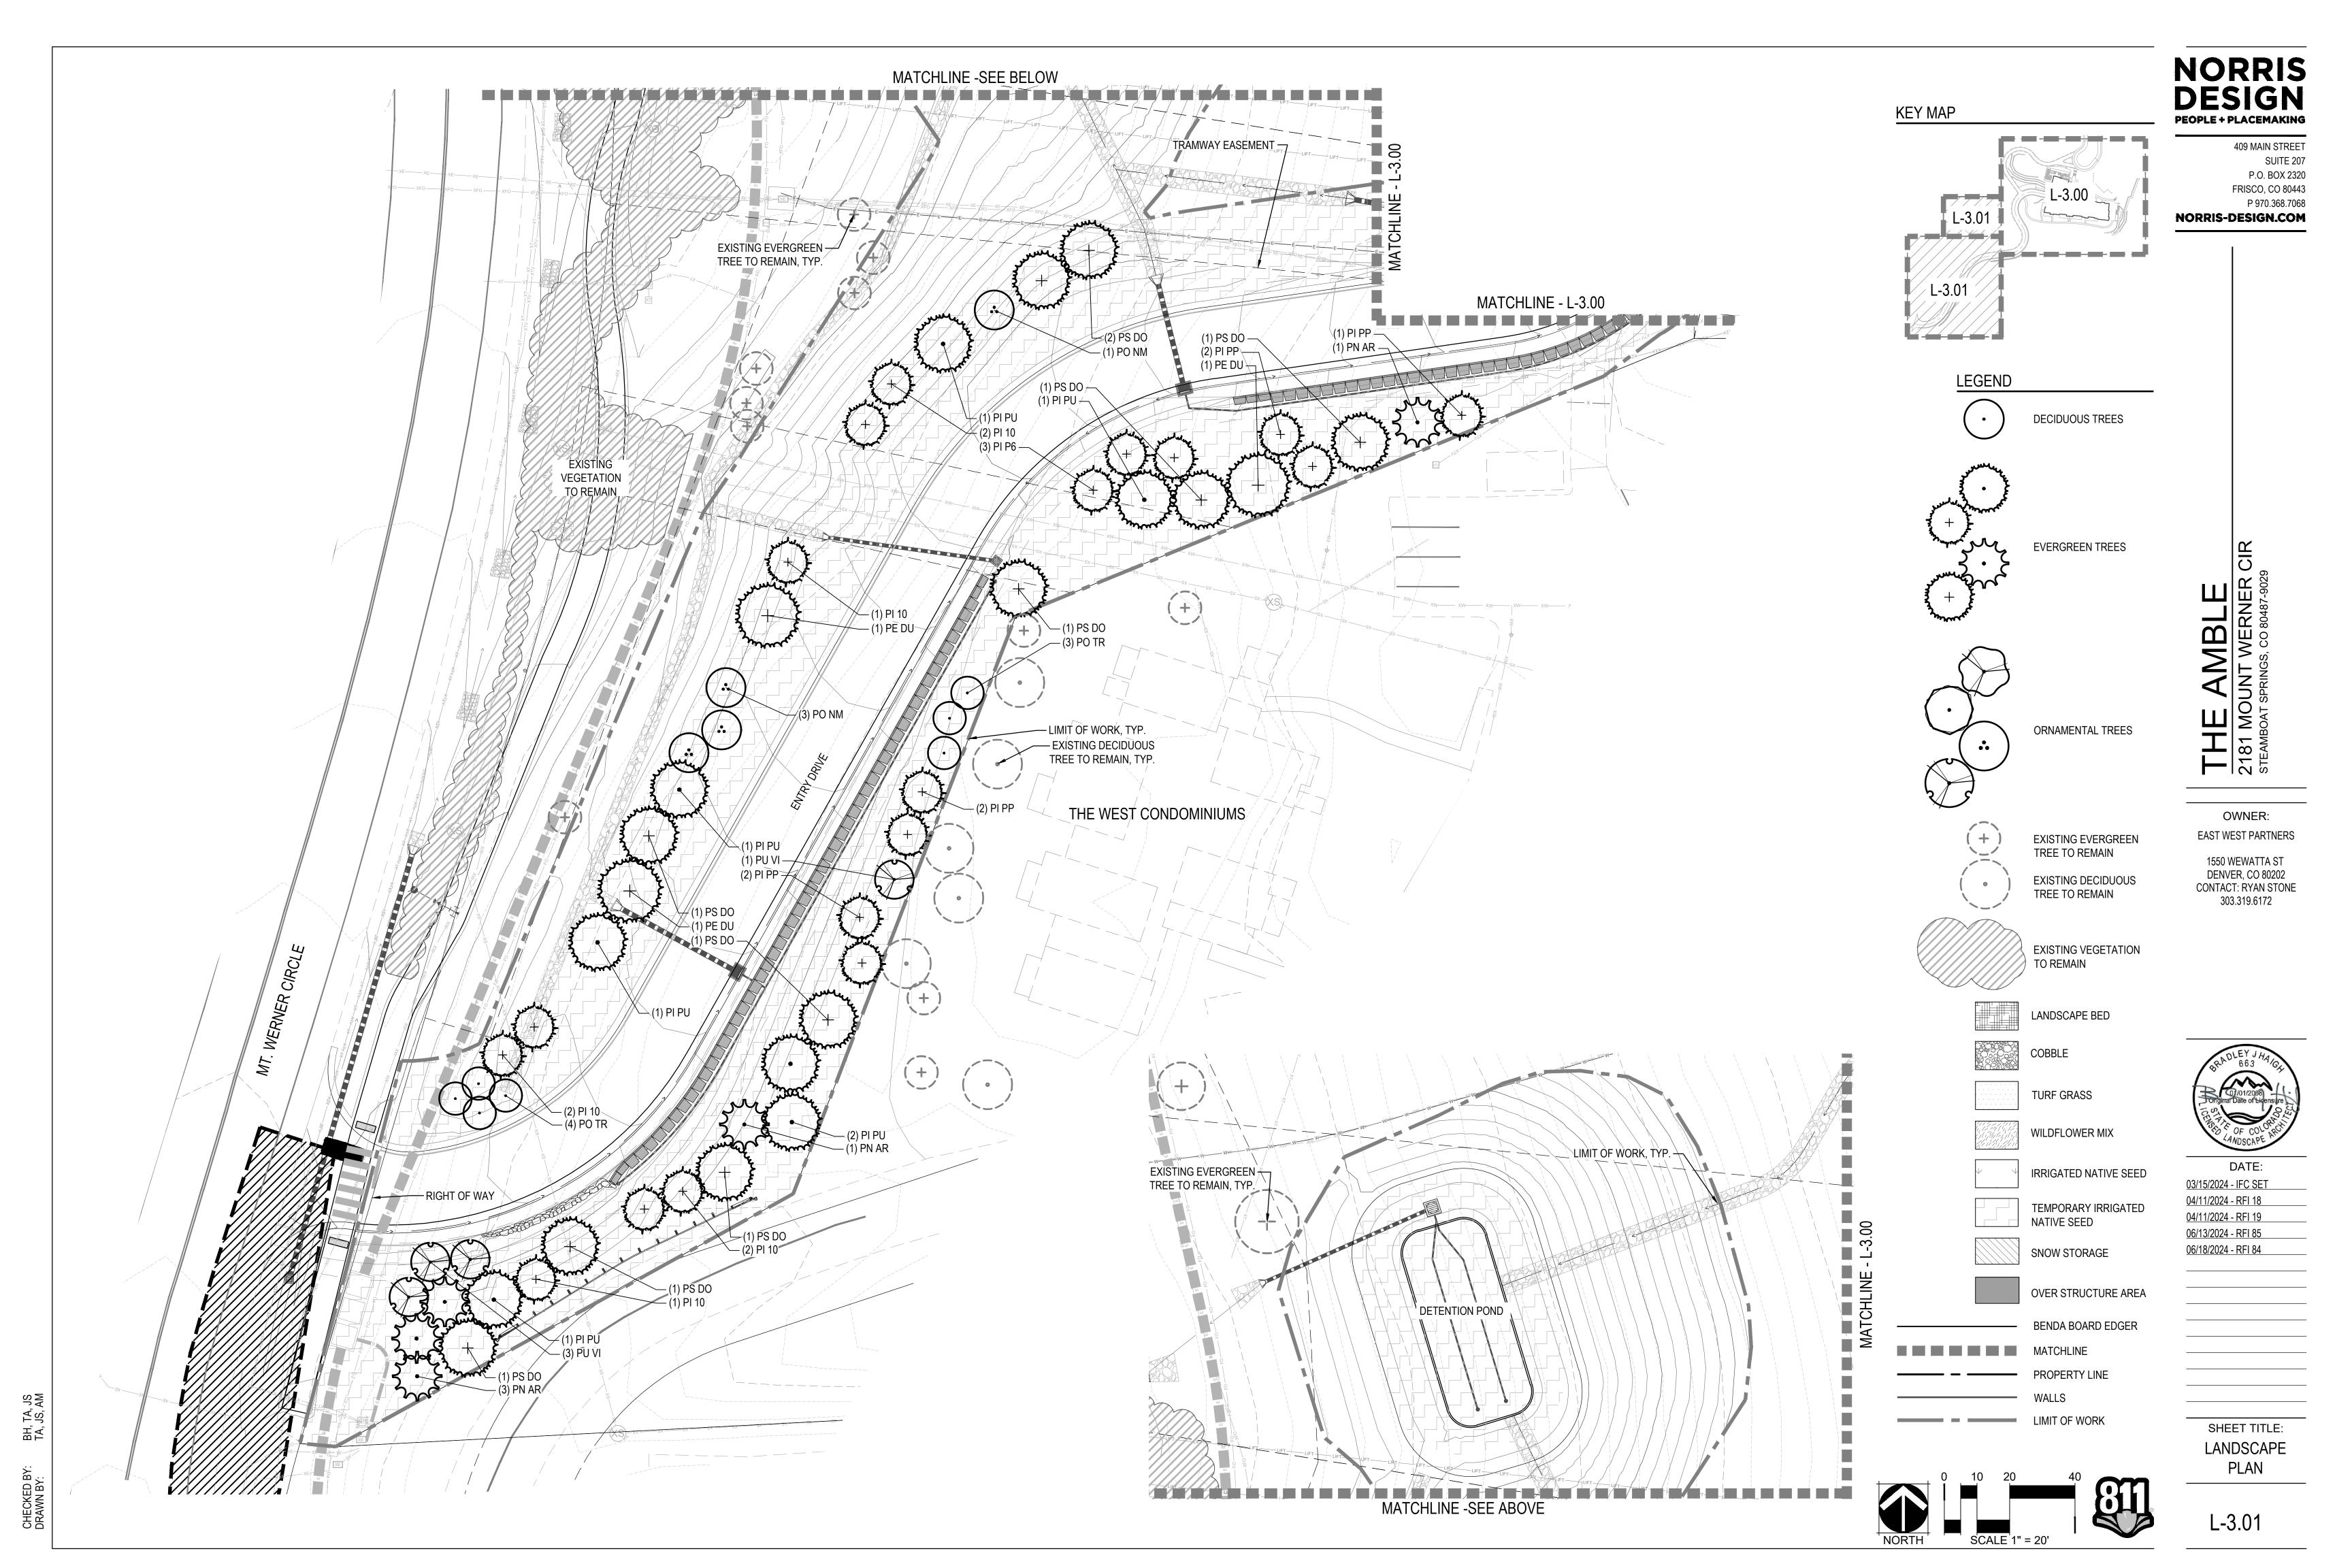

BH, TA, JS TA, JS, AM




SNOW STORAGE

409 MAIN STREET SUITE 207 P.O. BOX 2320 FRISCO, CO 80443 P 970.368.7068 NORRIS-DESIGN.COM

EAST WEST PARTNERS

1550 WEWATTA ST DENVER, CO 80202 CONTACT: RYAN STONE 303.319.6172

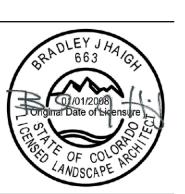

03/15/2024 - IFC SET 04/11/2024 - RFI 19 06/13/2024 - RFI 85 <u>06/18/2024 - RFI 84</u>

SHEET TITLE: SNOW STORAGE PLAN

L-4.00

BH, TA, JS TA, JS, AM

NORRIS DESIGN PEOPLE + PLACEMAKING

409 MAIN STREET SUITE 207

P 970.368.7068 WERNER CIR AND GONDOLA TRANSIT CENTER, NORRIS-DESIGN.COM

P.O. BOX 2320

FRISCO, CO 80443

DECK RAMP AND CONCRETE TRAIL 5'+ WIDTH,

PROPERTY LINE

NO STAIRS

ROUTE AROUND BUILDING, CONCRETE TRAIL 5'+ WIDTH


STAIR CONNECTION TO SKI LOCKER DECK,

CONCRETE TRAIL 5'+ WIDTH WITH STAIRS.

ADA COMPLIANT ROUTE CONNECTING TO MT

EAST WEST PARTNERS

1550 WEWATTA ST DENVER, CO 80202 CONTACT: RYAN STONE 303.319.6172

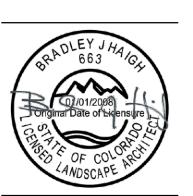

DATE: 03/15/2024 - IFC SET <u>04/11/2024 - RFI 18</u>

<u>04/11/2024 - RFI 19</u> <u>06/13/2024 - RFI 85</u> 06/18/2024 - RFI 84

> SHEET TITLE: TRAILS PLAN **EXHIBIT**

> > L-4.01

409 MAIN STREET

SUITE 207 P.O. BOX 2320

= 79.5% TOTAL GROUNDCOVER


= 18.2% TOTAL GROUNDCOVER

FRISCO, CO 80443

P 970.368.7068 = 2.3% TOTAL GROUNDCOVER NORRIS-DESIGN.COM

EAST WEST PARTNERS

1550 WEWATTA ST DENVER, CO 80202 CONTACT: RYAN STONE 303.319.6172

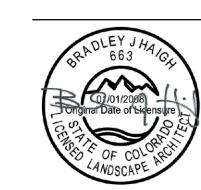

03/15/2024 - IFC SET 04/11/2024 - RFI 18 04/11/2024 - RFI 19 06/13/2024 - RFI 85 06/18/2024 - RFI 84

> SHEET TITLE: HYDROZONE PLAN EXHIBIT

ALL PRUNING SHALL COMPLY WITH ANSI A300 STANDARDS

DO NOT HEAVILY PRUNE TREE AT PLANTING. PRUNE ONLY CROSSOVER LIMBS, CO-DOMINANT LEADERS AND BROKEN BRANCHES. SOME INTERIOR TWIGS AND LATERAL BRANCHES MAY BE PRUNED. HOWEVER, DO NOT REMOVE THE TERMINAL BUDS OF BRANCHES THAT EXTEND TO THE EDGE OF THE CROWN.

STAKING NOTES:

STAKING NOTES:

STAKE TREES PER DIAGRAM. AFTER A MINIMUM OF (3) THREE YEARS CONFIRM TREE IS ESTABLISHED. CHECK FOR ROOTBALL STABILITY. APPLY HAND PRESSURE TO TRUNK OF TREE, WHEN ROOTBALL DOES NOT MOVE, REMOVE STAKING.

a. 2" CALIPER SIZE AND UNDER DECIDUOUS AND ASPEN TREES - MINIMUM 2 STAKES - ONE ON N.W. SIDE, ONE ON S.W. SIDE (OR PREVAILING WIND SIDE AND 180° FROM THAT SIDE).

EXCAVATE PLANTING HOLES WITH SLOPING SIDES. MAKE EXCAVATIONS AT LEAST THREE TIMES AS WIDE AS THE ROOT

BALL DIAMETER AND LESS THAN THE DISTANCE FROM THE TOP MOST ROOT AND THE BOTTOM OF THE ROOT BALL. THE

PLANTING AREA SHALL BE LOOSENED AND AERATED AT LEAST THREE TO FIVE TIMES THE DIAMETER OF THE ROOT BALL

TREES SHALL BE PLANTED WITH THE TOP MOST ROOT IN THE ROOT BALL 3" TO 5" HIGHER THAN THE FINISHED LANDSCAPE

DO NOT HEAVILY PRUNE TREE AT PLANTING. PRUNE ONLY CROSSOVER LIMBS, CO-DOMINANT LEADERS AND BROKEN

BRANCHES. SOME INTERIOR TWIGS AND LATERAL BRANCHES MAY BE PRUNED. HOWEVER, DO NOT REMOVE THE

STAKE TREES PER DIAGRAM. AFTER A MINIMUM OF (3) THREE YEARS CONFIRM TREE IS ESTABLISHED. CHECK FOR

ROOTBALL STABILITY. APPLY HAND PRESSURE TO TRUNK OF TREE, WHEN ROOTBALL DOES NOT MOVE, REMOVE STAKING.

a. 2" CALIPER SIZE AND UNDER DECIDUOUS AND ASPEN TREES - MINIMUM 2 STAKES - ONE ON N.W. SIDE, ONE ON S.W.

2. WIRE OR CABLE SHALL BE MINIMUM 12 GAUGE, TIGHTEN WIRE OR CABLE ONLY ENOUGH TO KEEP FROM SLIPPING. ALLOW

FOR SOME TRUNK MOVEMENT. NYLON STRAPS SHALL BE LONG ENOUGH TO ACCOMMODATE 1-1/2" OF GROWTH AND

TREES TO BE PROTECTED AND PRESERVED SHALL BE IDENTIFIED ON THE TRUNK WITH WHITE SURVEY TAPE.

PLACED OR STORED WITHIN THE DRIP LINE OR WITHIN 15 FEET OF A TREE TRUNK, WHICHEVER IS GREATER.

4. FENCING MATERIAL SHALL BE BRIGHT, CONTRASTING COLOR, DURABLE, AND A MINIMUM OF FOUR FEET IN HEIGHT.

MAINTAINED IN AN UPRIGHT POSITION THROUGHOUT THE DURATION OF CONSTRUCTION ACTIVITIES.

2. TO PREVENT ROOT SMOTHERING, SOIL STOCKPILES, SUPPLIES, EQUIPMENT OR ANY OTHER MATERIAL SHALL NOT BE

FENCING MATERIAL SHALL BE SET AT THE DRIP LINE OR 15 FEET FROM TREE TRUNK, WHICHEVER IS GREATER, AND

WHEN ROOT CUTTING IS UNAVOIDABLE, A CLEAN SHARP CUT SHALL BE MADE TO AVOID SHREDDING OR SMASHING.

ROOT CUTS SHOULD BE MADE BACK TO A LATERAL ROOT. ROOTS SHALL BE CUT NO MORE THAN 1/3 OF THE RADIUS

FROM DRIPLINE TO TRUNK. WHENEVER POSSIBLE, ROOTS SHOULD BE CUT BETWEEN LATE FALL AND BUD OPENING.

COVERED IMMEDIATELY TO PREVENT DEHYDRATION. ROOTS SHALL BE COVERED WITH SOIL OR BURLAP AND KEPT

MOIST.WATERING OF PROTECTED TREES IN WHICH ROOTS WERE CUT SHALL BE PROVIDED BY THE CONTRACTOR.

ROOT CUTS SHOULD BE MADE BACK TO A LATERAL ROOT. WHENEVER POSSIBLE, ROOTS SHOULD BE CUT BETWEEN

LATE FALL AND BUD OPENING, DURING DORMANCY PERIOD. EXPOSED ROOTS SHALL BE COVERED IMMEDIATELY TO

SHOULD BE AVOIDED FOR EXISTING TREES TO REMAIN. RETAINING WALLS AND TREE WELLS ARE ACCEPTABLE ONLY

7. WHEN ROOT CUTTING IS UNAVOIDABLE, A CLEAN SHARP CUT SHALL BE MADE TO AVOID SHREDDING OR SMASHING.

PREVENT DEHYDRATION. ROOTS SHALL BE COVERED WITH SOIL OR BURLAP AND KEPT MOIST.WATERING OF

8. ANY GRADE CHANGES (SUCH AS THE REMOVAL OF TOPSOIL OR ADDITION OF FILL MATERIAL) WITHIN THE DRIP LINE

PROTECTED TREES IN WHICH ROOTS WERE CUT SHALL BE PROVIDED BY THE CONTRACTOR.

DURING DORMANCY PERIOD. ROOT STIMULATOR SHALL BE APPLIED TO CUT ROOTS. EXPOSED ROOTS SHALL BE

USE GUY ASSEMBLIES FOR EVERGREENS AND TREES OVER 3" CALIPER. ALL WIRE TO BE MINIMUM 12 GAUGE GALVANIZED.

3. FORM SOIL INTO A 3" TO 5" TALL WATERING RING (SAUCER) AROUND PLANTING AREA. THIS IS NOT NECESSARY IN

IRRIGATED TURF AREAS. APPLY 3" TO 4" DEPTH OF SPECIFIED MULCH INSIDE WATERING RING.

b. EVERGREEN TREES - 3 STAKES PER DIAGRAM. c. 3" CALIPER SIZE AND LARGER - 3 STAKES PER DIAGRAM.

REFERENCE TREE PLANTING DETAIL FOR BACKFILL NOTES.

ALL PRUNING SHALL COMPLY WITH ANSI A300 STANDARDS

b. EVERGREEN TREES - 3 STAKES PER DIAGRAM.

ADJUST STAKING, STRAPS AND GUY WIRES ANNUALLY.

TREE PLANTING ON SLOPE

GROUPING OF MORE THAN ONE TREE MAY OCCUR.

WHEN CONSTRUCTED PRIOR TO GRADE CHANGE.

TREE PROTECTION

TREE ROOTS SHALL NOT BE CUT UNLESS CUTTING IS UNAVOIDABLE.

BUFFER ALL BRANCHES FROM WIRE.

c. 3" CALIPER SIZE AND LARGER - 3 STAKES PER DIAGRAM.

WIRE OR CABLE SHALL BE MINIMUM 12 GAUGE, TIGHTEN WIRE OR CABLE ONLY ENOUGH TO KEEP FROM SLIPPING. ALLOW FOR SOME TRUNK MOVEMENT. NYLON STRAPS SHALL BE LONG ENOUGH TO ACCOMMODATE 1-1/2" OF GROWTH AND BUFFER ALL BRANCHES FROM WIRE

ADJUST STAKING, STRAPS AND GUY WIRES ANNUALLY.


TREATED WOOD POST PREFERRED. METAL T STAKES WITH PLASTIC SAFETY CAPS ACCEPTABLE WITH APPROVAL FROM OWNER

GRADE. TREES WHERE THE TRUNK FLARE IS NOT VISIBLE SHALL BE REJECTED.

TERMINAL BUDS OF BRANCHES THAT EXTEND TO THE EDGE OF THE CROWN.

SIDE (OR PREVAILING WIND SIDE AND 180° FROM THAT SIDE).

TREE PLANTING DETAIL

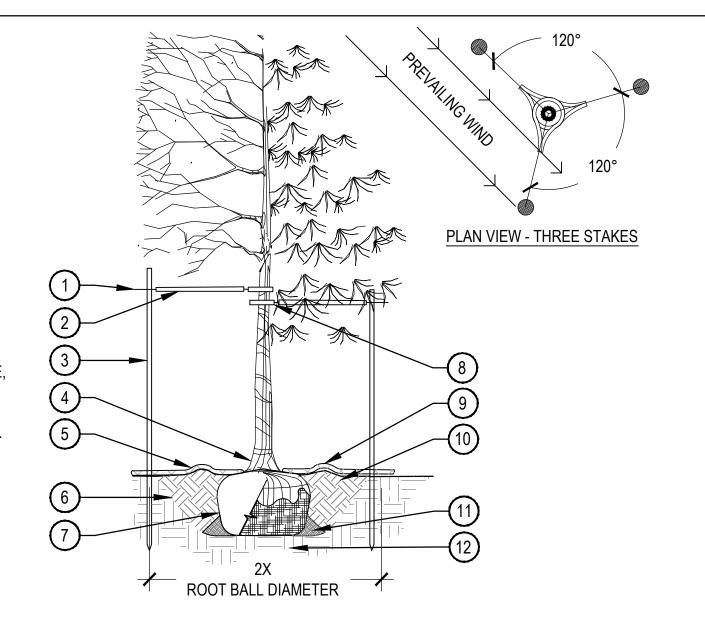

SLOPE SIDED PLANTING AREA

SHALL BE LOOSENED AND

**AERATED MINIMUM 3 TIMES THE** 

DIAMETER OF ROOT BALL

ROOT PROTECTION ZONE

VARIES PER TREE SIZE

EXTENDS FROM DRIPLINE TO DRIPLINE

(1) GALVANIZED WIRE 2) PLACE MINIMUM 1/2" PVC PIPE AROUND EACH WIRE, **EXPOSED WIRE SHALL BE** 

MAXIMUM 2" EACH SIDE (3) INSTALL STAKING PER SPECIFICATIONS

(4) PLANT TREE SO THAT FIRST ORDER MAJOR ROOT IS 1"-2" ABOVE FINAL GRADE

(5) 2'-0" RADIUS MULCH RING, VENTERED ON TRUNK, 3" DEPTH, ON TOP OF WEED FABRIC, DO NOT PLACE MULCH IN CONTACT WITH TREE TRUNK, FINISHED GRADE REFERENCES TOP OF MULCH

(6) 1:1 SLOPE ON SIDES OF PLANTING HOLE

(7) REMOVE ALL TWINE, ROPE, BURLAP AND WIRE FROM THE ENTIRE ROOTBALL AND TRUNK

(1) GROMMETED NYLON STRAP

(3) TOP MOST ROOT IN ROOTBALL

(4) 2-4" OF ORGANIC MULCH

REFER TO MATERIAL

TOP OF MULCH

1"-2" ABOVE EXISTING GRADE,

APPLIED OVER PLANTING AREA

AND AWAY FROM THE TRUNK,

FINISHED GRADE REFERENCES

PLANT MIX SHALL CONSIST OF

COMPOST, EXCAVATED SOIL,

SCHEDULE, SHEET L-1.01,

(5) BACKFILL WITH PLANT MIX,

**EQUAL PARTS TOPSOIL** 

SPECIFICATIONS, WATER

PLUS MYCORRHIZAL

THOROUGHLY WHEN

(6) REMOVE ALL TWINE, ROPE,

BURLAP AND WIRE FROM

ENTIRE ROOTBALL AND TRUNK

KEEP OUT

TREE PROTECTION

AREA

SIGN

**INOCULANT PER** 

BACKFILLING

(2) GALVANIZED WIRE

**UPHILL SIDE** 

(8) GROMMETED NYLON STRAPS

(9) 4-6" HIGH WATER SAUCER IN NON-TURF AREAS

(10) BACKFILL AROUND ROOTBALL WITH PLANT MIX, PLANT MIX SHALL CONSIST OF EQUAL PARTS TOPSOIL, COMPOST EXCAVATED SOIL, PLUS MYCORRHIZAL INOCULANT PER **SPECIFICATIONS** 

(11) PLACE SOIL AROUND ROOT BALL FIRMLY, DO NOT COMPACT OR TAMP, SETTLE SOIL WITH WATER TO FILL ALL AIR POCKETS

(12) PLACE ROOT BALL ON UNDISTURBED SOIL TO PREVENT SETTLEMENT

(7) PLACE ROOTBALL ON

UNDISTURBED SOIL TO

PREVENT SETTLEMENT, IF SOIL

HAS BEEN IMPORTED, PROVIDE

MODERATE FOOT PACKING OF

SCALE: 3/16" = 1'-0"

OF LIMBS. SHRUB PLANTING

FROM ITS CONTAINER.

HIGHER THAN FINISH GRADE (2) FINISH GRADE (TOP OF

(1) SET SHRUB ROOT-BALL 1"

(3) SPECIFIED MULCH, REFER TO MATERIAL SCHEDULE SHEET

L-1.01 4 TILL IN SPECIFIED SOIL

AMENDMENT TO A DEPTH OF

8" IN BED (5) BACKFILLED AMENDED SOIL

**1X CONTAINER** 

**HEIGHT** 

409 MAIN STREET SUITE 207 P.O. BOX 2320 FRISCO, CO 80443 P 970.368.7068

**NORRIS-DESIGN.COM** 

**NORRIS** 

**DESIGN** 

**PEOPLE + PLACEMAKING** 

(6) UNDISTURBED SOIL

SCALE: 1 1/2" = 1'-0"

(1) SPECIFIED MULCH, REFER TO MATERIAL SCHEDULE SHEET

(2) AMENDED PLANTING BED

TILLED TO A DEPTH OF 6" (3) CENTER OF PLANT

EAST WEST PARTNERS

1550 WEWATTA ST **DENVER, CO 80202 CONTACT: RYAN STONE** 303.319.6172

FINISH GRADE OF THE MULCH LAYER.

BROKEN OR CRUMBLING ROOT-BALLS WILL BE REJECTED.

4. DIG PLANT PIT TWICE AS WIDE AND AS HIGH AS THE CONTAINER.

SOIL DIRECTLY UNDER LOCATION OF ROOTBALL 8 24" X 3/4" P.V.C. MARKERS (TYPICAL) OVER WIRES (9) TREATED WOOD POST, OR METAL T STAKE WITH CAP, WITH GROMMETED NYLON STRAPS, USE 2 GUY WIRES

(10) UNAMENDED TOPSOIL ADDED TO EXISTING GRADE ON DOWN HILL SIDE, REFER TO **SPECIFICATIONS** 

(11) EXISTING GRADE

1 TRUNK PROTECTION - 1"

BOARDS.

**BOARDS NO LESS THAN 5** LONG OR TO REACH FIRST

SCAFFOLD BRANCH. WIRE TO

HOLD BOARDS IN PLACE, NO NAILS PERMITTED. INCLUDE

WRAPPING OF BURLAP UNDER

SECTION

WHEN PLANTED ON A CURVE, ORIENT ROWS TO FOLLOW THE LONG AXIS OF AREAS WHERE PLANTS ARE MASSED.

2X CONTAINER

2. CARE SHOULD BE TAKEN NOT TO DAMAGE THE SHRUB OR ROOT-BALL WHEN REMOVING IT

3. ALL JUNIPERS SHOULD BE PLANTED SO THE TOP OF THE ROOT-BALL OCCURS ABOVE THE

5. PRUNE ALL DEAD OR DAMAGED WOOD PRIOR TO PLANTING, DO NOT PRUNE MORE THAN 20%

← 18" ON CENTER SPACING

PLAN ON CURVE


PERENNIAL PLANT LAYOUT

(2) BRANCH PROTECTION -PROTECT LOWER BRANCHES OF TREE CANOPY. PROVIDE CONSTRUCTION FENCING OR EQUAL AT DRIPLINE MINIMUM.

SCALE: 1/4" = 1'-0"

(3) PLACE SIGNS EVERY 50', PLACE SIGNS WHERE VISIBLE ATTACH TO FENCING.

SCALE: 1/8" = 1'-0"

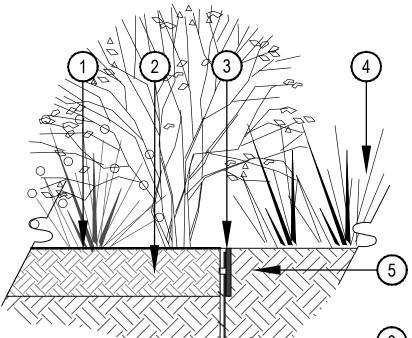

SCALE: 1" = 1'-0"

1 FINISH GRADE (2) ADJACENT LANDSCAPE, SEE


3 BENDA BOARD EDGER REFER TO MATERIAL SCHEDULE SHEET

LANDSCAPE PLANS FOR TYPE

(4) NATIVE SEED OR ADJACENT LANDSCAPE, REFER TO LANDSCAPE PLANS

(5) SUBGRADE

(6) EDGER STAKE, INSTALL PER **MANUFACTURER SPECIFICATIONS** 

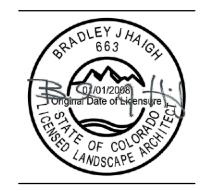

DATE: 03/15/2024 - IFC SET

04/11/2024 - RFI 18 04/11/2024 - RFI 19 06/13/2024 - RFI 85 06/18/2024 - RFI 84


BENDA BOARD EDGER


N.T.S.

LANDSCAPE **DETAILS** 

SHEET TITLE:

L-5.00

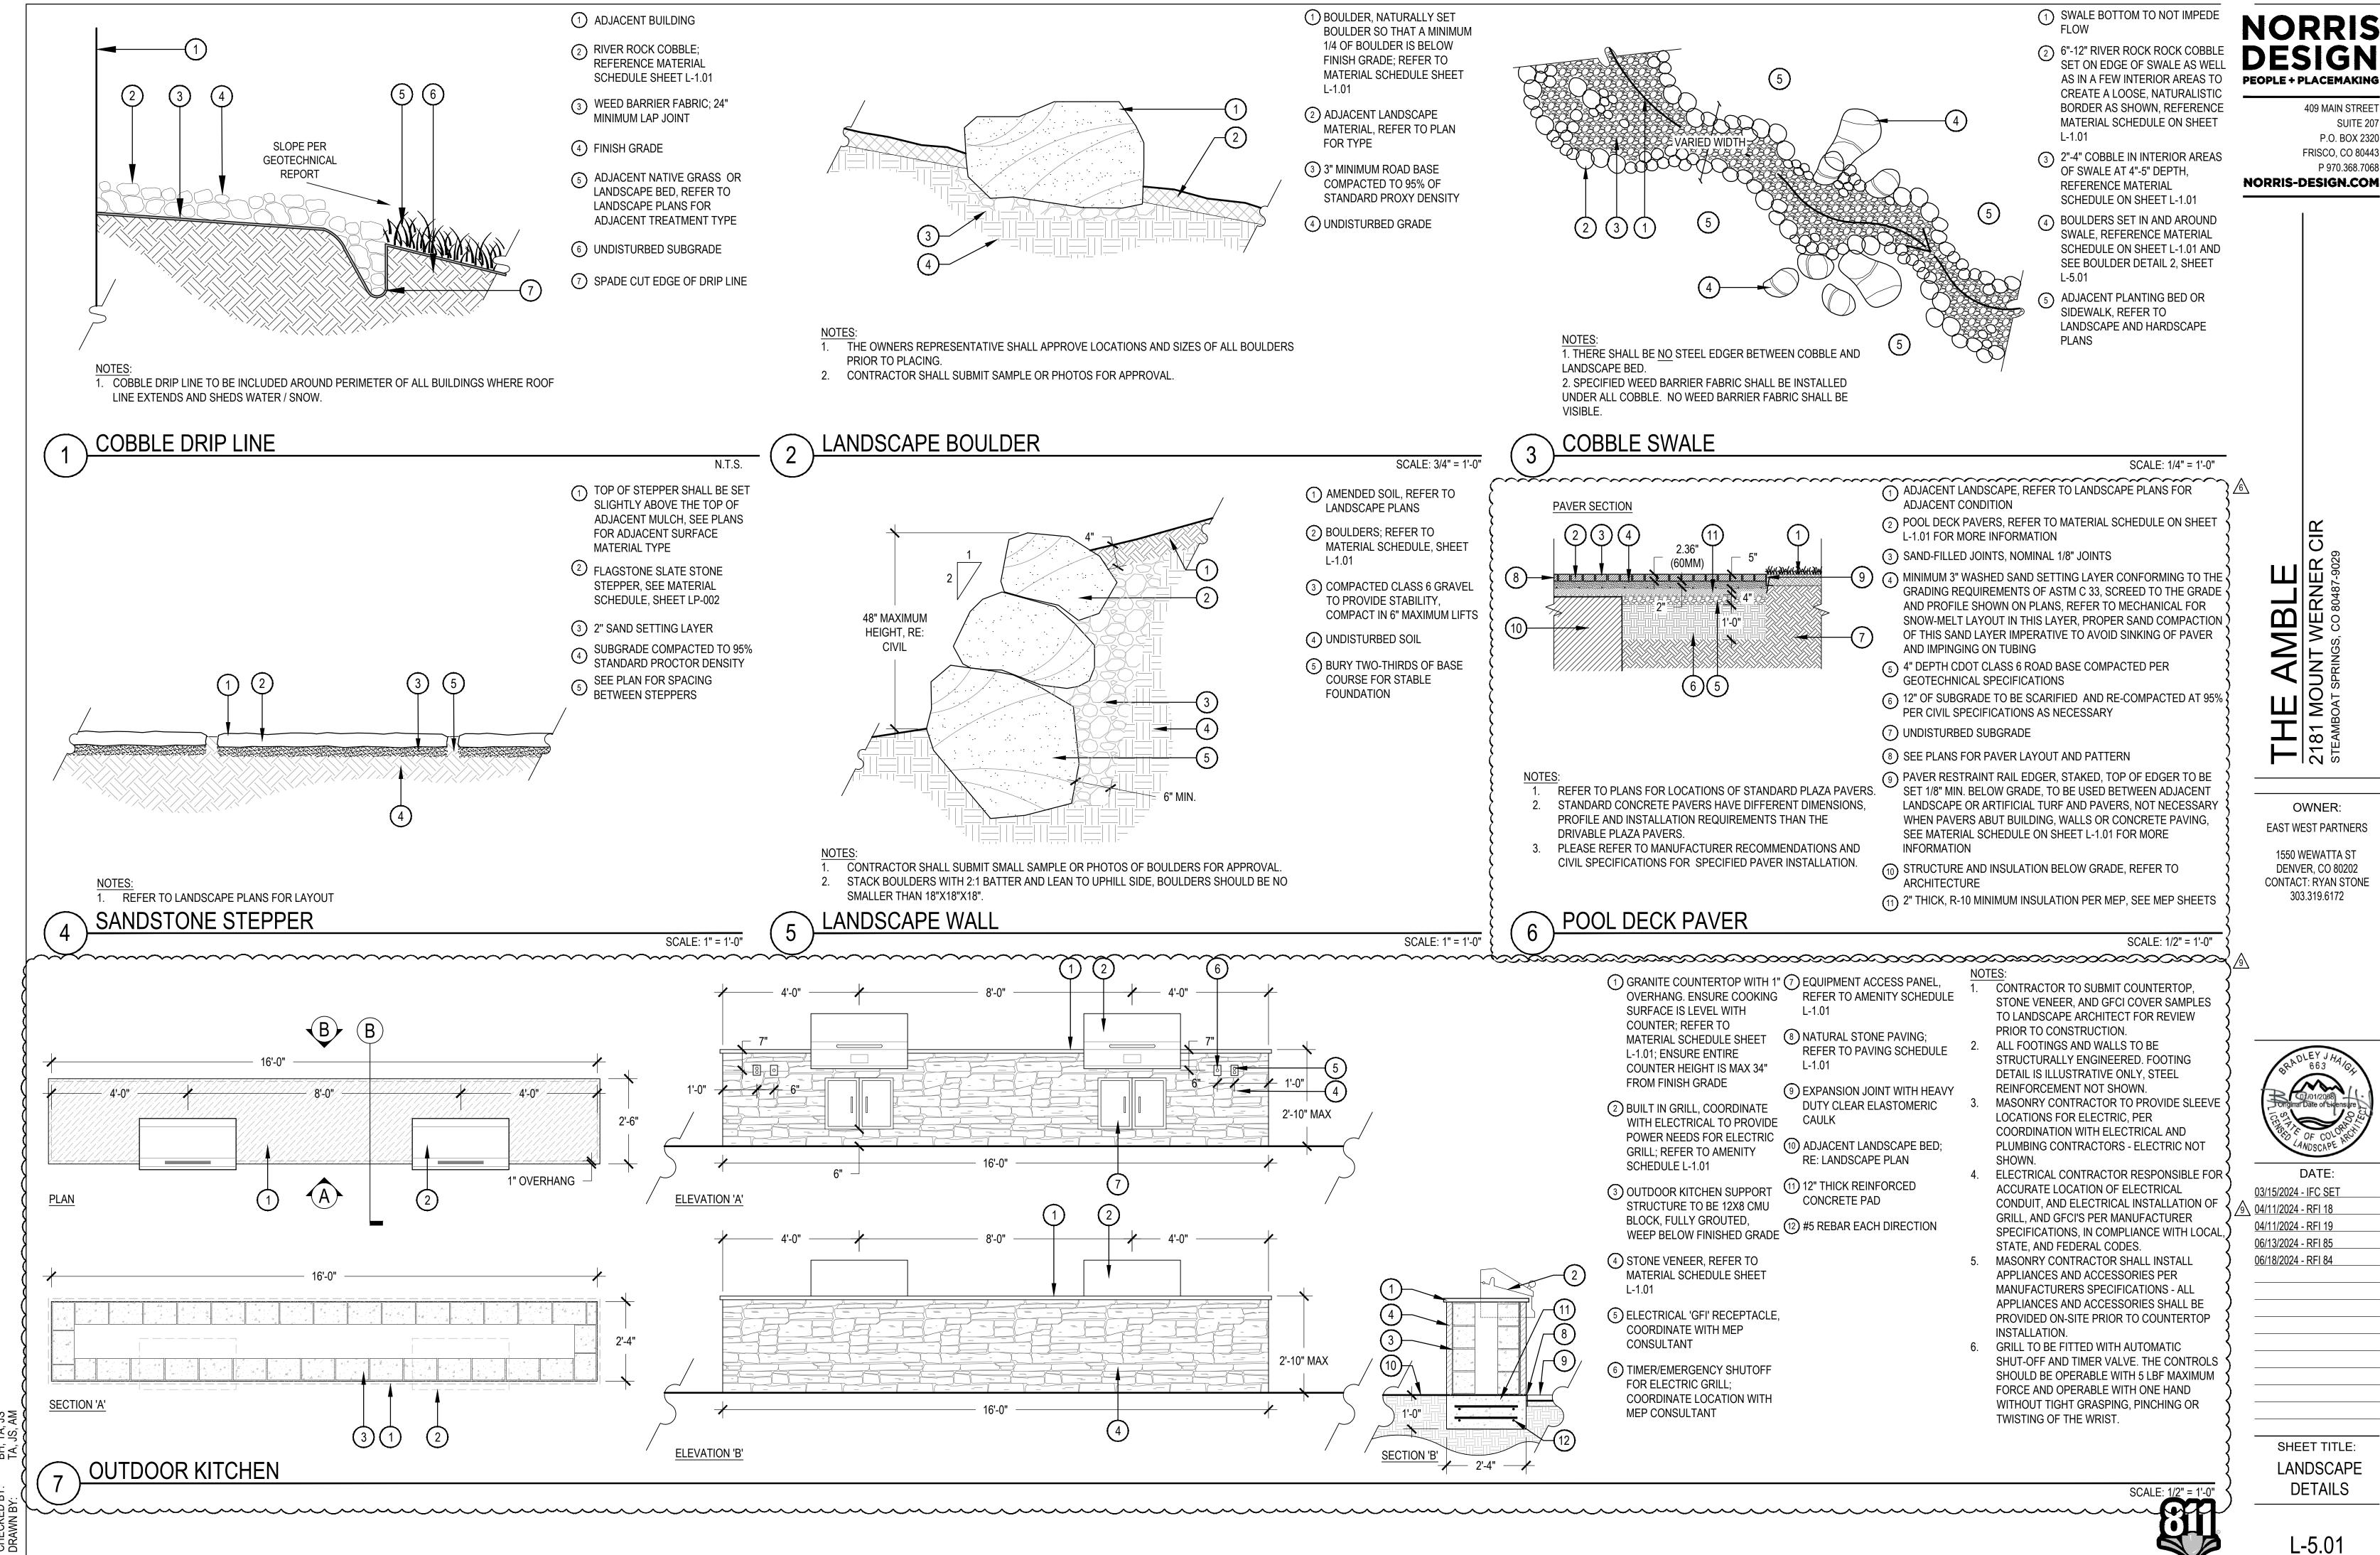

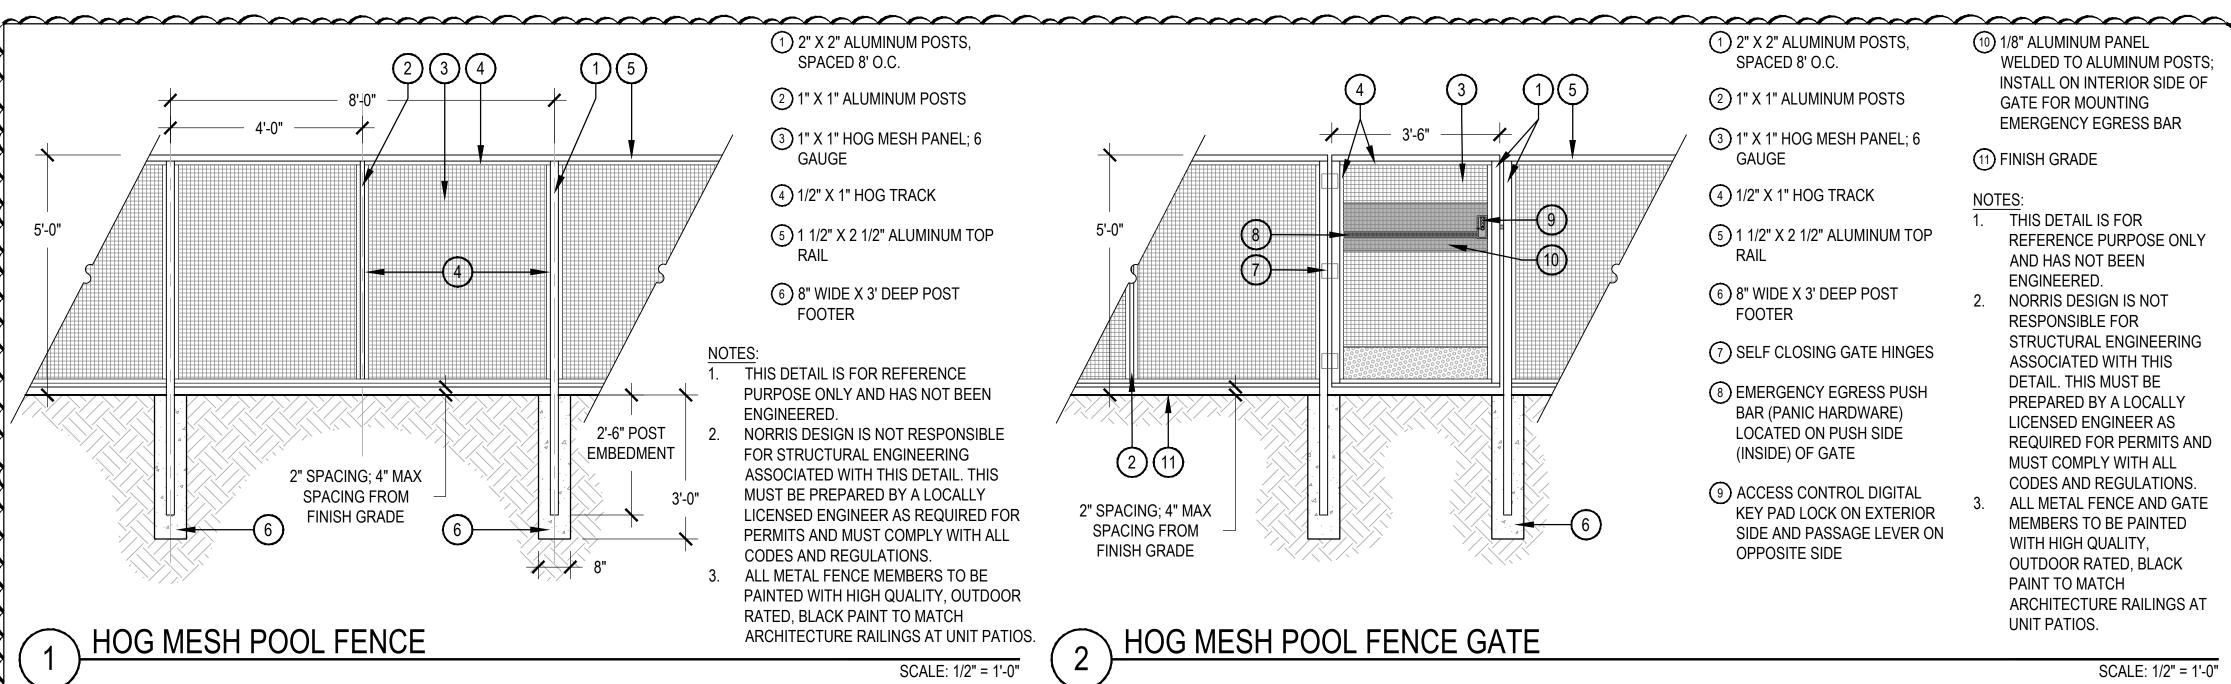

SPACED 8' O.C. (2) 1" X 1" ALUMINUM POSTS


(3) 1" X 1" HOG MESH PANEL; 6 **GAUGE** 

(4) 1/2" X 1" HOG TRACK

(6) 8" WIDE X 3' DEEP POST

THIS DETAIL IS FOR REFERENCE PURPOSE ONLY AND HAS NOT BEEN ENGINEERED.

NORRIS DESIGN IS NOT RESPONSIBLE FOR STRUCTURAL ENGINEERING ASSOCIATED WITH THIS DETAIL. THIS MUST BE PREPARED BY A LOCALLY LICENSED ENGINEER AS REQUIRED FOR PERMITS AND MUST COMPLY WITH ALL CODES AND REGULATIONS. ALL METAL FENCE MEMBERS TO BE PAINTED WITH HIGH QUALITY, OUTDOOR RATED, BLACK PAINT TO MATCH ARCHITECTURE RAILINGS AT UNIT PATIOS.

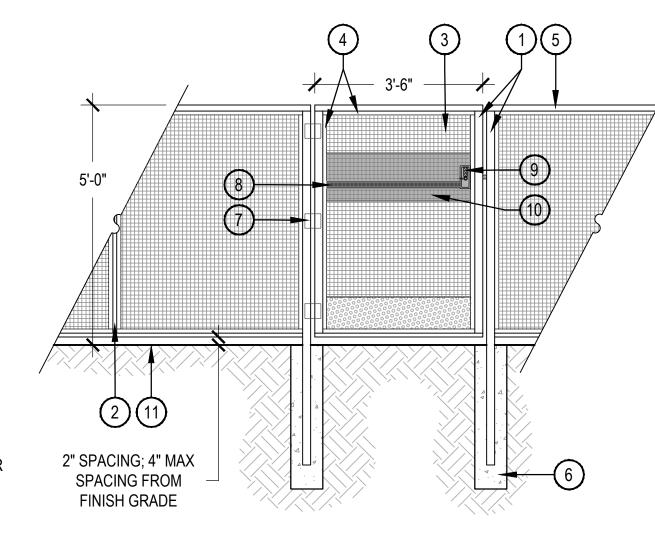

HOG MESH POOL FENCE GATE

(10) 1/8" ALUMINUM PANEL (1) 2" X 2" ALUMINUM POSTS, SPACED 8' O.C. (2) 1" X 1" ALUMINUM POSTS GATE FOR MOUNTING

THIS DETAIL IS FOR REFERENCE PURPOSE ONLY AND HAS NOT BEEN

(6) 8" WIDE X 3' DEEP POST **FOOTER** 

(3) 1" X 1" HOG MESH PANEL; 6

GAUGE

(4) 1/2" X 1" HOG TRACK

(7) SELF CLOSING GATE HINGES

(5) 1 1/2" X 2 1/2" ALUMINUM TOP

(8) EMERGENCY EGRESS PUSH BAR (PANIC HARDWARE) LOCATED ON PUSH SIDE (INSIDE) OF GATE

(9) ACCESS CONTROL DIGITAL KEY PAD LOCK ON EXTERIOR SIDE AND PASSAGE LEVER ON **OPPOSITE SIDE** 


WELDED TO ALUMINUM POSTS; INSTALL ON INTERIOR SIDE OF EMERGENCY EGRESS BAR

(11) FINISH GRADE

ENGINEERED. NORRIS DESIGN IS NOT RESPONSIBLE FOR STRUCTURAL ENGINEERING ASSOCIATED WITH THIS DETAIL. THIS MUST BE PREPARED BY A LOCALLY REQUIRED FOR PERMITS AND

LICENSED ENGINEER AS MUST COMPLY WITH ALL CODES AND REGULATIONS. ALL METAL FENCE AND GATE MEMBERS TO BE PAINTED WITH HIGH QUALITY, OUTDOOR RATED, BLACK PAINT TO MATCH ARCHITECTURE RAILINGS AT UNIT PATIOS.

SCALE: 1/2" = 1'-0"

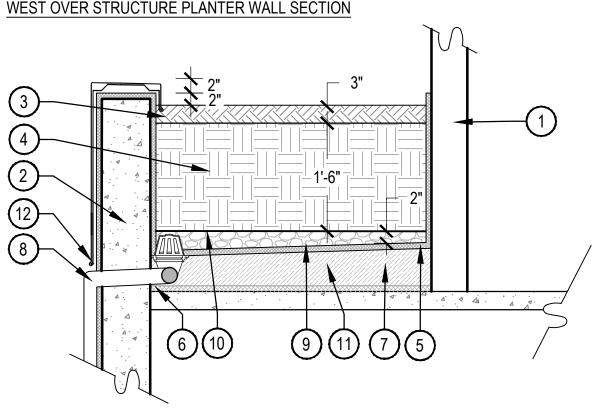

THIS DETAIL'S INTENT IS TO DEMONSTRATE THE OVER STRUCTURE GREEN ROOF

- PLANTER ASSEMBLY. NORRIS DESIGN IS NOT RESPONSIBLE FOR CONNECTIONS TO THE BUILDING OR
- WATERPROOFING AT THE BUILDING ENVELOPE. ALL PLANTERS TO BE IRRIGATED AND HAVE DRAINS, REFER TO DRAINAGE PLAN AND MEP FOR DRAIN SIZE, DETAILS AND FINAL LOCATION, REFER TO IRRIGATION PLANS FOR IRRIGATION TYPE.

ADJACENT BUILDING FACADE, REFER TO ARCHITECTURE FOR FACADE FINISH AND WATERPROOFING DETAILS. REFER TO ARCHITECTURE FOR FLASHING DETAIL AND STRUCTURAL FOR REINFORCEMENT

SCALE: 1/2" = 1'-0"

(2) ADJACENT BUILDING PARAPET, REFER TO ARCHITECTURE FOR PARAPET FINISH AND WATERPROOFING DETAILS. REFER TO STRUCTURAL FOR REINFORCEMENT (3) PLANTING BED MULCH, REFER TO MATERIAL

SCHEDULE SHEET L-1.01 (4) AMENDED PLANTING SOIL, MINIMUM 18" DEPTH, REFER TO SPECIFICATIONS FOR SOIL PREPARATION AND REQUIREMENTS FOR

SHRUB BED SOIL AMENDMENTS 5 PLANTER INTERIOR WATERPROOFING OVER (1) IRRIGATION LINE TO PLANTERS, REFER TO SEOFOAM BASE MEMBRANE TO MATCH ARCHITECTURE

(6) WATER PROOFING MEMBRANE AND STRUCTURAL SLAB ASSEMBLY, REFER TO ARCHITECTURE AND STRUCTURAL FOR DETAILING AND SPECIFICATIONS

(7) INSTALL GEO-FOAM TO SLOPE BASE OF PLANTER TO DIRECT DRAINAGE, INSTALL PER MANUFACTURER SPECIFICATIONS WATERPROOFING FOR INTERIOR OF PLANTER TO BE APPLIED BETWEEN GEOFOAM AND PLANTER SOIL OR GRAVEL, REFER TO ARCHITECTURE FOR WATERPROOFING SPECIFICATION


ARCHITECTURE FOR FLASHING DETAIL AND 8 DRAIN; REFER TO MEP FOR DRAIN TYPE, SIZE, AND LOCATION; REFER TO MEP AND ARCHITECTURE FOR CONNECTIONS TO DOWNSPOUT LOCATIONS AND DAYLIGHTING.

(9) MINIMUM 2" DEPTH 3/4"-1.5" AGGREGATE BASE TO ENSURE DRAINAGE OF PLANTER (10) MIRIFI FILTER FABRIC BETWEEN POTTING SOIL AND DRAINAGE AGGREGATE

IRRIGATION DRAWINGS FOR DETAILS

(12) REFER TO ARCHITECTURE FOR WALL FINISH

ENTRY DRIVE GREEN ROOF SECTION

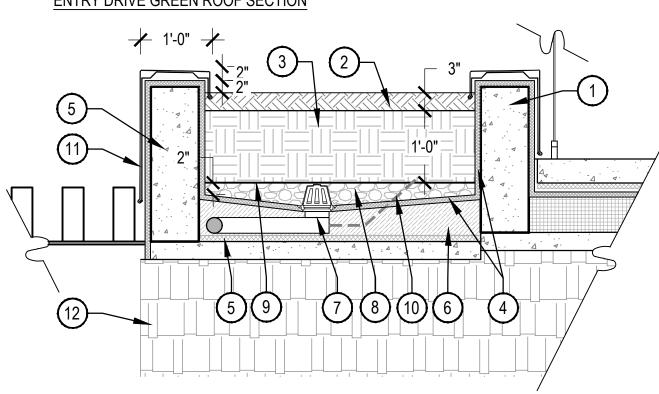

THIS DETAIL'S INTENT IS TO DEMONSTRATE THE OVER STRUCTURE GREEN ROOF PLANTER

ASSEMBLY. NORRIS DESIGN IS NOT RESPONSIBLE FOR CONNECTIONS TO THE BUILDING OR WATERPROOFING

AT THE BUILDING ENVELOPE ALL PLANTERS TO BE IRRIGATED AND HAVE DRAINS, REFER TO DRAINAGE PLAN AND MEP FOR DRAIN SIZE, DETAILS AND FINAL LOCATION, REFER TO IRRIGATION PLANS FOR IRRIGATION TYPE.

3/ ADJACENT BUILDING PARAPET, REFER TO ARCHITECTURE FOR PARAPET FINISH AND WATERPROOFING DETAILS. REFER TO ARCHITECTURE FOR FLASHING DETAIL AND STRUCTURAL FOR REINFORCEMENT

(2) PLANTING BED MULCH, REFER TO MATERIAL SCHEDULE SHEET L-1.01

(3) AMENDED PLANTING SOIL, MINIMUM 12" PREPARATION AND REQUIREMENTS FOR SHRUB BED SOIL AMENDMENTS

(4) PLANTER INTERIOR WATERPROOFING OVER GEOFOAM BASE MEMBRANE TO MATCH **ARCHITECTURE** 

(5) WATER PROOFING MEMBRANE AND STRUCTURAL SLAB ASSEMBLY, REFER TO ARCHITECTURE AND STRUCTURAL FOR **DETAILING AND SPECIFICATIONS** 

(6) INSTALL GEO-FOAM TO SLOPE BASE OF PLANTER TO DIRECT DRAINAGE, INSTALL PER MANUFACTURER SPECIFICATIONS, WATERPROOFING FOR INTERIOR OF PLANTER TO BE APPLIED BETWEEN GEOFOAM AND PLANTER SOIL OR GRAVEL, REFER TO ARCHITECTURE FOR WATERPROOFING SPECIFICATION

7 DRAIN; REFER TO MEP FOR DRAIN TYPE, SIZE, AND LOCATION; REFER TO MEP AND ARCHITECTURE FOR CONNECTIONS TO DOWNSPOUT LOCATIONS AND DAYLIGHTING

(8) MINIMUM 2" DEPTH 3/4"-1.5" AGGREGATE BASE TO ENSURE DRAINAGE OF PLANTER MIRIFI FILTER FABRIC BETWEEN POTTING

SOIL AND DRAINAGE AGGREGATE DEPTH, REFER TO SPECIFICATIONS FOR SOIL (10) IRRIGATION LINE TO PLANTERS, REFER TO IRRIGATION DRAWINGS FOR DETAILS

> 12) ARCHITECTURE 1ST FLOOR FACADE, REFER TO ARCHITECTURE

(11) REFER TO ARCHITECTURE FOR WALL FINISH

SCALE: 3/4" = 1'-0"

OWNER: EAST WEST PARTNERS

AMBI UNT WER

**NORRIS** 

**DESIGN** 

**PEOPLE + PLACEMAKING** 

NORRIS-DESIGN.COM

409 MAIN STREET

SUITE 207

P.O. BOX 2320

FRISCO, CO 80443

P 970.368.7068

1550 WEWATTA ST **DENVER, CO 80202** CONTACT: RYAN STONE 303.319.6172

WEST OVER STRUCTURE PLANTER

EAST GREEN ROOF PLANTER WALL SECTION

WIDTH VARIES REFER TO PLANS

THIS DETAIL'S INTENT IS TO DEMONSTRATE THE OVER STRUCTURE GREEN ROOF PLANTER **ASSEMBLY** 

NORRIS DESIGN IS NOT RESPONSIBLE FOR CONNECTIONS TO THE BUILDING OR WATERPROOFING AT THE BUILDING ENVELOPE. ALL PLANTERS TO BE IRRIGATED AND HAVE DRAINS, REFER TO DRAINAGE PLAN AND MEP FOR

EAST GREEN ROOF PLANTER WALL

DRAIN SIZE, DETAILS AND FINAL LOCATION, REFER TO IRRIGATION PLANS FOR IRRIGATION TYPE.

- (1) ADJACENT BUILDING PARAPET, REFER TO ARCHITECTURE FOR PARAPET FINISH AND WATERPROOFING DETAILS. REFER TO ARCHITECTURE FOR FLASHING DETAIL AND STRUCTURAL FOR REINFORCEMENT.
- (2) PLANTING BED MULCH, REFER TO MATERIAL SCHEDULE SHEET L-1.01
- AMENDED PLANTING SOIL, MINIMUM 18" PREPARATION AND REQUIREMENTS FOR SHRUB BED SOIL AMENDMENTS (4) PLANTER INTERIOR WATERPROOFING
- MEMBRANE OVER GEOFOAM BASE TO MATCH ARCHITECTURE (5) ADJACENT ELEVATED PATH, 6" CONCRETE
- SLAB ON GLU BOARD, THICKENED EDGE ALONG EAST EDGE, PATHWAY TOP ELEVATION TO BE EVEN WITH TOP OF PARAPET WALL, REFER TO STRUCTURAL FOR ELEVATED PATH SUPPORT.
- (6) WATER PROOFING MEMBRANE AND STRUCTURAL SLAB ASSEMBLY, REFER TO ARCHITECTURE AND STRUCTURAL FOR DETAILING AND SPECIFICATIONS

(7) REFER TO ARCHITECTURE AND STRUCTURAL FOR WALK SUPPORT

(8) INSTALL GEO-FOAM TO SLOPE BASE OF PLANTER TO DIRECT DRAINAGE, INSTALL PER MANUFACTURER SPECIFICATIONS, WATERPROOFING FOR INTERIOR OF PLANTER TO BE APPLIED BETWEEN GEOFOAM AND PLANTER SOIL OR GRAVEL,

SCALE: 3/4" = 1'-0"


- WATERPROOFING SPECIFICATION DEPTH, REFER TO SPECIFICATIONS FOR SOIL (9) DRAIN; REFER TO MEP FOR DRAIN TYPE, SIZE, AND LOCATION; REFER TO MEP AND ARCHITECTURE FOR CONNECTIONS TO DOWNSPOUT LOCATIONS AND DAYLIGHTING
  - (10) MINIMUM 2" DEPTH 3/4"-1.5" AGGREGATE BASE TO ENSURE DRAINAGE OF PLANTER (11) MIRIFI FILTER FABRIC BETWEEN POTTING

REFER TO ARCHITECTURE FOR

- SOIL AND DRAINAGE AGGREGATE (12) IRRIGATION LINE TO PLANTERS, REFER TO IRRIGATION DRAWINGS FOR DETAILS
- (13) ADJACENT RAILING, REFER TO ARCHITECTURE FOR FALL PROTECTION RAILING

SCALE: 3/4" = 1'-0"

ENTRY DRIVE GREEN ROOF

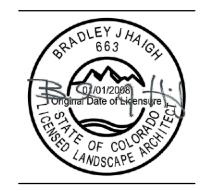

DATE: 03/15/2024 - IFC SET

/4\ <u>04/11/2024 - RFI 18</u> <u>04/11/2024 - RFI 19</u> 06/13/2024 - RFI 85 <u>06/18/2024 - RFI 84</u>

> SHEET TITLE: LANDSCAPE DETAILS

L-5.02

#### IRRIGATION POINT OF CONNECTION NOTES

- POINT OF CONNECTION: THERE IS ONE (1) POINT OF CONNECTION ON THIS PROJECT.
- POC #1: 1" DEDICATED IRRIGATION BACKFLOW PREVENTION UNIT INSIDE THE MECHANICAL ROOM BY OTHERS
- CONTRACTOR IS TO LOCATE AND CONNECT DOWNSTREAM OF THE DEDICATED POTABLE IRRIGATION BACKFLOW (PROVIDED BY OTHERS) WITH TYPE K COPPER EXTENDED INTO LANDSAPE AT A DEPTH OF 48" OR PER LOCAL CODE, WHICHEVER IS GREATER. INSTALL ONE MANUAL DRAIN, TRANSITION TO AND EXTEND CLASS 200 PVC MAINLINE TO THE 1" QUICK COUPLER, MASTER VALVE, 3 FLOW SENSOR, GATE VALVE, AND EXTEND MAINLINE TO VALVES AS SHOWN.
- ALL PIPING FROM DOWNSTREAM OF THE DEDICATED BACKFLOW PREVENTION UNIT THROUGH DRAIN VALVE SHALL BE THE SAME SIZE AS THE METER UNLESS OTHERWISE NOTED.
- THE CONTRACTOR SHALL CONFORM TO ALL LOCAL CODES, OBTAIN AND PROVIDE PAYMENT FOR ALL PERMITS ASSOCIATED WITH THIS WORK. FINAL LOCATION OF BACKFLOW PREVENTION UNIT SHALL BE APPROVED BY THE OWNER'S REPRESENTATIVE PRIOR TO INSTALLATION.
- CONTROLLER LOCATION: THERE IS ONE (1) CONTROLLER ON THIS PROJECT.
- CONTROLLER A: WALL MOUNTED CONTROLLER LOCATED NORTH WEST CORNER OF THE ENTRANCE TO THE GARAGE. REFER TO PLANS FOR APPROXIMATE LOCATION. FINAL LOCATION TO BE APPROVED BY OWNER.
- CONTROLLER SHALL BE PROGRAMMED TO RUN MULTIPLE VALVES AT ONE TIME WITH A MAXIMUM TOTAL OF 20 GPM.
- CONTROLLER, TO BE MOUNTED PER DETAILS AND MANUFACTURER'S SPECIFICATIONS. CONTRACTOR TO COORDINATE WITH OWNER'S REPRESENTATIVE AND ELECTRICAL PLANS FOR POWER SERVICE. ALL ELECTRICAL EQUIPMENT AND POWER CONNECTION INSTALLATION SHALL CONFORM TO ALL LOCAL CODES. INSTALL A LINE VOLTAGE SURGE DEVICE (INTERMATIC AG2401C3/ OR SQUARE D SDSA1175) FOR 120V IN A JUNCTION BOX PRIOR TO
- CONTROLLER. RAIN/FREEZE SENSOR: MOUNT THE RAIN SENSOR ON BUILDING EAVE IN PROXIMITY TO THE CONTROLLER. THE SENSOR SHALL BE MOUNTED IN A LOCATION IN FULL SUN AND OPEN TO RAINFALL. SENSOR SHALL BE NO MORE THAN 200' FROM WIRELESS RECEIVER. MOUNT WIRELESS RECEIVER ON OR ADJACENT TO THE IRRIGATION CONTROLLER.
- SYSTEM PRESSURE: THE SYSTEM HAS BEEN DESIGNED PER THE FOLLOWING SPECIFICATIONS: REQUIRED MINIMUM STATIC PRESSURE OF 80 PSI AND MAXIMUM SAFE VELOCITY OF 5 FPS IN ANY PVC PIPE AND 7.5 FPS IN ANY COPPER PIPE.
- PER WATER PURVEYOR THE STATIC PRESSURE ON SITE IS APPROXIMATELY 90 PSI AT THE IRRIGATION CONNECTION IN MECHANICAL ROOM
- THE CONTRACTOR IS RESPONSIBLE FOR VERIFYING THE PRESSURE IN THE FIELD AT THE POINT OF CONNECTION BEFORE CONSTRUCTION BEGINS AND FOR NOTIFYING THE OWNER'S REPRESENTATIVE OF ANY DISCREPANCY BETWEEN THE DESIGN PRESSURE OF THE SYSTEM AND THE MEASURED PRESSURE IN THE FIELD. IF THE CONTRACTOR FAILS TO NOTIFY OWNER'S REPRESENTATIVE OF SUCH DISCREPANCIES, THEN THE CONTRACTOR ASSUMES ALL LIABILITY AND COSTS ASSOCIATED WITH SYSTEM MODIFICATIONS TO ACCOMMODATE THE ACTUAL PRESSURE.
- FLOW SENSOR: SENSOR REQUIRES A MINIMUM FLOW FOR PROPER READINGS. MULTIPLE ZONES MAY BE REQUIRED TO RUN SIMULTANEOUSLY TO ACHIEVE THE MINIMUM FLOWS REQUIRED. CONTRACTOR TO SET 'K' VALUES PER MANUFACTURER
- FLOW SENSOR 1 REQUIRES A MINIMUM FLOW OF 0.21 GPM.

#### TWO WIRE NOTES

- 1. GROUNDING FOR THE IRRIGATION CONTROLLER AND DECODERS ARE TO BE INSTALLED PER THE MANUFACTURER'S SPECIFICATIONS AND PER THE AMERICAN SOCIETY OF IRRIGATION CONSULTANTS GUIDELINE 100-2002 FOR EARTH GROUNDING ELECTRONIC EQUIPMENT IN IRRIGATION SYSTEMS FOUND AT WWW.ASIC.ORG. FOR ADDITIONAL TECHNICAL SUPPORT REGARDING THE IRRIGATION CONTROLLER OR GROUNDING PLEASE CONTACT THE MANUFACTURER.
- 2. DO NOT LOOP TWO WIRE PATH. STAR PATTERN FROM CONTROLLER FOR EACH BRANCH OF MAINLINE.
- CONTRACTOR IS RESPONSIBLE FOR GROUNDING THE TWO-WIRE PATH AT THE FOLLOWING LOCATIONS. BUT ARE NOT LIMITED TO:
- CONTROLLER TO BE GROUNDED INDEPENDENTLY FROM BUILDING.
- GROUND 1ST DECODER ON WIRE PATH FROM CONTROLLER.
- 4. THE TWO-WIRE CONTROLLER REQUIRES EACH CONTROL VALVE AND SENSOR TO HAVE A DECODER. IT IS THE RESPONSIBILITY OF THE CONTRACTOR TO PROVIDE THE PROPER DECODERS, SURGE SUPPRESSION AND GROUNDING. THE RAIN SENSOR AND FLOW SENSOR REQUIRE A SENSOR DECODER.
- 5. QTY OF STATIONS (VALVES) PER MANIFOLD REQUIRED DECODER
- SINGLE STATION EZ-1 DECODER (HUNTER)
- 6. CONTROLLER TWO-WIRE PATH SHALL BE MANUFACTURER'S APPROVED WIRE OR APPROVED EQUAL
- 7. CONTRACTOR SHALL USE UL APPROVED WIRE STRIPPER AND WATERPROOF CONNECTIONS (DBR/Y OR APPROVED EQUAL) AT ALL SPLICES AND CONNECTIONS POINTS.
- 8. PROVIDE 30" MINIMUM TWO WIRE PATH IN EACH VALVE BOX FOR MAINTENANCE.
- 9. CONTRACTOR SHALL INCLUDE TWO-WIRE RUN PATHS ON AS-BUILT DRAWINGS.

### SLEEVING COORDINATION NOTES

- INSTALLATION OF IRRIGATION SLEEVING IS THE RESPONSIBILITY OF THE GENERAL CONTRACTOR. THE GENERAL CONTRACTOR SHALL COORDINATE WITH THE IRRIGATION CONTRACTOR FOR LOCATION AND SIZING OF SLEEVES PRIOR TO THE START OF CONSTRUCTION.
- SLEEVES SHALL BE INSTALLED PRIOR TO THE START OF PAVING OPERATIONS.
- THE CONTRACTOR SHALL SLEEVE ALL IRRIGATION DISTRIBUTION LINES, VALVE CONTROL WIRES AND COMMUNICATION WIRES UNDER ALL PAVED SURFACES, WALL FOOTERS, DRAINAGE CHANNELS, INLETS, CATCH BASINS, ETC.
- ALL SLEEVES SHALL EXTEND A MINIMUM OF 12" BEYOND EDGE OF ALL OBSTRUCTIONS. NO TEES, ELLS OR OTHER TURNS IN PIPING SHALL BE LOCATED UNDER ANY OBSTRUCTIONS.
- EACH PIPE SHALL BE IN A SEPARATE SLEEVE. WIRES SHALL BE IN A SEPARATE PIPE UNDER ALL PAVED SURFACES.
- SLEEVING SHALL BE INSTALLED PER THE SIZES AND QUANTITIES SHOWN ON THE PLANS BASED ON THE CHART BELOW.

**PIPING** REQUIRED SLEEVE SIZE MAINLINE PIPING 3" CLASS 200 PVC

2X NOMINAL DIAMETER OF LATERAL LATERAL PIPING **CONTROL WIRES** 2" CLASS 200 PVC

### IRRIGATION GENERAL NOTES

- THE CONTRACTOR SHALL PROVIDE ALL LABOR, MATERIALS AND EQUIPMENT NECESSARY TO INSTALL THE IMPROVEMENTS SHOWN ON THE PLANS.
- THE CONTRACTOR SHALL COORDINATE AS NECESSARY WITH THE GENERAL CONTRACTOR AND OWNER'S REPRESENTATIVE FOR SUCCESSFUL COMPLETION OF THIS WORK.
- ALL IRRIGATION EQUIPMENT IS TO BE AS SPECIFIED OR APPROVED EQUAL PER THE DISCRETION OF THE OWNER'S REPRESENTATIVE. THE CONTRACTOR ASSUMES ALL LIABILITY ASSOCIATED WITH THE MODIFICATION OF THE IRRIGATION SYSTEM DESIGN WITHOUT NOTIFYING THE OWNER'S REPRESENTATIVE.
- 4. IT IS THE CONTRACTOR'S RESPONSIBILITY TO CONDUCT A THOROUGH SITE INSPECTION AND REVIEW OF THE PROJECT CONSTRUCTION DOCUMENTS INCLUDING BUT NOT LIMITED TO THE FOLLOWING: LANDSCAPE PLAN, UTILITY PLAN, CIVIL UTILITY PLAN, ARCHITECTURE PLAN, GRADING AND DRAINAGE PLAN AND ALL OTHER ASSOCIATED PLANS AND SPECIFICATIONS THAT AFFECT THIS WORK PRIOR TO START OF WORK. IF THE AND CONTRACTOR OBSERVES ANY DISCREPANCIES AMONG THE CONSTRUCTION DOCUMENTS AND THE EXISTING CONDITIONS ON SITE, IT IS THEIR RESPONSIBILITY TO CONTACT THE OWNER'S REPRESENTATIVE IMMEDIATELY.
- THE CONTRACTOR MUST VERIFY THE LOCATION OF ALL PUBLIC AND PRIVATE UNDERGROUND UTILITIES PRIOR TO CONSTRUCTION. IF THE CONTRACTOR FAILS TO DO SO AND DAMAGES ANY UNDERGROUND UTILITIES. THE CONTRACTOR SHALL PAY FOR ANY REPAIR WORK ASSOCIATED WITH SAID DAMAGES.
- 6. IT IS THE CONTRACTOR'S RESPONSIBILITY TO ENSURE ADEQUATE VERTICAL AND HORIZONTAL SEPARATION BETWEEN ALL IRRIGATION DISTRIBUTION LINES AND ALL UTILITIES (EXISTING OR PROPOSED), CONDUIT, STORM WATER COMPONENTS, DRAINS, ETC.
- THE CONTRACTOR SHALL CONFORM TO ALL LOCAL AND STATE REGULATIONS AND INSTALL THE IRRIGATION SYSTEM AND ITS COMPONENTS PER MANUFACTURER'S SPECIFICATIONS. THE CONTRACTOR SHALL OBTAIN AND PROVIDE PAYMENT FOR ALL PERMITS REQUIRED BY ANY LOCAL AND STATE AGENCIES AND UTILITY COMPANIES HAVING JURISDICTION OVER THIS SITE
- IT IS THE INTENT OF THIS DESIGN THAT ALL IRRIGATION EQUIPMENT BE INSTALLED WITHIN LANDSCAPE AREAS AND WITHIN THE PROJECT LIMITS. EQUIPMENT SHOWN OUTSIDE OF THESE LIMITS IS SHOWN FOR GRAPHIC CLARITY ONLY. IF THERE IS A QUESTION REGARDING THE LOCATION OF ANY COMPONENT OF THE IRRIGATION SYSTEM, IT IS THE CONTRACTOR'S RESPONSIBILITY TO CONTACT THE OWNER'S REPRESENTATIVE. IF THE CONTRACTOR NEGLECTS TO NOTIFY THE NECESSARY PARTIES, THE CONTRACTOR SHALL PAY FOR ANY REPLACEMENT OR MODIFICATION TO ENSURE PROPER LOCATION AND OPERATION OF THE IRRIGATION SYSTEM
- ALL IRRIGATION DISTRIBUTION LINES AND EQUIPMENT INCLUDING BUT NOT LIMITED TO, MAINLINE, LATERALS, SPRAY HEADS, DRIP EMITTERS SHALL BE KEPT A MINIMUM DISTANCE OF 6' AWAY FROM ALL BUILDING AND WALL FOUNDATIONS, OR AS STIPULATED IN THE GEOTECHNICAL REPORT, WHICHEVER IS GREATER. EQUIPMENT MAY BE SHOWN IN THIS AREA FOR GRAPHIC CLARITY. COORDINATE ALL REQUIRED SETBACKS WITH OWNER'S REPRESENTATIVE PRIOR TO START OF WORK
- 10. EACH VALVE SHALL BE INSTALLED IN A SEPARATE VALVE BOX AS DETAILED. ALL VALVE BOXES AND LIDS SHALL BE COMMERCIAL GRADE, PLASTIC WITH SELF LOCKING COVERS. LID COLOR TO BE GREEN. INSTALL FLUSH TO FINISH GRADE AND PER CONSTRUCTION DETAILS. DO NOT INSTALL IN PAVED AREAS OR IN BOTTOMS OF DRAINAGE SWALES/BASINS.
- 11. CONTRACTOR SHALL INSTALL DETECTABLE MARKING TAPE OR #14g DIRECT BURY TRACER WIRE IN ALL PRESSURE MAINLINE TRENCHES. SEE IRRIGATION DETAILS FOR MORE INFORMATION.
- 12. PLANT MATERIAL LOCATIONS TAKE PRECEDENCE OVER ROUTING OF IRRIGATION PIPING. COORDINATE INSTALLATION OF IRRIGATION EQUIPMENT SO THAT IT DOES NOT INTERFERE WITH THE PLANTING OF TREES OR OTHER LANDSCAPE MATERIAL
- 13. THE CONTRACTOR SHALL MARK THE LOCATION OF THE MAINLINE, CONTROL VALVES, GATE VALVES AND HEAD LAYOUT OF A REPRESENTATIVE SPRAY ZONE. SCHEDULE A REVIEW WITH THE OWNER'S REPRESENTATIVE PRIOR TO INSTALLATION.
- 14. INSTALL SCH. 40 BALL WITH OPERATIONAL INDICATOR AT ENDS OF ALL DRIP LATERALS AS DETAILED. FLUSH ALL LATERALS THOROUGHLY BEFORE INSTALLING EMITTERS AND BUBBLERS.
- 15. CONTRACTOR SHALL FINE TUNE AND ADJUST NOZZLE DIRECTION AND RADIUS TO REDUCE OVERSPRAY ONTO PAVING OR HARD
- 16. CONTRACTOR SHALL INSTALL A QUICK COUPLER IN 10" VALVE BOX AT THE END OF ALL BRANCHES OF THE MAINLINE, OR AS SHOWN ON PLANS, FOR WINTERIZATION AND FLUSHING OF MAINLINE.
- 17. THE CONTRACTOR SHALL PERFORM A PRESSURE TEST ON ALL MAINLINES. CONTRACTOR SHALL PRESSURIZE MAINLINES TO 120 PSI AND MAINTAIN PRESSURE AT 120 PSI FOR A MINIMUM CONTINUOUS PERIOD OF TWO (2) HOURS TO ACHIEVE FINAL ACCEPTANCE.
- 18. THIS IRRIGATION SYSTEM HAS BEEN DESIGNED TO OPERATE DURING A THREE(3) NIGHT PER WEEK, SIXTEEN(16) HOURS PER NIGHT WATERING WINDOW. DRIP IRRIGATION ZONES MAY BE ALLOWED TO RUN ON A SEPARATE SCHEDULE FROM THIS WATER WINDOW DEPENDING JURISDICTION. LANDSCAPE ESTABLISHMENT WILL REQUIRE INCREASED IRRIGATION WATER FOR DURATION OF THE ESTABLISHMENT PERIOD AND MAY REQUIRE TWICE THE AMOUNT OF WATER AS ESTABLISHED PLANT MATERIAL. THE CONTRACTOR SHALL COORDINATE WATERING SCHEDULES AND APPLICATION RATES WITH THE OWNER'S REPRESENTATIVE PRIOR TO FINAL **ACCEPTANCE**
- 19. THE DESIGN IS BASED ON THE FOLLOWING PROJECTED PEAK SEASON WEEKLY APPLICATION RATES AFTER ESTABLISHMENT. THESE FIGURES WILL NEED TO BE ADJUSTED DUE TO SEASONAL CHANGES AND VARIABLE WEATHER CONDITIONS.
  - FESCUE/BLUEGRASS BLEND TURF 1.75" PER WEEK PEAK SEASON
- TREE, SHRUB, AND PERENNIAL PLANT MATERIAL 1.00" PER WEEK PEAK SEASON
- NATIVE DRAUGHT TOLERANT SEED MIX 0.75" PER WEEK PEAK SEASON 21. THE CONTRACTOR SHALL PROVIDE A SEASONAL MAINTENANCE SCHEDULE WHICH SHALL BEGIN ON MAY 15TH AND END ON SEPTEMBER 30TH TO ENSURE THE EFFICIENCY AND LONGEVITY OF THE IRRIGATION SYSTEM. THE MAINTENANCE SCHEDULE SHALL INCLUDE BUT IS NOT LIMITED TO THE FOLLOWING LIST OF BEST MANAGEMENT PRACTICES:
  - CHECK HEADS FOR COVERAGE AND LEAKAGE
  - CHECK CONTROLLER PROGRAMMING AND ADJUST FOR SEASONAL CHANGES AS NECESSARY.
  - VERIFY THAT THE WATER SUPPLY AND PRESSURE ARE AS STATED IN THE DESIGN
  - CERTIFY THE BACKFLOW PREVENTION DEVICE AND SUBMIT TEST RESULTS TO THE PROPERTY MANAGER. PERIODICALLY VERIFY THE THE SENSORS IN THE IRRIGATION SYSTEM ARE OPERATING CORRECTLY
- WINTERIZATION AND SPRING START UP PROCEDURES.

SYMBOL	DESCRIPTION	_	EL NO. CRIPTION	DETAIL # AND SHEET					
C	IRRIGATION	HUNTER HCC-800-S-EZ-DM MODULE					LI-3.00		
	CONTROLLER RAIN	120VAC POWER REQUIRED - SEE PLANS FOR LOCATION(S)  HUNTER WSS-SEN + WS/WR-GUARD				1			
<b></b>	SENSOR	REFER TO CONTROLLER NOTES				2	LI-3.00		
<b>⊚</b>	MANUAL DRAIN VALVE		<b>CO-NORCA 3/4" 201X</b> ALLED IN AEP 910L-1G2G V <i>F</i>	ALVE BOX		4	LI-3.00		
©	QUICK	RAIN	I BIRD 44LRC			7	LI-3.00		
	COUPLER		ALLED IN AEP 910L-1G2G V <i>A</i> <b>TER IBV-101G SERIES WITH</b>						
<b>₩</b>	MASTER VALVE	INST	ALLED IN AEP 1015-1G2G VA			5	LI-3.00		
FS	FLOW SENSOR	FLOWMEC QS-200-10 WITH DIRECT WIRING TO CONTROLLER, INSTALLED IN AEP 1015-1G2G VALVE BOX				6	LI-3.00		
×	ISOLATION GATE VALVE	MATCO-NORCA 514TX (2.5" AND SMALLER) MATCH LINE SIZE, INSTALLED IN AEP 910L-1G2G VALVE BOX				8	LI-3.00		
•	TURF VALVE ASSEMBLY	HUNTER ICV-G SERIES WITH SCH 40 BALL VALVE, AND EZ-1 DECODER INSTALLED IN AEP 1015-1G2G VALVE BOX, SIZED PER PLAN				9	LI-3.00		
$\oplus$	DRIP VALVE ASSEMBLY	WITH	<b>TER ICZ-101-LF</b> I SCH 40 BALL VALVE, AND I /E BOX, SIZED PER PLAN	4	LI-3.01				
<u> </u>	GROUNDING / LINE SURGE SUPRESSION	WITH	PER-CLAD GROUNDING ROI I WATERPROOF WIRE CONI ODER JUSTALI ED IN AER 94	NECTORS AND EZ-1 SU		3	LI-3.01		
STRIP III III		RAIN	I BIRD RD06-S-P45-F WITH R	-VAN SERIES NOZZLE		_			
R-VAN18 • • • • • • • • • • • • • • • • • • •	TURF ROTARY		ZLE PER PLAN			5	LI-3.01		
	TURF SPRAY (FIXED)	RAIN NOZ	5	LI-3.01					
8 00 02 03	TURF SPRAY (ADJUSTABLE)	RAIN BIRD RD06-S-P30-F WITH U-SERIES NOZZLE NOZZLE PER PLAN					LI-3.01		
R-VAN STRIP	NATIVE SEED ROTARY	RAIN BIRD RD12-S-P45-F WITH R-VAN SERIES NOZZLE NOZZLE PER PLAN					LI-3.01		
	NATIVE SEED SPRAY (FIXED)	RAIN BIRD RD12-S-P30-F WITH U-SERIES NOZZLE NOZZLE PER PLAN					LI-3.01		
8 0 0 0 0	NATIVE SEED SPRAY (ADJ)	RAIN BIRD RD12-S-P30-F WITH U-SERIES NOZZLE NOZZLE PER PLAN					LI-3.01		
	TREES IN NATIVE	(2) RAIN BIRD RD04-S-P30-F WITH 1402 BUBBLER ASSEMBLIES PER TREE					LI-3.02		
<b>©</b>	PLANTER POT ASSEMBLIES	TRANSITION TO HUNTER MPE-10 MULTI-OUTLET EMITTER  COIL DRIPLINE AROUND PLANTER				7	LI-3.01		
	SLEEVING		SS 200 PVC	-N		1	LI-3.01		
	PVC		ER TO SLEEVING NOTES SS 200 PVC BE			'			
	MAINLINE	SIZE	: 1.5" UNLESS OTHERWISE N	NOTED		2	LI-3.01		
	PVC TURF LATERAL	l	<b>SS 200 PVC BE</b> : 1" MINIMUM UNLESS OTHE	RWISE NOTED		2	LI-3.01		
	PVC TREE	CLA	SS 200 PVC			2	LI-3.01		
	LATERAL DRIP		: 1" UNLESS OTHERWISE NO ESISTANT POLYETHYLENE						
	LATERAL		: 3/4" MINIMUM UNLESS OTH			2	LI-3.01		
	FLUSH END CAP		EDULE 40 BALL VALVE & HU ALLED IN AEP 910L-1G2G VA			3	LI-3.02		
V/	ALVE CALLOUT			EMITTER SCI	HEDULE				
	VALVE/STATION NUMBER		PLANT TYPE	EMITTER	QTY.		L GPH		
	ZONE DESIGNATION: T (TREES), S (SHRUBS),		PERENNIAL / GRASSES	0.5 GPH	TWO EACH	1.0 GPH			
<b>■</b> X-X	G (TURF), N (NATIVE),		DECIDUOUS SHRUBS EVERGREEN SHRUBS	1.0 GPH 1.0 GPH	TWO EACH	2.0 GPH 2.0 GPH			
X" XX	7 (TEMPORARY NATIVE)		DECIDUOUS TREE	1.0 GPH 1.0 GPH	EIGHT EACH				
	∼ VALVE FLOW: (GPM)	EVERGREEN TREE 1.0 GPH EIGHT EACH				8.0 GPH 8.0 GPH			
	- VALVE SIZE	TREES IN NATIVE TREE BUBBLER REFER TO IRRIGATION S							
			EMITTER NOTES						
			ITH HUNTER HE SERIES PR Y. THE CONTRACTOR SHAI			S BASF	D ON THE		

2. EMITTER SCHEDULE IS FOR REFERENCE ONLY. THE CONTRACTOR SHALL ADJUST EMITTER AND NUMBER OF EMITTERS BASED ON THE

NEEDS OF INDIVIDUAL PLANTS OR PLANT HYDROZONES.

3. 1/4" DISTRIBUTION TUBING NOT TO EXCEED 8' IN LENGTH.

4. HUNTER HE DIFFUSER BUG CAP AND STAKE ON ALL 1/4" DISTRIBUTION TUBING EMISSION POINTS. 5. REFER TO DRIP IRRIGATION DETAILS 8 & 9 SHEET LI-301 AND , DETAILS 2 & 3 ON SHEET LI-3.02

DATE:

EAST WEST PARTNERS

1550 WEWATTA ST

DENVER, CO 80202

CONTACT: RYAN STONE

303.319.6172

**NORRIS** 

PEOPLE + PLACEMAKING

NORRIS-DESIGN.COM

**409 MAIN STREET** 

P.O. BOX 2320

FRISCO, CO 80443

P 970.368.7068


SUITE 207

03/15/2024 - IFC SET 04/11/2024 - RFI 18 04/11/2024 - RFI 19 06/1<u>3/2024 - RFI 85</u> 06/18/2024 - RFI 84

> SHEET TITLE: IRRIGATION **SCHEDULE**

> > LI-1.00

1550 WEWATTA ST DENVER, CO 80202 CONTACT: RYAN STONE 303.319.6172

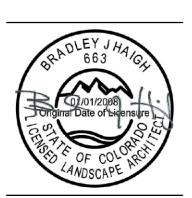


DATE: 03/15/2024 - IFC SET 04/11/2024 - RFI 18 04/11/2024 - RFI 19 06/13/2024 - RFI 85

06/18/2024 - RFI 84

SHEET TITLE: OVERALL IRRIGATION PLAN

LI-1.01

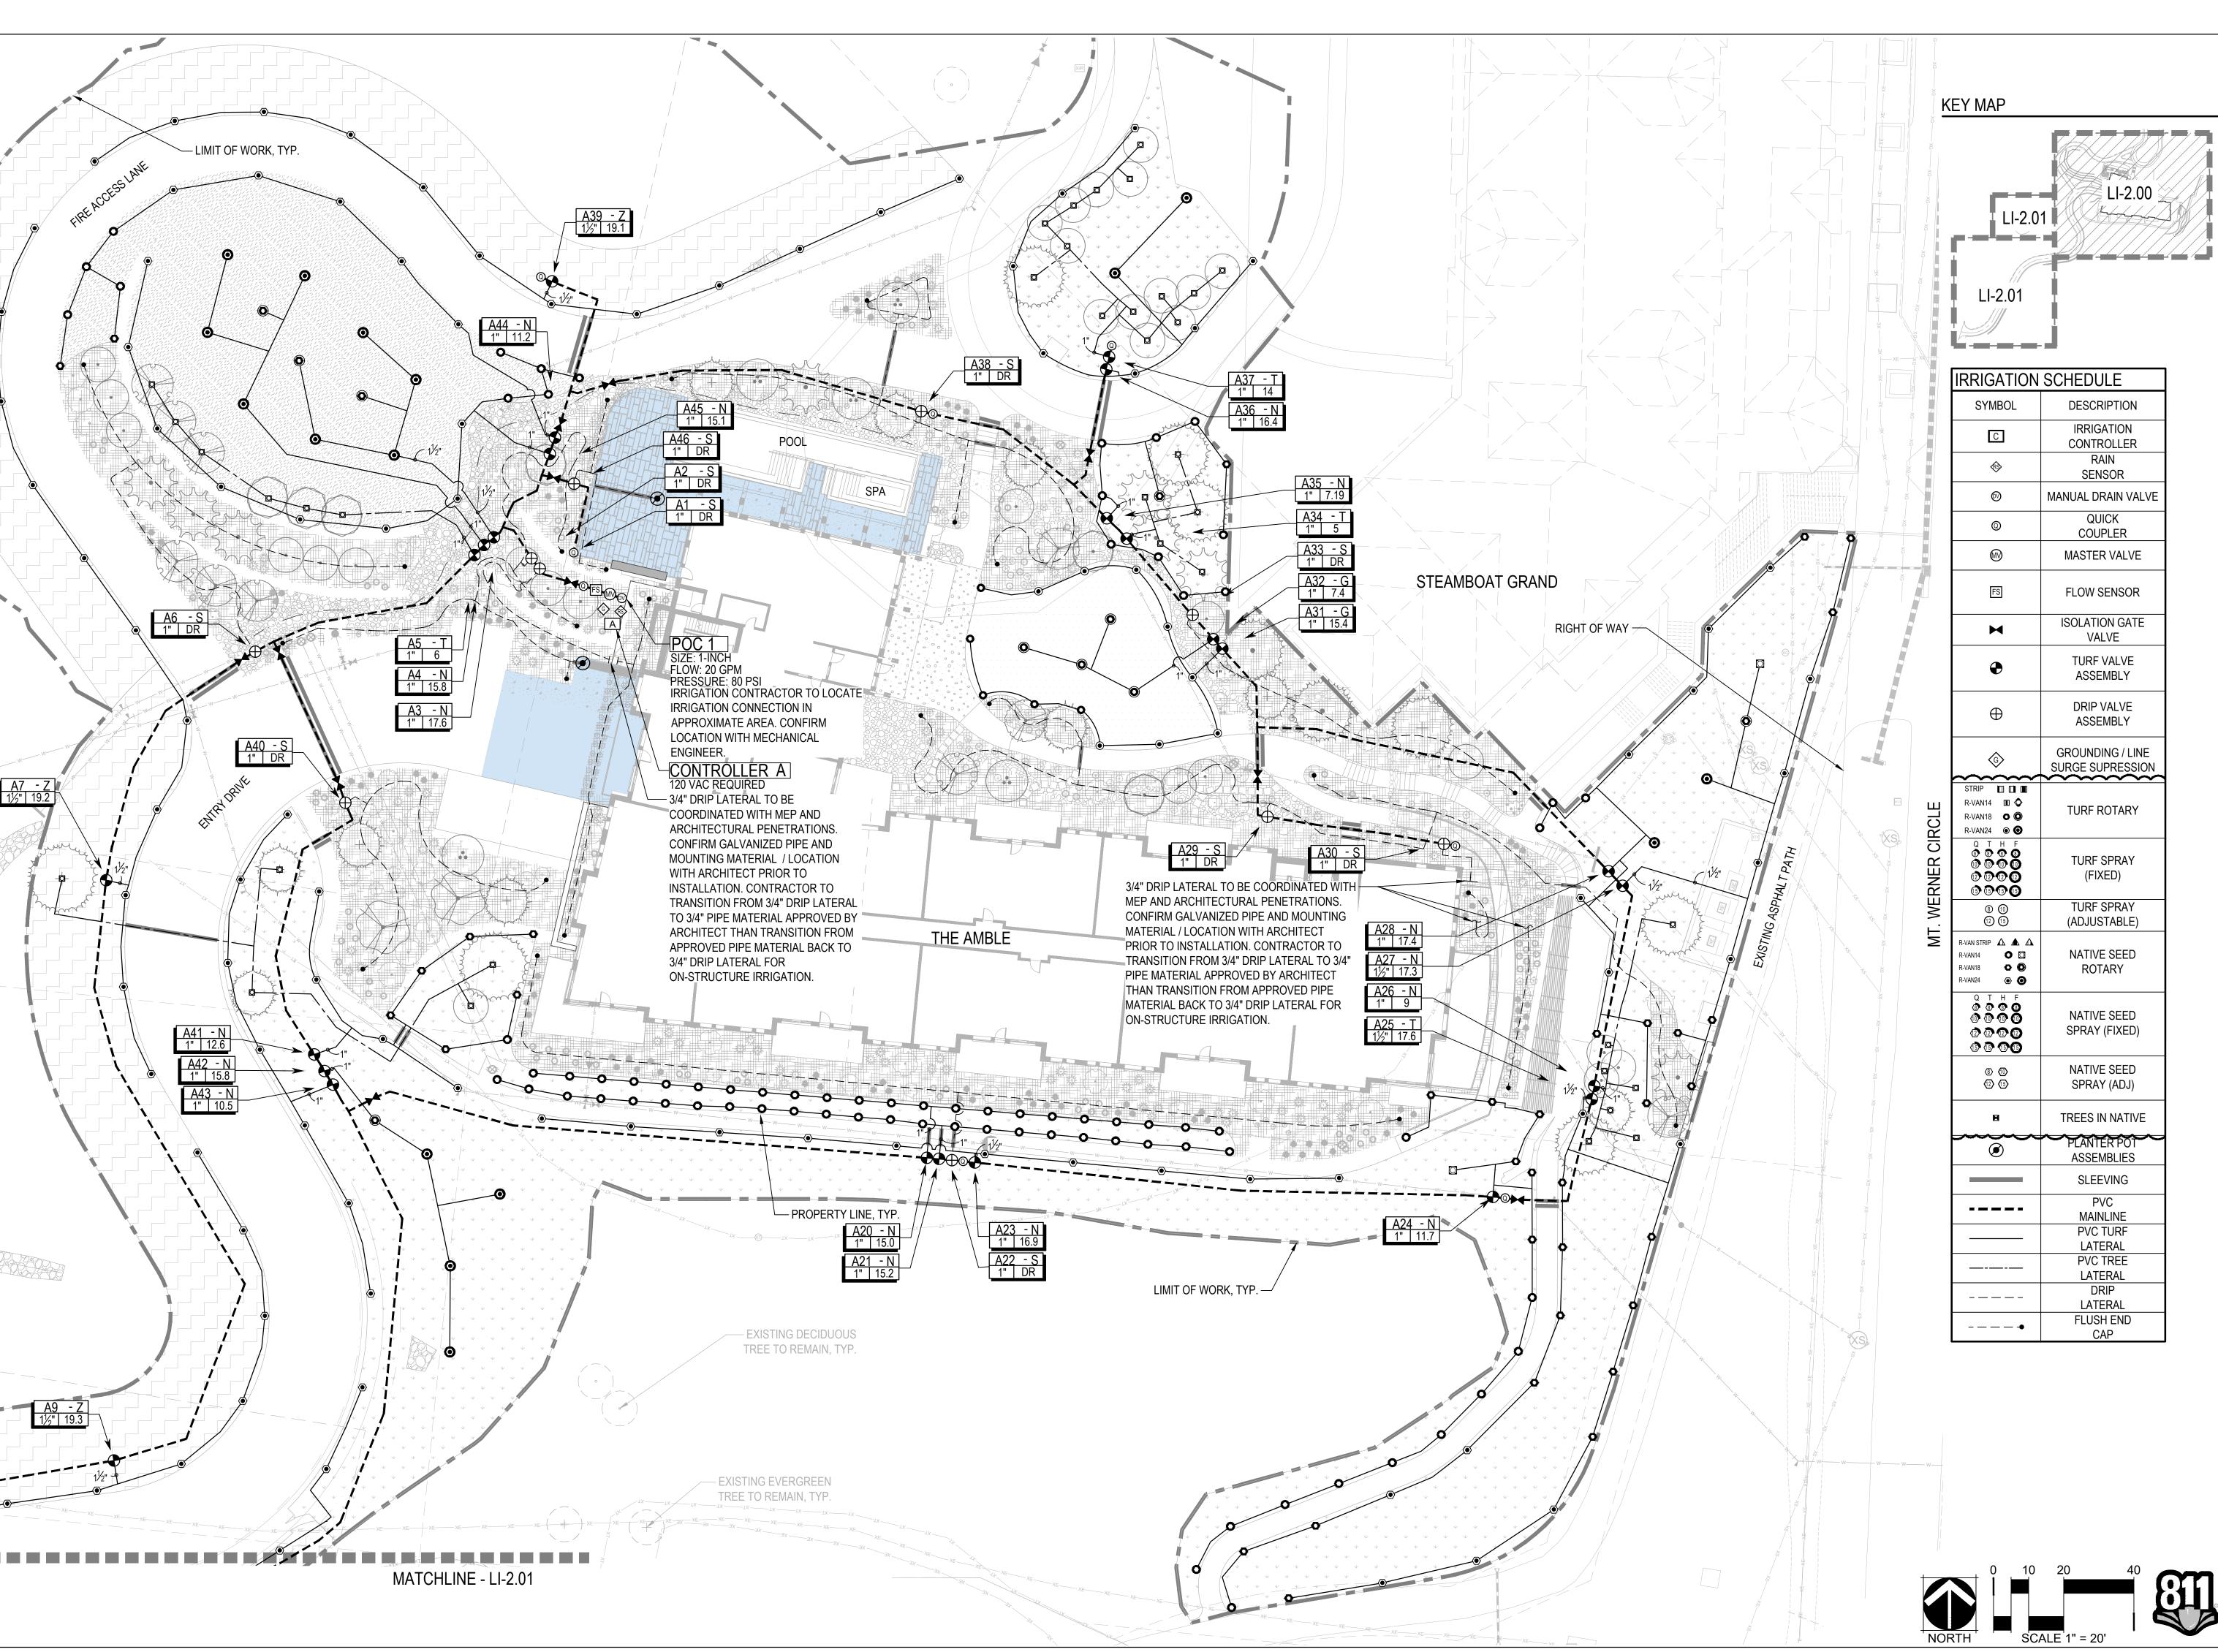


NORRIS DESIGN

409 MAIN STREET SUITE 207 P.O. BOX 2320 FRISCO, CO 80443 P 970.368.7068

**NORRIS-DESIGN.COM** 

OWNER: EAST WEST PARTNERS

1550 WEWATTA ST DENVER, CO 80202 CONTACT: RYAN STONE 303.319.6172

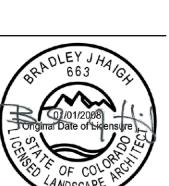


DATE: 03/15/2024 - IFC SET 04/11/2024 - RFI 18 04/11/2024 - RFI 19 <u>06/13/2024 - RFI 85</u>

06/18/2024 - RFI 84

SHEET TITLE: **IRRIGATION** PLAN

LI-2.00

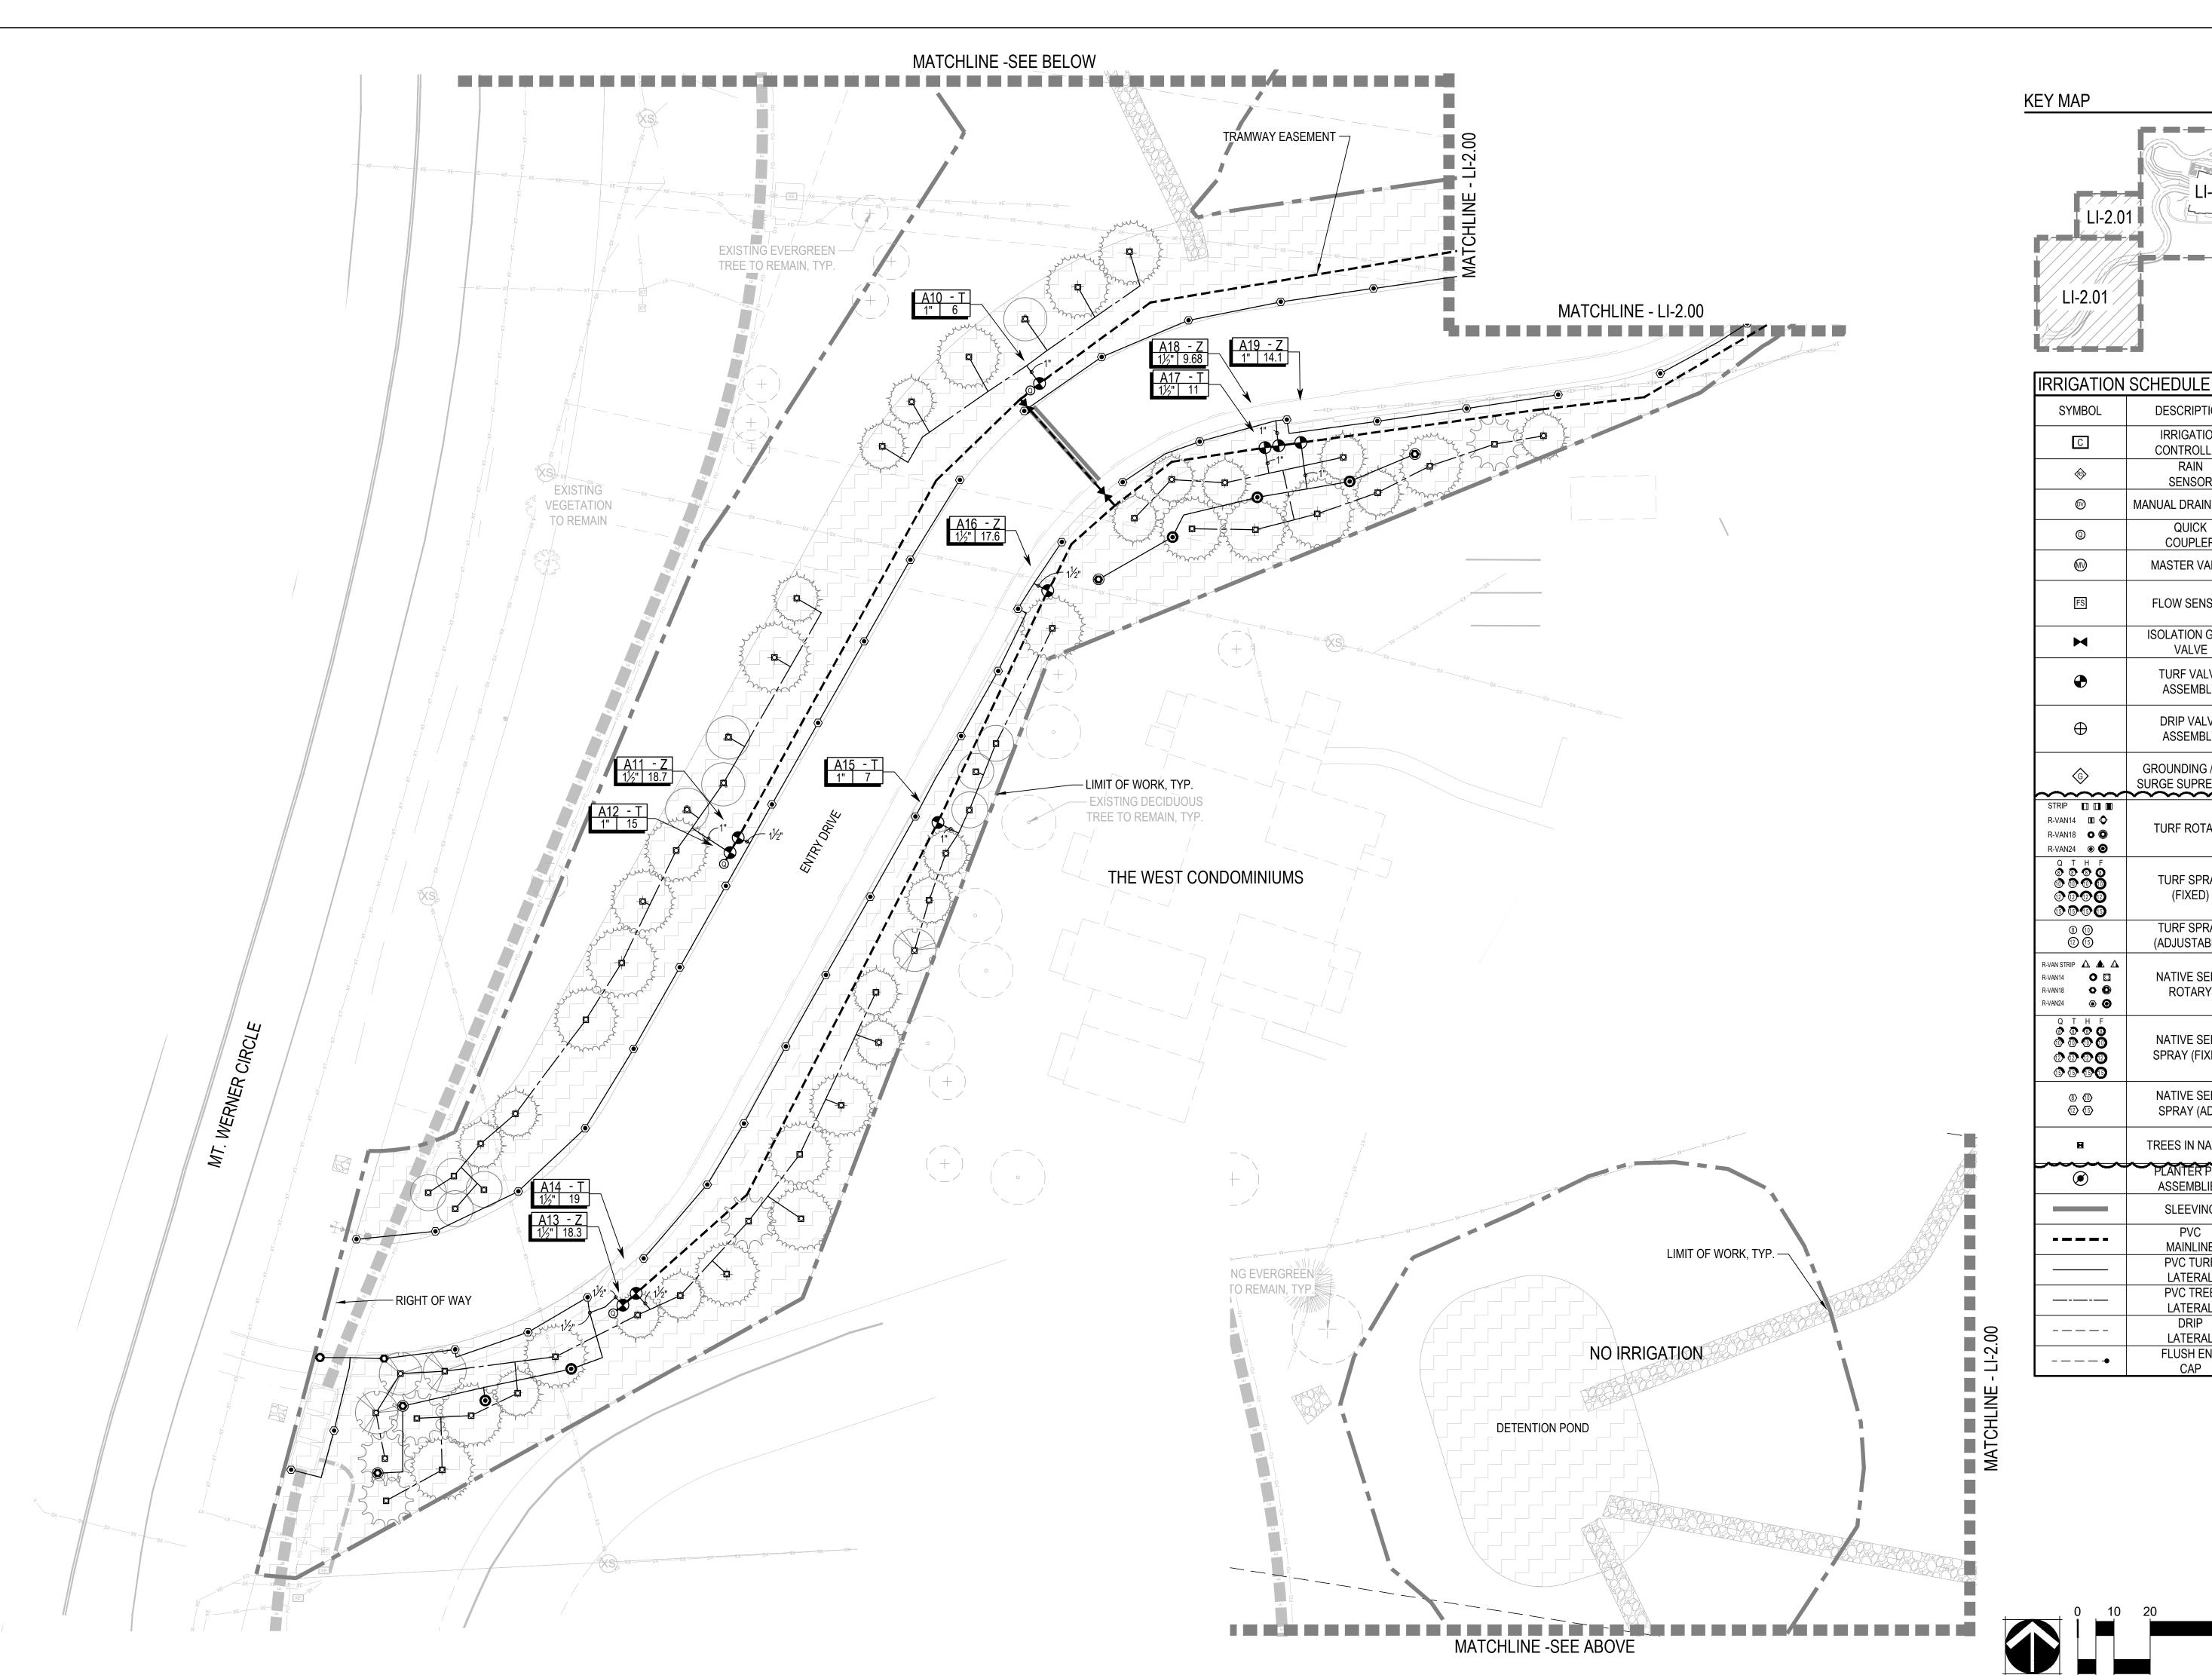

BH, TA,

NORRIS DESIGN

409 MAIN STREET SUITE 207 P.O. BOX 2320 FRISCO, CO 80443

P 970.368.7068 **NORRIS-DESIGN.COM** 

DESCRIPTION SYMBOL IRRIGATION С CONTROLLER RAIN SENSOR MANUAL DRAIN VALVE **(**(V) QUICK 0 COUPLER MASTER VALVE FLOW SENSOR ISOLATION GATE VALVE TURF VALVE **ASSEMBLY** DRIP VALVE ASSEMBLY GROUNDING / LINE SURGE SUPRESSION STRIP 🔲 🖽 TURF ROTARY R-VAN18 O O R-VAN24 ⊚ **⊙** Q T H F 0 0 0 0 0 0 0 0 0 0 0 0 0 0 0 0 0 0 0 TURF SPRAY (FIXED) TURF SPRAY (ADJUSTABLE) R-VAN STRIP 🛕 🛕 🗘 NATIVE SEED R-VAN14 O R-VAN18 • • • ROTARY R-VAN24 Q T H F (a) (a) (a) (b) (b) (b) (b) (c) (c) (c) (c) (c) (d) (d NATIVE SEED SPRAY (FIXED) NATIVE SEED 3 (1)(2) (15) SPRAY (ADJ) TREES IN NATIVE **ASSEMBLIES** SLEEVING PVC MAINLINE

PVC TURF

LATERAL

**PVC TREE** 

LATERAL

LATERAL

FLUSH END

SCALE 1" = 20'


EAST WEST PARTNERS

1550 WEWATTA ST DENVER, CO 80202 CONTACT: RYAN STONE 303.319.6172

DATE: 03/15/2024 - IFC SET <u>04/11/2024 - RFI 18</u> <u>04/11/2024 - RFI 19</u> <u>06/13/2024 - RFI 85</u>

> SHEET TITLE: IRRIGATION PLAN

> > LI-2.01

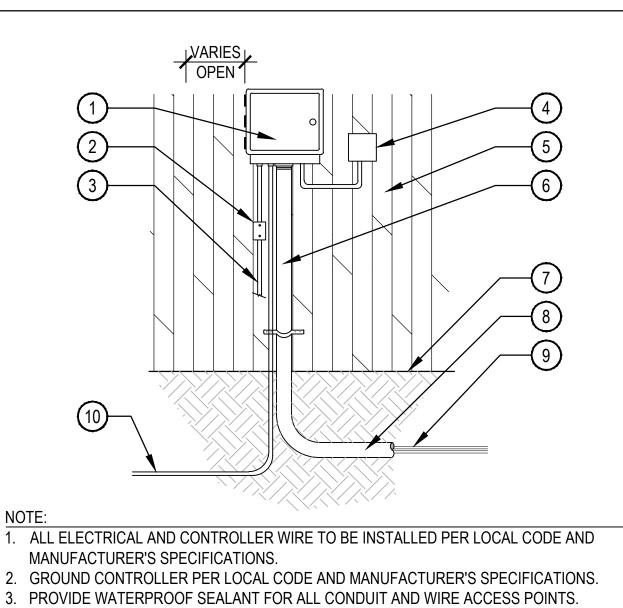

(1) CONTROLLER MOUNT AT EYE-LEVEL PER MANUFACTURER'S RECOMMENDATIONS

(2) DISCONNECT SWITCH

(3) 120 POWER SOURCE IN STEEL CONDUIT

4 WIRELESS SENSOR RECEIVER

(5) BUILDING EXTERIOR WALL

6 RIGID STEEL CONDUIT W/ CONTROL WIRES TO VALVES

(7) FINISH GRADE

(8) CONDUIT TO EXTEND 5 FT. **BEYOND WALL** 

(9) UF DIRECT BURIAL WIRE TO CONTROL VALVES

10 UF DIRECT BURIAL WIRE TO **GROUNDING PER ASIC GUIDELINES** 

2. GROUND CONTROLLER PER LOCAL CODE AND MANUFACTURER'S SPECIFICATIONS


3. PROVIDE WATERPROOF SEALANT FOR ALL CONDUIT AND WIRE ACCESS POINTS.

## **CONTROLLER WALL MOUNT EXTERIOR**

1. ALL THREADED CONNECTIONS SHALL BE COATED WITH TEFLON TAPE

2. LOCATE DRAIN VALVE AT POINT OF CONNECTION AND AT ALL LOW POINT(S) ALONG THE

4. PROVIDE LOCK FOR ENCLOSURE.

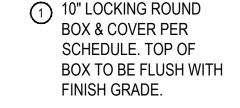

2 2" VALVE MARKER

(3) 2" CL160 PVC ACCESS SLEEVE LENGTH AS REQUIRED.

(4) 3" DEPTH 3/4" CRUSHED GRAVEL 6" BEYOND EDGE OF BOX

(5) PVC PRESSURE MAIN LINE

(6) SCH. 80 TEE PER MAINLINE SIZE. ALIGN IN A DOWNWARD POSITION

(7) SCH. 80 PVC NIPPLE

(8) FINISH GRADE

(9) 1" BRONZE STOP VALVE WITH SLOTTED KEY OPERATOR

(10) SCH. 80 PVC ELL

(11) SCH. 80 PVC NIPPLE

12) 3/4" GRAVEL SUMP - 1 CU. FT. MIN


(13) SOIL BLANKET ENCLOSING SUMP AMOCO ENG. FABRIC 4545 - 4.5 OZ. OR EQUAL

SCALE: NTS

# MANUAL DRAIN VALVE

IRRIGATION MAINLINE AS NEEDED.



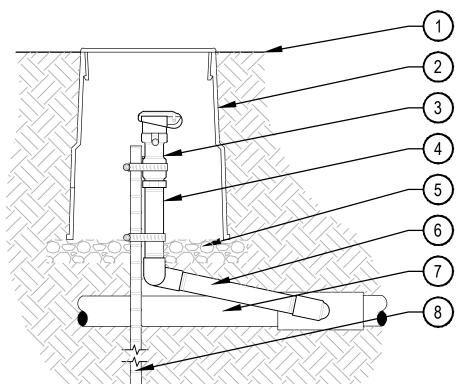

EACH QUICK COUPLER SHALL BE IN A SEPARATE VALVE BOX

PROVIDE (1) QUICK COUPLER KEY FOR EACH QUICK COUPLER VALVE. QUICK COUPLER SHALL HAVE LOCKING RUBBER COVER. COLOR PER LEGEND.

COMPACT SOIL AROUND GATE VALVE ASSEMBLY TO THE SAME DENSITY AS ADJACENT UNDISTURBED SUB-GRADE.

5. ALL THREADED CONNECTIONS SHALL BE COATED WITH TEFLON TAPE.

1 FINISH GRADE

(2) 10" ROUND BOX & COVER PER SCHEDULE. TOP OF BOX TO FLUSH WITH FINISH GRADE

(3) QUICK COUPLING VALVE W/ LOCKING COVER PER SCHEDULE


(4) SCH. 80 PVC RISER (T x T)

(5) 3" DEPTH 3/4" GRAVEL BASE EXTEND 6" BEYOND EDGE OF

(6) PVC SWING JOINT

7 PVC MAINLINE


(8) 24" LONG #4 REBAR TO HOLD QUICK COUPLER IN PLACE W/ (2) STAINLESS STEEL CLAMPS

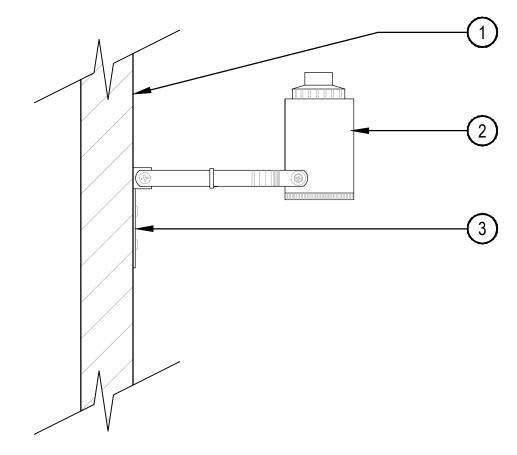

PROVIDE WATERPROOF SEALANT FOR ALL CONDUIT AND WIRE ACCESS POINTS.


2. FINAL LOCATION AND MOUNTING SYSTEM TO BE DETERMINED BY OWNER. 3. SENSOR SHOULD NOT BE MOUNTED UNDER TREES, IN AREAS AFFECTED BY SPRINKLER SYSTEM OR UNDER EAVE OF HOUSE.

## RAIN SENSOR SURFACE MOUNT

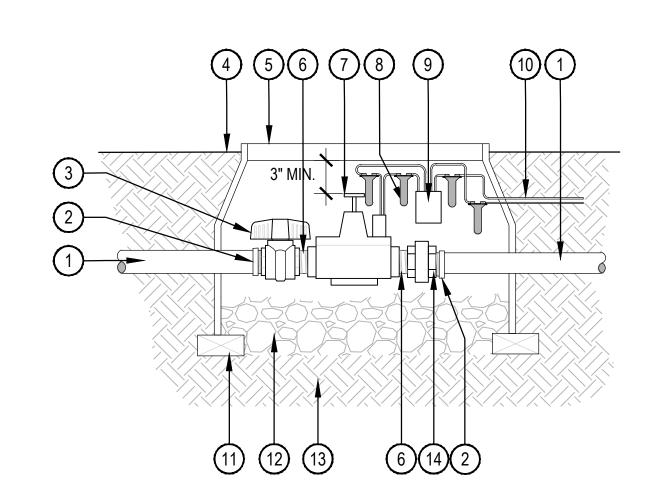

. INSTALL MASTER VALVE PER MANUFACTURER'S SPECIFICATIONS FOR WIRING AND GROUNDING.

## MASTER VALVE

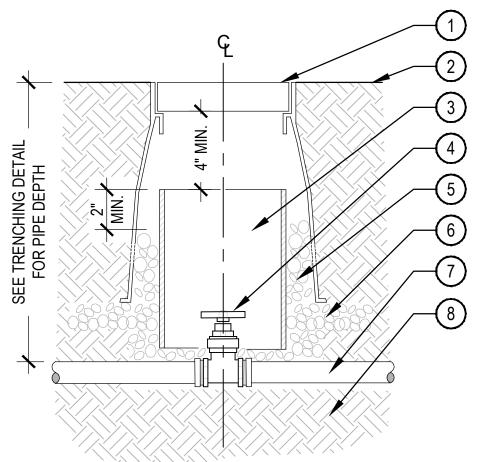

UNDISTURBED SUBGRADE. 2. DO NOT REST VALVE BOX OR ACCESS SLEEVES ON MAINLINE OR LATERAL LINE. 3. PROVIDE GATE VALVE KEY - LENGTH AS REQUIRED.

1. COMPACT SOIL AROUND GATE VALVE ASSEMBLY TO THE SAME DENSITY AS ADJACENT

**GATE VALVE 2" AND SMALLER** 

(1) SUITABLE FASCIA, WALL, OR **GUTTER MOUNT. MOUNT IN** LOCATION WHERE SENSOR CAN RECEIVE FULL SUN AND IS OPEN TO RAINFALL.

(2) WIRELESS RAIN SENSOR, LOCATE WITHIN 500' OF THE CONTROLLER.

(3) SECURE MOUNTING BRACKET TO EXTERIOR WALL WITH SCREWS PER LOCAL CODES

1 PVC MAINLINE

4 FINISH GRADE

(2) SCH. 80 PVC MALE ADAPTER

3 SCH. 80 PVC BALL VALVE

**5** LOCKING VALVE BOX

6 SCH. 80 PVC NIPPLE

(8) WATERPROOF ELECTRICAL

(10) WIRES TO CONTROLLER

(11) BRICK SUPPORTS 2 MIN.

(13) COMPACTED SUBGRADE

12) 3/4" GRAVEL SUMP - 8" DEPTH

(14) SCH. 80 PVC UNION (THREADED)

1 LOCKING ROUND BOX & COVER

(3) 8" SCH 40 PVC ACCESS SLEEVE

(4) GATE VALVE W/ CROSS HANDLE

(5) 3/4" GRAVEL SUMP FILL IN AND

AROUND BOX AS REQUIRED.

(6) 3" DEPTH 3/4: GRAVEL EXTEND 6"

AND SOLID WEDGE DISC PER

LENGTH AS REQUIRED.

2 FINISH GRADE

SCHEDULE

PER SCHEDULE. TOP OF BOX TO

BE FLUSH WITH FINISH GRADE

SCALE: NTS

(THREADED)

7 MASTER VALVE

9 DECODER

CONNECTIONS


NTS

1. INSTALL ONLY ONE RCV TO VALVE BOX. LOCATE AT LEAST 12-INCHES FROM AND ALIGN WITH NEARBY WALLS OR EDGES OF PAVED AREAS. GROUP RCV ASSEMBLIES TOGETHER WHERE PRACTICAL

2. GROUP RCV ASSEMBLIES TOGETHER WHERE PRACTICAL, BUT AVOID GROUPING MORE THAN

THREE (3) STANDARD VALVE BOXES TOGETHER IN A SERIES. 3. ARRANGE GROUPED VALVE BOXES IN RECTANGULAR PATTERNS. VALVE BOX PLACEMENT

> SCALE: NTS 1) WIRES TO CONTROLLER

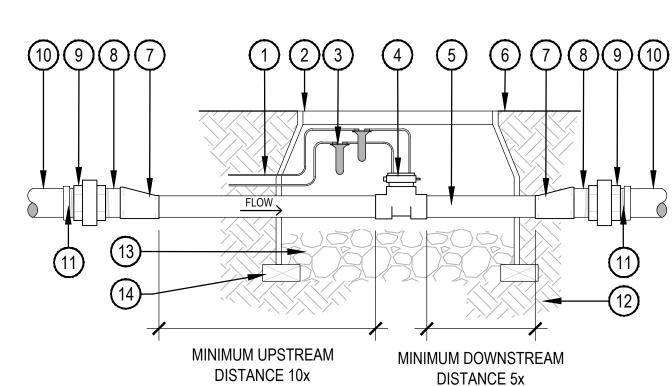

DISTANCE 10x FLOW METER SIZE FLOW METER SIZE OF CLEAN STRAIGHT PIPE OF CLEAN STRAIGHT PIPE

8 9 1011

1. INSTALL FLOW SENSOR PER MANUFACTURER'S SPECIFICATIONS FOR WIRING AND

COUPLING (S x S) - SIZE & QTY TO BE DETERMINED IN FIELD (8) SCH. 80 PVC NIPPLE (MPTxS) (9) SCH. 80 PVC UNION (THREADED)

7 SCH. 80 PVC ECCENTRIC

(2)LOCKING VALVE BOX

(5)DOWNSIZED MAINLINE

CONNECTIONS

6)FINISH GRADE

(3)WATERPROOF ELECTRICAL

4 FLOW SENSOR PER SCHEDULE

1 VALVE BOX; ALIGN EVENLY AND

SPACE EVENLY FROM SIDEWALK

STRUCTURE, WALL, OR CURB

(3) VALVE BOX LID BRANDED WITH

**CONTROLLER & STATION** 

2 SIDEWALK OR PAVING

NUMBER

10PVC MAINLINE

(11)SCH. 80 PVC MALE ADAPTER (12)COMPACTED SUBGRADE

(13)3/4" GRAVEL SUMP 8" DEPTH

(14)BRICK SUPPORTS 2 MIN.

# FLOW SENSOR

GROUNDING.

1)PVC MAINLINE 2) BRICK SUPPORT (4 MIN.)

3 CONTROL WIRE

(4) COMMON WIRE TO NEXT VALVE(S)

(5) PVC LATERAL W/ MALE ADAPTER

SCALE: NTS

(6) SCH. 80 PVC UNION (THREADED) 7 WATERPROOF CONNECTORS

8 TWO-WIRE DECODER

9 CONTROL VALVE (10)(4) SCH. 80 PVC NIPPLE/ RISER (LENGTH & SIZE VARY)

(11) SCH. 80 PVC BALL VALVE

12 LOCKING VALVE BOX

(13) FINISH GRADE

(14) PVC ELBOW (TxT) (15)3/4" GRAVEL SUMP - 4" DEPTH

(16) PVC TEE (SxSxT)

LI-3.00

**NORRIS** 

**PEOPLE + PLACEMAKING** 

NORRIS-DESIGN.COM

AMBLE

JUNT WERNER

SPRINGS, CO 80487-9029

81 MOU

**EAST WEST PARTNERS** 

1550 WEWATTA ST

**DENVER, CO 80202** 

CONTACT: RYAN STONE

303.319.6172

DATE:

03/15/2024 - IFC SET

04/11/2024 - RFI 18

04/11/2024 - RFI 19

06/13/2024 - RFI 85

06/18/2024 - RFI 84

409 MAIN STREET

P.O. BOX 2320

FRISCO, CO 80443

P 970.368.7068

SUITE 207

**QUICK COUPLER** 

SCALE: NTS

SCALE: NTS

BEYOND EDGE OF BOX

(8) COMPACTED SUBGRADE

7 PVC MAINLINE

1. BUNDLE & TAPE WIRE EVERY 10 FT. SEAL WIRE ENDS WITH WATERPROOF SPLICING

CONTROL VALVE DECODER


2. 30" MINIMUM LENGTH OF CONTROL WIRE, COILED AND PLACED IN BOX AT WATERPROOF CONNECTION TO SOLENOID.

3. INSTALL DECODER PER MANUFACTURE'S SPECIFICATIONS FOR WIRING AND GROUNDING.

SCALE: NTS

**IRRIGATION DETAILS** 

SHEET TITLE:

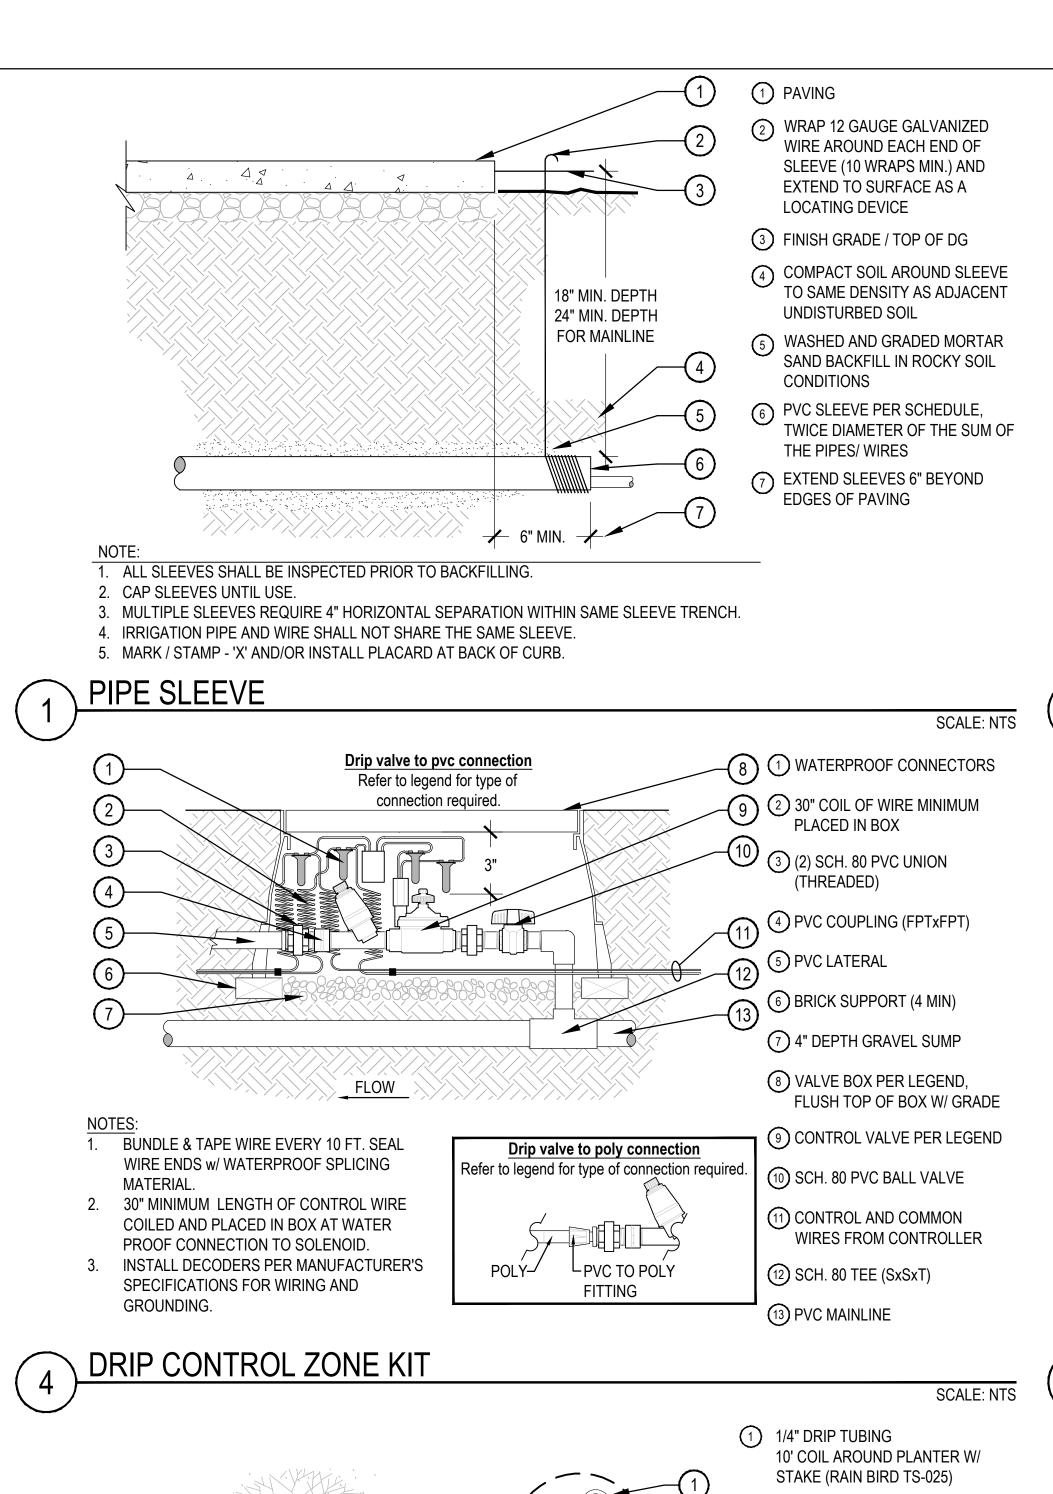

**ENLARGEMENT** 

SPRAY POP-UP

(2) HUNTER MPE-10 DRIP TRANSFER

4) DRIP COUPLING FITTING

5 1/2" POLYETHYLENE BLANK

(6) 1-1/2" CONDUIT SLEEVING -

(7) BLANK TUBING TO VALVE

(8) COMPACTED SUB GRADE

(10) FINISH GRADE

CONTRACTOR TO SEAL POT

OPENING AROUND SLEEVING


(9) PAVING PER LANDSCAPE PLANS

12) PLANTER PER LANDSCAPE PLANS

(11) DRAINAGE PER LANDSCAPE

1/2" DRIP MALE ADAPTER FITTING

COURTS, ETC.

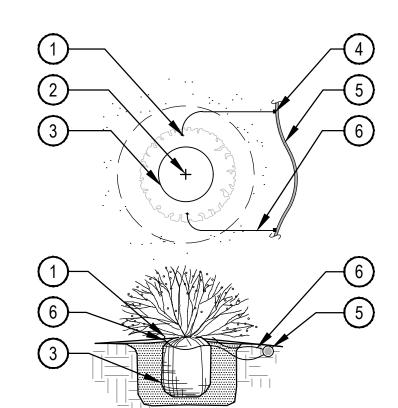

1. AFTER FLUSHING HEADS, REGRADE AND COMPACT AS NEEDED TO RETURN TO FINISH GRADE.

2. SPRINKLERS SHALL BE MIN. 6" FROM ANY WALLS, WALKS, COURTS, AND 12" FROM TURF EDGE.

5. COMPACT SOIL AROUND HEAD TO THE SAME DENSITY AS ADJACENT UNDISTURBED SUBGRADE.

3. ADJUST ALL SPRINKLERS HEADS SO THAT NO OVERSPRAY OCCURS ON ANY WALLS, WALKS,

4. ALL THREADED CONNECTIONS SHALL BE COATED WITH TEFLON TAPE.

. EMITTERS SHALL BE EQUALLY SPACED AROUND ROOTBALL

2. FLUSH ALL LINES THOROUGHLY PRIOR TO EMITTER INSTALLATION. 2. IF PLANTING ON A 4:1 SLOPE OR STEEPER, INSTALL EMITTERS ON THE UPHILL SIDE OF PLANT. 3. EMITTERS SHALL BE SELF-FLUSHING PRESSURE COMPENSATING-TYPE UNLESS NOTED

4. DRIP VALVE ZONES (HYDROZONES) ARE DESIGNED TO ACCOUNT FOR DIFFERENCES IN PLANT

REQUIREMENTS AND SUN EXPOSURE. 5. CONTRACTOR SHALL ENSURE HYDROZONES ARE VALVED SEPARATELY AS SHOWN ON PLAN.

SINGLE OUTLET EMITTER PLACEMENT

SCALE: NTS

(1) SNAKE PVC OR POLYETHYLENE PIPE IN TRENCH (2) EXCAVATED COVER MATERIAL

(SEE NOTES) (3) FINISH GRADE

(4) MAINLINE MARKING TAPE (PURPLE MARKING TAPE IF RECLAIMED)

POLYETHYLENE DRIP LATERAL/ DRIP PVC LATERAL PIPE (6" MIN. COVERAGE, 18" MIN. COVERAGE BELOW PEDESTRIAN WALKS.)

1. ALL MAINLINES TO BE INSTALLED IN ACCORDANCE WITH MANUFACTURER' SPECIFICATIONS. 6 IRRIGATION LATERAL PIPE

4. ALL ELECTRICAL WIRE CONNECTIONS TO VALVES AND SPLICES TO BE INSTALLED WITHIN A 8 VALVE WIRING

1 FINISH GRADE

SCHEDULE

(3) PVC LATERAL PIPE

(2) POP-UP SPRAY HEAD PER

(4) SWING JOINT ASSEMBLY

(5) PVC SCH. 40 TEE OR ELL (S x T)

(6) WALLS, WALKS, COURTS, CURB,

**SECTION** 

2. ALL PVC PIPING TO BE SNAKED IN TRENCHES AS SHOWN IN PLAN VIEW ABOVE.

6. VALVE WIRES TO BE INSTALLED WITHIN MAINLINE TRENCH WHEREVER POSSIBLE

VALVE BOX AND MADE WITH DBY WATERPROOF CONNECTORS, OR APPROVED EQUAL

7. BEDDING MATERIAL SHALL BE 1/4" MINUS SAND, AND SHALL BE 3" BELOW LOWEST PIPE OR

10. EXCAVATED COVER MATERIAL SHALL BE FREE FROM DEBRIS AND ROCKS 1/2" OR GREATER

11. PIPE BEDDING MATERIAL TO BE ROCK AND DEBRIS FREE, BACKFILL IN 6" LIFTS, PUDDLE WITH

3. ALL 120 VOLT WIRING IN CONDUIT TO BE INSTALLED AS PER LOCAL CODES.

WIRE AND 3" ABOVE HIGHEST PIPE OR WEIR WITHIN TRENCH.

9. BEDDING IS NOT REQUIRED IN POLYETHYLENE TUBING TRENCHES.

8. BEDDING MATERIAL SHALL BE IN MAINLINE TRENCH ONLY

6" MIN. OR PER

LOCAL CODE

5. BUNDLE AND TAPE WIRING AT 10' INTERVALS

WATER, BETWEEN LIFTS.

PIPE TRENCH

(7) IRRIGATION MAINLINE PIPE

(9) BEDDING MATERIAL (SEE NOTES)

SCALE: NTS

SCALE: NTS

1) DIFFUSER CAP W/ DRIP STAKE

2 PLANT CENTER

(3) PLANT ROOTBALL

4) SINGLE OUTLET EMITTER

(6) 1/4" DISTRIBUTION TUBING

(5) 3/4" POLYETHYLENE DRIP TUBING

(LENGTH NOT TO EXCEED 8')

LESS. REFER TO TWO-WIRE COMPONENTS MANUFACTURER'S RECOMMENDATIONS AND SPECIFICATIONS FOR INSTALLATION. 3. INSTALL GROUNDING PER ASIC'S GUIDELINES.

THE TWO-WIRE PATHS. WHEN POSSIBLE

6" MIN. OR PER

1 VALVE BOX WITH COVER PER LEGEND

**NORRIS** 

**DESIGN** 

**PEOPLE + PLACEMAKING** 

**NORRIS-DESIGN.COM** 

AMBI UNT WER

81 MC

OWNER:

EAST WEST PARTNERS

1550 WEWATTA ST

**DENVER, CO 80202** 

**CONTACT: RYAN STONE** 

303.319.6172

DATE:

03/15/2024 - IFC SET

04/11/2024 - RFI 18

04/11/2024 - RFI 19

06/13/2024 - RFI 85

06/18/2024 - RFI 84

409 MAIN STREET

P.O. BOX 2320

FRISCO, CO 80443

P 970.368.7068

SUITE 207

(2) FINISH GRADE

(3) WIRE FROM LINE SURGE PROTECTOR TO GROUNDING

ROD BRASS CLAMPS (1 OF 2) (4) GROUNDING ROD: 10 OHMS OR

 $\frac{5}{3}$  3 INCH MINIMUM DEPTH OF  $\frac{3}{4}$ 

INCH WASHED GRAVEL (6) LINE SURGE ARRESTOR

(7) WATERPROOF CONNECTORS

(8) WIRE FROM DECODER TO WIRE CONNECTOR

 INSTALL THE GROUNDING WIRE AND EACH GROUNDING HARDWARE AT RIGHT ANGLES FROM (9) BRICK (2 MINIMUM)

2. EACH GROUND SYSTEM SHALL MAINTAIN A MAXIMUM GROUND RESISTANCE OF 10 OHMS OR (10) TWO-WIRE CABLE/COMMUNICATION WIRE. SURGE PROTECTOR AT CONTROLLER ONLY

SURGE PROTECTION (CONTROLLER ONLY)

(1) FINISH GRADE (2) 12" POP-UP SPRAY HEAD PER

SCALE: NTS

3 PVC LATERAL PIPE PER SCHEDULE

SCHEDULE

(4) SWING JOINT ASSEMBLY

(5) PVC SCH. 40 TEE OR ELL (S x T)

(6) WALLS, WALKS, COURTS, CURB,

LOCAL CODE

1. AFTER FLUSHING HEADS, REGRADE AND COMPACT AS NEEDED TO RETURN TO FINISH GRADE.

2. SPRINKLERS HEAD SHALL BE LEVEL WITH SURROUNDING FINISHED GRADE. 3. ADJUST ALL SPRINKLERS HEADS SO THAT NO OVERSPRAY OCCURS ON ANY WALLS, WALKS, COURTS, ETC.

4. ALL THREADED CONNECTIONS SHALL BE COATED WITH TEFLON TAPE.

5. COMPACT SOIL AROUND HEAD TO THE SAME DENSITY AS ADJACENT UNDISTURBED SUBGRADE

∫6" MIN.

12" MAX

2. ALL EMISSION POINTS SHALL BE LOCATED ON UPHILL SIDE OF PLANT MATERIAL. ONE

4. THIS IS A WATERING GUIDE ONLY. SITE, SOIL AND PLANT CONDITIONS VARY GREATLY.

CONTRACTOR MUST OBSERVE THE PLANT MATERIAL AND MAKE ADJUSTMENTS AS

CALIPER OR GREATER OR CONIFEROUS TREES 10' OR GREATER IN HEIGHT

EMISSION POINT SHALL BE DIRECTLY TO PLANT BALL AS INDICATED. ADDITIONAL EMISSION

POINTS SHALL BE WITHIN PLANT PIT PERIMETER AS DIRECTED IN THE EMITTER SCHEDULE.

3. SECOND EMISSION POINTS (IF NEEDED) AS PER THE EMITTER SCHEDULE FOR TREES WITH 3"

12 INCH POP-UP SPRAY

SCALE: NTS

(1) EMISSION POINT. DIFFUSER CAP W/ DRIP STAKE (TYP.)

(2) PLANT ROOT BALL (TYP.)

**NOTE 3 BELOW** 

(3) PLANT CENTER (TYP.) (4) SECOND EMISSION POINTS SEE

(5) TREE TRUNK

(6) MULCH LAYER

7) 1/4" DISTRIBUTION TUBING (LENGTH NOT TO EXCEED 8')

(8) 3/4" POLYETHYLENE DRIP TUBING

(9) SINGLE OUTLET EMITTER

(10) ROOTBALL

TREE EMITTER PLACEMENT

1. MAXIMUM LENGTH OF ONE DISTRIBUTION TUBE SHALL BE 8'

NECESSARY FOR PROPER PLANT WATER REQUIREMENT

SCALE: NTS

SHEET TITLE: **IRRIGATION DETAILS** 

LI-3.01


98

PLANTER FOR MAINTENANCE PURPOSES

CONDUIT SLEEVING TO EXTEND 2 FEET FROM PLANTER BOX.

CONTRACTOR SHALL ALLOCATE ADDITIONAL LENGTH IN BLANK TUBING WITHIN

IN-LINE DRIP EMITTERS IN RAISED PLANTERS

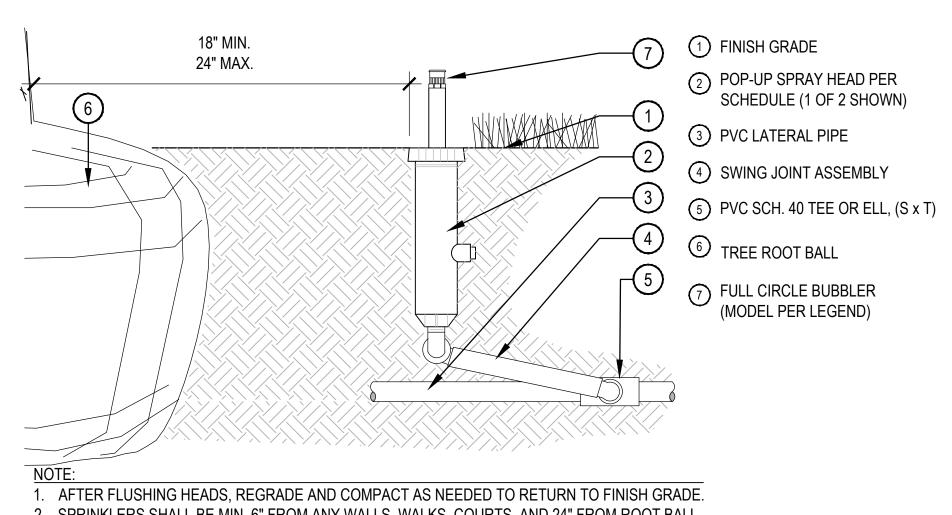

- 2. SPRINKLERS SHALL BE MIN. 6" FROM ANY WALLS, WALKS, COURTS, AND 24" FROM ROOT BALL.
- 3. ADJUST ALL SPRINKLERS BODIES SO THAT NO FLODDING OCCURS ON ANY WALLS, WALKS, COURTS, ETC.
- 4. ALL THREADED CONNECTIONS SHALL BE COATED WITH TEFLON TAPE.
- 5. COMPACT SOIL AROUND HEAD TO THE SAME DENSITY AS ADJACENT UNDISTURBED SUB-GRADE.
- 6. 1 OF 2 ASSEMBLIES SHOWN

POP-UP BUBBLER


SINGLE OUTLET EMITTER

SCALE: NTS

1/4" DISTRIBUTION TUBING. RUN TUBING UNDER WEED BARRIER FABRIC TO PLANT. LENGTH NOT TO EXCEED 8'

- 2 UNIVERSAL 1/4" STAKE
- 3 DIFFUSER CAP 4 TOP OF MULCH
- 5 PRESSURE COMPENSATING EMITTER PER EMITTER SCHEDULE. INSTALL EMITTER AT 45° TO 60° ANGLE
- (6) 3/4" POLYETHYLENE TUBING SET WITH TOP OF TUBING FLUSH WITH FINISH GRADE OF SOIL
- 7 FINISH GRADE OF SOIL
- 8 WEED BARRIER FABRIC

SCALE: NTS

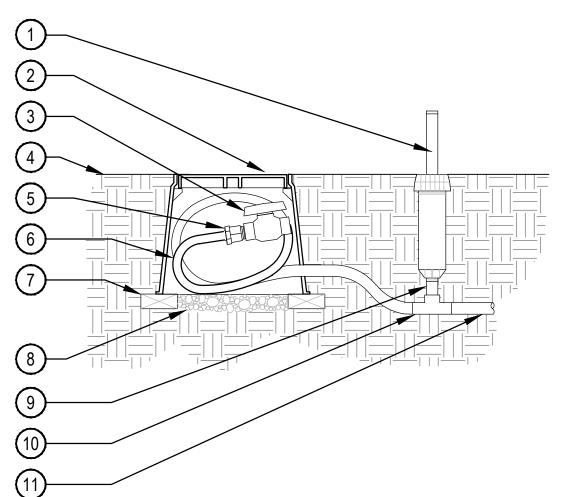

1. COMPACT SOIL AROUND VALVE BOX TO THE SAME DENSITY AS ADJACENT UNDISTURBED SUBGRADE.

2. INSTALL OPERATIONAL INDICATOR WITHIN 24" OF FLUSH VALVE. 3. ALL THREADED CONNECTIONS SHALL BE COATED WITH TEFLON TAPE. 6" MIN. POP-UP HEAD WITH ENCLOSED NOZZLE AND SWING PIPE. (ZONE OPERATIONAL INDICATOR)

2 LOCKING ROUND BOX & COVER PER SCHEDULE. TOP OF BOX TO

BE FLUSH WITH FINISH GRADE

3 3/4" SCH. 40 PVC BALL VALVE

4 FINISH GRADE 3/4" MXI MALE ADAPTER W/

CLAMPS 6 3/4" POLYETHYLENE DRIP TUBING - 24" COIL IN BOX FOR MAINTENANCE

7) BRICK (2 REQUIRED MIN.)

8 3/4" GRAVEL SUMP, 4" DEPTH

9 1/2" SCH. 80 NIPPLE (LENGTH AS NEEDED)

① 3/4"x3/4"x1/2" lxlxF INSERT TEE

11) POLY LATERAL

DRIP FLUSH VALVE WITH OPERATIONAL INDICATOR

SCALE: NTS

**NORRIS** 

**DESIGN** 

PEOPLE + PLACEMAKING

**NORRIS-DESIGN.COM** 

409 MAIN STREET


P.O. BOX 2320

FRISCO, CO 80443 P 970.368.7068

SUITE 207

EAST WEST PARTNERS

1550 WEWATTA ST DENVER, CO 80202 CONTACT: RYAN STONE 303.319.6172

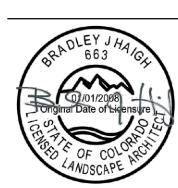

03/15/2024 - IFC SET 04/11/2024 - RFI 18 04/11/2024 - RFI 19 <u>06/13/2024 - RFI 85</u> <u>06/18/2024 - RFI 84</u>

> SHEET TITLE: **IRRIGATION**

LI-3.02

**DETAILS** 

BH, TA, JS TA, JS, AM