

3. PROVIDE A JUNCTION BOX AT 8-INCHES ABOVE POOL DECK IN AN APPROPRIATE LOCATION IN ACCORDANCE WITH ARTICLE 680.24 OF THE 2017 NEC.

TOTAL

54.4

CONTROLLER

SPA JET

FILTER

SKIMMERS

SPA CIRCULATION

PENTAIR

PENTAIR

PENTAIR

STARBRITE

WISPERFLOW

WISPERFLOW

TR-20

SP-1070

SHEET NOTES:

- 1. SPA IS INSIDE THE NEW HOLIDAY INN EXPRESS IN STEAMBOAT SPRINGS CURRENTLY UNDER CONSTRUCTION. SPA AREAIS NOT ACCESSIBLE WITHOUT FACILITY KEY. ALL DOORS AND GATES TO POOL AREA SHALL BE SELF CLOSING AND SELF-LATCHING (BY OTHERS). 2. LATCHES SHALL BE OF ONE OF THE FOLLOWING TYPES:
- 2.1. CONTINUOUSLY LOCKED
- 2.2. CODED 2.3. OR RAISED 60 IN. OR MORE IN HEIGHT
- GATES SHALL HAVE A SEPARATE LOCKING METHOD TO LOCK DOORS WHEN POOL IS CLOSED.
- HAND ACTIVATED DOOR OPENING HARDWARE HEIGHT SHALL BE AT A MIN. HEIGHT OF 60 IN. POOL AREA DECK (INSTALLED BY OTHERS) SHALL BE IMPERVIOUS TO WATER, CLEANABLE, WATER-SEALED, AND SLIP RESISTANT. CONCRETE W/ LIGHT BROOM FINISH.
- POOL WALLS AND FLOORS MUST BE WHITE OR LIGHT PASTEL PLASTER.
- ALL STEPS AND POOL SURFACES SHALL HAVE A NON-SLIP SURFACE. CONTRASTING STRIPE
- 8.1. ALL EDGES OF STEPS AND/OR BENCHES SHALL HAVE A 2 IN. STRIPE OF CONTRASTING COLOR ON THE HORIZONTAL FACE.
- ALL EDGES OF LEISURE DECKS SHALL HAVE A 2 IN. STRIPE OF CONTRASTING COLOR ON BOTH THE HORIZONTAL AND VERTICAL SURFACE.
- 4 IN. STRIPE OF CONTRASTING COLOR ON POOL WALLS AND FLOOR AT ANY GRADE BREAK GREATER THAN 1:12.
- HOSE BIBBS WITH BACK FLOW PREVENTION SHALL BE INSTALLED SO THAT ALL AREAS OF THE DECK CAN BE REACHED BY A 150 FT. HOSE.
- 10. THERE SHALL BE NO STEPPING POINTS, INCLUDING POSTS AND CABLE BOXES, NEAR THE
- 11. SIGNS SHALL BE INSTALLED PRIOR TO PRE-OPENING INSPECTION.
- 12. DECKING SHALL BE SLOPED AT A MIN OF $\frac{1}{4}$ IN. PER FT. AND A MAX OF $\frac{1}{2}$ IN. PER FT. AWAY FROM POOL AND BUILDING TO ENSURE POSITIVE DRAINAGE TOWARD LANDSCAPE AREAS AND/OR DECK DRAINS.

DECK AREA: 492 SF WATER AREA: 236 SF DECK TO WATER RATIO: 1 TO 2.1

XFE-20 5 HP, High Efficiency

XFE-8 2 HP, High Efficiency XF-8 2 HP, Standard Efficiency XFDS-8 2 HP, 2-Speed

XFE-30 2.5 HP, High Efficiency, Uprated XF-30 2.5 HP, Standard Efficiency, Uprated

XFDS-30 2.5 HP, 2-Speed, Uprated


XFK-8 2 HP, 3-Phase, TEFC Motor

XFDS-12 3 HP, 2-Speed

XFK-20 5 HP, 3-Phase, TEFC Motor XFE-12 3 HP, High Efficiency

SPA CALCULATIONS										
AREA	237	SF								
PERIMETER	68	LF								
VOLUME	664	CF	4964	GAL						
DECK JET MAIN DRAIN	7.065	SQ-IN	8.2	FPS						
DECK JET SUCTION PIPE SIZE/FLOW - TRUNK LINE	3	IN	8.2							
DECK JET RETURN LINE SIZE/FLOW - TRUNK LINE	3	IN	8.2							
DECK JET FLOW RATE			180	GPM						
DECK JET TDH			69	FT						
POOL PATRON LOAD	10 BATHERS									

PUMP CURVE

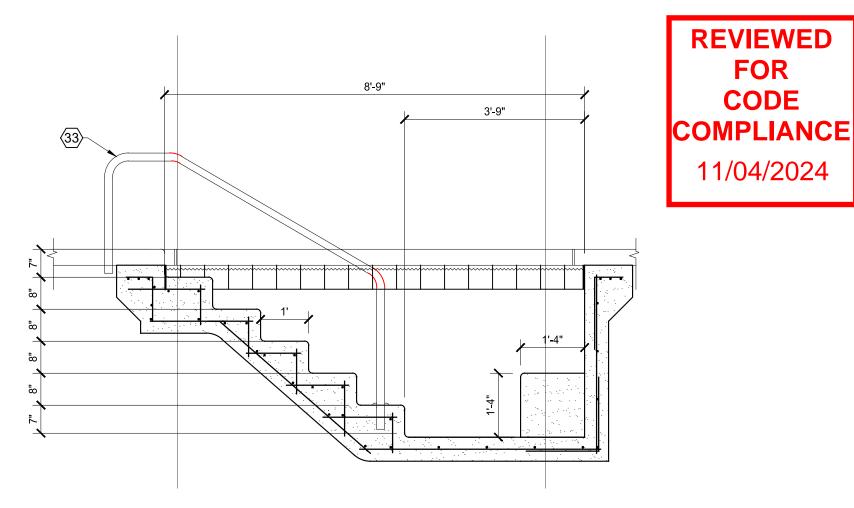

SECTION C-C

SCALE: NTS

GENERAL REQUIREMENTS

- 1. MAXIMUM WATER VELOCITY IN BRANCH SUCTION WILL BE LESS THAN 6 FEET PER SECOND.
- 2. MAXIMUM WATER VELOCITY IN CIRCULATING PIPING SYSTEM IS LESS THAN 10 FEET PER SECOND.
- 3. A VACUUM BREAKER SHALL BE PROVIDED AND LOCATED ON THE DISCHARGE SIDE OF THE FINAL VALVES AND BY AT LEAST 6-INCHES ABOVE THE OVERFLOW RIM.
- 4. ALL EQUIPMENT, PIPING AND VALVES SHALL COMPLY WITH CITY OF ALBUQUERQUE ADOPTED CODES.
- 5. A FLOOR DRAIN WILL BE PROVIDED IN THE MECHANICAL ROOM AND DISCHARGE TO THE SANITARY SEWER.

KEYED NOTES (

(1) GENERAL: ALL WORK AND MATERIALS SHALL CONFORM TO ALL APPLICABLE CODES AND REGULATIONS.

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POOL CONSTRUCTION SHALL BE REINFORCED **GUNITE AS FOLLOWS:**

GUNITE: 4,000 PSI (MIN) REINFORCING: GRADE 60 (ASTM A615) AMERICAN CONCRETE INSTITUTE SPECIFICATIONS: (ACI 318, ACI 506, ACI C06.2)

- $\langle 2 \rangle$ ADA COMPLIANT SWIMMING POOL LIFT, AQUATRAM, OAE
- (3) WATERLINE
- 4 6" GUNITE WALL WITH #3 BARS AT 12" CENTERS EACH WAY
- 6" GUNITE BOTTOM WITH #3 BARS AT 12" CENTERS EACH WAY WHERE WATER
- 6 8" MAINDRAIN PARAMOUNT SDX2 HIGH FLOW SAFETY DRAIN PRODUCT NO. 004-162-2215-01 WITH HYDROSTATIC RELIEF
- (7) COMPACT TO 95% OF MAXIMUM DENSITY AT OPTIMUM MOISTURE CONTENT PER ASTM D-1557.
- 8 4" CONCRETE SLAB WITH 6X6, W1.4 X W1.4 WWF ON COMPACTED EARTH / FILL SLOPE FROM SPA
- $\langle 9 \rangle$ NOT USED
- (10) NON-SLIP 6" DEPTH AND NO DIVING MARKER

VALVE (HAYWARD, AQUASTAR, OAE.)

(11) RECESSED LIGHT

 $\frac{1}{4}$ " PER FOOT: (MIN)

- 12 FILL & AUTOFILL PER DETAILS SHEET 3
- (13) SKIMMER (SEE DETAIL 3/2) (PENTAIR STA-RITE U-3 SKIMMER
- NO. 08650-1404, 8.5" WIER, ÔAE).
- (14) 3-#3 BARS CONTINUOUS AT BOND BEAM: (LAP 18" MIN)
- 43 BAR AT 12" CENTERS VERTICAL
- (16) #3 BAR AT 12" CENTER HORIZONTAL
- TRANSVERSE REINFORCING: #3 BAR AT 12" CENTERS, LAP INTO WALL 18"
- (18) LONGITUDINAL REINFORCING: #3 BAR AT 12" CENTERS.
- (19) 6" GUNITE BOTTOM WITH #3 BAR AT 12" CENTERS EACH
- (20) 6" FROST PROOF TILE
- (21) NOT USED
- 22 NOT USED
- (23) CONDUIT
- (24) ELECTRICAL PANEL (SEE ELECTRICAL)
- 25 RETURN
- (26) NOT USED
- 27 ELECTRICAL: BONDING SHALL BE AS PER NEC 680-22 GROUND FAULT PROTECTION SHALL BE AS PER NEC 680-20
 - JUNCTION BOX 8" ABOVE DECK AS PER NEC 680-21
- (28) TO PUMP SUNCTION
- 29 GUNITE.
- 30 3-INCH PVC SCHEDULE 80
- RECESSED TREADS - MIN. DEPTH OF 5-INCHES AND WIDTH

FOR

CODE

11/04/2024

- SR SMITH THREE-BEND STAIR RAIL W/ EXTENSION ON POOL LEG PRODUCT NO. 3HR-R-4; STAINLESS STEEL TUBE WITH
- (34) DECK TRENCH DRAIN
- SUMP PIT INSTALL PUMP AND OUTLET PIPE TO SANITARY 35 WASTE LINE

BUILDING CODE.

NOTE

DESIGN IS IN ACCORDANCE WITH 2015 IBC INTERNATIONAL


WATER TURNOVER

SPA TURN OVER RATE IS APPROXIMATELY 28 MINUTES.

TRITON II SAND FILTERS												
Product M	Model Filtrtatio		Flow Rate	Flow Rate (GPM Comm)	Turnover Capacity (Gallons)		uran Maria					
		Effective Filtrtation Area (Sq Ft)			8 Hour	10 Hour	12 Hour	Filter Media Pea Gravel Required (Lbs)	Filter Media Sand Required (Lbs)	All Sand Required (Lbs)	Carton Qty	Carton Wt (Lbs)
140236	TR 40	1.92	38	38	18240	22800	27360	50	125	175	1	25
140249	TR 50	2.46	49	49	23520	29400	35280	50	175	225	1	34
140264	TR 60	3.14	63	63	30240	37800	45360	75	250	325	1	40
140210	TR 100	4.91	98	74	47040	58800	70560	150	450	600	ä	65
140243	TR 140	7.06	141	106	67680	84600	101520	275	650	925	1	75

FILTER RATES 2 EACH TR100 REQUIRED AT 98 GPM EACH

SEPTEMBER 5, 20 SHEET:

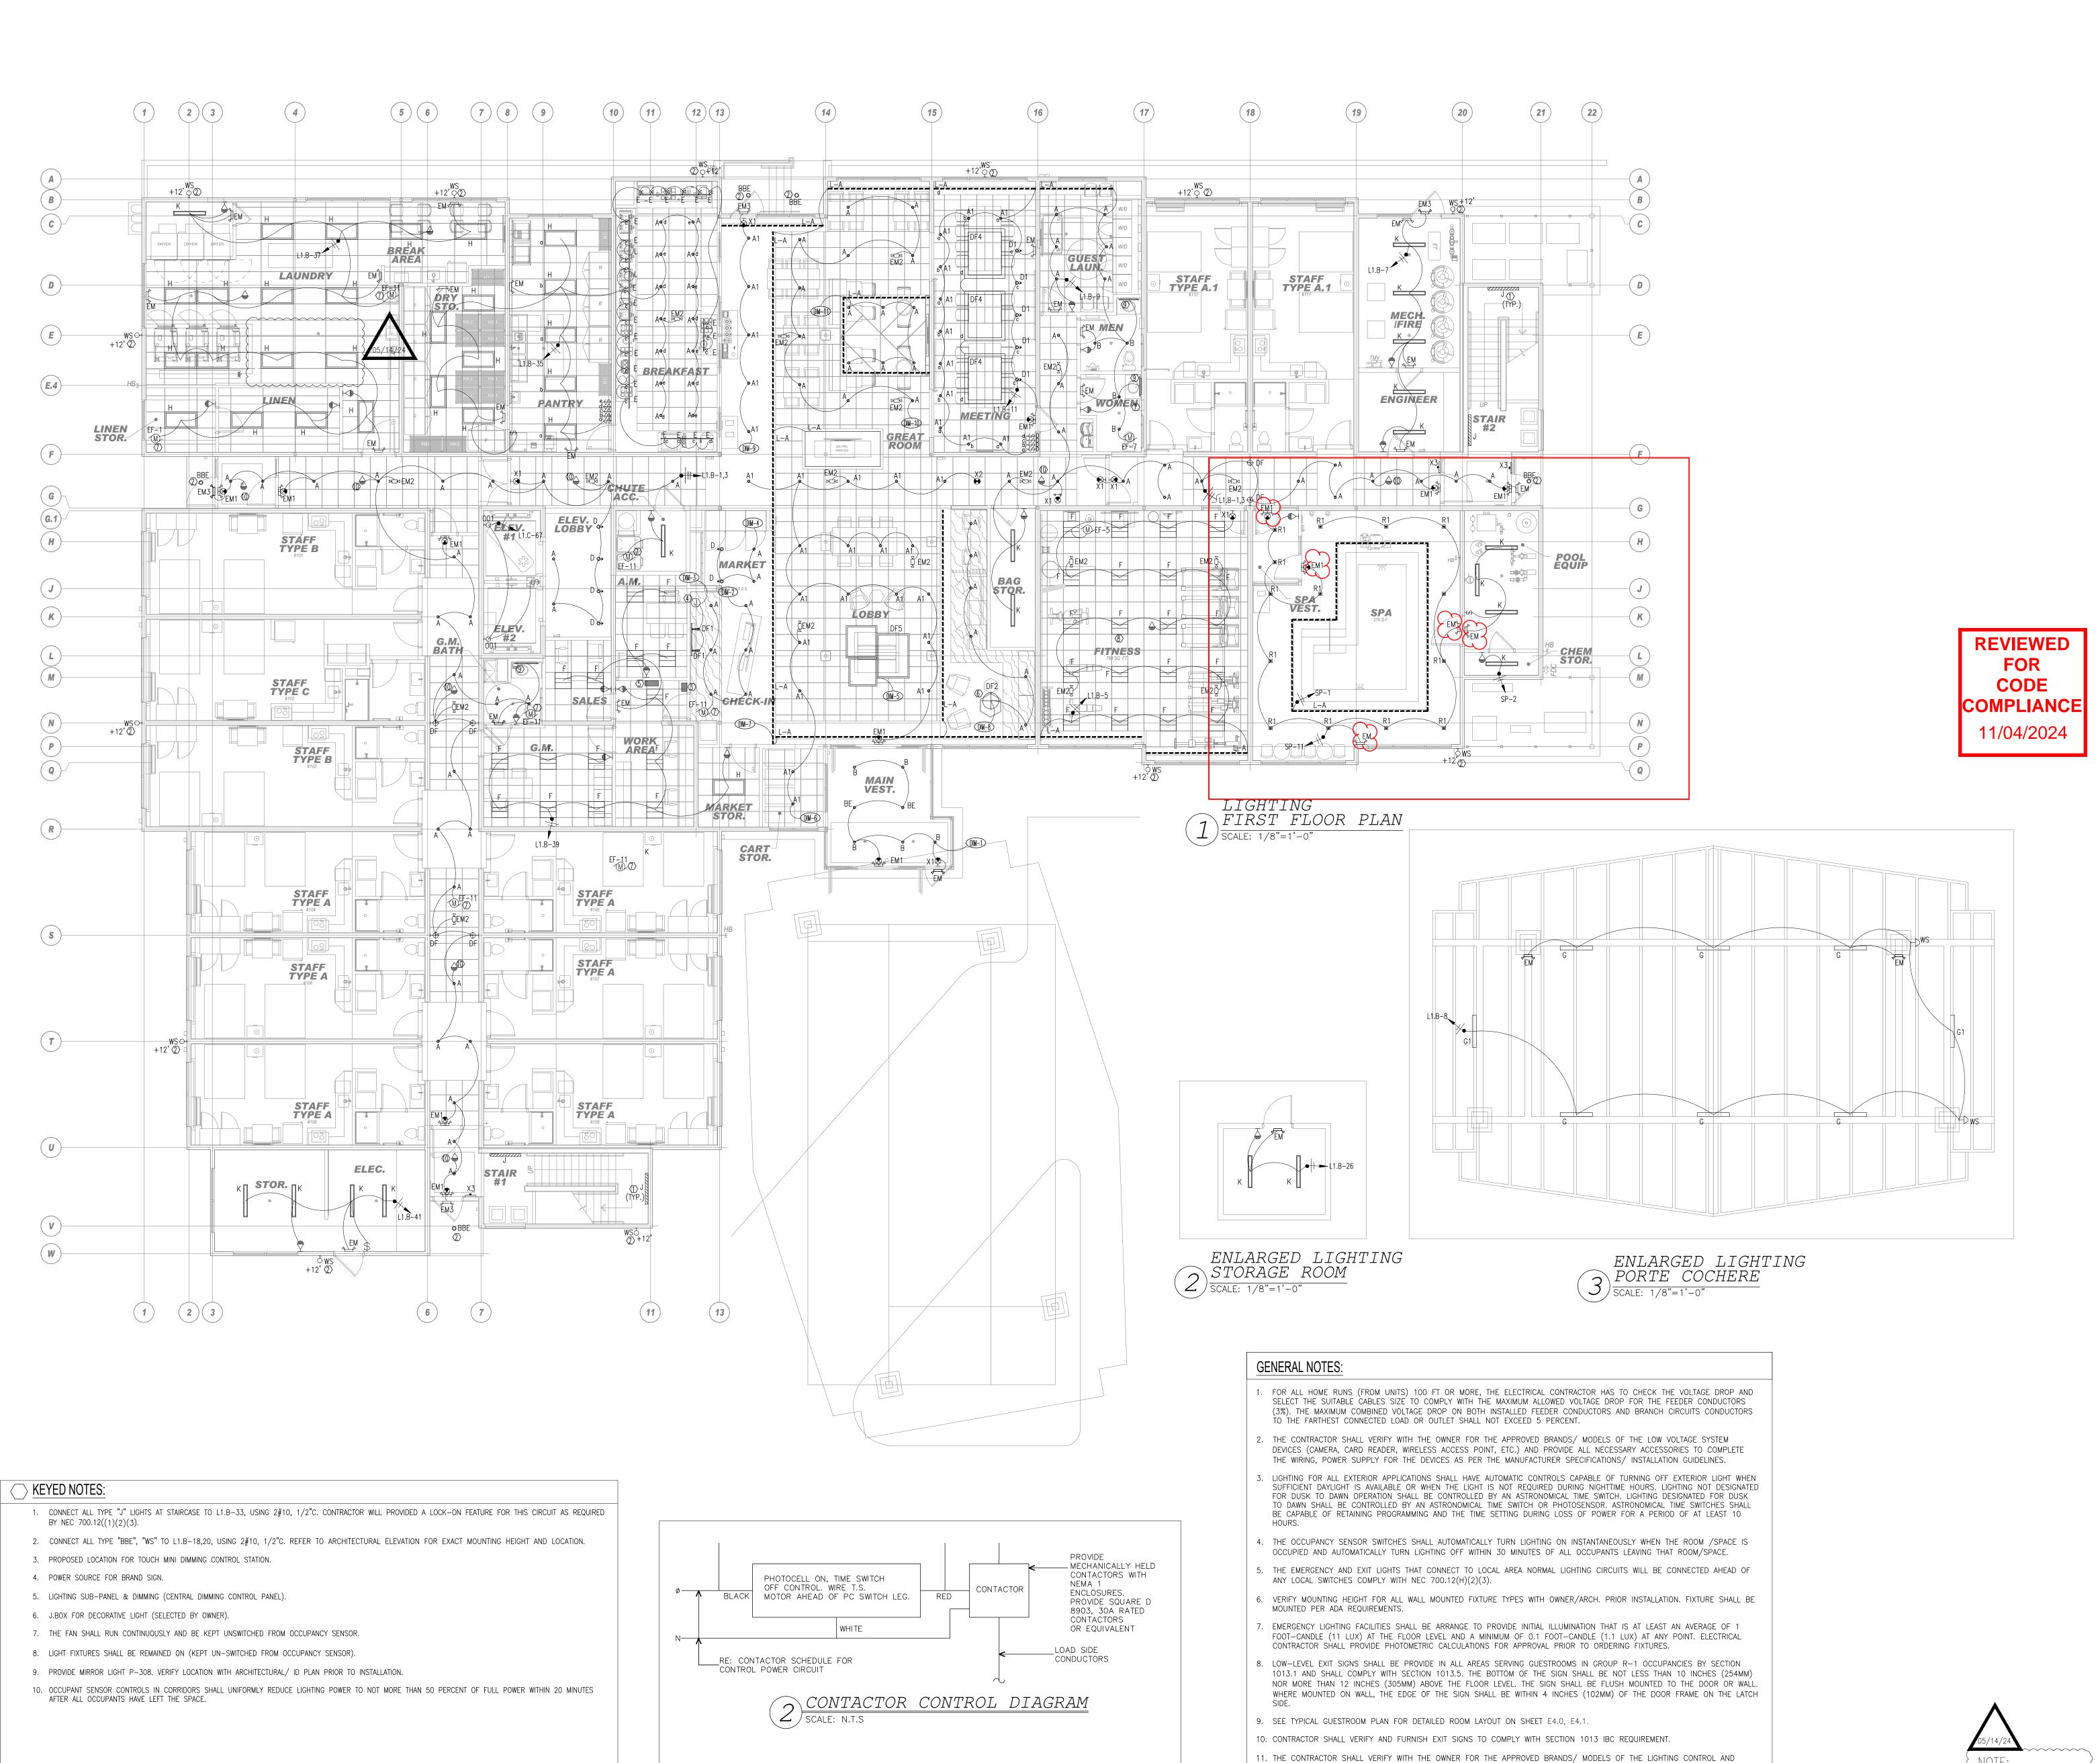

PROVIDE ALL NECESSARY ACCESSORIES TO COMPLETE THE WIRING, POWER SUPPLY FOR THE DEVICES AS PER THE


12. THE ELECTRICAL CONTRACTOR SHALL COORDINATE WITH THE SPRINKLER CONTRACTOR FOR THE PLACEMENTS OF THE LIGHT FIXTURES AND SPRINKLER HEADS TO COMPLY WITH THE NFPA 13 REQUIREMENTS.

13. SUFFICIENT EMERGENCY LIGHTING LEVELS WILL BE DETERMINED DURING THE ONSITE INSPECTION. ADDITIONAL EMERGENCY LIGHTING MAY BE REQUIRED BY FIELD INSPECTOR IF DEEMED INSUFFICIENT

MANUFACTURER SPECIFICATIONS/ INSTALLATION GUIDELINES.





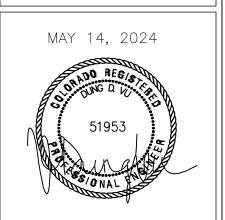

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DRAWING ISSUE DATES: 8/18/23 Permit Set

REVISION DATES: 10/19/23 Staff/GM Toilets, Permit Revisions 11/29/23 Mt. Werner Revisions 02/15/24 Pool Removal, Guest Room Addition 03/05/24 Updated plans 05/14/24 Updated plans


PROJECT MANAGER:

DRAWN BY:

NEW BACKGROUND

SHEET TITLE: LIGHTING FIRST FLOOR PLAN

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- 1. FOR GENERAL NOTES, PLUMBING FIXTURES AND SPECIFICATIONS, SEE PLUMBING DRAWING P1.0, P1.1.
- 2. FOR DRAWING CLARITY, SEE THE VENT PIPING WITH SIZING ON RISER DIAGRAM P4.0, P4.1
- 3. ALL PENETRATIONS THROUGH FIRE WALL MUST BE SEALED TO MEET THE CRITERIA.
- 4. FOR SCHEMATIC DIAGRAMS SEE PLUMBING DRAWING P4.0, P4.1 5. FOR GAS SCHEMATIC DIAGRAM SEE PLUMBING DRAWING P1.1
- 6. ALL FLOOR DRAINS TO BE INSTALLED W/TRAP SEALS.
- 7. PROVIDE DRAIN & VENT FOR SWIMMING POOL PER RECOMMENDATION OF POOL EQUIPMENT SUPPLIER.
- 8. CONTRACTOR TO SUPPLY THE TEMPERED WATER LIMITING DEVICE FOR WATER HEATER SYSTEM
- 9. VACUUM RELIEF VALVE INSTALLED IN THE COLD WATER SUPPLY LINE ABOVE THE TOP OF THE HEATER OR TANK, SHALL BE PROVIDED TO PREVENT SIPHONING OF ANY STORAGE WATER HEATER OR TANK.
- 10. DRAIN SIZES FROM PLUMBING FIXTURES SHALL BE AS FOLLOWS: WATER CLOSETS- 3"ø
- BATHTUB 2"ø LAVATORY – 2"ø FLOOR DRAIN (GUESTROOM)- 2"ø FLOOR DRAIN (PUBLIC AREAS) — 3"ø

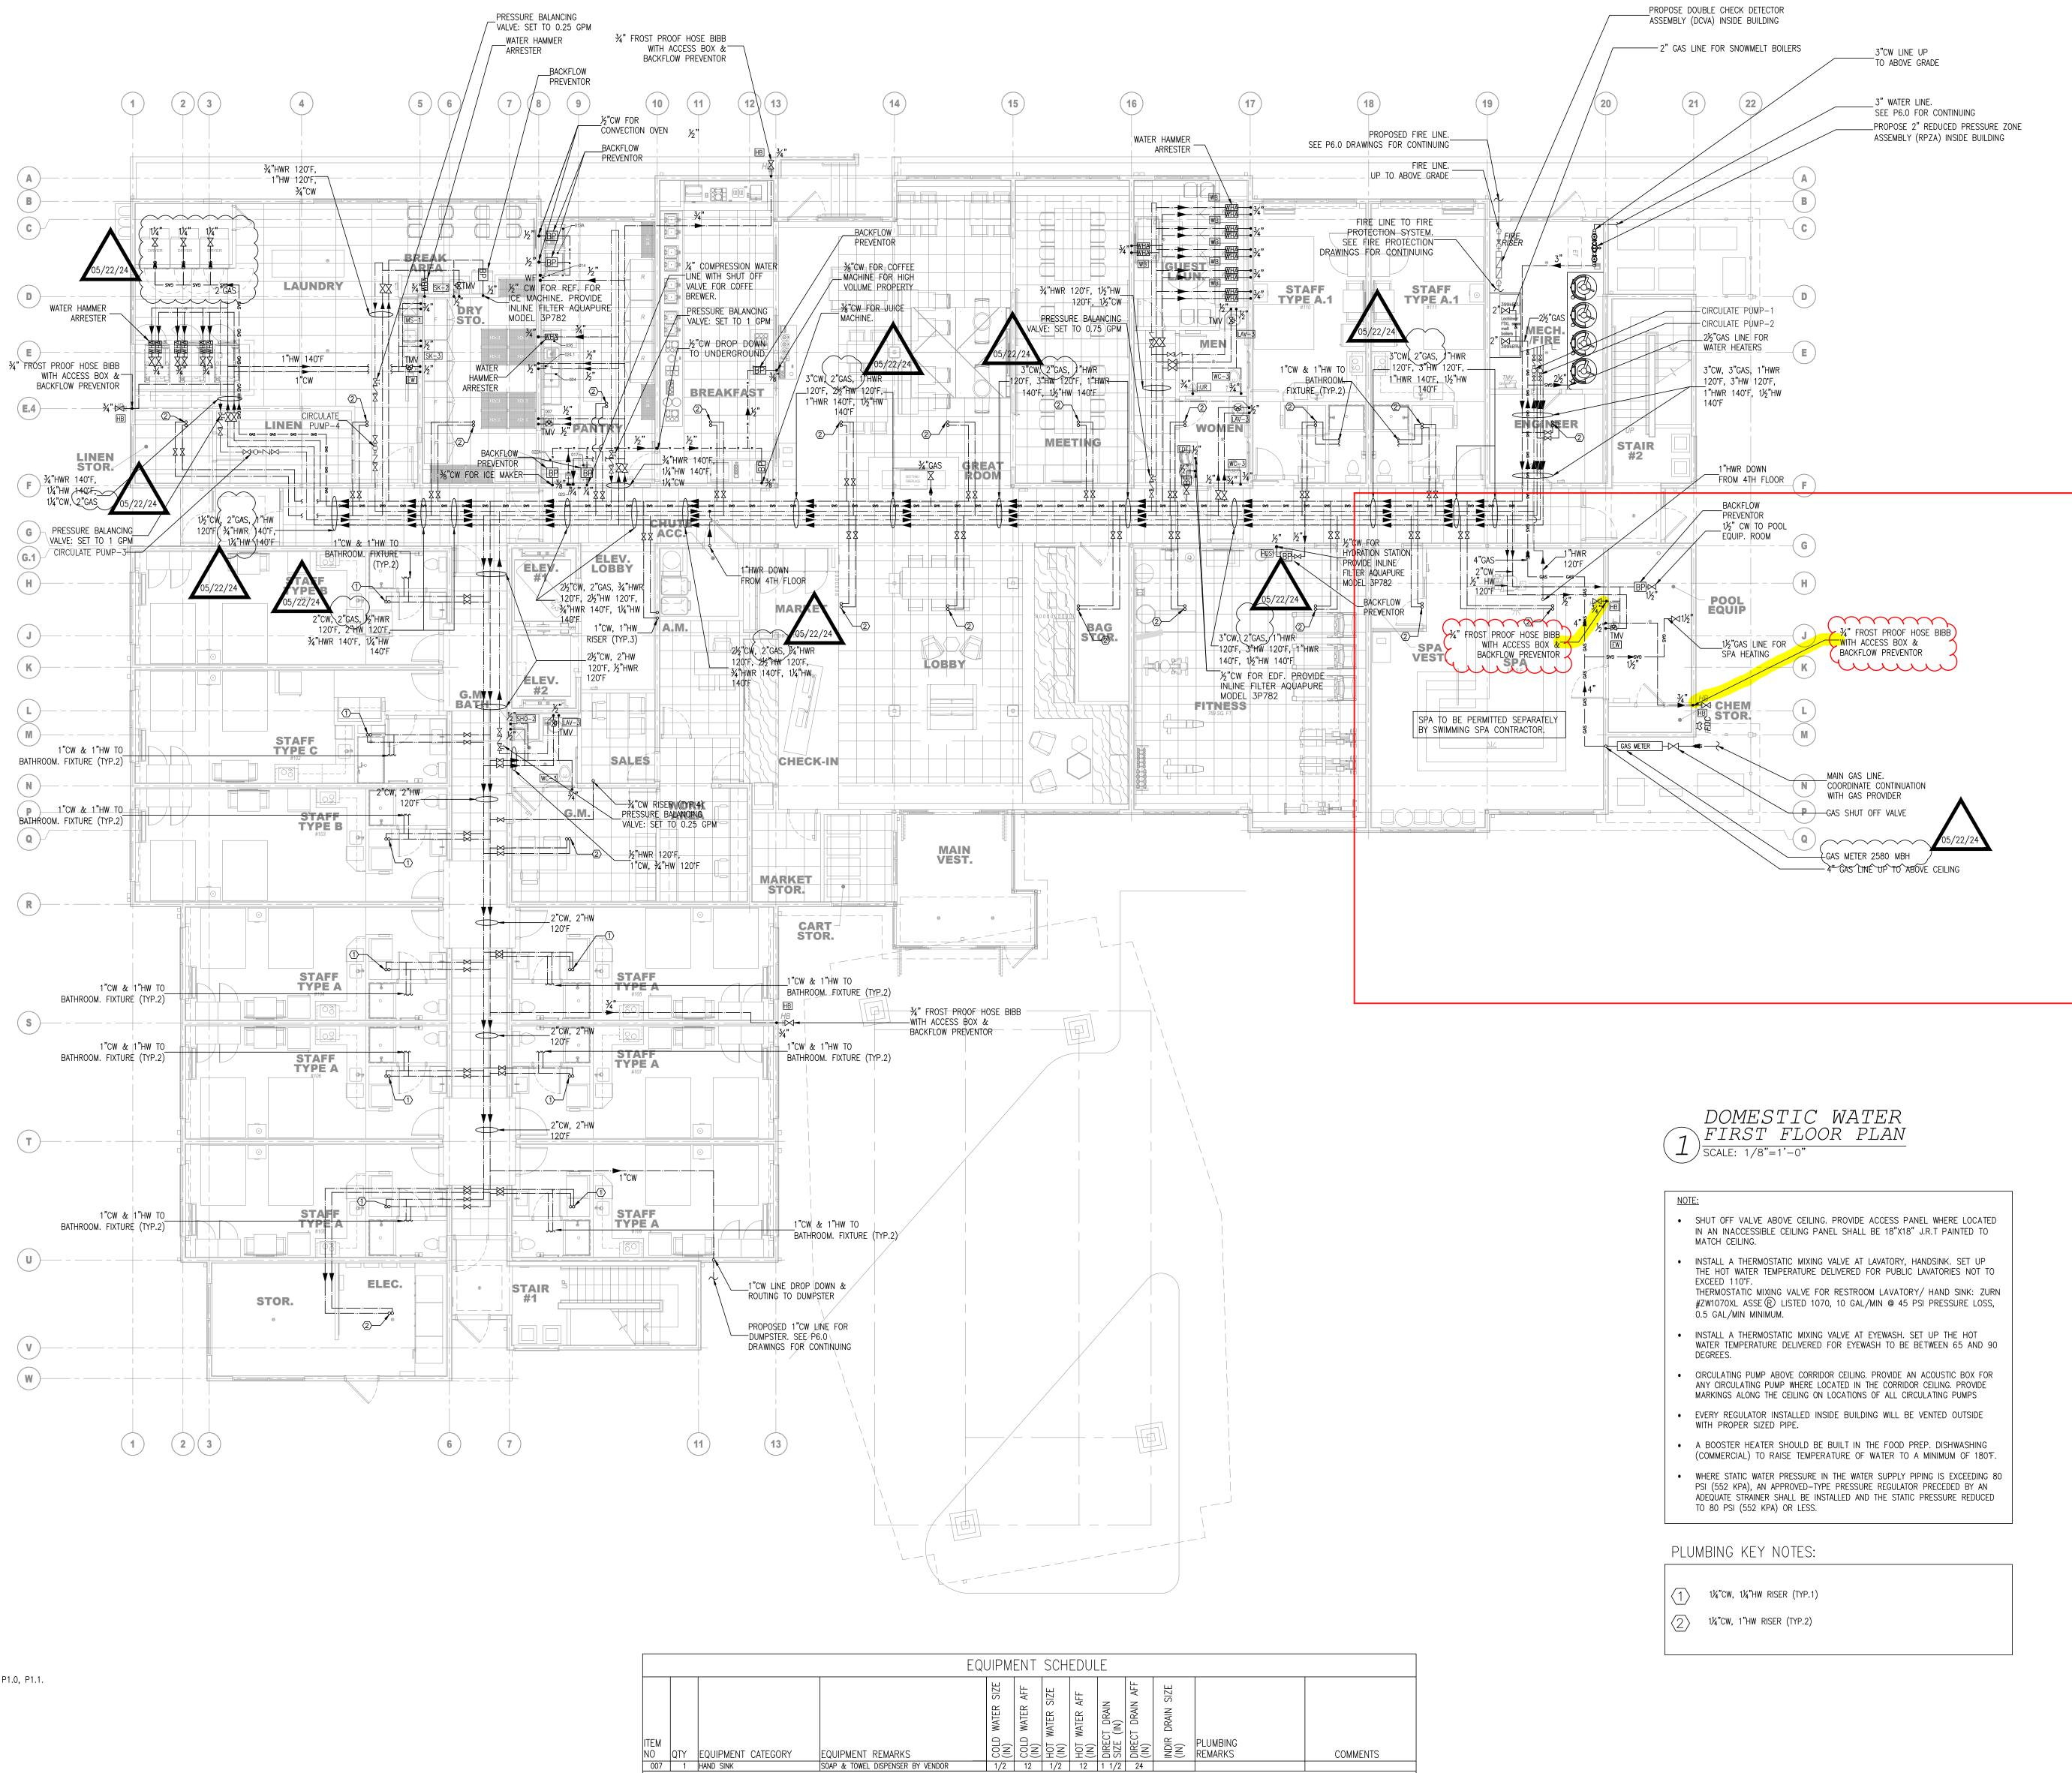
FLOOR SINK - 3"ø

INSTALLED

1. THE PLUMBING CONTRACTOR MUST PREPARE SHOP DRAWING TO COORDINATE WITH STRUCTURAL ENGINEER BEFORE INSTALLING AND GUARANTEE THE WATER, SEWER AND STORM LINE DO NOT RUNNING ALONG WITH THE GRADE BEAMS.

SUFFICIENT HOT WATER THAT DELIVERS TO EVERY GUESTROOM UNIT BEFORE CEILING TILE IS

2. THE CONTRACTOR MUST PERFORM THE COLD/HOT WATER BALANCING TO ENSURE

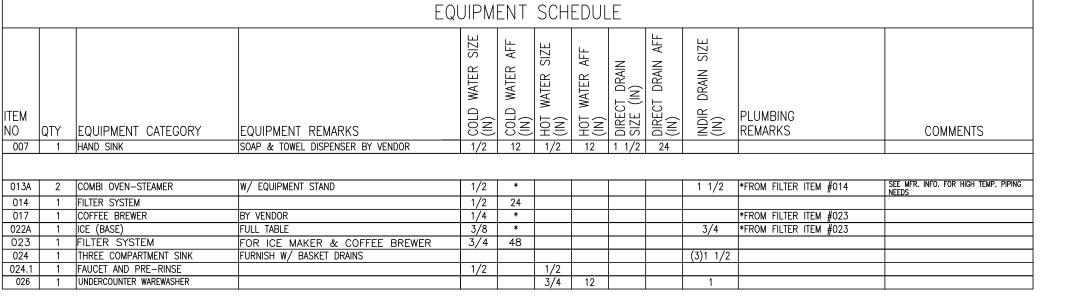

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COMPLIANCE

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PROJECT MANAGER: DRAWN BY:

SHEET TITLE: DOMESTIC WATER FIRST FLOOR PLAN