All work must comply with state and local codes, based on the City of Steamboat Springs Community Development Code, the 2021 International Building Code, the 2021 International Plumbing Code, the 2021 International Mechanical Code, the 2021 Energy Conservation Code and the 2023 National Electric code. The contractor shall comply with all laws, ordinances, rules and regulations of any public authority bearing on the performance of the work, including O.S.H.A.

Location of the utilities (electrical, telephone, cable TV, gas, water, sewer) shall be verified before construction begins.

All on site construction safety and construction means and methods are the responsibility of the contractor. There is no implication of the construction safety requirements or building methods contained in these drawings.

Actual site conditions may require that some of the components of the work should be done differently than shown on these drawings. All dimensions and conditions to be verified by the contractor prior to construction. Verify changes with the designer and engineer.

These drawings represent a simplified builder's set of plans. Additional detailing may be required of the engineer during construction

Any variation which requires a physical change from these plans must be brought to the attention of the designer and engineer in order to maintain the design intent of the project.

All work connected with this project by any trade involved shall be of the highest quality attainable in accordance with the professional practice of the trade.

DIMENSIONS

All interior and exterior dimensions are to face of stud or face of concrete, U.N.O.

All exterior walls are nominal 2x6 stud construction, U.N.O. All interior walls are nominal 2x4 stud construction, U.N.O.

Do not scale drawings

The water closet stool shall be located in a clear space of not less than 30" in width. The clear space in front of the water closet stool shall be not less than 21"

Crawl space access shall be provided w/ min. 18"x24" through the floor \$ min. 16"x24" through the wall.

Minimum clear ceiling height is 7'-6'' for habitable space \$ hallways \$ 6'-8'' for bathrooms, laundry rooms \$ stairs. Exceptions apply for sloped ceilings and basements per IBC 1003.2

If any discrepancies are found in these drawings notify engineer and/or designer immediately.

Exterior roofs, flashing, ledges, concrete \sharp other surfaces shall slope min. $\frac{1}{2}$:12 to prevent water ponding. Landinas shall also slope max. 1/4:12 to prevent slipping. Covered garages or carports floor surface shall slope min. 1/8:12 to provide positive drainage to drain, unless surfaced with asphalt.

STAIRWAYS:

Stairs shall have a minimum 44" clear width or min. 36" if serving an occupant load less than 50. The surface of stairs shall be slip resistant. Minimum vertical headroom is 6'-8" from the nosing. Maximum riser height is 7", and minimum tread depth is 11".

Landings shall be provided at the top and bottom of each stairway with a length no less than the width of the stairway served. Landings are not required at the top of interior stairs provided that a door does not swing over the stairs.

Handrails shall be provided on at least one side of each continuous stair flight with four or more risers, and shall be 34"-38" tall, measured vertically from the sloped plane of the tread nosings. Handrails shall comply with section IBC Section 1014

Open sides of stairways, landings, ramps, balconies and porches which are more than 30" above grade shall be protected by a guardrail. All guardrails must be 36" above finished floor and shall allow no more than a 4" diameter sphere to pass through any portion of the railing per IBC Sec. 1012.10.2

Walls and ceilings of enclosed usable space under stairs requires 1/2" gypsum wallboard. The door to access such spaces need not be rated.

Habitable spaces within dwelling units shall have natural light provided by exterior openings equal to 8% of the floor area. Natural ventilation shall be provided by means of operable exterior openings equal to 4% of the floor area.

Safety glazing shall be provided in the following hazardous locations:

- 1) In doors where glazed opening is greater than $3^{\circ}\phi$ 2) Within 24" adjacent to doors if less than 60" above the walking surface
- 3) Single panes where all following conditions exist: greater than 9 sq.ft., less than 18" above the floor, top edge
- higher than 36" above the floor and within 36" horizontal distance of walking surface. 4) Glazing in guards and railings
- 5) Glazing containing wet surfaces of bathtubs, showers, pools, etc. if less than 60" to walking surface.
- 6) Adjacent to the bottom stair landing w/in 60" arc length if less than 36" above landing
- 7) Site-built Windows
- 8) Skylights and glazing sloped more than 15°

Sleeping rooms and basements w/ habitable space shall have min. one operable emergency escape w/ min 5.7 s.f. openable area, min. 20" clear width or min. 24" clear hat. \$ max 44" sill height.

ROOF ASSEMBLIES

Attic access shall be provided if attic is more than 30" tall (measured from top of ceiling framing to underside of roof framing members for more than 30 sq. ft. Access shall have a rough-framed opening of min. 22"x30" with min. 30" clear headroom.

MECHANICAL/ENERGY SYSTEMS:

Appliances located in garages and having an ignition source shall be elevated such that the source of ignition less than 18" above the floor.

terminate on the outside of the building in accordance with IMC section M501 and M502.

Dryer exhaust systems shall be independent of all other systems, shall transport the moisture to the outdoors and shall

Dishwashers shall be connected to a separate stand pipe or approved air gap prior to connection to sanitary drainage

Heating and Cooling equipment appliances shall be installed per manufacturers instructions and in accordance with the IBC Chapter 28.

Meter location must be approved by an Atmos Energy Corporation employee during a mandatory site visit to be scheduled after foundation is in place. Meters will not be allowed under a shedding roofline or where overhanging snow is a danger to the meter set.

The building or dwelling unit shall be tested and verified in accordance with the IECC.

Heating load calculations and equipment sizing shall be submitted for review and approval when applying for a mechanical permit. Do not install or inspect mechanical equipment or HVAC until submitted to RCRBD and approved.

Lighting shall be provided per IBC section 1204 and ventilation shall be provided per IBC section 1202.5

AREA CALCULATIONS

				Square	Load	Occupa
Unit	Level	CDC Use	IBC Use	Footage	Factor	Load
Unit 1	Level 1	Garage (1A)	S-2 (1A)	1373	200	
	Level 1	Office (1A)	B (1A)	300	150	
	Level 2	Garage (1A)	S-2 (1A)	64	200	
	Level 3	Dwelling Unit (1B)	R-2 (1A)	1471	200	
	All Level	Stairwell	B (1A and 1B Stairwell)	221	150	
Unit 2	Level 1	Garage (2A)	S-2 (2A)	1010	200	
	Level 1	Office (2A)	B (2A)	1429	150	
	Level 2	Garage (2A)	S-2 (2A)	60	200	
	Level 2	Dwelling Unit (2A)	R-2 (2A)	1251	200	
	Level 3	Dwelling Unit (2B)	R-2 (2B)	1793	200	
	All Levels	Stairwell	R-2 (2A and 2B Stairwell)	324	200	
Unit 3	Level 1	Garage (3A)	U (3A)	725	200	
	Level 1	Dwelling Unit (3A)	R-2 (3A)	616	200	
	Level 2	Garage (3A)	U (3A)	57	200	
	Level 2	Dwelling Unit (3A)	R-2 (3A)	668	200	
	Level 3	Dwelling Unit (3B)	R-2 (3B)	1045	200	
	All Levels	Stairwell	R-2 (3A and 3B Stairwell)	214	200	
	Level 1	Garage (4A)	U (4A)	482	200	
Unit 4	Level 1	Dwelling Unit (4A)	R-2 (4A)	906	200	
	Level 2	Garage (4A)	U (4A)	157	200	
	Level 2	Dwelling Unit (4A)	R-2 (4A)	494	200	
	Level 3	Dwelling Unit (4B)	R-2 (4B)	1060	200	
	All Levels	Stairwell	R-2 (4A and 4B Stairwell)	250	200	
	Level 1	Garage (5A)	U (5A)	696	200	
	Level 1	Office (5A)	B (5A)	624	150	
10	Level 2	Garage (5A)	U (5A)	93	200	
Unit 5	Level 2	Office (5A)	B (5A)	466	150	
	Level 3	Dwelling Unit (5B)	R-2 (5B)	1036	200	
	All Levels	Stairwell	B (5A and 5B Stairwell)	243	150	
	Level 1	Garage (6B)	U (6B)	620	200	
	Level 1	Dwelling Unit (6A)	R-2 (6A)	634	200	
Unit 6	Level 2	Garage (6B)	U (6B)	325	200	
5	Level 2	Dwelling Unit (6B)	R-2 (6B)	386	200	
	Level 3	Dwelling Unit (6B)	R-2 (6B)	1006	200	
	All Levels	Stairwell	R-2 (6A and 6B Stairwell)	311	200	
	Level 1	Garage (7A)	U (7A)	865	200	
	Level 1	Office (7A)	B (7A)	373	150	
Unit 7	Level 2	Garage (7A)	U (7A)	58	200	
	Level 2	Dwelling Unit (7B)	R-2 (7B)	447	200	
	Level 3	Dwelling Unit (7B)	R-2 (7B)	953	200	
	All Levels	Stairwell	R-2 (7A and 7B Stairwell)	210	200	

Use	Allowable Area (s.f	.)
S-2	40500	
R-2	21000	
8	27900	
U	16500	
Use	Actual Area(s.f.)	Ratio
Level 1		
S-2	2383	0.059
g-2	2156	0.10
8	2726	0.10
U	3388	0.20
Total	7265	0.26
levef 2		
S-2	124	9,00
R-2	4555	0.21
8	930	0.03
U	990	9.64
Total	5609	0.25
te vel 3		
8-2	3364	0.39

ACCESSIBLE TYPE B DWELLING UNITS IN OVERALL BUILDING

Unit Number	Type B Required (y/n)	Commentary
Unit 1A	No	Unit 1A is not a dwelling unit - office must be accessible
Unit 1B	Yes	Has a p private elevator, therefore accessible per original construction
Unit 2A	No	Upper level dwelling unit w/o elevator exempt per 1108.7.1.1 Office must be accessible
Unit 2B	No	Upper level unit w/o elevator exempt per 1108.7.1.1
Unit 3A	No	Multi story unit exempt per 11087.7.2
Unit 3B	No	Upper level unit w/o elevator exempt per 1108.7.1.1
Unit 4A	No	Multi story unit exempt per 11087.7.2
Unit 4B	No	Upper level unit w/o elevator exempt per 1108.7.1.1
Unit 5A	No	Unit 5A is not a dwelling unit - office must be accessible
Unit 5B	No	Upper level unit w/o elevator exempt per 1108.7.1.1
Unit 6A	Yes	Single story dwelling unit, therefore must be Type B
Unit 6B	No	Upper level unit w/o elevator exempt per 1108.7.1.1
Unit 7A	No	Not a dwelling unit – office must be accessible
Unit 7B	No	Upper level unit w/o elevator exempt per 1108.7.1.1

	SHEET SCHEDULE
SHEET	CONTENTS
A-0	ARCHITECTURAL NOTES & CODE STUDY
A-0.1	PUBLIC ADA SPECIFICATIONS & STANDARDS
A-0.2	1-hr RATED ASSEMBLY OPTIONS
A-1	PLANNING DEPARTMENT USE PLANS
A-2	LEVEL ONE USE/FIRE SEPARATION PLAN
A-3	LEVEL TWO USE/FIRE SEPARATION PLAN
A-4	LEVEL ONE WORK KEY
A-5	LEVEL TWO WORK KEY
S-0	STRUCTURAL NOTES
S-0.1	GENERAL FRAMING SECTIONS
S-1	LEVEL TWO FRAMING PLAN

2021 IBC CODE STUDY

Re: 2021 INTERNATIONAL BUILDING CODE \$ 2021 INTERNATIONAL EXISTING BUILDING CODE

USE \$ OCCUPANCY CLASSIFICATION (CH.3)

- Level 1 occupancies

- B (business) \$ S-2 (low-hazard storage) private garage greater than 1,000#
- \$ U (utility) private garages less than 1,000# - Level 2: R-2
- Level 3: R-2 (no changes to original construction)

means of egress (stairwells) - per IBC 1004.4 - means of egress have been included in area calculations for more stringent of all occupancies served.

TYPE OF CONSTRUCTION / ALLOWABLE AREAS \$ HEIGHTS (CH. 5 \$ 6)

CONSTRUCTION TYPE: V-B

NFPA 13 SPRINKLERED SYSTEM (IBC 903.3.1.1) - (required for 1-hr fire resistance rated separation per IBC tbl. 508.4) SEPARATED OCCUPANCIES (IBC 508.4)

REVIEWED

CODE

COMPLIANCE

10/31/2024

ALLOWABLE BUILDING HEIGHTS PER IBC TABLE 504.3 B, S-2, U & R-2: 60'-0'' max. (40') existing

ALLOWABLE NUMBER OF STORIES PER IBC TABLE 504.4 B \$ S-2 \$ R-2: 3 stories max. - (3 existing) U: 2 stories max. abv. grade plane - (2 existing)

ALLOWABLE BUILDING AREA PER IBC TABLE 506.2: B: 27,000 MAX.

R-2: 21,000 MAX. S-2: 40.500 MAX U: 16,500 MAX

(see building area calculations - sum of actual building area/allowable area ratios for each occupancy = less than 1 for ea. story)

OCCUPIED ROOFS PER IBC 503.1.4

- number of stories complies w/ tbl 504.4 for occupancy immediately below occupied roof - occupied roof area shall not be included in the building area or number of stories

SPACES ω / (1) EXIT (TABLE 1006.2.1)

<u>S-2:</u> Max. occupant load shall not exceed (29) max travel distance shall not exceed 100ft. R-2: Max. occupant load shall not exceed (20) max travel distance shall not exceed 125ft. B: Max. occupant load shall not exceed (49), max travel distance shall not exceed 100ft. U: Max. occupant load shall not exceed (49), max travel distance shall not exceed 75ft.

FIRE RESISTANCE REQUIREMENTS (CH.4,5,7,10)

FIRE BARRIERS & HORIZONTAL ASSEMBLY BETWEEN USES

Per IBC table 508.4 - 1-hr fire separation required between all mixed uses as fire barriers (per IBC sect. 707) \$/or horizontal assemblies (per IBC sect. 711). Supporting construction shall also be 1-hr fire resistance rated (per IBC sect. 711.2.3).

FIRE SEPARATION BETWEEN PRIVATE GARAGES & DWELLINGS

Ducts that penetrate walls or ceiling separating the dwelling unit from the garage shall be min. .019" sheet steel \$ shall not have openings in garage (per IBC, sect. 406.3.1)

Private garages (U) beneath habitable rooms shall be separated from habitable rooms abv. by min. 3/8" Type X gypsum board or equivalent. Door openings between a private garage and dwelling unit shall have min. 20-min. fire protection rating and be self-closing and self-latching. (Per IBC sect. 406.3.2.1 & Tbl. 508.4, footnote c)

FIRE PARTITIONS BETWEEN DWELLING UNITS

Walls separating dwelling units shall be "fire partitions" (per IBC sect. 420.2) \$ shall be min. 为 hour fire resistance rating w/ NFPA 13 automatic sprinkler system (per IBC sect. 708.3). exception 2 or min. 1-hr w/ NFPA 13R system. Fire partitions shall extend from the top of the floor/ceiling assembly and be securely attached to the underside of the roof sheathing or the underside the roof/ceiling w/ a fire resistance rating not less than the fire partition.

INTERIOR EXIT STIARWELLS & EXIT PASSAGEWAYS

Per (IBC section 1023.2), "interior exit stairwells" require min. 1-hr fire rating \$ shall extend to the exterior of the building with an "exit passageway" w/ min. 1-hr fire rating (per IBC 1024.2) w/ min. 36" unobstructed width \$ max. occupant load of 50

OPENING PROTECTIVES Min 1-hr fire doors in 1-hr rated fire barrier walls

Smoke alarms shall be provided in accordance w/ IBC Sect. 907.2.11.2 for group R-2

ACCESSIBILITY (CH.11)

ACCESSIBLE ROUTE Not required for:

- Upper stories or mezzanines or occupied roofs (per IBC 1104.4, exception 2). for stories that do not contain accessible elements as determined by sect. 1108
- 2nd stories in 2-story facilities w/ occupant load of 5 or less \$ no public space (per IBC 1104.4, exception 4)
- Group R-2 complying w/ section 1108.6.2.2.1 (Per IBC sect. 1108.4, exception 3) -- Type B units exempted by sect. 1108.7 (per IBC sect. 1108.4, exception 7) (see blw).

ACCESSIBLE R-2 DWELLING UNITS (IBC 1108.6.2.2 \$ 1108.7)

- Type A: 1108.6.2.2.1 Exception 2 Existing structures on a site shall not contribute to the total number of units on a site. There are (14) existing dwelling units and (9) proposed dwelling units. There are (9) proposed dwelling units, therefore Type A units
- not required In Group R-2 Occupancies containing less than (20) dwelling units.

 Type B: 1108.6.2.2.2 Exception The number of Type B units is permitted to be reduced in accordance with Section 1108.7.
- Buildings 3 and 4 qualify for the following Exceptions: -- IBC sect. 1108.7.1.1 - w/ Type B units provided on all ground level units of a
- structure w/o elevator service, other levels are not required to be Type B. -- IBC sect. 1108.7.2. - Multistory units w/o elevator service \$ dwelling area on both

levels is not required to be Type B. Please refer to the "Accessible type B Dwelling Units in Overall Building" table for units and qualifying exceptions

- Unit 1B and 6A shall be Type B units. ACCESSIBLE B & S-2 OCCUPANCY UNITS

- Offices \$ garages shall be fully accessible on ground level


- 2nd level storage areas located within garages that have less than 5 occupants and no public space are not required to be accessible (Per IBC sect. 1104.4, Exception 4)






ISSUE DATES 09 . 19 . 24 PERMIT

DRAWN BY: JEM REVIEWED BY: CWM PROJECT # 24018 ARCHITECTURAL NOTES & CODE STUDY

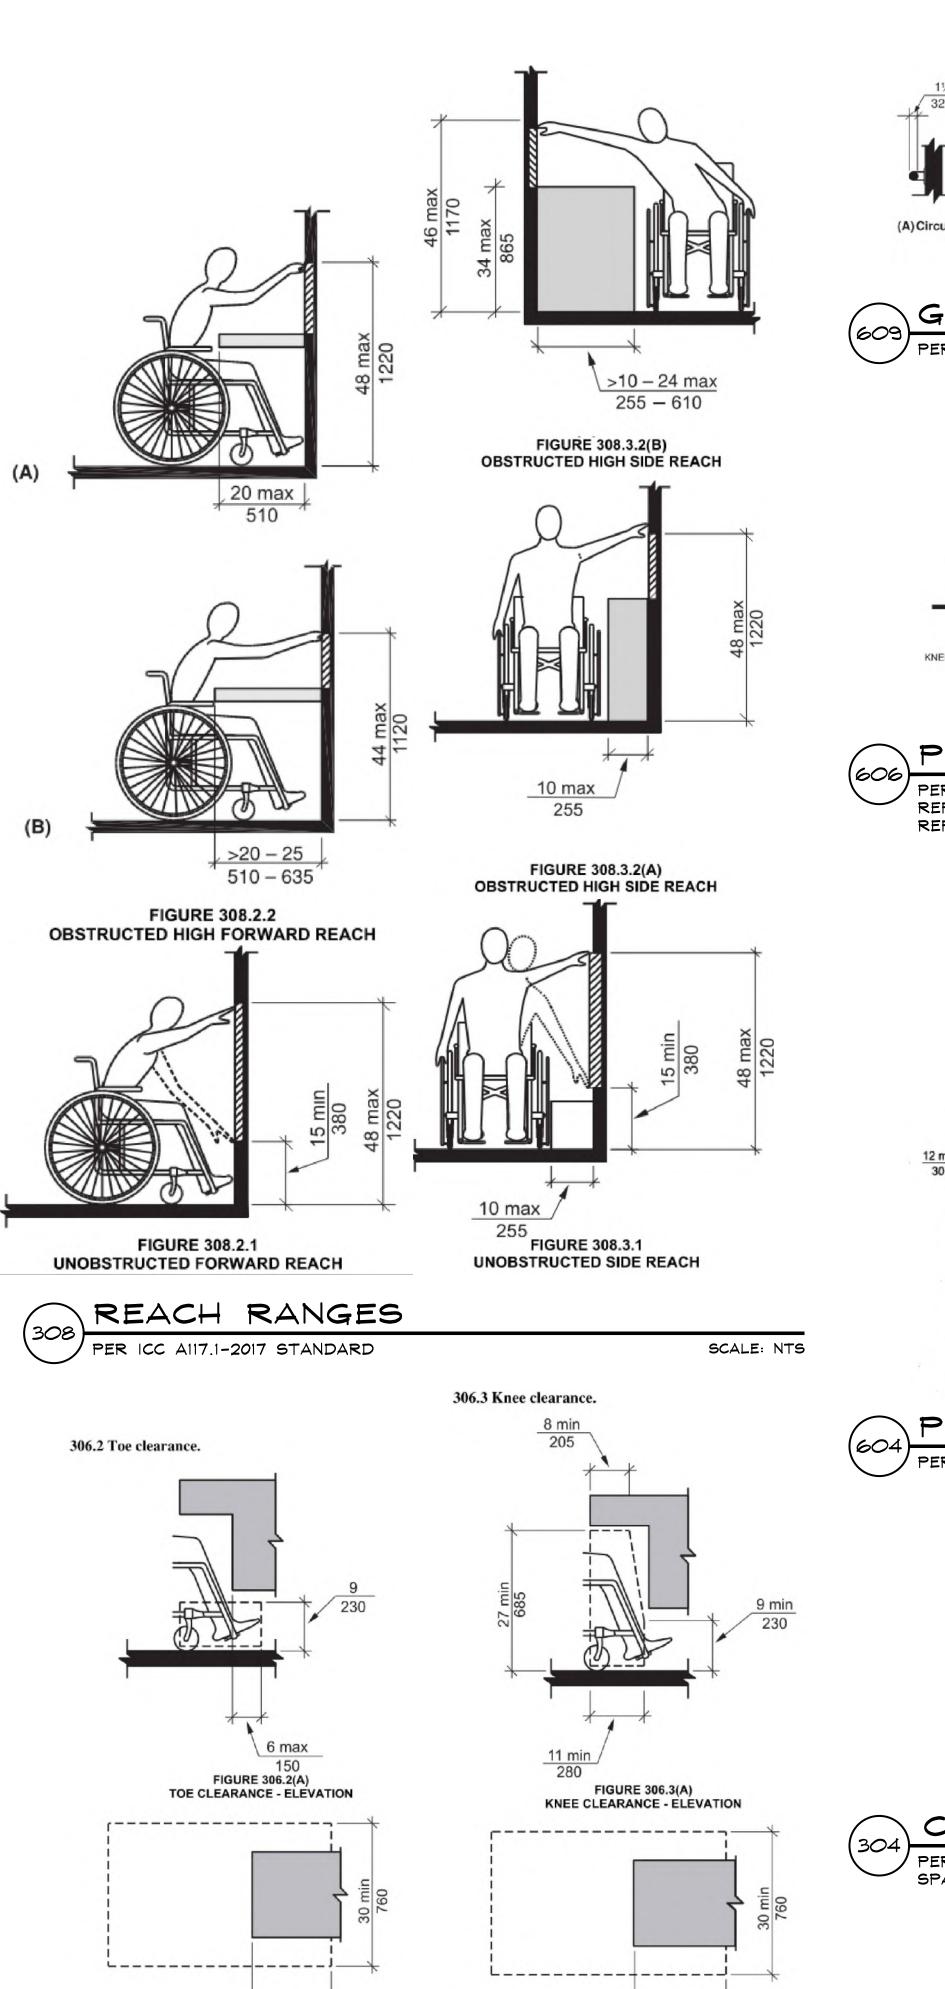

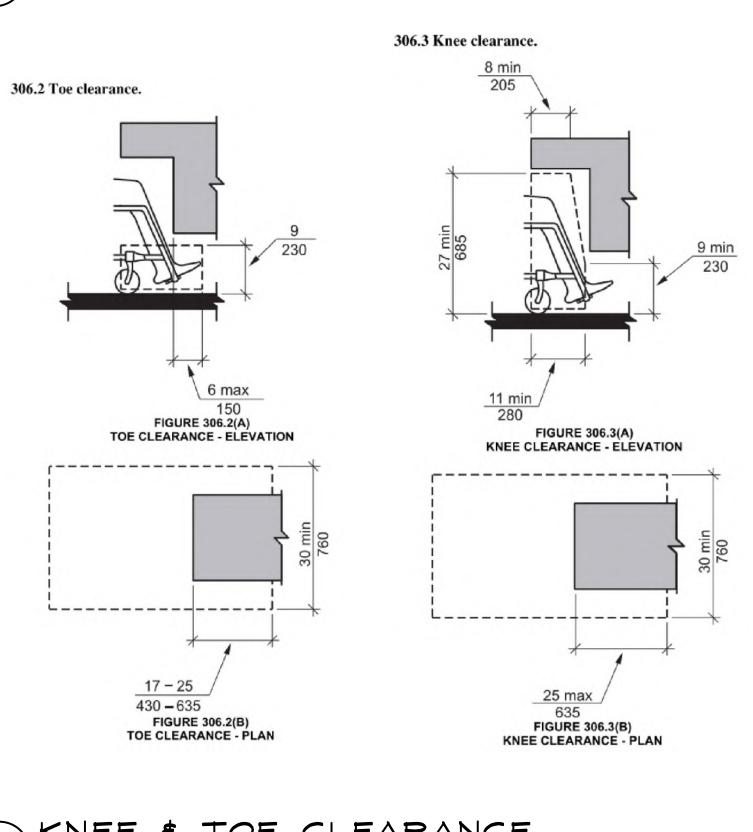



REQUIRED WHEN SPACE BENEATH AN ELEMENT IS INCLUDED AS CLEAR FLOOR SPACE, CLEARANCE OR TURNING SPACE

SCALE: NTS

4 to 4.8 perimeter 100 - 120 $1\frac{1}{4} - 2$ 32 - 51(A) Circular FIGURE 609.2 SIZE OF GRAB BARS FIGURE 609.3

GRAB BARS

SCALE: NTS PER ICC A117.1-2017 STANDARD

SPACING OF GRAB BARS

FIGURE 404.2.3.5(A)
RECESSED DOORS AND GATES - NEW BUILDINGS

PULL SIDE

FIGURE 404.2.3.5(B)

RECESSED DOORS AND GATES - NEW BUILDINGS

PUSH SIDE

FIGURE 404.2.3.5(C)

RECESSED DOORS AND GATES - NEW BUILDINGS

PUSH SIDE - DOOR PROVIDED WITH BOTH


CLOSER AND LATCH

6 MAX TOE CLEARANCE KNEE CLEARANCE 8 MIN 17 MIN DEPTH

NOTE: EQUIPMENT PERMITTED IN SHADED AREA


Figure C606.2(a) LAVATORIES AND SINKS PUBLIC LAVATORY

PER ICC A117.1-2017 STANDARD SCALE: NTS REFER TO CLEAR FLOOR SPACE STANDARDS REFER TO KNEE \$ TOE CLEARANCE STANDARDS

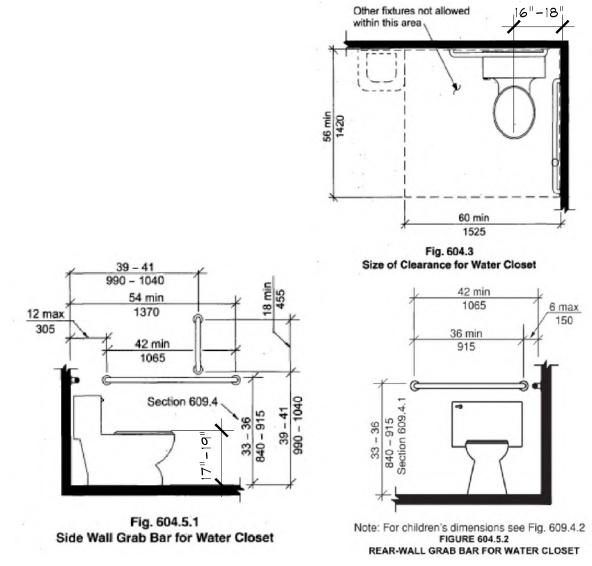

CLOSET PUBLIC WATER


SCALE: NTS PER ICC A117.1-2017 STANDARD

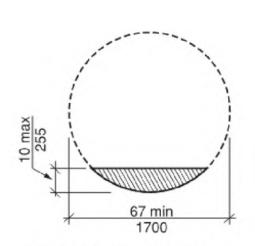

Overlap of knee and toe clearance FIGURE 304.3.1.1 **CIRCULAR TURNING SPACE - NEW BUILDINGS** SIZE AND OVERLAP

CIRCULAR TURNING SPACE

PER ICC A117.1-2017 STANDARD SCALE: NTS SPACES SHALL BE LOCATED ON SLOPE LESS THAN 1:48

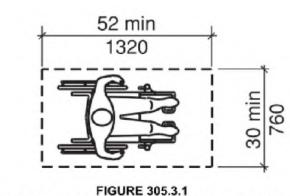

SIZE OF CLEAR FLOOR SPACE - NEW BUILDINGS

CLEAR FLOOR SPACE

PER ICC A117.1-2017 STANDARD SCALE: NTS SPACES SHALL BE LOCATED ON SLOPE LESS THAN 1:48


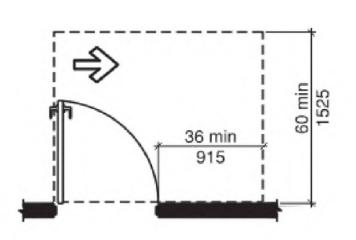


FIGURE 404.2.3.2(D) MANEUVERING CLEARANCE AT MANUAL SWINGING DOORS HINGE APPROACH - PULL SIDE

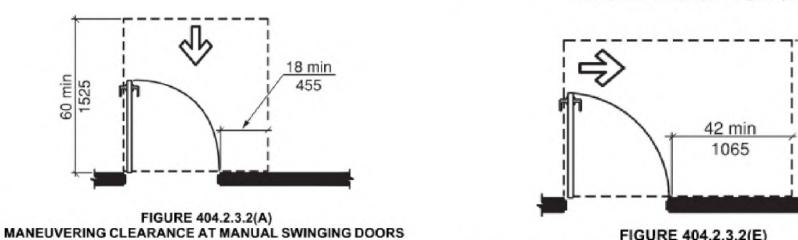


COMPLIANC FIGURE 404.2.3.2(E)
MANEUVERING CLEARANCE AT MANUAL SWINGING DOORS 10/31/20

HINGE APPROACH - PULL SIDE *If both closer and latch are provided * 48 min (1220) if both closer and latch provided r-----

FIGURE 404.2.3.2(B)
MANEUVERING CLEARANCE AT MANUAL SWINGING DOORS

FIGURE 404.2.3.2(A)


FRONT APPROACH - PULL SIDE

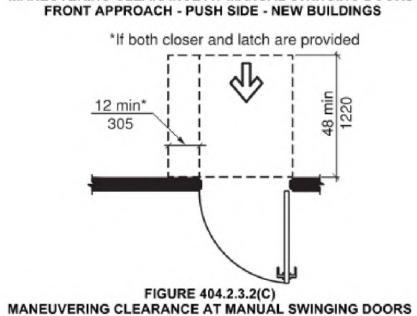

FRONT APPROACH - PUSH SIDE - EXISTING BUILDINGS

FOOTNOTE 4

FIGURE 404.2.3.2(F)
MANEUVERING CLEARANCE AT MANUAL SWINGING DOORS HINGE APPROACH - PUSH SIDE

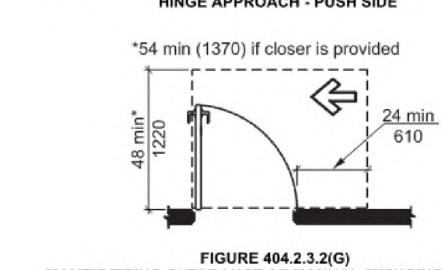

MANEUVERING CLEARANCE AT MANUAL SWINGING DOORS LATCH APPROACH - PULL SIDE

DOOR SWING MANEUVERING CLEARANCE

PER ICC A117.1-2017 STANDARD MIN. CLEAR WIDTH OF DOOR OPENING IS 32" DOORS IN SERIES NEED MIN. 48" CLEAR PLUS WIDTH OF DOORS SWINGING INTO SPACE


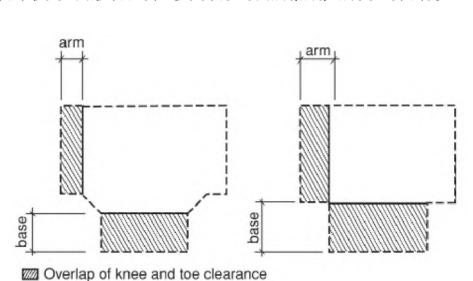


FIGURE 304.3.2.1.1 T-SHAPED TURNING SPACE **NEW BUILDINGS - OVERLAP**

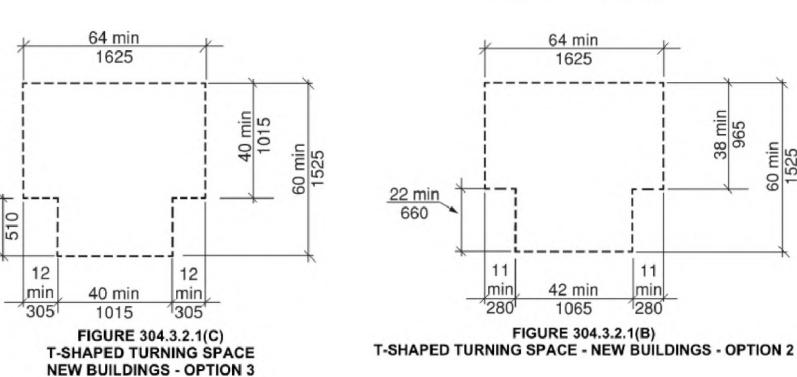

1725 ------

FIGURE 304.3.2.1(A) T-SHAPED TURNING SPACE - NEW BUILDINGS - OPTION 1

-SHAPED TURNING SPACE

PER ICC A117.1-2017 STANDARD SPACES SHALL BE LOCATED ON SLOPE LESS THAN 1:48 DOORS ARE PERMITTED TO SWING INTO TURING SPACES, U.N.O.


REVIEWED BY: CWM PROJECT # 24018 PUBLIC ADA SPECIFICATIONS STANDARDS


DRAWN BY: JEM


09 . 19 . 24 PERMIT


SCALE: NTS


SCALE: N.T.S.

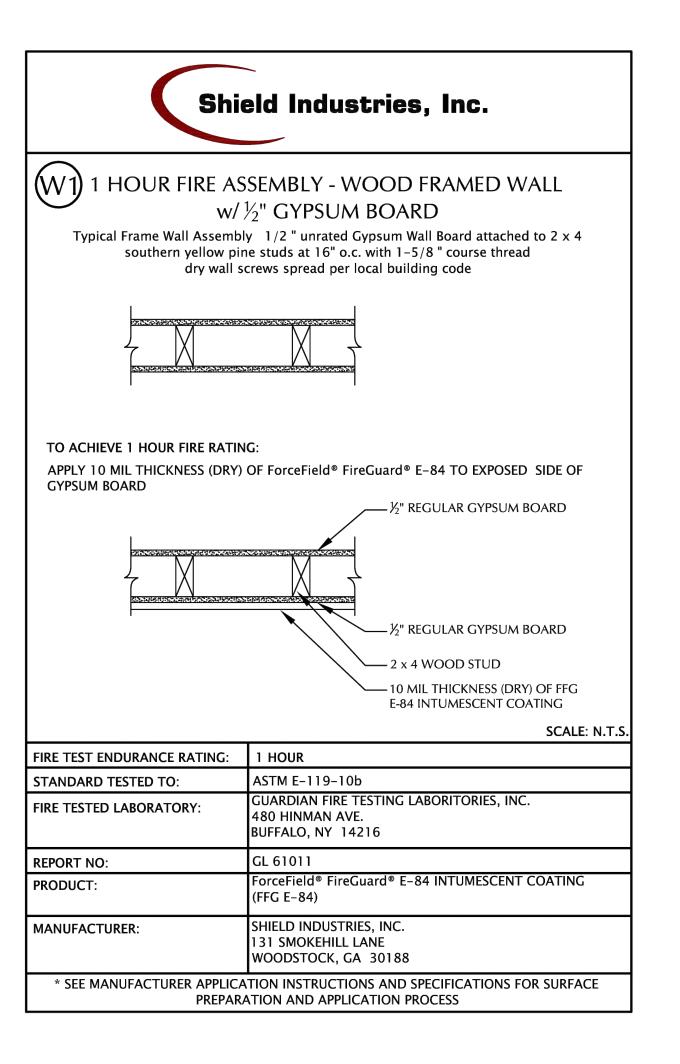


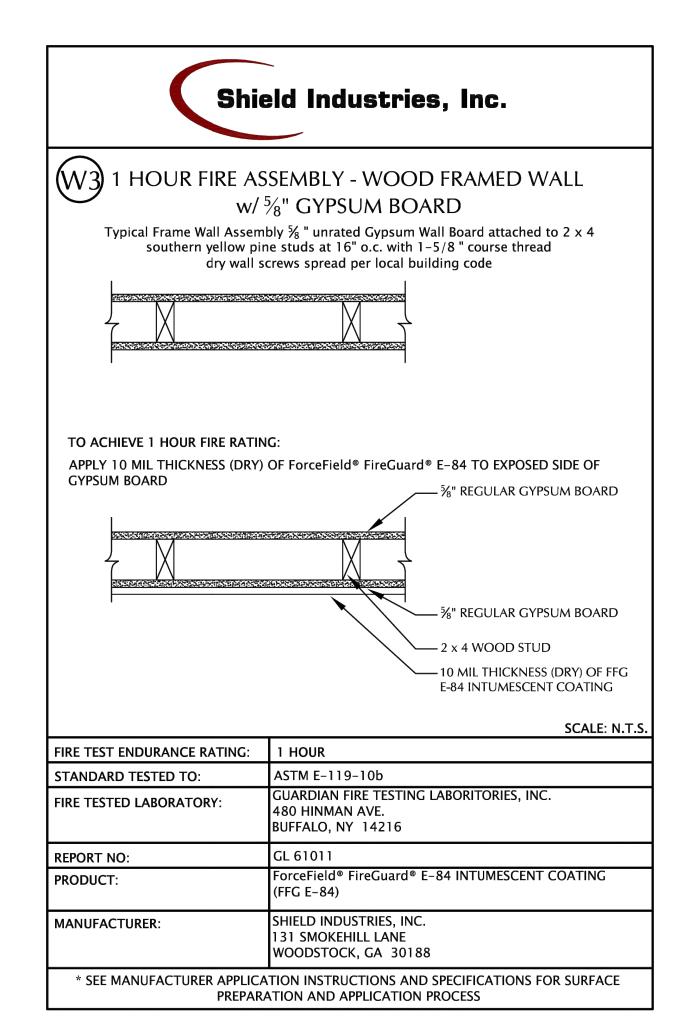

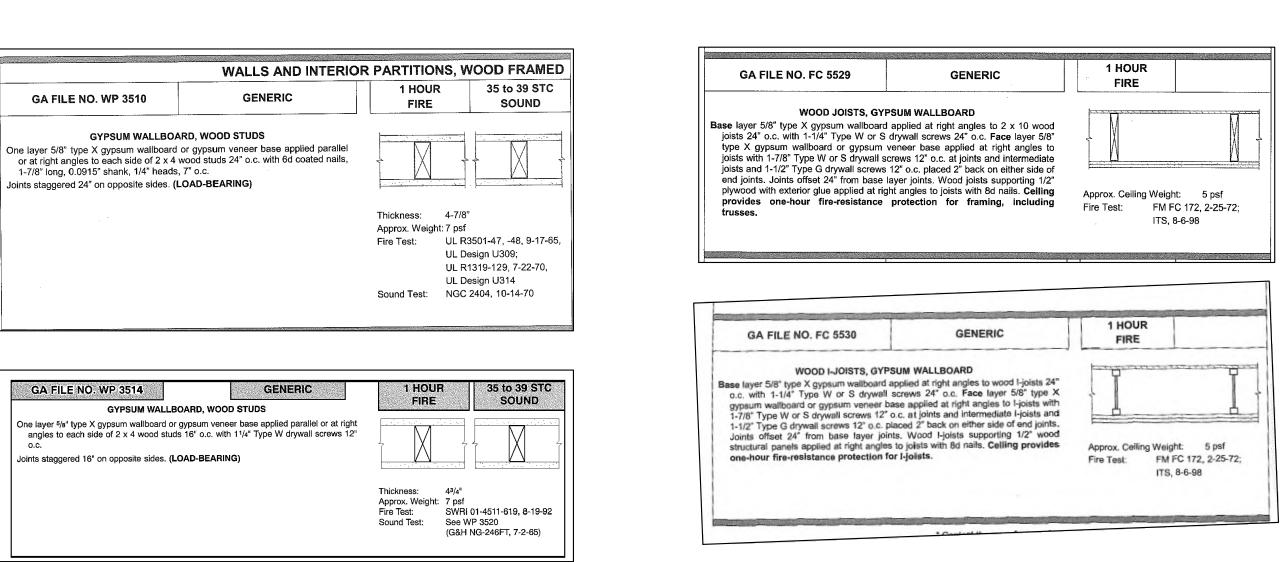

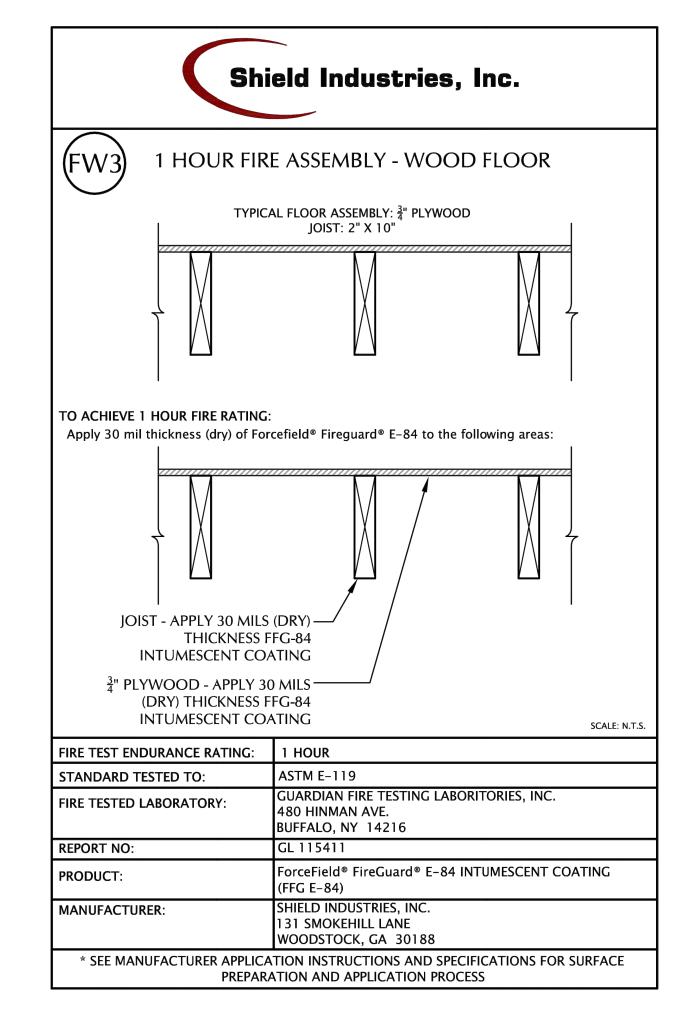

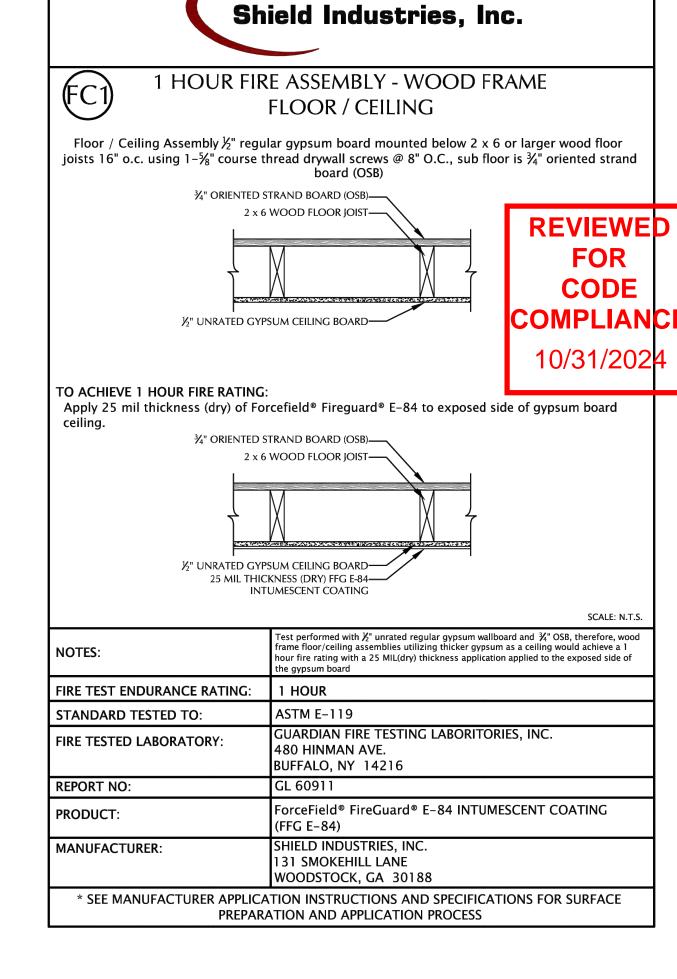

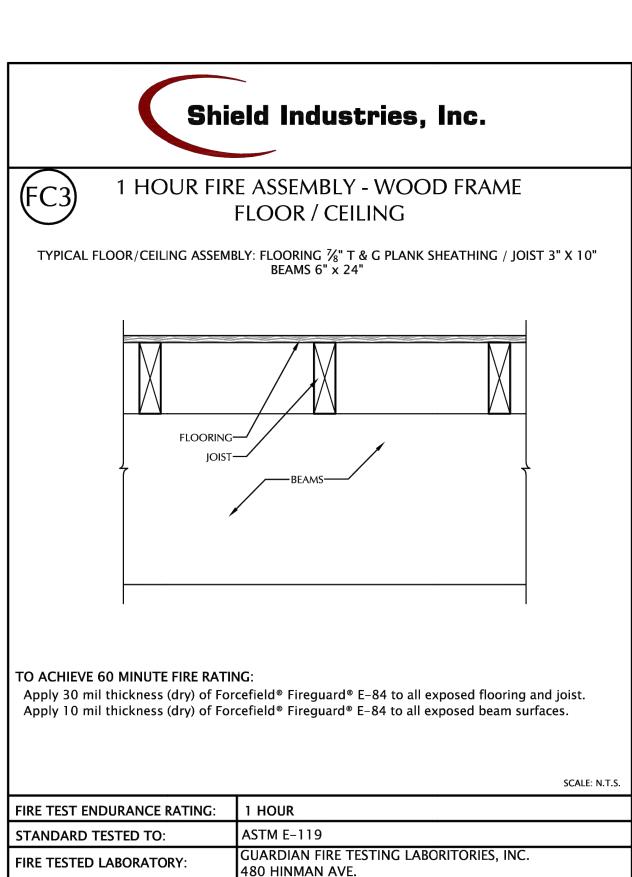

BUFFALO, NY 14216

SHIELD INDUSTRIES, INC.

WOODSTOCK, GA 30188

* SEE MANUFACTURER APPLICATION INSTRUCTIONS AND SPECIFICATIONS FOR SURFACE

PREPARATION AND APPLICATION PROCESS

31 SMOKEHILL LANE

ForceField® FireGuard® E-84 INTUMESCENT COATING


GL 115411

(FFG E-84)

REPORT NO:

PRODUCT:

MANUFACTURER:

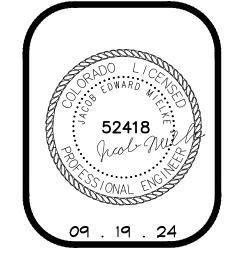



ISOO BRIDGE LANE - UNIT 24 \$ 25 STEAMBOAT SPRINGS, COLORAD

ISSUE DATES

09 . 19 . 24 PERMIT

REVIEWED BY: CWM
PROJECT # 24018

1-hr RATED
ASSEMBLY
OPTIONS

DRAWN BY: JEM




UNIT 2 SQUARE FOOTAGE SUMMARY TABLE:


Level 1	Garage 2A	1010
Level 1	Office 2A	1429
Level 2	Garage 2A	60
Level 2	Dwelling Unit 2A	1251
Level 3	Dwelling Unit 2B	1793

UNIT 2 DWELLING UNIT TABLE:

1251
2321
1793

NOTE: THE SHADED USES AND AREAS LISTED THIS PLAN ARE BASED ON THE CITY OF STEAMBOAT SPRINGS PLANNING DEPARTMENT AND COMMUNITY DEVELOPMENT CODE THIS DEVELOPMENT APPLICATION PL20240033. THESE USES WERE APPROVED APPLICATION. PLEASE REFER TO THE FOLLOWING SHEETS FOR ALL IBC USES AND SQUARE FOOTAGES

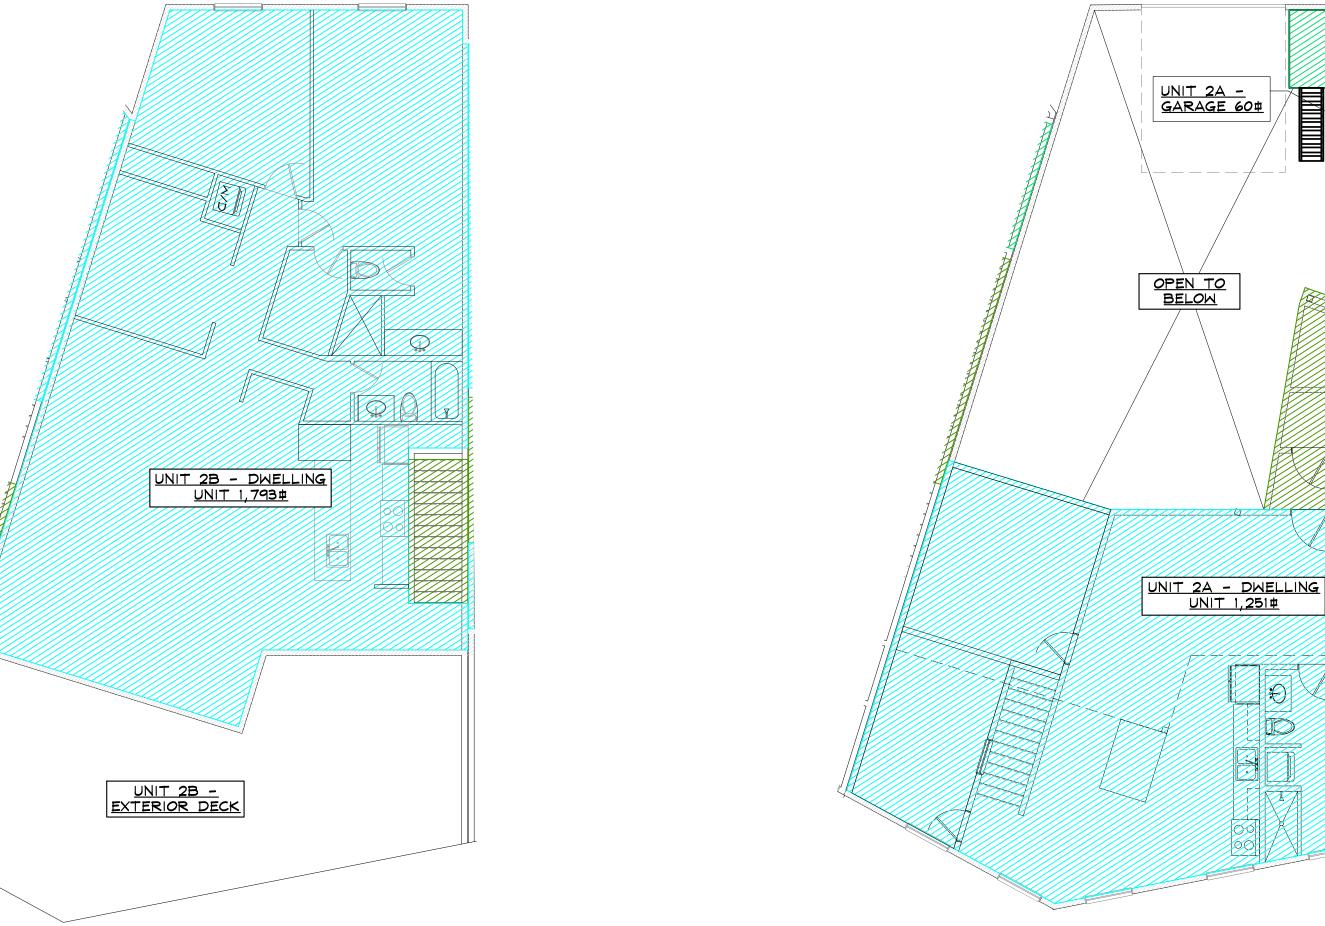


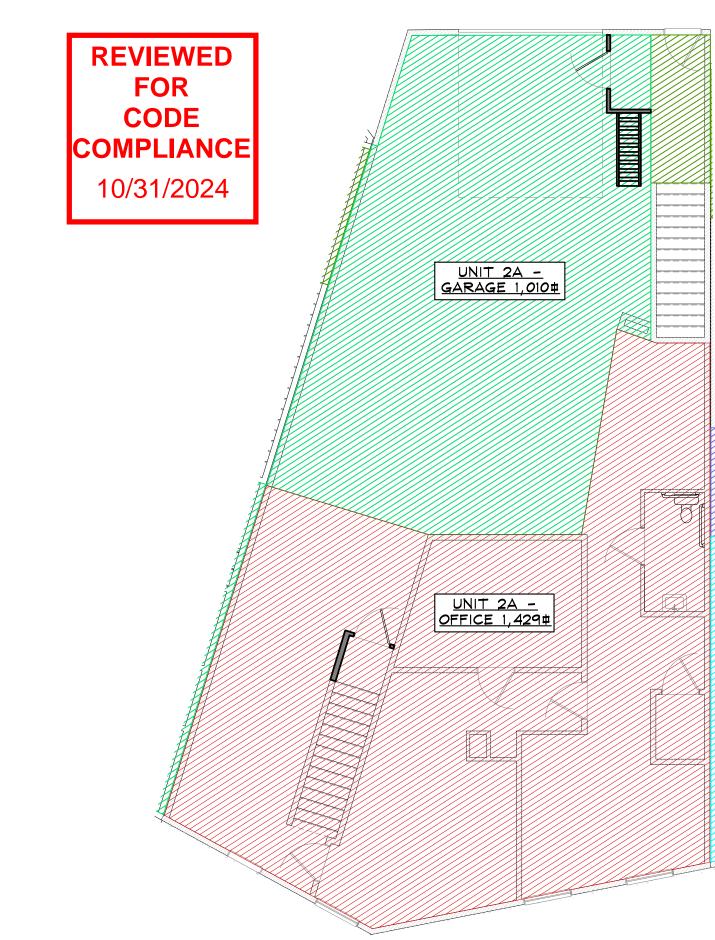

LEVEL THREE FLOOR PLAN - USE SHADING


SCALE: 1/8" = 1'-0" TWO FLOOR PLAN - USE SHADING

LEVEL ONE FLOOR PLAN - USE SCALE: $\frac{1}{8}$ " = 1'-0"

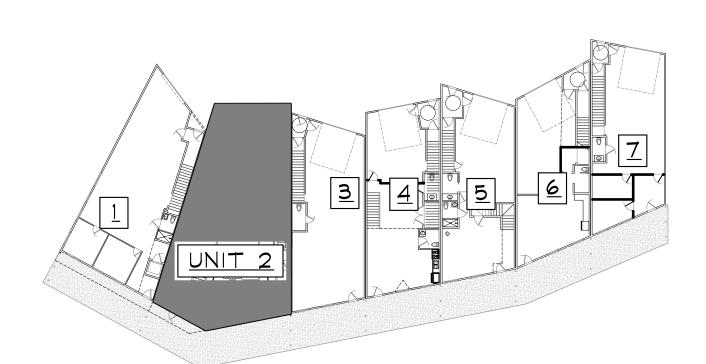

SCALE: 1/32" = 1'-0"



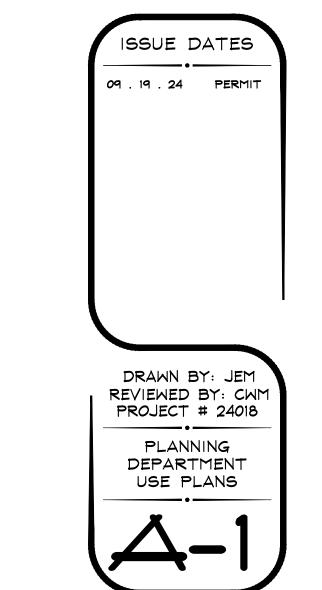

T C BRIDGE

52418

NOTES

1. CONTRACTOR TO PROVIDE/VERIFY EXISTING STAIRS HAVE MAX 7" RISERS & MIN 11" TREADS AT ALL STAIRS. MAX TOLERANCE BETWEEN THE LARGEST AND SMALLEST FOR STAIR RISERS AND TREADS ON ALL FLIGHTS OF STAIRS SHALL BE 36" PER IBC SEC. 1011.5.4

- 2. PROVIDE/VERIFY GRASPABLE HANDRAILS PER IBC SEC. 1014 AT ALL STAIRS
- 3. PROVIDE/VERIFY GUARDRAILS PER IBC SEC. 1015 AT ALL STAIRS
- 4. ENTRY \$ STAIRWELL FLOOR AREA INCLUDED IN MOST STRINGENT OCCUPANCY RATING FOR AREA SERVED PER IBC 1004.1
- 5. COMMERCIAL SPACES SHALL BE FLEXIBLE OCCUPANCIES AS ALLOWED FROM CDC TABLE 300-1

6. PER RCRBD, ANY FUTURE TENANT FINISH IMPROVEMENT PERMITS OR FUTURE CHANGE OF USE W/IN COMMERCIAL UNITS SHALL BE OBTAINED FOR EA. BUSINESS IN ADVANCE TO WORK DONE IN UNIT.


7. ALL STORAGE (S-2) AREAS ON LEVEL 2 ARE LESS THAN 250# AND LESS THAN (5) OCCUPANTS, THEREFORE CAN BE ACCESSED VIA AN ALTERNATING TREAD DEVICE PER IBC 1011.14.


8. ALL UTILITY AREAS ON LEVEL 2 ARE NOT OPEN TO THE GENERAL PUBLIC, THEREFORE PER IBC 1011.16 EXCEPTION 4 CAN BE ACCESSED VIA PERMANENT LADDER.

9. ALL BEDROOMS SHALL HAVE AN EMERGENCY ESCAPE/RESCUE OPENING PER IBC 1031.3.


10. ALL DOORS IN FIREWALL SHALL BE 1hr RATED \$ SHALL MEET THE REQUIREMENTS OF IBC TABLE 716.1(2).


11. SEAL ALL PENETRATIONS THROUGH FIRE-RATED SEPERATION WALLS & HORIZONTAL ASSEMBLIES W/ HILIT FS-ONE FIRESTOP TO SATISFY IBC 714.4.1.2 - INSTALL PER MANUFACTURER'S RECOMMENDATIONS.

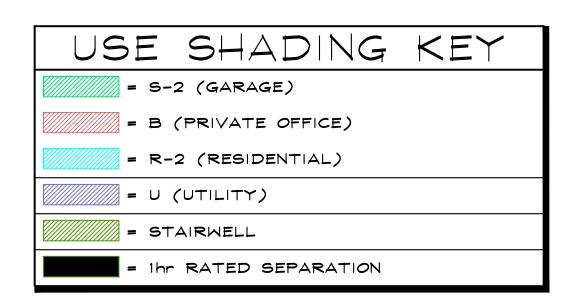

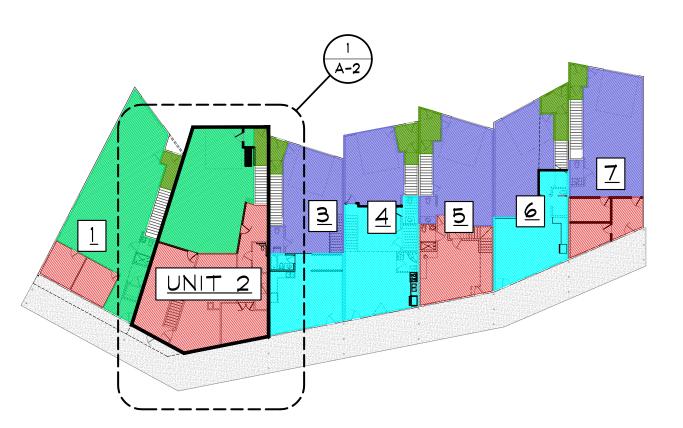



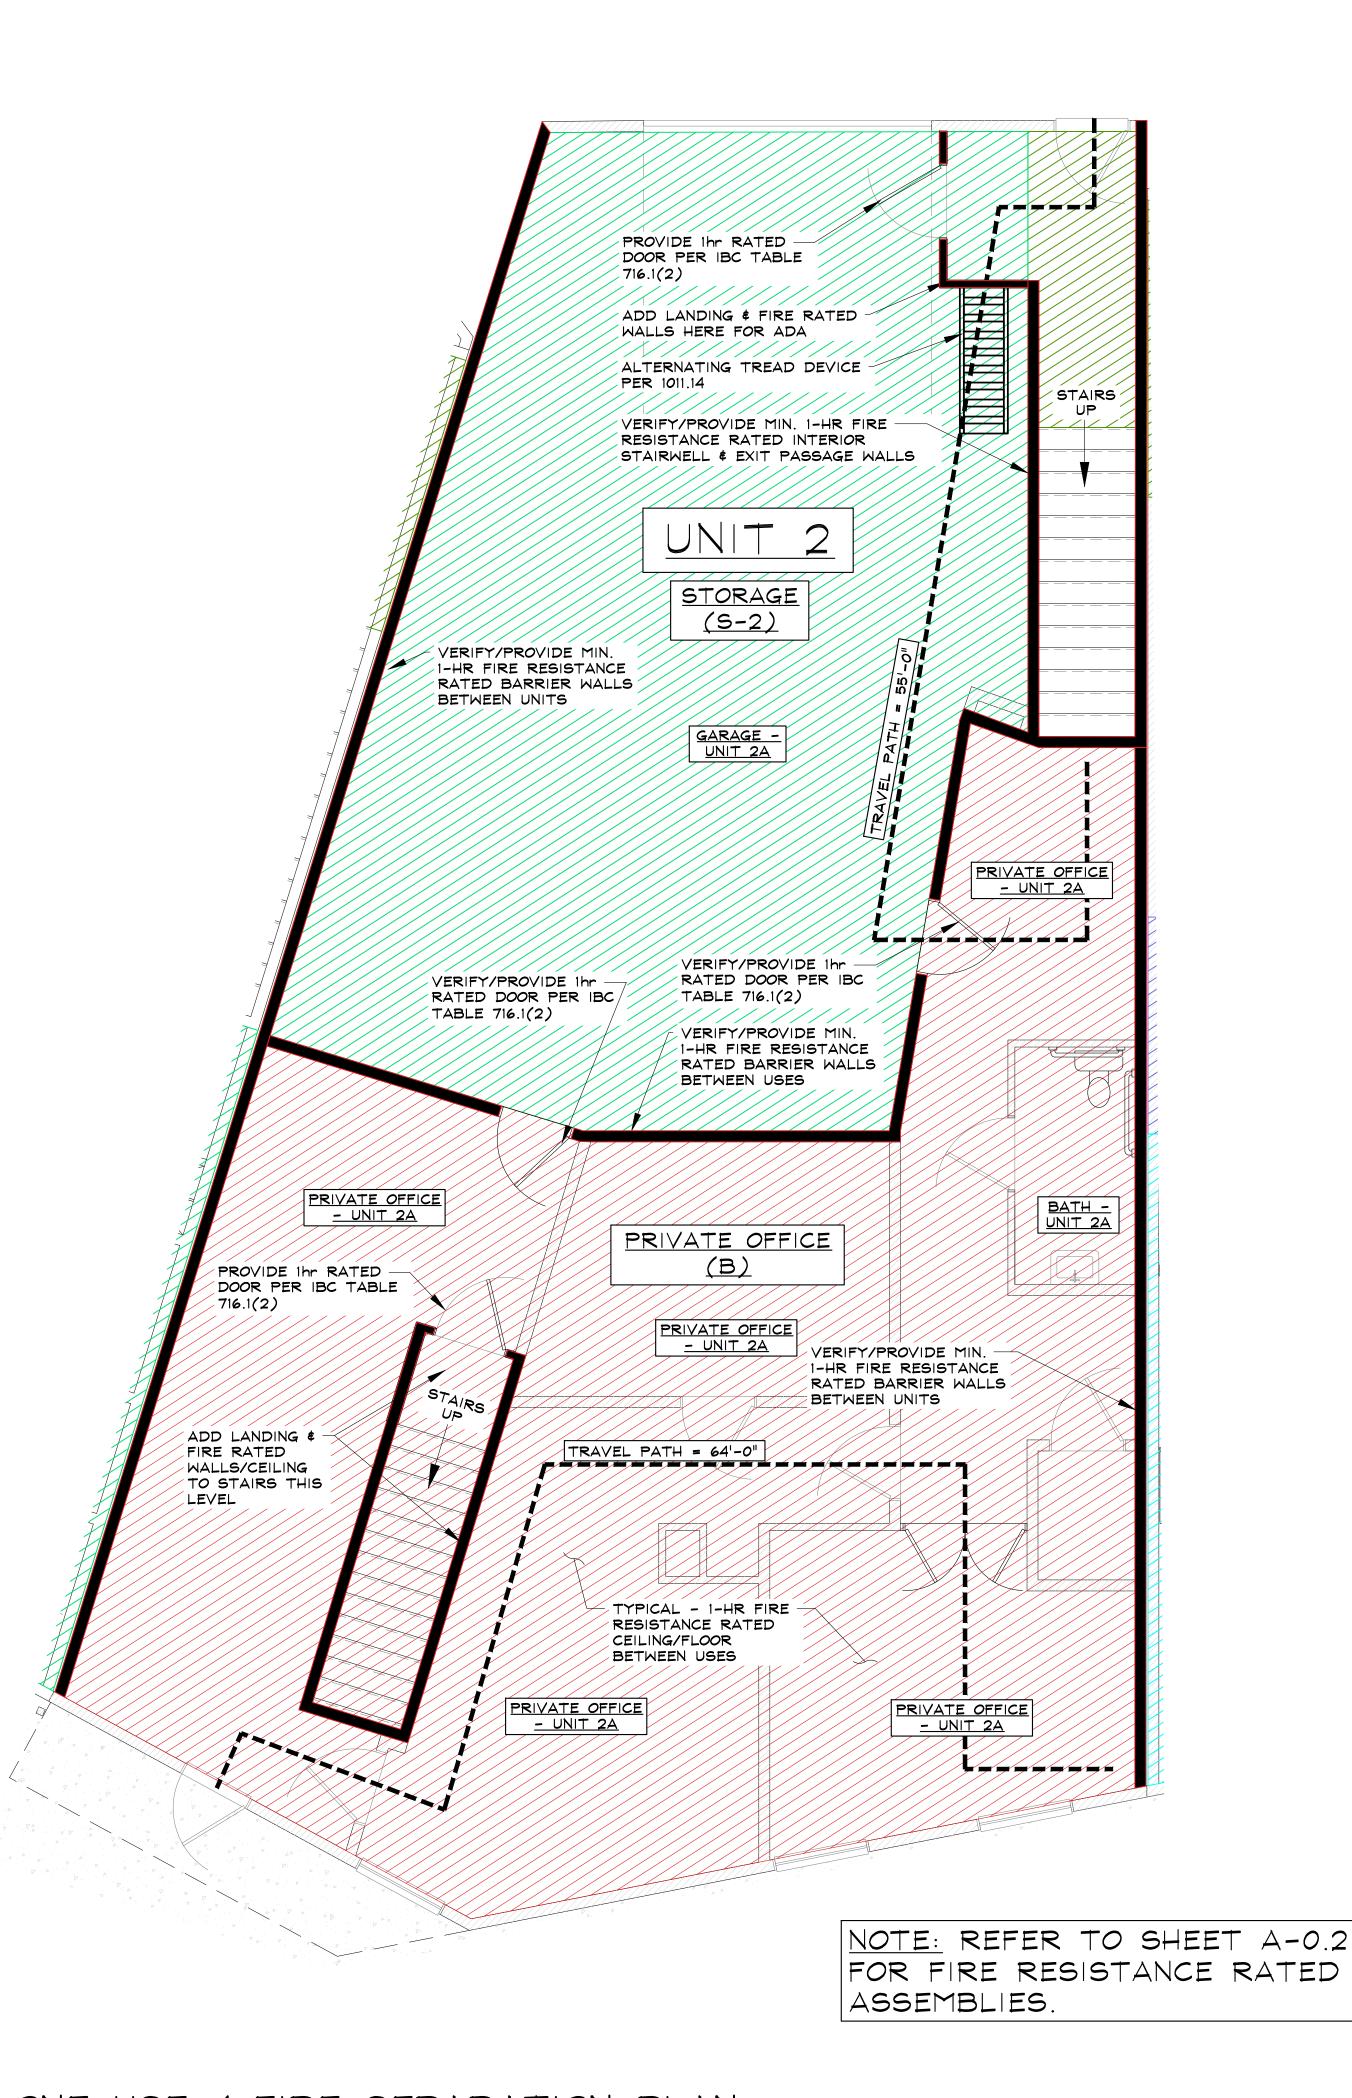

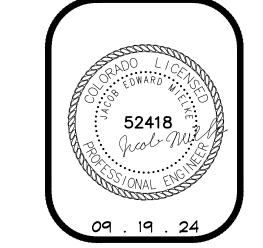



REVIEWED
FOR
CODE
COMPLIANCE
10/31/2024

RET UNIT 2

1900 BRIDGE LANE STEAMBOAT SPRING

ISSUE DATES

DRA REVIE PROJ LE

DRAWN BY: JEM
REVIEWED BY: CWM
PROJECT # 24018

LEVEL ONE
USE/FIRE
SEPARATION PLAN

PLAN

NOTES

1. CONTRACTOR TO PROVIDE/VERIFY EXISTING STAIRS HAVE MAX 7" RISERS & MIN 11" TREADS AT ALL STAIRS. MAX TOLERANCE BETWEEN THE LARGEST AND SMALLEST FOR STAIR RISERS AND TREADS ON ALL FLIGHTS OF STAIRS SHALL BE 36" PER IBC SEC. 1011.5.4

- 2. PROVIDE/VERIFY GRASPABLE HANDRAILS PER IBC SEC. 1014 AT ALL STAIRS
- 3. PROVIDE/VERIFY GUARDRAILS PER IBC SEC. 1015 AT ALL STAIRS
- 4. ENTRY & STAIRWELL FLOOR AREA INCLUDED IN MOST STRINGENT OCCUPANCY RATING FOR AREA SERVED PER
- 5. COMMERCIAL SPACES SHALL BE FLEXIBLE OCCUPANCIES AS ALLOWED FROM CDC TABLE 300-1

6. PER RCRBD, ANY FUTURE TENANT FINISH IMPROVEMENT PERMITS OR FUTURE CHANGE OF USE W/IN COMMERCIAL UNITS SHALL BE OBTAINED FOR EA. BUSINESS IN ADVANCE TO WORK DONE IN UNIT.


7. ALL STORAGE (S-2) AREAS ON LEVEL 2 ARE LESS THAN 250# AND LESS THAN (5) OCCUPANTS, THEREFORE CAN BE ACCESSED VIA AN ALTERNATING TREAD DEVICE PER IBC 1011.14.


8. ALL UTILITY AREAS ON LEVEL 2 ARE NOT OPEN TO THE GENERAL PUBLIC, THEREFORE PER IBC 1011.16 EXCEPTION 4 CAN BE ACCESSED VIA PERMANENT LADDER.

9. ALL BEDROOMS SHALL HAVE AN EMERGENCY ESCAPE/RESCUE OPENING PER IBC 1031.3.


10. ALL DOORS IN FIREWALL SHALL BE 1hr RATED \$ SHALL MEET THE REQUIREMENTS OF IBC TABLE 716.1(2).


11. SEAL ALL PENETRATIONS THROUGH FIRE-RATED SEPERATION WALLS & HORIZONTAL ASSEMBLIES W/ HILIT FS-ONE FIRESTOP TO SATISFY IBC 714.4.1.2 - INSTALL PER MANUFACTURER'S RECOMMENDATIONS.

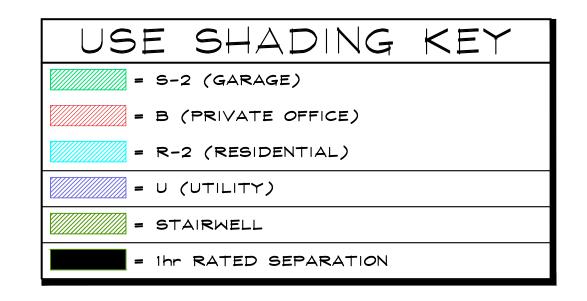

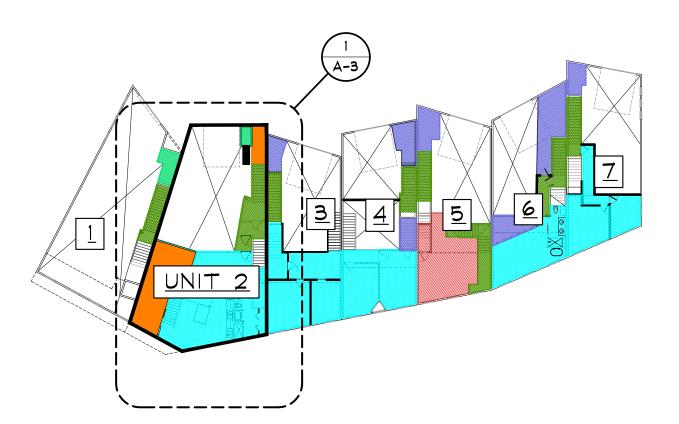



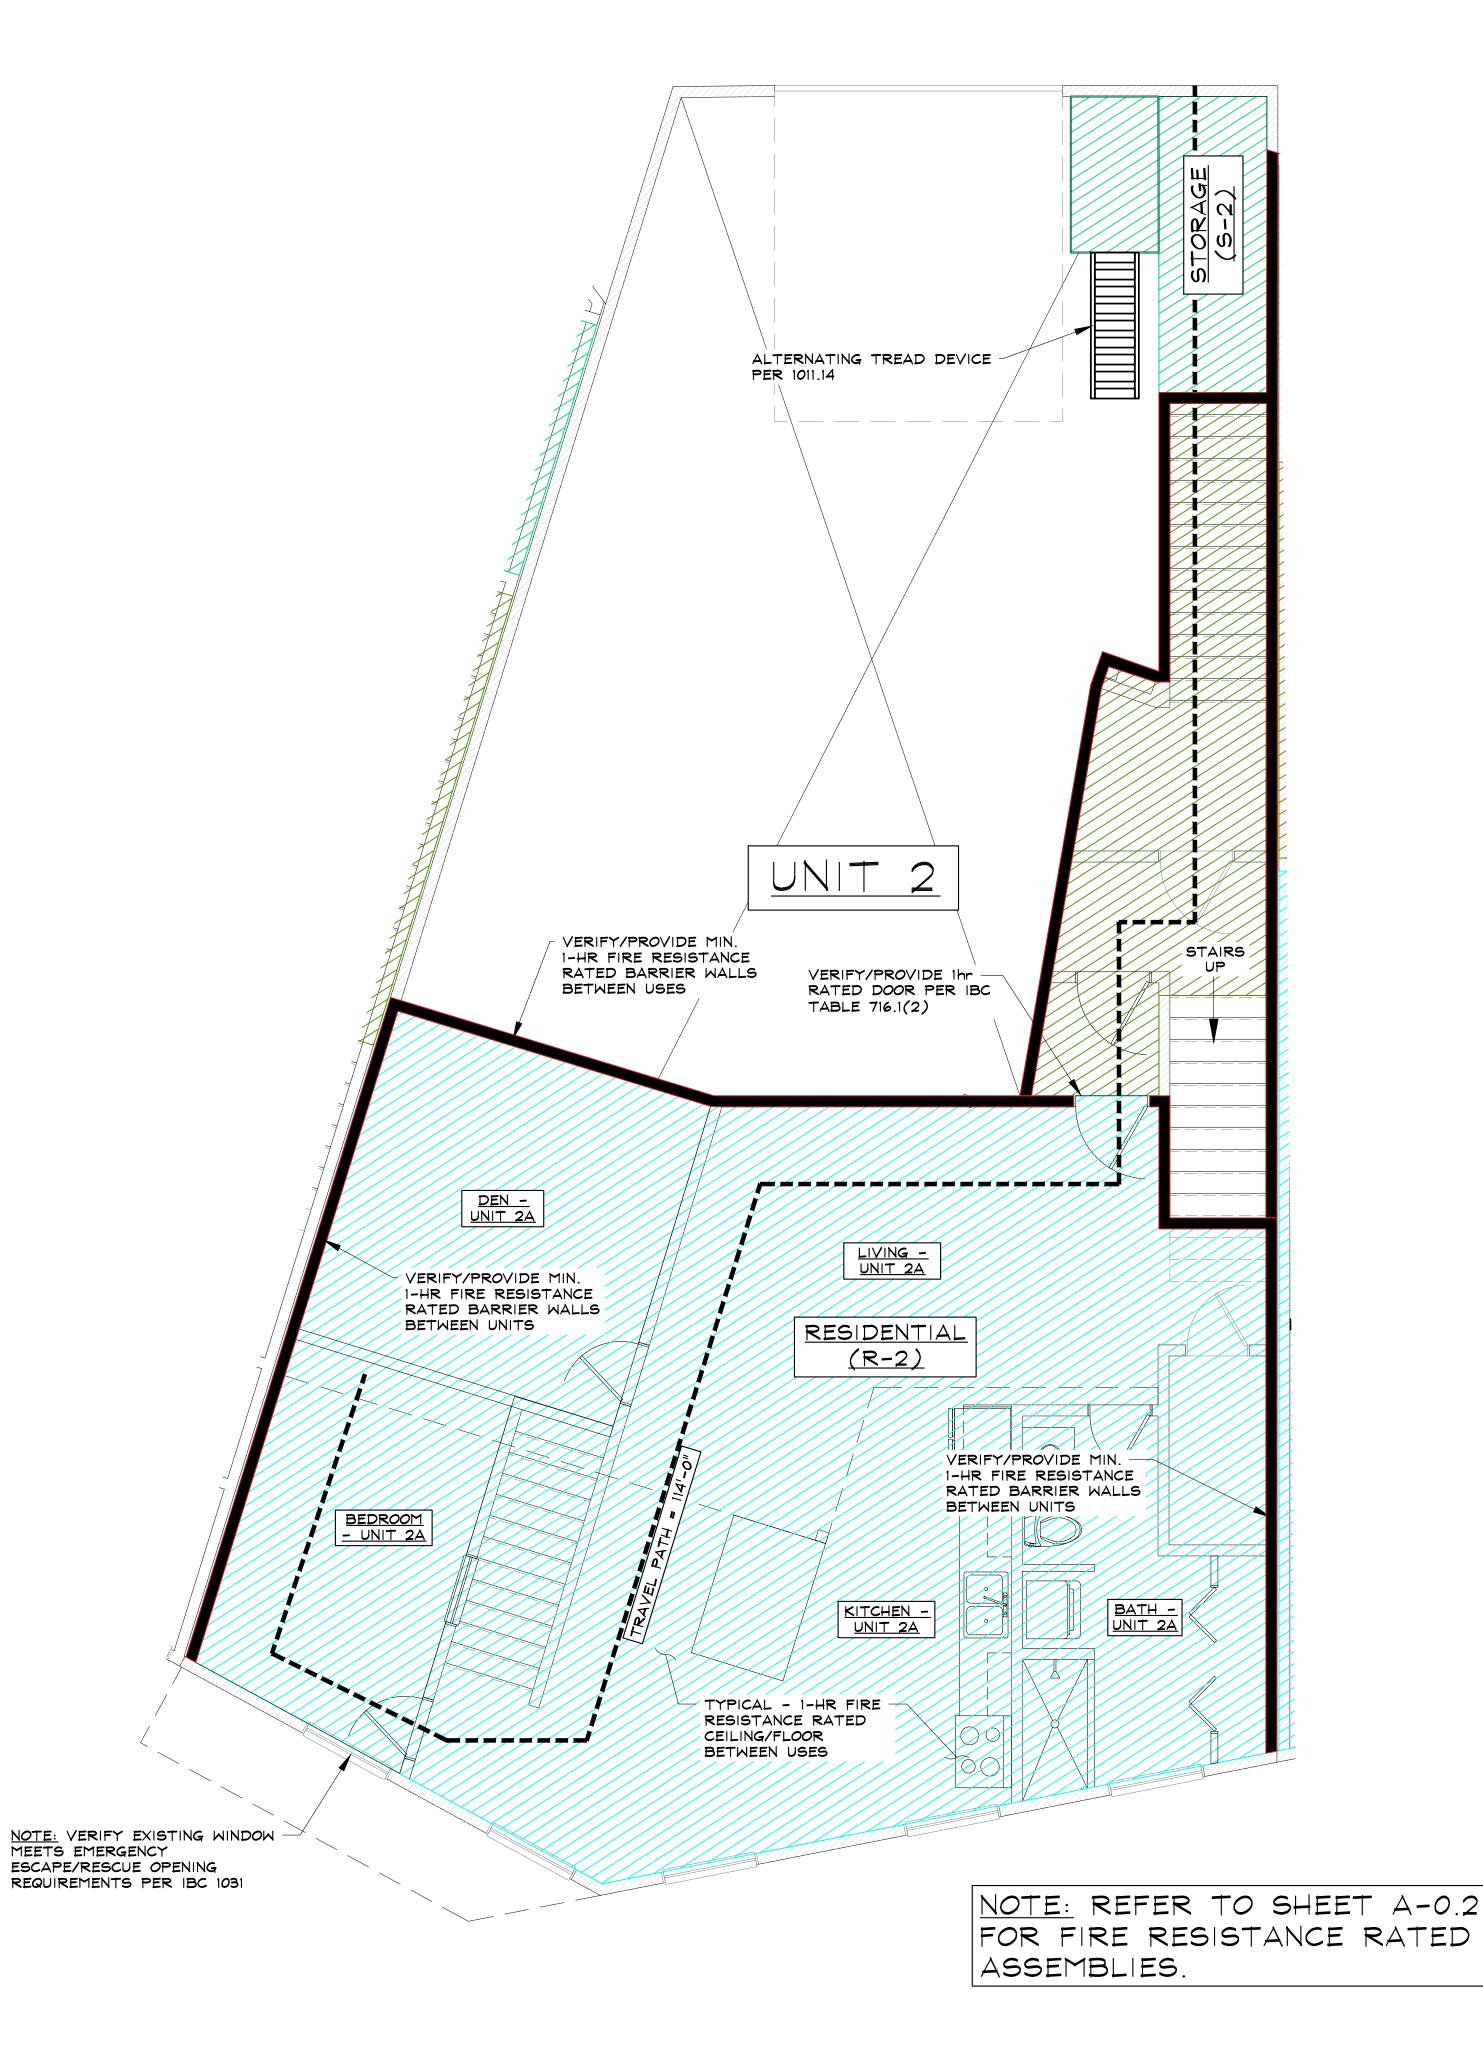

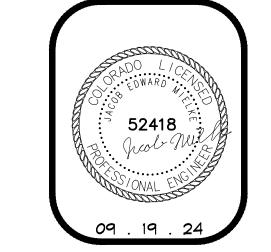



REVIEWED FOR CODE COMPLIANCE 10/31/2024

MAT UNIT 24 & EAMBOAT SPRINGS, COLORY

ISSUE DATES

09 . 19 . 24 PERMIT

W E

PLAN

DRAWN BY: JEM
REVIEWED BY: CWM
PROJECT # 24018

LEVEL TWO
USE/FIRE
SEPARATION PLAN

LEVEL TWO USE / FIRE SEPARATION PLAN

CONTRACTOR TO PROVIDE/VERIFY EXISTING STAIRS HAVE MAX 7" RISERS & MIN 11" TREADS AT ALL STAIRS. MAX TOLERANCE BETWEEN THE LARGEST AND SMALLEST FOR STAIR RISERS AND TREADS ON ALL FLIGHTS OF STAIRS SHALL BE 3/8" PER IBC SEC. 1011.5.4

2. PROVIDE/VERIFY GRASPABLE HANDRAILS PER IBC SEC. 1014 AT ALL STAIRS

B. PROVIDE/VERIFY GUARDRAILS PER IBC SEC. 1015 AT ALL STAIRS

4. ENTRY & STAIRWELL FLOOR AREA INCLUDED IN MOST STRINGENT OCCUPANCY RATING FOR AREA SERVED PER

5. COMMERCIAL SPACES SHALL BE FLEXIBLE OCCUPANCIES AS ALLOWED FROM CDC TABLE 300-1

6. PER RCRBD, ANY FUTURE TENANT FINISH IMPROVEMENT PERMITS OR FUTURE CHANGE OF USE W/IN COMMERCIAL UNITS SHALL BE OBTAINED FOR EA. BUSINESS IN ADVANCE TO WORK DONE IN UNIT.

7. ALL STORAGE (S-2) AREAS ON LEVEL 2 ARE LESS THAN 250# AND LESS THAN (5) OCCUPANTS, THEREFORE CAN BE ACCESSED VIA AN ALTERNATING TREAD DEVICE PER IBC 1011.14.

8. ALL UTILITY AREAS ON LEVEL 2 ARE NOT OPEN TO THE GENERAL PUBLIC, THEREFORE PER IBC 1011.16 EXCEPTION 4 CAN BE ACCESSED VIA PERMANENT LADDER.

9. ALL BEDROOMS SHALL HAVE AN EMERGENCY ESCAPE/RESCUE OPENING PER IBC 1031.3.

10. ALL DOORS IN FIREWALL SHALL BE 1hr RATED \$ SHALL MEET THE REQUIREMENTS OF IBC TABLE 716.1(2).

. SEAL ALL PENETRATIONS THROUGH FIRE-RATED SEPERATION WALLS & HORIZONTAL ASSEMBLIES W/ HILIT FS-ONE FIRESTOP TO SATISFY IBC 714.4.1.2 - INSTALL PER MANUFACTURER'S RECOMMENDATIONS.

LEGEND

= EXISTING WALLS TO BE REMOVED


= EXISTING WOOD FRAMED WALLS TO REMAIN

= PROPOSED WOOD FRAMED NON-BEARING WALLS

= EXISTING NON-PERMITTED WALLS/DOORS/ROOMS

= EXISTING NON-PERMITTED KITCHEN/BATHROOM



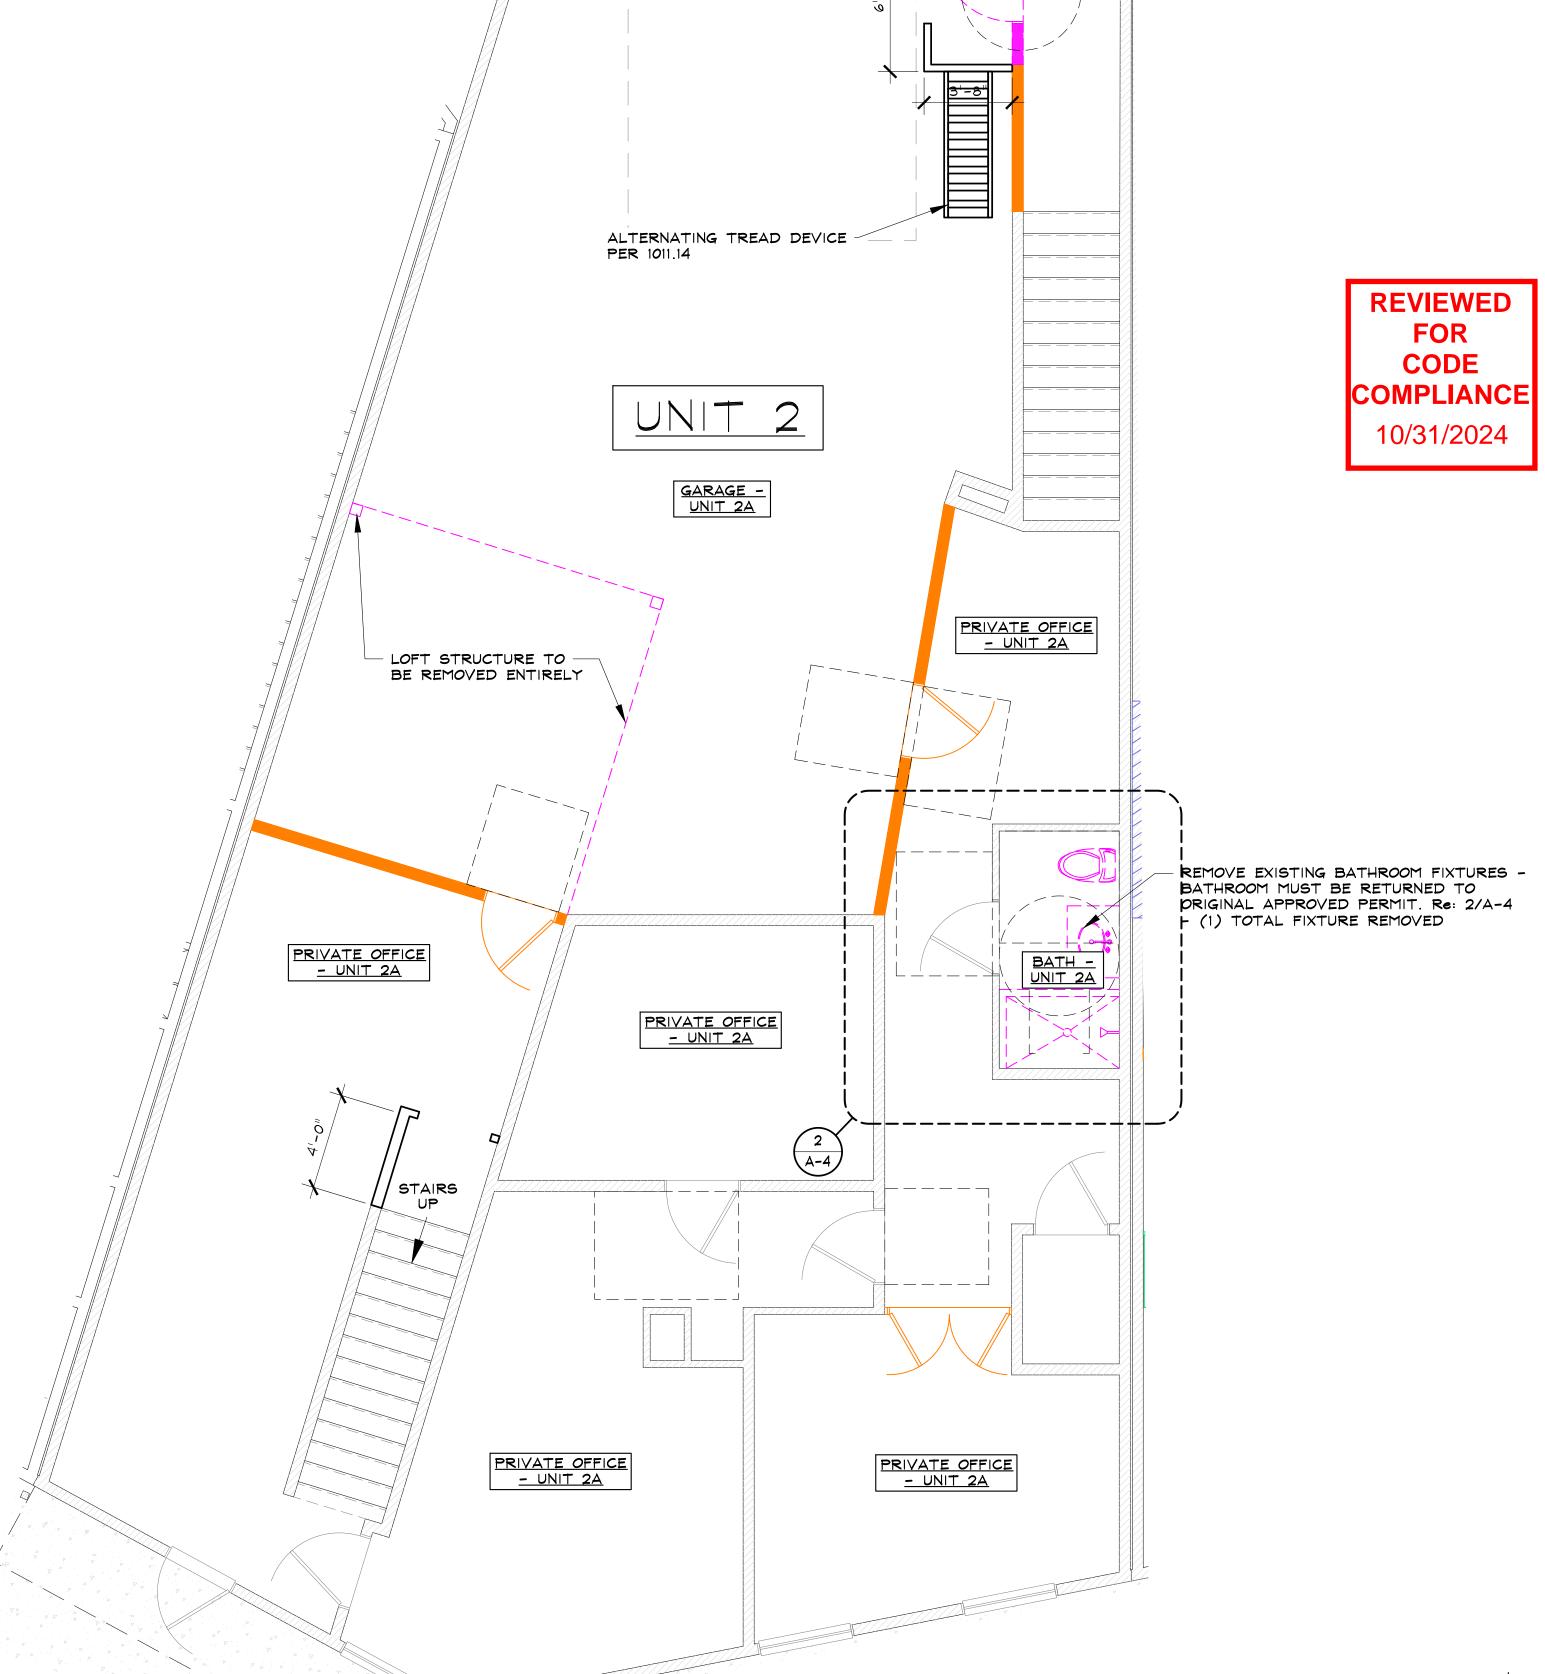





52418

09 . 19 . 24 PERMIT

DRAWN BY: JEM REVIEWED BY: CWM PROJECT # 24018 LEVEL ONE WORK KEY

(3) BUILDING LOCATION KEY

UNIT 2

<u>Note:</u> Re: Sheet A-0.1 for general ADA Requirements

LEVEL ONE ACCESSIBLE BATHROOM

SCALE: $1/32'' = 1' - \overline{0''}$

CONTRACTOR TO PROVIDE/VERIFY EXISTING STAIRS HAVE MAX 7" RISERS & MIN 11" TREADS AT ALL STAIRS. MAX TOLERANCE BETWEEN THE LARGEST AND SMALLEST FOR STAIR RISERS AND TREADS ON ALL FLIGHTS OF STAIRS SHALL BE 3 PER IBC SEC. 1011.5.4

2. PROVIDE/VERIFY GRASPABLE HANDRAILS PER IBC SEC. 1014 AT ALL STAIRS

3. PROVIDE/VERIFY GUARDRAILS PER IBC SEC. 1015 AT ALL STAIRS

4. ENTRY \$ STAIRWELL FLOOR AREA INCLUDED IN MOST STRINGENT OCCUPANCY RATING FOR AREA SERVED OER

5. COMMERCIAL SPACES SHALL BE FLEXIBLE OCCUPANCIES AS ALLOWED FROM CDC TABLE 300-1

6. PER RCRBD, ANY FUTURE TENANT FINISH IMPROVEMENT PERMITS OR FUTURE CHANGE OF USE W/IN COMMERCIAL UNITS SHALL BE OBTAINED FOR EA. BUSINESS IN ADVANCE TO WORK DONE IN UNIT.

7. ALL STORAGE AREAS ON MIDDLE LEVEL ARE LESS THAN 250# AND LESS THAN (5) OCCUPANTS THEREFORE CAN BE ACCESSED VIA AN ALTERNATING TREAD DEVICE PER IBC 1011.14.

8. ALL BEDROOMS SHALL HAVE AN EMERGENCY ESCAPE/RESCUE OPENING PER IBC 1031.3.

9. ALL DOORS IN FIREWALL SHALL BE 1hr RATED \$ SHALL MEET IBC TABLE 716.1(2).

LEGEND

= EXISTING WALLS TO BE REMOVED

= EXISTING WOOD FRAMED WALLS TO REMAIN

= PROPOSED WOOD FRAMED NON-BEARING WALLS

= EXISTING NON-PERMITTED WALLS/DOORS/ROOMS

= EXISTING NON-PERMITTED KITCHEN/BATHROOM

REVIEWED CODE COMPLIANCE 10/31/2024




52418

09 . 19 . 24 PERMIT

DRAWN BY: JEM REVIEWED BY: CWM PROJECT # 24018 LEVEL TWO WORK KEY

ALTERNATING TREAD DEVICE PER 1011.14 LOFT STRUCTURE TO BE REMOVED ENTIRELY <u>DEN -</u> UNIT 2A <u>LIVING -</u> <u>UNIT 2A</u> BEDROOM - UNIT 2A BATH -UNIT 2A KITCHEN -UNIT 2A NOTE: VERIFY EXISTING WINDOW MEETS EMERGENCY ESCAPE/RESCUE OPENING REQUIREMENTS PER IBC 1031

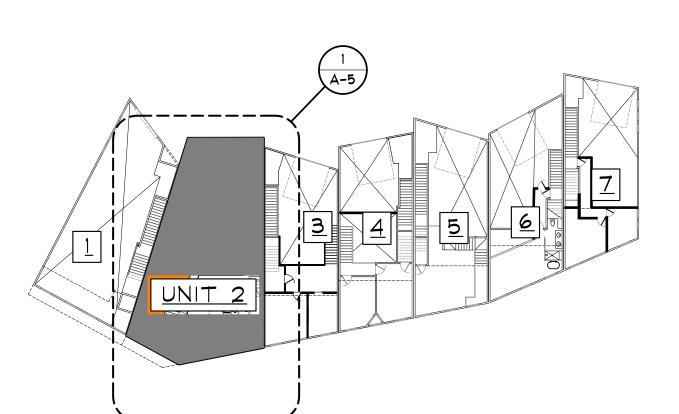

3 BUILDING LOCATION KEY

EVEL TWO DEMO/PERMITTED WORK KEY