### ARCHITECTURAL NOTES

All work must comply with state and local codes, based on the Routt County Zoning Regulations, the 2009 International Building Code, the 2009 International Residential Code, the International Plumbing Code, the International Mechanical Code, the Energy Conservation Code and the International Electric code. The contractor shall comply with all laws, ordinances, rules and regulations of any public authority bearing on the performance of the work, including O.S.H.A.

Location of the utilities (electrical, telephone, cable TV, gas, water, sewer) shall be verified before construction begins.

All on site construction safety and construction means and methods are the responsibility of the contractor. There is no implication of the construction safety requirements or building methods contained in these drawings.

All interior and exterior dimensions are to face of stud or face of concrete, U.N.O.

#### Do not scale drawings.

slab-on-grade construction.

Actual site conditions may require that some of the components of the work should be done differently than shown on these drawings. All dimensions and conditions to be verified by the contractor prior to construction. Verify changes with the designer and engineer.

These drawings represent a simplified builder's set of plans. Additional detailing may be required of the engineer during construction.

If any discrepancies are found in these drawings notify engineer and/or designer immediately.

Any variation which requires a physical change from these plans must be brought to the attention of the designer and engineer in order to maintain the design intent of the project.

All work connected with this project by any trade involved shall be of the highest quality attainable in accordance with the professional practice of the trade.

Open sides of stairways, landings, ramps, balconies and porches which are more than 30" above grade shall be protected by a guardrail. All guardrails must be 36" above finished floor and shall allow no more than a 4" diameter sphere to pass through any portion of the railing per 2009 IRC R312.

Habitable spaces within dwelling units shall have natural light provided by exterior openings equal to 8% of the floor area. Natural ventilation shall be provided by means of operable exterior openings equal to 4% of the floor area.

The water closet stool shall be located in a clear space of not less than 30" in width. The clear space in front of the water closet stool shall be not less than

All exterior walls are nominal 2x6 stud construction, U.N.O. All interior walls are nominal 2x4 stud construction, U.N.O.

The surface of exterior stairs shall be slip resistant.

Provide Grace lice and water shield, or equivalent product, from the edge of roof overhangs to the ridge

Walls and ceilings of enclosed usable space under stairs requires 1/2" gypsum wallboard. The door to access such spaces need not be rated.

Provide smoke detection per 2009 IRC section R314.

#### COMMERCIAL ENERGY CODE STANDARDS Re: 2009 International Energy Conservation Code Table 502.2(1) BUILDING ENVELOPE REQUIREMENTS - OPAQUE BUILDINGS Roofs <u> Malis Below Grade</u> <u>Floors</u> <u>Slab-on-Grade Floors</u> Opaque Doors Malls Above Grade Climate Insulation Metal buildings Swinging | Roll up Metal Metal Joists/ Below grade Zone ' Attic 6 Framed entirely (w/ r-5 or Sliding Buildingb Framed Framing Slabs Slabs thermal blocks)b other \$ Other R-15 for Group R R-25ci R-19 + R-10 R-38 R-15.2ci R-19 + R-13 + R-13 + R-10ci R-16.7ci R-30 R-20 for U-0.50 U-0.50 R-5.6ci R-7.5ci R-7.5ci 24in. below |48in. belou U-0.50 U-0.50 All other R-25ci R-13 + R-19| R-38 | R-15.2ci | R-13 + | R-13 + R-13 + R-7.5ci R-15ci R-30 R-15 for R-20 for R-7.5ci R-5.6ci R-7.5ci 24in. below |24in. below a Thermal blocks are a minimum R-5 of rigid insulation, which extends 1 inch beyond the width of the purlin on each side, perpendicular to the purlin. Assembly descriptions can be found in Table 502.2(2) R-5.7 ci may be substituted with concrete block walls complying with ASTM C 90, ungrouted or partially grouted at 32 inches or less on center vertically and 48 inches or less on center horizontally, with ungrouted cores filled with material having a maximum thermal conductivity of 0.44 Btu-in./h- $f^2$ F. When heated slabs are placed below grade, below grade walls must meet the exterior insulation requirements for perimeter insulation according to the heated

# POOR & HARDWARE SCHEDULE

| NO. | LOCATION     | ROUGH OPENING |        | DOOR | JAMB    | FIRE   | FRAME            | DOOR | REMARKS            |  |
|-----|--------------|---------------|--------|------|---------|--------|------------------|------|--------------------|--|
|     |              | WIDTH         | HEIGHT | SIZE | THICK.  | RATING |                  | HAND |                    |  |
| 1   | CONTROL ROOM | 3'-2"         | 6'-10" | 3068 | 6 9/16" | N/A    | STAIN GRADE WOOD | LEFT | EXT. w/ CLAD FRAME |  |

NOTE: VERIFY ALL ROUGH OPENINGS

## # WINDOW SCHEDULE

| NO. | MANUFACTURER | QTY. | UNIT DIMENSION |        | ROUGH OPENING |        | FUNCTION | DIRECTION | воттом             | REMARKS |
|-----|--------------|------|----------------|--------|---------------|--------|----------|-----------|--------------------|---------|
|     |              |      | WIDTH          | HEIGHT | WIDTH         | HEIGHT |          | (HAND)    | OF HEADER          |         |
| Α   | T.B.D.       | з    | 4'-0"          | 3'-0"  | 4'-01/2"      | 3'-0%" | SLIDER   | N/A       | 6'-10" ABV. PLYWD. |         |
|     |              |      |                |        |               |        |          |           |                    |         |

NOTE: VERIFY ALL ROUGH OPENINGS

1 HOUR GA FILE NO. WP 8126 PROPRIETARY\* FIRE GYPSUM PANEL PRODUCTS, FOAM PLASTIC BOARDS, WOOD STUDS, EXTERIOR CLADDING EXTERIOR SIDE: Base layer 5/8" proprietary type X gypsum sheathing or glass mat gypsum substrate applied parallel or at right angles to 2 x 4 wood studs 16" o.c. with 6d cement-coated or common nails or 1-7/8" Type W drywall screws 7" o.c. Second layer maximum 1-1/2" proprietary faced polyisocyanurate foam plastic sheathing applied parallel to study with 3" galvanized roofing nails 8" o.c. at perimeter and 12" o.c. at intermediate studs. Face laver exterior siding, fiber-

Approx. Weight: 6 psf

UL R2637, 94NK19449

UL R14196, 11NK04002

UL Design U354

6-28-96:

INTERIOR SIDE: 5/8" proprietary type X gypsum wallboard applied at right angles to studs with 6d cement-coated or common nails or 1-7/8" Type W drywall screws 7" o.c. Unfaced 3-1/2" glass fiber, 0.72 pcf, friction fit in stud space. (LOAD-BEARING)

cement siding, masonry veneer, stucco, or exterior insulation and finish system

#### PROPRIETARY GYPSUM PANEL PRODUCTS

American Gypsum Company LLC..... ....5/8" FireBloc® Type X Gypsum Board 5/8" M-Glass® Type X Exterior Gypsum Sheathing ... 5/8" GlasRoc® Sheathing Type X Gypsum Panels CertainTeed Gypsum Inc... 5/8" CertainTeed® Type X Gypsum Board ....5/8" Weather Defense® Platinum Sheathing Continental Building Products ...


5/8" Firecheck® Type X ..5/8" DensArmor Plus® Fireguard® Interior Panel Georgia-Pacific Gypsum LLC..... 5/8" DensGlass® Fireguard® Sheathing National Gypsum Company ......5/8" Gold Bond® Brand FIRE-SHIELD® Gypsum Sheathing 5/8" Gold Bond® Brand FIRE-SHIELD® Gypsum Board PABCO Gypsum ..... .....5/8" FLAME CURB® Type X 5/8" PABCO GLASS® Sheathing Type X


# NOTE


ALL EXTERIOR WALLS SHALL BE 1hr. FIRE RATED PER GA FILE NO. WP8126

ROOF/CEILING SHALL BE 1 hr. FIRE RATED PER GA FILE NO. RC2602


FLOOR/CEILING SHALL BE 1hr. FIRE RATED PER GA FILE NO. FC5529 (LVL JOISTS CAN BE SUBSTITUTED FOR DIMENSIONAL LUMBER PER TJI BULLETIN #1500, FIRE RATED ASSEMBLIES, PAGE 14)

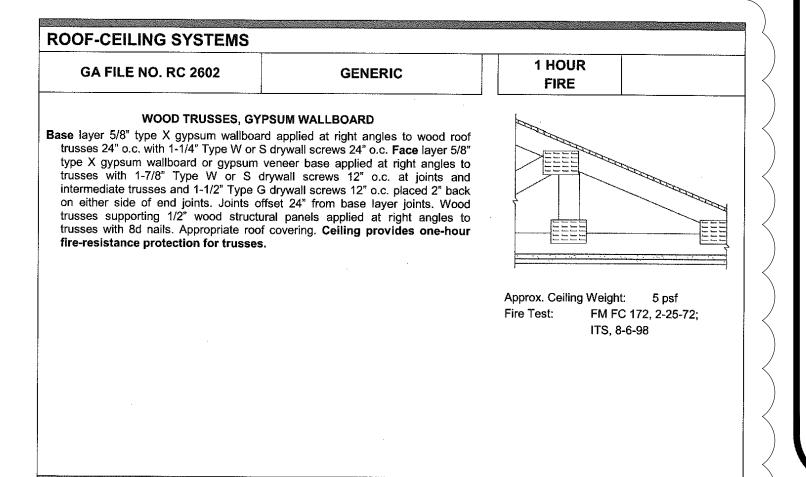


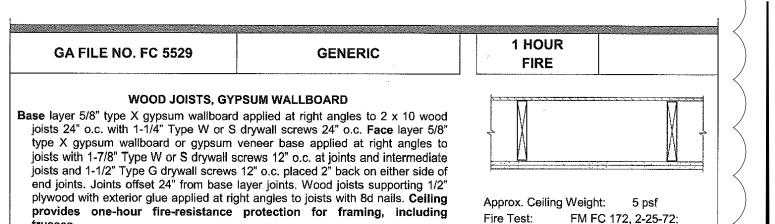

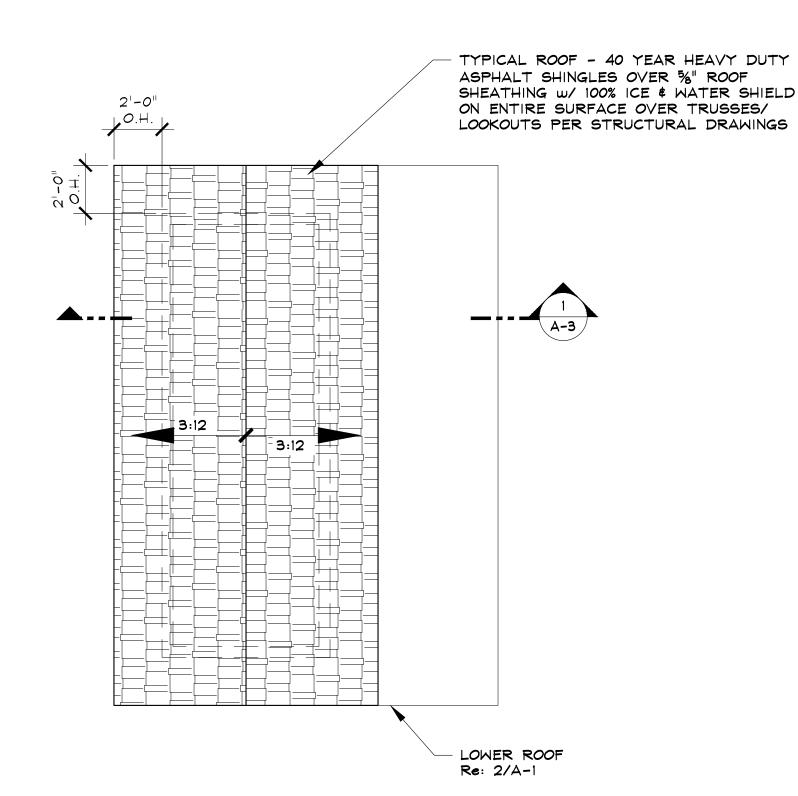

Insulation is not required for mass walls in Climate Zone 3A located below the "Warm-Humid" line, and in Zone 3B.

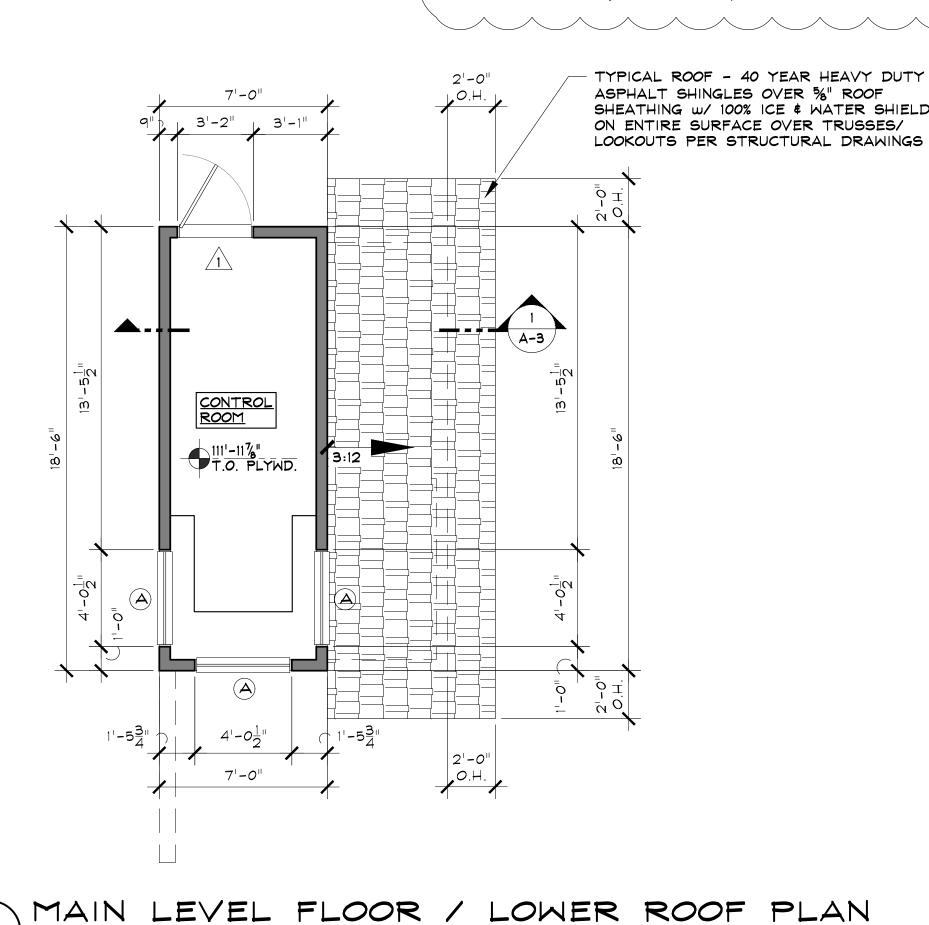

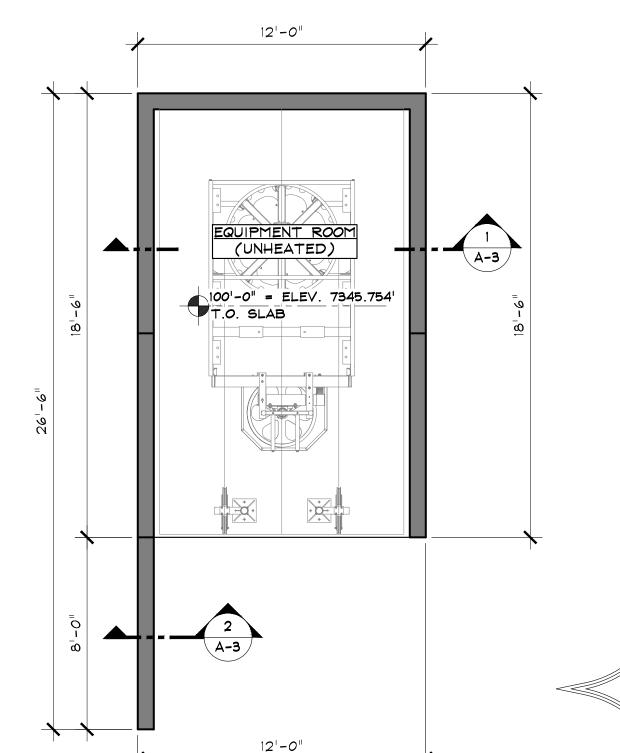

-OWER LEVEL FLOOR PLAN

<u>PLAN</u>

SCALE:  $\frac{1}{4}$ " = 1'-0"

JPPER ROOF PLAN

SCALE:  $\frac{1}{4}$ " = 1'-0"

129.5 SQ. FT. CONTROL ROOM

ITS, 8-6-98

PRGRESS PERMIT

07 . 06 . 16 08 . 03 . 16 △ 08 . 11 . 16

DRAWN BY: SJM/JEM PROJECT # 16020 UPPER BUILDING FLOOR PLANS

SHEET 2 of 6

# THERMAL ENVELOPE NOTES

THE BUILDING ENVELOPE SHALL BE DURABLY SEALED TO LIMIT INFILTRATION. THE SEALING METHODS BETWEEN DISSIMILAR MATERIALS SHALL ALLOW FOR DIFFERENTIAL EXPANSION AND CONTRACTION. THE FOLLOWING SHALL BE CAULKED, GASKETED, WEATHER-STRIPPED, OR OTHERWISE SEALED WITH A BARRIER MATERIAL, SUITABLE FILM, OR SOLID MATERIAL:

- 1. ALL JOINTS, SEAMS, AND PENETRATIONS
  2. SITE-BUILT WINDOWS, DOORS, & SKYLIGHTS
- 3. OPENINGS BETWEEN WINDOW & DOOR ASSEMBLIES
- 4. UTILITY PENETRATIONS
- 4. UTILITY PENETRATIONS
  5. DROPPED CEILINGS & CHASES ADJACENT TO THE
  THERMAL ENVELOPE
- 6. KNEE WALLS 7. WALLS & CEILING SEPARATING A GARAGE FROM
- 7. WALLS & CEILING SEPARATING A GARAGE FROM CONDITIONED SPACES
- 8. BEHIND TUBS & SHOWERS OF EXTERIOR WALLS
- 9. BEHIND FIREPLACE INSERTS
  10. ANY OTHER SOURCE OF INFILTRATION

SANDSTONE CAP - SLOPE -

TO DRAIN WATER

NUDURA INSULATED

BRING WASHED ROCK

OVER FOOTING \$

DRAIN TILE TO

CLOTH

95'-8" T.O. FOOTING

DAYLIGHT

COVER W/ GROUND

TYPICAL - PROVIDE WEEP HOLES @ BOTTOM OF

CONCRETE FORMS

STONE VENEER

Re: 1/A-3

WINDOWS, SKYLIGHTS, & SLIDING DOORS SHALL HAVE AN AIR INFILTRATION RATE OF NO MORE THAN 0.3 cfm PER SQUARE FOOT. SWINGING DOORS SHALL HAVE AN AIR INFILTRATION RATE OF NO MORE THAN 0.5 cfm PER SQUARE FOOT.

RECESSED LUMINARIES INSTALLED IN THE BUILDING THERMAL ENVELOPE SHALL BE SEALED TO LIMIT AIR LEAKAGE BETWEEN CONDITIONED \$ UNCONDITIONED SPACES BY BEING:

IC RATED \$ LABELED WITH ENCLOSURES THAT ARE SEALED OR GASKETED TO PREVENT AIR LEAKAGE

TO THE CEILING CAVITY OR UNCONDITIONED SPACE

ABOVE GRADE FRAME WALLS, FLOORS, & CEILINGS NOT VENTILATED TO ALLOW MOISTURE TO ESCAPE SHALL BE PROTECTED WITH LATEX PAINT OR 6 MIL. POLY OVERLAPPED & TAPERED AT ALL JOINTS. THE VAPOR RETARDER SHALL BE INSTALLED ON THE WARM-IN-WINTER SIDE OF THE THERMAL ENVELOPE.

## NOTE

8" CONCRETE WALL

PROPOSED APPROX.

CONCRETE FOOTING

ON UNDISTURBED

GRADE - NO

EXPOSED I.C.F.'s

W/ WATERPROOFING

ALL EXTERIOR WALLS SHALL BE 1hr.


FIRE RATED PER GA FILE NO. WP8126


Re: SHEET A-1


ROOF/CEILING SHALL BE 1 hr. FIRE RATED PER GA FILE NO. RC2602 Re: SHEET A-1

FLOOR/CEILING SHALL BE 1hr. FIRE RATED PER GA FILE NO. FC5529 Re: SHEET A-1 (LVL JOISTS CAN BE SUBSTITUTE!

(LVL JOISTS CAN BE SUBSTITUTED FOR DIMENSIONAL LUMBER PER TJI BULLETIN #1500, FIRE RATED ASSEMBLIES, PAGE 14)

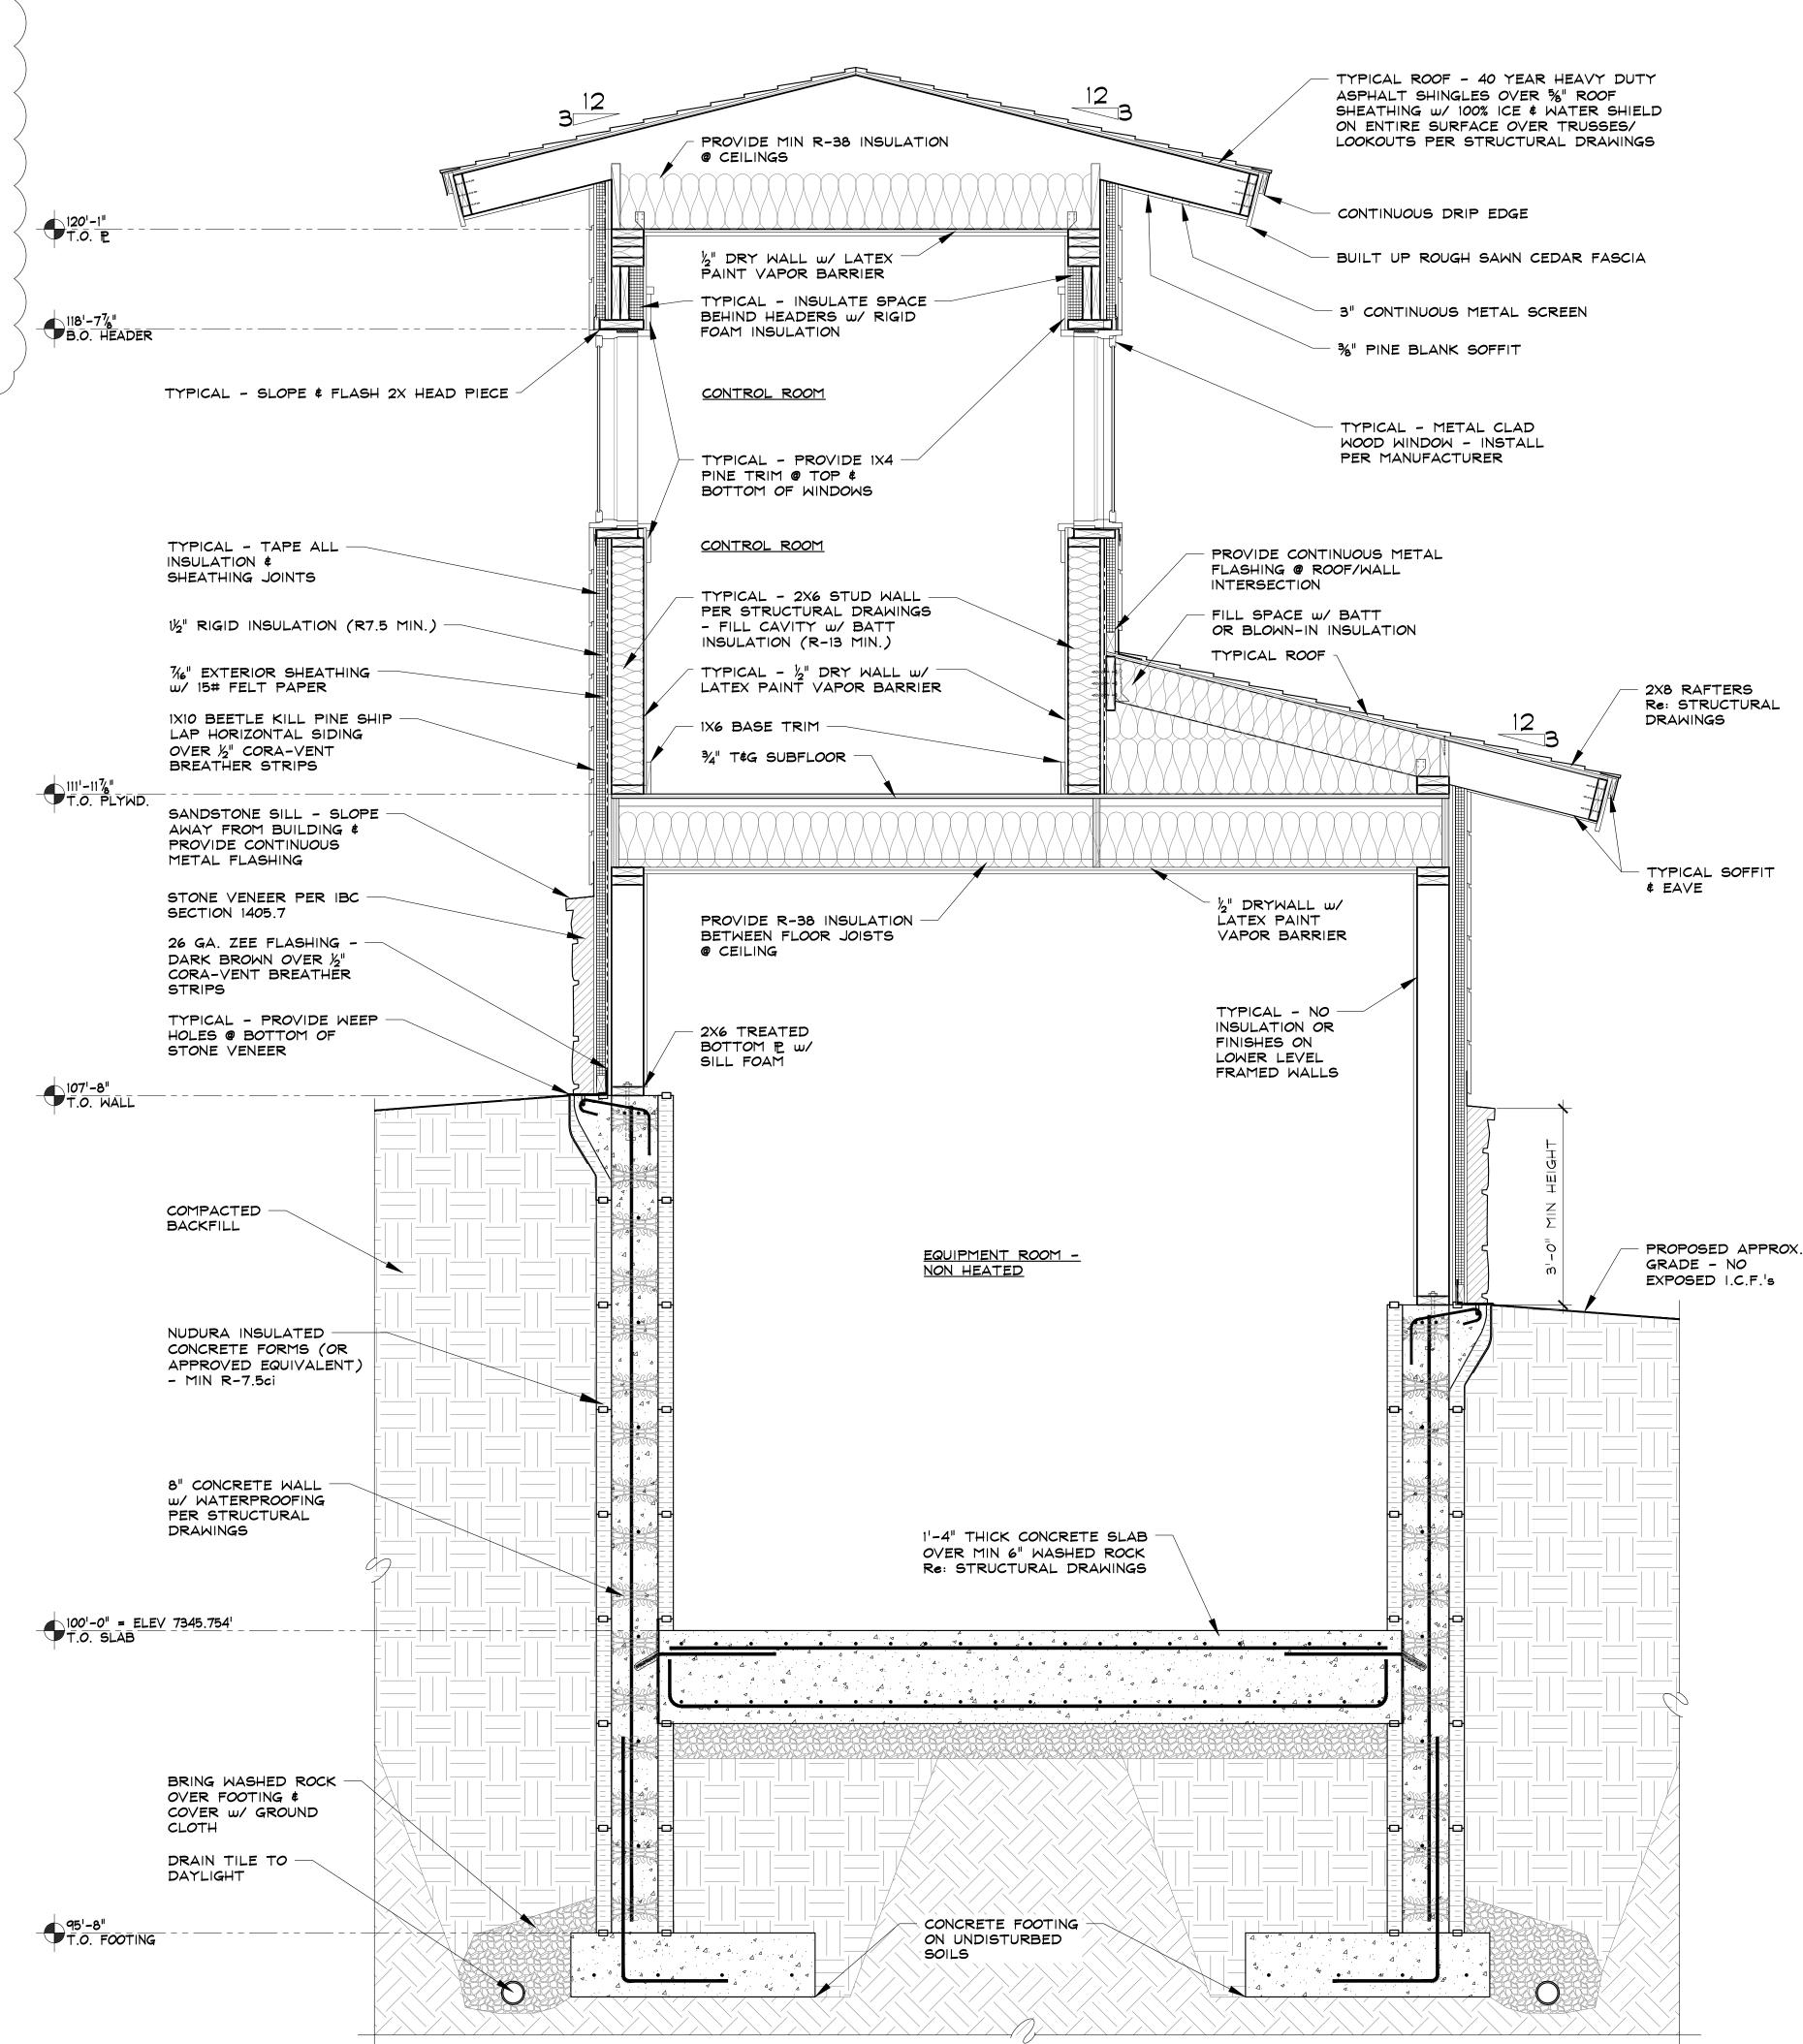

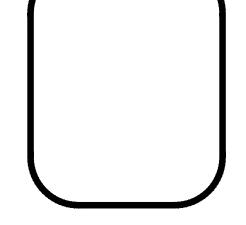

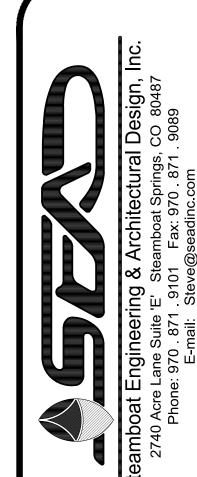

NE COASTER UPPER BUILD
2305 MT, WERNER CIRCLE

PRGRESS 07 . 06 . 16 PERMIT

DRAWN BY:

08 . 03 . 16 10 08 . 11 . 16

SJM/JEM
PROJECT # 16020

BUILDING SECTION

<u>Д-3</u>

SHEET 4 of 6

2 RETAINING WALL SECTION

SCALE: 3/4" = 1'-0"

BUILDING SECTION

100'-0" = ELEV 7345.754' T.O. SLAB / GRADE

SCALE:  $\frac{3}{4}$ " =  $1^1 - 0^1$