CONTROL JOINT CJ CONCRETE MASONRY UNIT

CONC CONCRETE CRPT CARPET

EBO ENGINEERED BY OTHERS ELEV ELEVATION

EXISTING **EXIST** FFE FINISH FLOOR ELEVATION FLOOR DRAIN

FACE OF CONCRETE FOS FACE OF STUD OR FRAMING

FT FTG **FOOTING** 

GAUGE GC GENERAL CONTRACTOR

HVAC HEATING, VENTILATION, & AC INSULATED CONCRETE FORM

LAMINATED VENEER LUMBER

LVL

NOT IN CONTRACT NOT TO SCALE

ON CENTER 0.6. OD OUTSIDE DIAMETER

OHD OVERHEAD DOOR PRESSURE TREATED

RETURN AIR

ROUGH OPENING STRUCTURAL INSULATED PANEL

T&G TONGUE & GROVE THK THICK

TOC TOP OF CONCRETE TOF. TOP OF FOOTING

T05 TOP OF STEEL

TOP OF WALL TOM UNLESS NOTED OTHERWISE

UNLESS OTHERWISE NOTED MELDED MIRE FABRIC

#### **GENERAL NOTES:**

- 1. ALL EXISTING CONDITIONS MUST BE VERIFIED BY THE BUILDER IN THE FIELD. UNKNOWN AND VARIED CONDITIONS MAY BE FOUND. NOTIFY THE ENGINEER OF ANY STRUCTURAL CONDITIONS FOUND TO YARY FROM THAT INDICATED BY THE STRUCTURAL DRAWINGS. DESIGN REVISIONS MAY BE REQUIRED.
- 2. THE CONTRACTOR SHALL VERIFY THAT SITE CONDITIONS ARE CONSISTENT WITH THESE PLANS BEFORE STARTING WORK.
- 3. ALL DIMENSIONS ON STRUCTURAL DRAWINGS SHALL BE VERIFIED WITH THE ARCHITECTURAL DRAMINGS. ANY DISCREPANCIES SHALL BE BROUGHT TO THE
- ATTENTION OF THE DESIGNER AND ENGINEER FOR CORRECTION. 4. THE ENGINEER/DESIGNER SHALL BE CONSULTED FOR CLARIFICATION IF SITE CONDITIONS ARE ENCOUNTERED THAT ARE DIFFERENT THAN SHOWN, IF DISCREPANCIES ARE FOUND IN THE PLANS OR NOTES. OR IF A QUESTION ARISES OVER
- THE INTENT OF THE PLANS OR NOTES. 5. THE GENERAL CONTRACTOR SHALL COMPLY WITH ALL BUILDING CODE REQUIREMENTS OF THE LOCAL GOVERNING AUTHORITY, AND SHALL OBTAIN AND PAY FOR ALL REQUIRED PERMITS, FEES, AND INSPECTIONS, WITH THE EXCEPTION OF PERMITS AND FEES REQUIRED FOR PLUMBING, MECHANICAL, AND ELECTRICAL; WHICH IS THE RESPONSIBILITY OF THE RESPECTIVE SUB-CONTRACTORS.
- 6. WORK NOT SPECIFICALLY DETAILED SHALL BE CONSTRUCTED TO THE SAME QUALITY AS SIMILAR WORK THAT IS DETAILED.
- 7. WRITTEN DIMENSIONS AND SPECIFIC NOTES SHALL TAKE PRECEDENCE OVER SCALED DIMENSIONS AND GENERAL NOTES.

CODES:

**HEATING:** 

1. NO NEW HEATING

1. THESE PLANS ARE INTENDED TO BE IN ACCORDANCE WITH THE 2018 INTERNATIONAL

2. ALL REFERENCES IN THESE DRAWINGS, DETAILS, AND SPECIFICATIONS ARE FROM THE

STANDARDS ADOPTED BY THE ROUTT COUNTY BUILDING DEPARTMENT. ALL

2018 INTERNATIONAL RESIDENTIAL CODE UNLESS OTHERWISE NOTED.

CONSTRUCTION SHALL CONFORM TO THESE CODES.

3. TYPE OF CONSTRUCTION: TYPE V, R3 OCCUPANCY.

RESIDENTIAL CODE, ALL LATEST GOVERNING CODES, CODE AMENDMENTS, AND LATEST

SNOW

LOAD

WIND - 115 MPH, EXP B

SEISMIC - Ss = 0.26g, S1 = 0.068g, GROUP I CATEGORY II

- 8. CO-ORDINATE ALL OPENINGS THROUGH FLOORS, WALLS AND ROOFS WITH THE MECHANICAL AND ELECTRICAL CONTRACTORS AND WITH THE FRAMING LAYOUT.
- 9. CONTRACTOR SHALL VERIFY AND IS RESPONSIBLE FOR ALL DIMENSIONS (INCLUDING ROUGH OPENINGS). 10. VERIFY SUBSTITUTED MATERIALS WITH THE ENGINEER OR WITH ASCEND DESIGN & CONSTRUCTION. THE MATERIAL SIZES NOTED ON THE PLANS ARE MINIMUM AND CAN BE
- SUBSTITUTED WITH STRONGER MATERIALS FOR EASE OF CONSTRUCTION OR ESTHETICS. 11. THE DESIGNERS RESPONSIBILITY IS LIMITED TO THE ITEMS SHOWN ON THE DESIGN

DRAWINGS. OBTAIN THE DESIGNERS SPECIFIC WRITTEN APPROVAL PRIOR TO

- DEVIATING FROM THESE DRAWINGS. 12. IT IS THE CONTRACTOR'S RESPONSIBILITY TO FOLLOW THE APPLICABLE SAFETY CODES AND REGULATIONS DURING ALL PHASES OF CONSTRUCTION. OBSERVATION VISITS TO THE SITE BY THE ENGINEER AND THE DESIGNER SHALL NOT INCLUDE INSPECTION OF THE CONTRACTOR'S MEANS, METHODS, TECHNIQUES, SEQUENCES FOR PROCEDURE OF CONSTRUCTION, OR THE SAFETY PRECAUTIONS AND THE PROGRAMS INCIDENT
- 13. CONTRACTOR SHALL BE RESPONSIBLE AND BEAR ANY FINES OR PENALTIES FOR CODE,
- ORDINANCE, REGULATION OR BUILDING PROCESS VIOLATIONS. 14. INSURANCES SHALL BE IN FORCE THROUGHOUT THE DURATION OF THE BUILDING
- 15. ALL TRADES SHALL MAINTAIN A CLEAN WORK SITE AT THE END OF EACH WORK DAY. 16. SEE ADDITIONAL NOTES CALLED OUT ON OTHER SHEETS.

#### **DESIGN NOTES:**

- 1. ALL EXTERIOR WALLS SHALL BE 2×6 (5 1/2") FRAMED UNLESS OTHERWISE NOTED. 2. ALL INTERIOR WALLS SHALL BE 2x4 (3 1/2") FRAMED UNLESS OTHERWISE NOTED. 3. HABITABLE ROOMS, HALLWAYS, CORRIDORS, BATHROOMS, TOILET ROOMS, LAUNDRY ROOMS AND BASEMENTS SHALL HAVE A CEILING HEIGHT OF NOT LESS THAN 7'-0". FOR
- EXCEPTIONS SEE (R305) 4. MINIMUM FIXTURE CLEARANCES SHALL BE IN ACCORDANCE WITH (R307.2) 5. ALL GLAZING SHALL BE IN ACCORDANCE WITH (R308) REFER TO (R308.4) FOR HAZARDOUS LOCATIONS REQUIRING SAFETY GLAZING (TEMPERED WINDOWS)
- 6. HALLWAYS SHALL HAVE A MINIMUM WIDTH OF 36" (R311.4) 7. WALLS, SOFFITS, AND UNDER STAIR SURFACE IN AN ENCLOSED ACCESSIBLE SPACE
- UNDER STAIRS SHALL HAVE 1/2" GYPSUM BOARD. 8. NOT LESS THAN ONE EXIT DOOR PROVIDED PER DWELLING UNIT. THIS DOOR SHALL BE
- NO LESS THAN 3'-0" WIDE AND 6'-8" IN HEIGHT. 9. APPROVED NUMBERS OR ADDRESSES SHALL BE PROVIDED FOR ALL NEW BUILDINGS IN SUCH A POSITION AS TO BE PLAINLY VISIBLE AND LEGIBLE FROM THE STREET OR ROAD
- FRONTING THE PROPERTY (R321.1) 10. AN ATTIC ACCESS OPENING SHALL BE PROVIDED TO ATTIC AREAS THAT EXCEED 30 SQUARE FEET AND HAVE A VERTICAL HEIGHT OF 30 INCHES OR GREATER (R807.1)



### NORTH RENDERING

RENDERINGS ARE NOT TO SCALE, TYPICAL; ALL RENDERINGS ARE FOR ARTISTIC DEPICTION ONLY. PLAN UPDATES MAY NOT BE REFLECTED IN RENDERINGS. RENDERINGS SHALL NOT BE USED FOR CONSTRUCTION.

#### CLIMATE & GEOGRAPHIC DESIGN CRITERIA ICE SHIELD FLOOD MEAN MINTER AIR MIND SEISMIC SUBJECT TO DAMAGE FROM UNDERLAYMENT DESIGN HAZARDS FREEZING ANNUAL SPEED DESIGN CATEGORY WEATHERING TERMITE DECAY REQUIRED TEMP (F) INDEX TEMP (F) (MPH) NONE TO NON TO STEAMBOAT 40° - 4**5**° 2239 SLIGHT SLIGHT

DESIGN LIVE & SNOW LADS		GOVERNING CODES
ROOF, UNCOVERED DECK	85 PSF ROOF	INTERNATIONAL RESIDENTIAL CODE (IRC), 2018 EDITION
SNOW		INTERNATIONAL PLUMBING CODE (IPC), 2018 EDITION
FLOORS	40	INTERNATIONAL MECHANICAL CODE (IMC), 2018 EDITION
PSF LIVE		INTERNATIONAL FUEL GAS CODE (IFGC), 2018 EDITION
GARAGE	50	INTERNATIONAL ENERGY CONSERVATION CODE (IECC), 2018 EDITION
PSF LIVE, 2000 Ib POINT LOAD		NATIONAL ELECTRIC CODE, (NEC) 2020 EDITION

#### 2018 International Energy Conservation Code Checklist for General Prescriptive Method

Building Components Thermal Envelope R402: General Prescriptive Method to Compliance				
Vapor Retarder: Class I =Poly Class II =Kraft-Faced insulation Class III = Paint	Follow IRC Section R702.7 or IBC Section 1405.3 Class of vapor retarder is based upon selected methods of insulating the exterior walls of the structure.			
Windows and Doors U-Factor = 0.30	R402.1.5 Total UA Alternative may be used to lower the U-Factor			
Skylights U-Factor = 0.55	R402.1.5 Total UA Alternative may be used to lower the U-Factor			
Ceiling Insulation with Attic Space = R49	R402.2.1 reduction to R38 wherever the full height of uncompressed R-38 extends over the wall top plate at the eaves.			
Ceiling Insulation without Attic Space = R-49	R402.2.2 reduction to R30 provided when roof/ceiling assemblies don't have sufficient space.			
Wood Framed Wall Insulation : 2x6 wall = R20/5 Wood Framed Wall Insulation: 2x6 wall = R22/3 Wood Framed Wall Insulation: 2x6 wall = R27/0 Wood Framed Wall Insulation: 2x4 wall = R13/10	R20 in the cavity of the wall and R5 continuous insulation, R22 in the cavity of the wall and R3 continuous insulation, or R27 in the cavity of the wall and no continuous insulation. Walls with Structural Sheathing see Section R402.2.7 for reduction R13 in the cavity of the wall and R10 continuous insulation. Walls with Structural Sheathing see Section R402.2.7 for reduction			
Mass Walls R-19/21	Defined & Reviewed based upon formula from Section 402.2.5			
Floor Insulation = R38	See Section 402.2.8 for definition and exception			
Basement Wall Insulation = R-15/19	See Section 402.2.9 for definition R15 continuous on either side or R19 on interior side. See footnotes in R402.1.2 for alternatives			
Concrete Slab on Grade Insulation = R10/4ft	See Section R402.2.10 Insulation depth shall be depth of the footing minimum of 4 feet.			
Crawl Space Wall Insulation = R15/19	See Section R402.2.11 for definition R15 continuous on either side or R19 on interior side.			
Fenestration Air Leakage: windows, sliding doors, skylights	= 0.3 cfm/sf Exception for site built windows, skylights, and doors.</td			
Fenestration Air Leakage: Swinging Doors	= 0.5 cfm/sf Exception for site built doors.</td			
Air Leakage: The building thermal envelop shall be constructed to limit air leakage.	All products installed in accordance with manufactures instructions and be labeled in accordance with the requirements of the 2018 IECC.			
Fireplaces new wood-burning units	See Section R402.4.2 Information on tight fitting doors and labels required.			

#### AREA'S

EXISTING GARAGE: GARAGE ADDITION: NEW GARAGE TOTAL:

600 SQ. FT. 215 SQ. FT. 815 SQ. FT.

#### DRAWING INDEX

SHEET	TITLE	PAGE
C0 C1 A0 A1 A2 A4 A5 A6 S1 S2 S4 E1 E2	COYER PAGE SITE PLAN EXISTING FLOOR PLANS EXISTING ELEVATIONS EXISTING ELEVATIONS NEW GARAGE FLOOR PLAN NEW UPPER FLOOR PLAN NEW ELEVATIONS NEW ELEVATIONS NEW ELEVATIONS FOUNDATION PLAN & DETAILS FOUNDATION DETAILS ROOF FRAMING PLAN DECK FRAMING PLAN UPPER FLOOR ELECTRICAL PLAN UPPER FLOOR ELECTRICAL PLAN	1 2 3 4 5 6 7 8 9 10 11 12 13 14 15

Reviewed for Code Compliance


10/02/2023


ADE 

0 SC


PROJECT NUMBER: 2022.009 MARCH 10, 2023 DRAWN BY: FRANK RELEASE DATE:

**PERMIT SET** 

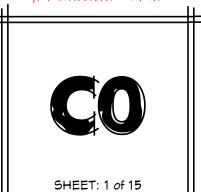

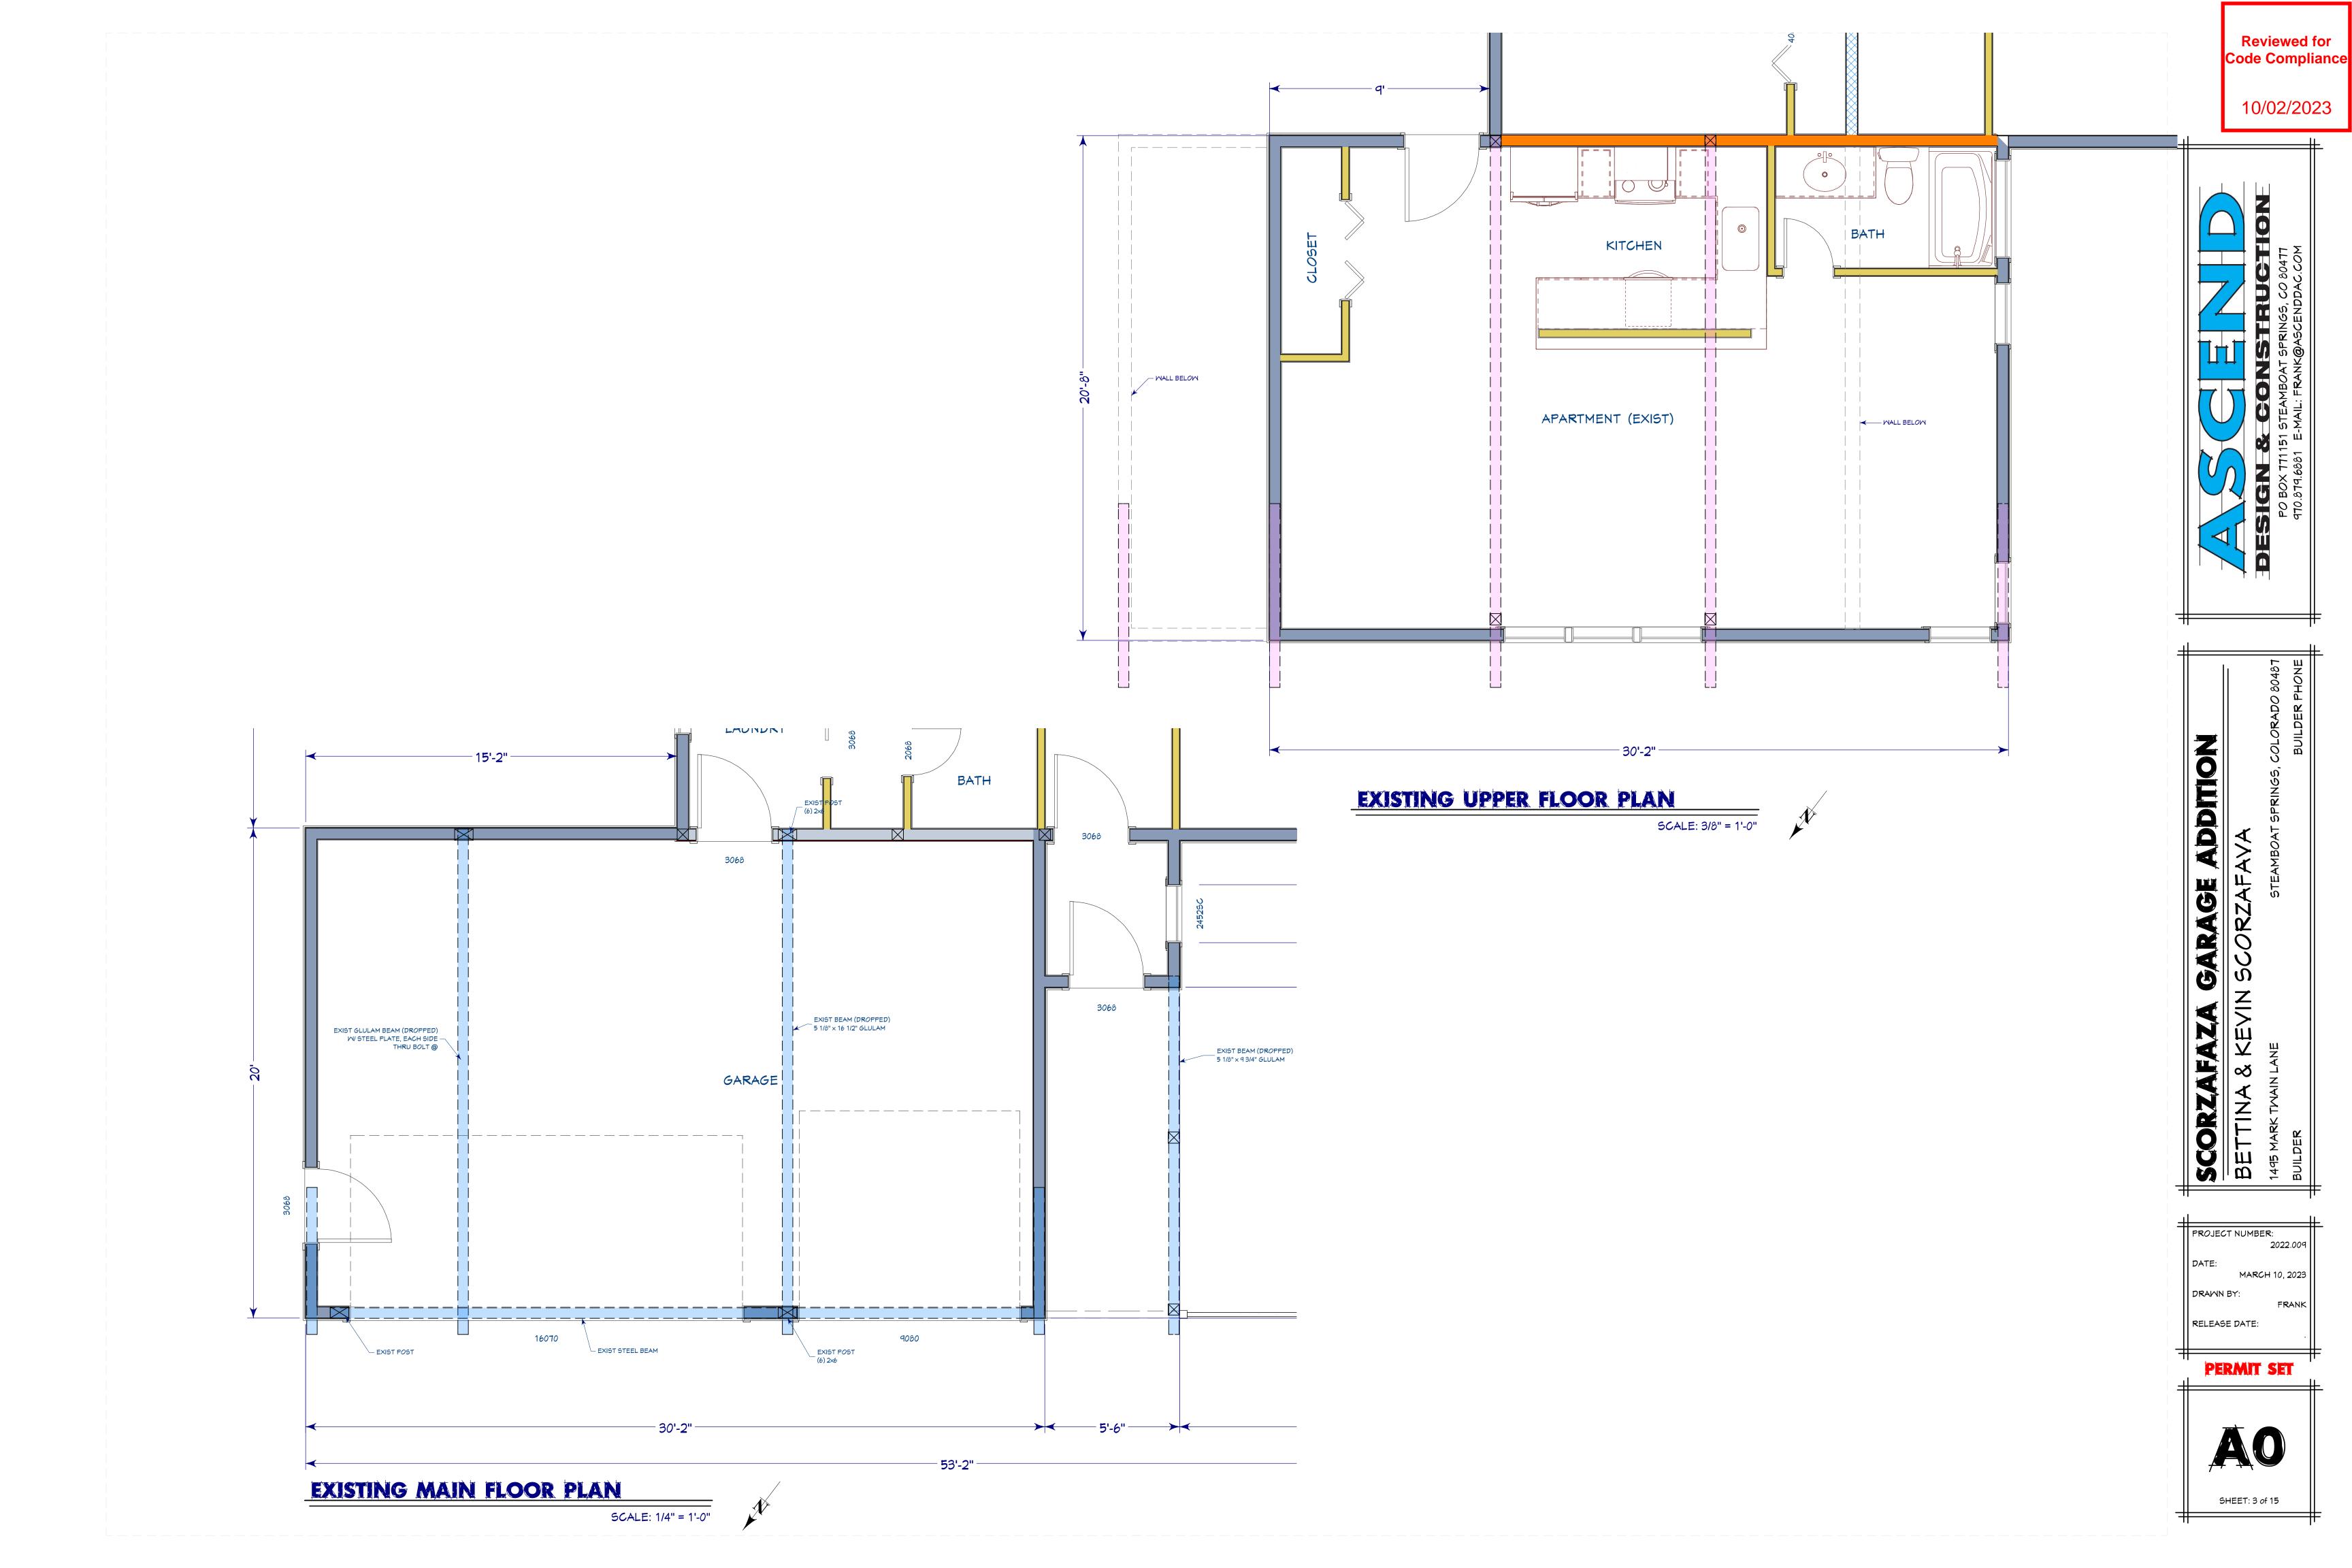

10/02/2023

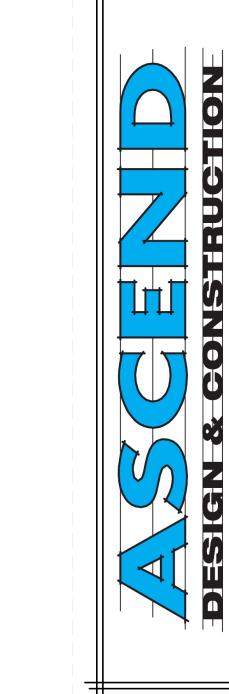

SCORZAFAZA GARAGE ADDITION
BETTINA & KEVIN SCORZAFAVA
BUILDER


STEAMBOAT SPRINGS, COLC

PROJECT NUMBER:

MARCH 10, 2023 DRAWN BY: RELEASE DATE:

2022.009

PERMIT SET

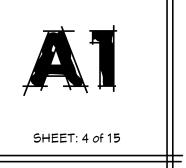




# EXISTING FRONT ELEVATION

SCALE: 1/4" = 1'-0"



## EXISTING RIGHT SIDE ELEVATION

10/02/2023

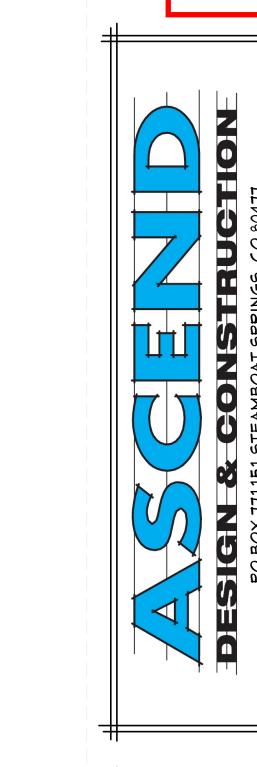

SCORZAFAZA GARAGE ADDITION


BETTINA & KEVIN SCORZAFAVA

BUILDER

BUILDER

PROJECT NUMBER: 2022.009 MARCH 10, 2023 DRAWN BY: RELEASE DATE:

PERMIT SET

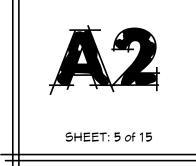




# EXISTING LEFT SIDE ELEVATION


SCALE: 1/4" = 1'-0"



# EXISTING REAR ELEVATION

SCALE: 1/4" = 1'-0"

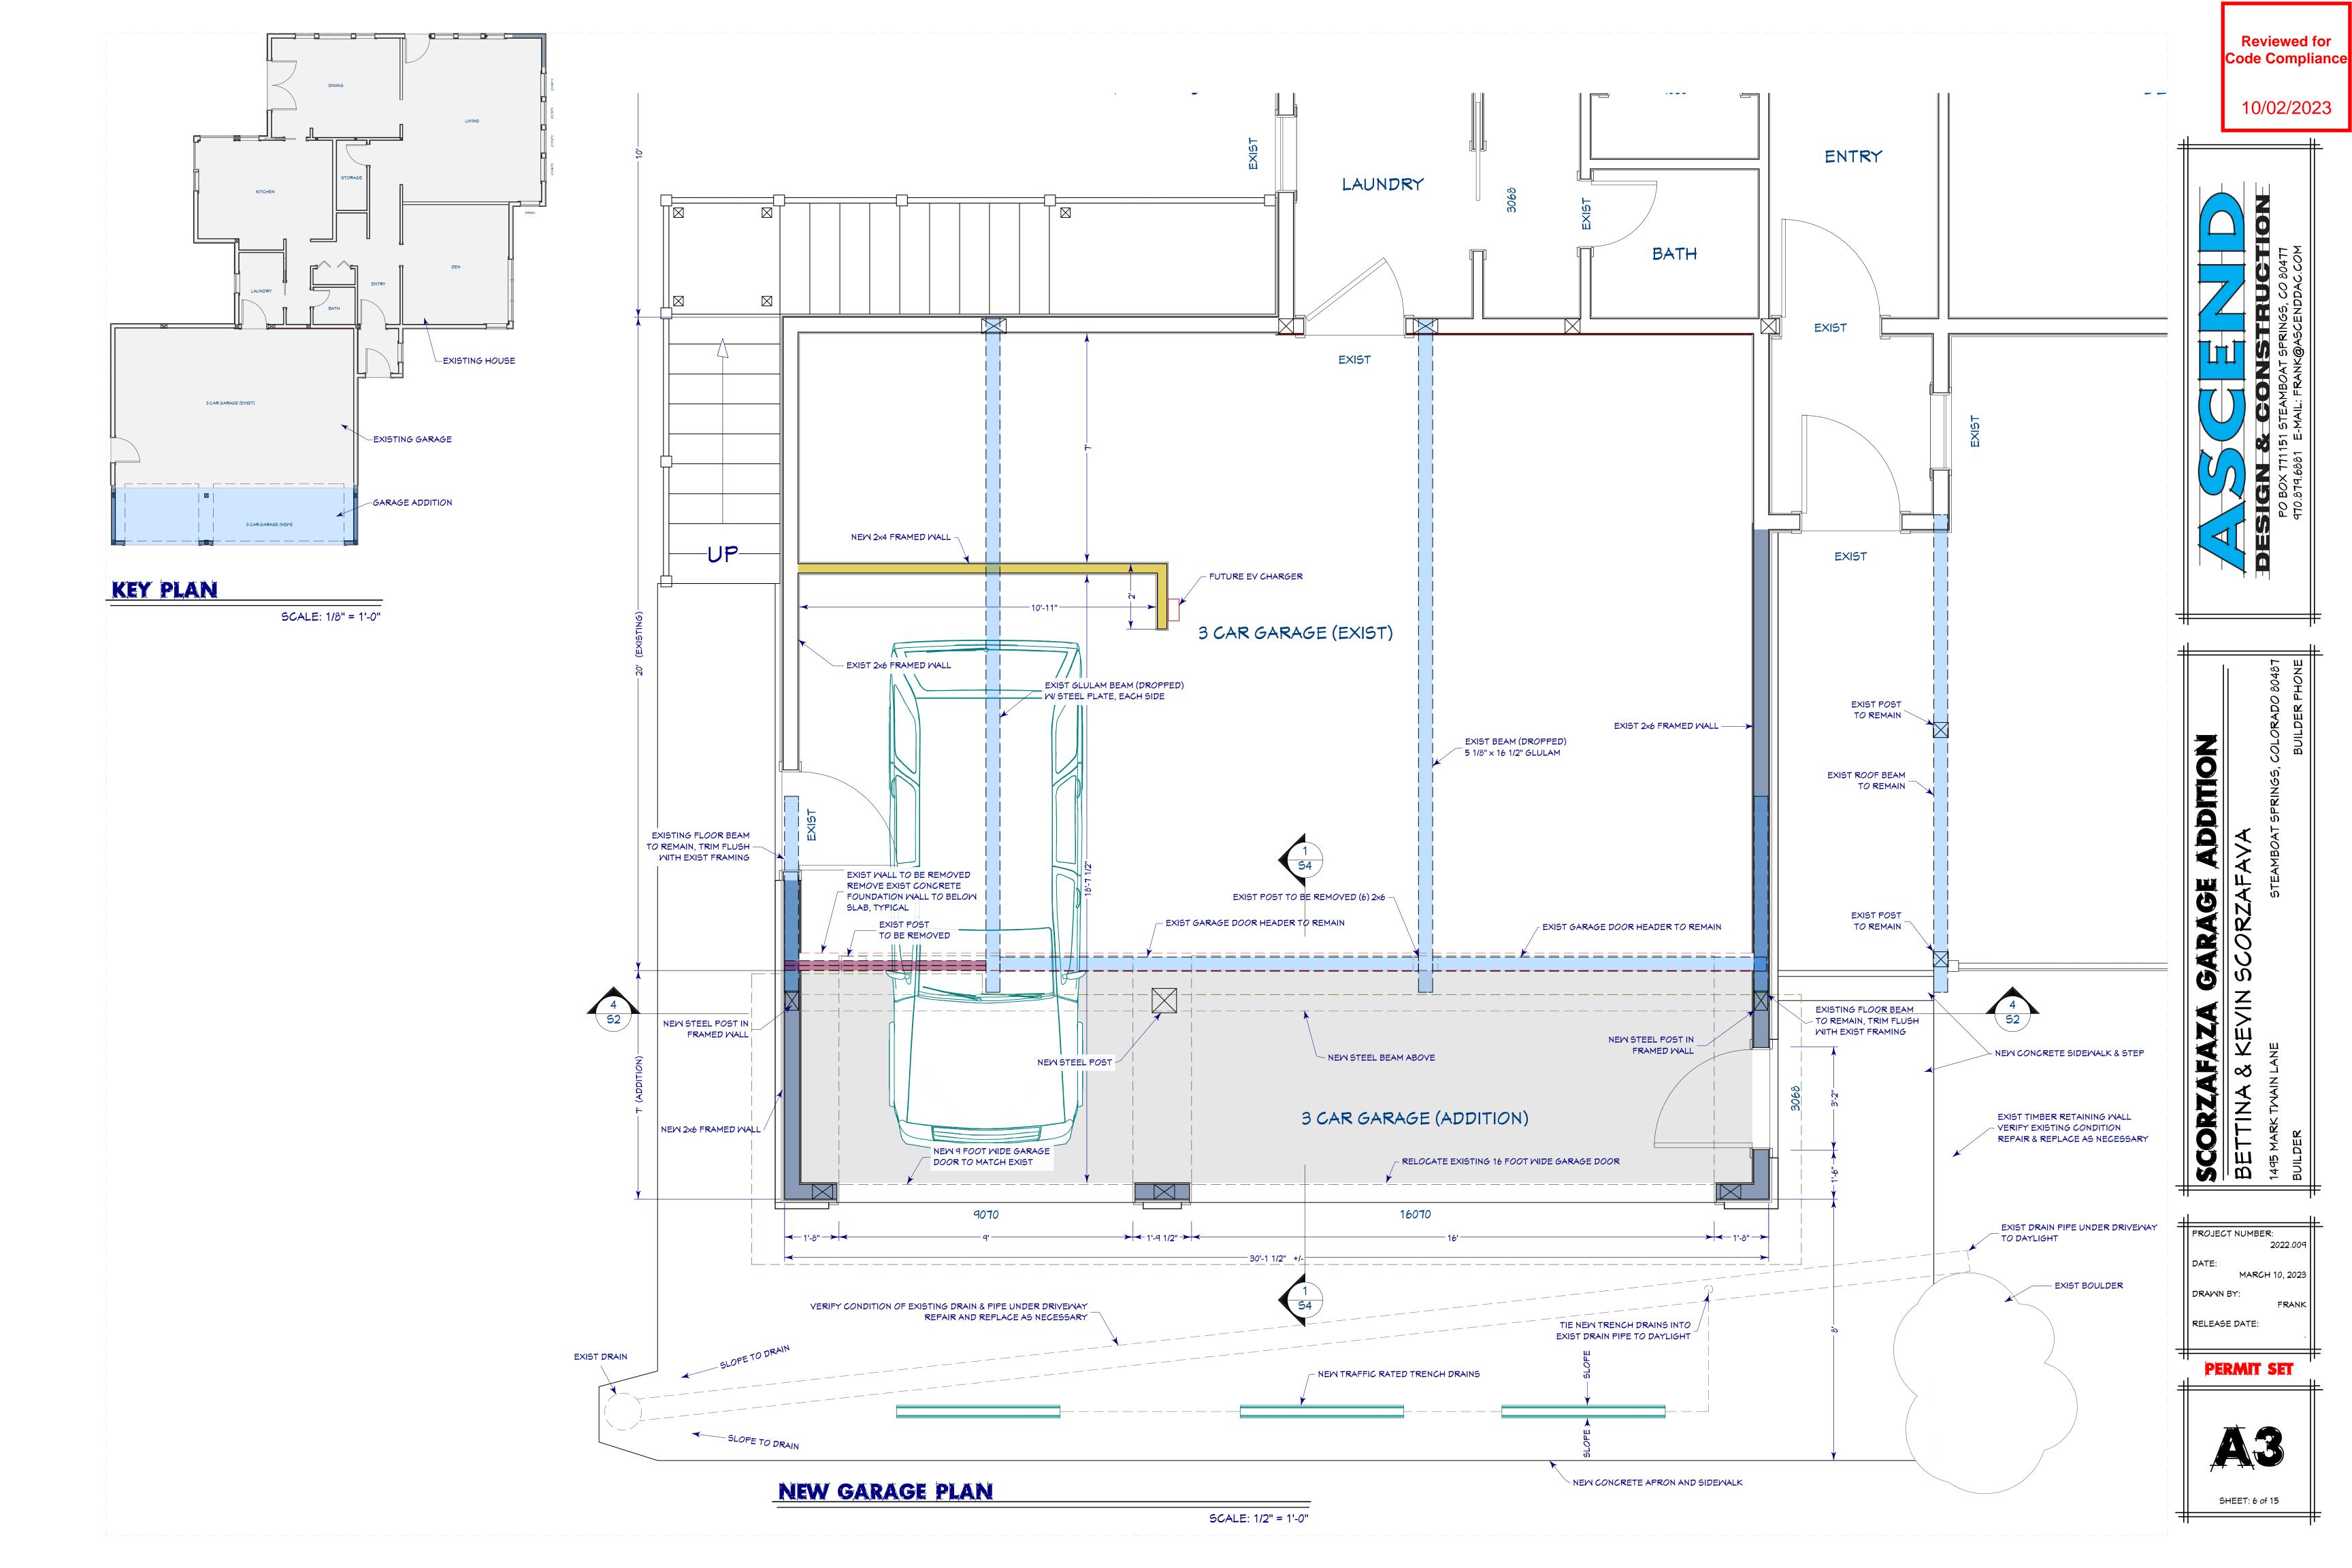

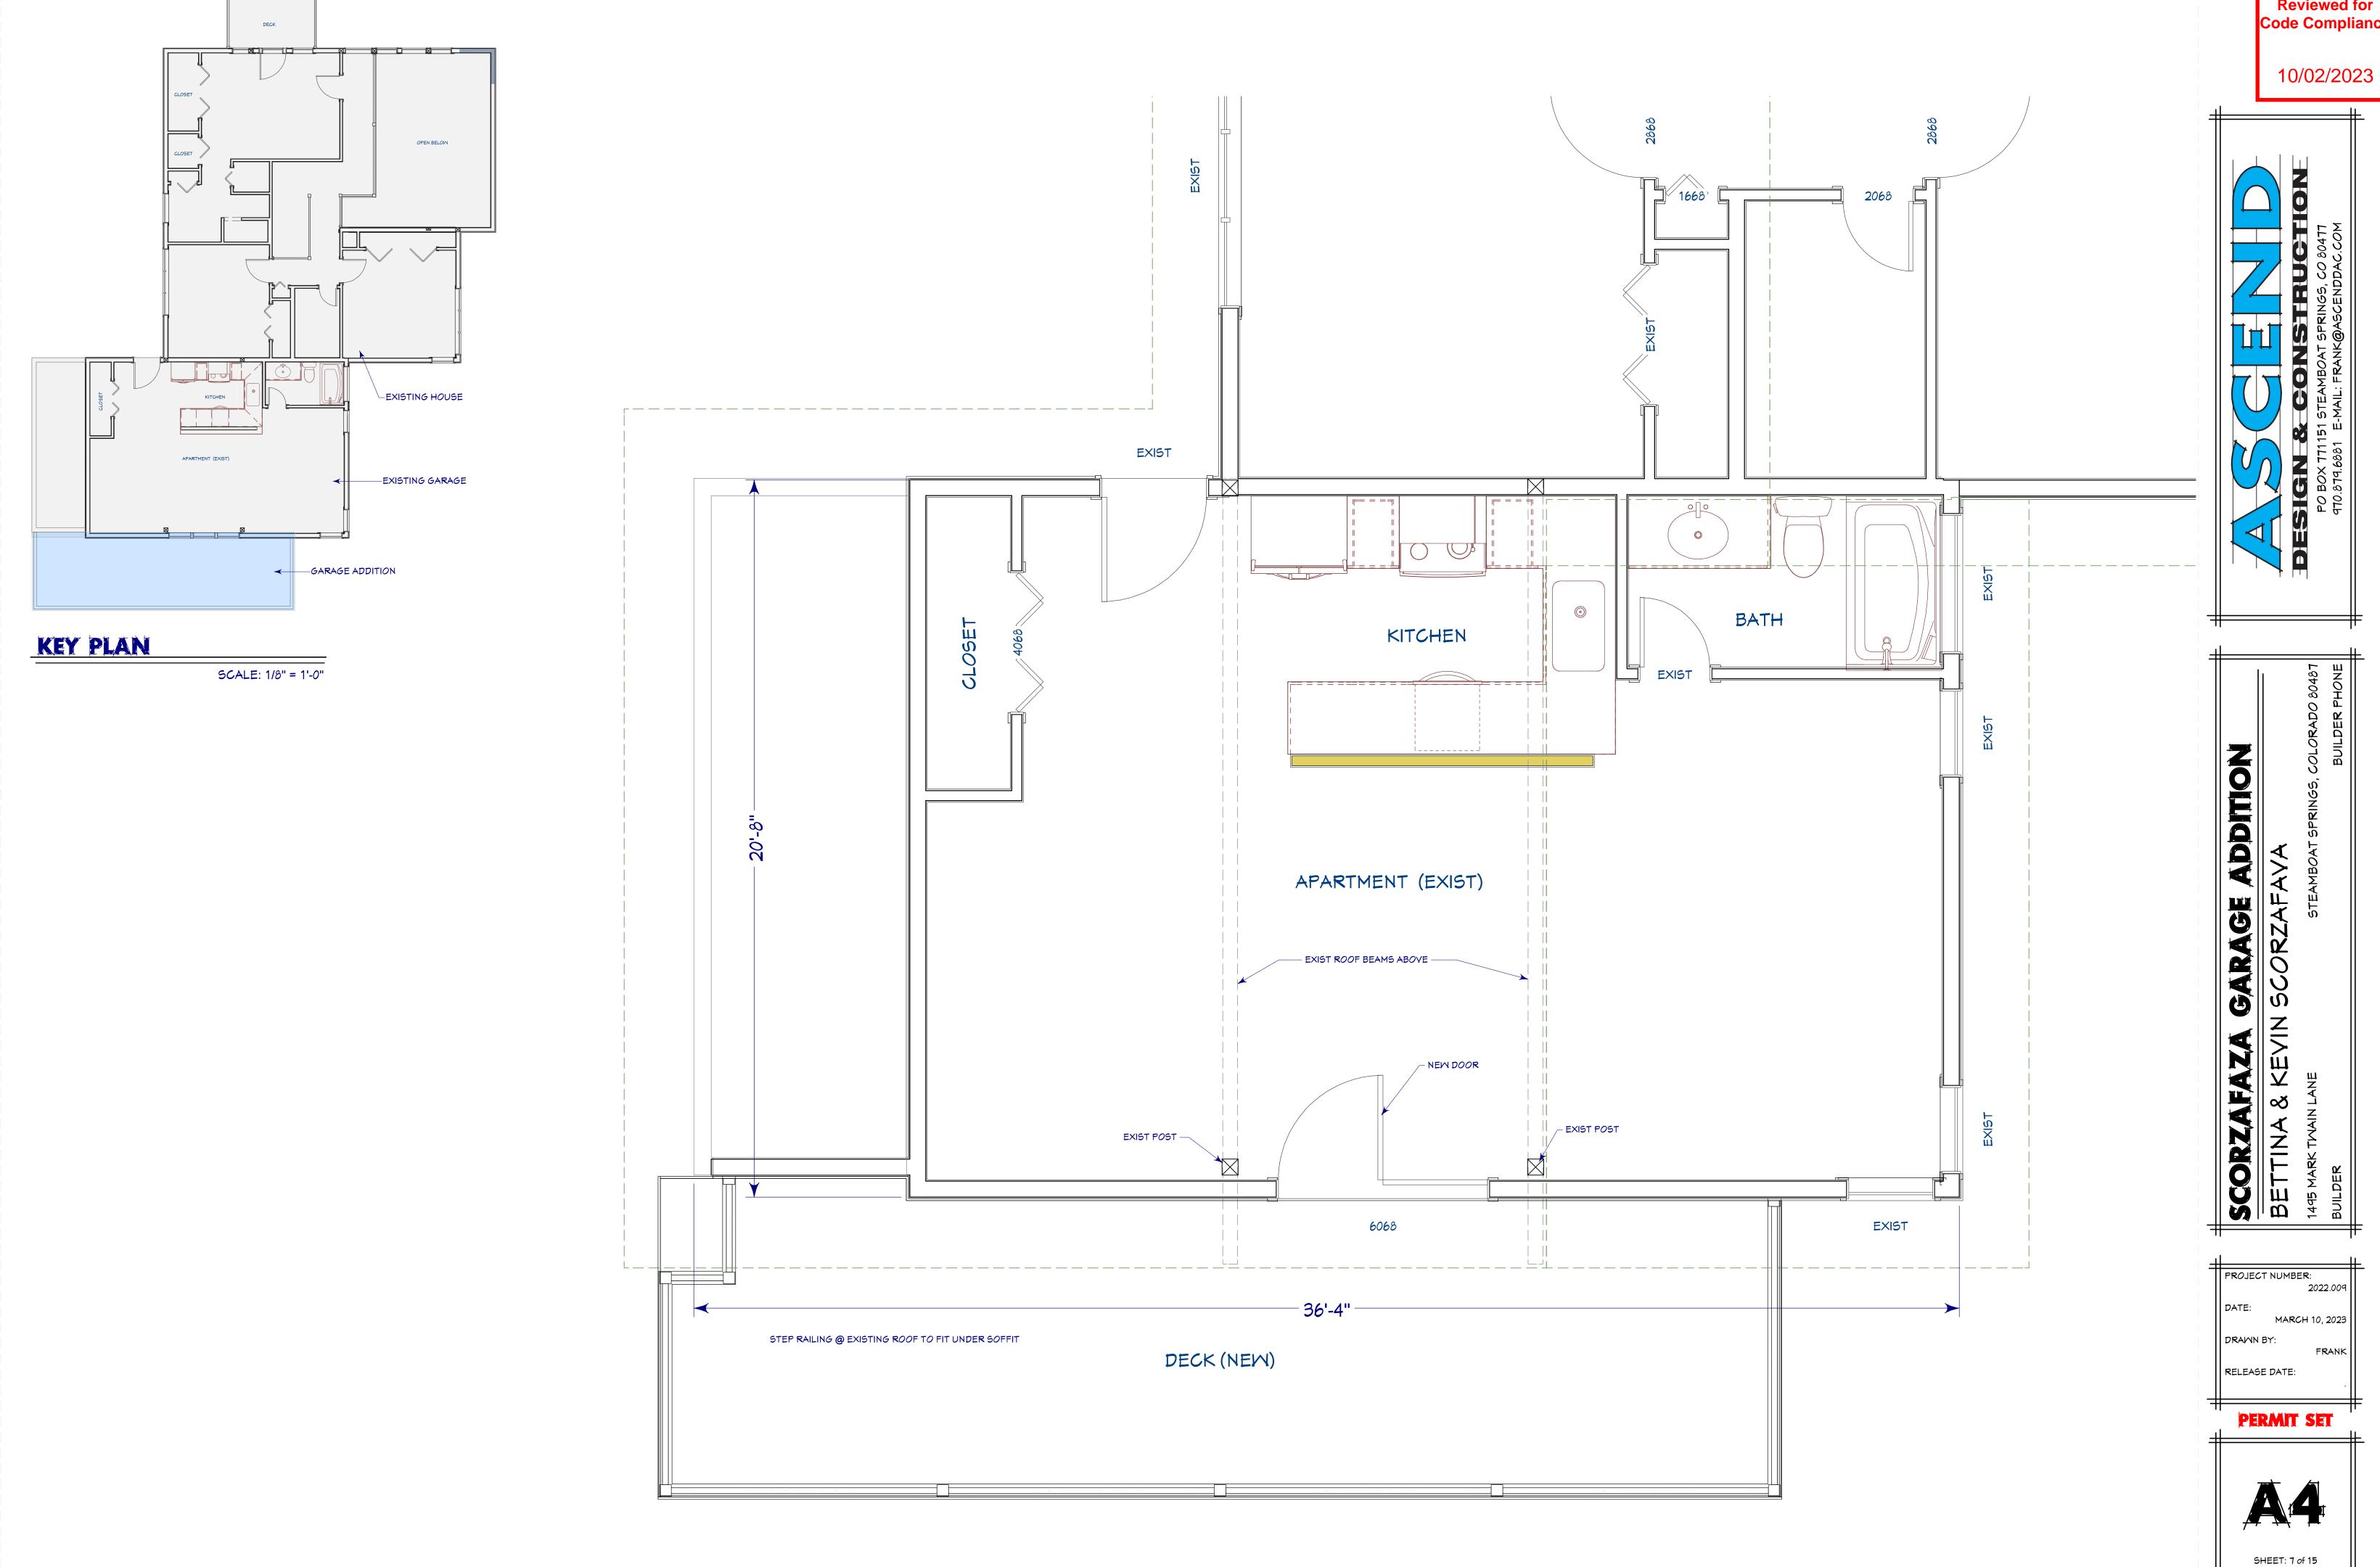

**Reviewed for** Code Compliance



Reviewed for Code Compliance

10/02/2023

PO BOX 771151 STEAMBOAT SPRINGS, CO 80477
970.879.6881 E-MAIL: FRANK@ASCENDDAC.COM

SCORZAFAZA GARAGE ADDITION

BETTINA & KEVIN SCORZAFAVA


PROJECT NUMBER:
2022.009

DATE:
MARCH 10, 2023

DRAWN BY:
FRANK

RELEASE DATE:

PERMIT SET

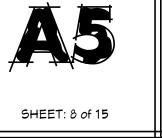

10/02/2023



ADDITION


SCORZAFAZA SCORZAFAZA DETTINA & KEVIN 1495 MARK TWAIN LANE BUILDER

PROJECT NUMBER: 2022.009 MARCH 10, 2023 DRAWN BY:

PERMIT SET


RELEASE DATE:



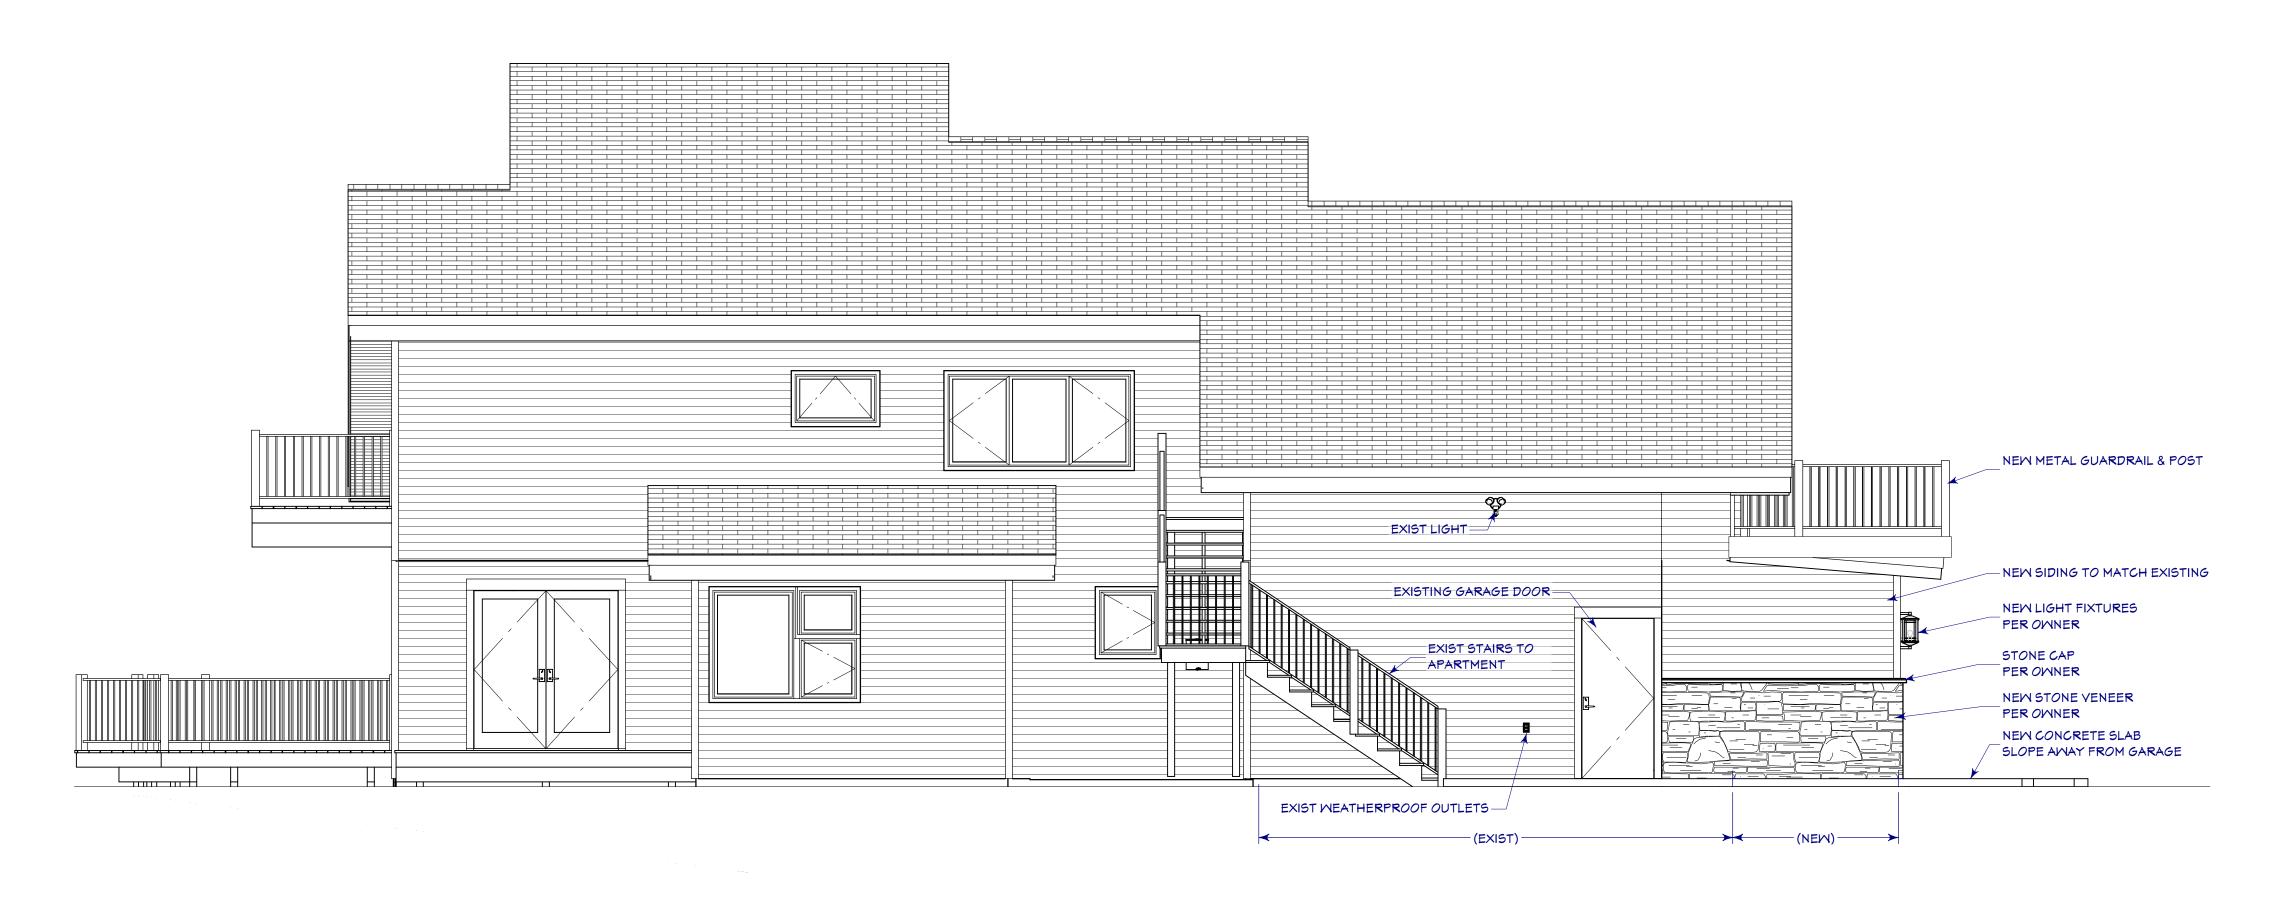

## NEW LEFT SIDE ELEVATION

SCALE: 1/4" = 1'-0"

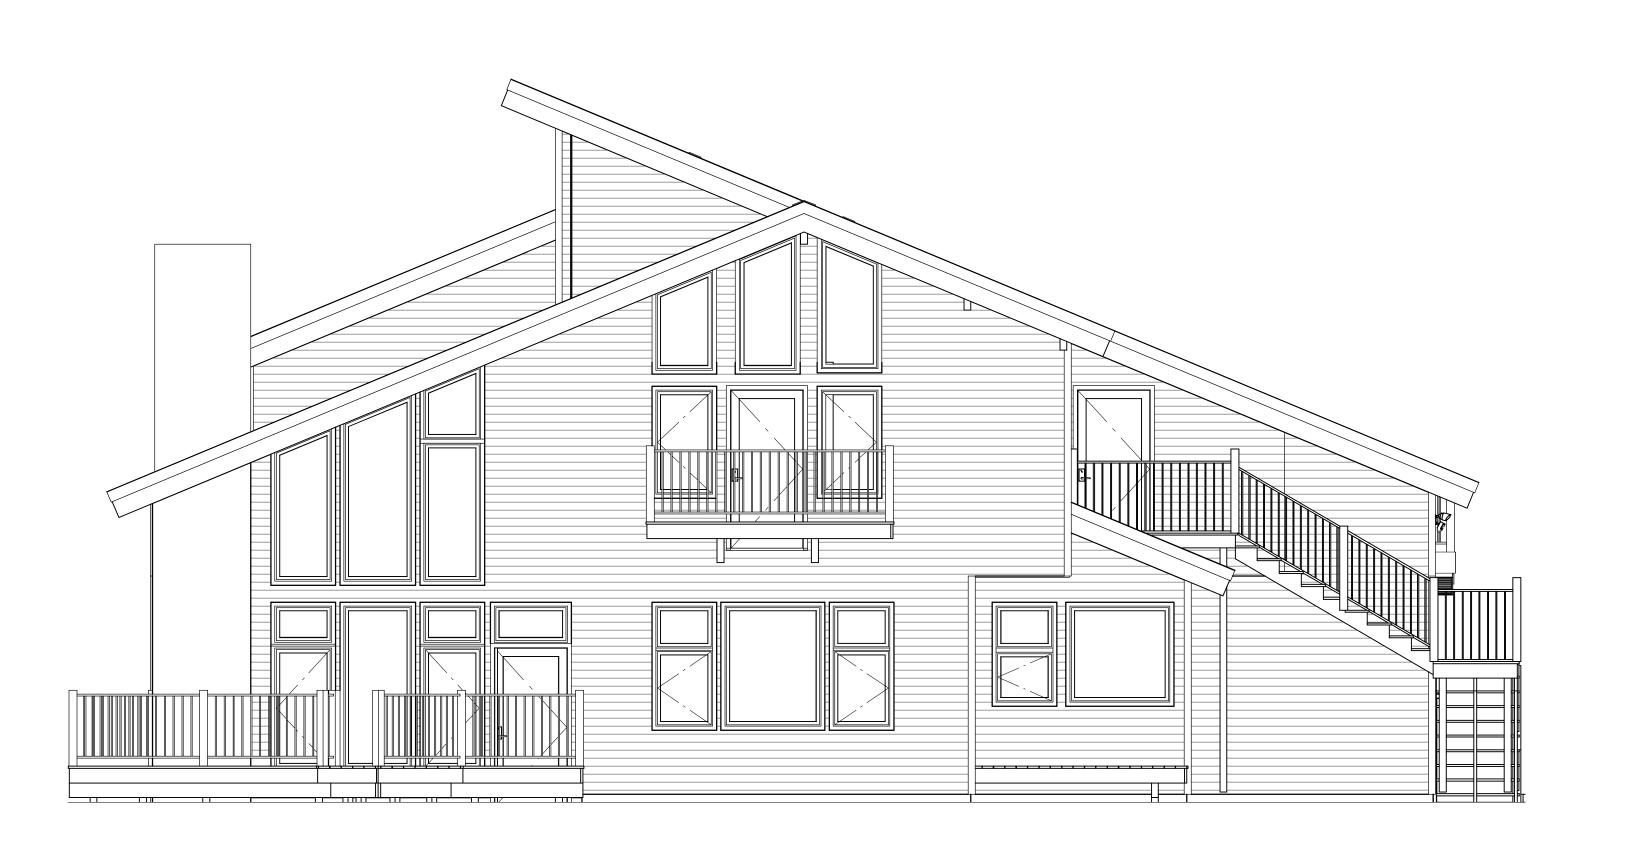

## NEW REAR ELEVATION