PROJECT INFORMATION

FOLLOWING ARE THE PLANS OUTLINING THE SCOPE OF WORK REQUIRED FOR THE NEW CONSTRUCTION AND RENOVATION OF THE STEAMBOAT BASE VILLAGE. THE WORK OF PROJECT IS DEFINED BY THE CONTRACT DOCUMENTS. THE WORK IS TO INCLUDE THE INTERIOR RENOVATION OF THE EXISTING BUILDING A STORAGE SPACE TO CREATE A NEW MERCANTILE OCCUPANCY RETAIL SPACE. THE WORK WILL INCLUDE NEW PARTITIONS, CEILINGS, FINISHES, MECHANICAL, AND ELECTRICAL. NO EXTERIOR RENOVATIONS ARE INCLUDED IN THIS PROJECT. THE DRAWINGS, IN CONCERT WITH THE PROJECT MANUAL, COMPRISE THE CONTRACT DOCUMENTS OUTLINING THE DESIGN INTENT AND PROJECT SCOPE, AND MAY BE SUPPLEMENTED BY FURTHER INFORMATION ISSUED BY ARCHITECT THE DRAWINGS ARE ARRANGED IN GENERAL TO SPECIFIC ORDER, FOLLOWING A TOP TO BOTTOM, RIGHT TO LEFT FORMAT. CONTRACTORS ARE ADVISED TO READ AND FAMILIARIZE THEMSELVES WITH THE INFORMATION IN THE PROJECT MANUAL, AS WELL AS THE GENERAL LEGENDS CONTAINED IN THE G SERIES OF DRAWINGS, PRIOR TO REVIEW OF THE PLANS, ELEVATIONS AND DETAILS. ADVISE THE ARCHITECT WHERE INTENT IS NOT CLEARLY PERCEIVED, PRIOR TO PROCEEDING WITH WORK. BUILDING ADDRESS: 2305 MOUNT WERNER CIRCLE STEAMBOAT SPRINGS, CO 80487 BUILDING JURISDICTION: ROUTT COUNTY, STEAMBOAT SPRINGS, COLORADO APPLICABLE CODES: 2018 INTERNATIONAL BUILDING CODE 2018 INTERNATIONAL MECHANICAL CODE 2018 INTERNATIONAL PLUMBING CODE 2018 INTERNATIONAL FUEL GAS CODE 2018 INTERNATIONAL FIRE CODE 2020 NATIONAL ELECTRIC CODE 2018 INTERNATIONAL ENERGY CONSERVATION CODE ASHRAE 90.1 2016 2009 ICC A117.1, ACCESSIBILITY REQUIREMENTS 2010 ADA ACCESSIBILITY GUIDELINES ANSI/ASME A17.1, SAFETY CODE FOR ELEVATORS 2013 USEABLE BUILDING & FACILITIES CODE STEAMBOAT SPRINGS AND ROUTE COUNTY CODE AMENDMENTS OCCUPANCY TYPE: M-MERCANTILE, S-2 STORAGE SEPARATED USE: NON SEPARATED MIXED OCCUPANCY CONSTRUCTION TYPE: TYPE IIA FIRE SUPPRESSION: FIRE RESISTIVE, (100% SPRINKLERED)


FIRE ALARM AND SMOKE DETECTION SYSTEM PER IBC 907.2 & NFPA 72 FIRE ALARM SYSTEM


 FIRE SPRINKLER SYSTEM ACCESS CONTROL HARDWARE NUMBER OF STORIES IN BUILDING: 4 STORIES (ABOVE GRADE) 1 STORY (BELOW GRADE) TOTAL FLOOR AREA: 32,340 SF

SCOPE OF WORK AREA: 1,406 SF LEED CERTIFICATION: NONE

FIRE ALARM SYSTEM:

DEFERRED SUBMITTALS:

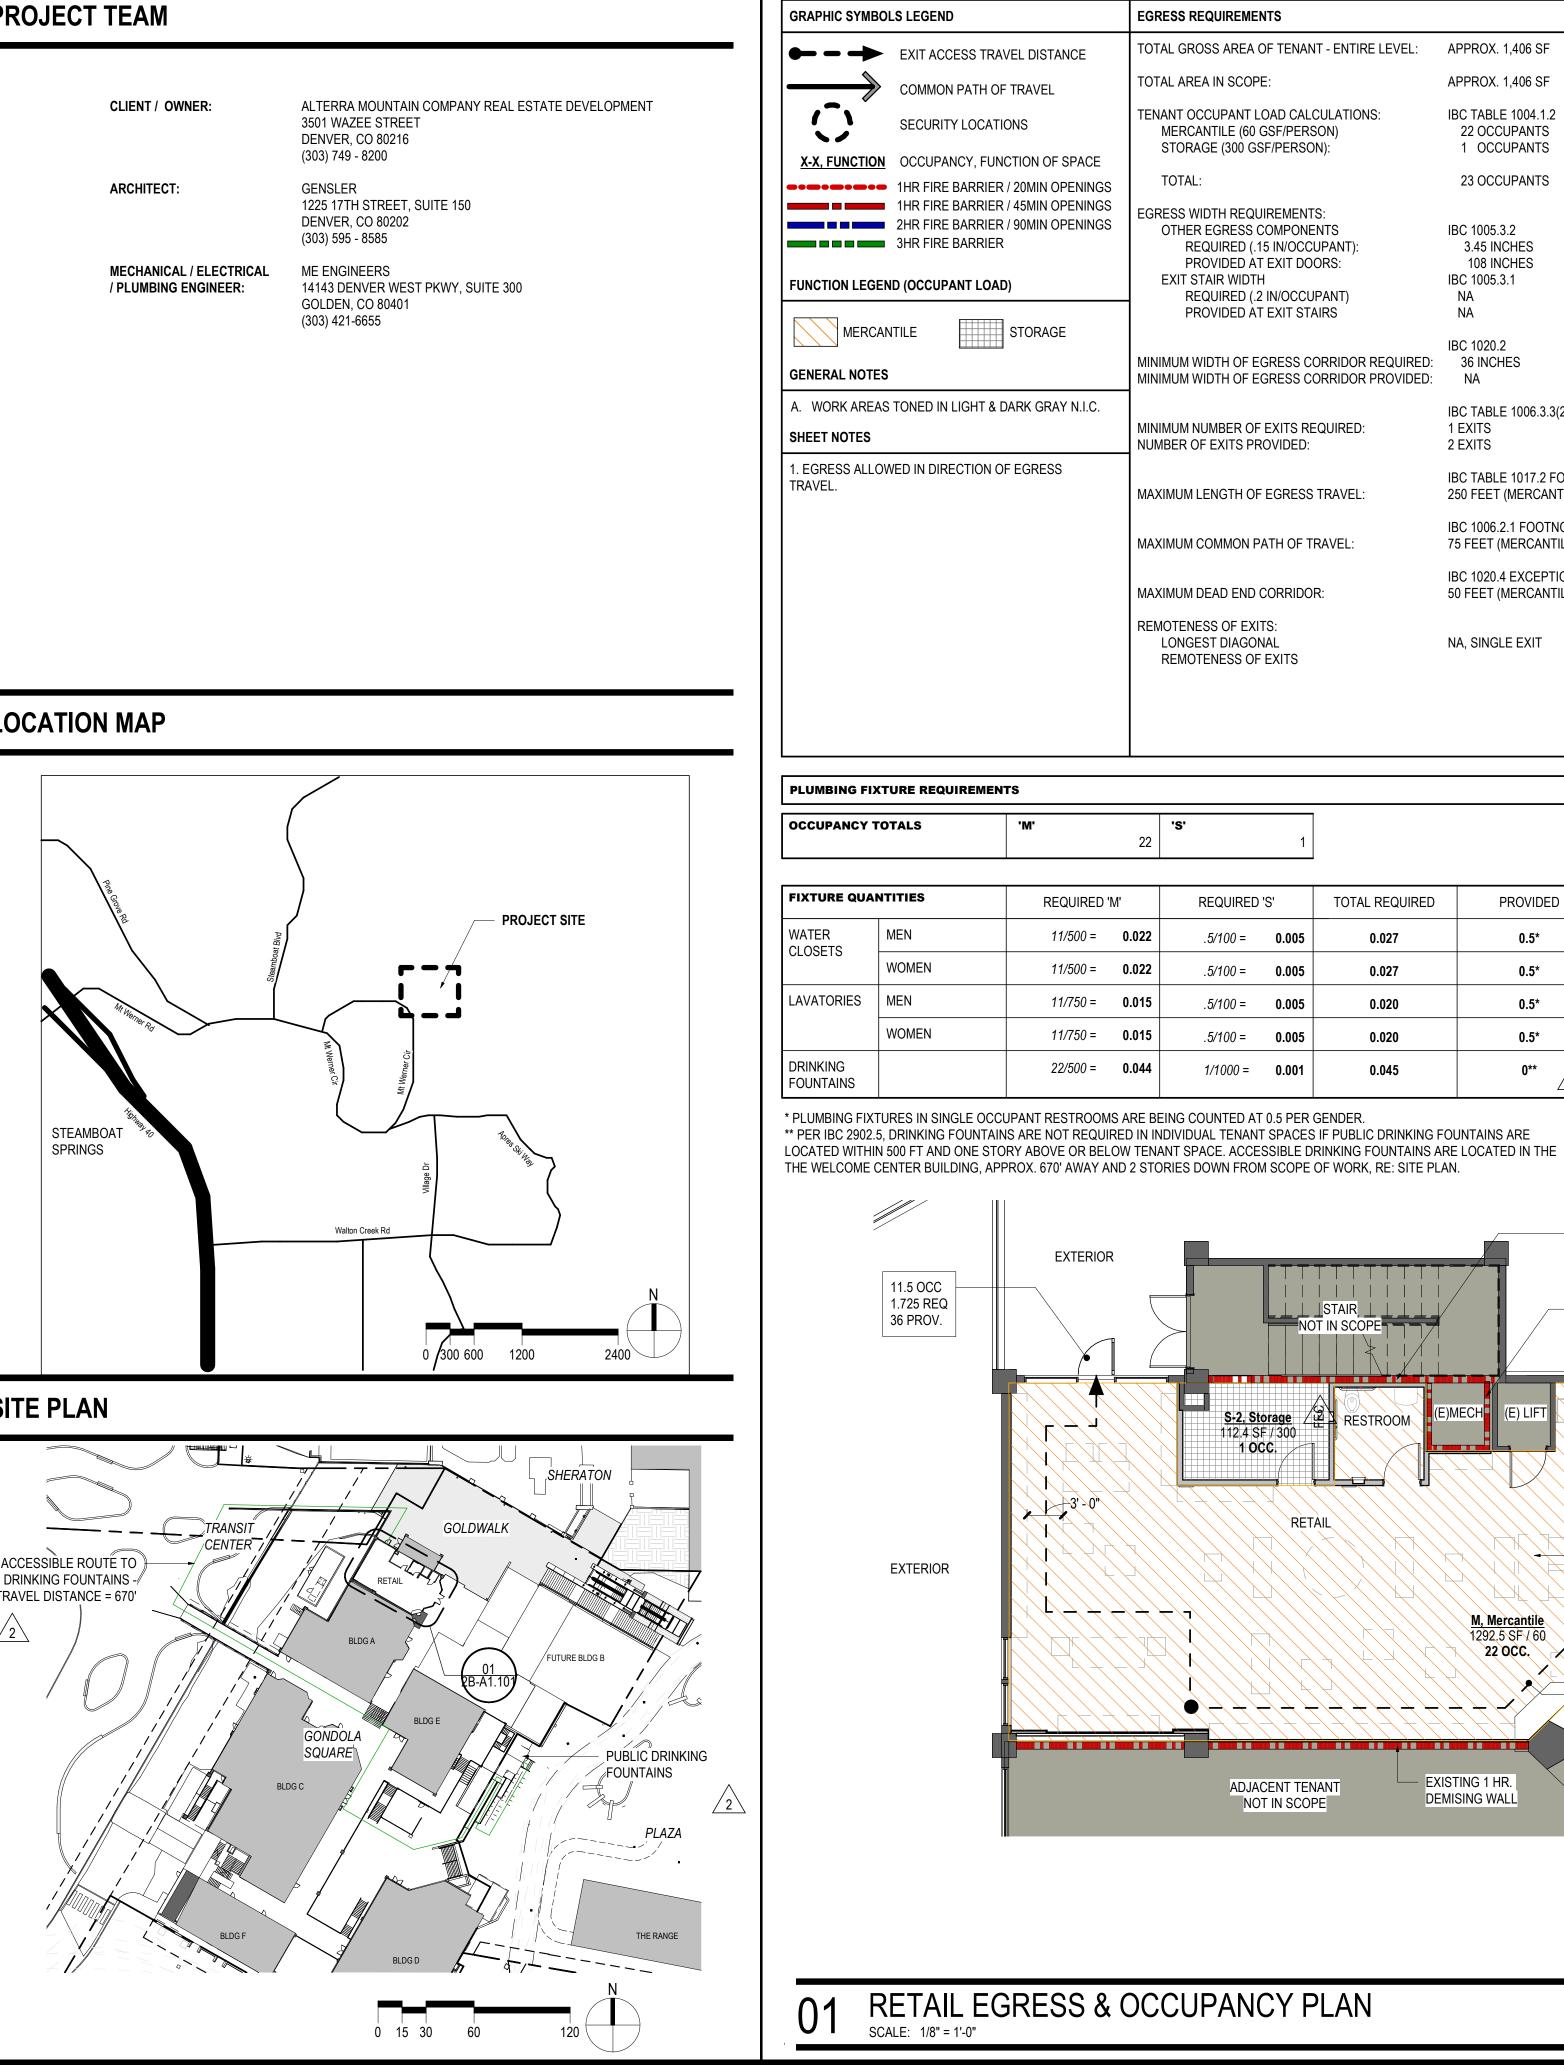


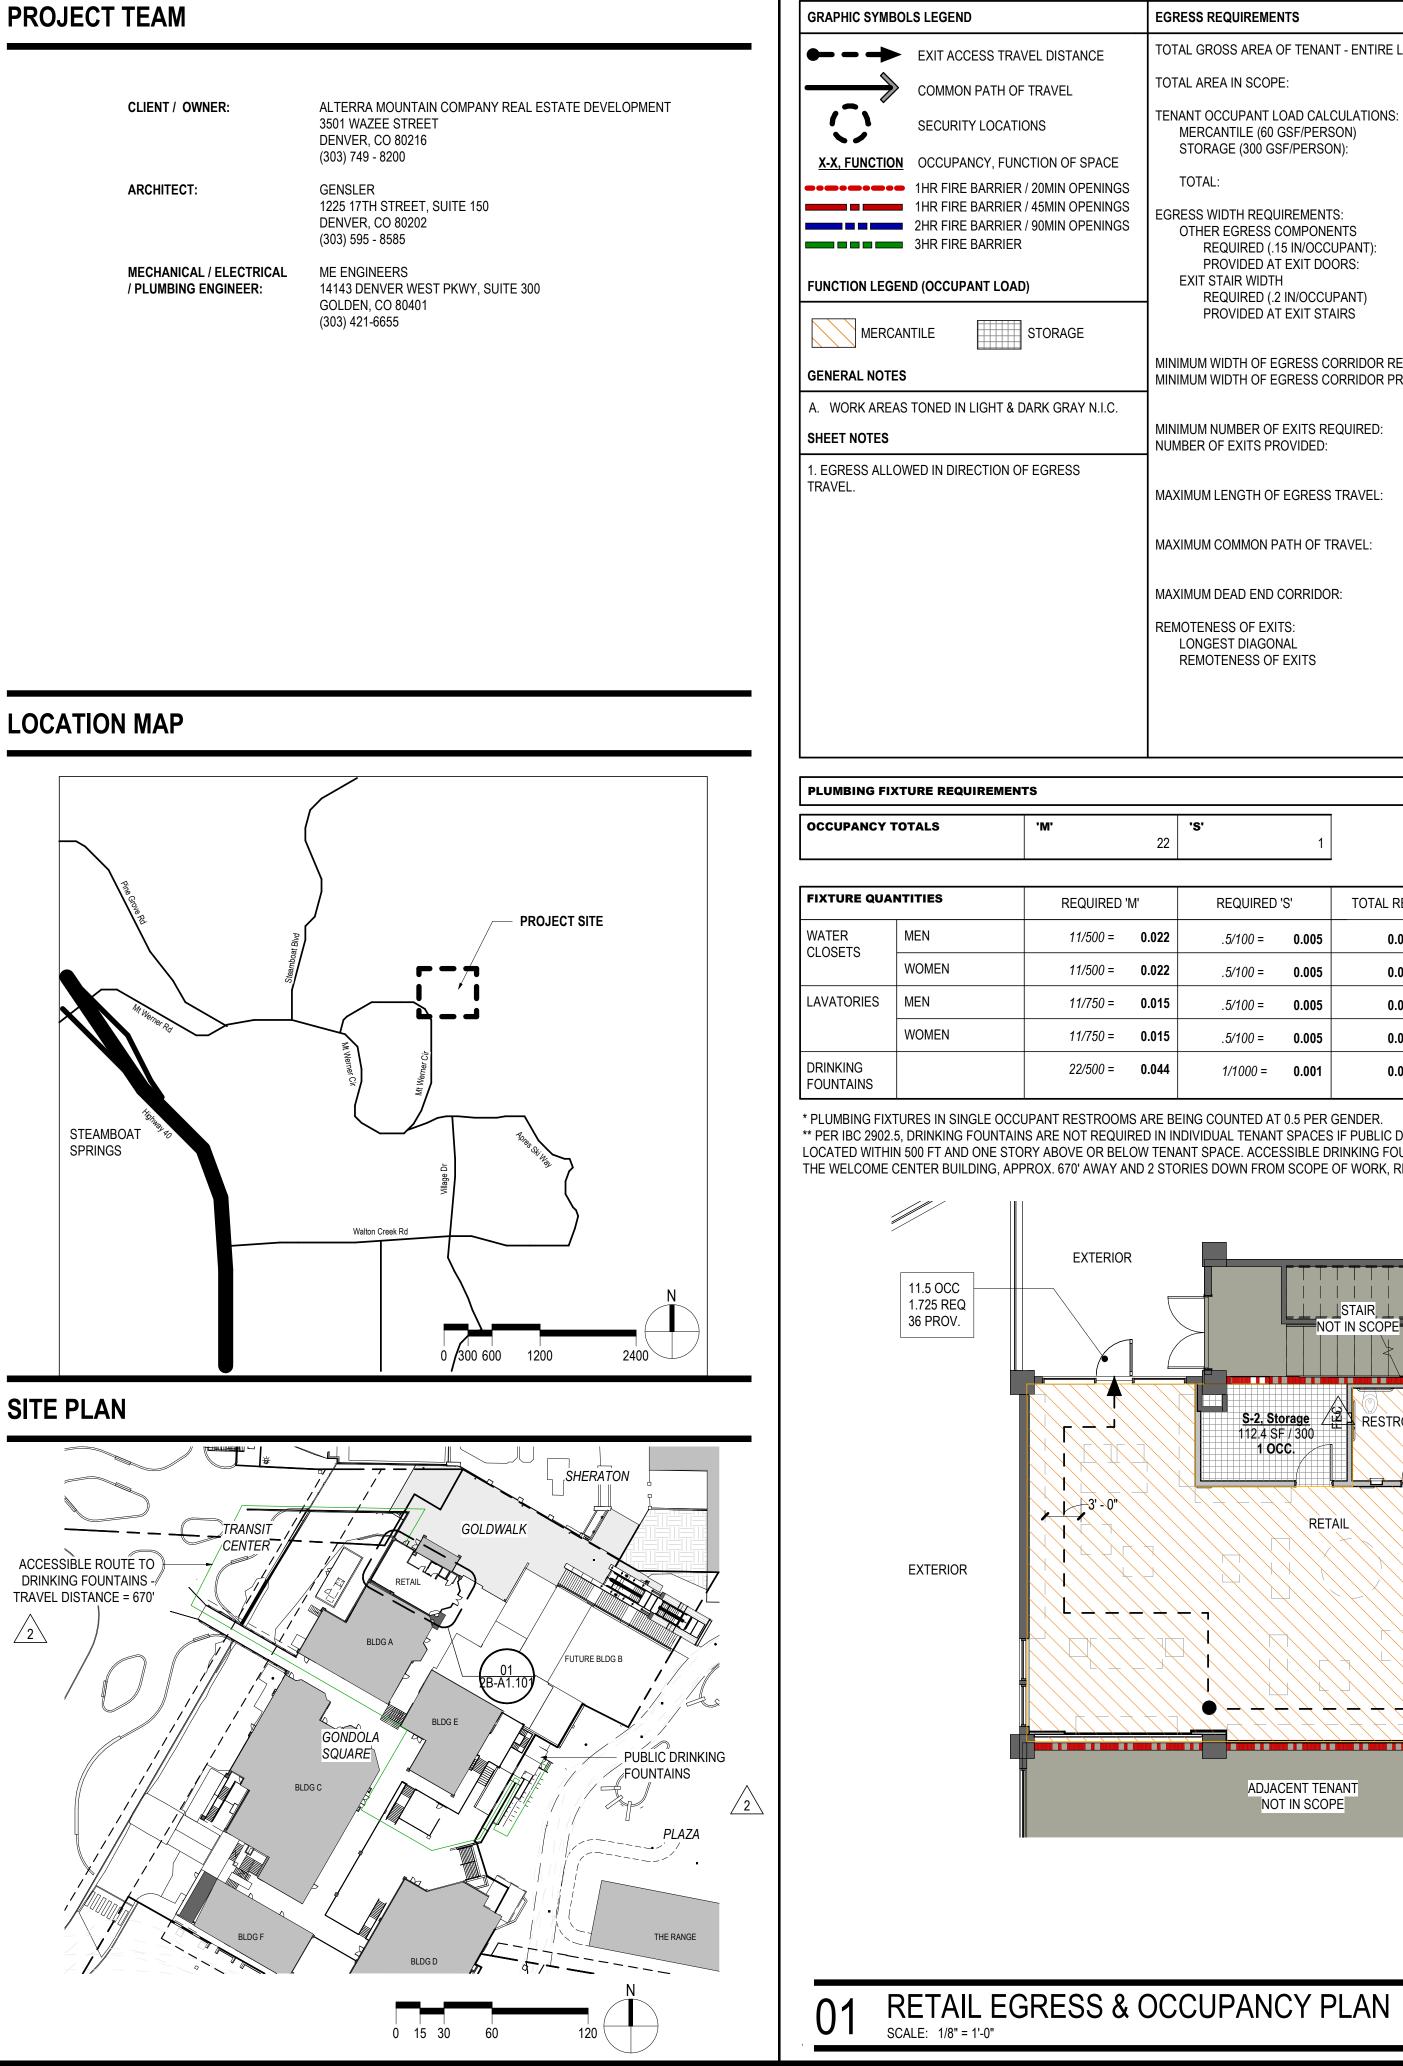

STEAMBOAT SKI & RESORT CORPORATION

SSRC | BASE AREA IMPROVEMENTS 2305 Mount Werner Circle Steamboat Springs, CO 80487


Building A: Retail - BULLETIN 02 2022.08.10

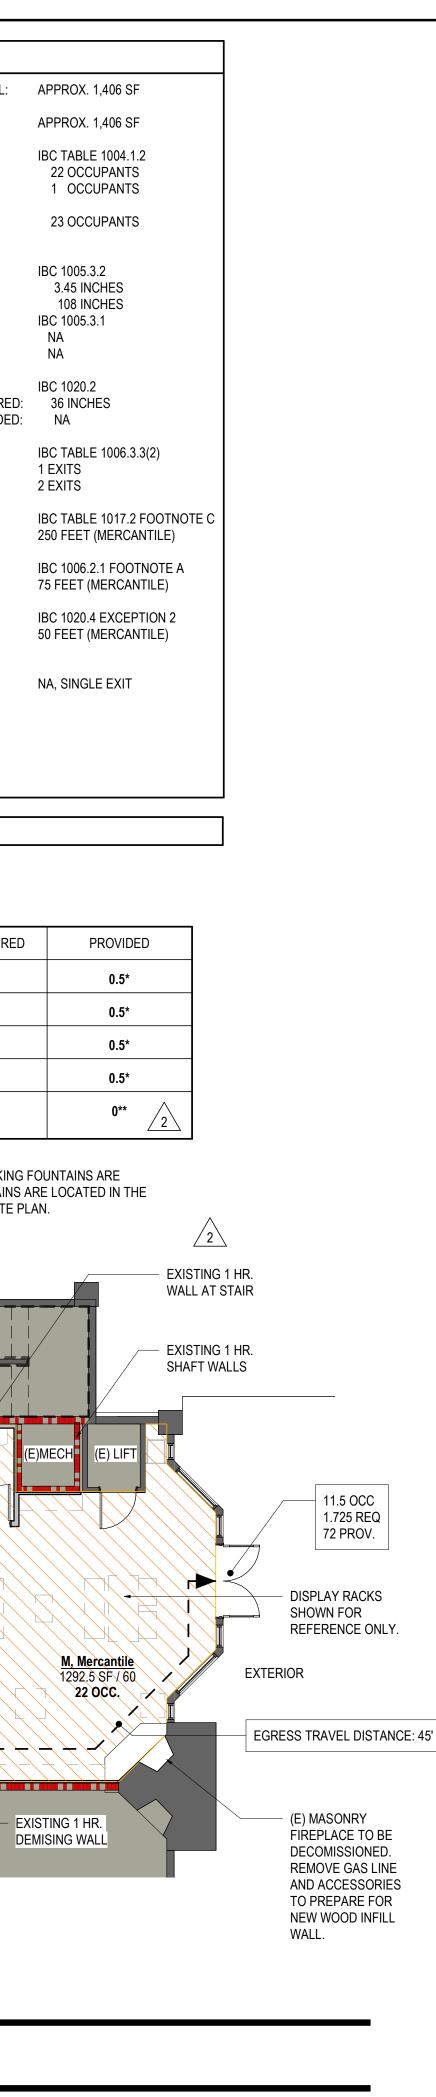



DRAWING INDEX

			Current Revision to IFC (If applicable)			
Sheet Number	Sheet Name	Latest		Date		
01 - GENERAL 2B-G0.000	COVER	2	BULLETIN 1	06/27/2022		
2B-G0.000 01 - GENERAL	COVER	Z	BULLETIN I	00/21/2022		
2B-G1.101	DEMOLITION PLAN AND SCHEDULES	2	BULLETIN 1	06/27/2022		
20-01.101	DEMOLITION FLAN AND SCILEDULES	2		00/21/2022		
05 - ARCHITEC	TURE					
2B-A1.101	CONSTRUCTION PLAN, RCP, SECTION, & ELEVATIONS	3	BULLETIN 2	08/10/2022		
2B-A1.102	INTERIOR ELEVATIONS & DETAILS	3	BULLETIN 2	08/10/2022		
08 - MECHANIC	ČAL					
2B-M0.000	MECHANICAL LEGEND	1	ISSUE FOR CONSTRUCTION	05/20/2022		
2B-M0.001	MECHANICAL GENERAL NOTES	1	ISSUE FOR CONSTRUCTION	05/20/2022		
2B-M0.002	MECHANICAL CONTROLS	2	BULLETIN 1	06/27/2022		
2B-M1.201	MECHANICAL PLAN - LEVEL 02	2	BULLETIN 1	06/27/2022		
2B-M1.301	MECHANICAL PIPING PLAN - LEVEL 02	1	ISSUE FOR CONSTRUCTION	05/20/2022		
2B-M8.000	MECHANICAL DETAILS	1	ISSUE FOR CONSTRUCTION	05/20/2022		
2B-MEP0.000	MECHANICAL SCHEDULES	2	BULLETIN 1	06/27/2022		
09 - PLUMBING	i i i i i i i i i i i i i i i i i i i					
2B-P0.000	PLUMBING LEGEND	2	BULLETIN 1	06/27/2022		
2B-P0.001	PLUMBING SCHEDULES & DETAILS	2	BULLETIN 1	06/27/2022		
2B-P1.201	PLUMBING PLAN - LEVEL 03	2	BULLETIN 1	06/27/2022		
10 - ELECTRIC/	AL					
2B-E0.000	ELECTRICAL LEGEND	1	ISSUE FOR CONSTRUCTION	05/20/2022		
2B-E0.001	ELECTRICAL ONE-LINE	1	ISSUE FOR CONSTRUCTION	05/20/2022		
2B-E0.002	ELECTRICAL SCHEDULES	2	BULLETIN 1	06/27/2022		
2B-E1.201	ELECTRICAL PLAN - LEVEL 03	2	BULLETIN 1	06/27/2022		
2B-E1.301	LIGHTING PLAN - LEVEL 03	2	BULLETIN 1	06/27/2022		
2B-E8.000	ELECTRICAL DETAILS	1	ISSUE FOR CONSTRUCTION	05/20/2022		
15 - TECHNOLO)GY					
2B-T0.000	TECHNOLOGY LEGEND	1	ISSUE FOR CONSTRUCTION	05/20/2022		
2B-T0.001	TECHNOLOGY GENERAL NOTES & ABBREVIATIONS	1	ISSUE FOR CONSTRUCTION	05/20/2022		
2B-T1.201	TECHNOLOGY PLAN - LEVEL 03	1	ISSUE FOR CONSTRUCTION	05/20/2022		
2B-T8.000	TECHNOLOGY DETAILS	1	ISSUE FOR CONSTRUCTION	05/20/2022		
2B-T8.001	TECHNOLOGY DETAILS	1	ISSUE FOR CONSTRUCTION	05/20/2022		


© 2022 Gensler

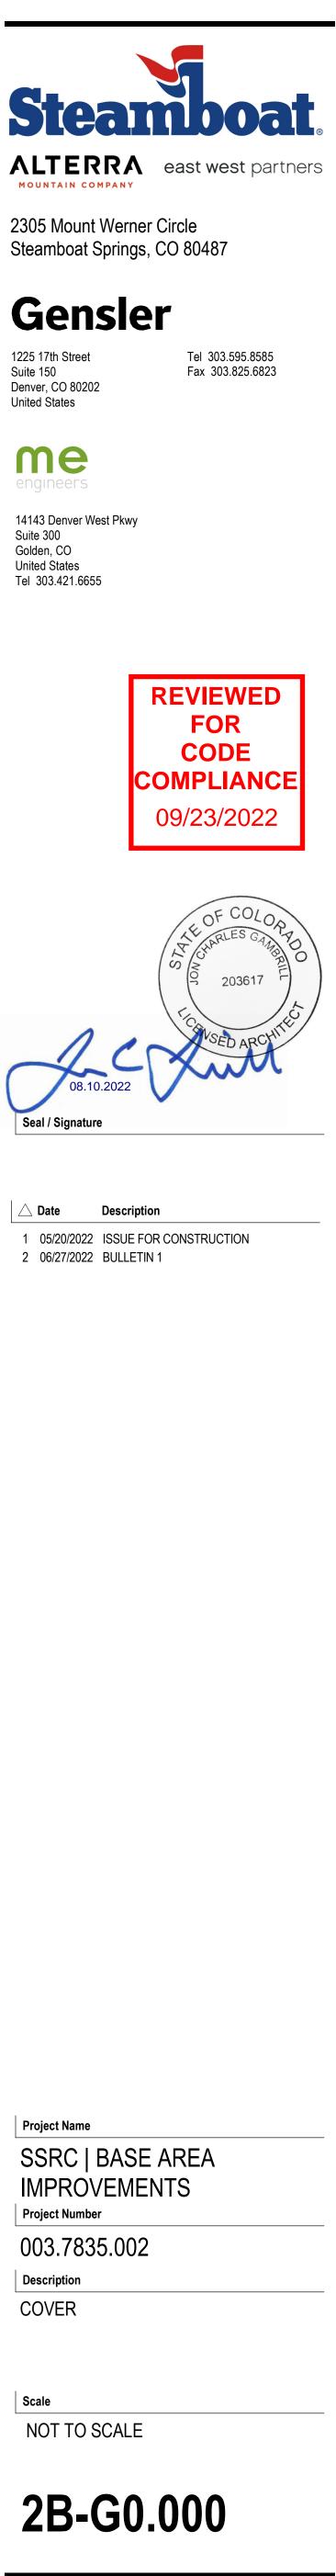

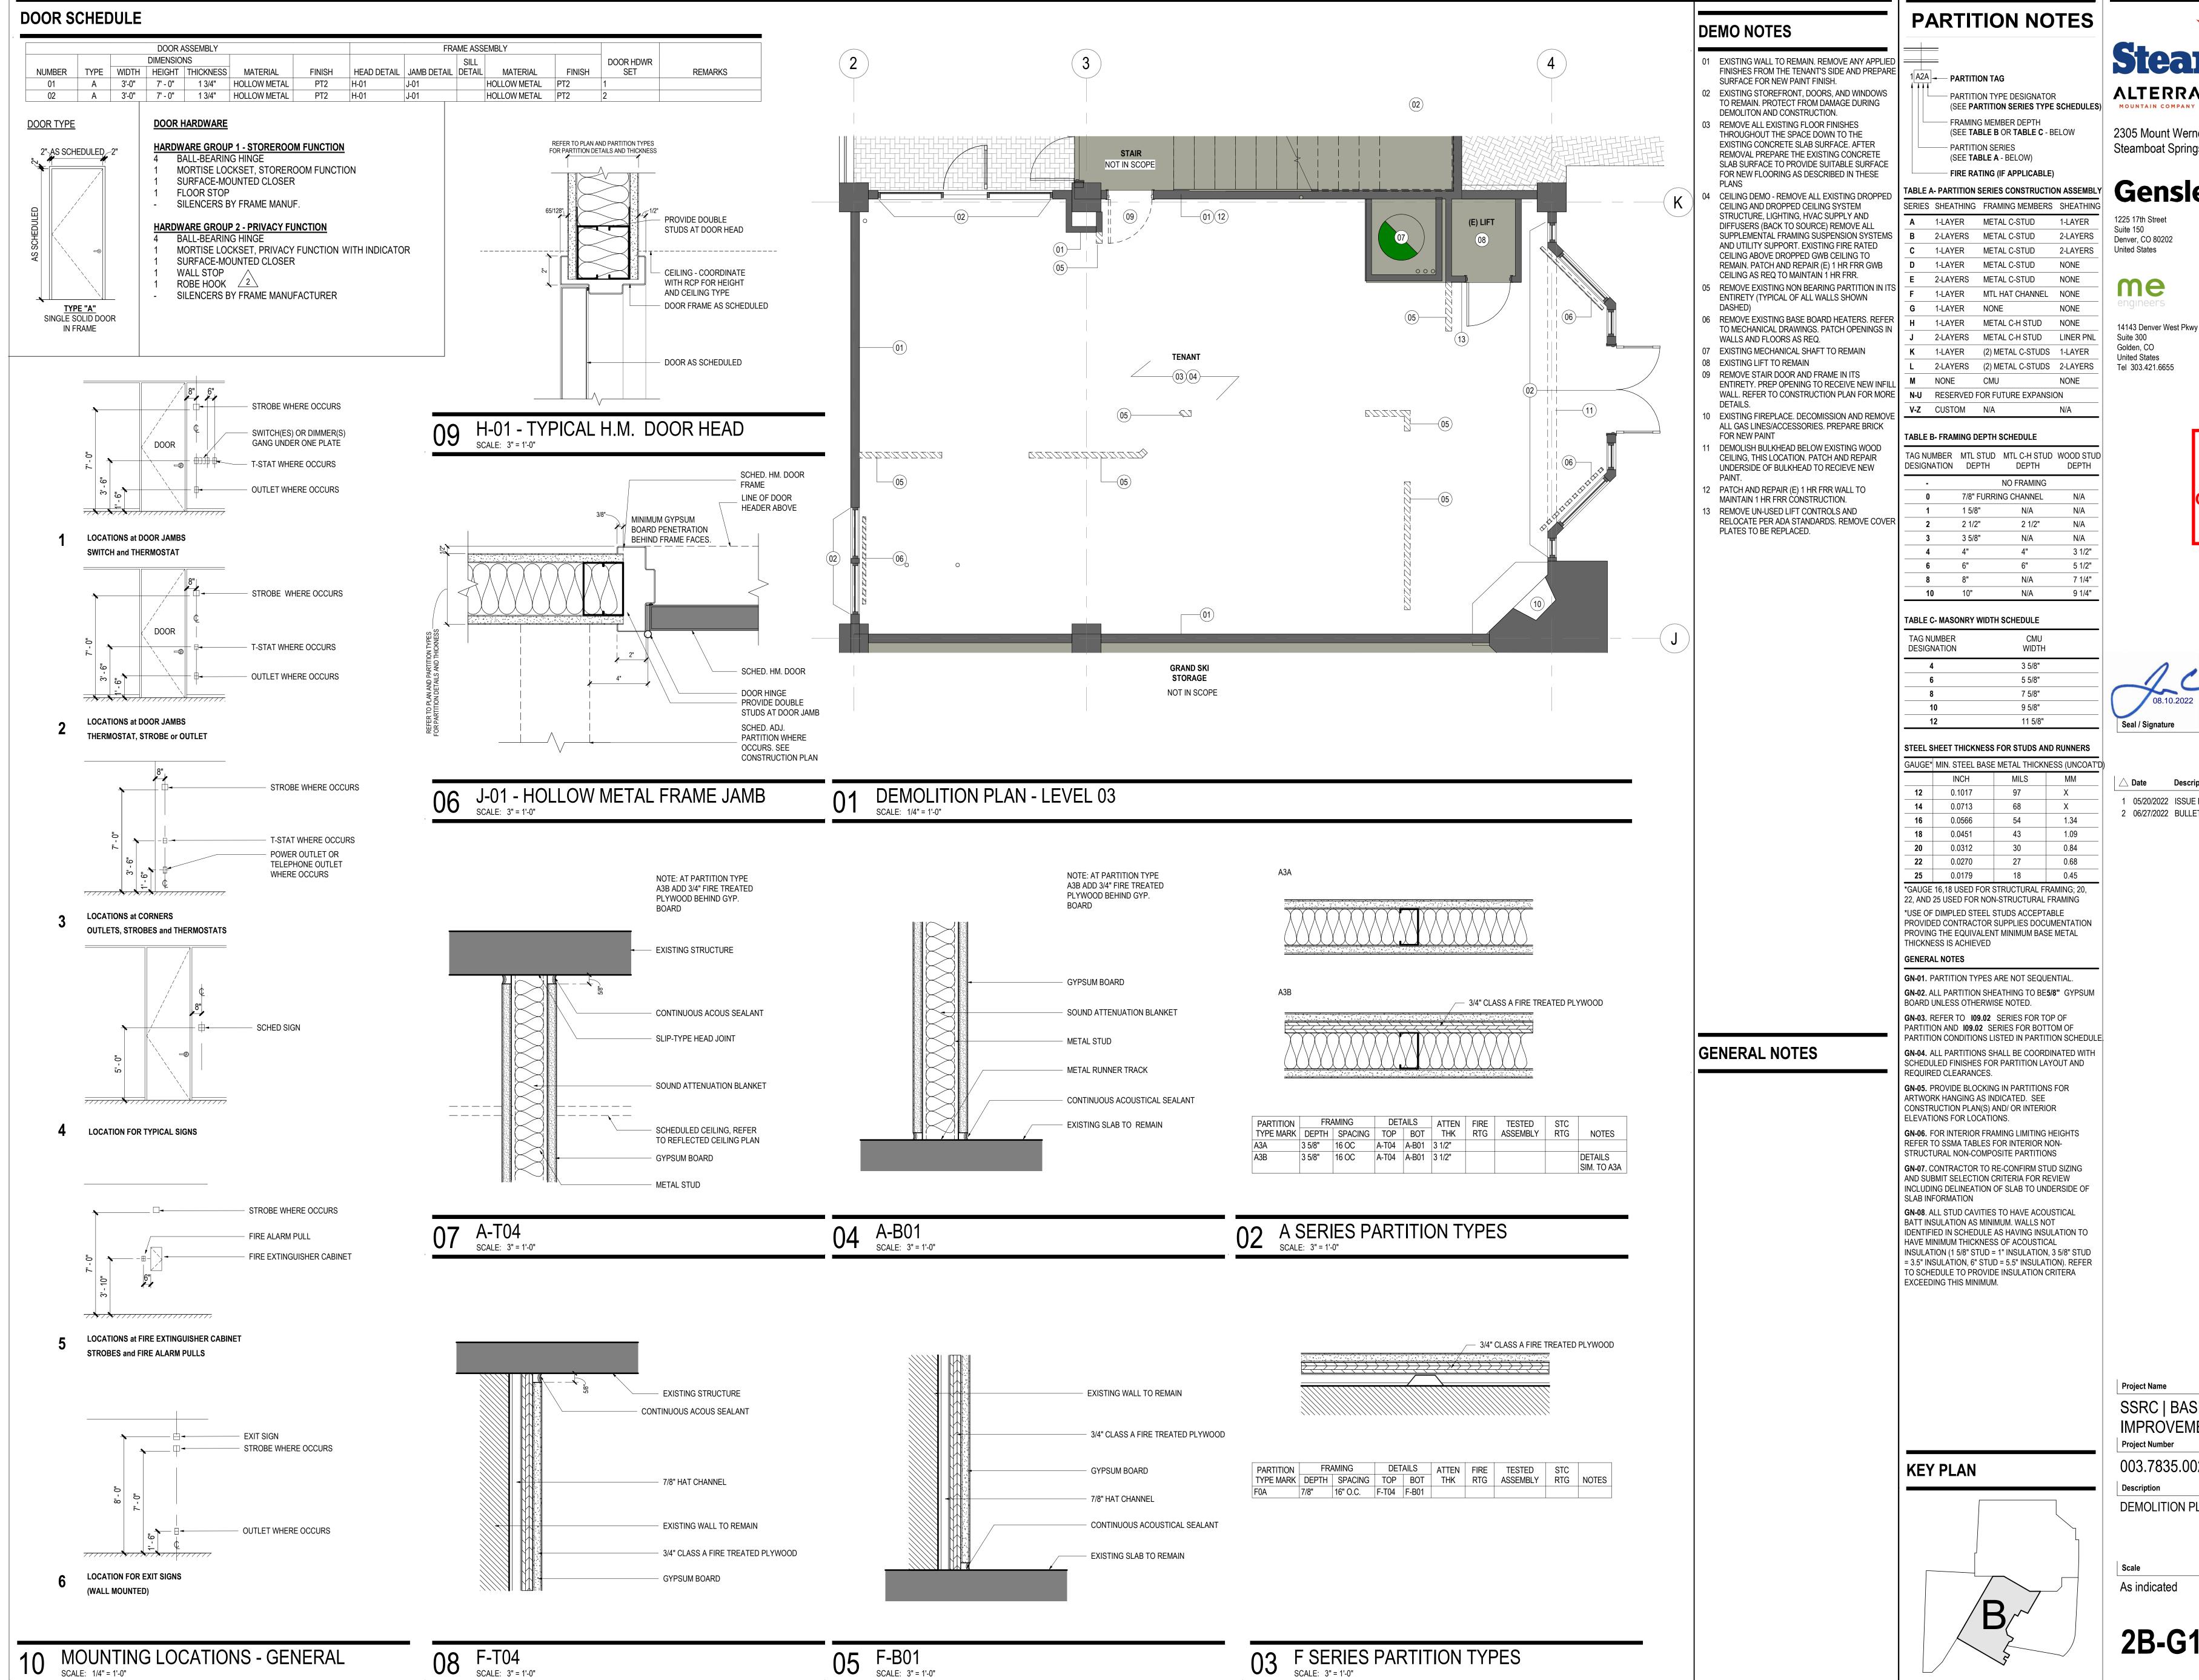

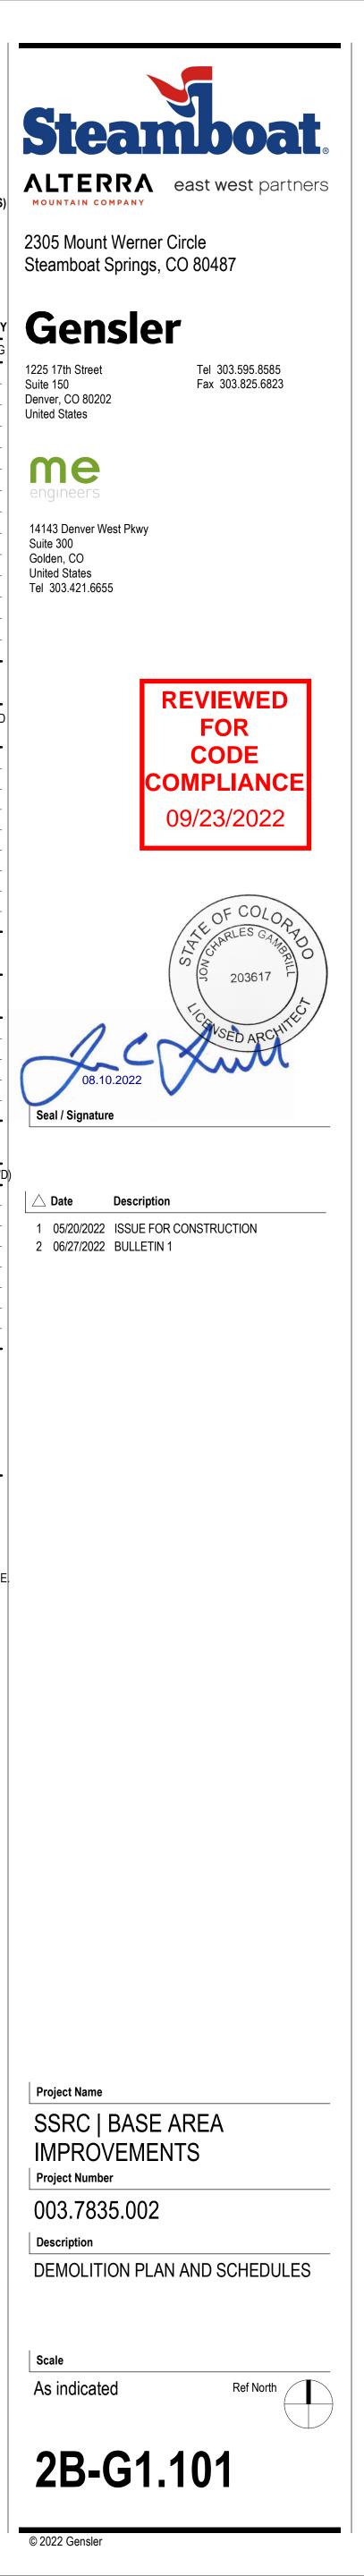


	IAL SCHED			1110		EQUIP. S
<u>CEILINGS</u>		<u>PAINT</u>		<u>WO</u>	OD BASE, INTERIOR	301
CL1		PT1		WB	-	
9 51 00 ACOUSTICAL CE Ame: Ultima Rid Size: Suprafine 9/*		09 91 13 INTERIOR PAINTING MANUFACTURER: BENJAMIN MOORI NUMBER: OC-65	E	SIZE: 4"	3 WOOD BASE ' TALL : TO MATCH ADJACENT WALL	302
ID COLOR: WHITE ID STYLE: BEVELED TE	GULAR	COLOR: CHANTILLY LACE FINISH: WALLS TO BE EGGSHELL, C			TO MATCH ADJACENT WALL	
LE MANUFACTURER: AR DUSTRIES INC. LE SIZE: 12" X 24"	MSTRONG WORLD	FLAT, RESTROOMS TO BE SATIN, RI AND TRIM TO BE SEMI-GLOSS, DOO TO BE SEMI-GLOSS		WO	OD WALL	303
LE COLOR: WHITE		STYLE: ULTRA SPEC 500		WD ⁴	1	
		PT2 09 91 13 INTERIOR PAINTING		DESCRI	INTERIOR ARCHITECTURAL WOODWORK	204
<u>ARPET</u>		MANUFACTURER: BENJAMIN MOORI NUMBER: 2108-40	E		TREE. Q/INCT TIN USE P53 OUNDS FORMARY BETWEED A AND 16" DIA., EN 1/2" AND 1 1/2" THICK	304
68 16 SHEET CARPETI	NG	COLOR: STARDUST FINISH: WALLS TO BE EGGSHELL, C FLAT, RESTROOMS TO BE SATIN, RI			CLASS C FIRE RATED FINISH 3	
ANUFACTURER: INTERF/ JMBER: 105596		AND TRIM TO BE SEMI-GLOSS, DOO TO BE SEMI-GLOSS		TILE	E	305
DLOR: CHARCOAL STITC TTERN NAME: STITCH I		STYLE: ULTRA SPEC 500		TL1	_	
		PT3 09 91 13 INTERIOR PAINTING	\wedge		THEORETICAL	306
ECORATIVE	METALS	MANUFACTURER: BENJAMIN MOORI	E Z		IPTION: FLOOR TILE ACTURER: AMERICAN OLEAN	
<u></u>		COLOR: BLACK IRON 3 HINISH: WALLS TO BE EGGSHELL, C		FINISH:		307
		FLAT, RESTROOMS TO BE SATIN, RU AND TRIM TO BE SEMI-GLOSS, DOO TO BE SEMI-GLOSS			OLOR: TBD IESS: 5/16"	
	SE 3			TL2		
DTE: PRIMED AND PAINT	ED PT3			09 30 00 Name: /) TILE	308
				MANUF	IPTION: WALL TILE ACTURER: CROSSVILLE	
					: ICE UNPOLISHED	
				THICKN	OLOR: TBD IESS: 10.5 MM BASE TO BE 6"H X 12"W COVE BASE. ON WET	309
				WALLS TRANSI	PROVIDE 4'-6" TALL TILE BEFORE TIONING TO GYP ABOVE. EXPOSED EDGES	
					TO BE CAPPED WITH "SCHLUTER JOLLY"	
				2		£310
			Z	<u> </u>		} ◯
						الا مع المر الم
RAPHIC SYN						0.0.0.0
REFLECTED	CEILING		CONST	RUC	IION	FIN
				Ì		/
	ACOUSTICAL CEILIN	NG AND GRID	A)		 COLUMN GRID REFERENCE NUMBER COLUMN GRID LINES AND REFERENCE NUMBER 	,
 xx'-xx" ₩					EXISTING CONSTRUCTION TO REMAIN	/
xx'-xx"	CEILING HEIGHT CH	HANGE SYMBOL			EXISTING CONSTRUCTION TO BE DEMOLISHED NEW PARTITION	
(X'-X")	FINISH CEILING HEI	IGHT SYMBOL				
			<u> </u>		1 HR. RATED PARTITION 2 HR. RATED PARTITION	
•					2 HR. RATED PARTITION 3 HR. RATED PARTITION	
	GRID STARTPOINT CEILING FINISH TAC MOTION SENSOR		 		2 HR. RATED PARTITION	
AT1	CEILING FINISH TAC	G			2 HR. RATED PARTITION 3 HR. RATED PARTITION 4 HR. RATED PARTITION	
AT1 AT1 MS S	CEILING FINISH TAC MOTION SENSOR CEILING MOUNTED CEILING MOUINTED	G SPEAKER D CAMERA			2 HR. RATED PARTITION 3 HR. RATED PARTITION 4 HR. RATED PARTITION - MILLWORK	
AT1 MS	CEILING FINISH TAC MOTION SENSOR CEILING MOUNTED CEILING MOUINTED CEILING MOUNTED	G SPEAKER D CAMERA SPRINKLER HEAD			2 HR. RATED PARTITION 3 HR. RATED PARTITION 4 HR. RATED PARTITION - MILLWORK - MILLWORK ABOVE	
AT1 AT1 MS S	CEILING FINISH TAC MOTION SENSOR CEILING MOUNTED CEILING MOUINTED CEILING MOUNTED	G SPEAKER D CAMERA SPRINKLER HEAD SMOKE DETECTOR		XXX+	 2 HR. RATED PARTITION 3 HR. RATED PARTITION 4 HR. RATED PARTITION MILLWORK MILLWORK ABOVE DETAIL NUMBER SHEET NUMBER DESCRIPTION OF SIMILAR OR OPPOSITE 	
AT1 MS S +	CEILING FINISH TAC MOTION SENSOR CEILING MOUNTED CEILING MOUNTED CEILING MOUNTED CEILING MOUNTED	G SPEAKER D CAMERA SPRINKLER HEAD SMOKE DETECTOR STROBE LIGHT		XXX+	 2 HR. RATED PARTITION 3 HR. RATED PARTITION 4 HR. RATED PARTITION MILLWORK MILLWORK ABOVE DETAIL NUMBER SHEET NUMBER DESCRIPTION OF SIMILAR OR OPPOSITE AREA TO BE DETAILED 	1 11
AT1 MS S AT1 MS a AT1 MS a A A A A A A A A A A A A A	CEILING FINISH TAC MOTION SENSOR CEILING MOUNTED CEILING MOUNTED CEILING MOUNTED	G SPEAKER D CAMERA SPRINKLER HEAD SMOKE DETECTOR STROBE LIGHT		XXX+	 2 HR. RATED PARTITION 3 HR. RATED PARTITION 4 HR. RATED PARTITION MILLWORK MILLWORK ABOVE DETAIL NUMBER SHEET NUMBER DESCRIPTION OF SIMILAR OR OPPOSITE 	VN
$\mathbf{AT1}$ \mathbf{MS} \mathbf{S} \mathbf{S} \mathbf{MS} \mathbf{S} \mathbf{S} \mathbf{MS} \mathbf{S} \mathbf	CEILING FINISH TAO MOTION SENSOR CEILING MOUNTED CEILING MOUNTED CEILING MOUNTED CEILING MOUNTED CEILING MOUNTED	G SPEAKER D CAMERA SPRINKLER HEAD SMOKE DETECTOR STROBE LIGHT		XXX SIM	 2 HR. RATED PARTITION 3 HR. RATED PARTITION 4 HR. RATED PARTITION 4 HR. RATED PARTITION MILLWORK MILLWORK ABOVE DETAIL NUMBER DETAIL NUMBER DESCRIPTION OF SIMILAR OR OPPOSITE AREA TO BE DETAILED LOCATION ON SHEET WHERE ELEVATION IS SHOW DIRECTION OF ELEVATION SHEET NUMBER WHERE ELEVATION IS SHOWN 	VN
$ \begin{array}{c} & & \\ & & $	CEILING FINISH TAO MOTION SENSOR CEILING MOUNTED CEILING MOUNTED CEILING MOUNTED CEILING MOUNTED CEILING MOUNTED WALL MOUNTED EX	G SPEAKER D CAMERA SPRINKLER HEAD SMOKE DETECTOR STROBE LIGHT EXIT SIGNS		XXX SIM	 2 HR. RATED PARTITION 3 HR. RATED PARTITION 4 HR. RATED PARTITION 4 HR. RATED PARTITION MILLWORK MILLWORK ABOVE DETAIL NUMBER SHEET NUMBER DESCRIPTION OF SIMILAR OR OPPOSITE AREA TO BE DETAILED LOCATION ON SHEET WHERE ELEVATION IS SHOW DIRECTION OF ELEVATION SHEET NUMBER WHERE ELEVATION IS SHOWN INTERIOR AND EXTERIOR ELEVATION MARKER 	VN
$ \begin{array}{c} & & \\ & \\ & \\ & \\ & \\ & \\ & \\ & \\ & \\ $	CEILING FINISH TAO MOTION SENSOR CEILING MOUNTED CEILING MOUINTED CEILING MOUNTED CEILING MOUNTED CEILING MOUNTED WALL MOUNTED EX	G SPEAKER CAMERA SPRINKLER HEAD SMOKE DETECTOR STROBE LIGHT EXIT SIGNS KIT SIGNS - PARALLEL		XXX SIM	 2 HR. RATED PARTITION 3 HR. RATED PARTITION 4 HR. RATED PARTITION 4 HR. RATED PARTITION MILLWORK MILLWORK ABOVE DETAIL NUMBER SHEET NUMBER DESCRIPTION OF SIMILAR OR OPPOSITE AREA TO BE DETAILED LOCATION ON SHEET WHERE ELEVATION IS SHOW DIRECTION OF ELEVATION SHEET NUMBER WHERE ELEVATION IS SHOWN INTERIOR AND EXTERIOR ELEVATION MARKER REVISION REFERENCE NUMBER 	VN
	CEILING FINISH TAO MOTION SENSOR CEILING MOUNTED CEILING MOUNTED CEILING MOUNTED CEILING MOUNTED CEILING MOUNTED WALL MOUNTED EX WALL MOUNTED EX	G SPEAKER CAMERA SPRINKLER HEAD SMOKE DETECTOR STROBE LIGHT EXIT SIGNS KIT SIGNS - PARALLEL KIT SIGNS - PERPENDICULAR		XXX SIM	 2 HR. RATED PARTITION 3 HR. RATED PARTITION 4 HR. RATED PARTITION 4 HR. RATED PARTITION MILLWORK MILLWORK ABOVE DETAIL NUMBER SHEET NUMBER DESCRIPTION OF SIMILAR OR OPPOSITE AREA TO BE DETAILED LOCATION ON SHEET WHERE ELEVATION IS SHOW DIRECTION OF ELEVATION SHEET NUMBER WHERE ELEVATION IS SHOWN INTERIOR AND EXTERIOR ELEVATION MARKER 	٧N
$ \begin{array}{c} & & & \\ & & \\ \hline AT1 \\ \hline MS \\ \hline S \\ \hline \\ \\ \\ \\ \\ \\ \\ \\ \\ \\ \\ \\ \\ \\ $	CEILING FINISH TAO MOTION SENSOR CEILING MOUNTED CEILING MOUNTED CEILING MOUNTED CEILING MOUNTED CEILING MOUNTED CEILING MOUNTED WALL MOUNTED EX WALL MOUNTED EX	G SPEAKER CAMERA SPRINKLER HEAD SMOKE DETECTOR STROBE LIGHT EXIT SIGNS KIT SIGNS - PARALLEL			 2 HR. RATED PARTITION 3 HR. RATED PARTITION 4 HR. RATED PARTITION 4 HR. RATED PARTITION MILLWORK MILLWORK ABOVE DETAIL NUMBER SHEET NUMBER DESCRIPTION OF SIMILAR OR OPPOSITE AREA TO BE DETAILED LOCATION ON SHEET WHERE ELEVATION IS SHOW DIRECTION OF ELEVATION SHEET NUMBER WHERE ELEVATION IS SHOWN INTERIOR AND EXTERIOR ELEVATION MARKER REVISION REFERENCE NUMBER 	W
$\mathbf{AT1}$ \mathbf{MS} \mathbf{S} \mathbf{S} $\mathbf{AT1}$ \mathbf{MS} \mathbf{S} \mathbf{S} $\mathbf{AT1}$ \mathbf{MS} \mathbf{S}	CEILING FINISH TAO MOTION SENSOR CEILING MOUNTED CEILING MOUNTED CEILING MOUNTED CEILING MOUNTED CEILING MOUNTED WALL MOUNTED EX WALL MOUNTED EX	G SPEAKER CAMERA SPRINKLER HEAD SMOKE DETECTOR STROBE LIGHT EXIT SIGNS KIT SIGNS - PARALLEL KIT SIGNS - PERPENDICULAR			 2 HR. RATED PARTITION 3 HR. RATED PARTITION 4 HR. RATED PARTITION 4 HR. RATED PARTITION MILLWORK MILLWORK ABOVE DETAIL NUMBER SHEET NUMBER DESCRIPTION OF SIMILAR OR OPPOSITE AREA TO BE DETAILED LOCATION ON SHEET WHERE ELEVATION IS SHOW DIRECTION OF ELEVATION SHEET NUMBER WHERE ELEVATION IS SHOWN INTERIOR AND EXTERIOR ELEVATION MARKER REVISION REFERENCE NUMBER REVISION CLOUD DEPICTING AREA REVISED 	٧N
$ \begin{array}{c} & & & \\ & & \\ \hline AT1 \\ \hline MS \\ \hline S \\ \hline \\ & \\ \\ \\ & \\ \\ \\ & \\ \\ \\ \\ \\ & \\$	CEILING FINISH TAO MOTION SENSOR CEILING MOUNTED CEILING MOUNTED CEILING MOUNTED CEILING MOUNTED CEILING MOUNTED CEILING MOUNTED WALL MOUNTED EX WALL MOUNTED EX DENOTES EXISTING ACCESS DOOR	G SPEAKER CAMERA SPRINKLER HEAD SMOKE DETECTOR STROBE LIGHT EXIT SIGNS KIT SIGNS - PARALLEL KIT SIGNS - PERPENDICULAR G TO REMAIN G TO BE RELOCATED	×XX 1 2 A11.X NAME 1234		 2 HR. RATED PARTITION 3 HR. RATED PARTITION 4 HR. RATED PARTITION 4 HR. RATED PARTITION MILLWORK MILLWORK ABOVE DETAIL NUMBER SHEET NUMBER DESCRIPTION OF SIMILAR OR OPPOSITE AREA TO BE DETAILED LOCATION ON SHEET WHERE ELEVATION IS SHOW DIRECTION OF ELEVATION SHEET NUMBER WHERE ELEVATION IS SHOWN INTERIOR AND EXTERIOR ELEVATION MARKER REVISION REFERENCE NUMBER REVISION CLOUD DEPICTING AREA REVISED ROOM NAME ROOM NAME RO	٧N
$ \begin{array}{c} & & \\ & & $	CEILING FINISH TAO MOTION SENSOR CEILING MOUNTED CEILING MOUNTED	G SPEAKER CAMERA SPRINKLER HEAD SMOKE DETECTOR STROBE LIGHT EXIT SIGNS KIT SIGNS - PARALLEL KIT SIGNS - PERPENDICULAR G TO REMAIN G TO BE RELOCATED	xx 1 2 A11.X NAME 1234 01		 2 HR. RATED PARTITION 3 HR. RATED PARTITION 4 HR. RATED PARTITION 4 HR. RATED PARTITION 4 HR. RATED PARTITION MILLWORK MILLWORK DETAIL NUMBER DETAIL NUMBER DESCRIPTION OF SIMILAR OR OPPOSITE AREA TO BE DETAILED LOCATION ON SHEET WHERE ELEVATION IS SHOW DIRECTION OF ELEVATION SHEET NUMBER WHERE ELEVATION IS SHOWN INTERIOR AND EXTERIOR ELEVATION MARKER REVISION REFERENCE NUMBER REVISION CLOUD DEPICTING AREA REVISED ROOM NAME ROOM NAME ROOM NAME SHEETNOTE REFERENCE 	
$ \begin{array}{c} & & \\ & \\ & \\ & \\ & \\ & \\ & \\ & \\ & \\ $	CEILING FINISH TAO MOTION SENSOR CEILING MOUNTED CEILING MOUNTED CA DENOTES EXISTING	G SPEAKER CAMERA SPRINKLER HEAD SMOKE DETECTOR STROBE LIGHT EXIT SIGNS KIT SIGNS - PARALLEL KIT SIGNS - PERPENDICULAR G TO REMAIN G TO BE RELOCATED	XX 1 2 A11.X 1 2 A11.X 1 1 1 1 1 A11.X 0 1 1 1 1 1 1 1 1 1 1 1 1 1		 2 HR. RATED PARTITION 3 HR. RATED PARTITION 4 HR. RATED PARTITION 4 HR. RATED PARTITION MILLWORK MILLWORK ABOVE DETAIL NUMBER SHEET NUMBER DESCRIPTION OF SIMILAR OR OPPOSITE AREA TO BE DETAILED LOCATION ON SHEET WHERE ELEVATION IS SHOW DIRECTION OF ELEVATION SHEET NUMBER WHERE ELEVATION IS SHOWN INTERIOR AND EXTERIOR ELEVATION MARKER REVISION REFERENCE NUMBER REVISION CLOUD DEPICTING AREA REVISED ROOM NAME ROOM NUMBER SHEETNOTE REFERENCE WALL TYPE REFERENCE FIRE RATING 	
$ \begin{array}{c} & & \\ & & $	CEILING FINISH TAG MOTION SENSOR CEILING MOUNTED CEILING CEILI	G SPEAKER CAMERA SPRINKLER HEAD SMOKE DETECTOR STROBE LIGHT EXIT SIGNS KIT SIGNS - PARALLEL KIT SIGNS - PERPENDICULAR G TO REMAIN G TO BE RELOCATED	XX 1 2 A11.X 1 2 A11.X 01 1 A3A XXX XXX XXX XXX		 2 HR. RATED PARTITION 3 HR. RATED PARTITION 4 HR. RATED PARTITION 4 HR. RATED PARTITION 4 HR. RATED PARTITION MILLWORK MILLWORK ABOVE DETAIL NUMBER SHEET NUMBER DESCRIPTION OF SIMILAR OR OPPOSITE AREA TO BE DETAILED LOCATION ON SHEET WHERE ELEVATION IS SHOW DIRECTION OF ELEVATION SHEET NUMBER WHERE ELEVATION IS SHOWN INTERIOR AND EXTERIOR ELEVATION MARKER REVISION REFERENCE NUMBER REVISION CLOUD DEPICTING AREA REVISED ROOM NAME ROOM NUMBER SHEETNOTE REFERENCE WALL TYPE REFERENCE FIRE RATING DOOR NUMBER DOOR NUMBER DOOR NUMBER DOOR NUMBER DOOR NUMBER 	
$ \begin{array}{c} & & \\ & & $	CEILING FINISH TAG MOTION SENSOR CEILING MOUNTED CEILING CEILI	G SPEAKER CAMERA SPRINKLER HEAD SMOKE DETECTOR STROBE LIGHT EXIT SIGNS KIT SIGNS - PARALLEL KIT SIGNS - PERPENDICULAR G TO REMAIN G TO BE RELOCATED T FIXTURE T FIXTURE	NAME 1234 01 1 A3A XXX XXX XXX XXX XXX XXX XXX		 2 HR. RATED PARTITION 3 HR. RATED PARTITION 4 HR. RATED PARTITION 4 HR. RATED PARTITION 4 HR. RATED PARTITION MILLWORK MILLWORK ABOVE DETAIL NUMBER SHEET NUMBER DESCRIPTION OF SIMILAR OR OPPOSITE AREA TO BE DETAILED LOCATION ON SHEET WHERE ELEVATION IS SHOW DIRECTION OF ELEVATION SHEET NUMBER WHERE ELEVATION IS SHOWN INTERIOR AND EXTERIOR ELEVATION MARKER REVISION REFERENCE NUMBER REVISION CLOUD DEPICTING AREA REVISED ROOM NAME ROOM NUMBER SHEETNOTE REFERENCE WALL TYPE REFERENCE FIRE RATING DOOR NUMBER DOOR NUMBER 	HEDULE)
$ \begin{array}{c} $	CEILING FINISH TAO MOTION SENSOR CEILING MOUNTED CEILING CEILI	G SPEAKER CAMERA SPRINKLER HEAD SMOKE DETECTOR STROBE LIGHT EXIT SIGNS ISTOBE LIGHT EXIT SIGNS - PARALLEL KIT SIGNS - PARALLEL AT REMAIN G TO REMAIN G TO REMAIN G TO BE RELOCATED T FIXTURE T FIXTURE T FIXTURE T FIXTURE ANT FIXTURE ORESCENT FIXTURE DANT FIXTURE JIGHT	XX 1 2 A11.X 1 2 A11.X 01 1 A3A XXX XXX XXX XXX		2 HR. RATED PARTITION 3 HR. RATED PARTITION 4 HR. RATED PARTITION 4 HR. RATED PARTITION MILLWORK MILLWORK DETAIL NUMBER DESCRIPTION OF SIMILAR OR OPPOSITE AREA TO BE DETAILED LOCATION ON SHEET WHERE ELEVATION IS SHOW DIRECTION OF ELEVATION SHEET NUMBER WHERE ELEVATION IS SHOWN INTERIOR AND EXTERIOR ELEVATION MARKER REVISION REFERENCE NUMBER REVISION CLOUD DEPICTING AREA REVISED ROOM NAME ROOM NUMBER SHEETNOTE REFERENCE WALL TYPE REFERENCE WALL TYPE REFERENCE DOOR RUMBER DOOR NUMBER DOOR NUMBER	HEDULE)
$ \begin{array}{c} $	CEILING FINISH TAG MOTION SENSOR CEILING MOUNTED CEILING CEILI	G SPEAKER CAMERA SPRINKLER HEAD SMOKE DETECTOR SMOKE DETECTOR STROBE LIGHT EXIT SIGNS EXIT SIGNS - PARALLEL KIT SIGNS - PARALLEL KIT SIGNS - PERPENDICULAR CTO REMAIN G TO REMAIN G TO REMAIN G TO BE RELOCATED T FIXTURE T FIXTURE T FIXTURE T FIXTURE T FIXTURE CARESCENT FIXTURE P FIXTURE DANT FIXTURE IGHT TABLE DOWNLIGHT	NAME 1234 01 1 A3A XXX XXX XXX XXX XXX XXX XXX		 2 HR. RATED PARTITION 3 HR. RATED PARTITION 4 HR. RATED PARTITION MILLWORK MILLWORK ABOVE DETAIL NUMBER SHEET NUMBER DESCRIPTION OF SIMILAR OR OPPOSITE AREA TO BE DETAILED LOCATION ON SHEET WHERE ELEVATION IS SHOW DIRECTION OF ELEVATION SHEET NUMBER WHERE ELEVATION IS SHOWN INTERIOR AND EXTERIOR ELEVATION MARKER REVISION REFERENCE NUMBER REVISION CLOUD DEPICTING AREA REVISED ROOM NAME ROOM NUMBER SHEETNOTE REFERENCE WALL TYPE REFERENCE WALL TYPE REFERENCE DOOR REFERENCE NUMBER (REFER TO DOOR SO DOOR NUMBER DOOR NUMBER DOOR NUMBER DOOR TYPE HARDWARE TYPE WINDOW REFERENCE NUMBER (REFER TO WINDOR 	HEDULE)
$ \begin{array}{c} $	CEILING FINISH TAG MOTION SENSOR CEILING MOUNTED CEILING CEILI	G SPEAKER CAMERA SPRINKLER HEAD SMOKE DETECTOR STROBE LIGHT EXIT SIGNS ATT SIGNS - PARALLEL ATT SIGNS - PERPENDICULAR CT REMAIN G TO REMAIN G TO BE RELOCATED T FIXTURE T FIXTURE	NAME 1234 01 1 A3A XXX XXX XXX XXX XXX XXX XXX		2 HR. RATED PARTITION 3 HR. RATED PARTITION 4 HR. RATED PARTITION 4 HR. RATED PARTITION MILLWORK DETAIL NUMBER DETAIL NUMBER SHEET NUMBER DESCRIPTION OF SIMILAR OR OPPOSITE AREA TO BE DETAILED LOCATION ON SHEET WHERE ELEVATION IS SHOW DIRECTION OF ELEVATION SHEET NUMBER WHERE ELEVATION IS SHOWN INTERIOR AND EXTERIOR ELEVATION MARKER REVISION REFERENCE NUMBER REVISION REFERENCE NUMBER REVISION CLOUD DEPICTING AREA REVISED ROOM NAME ROOM NUMBER SHEETNOTE REFERENCE WALL TYPE REFERENCE DOOR REFERENCE NUMBER (REFER TO DOOR SC DOOR NUMBER DOOR TYPE DOOR NUMBER DOOR TYPE HARDWARE TYPE WINDOW REFERENCE NUMBER (REFER TO WINDOW MILLWORK REFERENCE NUMBER (REFER TO MILL	HEDULE)
$ \begin{array}{c} $	CEILING FINISH TAO MOTION SENSOR CEILING MOUNTED CEILING CEILING CEILING CEILING CEILING CEILING CEILING CEILING CEILING CEILING CEILING CEILING CEILING LIGHT FINIG CEILING CEILI	G SPEAKER CAMERA SPRINKLER HEAD SMOKE DETECTOR STROBE LIGHT EXIT SIGNS ATT SIGNS - PARALLEL ATT SIGNS - PERPENDICULAR CT REMAIN G TO REMAIN G TO BE RELOCATED T FIXTURE T FIXTURE	$ \begin{array}{c} $		2 HR. RATED PARTITION 3 HR. RATED PARTITION 4 HR. RATED PARTITION 4 HR. RATED PARTITION 4 HR. RATED PARTITION MILLWORK DILLWORK ABOVE DETAIL NUMBER 5 SHEET NUMBER DESCRIPTION OF SIMILAR OR OPPOSITE AREA TO BE DETAILED LOCATION ON SHEET WHERE ELEVATION IS SHOWN INTERION OF ELEVATION SHEET NUMBER WHERE ELEVATION IS SHOWN INTERIOR AND EXTERIOR ELEVATION MARKER REVISION REFERENCE NUMBER REVISION REFERENCE NUMBER REVISION CLOUD DEPICTING AREA REVISED ROOM NAME ROOM NUMBER SHEETNOTE REFERENCE WALL TYPE REFERENCE FIRE RATING DOOR REFERENCE NUMBER (REFER TO DOOR SC DOOR NUMBER DOOR TYPE DOOR NUMBER DOOR TYPE HARDWARE TYPE WINDOW REFERENCE NUMBER (REFER TO WINDOW MILLWORK REFERENCE NUMBER (REFER TO WINDOW MILLWORK REFERENCE NUMBER (REFER TO WINDOW MILLWORK REFERENCE NUMBER (REFER TO MILL ELEVATION DATUM REFERENCE	HEDULE)
$ \begin{array}{c} $	CEILING FINISH TAG MOTION SENSOR CEILING MOUNTED CEILING CEILING CEILING CEILING CEILING CEILING CEILING CEILING CEILING LIGHT NO CEILING LIGHT NO CEILING LIGHT NO CEILING CEILING CEILING LIGHTING SURFACE MOUNTED	G SPEAKER CAMERA SPRINKLER HEAD SMOKE DETECTOR STROBE LIGHT EXIT SIGNS ATT SIGNS - PARALLEL ATT SIGNS - PERPENDICULAR CT REMAIN G TO REMAIN G TO BE RELOCATED T FIXTURE T FIXTURE	$ \begin{array}{c} $		 2 HR. RATED PARTITION 3 HR. RATED PARTITION 4 HR. RATED PARTITION 4 HR. RATED PARTITION 4 HR. RATED PARTITION 4 HR. RATED PARTITION MILLWORK MILLWORK DETAIL NUMBER SHEET NUMBER DESCRIPTION OF SIMILAR OR OPPOSITE AREA TO BE DETAILED LOCATION ON SHEET WHERE ELEVATION IS SHOWN DIRECTION OF ELEVATION SHEET NUMBER WHERE ELEVATION IS SHOWN INTERIOR AND EXTERIOR ELEVATION MARKER REVISION REFERENCE NUMBER REVISION CLOUD DEPICTING AREA REVISED ROOM NAME ROOM NAME ROOM NUMBER SHEETNOTE REFERENCE WALL TYPE REFERENCE FIRE RATING DOOR REFERENCE NUMBER (REFER TO DOOR SC DOOR NUMBER DOOR NUMBER DOOR NUMBER DOOR TYPE HARDWARE TYPE WINDOW REFERENCE NUMBER (REFER TO MINDOR MILLWORK REFERENCE NUMBER (REFER TO MINDOR MILLWORK REFERENCE NUMBER (REFER TO MINDOR MILLWORK REFERENCE NUMBER (REFER TO MINDOR FLOOR TYPE HARDWARE TYPE 	HEDULE) W SCHEDULE) WORK SCHEDULE)
$ \begin{array}{c} $	CEILING FINISH TAG MOTION SENSOR CEILING MOUNTED CEILING CEILING CEILING CEILING CEILING CEILING CEILING CEILING CEILING LIGHT FIL FLORESCENT LIGHT FLORESCENT STRIC FLORESCENT STRIC FLORESCENT STRIC FLORESCENT STRIC FLORESCENT PEND RECESSED DOWNL RECESSED DOWNL RECESSED ADJUST RECESSED ADJUST RECESSED RECESSED ADJUST RECESSED RECESSED ADJUST RECESSED RECESSED RECESSED RECESSED RECESSED RECESSED	G SPEAKER CAMERA SPRINKLER HEAD SMOKE DETECTOR STROBE LIGHT EXIT SIGNS ATT SIGNS - PARALLEL ATT SIGNS - PERPENDICULAR CT REMAIN G TO REMAIN G TO BE RELOCATED T FIXTURE T FIXTURE	Allign		2 HR. RATED PARTITION 3 HR. RATED PARTITION 4 HR. RATED PARTITION 4 HR. RATED PARTITION MILLWORK MILLWORK ABOVE DETAIL NUMBER DESCRIPTION OF SIMILAR OR OPPOSITE AREA TO BE DETAILED LOCATION ON SHEET WHERE ELEVATION IS SHOW DIRECTION OF ELEVATION SHEET NUMBER WHERE ELEVATION IS SHOWN INTERIOR AND EXTERIOR ELEVATION MARKER REVISION REFERENCE NUMBER REVISION REFERENCE NUMBER REVISION CLOUD DEPICTING AREA REVISED ROOM NAME ROOM NUMBER SHEETNOTE REFERENCE WALL TYPE REFERENCE WALL TYPE REFERENCE DOOR REFERENCE NUMBER (REFER TO DOOR SC DOOR NUMBER DOOR TYPE DOOR TYPE HARDWARE TYPE WINDOW REFERENCE NUMBER (REFER TO MINDO MILLWORK REFERENCE NU	HEDULE) W SCHEDULE) WORK SCHEDULE)
$ \begin{array}{c} & & \\ & \\ & \\ & \\ & \\ & \\ & \\ & \\ & \\ $	CEILING FINISH TAG MOTION SENSOR CEILING MOUNTED CEILING CEILING CEILING CEILING CEILING CEILING CEILING CEILING CEILING LIGHT FIL FLORESCENT LIGHT FLORESCENT STRIC FLORESCENT STRIC FLORESCENT STRIC FLORESCENT STRIC FLORESCENT PEND RECESSED DOWNL RECESSED DOWNL RECESSED ADJUST RECESSED ADJUST RECESSED RECESSED ADJUST RECESSED RECESSED ADJUST RECESSED RECESSED RECESSED RECESSED RECESSED RECESSED	G SPEAKER CAMERA SPRINKLER HEAD SMOKE DETECTOR STROBE LIGHT EXIT SIGNS ATT SIGNS - PARALLEL ATT SIGNS - PERPENDICULAR CT REMAIN G TO REMAIN G TO BE RELOCATED T FIXTURE T FIXTURE	Allign		2 HR. RATED PARTITION 3 HR. RATED PARTITION 4 HR. RATED PARTITION 4 HR. RATED PARTITION 4 HR. RATED PARTITION 4 HR. RATED PARTITION 5 MILLWORK 6 MILLWORK ABOVE 5 DETAIL NUMBER 5 DETAIL NUMBER 5 DESCRIPTION OF SIMILAR OR OPPOSITE 5 AREA TO BE DETAILED 6 LOCATION ON SHEET WHERE ELEVATION IS SHOWN 10 IRECTION OF ELEVATION 5 HEET NUMBER WHERE ELEVATION IS SHOWN 10 INTERIOR AND EXTERIOR ELEVATION MARKER 7 REVISION REFERENCE NUMBER 7 REVISION CLOUD DEPICTING AREA REVISED 10 RECTINOTE REFERENCE 10 ALL TYPE REFERENCE 11 FIRE RATING 10 DOOR NUMBER 10 DOOR TYPE 10 DOOR NUMBER 10 DOOR TYPE 10 DOOR NUMBER 10 DOOR TYPE 10 DOOR TYPE 10 DOOR TYPE 10 DOOR TYPE 10 DOOR TYPE HARDWARE TYPE 11 WINDOW REFERENCE NUMBER (REFER TO WINDOW 11 WINDOW REFERENCE NUMBER (REFER TO WINDOW 11 WINDOW REFERENCE NUMBER (REFER TO WINDOW 11 WINDOW REFERENCE NUMBER (REFER TO WINDOW 12 DOOR TYPE 14 DOOR TYPE 15 DOOR TYPE 16 DOOR TYPE 16 DOOR TYPE 17 DOOR NUMBER 17 DOOR NUMBER 17 DOOR TYPE 16 DOOR TYPE 17 DOOR NUMBER 17 DOOR TYPE 16 DOOR TYPE 17 DOOR NUMBER 17 DOOR TYPE 17 DOOR NUMBER 18 DOOR TYPE 19 DOOR TYPE 10 TYPE 10 TYPE 10 TYPE	HEDULE) W SCHEDULE) WORK SCHEDULE)
$ \begin{array}{c} & & \\ & \\ & \\ & \\ & \\ & \\ & \\ & \\ & \\ $	CEILING FINISH TAG MOTION SENSOR CEILING MOUNTED CEILING LIGHT NO CEILING LIGHT FIL FLORESCENT LIGHT FLORESCENT PEND RECESSED ADJUST RECESSED ADJUST RECESSED ADJUST RECESSED ADJUST RECESSED MOUNTED WALL SCONCE LIGHT SWITCH	G SPEAKER CAMERA SPRINKLER HEAD SMOKE DETECTOR STROBE LIGHT EXIT SIGNS ATT SIGNS - PARALLEL ATT SIGNS - PERPENDICULAR CT REMAIN G TO REMAIN G TO BE RELOCATED T FIXTURE T FIXTURE	Allign		2 HR. RATED PARTITION 3 HR. RATED PARTITION 4 HR. RATED PARTITION 4 HR. RATED PARTITION MILLWORK DETAIL NUMBER 5 SHEET NUMBER DESCRIPTION OF SIMILAR OR OPPOSITE AREA TO BE DETAILED 1 LOCATION ON SHEET WHERE ELEVATION IS SHOWN INTERIOR OF ELEVATION 5 SHEET NUMBER WHERE ELEVATION IS SHOWN INTERIOR AND EXTERIOR ELEVATION MARKER 7 REVISION REFERENCE NUMBER 7 REVISION CLOUD DEPICTING AREA REVISED 1 ROOM NAME 1 ROOM NAME 1 ROOM NUMBER 3 SHEETNOTE REFERENCE 4 WALL TYPE REFERENCE 5 WALL TYPE REFERENCE 5 WALL TYPE REFERENCE 5 WALL TYPE REFERENCE 5 UDOR NUMBER 1 DOOR RUMBER 5 DOOR TYPE 1 DOOR NUMBER 5 DOOR TYPE 1 DOOR NUMBER 5 DOOR TYPE HARDWARE TYPE 1 WINDOW REFERENCE NUMBER (REFER TO WINDOW 1 MILLWORK REFERENCE NUMBER (REFER TO WINDOW 1 MILLWORK REFERENCE NUMBER (REFER TO MILL 1 ELEVATION DATUM REFERENCE 5 FLOOR ELEVATION TRANSITION 1 MATCH LINE SYMBOL ALIGN WITH ESTABLISHED / ADJACENT SURFACES 4 ALIGN WITH ESTABLISHED / ADJACENT SURFACES	HEDULE) W SCHEDULE) WORK SCHEDULE)
$ \begin{array}{c} $	CEILING FINISH TAO MOTION SENSOR CEILING MOUNTED CEILING MOUNTED CEILING CEILING MOUNTED CEILING CEILING MOUNTED CEILING CEILING CEILING CEILING CEILING CEILI	G SPEAKER CAMERA SPRINKLER HEAD SMOKE DETECTOR STROBE LIGHT EXIT SIGNS KIT SIGNS - PARALLEL KIT SIGNS - PERPENDICULAR CIT	NAME 1 2 A11.X 2 A11.X A1.X A1.X A1.X A1.X A1.X A1.X A1.X A		2 HR. RATED PARTITION 3 HR. RATED PARTITION 4 HR. RATED PARTITION 4 HR. RATED PARTITION MILLWORK DETAIL NUMBER DETAIL NUMBER 5 HEET NUMBER DESCRIPTION OF SIMILAR OR OPPOSITE 4 AREA TO BE DETAILED 1 LOCATION ON SHEET WHERE ELEVATION IS SHOWN 1 DIRECTION OF ELEVATION 5 SHEET NUMBER WHERE ELEVATION IS SHOWN 1 INTERIOR AND EXTERIOR ELEVATION MARKER 7 REVISION REFERENCE NUMBER 7 REVISION CLOUD DEPICTING AREA REVISED 1 ROOM NAME 7 ROOM NAME 7 ROOM NAME 7 ROOM NAME 7 ROOM NAME 7 ROOM NAME 7 ROOM NAME 8 NEETNOTE REFERENCE 1 WALL TYPE REFERENCE 1 FIRE RATING 1 DOOR RUMBER 2 DOOR NUMBER 2 DOOR NUMBER 2 DOOR TYPE 1 DOOR NUMBER 2 DOOR TYPE HARDWARE TYPE 2 WINDOW REFERENCE NUMBER (REFER TO WINDOW 2 MILLWORK REFERENCE NUMBER (REFER TO WINDOW 2 MILLWORK REFERENCE NUMBER (REFER TO MILL 2 LEVATION DATUM REFERENCE 3 FLOOR ELEVATION TRANSITION 3 MATCH LINE SYMBOL 4 LIGN WITH ESTABLISHED / ADJACENT SURFACES 5 FIRE WARDEN STATION SYMBOL	HEDULE) W SCHEDULE) WORK SCHEDULE)
$ \begin{array}{c} $	CEILING FINISH TAG MOTION SENSOR CEILING MOUNTED CEILING LIGHT FLORESCENT LIGHT FLORESCENT LIGHT FLORESCENT PEND RECESSED ADJUST RECESSED ADJUST RECESSED ADJUST RECESSED ADJUST RECESSED MALL W TRACK LIGHTING SURFACE MOUNTED WALL SCONCE LIGHT SWITCH DIMMER SWITCH	G SPEAKER CAMERA SPRINKLER HEAD SMOKE DETECTOR STROBE LIGHT EXIT SIGNS KIT SIGNS - PARALLEL KIT SIGNS - PERPENDICULAR CIT	Allign		2 HR. RATED PARTITION 3 HR. RATED PARTITION 4 HR. RATED PARTITION 4 HR. RATED PARTITION 4 HR. RATED PARTITION MILLWORK MILLWORK ABOVE DETAIL NUMBER 5 SHEET NUMBER DESCRIPTION OF SIMILAR OR OPPOSITE 4 AREA TO BE DETAILED 1 LOCATION ON SHEET WHERE ELEVATION IS SHOW 1 DIRECTION OF ELEVATION 5 SHEET NUMBER WHERE ELEVATION IS SHOWN 1 INTERIOR AND EXTERIOR ELEVATION MARKER 7 REVISION REFERENCE NUMBER 7 REVISION CLOUD DEPICTING AREA REVISED 1 DOOR NUMBER 5 HEETNOTE REFERENCE 5 HIRE RATING 1 DOOR REFERENCE NUMBER (REFER TO DOOR SC 1 DOOR NUMBER 5 DOOR TYPE 1 DOOR NUMBER 5 DOOR TYPE 1 DOOR NUMBER 6 DOOR TYPE 1 DOOR NUMBER 6 DOOR TYPE 1 DOOR NUMBER 6 DOOR TYPE 1 DOOR NUMBER 7 DOOR NUMBER 6 DOOR TYPE 1 DOOR NUMBER 7 DOOR NUMER 7 DOOR	HEDULE) W SCHEDULE) WORK SCHEDULE)
AT1 MS S S AT1 MS S S AT1 MS S S AT1 MS S S AT1 MS S S AT1 MS AT1 AT1 MS S S AT1 AT1 MS S S AT1 AT1 AT1 AT1 AT1 AT1 AT1 AT1 AT1 AT1	CEILING FINISH TAO MOTION SENSOR CEILING MOUNTED CEILING CEILING CEILING CEILING CEILING CEILING CIRCULAR DIFFUSER	G SPEAKER CAMERA SPRINKLER HEAD SMOKE DETECTOR STROBE LIGHT EXIT SIGNS KIT SIGNS - PARALLEL KIT SIGNS - PERPENDICULAR CIT	NAME 2 A11.X 2 A11.X A1.X A		2 HR. RATED PARTITION 3 HR. RATED PARTITION 4 HR. RATED PARTITION 5 MILLWORK ABOVE 5 DETAIL NUMBER 5 SHEET NUMBER 5 DESCRIPTION OF SIMILAR OR OPPOSITE 4 AREA TO BE DETAILED 5 LOCATION ON SHEET WHERE ELEVATION IS SHOWN 1 INTERIOR AND SETERIOR ELEVATION SHOWN 1 INTERIOR AND EXTERIOR ELEVATION MARKER 5 REVISION CLOUD DEPICTING AREA REVISED 7 ROOM NUMBER 7 SHEETNOTE REFERENCE 6 FIRE RATING 7 DOOR NUMBER 7 DOO	HEDULE) W SCHEDULE) WORK SCHEDULE)
AT1 MS S S AT1 MS S S AT1 MS S S AT1 MS S S AT1 MS S AT1 AT1 MS AT1 AT1 MS S AT1 AT1 AT1 AT1 AT1 AT1 AT1 AT1 AT1 AT1	CEILING FINISH TAO MOTION SENSOR CEILING MOUNTED CEILING CEILI	G SPEAKER CAMERA SPRINKLER HEAD SMOKE DETECTOR STROBE LIGHT EXIT SIGNS KIT SIGNS - PARALLEL KIT SIGNS - PERPENDICULAR CIT	NAME 2 A11.X 2 A11.X A1.X A		2 HR. RATED PARTITION 3 HR. RATED PARTITION 4 HR. RATED PARTITION 4 HR. RATED PARTITION 4 HR. RATED PARTITION MILLWORK MILLWORK ABOVE DETAIL NUMBER 5 SHEET NUMBER DESCRIPTION OF SIMILAR OR OPPOSITE 4 AREA TO BE DETAILED 1 LOCATION ON SHEET WHERE ELEVATION IS SHOW 1 DIRECTION OF ELEVATION 5 SHEET NUMBER WHERE ELEVATION IS SHOWN 1 INTERIOR AND EXTERIOR ELEVATION MARKER 7 REVISION REFERENCE NUMBER 7 REVISION CLOUD DEPICTING AREA REVISED 1 DOOR NUMBER 5 HEETNOTE REFERENCE 5 HIRE RATING 1 DOOR REFERENCE NUMBER (REFER TO DOOR SC 1 DOOR NUMBER 5 DOOR TYPE 1 DOOR NUMBER 5 DOOR TYPE 1 DOOR NUMBER 6 DOOR TYPE 1 DOOR NUMBER 6 DOOR TYPE 1 DOOR NUMBER 6 DOOR TYPE 1 DOOR NUMBER 7 DOOR NUMBER 6 DOOR TYPE 1 DOOR NUMBER 7 DOOR NUMER 7 DOOR	HEDULE) W SCHEDULE) WORK SCHEDULE)

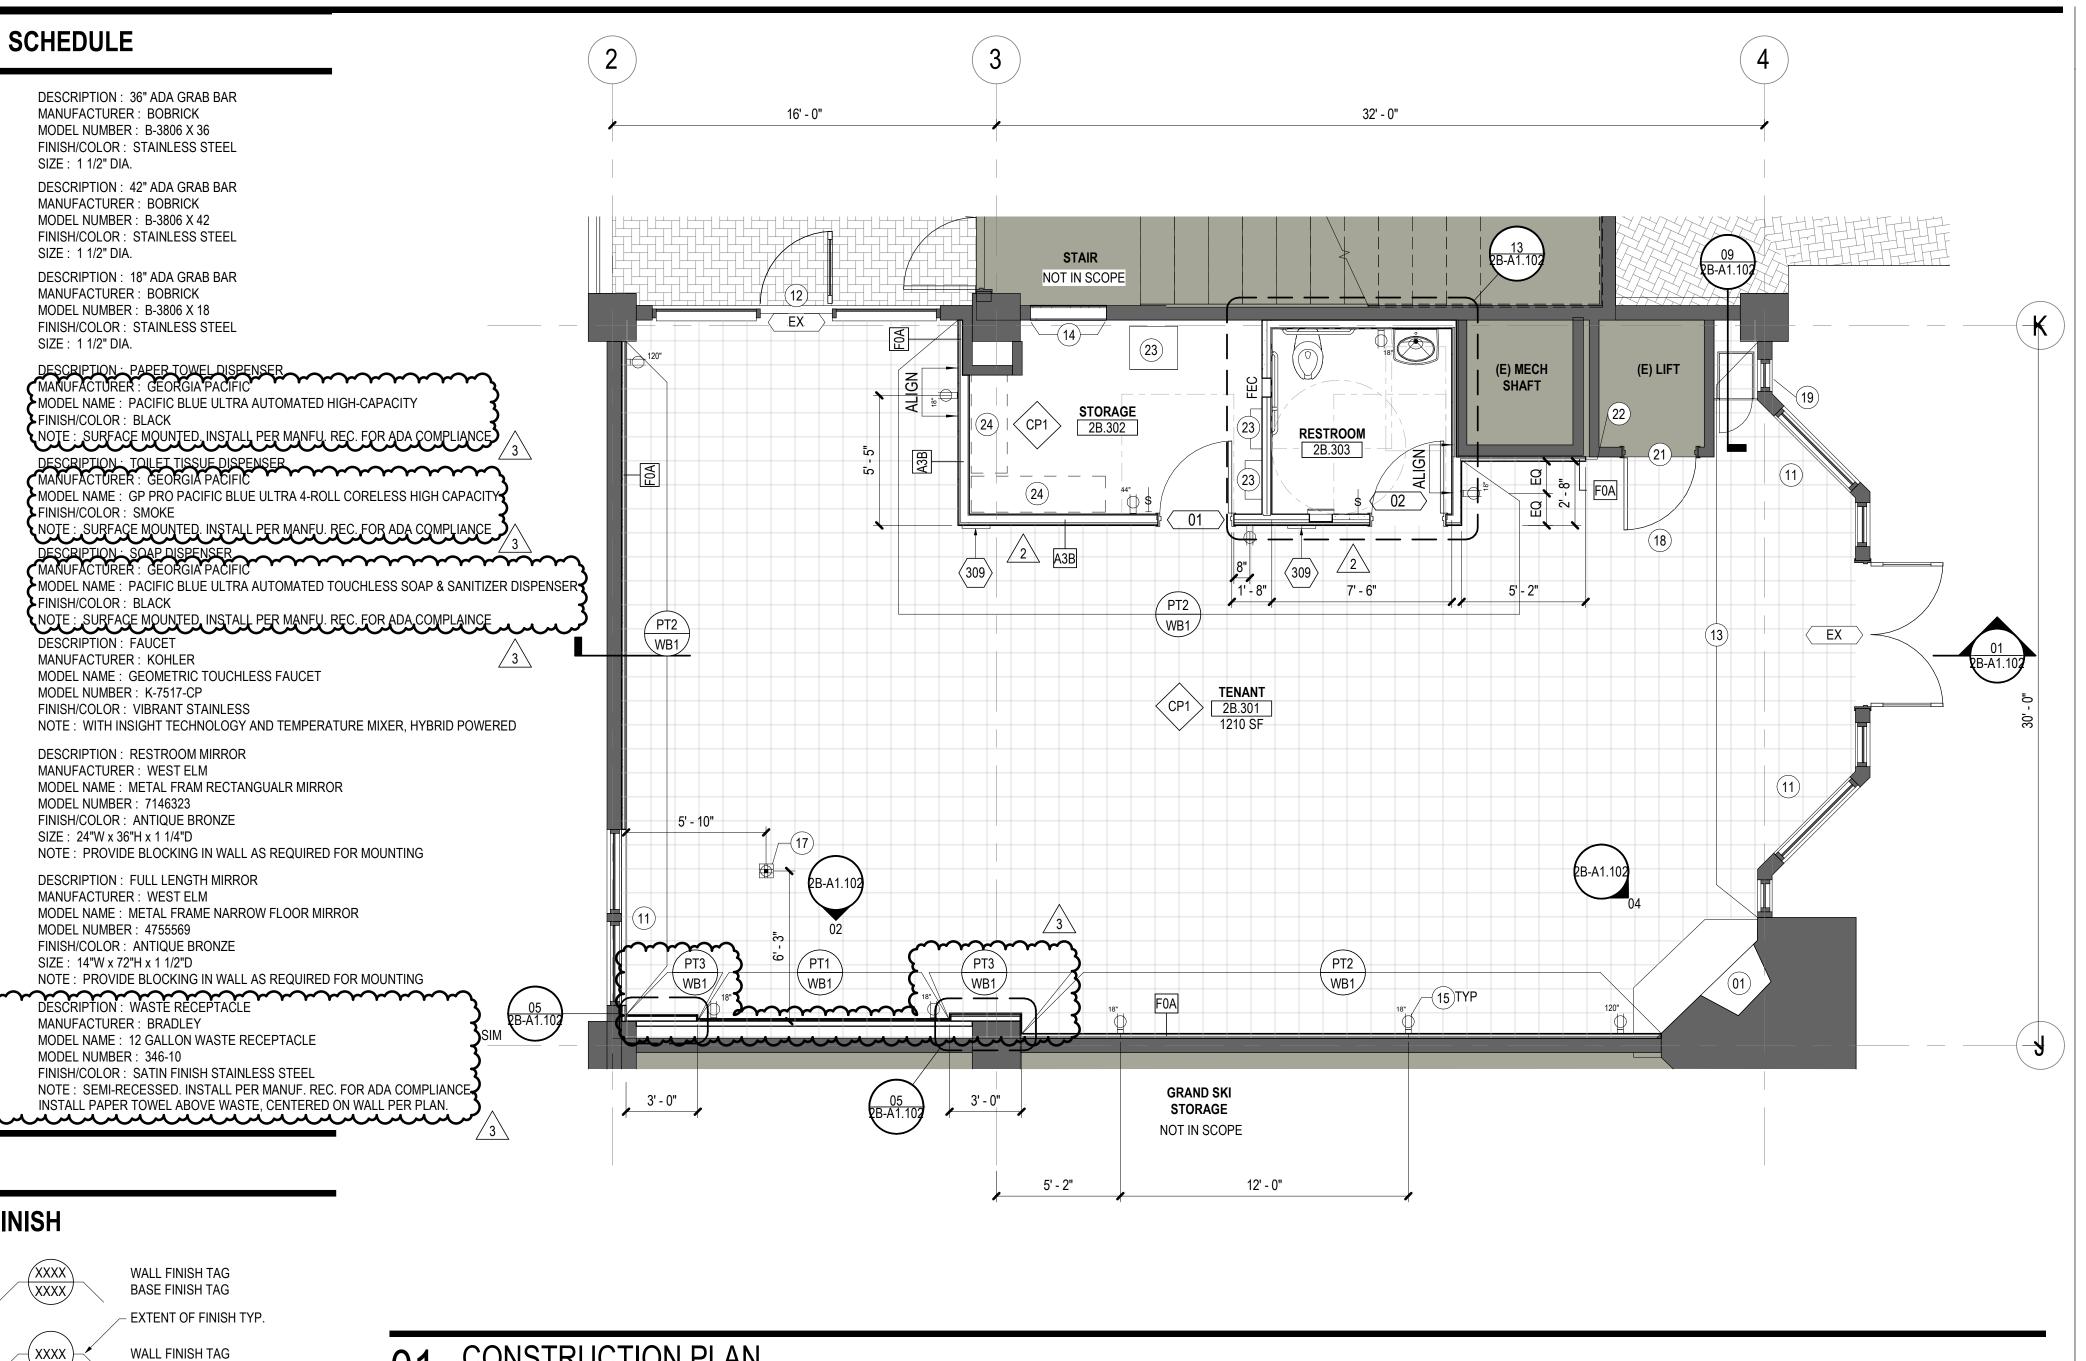

XXXX (XXXX) SPECIAL FINISH TAG $\langle XXXX \rangle$ FLOOR FINISH TAG /xxxx\ CEILING FINISH TAG \rightarrow CHANGE IN FLOOR FINISH

CONSTRUCTION PLAN SCALE: 1/4" = 1'-0"

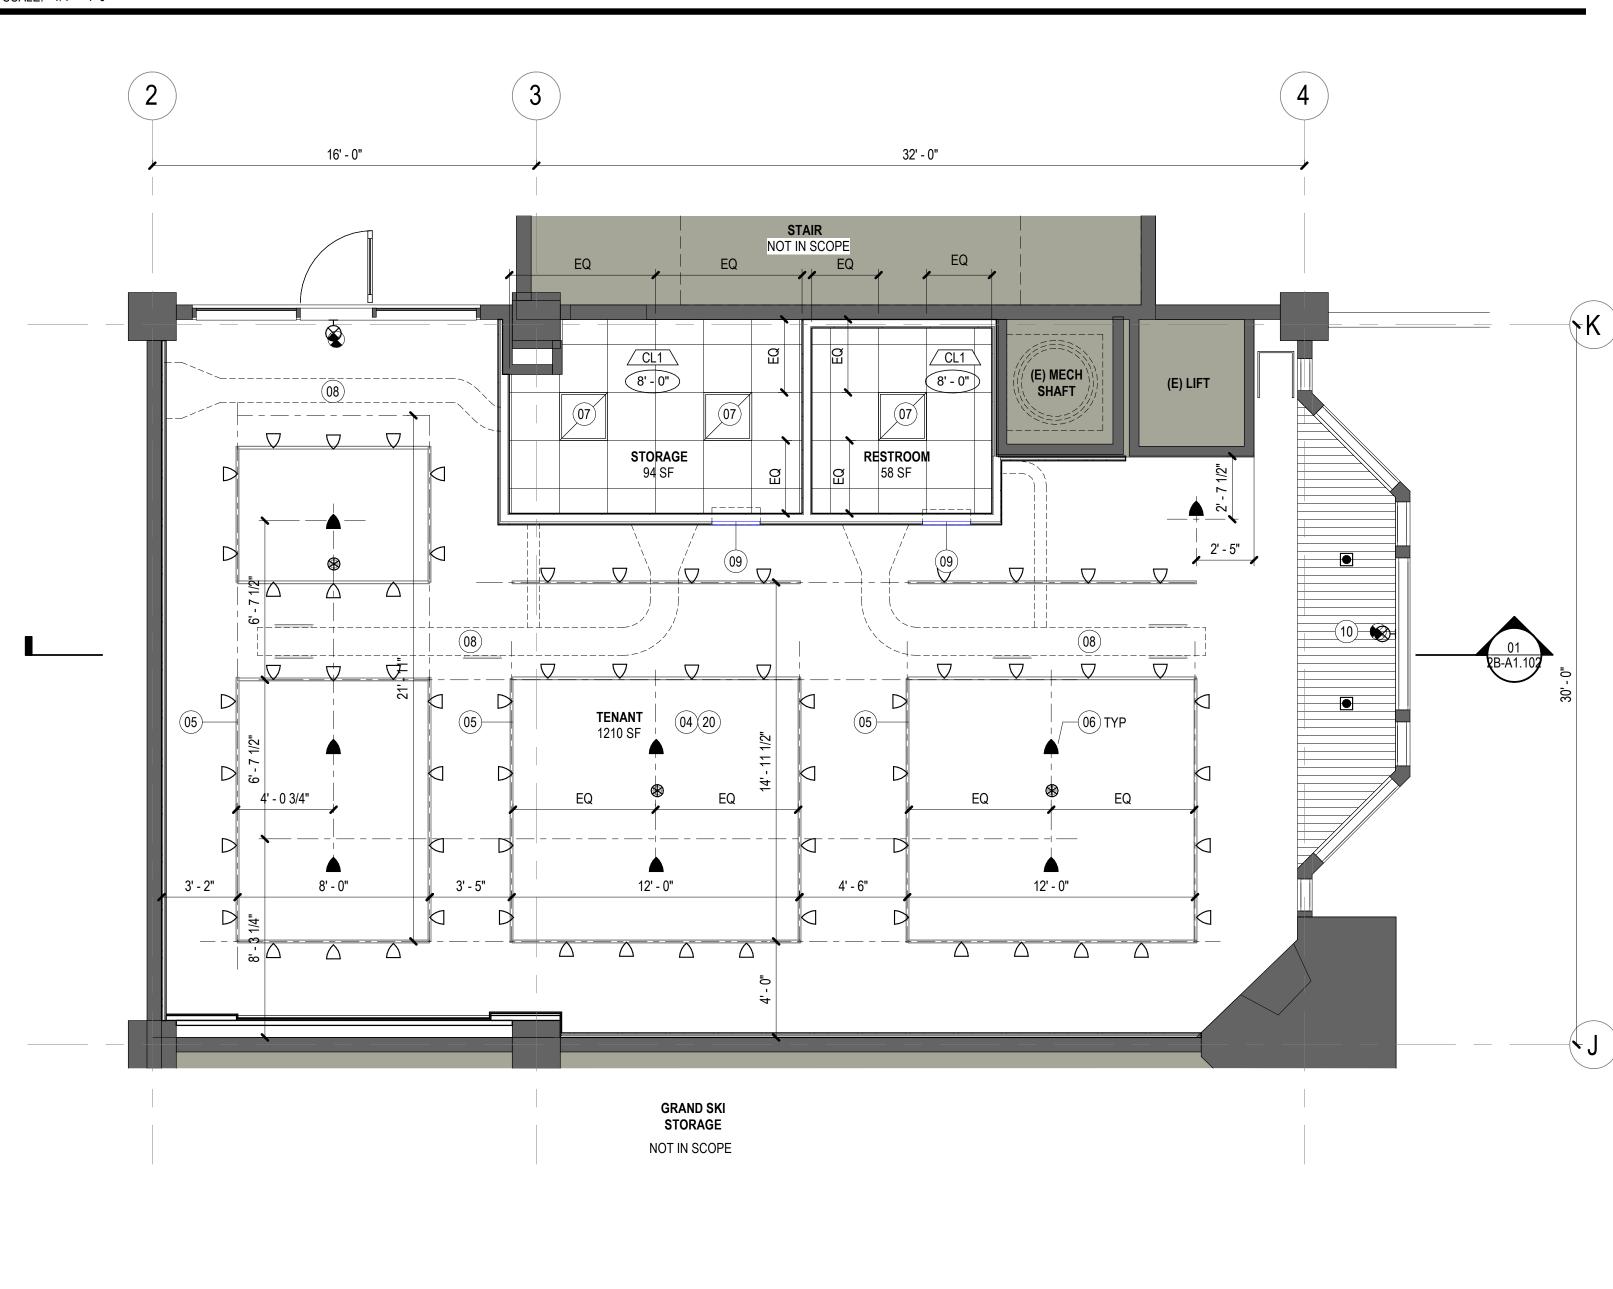

02 REFLECTED CEILING PLAN SCALE: 1/4" = 1'-0"

SHEET NOTES

- 01 EXISTING FIREPLACE. DECOMISSION AND REMOVE
- ALL CAS LINES/ACCESSORIES PAINT BRICK PT2. PAINT INSIDE OF FIREPLACE PT3 EXISTING RATED CEILING TO REMARK. PATCH AND REPAIR (E) 1 HR FRR GWB CEILING AS REQUIRED
- TO MAINTAIN 1 HR FRR. FINISH TO BE PT1 05 HANGING TRACK LIGHT. MOUNT LIGHT AS HIGH AS POSSIBLE UNDER MEP AND SPRINKLERS. GC TO VERIFY EXISTING CONDITIONS IN FIELD AND COORDINATE HEIGHT WITH ARCHITECT. RE: MEP
- 06 PENDANT LIGHT WITH SURFACE MOUNTED JUNCTION BOX. MOUNT LIGHT AS HIGH AS POSSIBLE UNDER MEP AND SPRINKLERS. GC TO VERIFY EXISTING CONDITIONS IN FIELD AND
- COORDINATE HEIGHT WITH ARCHITECT. RE: MEP 07 RECESSED 2' X 2' LIGHT FIXTURE. RE: MEP 08 EXPOSED DUCTWORK. MOUNT TIGHT TO CEILING. RE : MEP
- 09 WALL LOUVER TO UNITS OVER RESTROOM/STORAGE CEILING. CENTER OVER DOORS. RE: MEP
- 10 EXISTING WOOD CEILING TO REMAIN. PAINT PT1 11 BASEBOARD HEATER, REFER TO MECHANICAL DRAWINGS
- 12 EXISTING EGRESS DOOR. 13 EXISTING EXTERIOR DOORS AND WINDOWS. PAINT WOOD FRAME PT1
- 14 INFILL WALL, MATCH EXISTING FINISHES. WALL SHALL BE 1 HR FRR ASSEMBLY. 15 DUPLEX POWER OUTLET. REFER TO ELECTRICAL
- DRAWINGS FOR ADDITIONAL ELECTRICAL AND TECHNOLOGY INFORMATION 17 FLOOR FOURPLEX RECEPTACLE. REFER TO
- ELECTRICAL DRAWINGS FOR MORE INFORMATION 18 SLOPE FLOOR UP TO LIFT ELEVATION UNDER CARPET, 1:20 MAX.
- 19 ADD BLACKOUT FILM ON INTERIOR FACE OF EXISTING GLASS
- 20 ALL ABANDONED MEP DUCTWORK, PIPES, CONDUIT, ETC TO BE CAPPED AND REMOVED.
- 21 EXISTING LIFT DOOR TO REMAIN. PAINT PT1. REMOVE ALL UN-USED CONTROLS, REPLACE SWITCHPLATES WITH NEW.
- 22 RETURN GYP BACK TO EXISTING WALL AT EDGE OF F0A PARTITION 23 MEP EQUIPMENT. RE : MEP
- 24 STORAGE SHELVING AND CLOTHING RACKS ON CASTERS TO BE PROVIDED BY OTHERS

GENERAL NOTES

A. REF. GENERAL SHEETS FOR GRAPHIC SYMBOLS, GENERAL NOTES AND ABBREVIATIONS, ACCESSIBILITY REQUIREMENTS, CLEARANCES AND MOUNTING HEIGHTS.

B. ALL PARTITIONS TO BE TYPE "A" U.O.N.

C. PROVIDE LVL 4 FINISH AT ALL GYP.BD SURFACES, U.O.N.

D. ALL EXISTING PARTITIONS, INCLUDING AT PERIMETER TO BE MODIFIED / EXTENDED AS REQ'D TO BE FULLY FINISHED (GYP. BOARD, TAPED, MUDDED AND PAINTED) TO 12" BELOW DECK ABOVE TO COVER EXPOSED WALL STRUCTURE. COORD. SPECIFIC REQUIREMENTS & LOCATIONS W/ RCP SHEETS.

E. ALL POWER OUTLETS AT WALLS TO BE MOUNTED AT 18" AFF U.O.N. REFER TO GENERAL MOUNTING LOCATIONS.

F. PARTITIONS AT BUILDING PERIMETER SHALL BE CENTERED ON CENTERLINE OF WINDOW MULLION U.O.N.

G. INSTALL METAL CORNER BEADS AT ALL EXPOSED WALLBOARD EDGES. INSTALL CASING BEADS WHEREVER WALLBOARD, PLASTER, ETC. ABUTS A DISSIMILAR FINISH MATERIAL & PROVIDE SEALANT AS REQ'D.

H. PROVIDE MIN. 20 GA. BACKING STUDS AND/OR 18 GA. BY 6" WIDE BACK'G PLATES WHEN REQUIRED FOR SUPPORT U.O.N.

J. NOTIFY ARCHITECT IN WRITING OF CONFLICTS, DIMENSIONAL OR OTHER DISCREPANCIES PRIOR TO PROCEEDING WITH WORK OR AREAS AFFECTED.

K. ALL GLASS TO BE TEMPERED. ALL EXPOSED EDGES SHALL BE POLISHED.


L. PREP SLAB AS REQUIRED FOR SPECIFIED FINISH. M. DOOR JAMB LOCATIONS SHALL BE TYP. 4" FROM ADJ. WALL.


N. PATCH AND REPAIR SURFACES DAMAGED AS A RESULT OF WORK PERFORMED ON THIS PROJECT. PATCH & REPAIR EXIST SURFACES SURFACES AS REQ'D TO RECEIVE NEW FINISH.

P. PROVIDE PAINTED LAYOUT FOR REVIEW BY ARCHITECT PRIOR TO INSTALLATION OF TRACK AND STUDS. LAYOUT TO INCLUDE PARTITIONS, MILLWORK, SOFFITS, LIGHTS AND ALL SIGNIFICANT ARCHITECTURAL FEATURES.

Q. ALL PARTITIONS TO BE PAINTED PT1 WITH WB1 U.O.N. ALL CEILINGS TO BE PAINTED PT1 U.O.N.

KEY PLAN

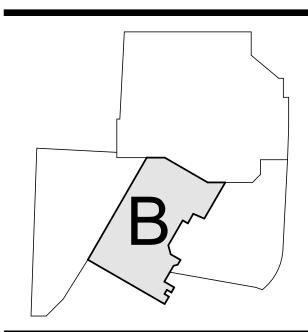

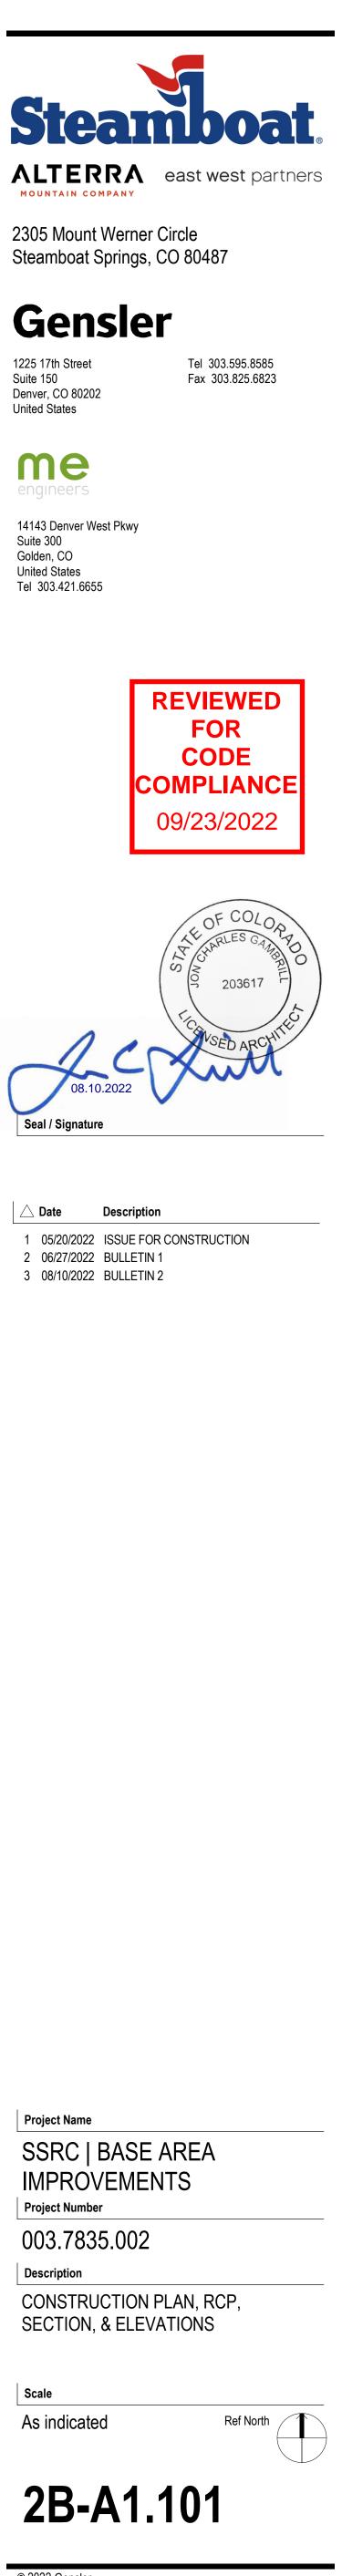

© 2022 Gensler

