

STEAMBOAT SKI & RESORT CORPORATION

SSRC | BASE AREA IMPROVEMENTS

2305 Mount Werner Circle  
Steamboat Springs, CO 80487

Building A: Retail - ISSUE FOR CONSTRUCTION

2022.05.20

PROJECT INFORMATION

FOLLOWING ARE THE PLANS OUTLINING THE SCOPE OF WORK REQUIRED FOR THE NEW CONSTRUCTION AND RENOVATION OF THE STEAMBOAT BASE VILLAGE.

THE WORK OF PROJECT IS DEFINED BY THE CONTRACT DOCUMENTS. THE WORK IS TO INCLUDE THE INTERIOR RENOVATION OF THE EXISTING BUILDING A STORAGE SPACE TO CREATE A NEW MERCANTILE OCCUPANCY RETAIL SPACE.

THE WORK WILL INCLUDE NEW PARTITIONS, CEILINGS, FINISHES, MECHANICAL, AND ELECTRICAL. NO EXTERIOR RENOVATIONS ARE INCLUDED IN THIS PROJECT.

THE DRAWINGS, IN CONCERT WITH THE PROJECT MANUAL, COMPRISE THE CONTRACT DOCUMENTS OUTLINING THE DESIGN INTENT AND PROJECT SCOPE, AND MAY BE SUPPLEMENTED BY FURTHER INFORMATION ISSUED BY ARCHITECT.

THE DRAWINGS ARE ARRANGED IN GENERAL TO SPECIFIC ORDER, FOLLOWING A TOP TO BOTTOM, RIGHT TO LEFT FORMAT. CONTRACTORS ARE ADVISED TO READ AND FAMILIARIZE THEMSELVES WITH THE INFORMATION IN THE PROJECT MANUAL, AS WELL AS THE GENERAL LEGENDS CONTAINED IN THE G SERIES OF DRAWINGS. PRIOR TO REVIEW OF THE PLANS, ELEVATIONS AND DETAILS, ADVISE THE ARCHITECT WHERE INTENT IS NOT CLEARLY PERCEIVED, PRIOR TO PROCEEDING WITH WORK.

BUILDING ADDRESS: 2305 MOUNT WERNER CIRCLE  
STEAMBOAT SPRINGS, CO 80487

BUILDING JURISDICTION: ROUTT COUNTY, STEAMBOAT SPRINGS, COLORADO

APPLICABLE CODES: 2018 INTERNATIONAL BUILDING CODE  
2018 INTERNATIONAL MECHANICAL CODE  
2018 INTERNATIONAL PLUMBING CODE  
2018 INTERNATIONAL FUEL GAS CODE  
2018 INTERNATIONAL FIRE CODE  
2020 NATIONAL ELECTRIC CODE  
2018 INTERNATIONAL ENERGY CONSERVATION CODE  
ASHRAE 90.1 2016  
2009 ICC A117.1, ACCESSIBILITY REQUIREMENTS  
2010 ADA ACCESSIBILITY GUIDELINES  
ANSI/ASME A17.1, SAFETY CODE FOR ELEVATORS 2013  
USEABLE BUILDING & FACILITIES CODE  
STEAMBOAT SPRINGS AND ROUTT COUNTY CODE AMENDMENTS

OCCUPANCY TYPE: M-MERCANTILE, S-2 STORAGE

SEPARATED USE: NON SEPARATED MIXED OCCUPANCY

CONSTRUCTION TYPE: TYPE IIA

FIRE SUPPRESSION: FIRE RESISTIVE, (100% SPRINKLERED)

FIRE ALARM SYSTEM: FIRE ALARM AND SMOKE DETECTION SYSTEM PER IBC 907.2 & NFPA 72

DEFERRED SUBMITTALS: • FIRE ALARM SYSTEM  
• FIRE SPRINKLER SYSTEM  
• ACCESS CONTROL HARDWARE

NUMBER OF STORIES IN BUILDING: 4 STORIES (ABOVE GRADE)  
1 STORY (BELOW GRADE)

TOTAL FLOOR AREA: 32,340 SF

SCOPE OF WORK AREA: 1,406 SF

LEED CERTIFICATION: NONE


PROJECT TEAM

CLIENT / OWNER: ALTRERA MOUNTAIN COMPANY REAL ESTATE DEVELOPMENT  
3501 WAZEE STREET  
DENVER, CO 80216  
(303) 749 - 8200


ARCHITECT: GENSLER  
1225 17TH STREET, SUITE 150  
DENVER, CO 80202  
(303) 595 - 8585

MECHANICAL / ELECTRICAL  
/ PLUMBING ENGINEER: ME ENGINEERS  
14143 DENVER WEST PKWY, SUITE 300  
GOLDEN, CO 80401  
(303) 421-6655

LOCATION MAP

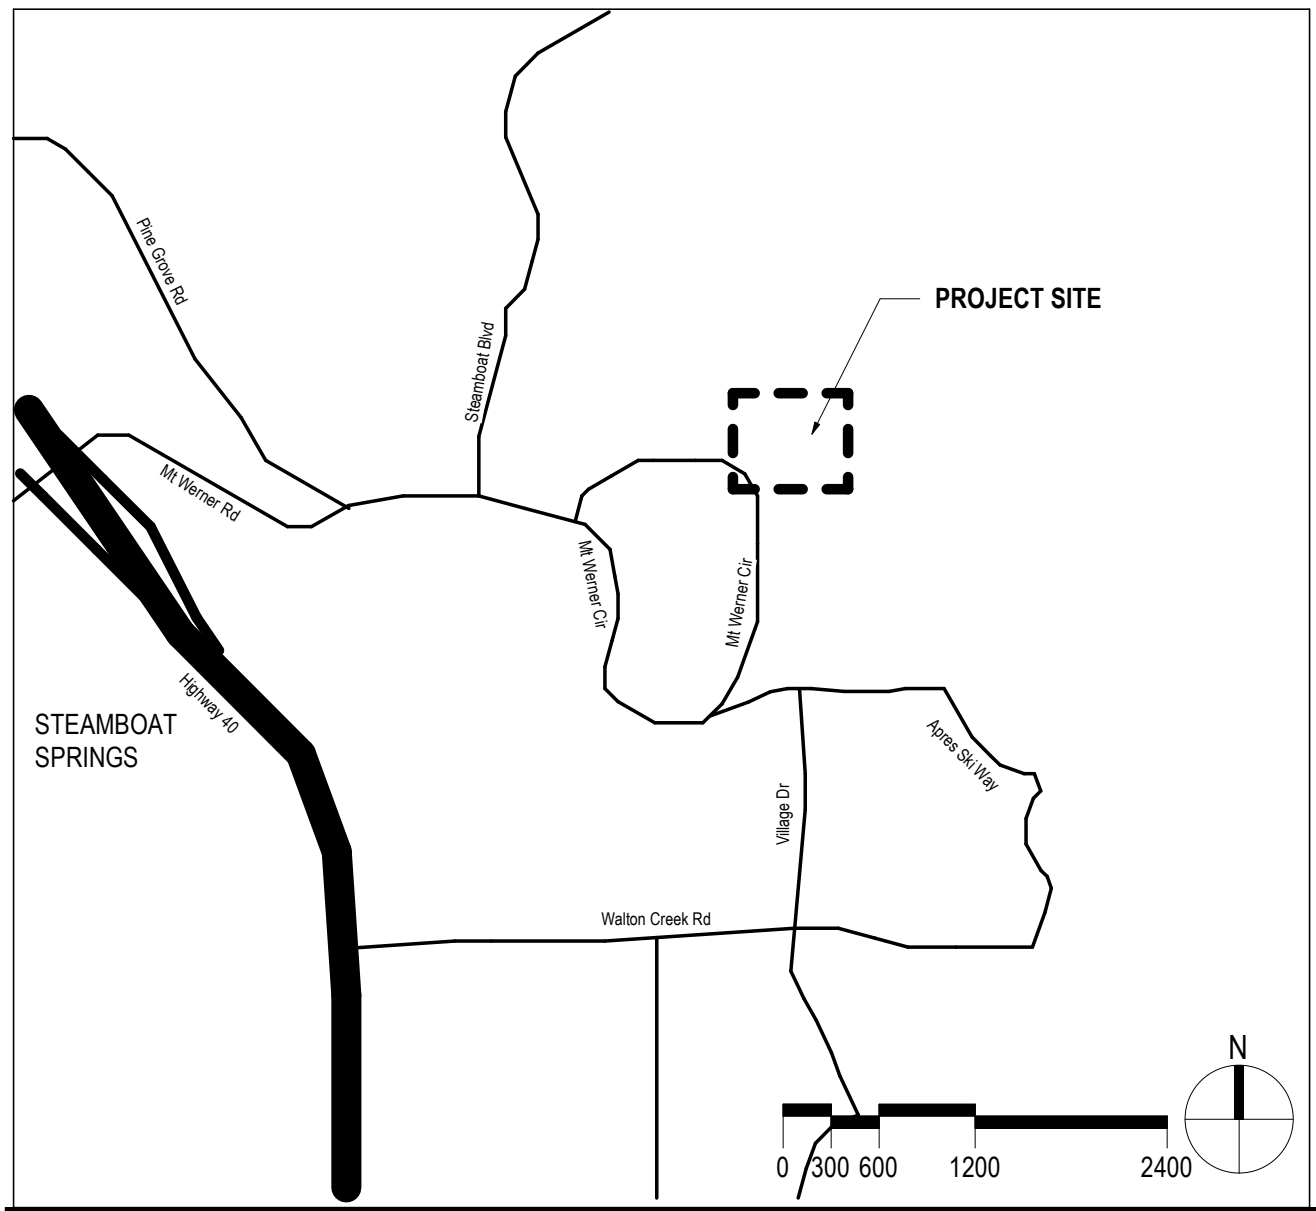

SITE PLAN

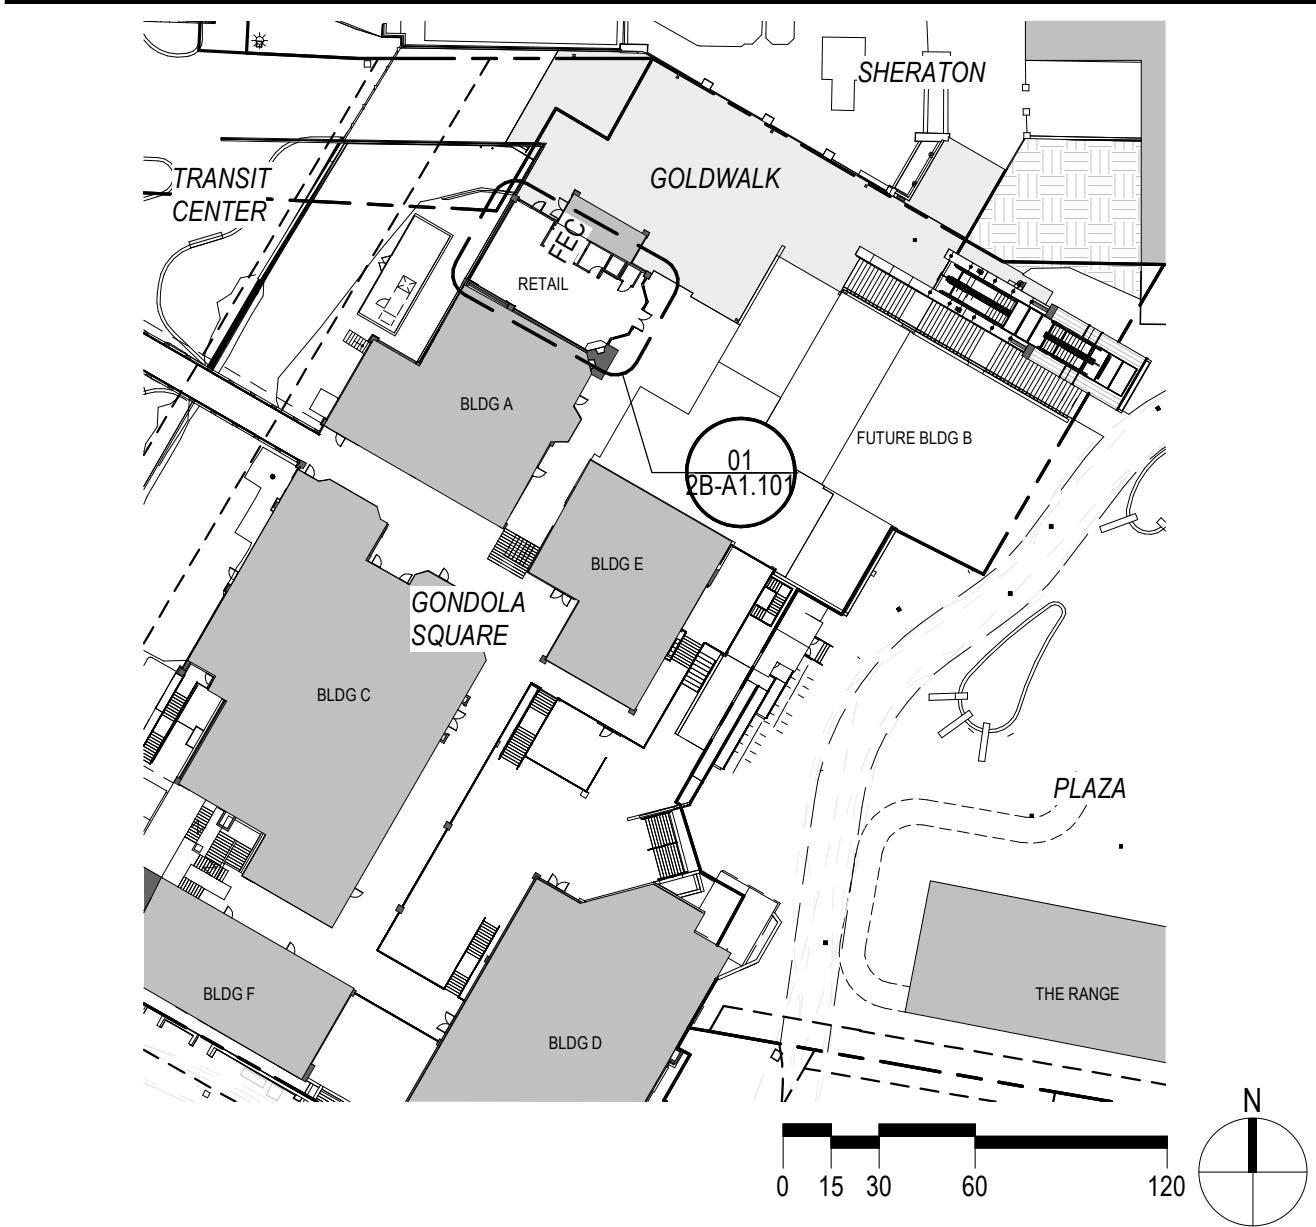


GRAPHIC SYMBOLS LEGEND		EGRESS REQUIREMENTS	
	EXIT ACCESS TRAVEL DISTANCE	TOTAL GROSS AREA OF TENANT - ENTIRE LEVEL:	APPROX. 1,406 SF
	COMMON PATH OF TRAVEL	TOTAL AREA IN SCOPE:	APPROX. 1,406 SF
	SECURITY LOCATIONS	TENANT OCCUPANT LOAD CALCULATIONS:	IBC TABLE 1004.1.2
	OCCUPANCY, FUNCTION OF SPACE	MERCANTILE (60 GSF/PERSON)	22 OCCUPANTS
	1HR FIRE BARRIER / 20MIN OPENINGS	STORAGE (300 GSF/PERSON):	1 OCCUPANTS
	1HR FIRE BARRIER / 45MIN OPENINGS	TOTAL:	23 OCCUPANTS
	2HR FIRE BARRIER / 90MIN OPENINGS	EGRESS WIDTH REQUIREMENTS:	IBC 1005.3.2
	3HR FIRE BARRIER	REQUIRED (.15 IN/OCCUPANT):	3.45 INCHES
FUNCTION LEGEND (OCCUPANT LOAD)		PROVIDED AT EXIT DOORS:	108 INCHES
	MERCANTILE	EXIT STAIR WIDTH:	IBC 1005.3.1
	STORAGE	REQUIRED (2 IN/OCCUPANT):	NA
GENERAL NOTES		PROVIDED AT EXIT STAIRS:	NA
A. WORK AREAS TONED IN LIGHT & DARK GRAY N.I.C.		MINIMUM WIDTH OF EGRESS CORRIDOR REQUIRED:	IBC 1020.2
SHEET NOTES		MINIMUM WIDTH OF EGRESS CORRIDOR PROVIDED:	36 INCHES
1. EGRESS ALLOWED IN DIRECTION OF EGRESS TRAVEL.		MINIMUM NUMBER OF EXITS REQUIRED:	NA
		NUMBER OF EXITS PROVIDED:	1 EXITS
			2 EXITS
		MAXIMUM LENGTH OF EGRESS TRAVEL:	IBC TABLE 1017.2 FOOT/NOTE C
			250 FEET (MERCANTILE)
		MAXIMUM COMMON PATH OF TRAVEL:	IBC 1006.2.1 FOOT/NOTE A
			75 FEET (MERCANTILE)
		MAXIMUM DEAD END CORRIDOR:	IBC 1020.4 EXCEPTION 2
			50 FEET (MERCANTILE)
		REMOVEDNESS OF EXITS:	
		LONGEST DIAGONAL	NA, SINGLE EXIT
		REMOVEDNESS OF EXITS	

PLUMBING FIXTURE REQUIREMENTS - LEVEL XX			
OCCUPANCY TOTALS	'M'	'S'	
	22	1	

FIXTURE QUANTITIES		REQUIRED 'M'	REQUIRED 'S'	TOTAL REQUIRED	PROVIDED
WATER CLOSETS	MEN	11/500 = 0.022	.5/100 = 0.005	0.027	0"
	WOMEN	11/500 = 0.022	.5/100 = 0.005	0.027	0"
LAVATORIES	MEN	11/750 = 0.015	.5/100 = 0.005	0.020	0"
	WOMEN	11/750 = 0.015	.5/100 = 0.005	0.020	0"
DRINKING FOUNTAINS		22/500 = 0.044	1/1000 = 0.001	0.045	0"

\* PLUMBING FIXTURES REQUIRED ARE TO BE PROVIDED IN FUTURE BUILDING B WORK.

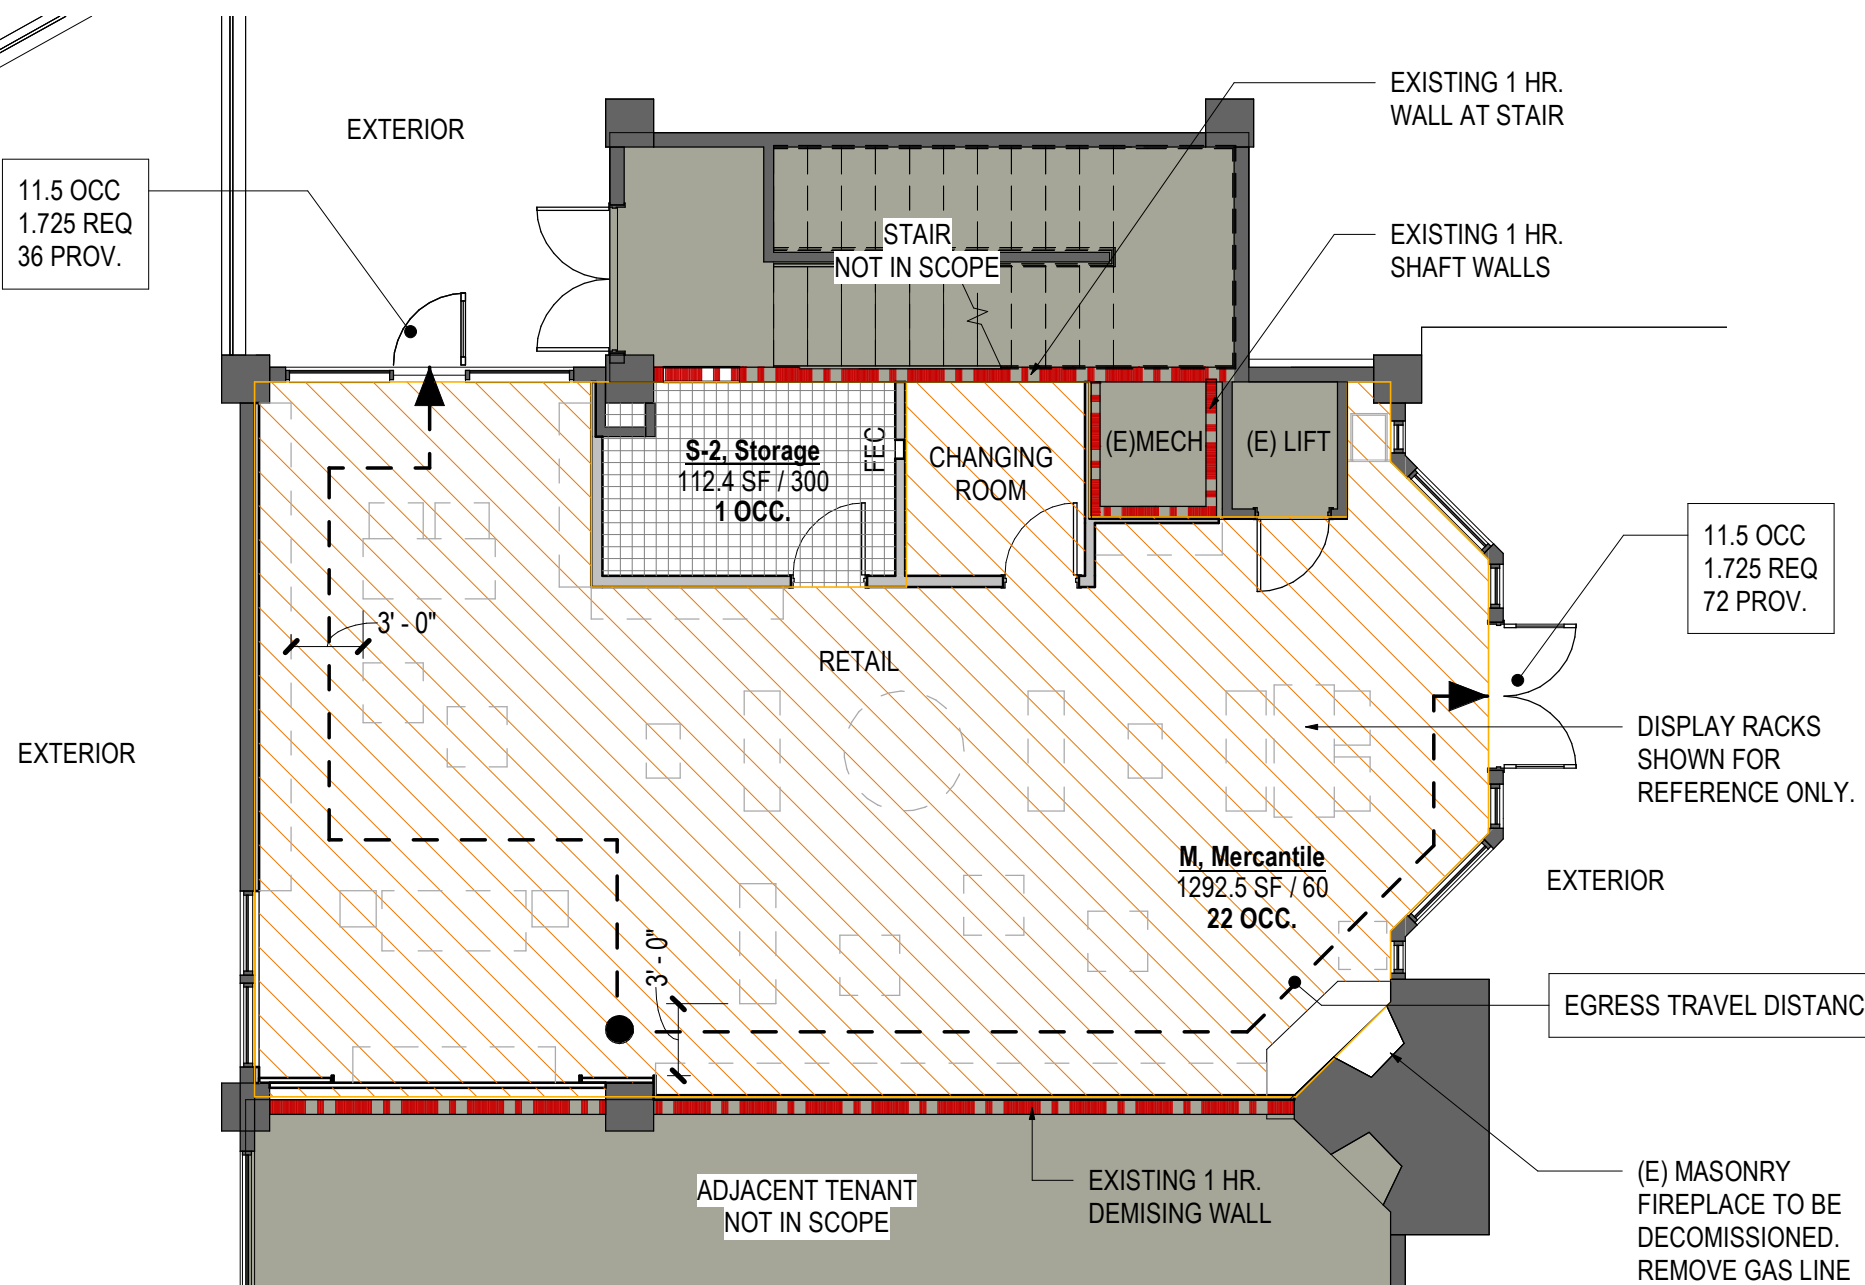

01 RETAIL EGRESS & OCCUPANCY PLAN

SCALE: 1/8" = 1'-0"

DRAWING INDEX

Sheet Number	Sheet Name	Current Revision to IFC (If applicable)		
		Latest	Description	Date
01 - GENERAL				
2B-G0.000	COVER	1	ISSUE FOR CONSTRUCTION	05/20/2022
01 - GENERAL				
2B-G1.101	DEMOLITION PLAN AND SCHEDULES	1	ISSUE FOR CONSTRUCTION	05/20/2022
05 - ARCHITECTURE				
2B-A1.101	CONSTRUCTION PLAN, RCP, SECTION, & ELEVATIONS	1	ISSUE FOR CONSTRUCTION	05/20/2022
2B-A1.102	INTERIOR ELEVATIONS & DETAILS	1	ISSUE FOR CONSTRUCTION	05/20/2022
06 - MECHANICAL				
2B-M0.001	MECHANICAL GENERAL NOTES	1	ISSUE FOR CONSTRUCTION	05/20/2022
2B-M0.002	MECHANICAL CONTROLS	1	ISSUE FOR CONSTRUCTION	05/20/2022
2B-M0.201	MECHANICAL PLAN - LEVEL 02	1	ISSUE FOR CONSTRUCTION	05/20/2022
2B-M0.301	MECHANICAL PIPING PLAN - LEVEL 02	1	ISSUE FOR CONSTRUCTION	05/20/2022
2B-M0.000	MECHANICAL LEGEND	1	ISSUE FOR CONSTRUCTION	05/20/2022
2B-M8.000	MECHANICAL DETAILS	1	ISSUE FOR CONSTRUCTION	05/20/2022
2B-MEP0.000	MECHANICAL SCHEDULES	1	ISSUE FOR CONSTRUCTION	05/20/2022
10 - ELECTRICAL				
2B-EO.000	ELECTRICAL LEGEND	1	ISSUE FOR CONSTRUCTION	05/20/2022
2B-EO.001	ELECTRICAL ONE-LINE	1	ISSUE FOR CONSTRUCTION	05/20/2022
2B-EO.002	ELECTRICAL SCHEDULES	1	ISSUE FOR CONSTRUCTION	05/20/2022
2B-E1.201	ELECTRICAL PLAN - LEVEL 03	1	ISSUE FOR CONSTRUCTION	05/20/2022
2B-E1.301	LIGHTING PLAN - LEVEL 03	1	ISSUE FOR CONSTRUCTION	05/20/2022
2B-E8.000	ELECTRICAL DETAILS	1	ISSUE FOR CONSTRUCTION	05/20/2022
15 - TECHNOLOGY				
2B-TO.000	TECHNOLOGY LEGEND	1	ISSUE FOR CONSTRUCTION	05/20/2022
2B-TO.001	TECHNOLOGY GENERAL NOTES & ABBREVIATIONS	1	ISSUE FOR CONSTRUCTION	05/20/2022
2B-T1.201	TECHNOLOGY PLAN - LEVEL 03	1	ISSUE FOR CONSTRUCTION	05/20/2022
2B-T8.000	TECHNOLOGY DETAILS	1	ISSUE FOR CONSTRUCTION	05/20/2022
2B-T8.001	TECHNOLOGY DETAILS	1	ISSUE FOR CONSTRUCTION	05/20/2022



ALTRERA east west partners  
MOUNTAIN COMPANY

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Seal / Signature

△ Date Description

1 05/20/2022 ISSUE FOR CONSTRUCTION

NOT FOR  
CONSTRUCTION

Project Name

SSRC | BASE AREA  
IMPROVEMENTS

Project Number

003.7835.002

Description

COVER

Scale

NOT TO SCALE


2B-G0.000



DOOR SCHEDULE

DOOR ASSEMBLY							FRAME ASSEMBLY					DOOR HWDR	REMARKS
NUMBER	TYPE	WIDTH	HEIGHT	THICKNESS	MATERIAL	FINISH	HEAD DETAIL	JAMB DETAIL	SILL DETAIL	MATERIAL	FINISH		
01	A	3'-0"	7'-0"	1 3/4"	HOLLOW METAL	PT2	H-01	J-01		HOLLOW METAL	PT2	1	
02	A	3'-0"	7'-0"	1 3/4"	HOLLOW METAL	PT2	H-01	J-01		HOLLOW METAL	PT2	2	

DOOR TYPE

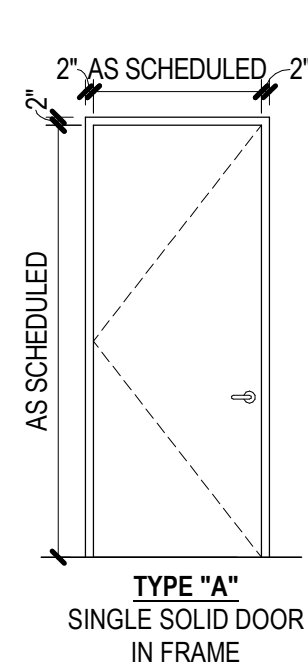


DOOR HARDWARE

HARDWARE GROUP 1 - STOREROOM FUNCTION

- 4 BALL-BEARING HINGE
- 1 MORTISE LOCKSET, STOREROOM FUNCTION
- 1 SURFACE-MOUNTED CLOSER
- 1 FLOOR STOP
- 1 WALL STOP
- 1 SILENCERS BY FRAME MANUF.


HARDWARE GROUP 2 - PRIVACY FUNCTION

- 4 BALL-BEARING HINGE
- 1 MORTISE LOCKSET, PRIVACY FUNCTION WITH INDICATOR
- 1 SURFACE-MOUNTED CLOSER
- 1 WALL STOP
- 1 SILENCERS BY FRAME MANUFACTURER

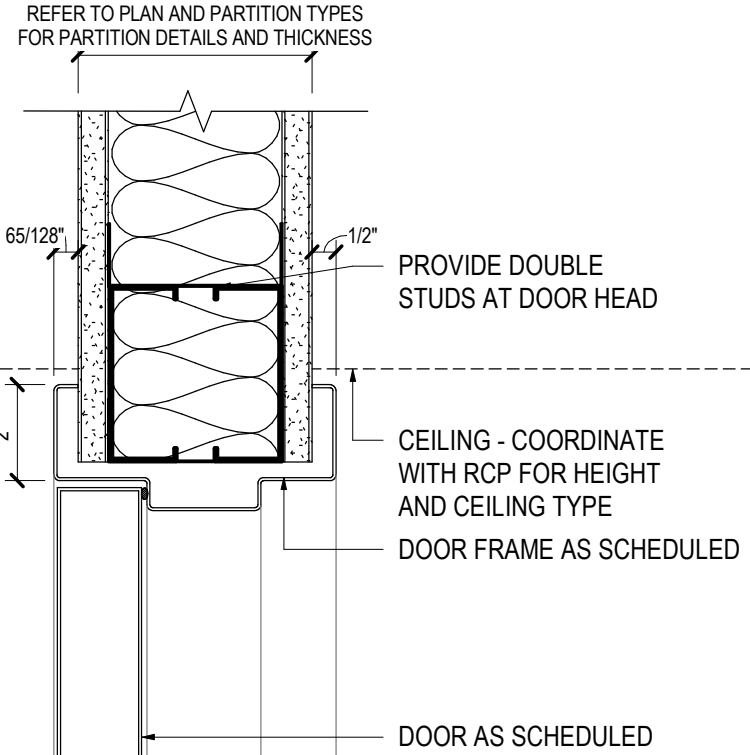


09 H-01 - TYPICAL H.M. DOOR HEAD

SCALE: 3" = 1'-0"

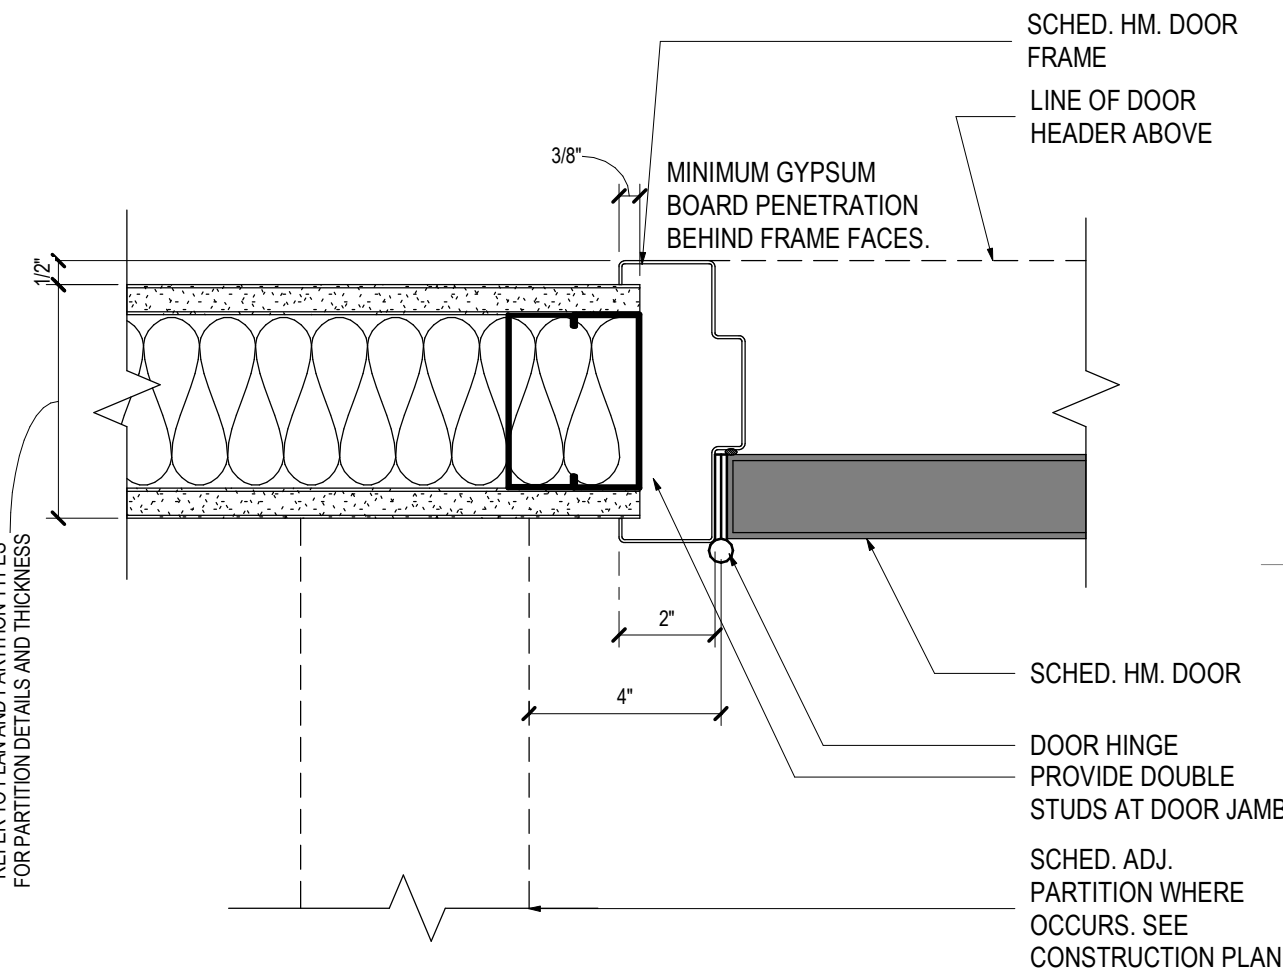


06 J-01 - HOLLOW METAL FRAME JAMB

SCALE: 3" = 1'-0"

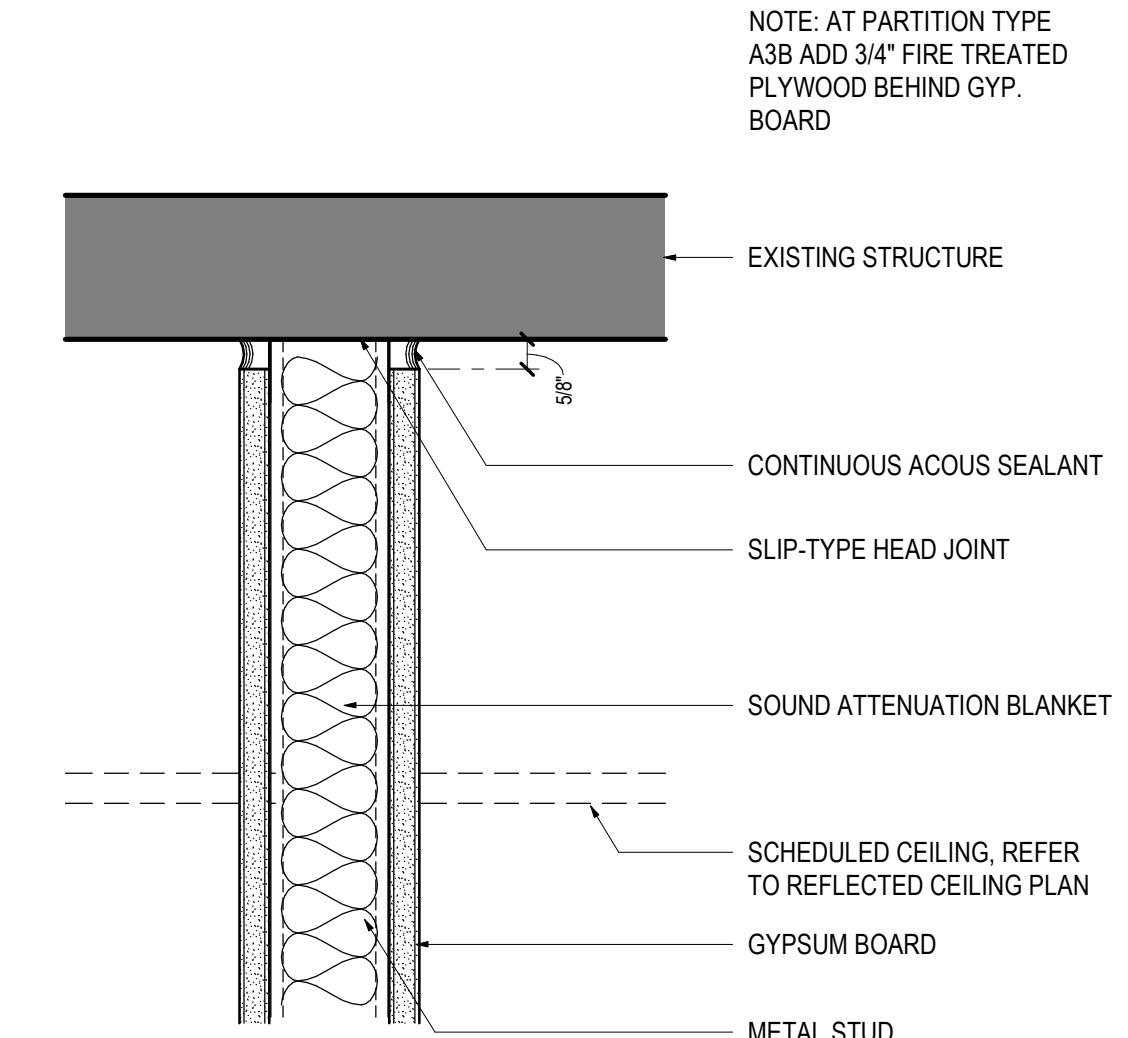


01 DEMOLITION PLAN - LEVEL 03

SCALE: 1/4" = 1'-0"

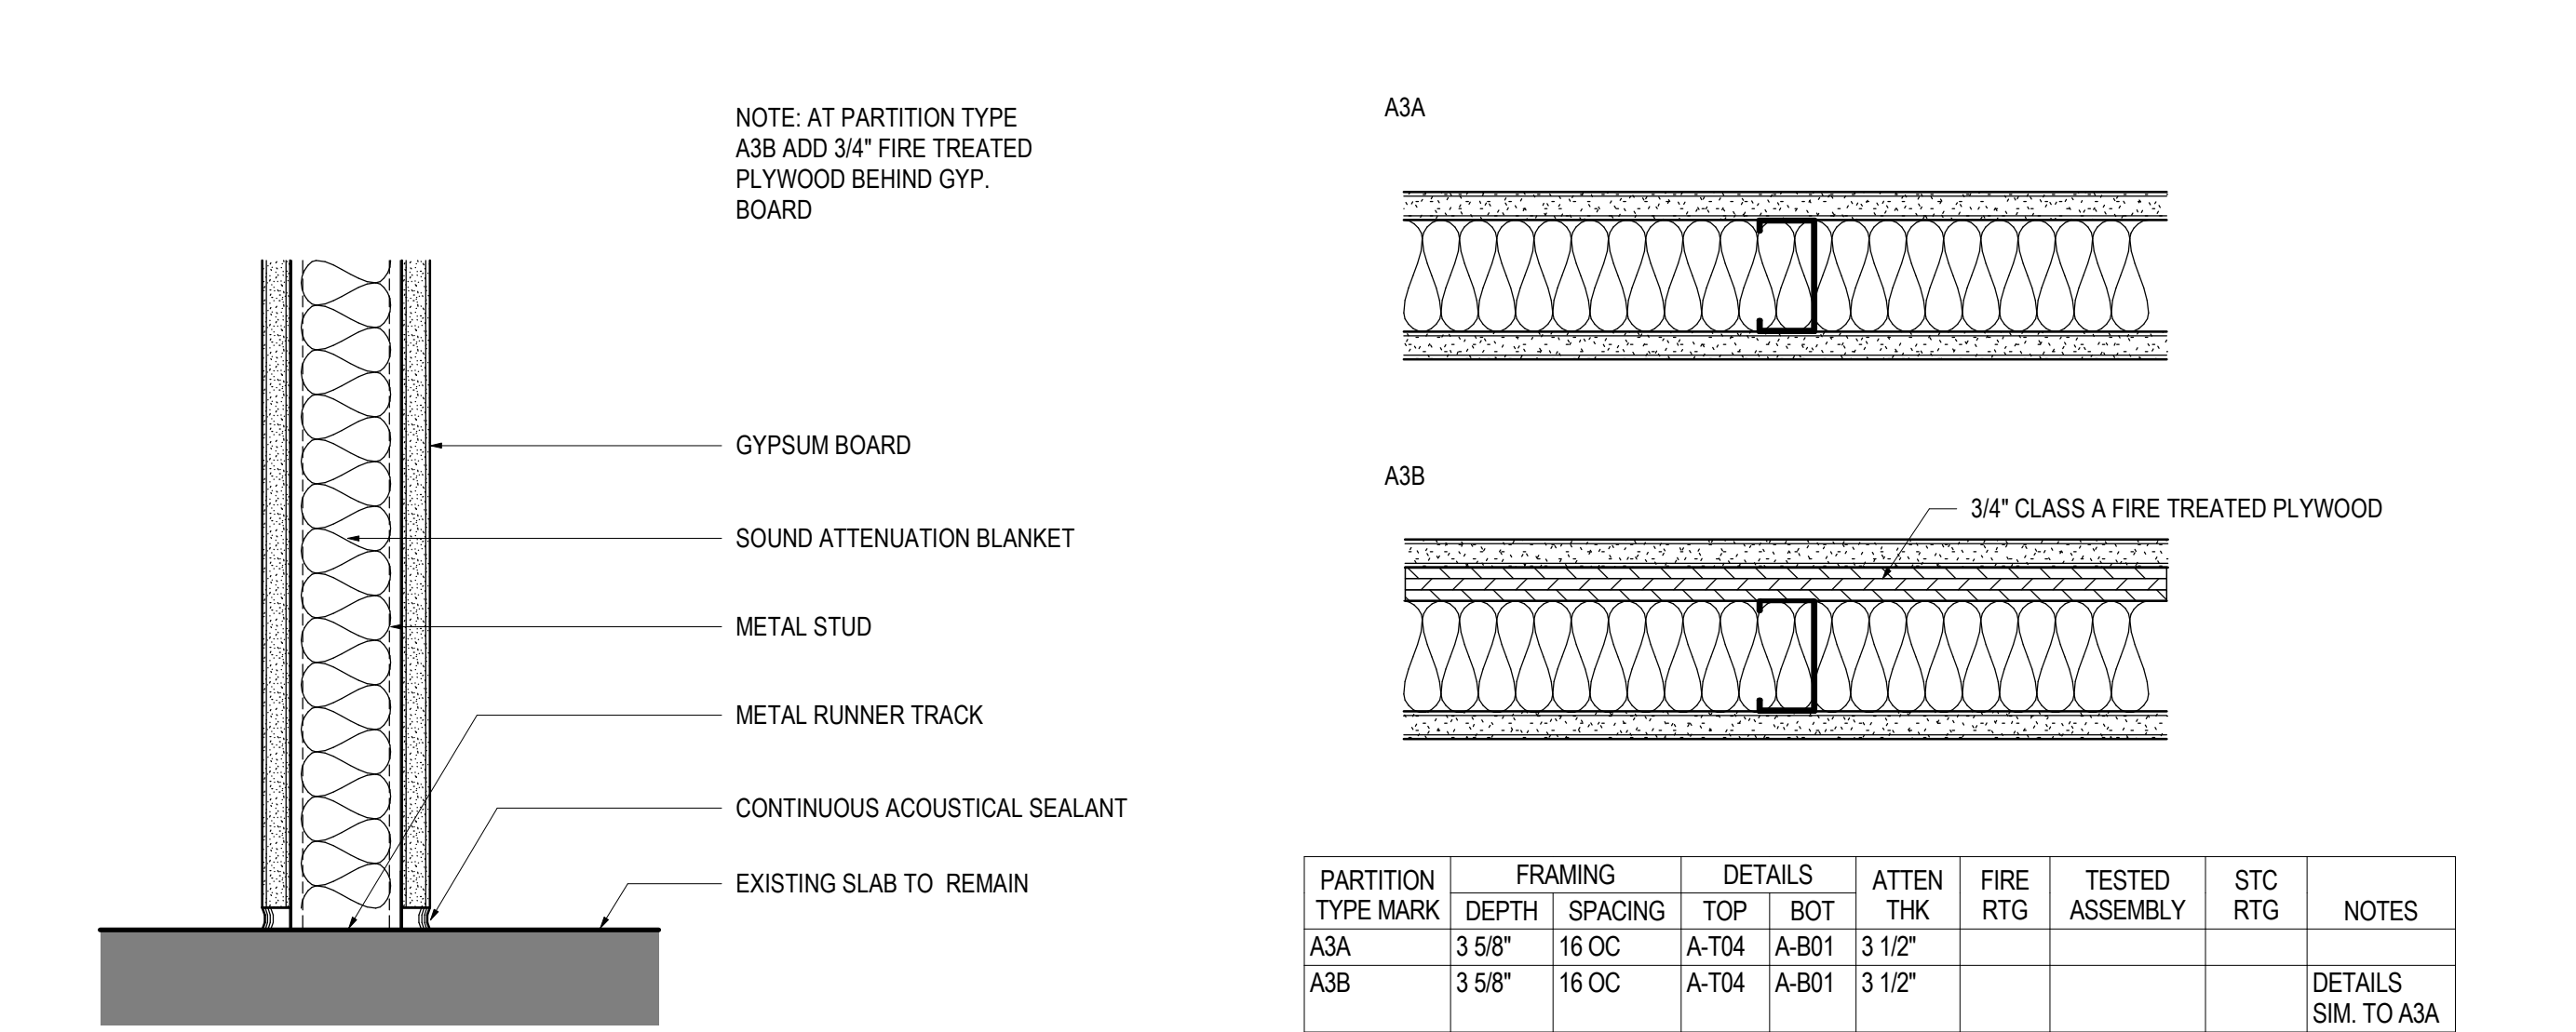


07 A-T04

SCALE: 3" = 1'-0"

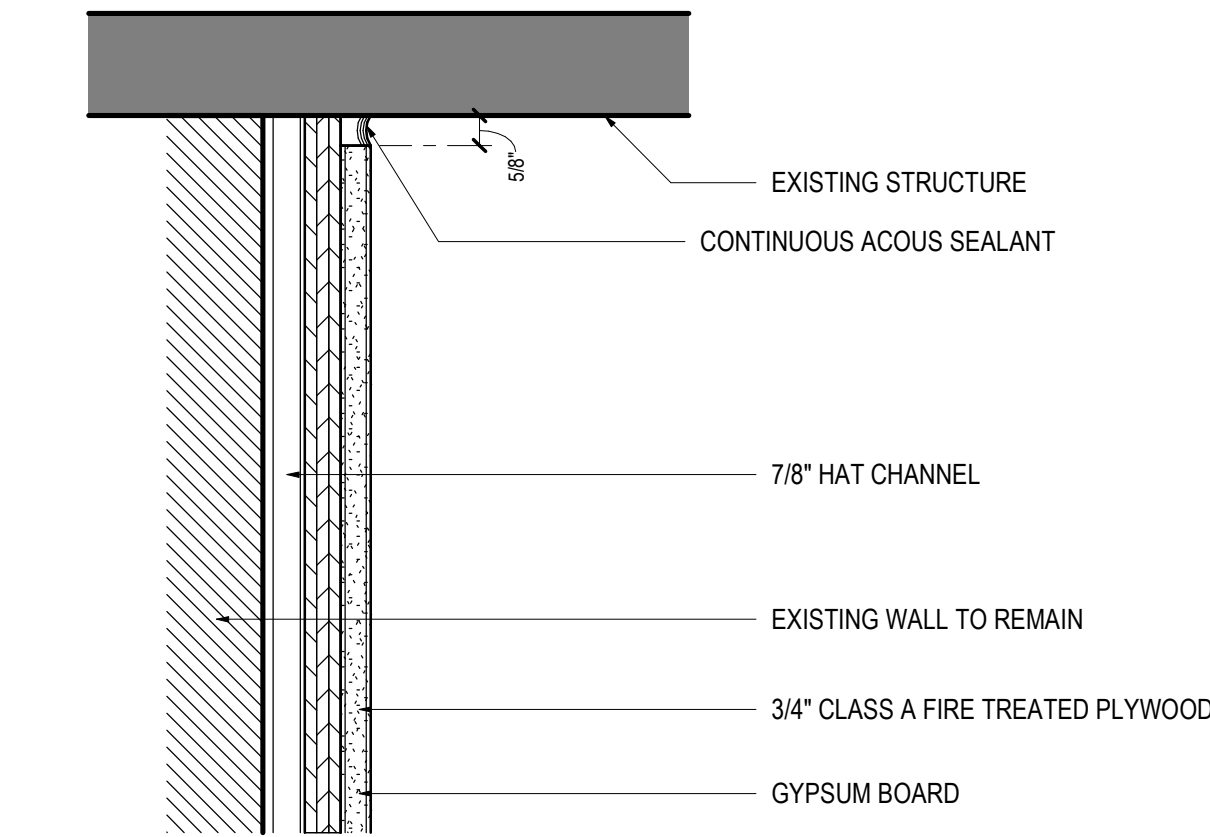


04 A-B01

SCALE: 3" = 1'-0"

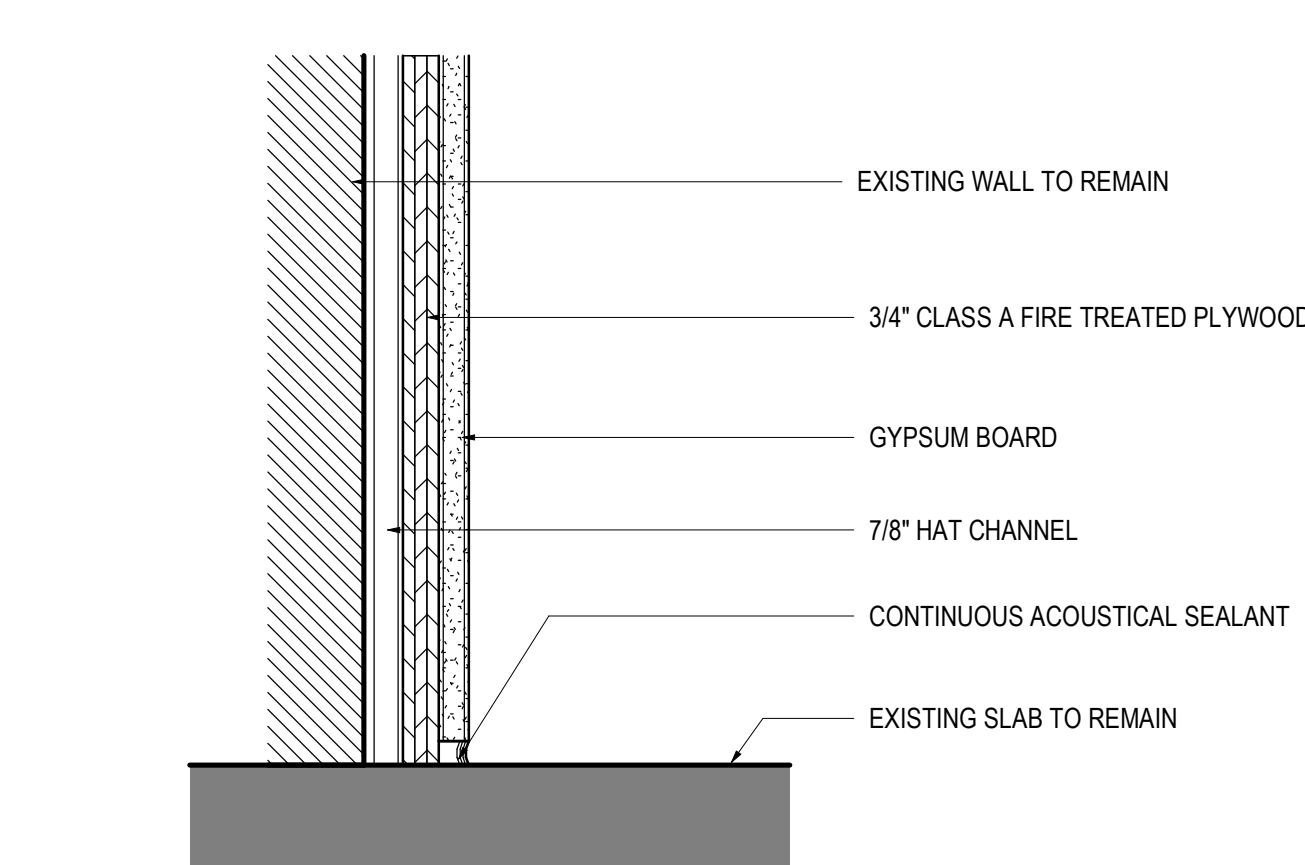


02 A SERIES PARTITION TYPES

SCALE: 3" = 1'-0"

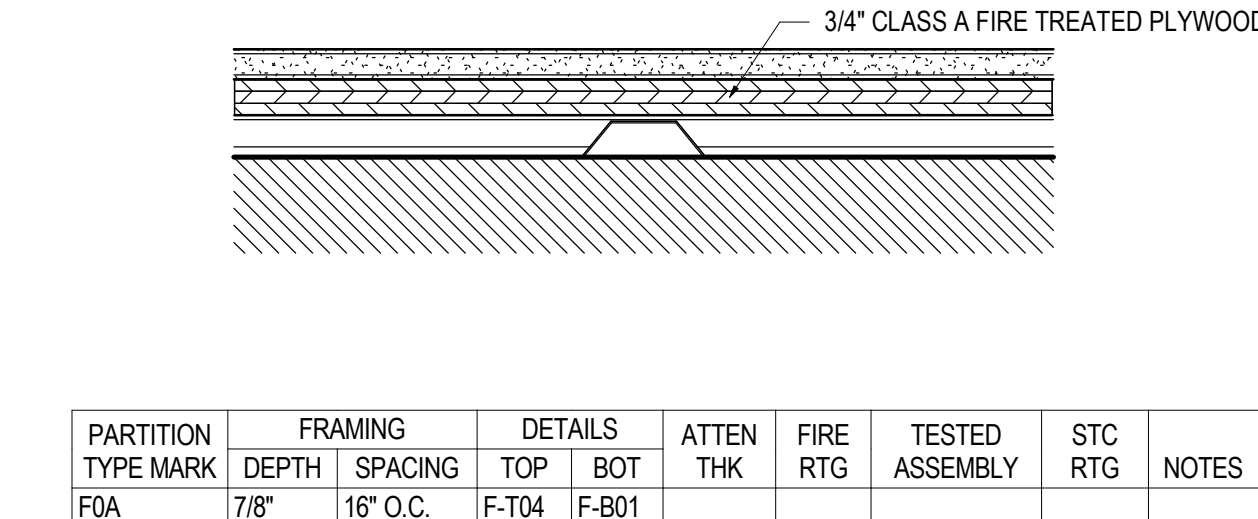

10 MOUNTING LOCATIONS - GENERAL

SCALE: 1/4" = 1'-0"

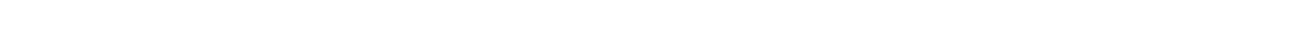

08 F-T04

SCALE: 3" = 1'-0"



05 F-B01

SCALE: 3" = 1'-0"



03 F SERIES PARTITION TYPES

SCALE: 3" = 1'-0"



DEMO NOTES

- EXISTING WALL TO REMAIN. REMOVE ANY APPLIED FINISHES FROM THE TENANT'S SIDE AND PREPARE SURFACE FOR NEW PAINT FINISH.
- EXISTING STOREFRONT, DOORS, AND WINDOWS TO REMAIN. PROTECT FROM DAMAGE DURING DEMOLITION AND CONSTRUCTION.
- REMOVE ALL EXISTING FLOOR FINISHES THROUGHOUT THE SPACE DOWN TO THE EXISTING CONCRETE SLAB SURFACE. AFTER REMOVAL, PREPARE THE EXISTING CONCRETE SLAB SURFACE TO PROVIDE SUITABLE SURFACE FOR NEW FLOORING AS DESCRIBED IN THESE PLANS.
- CEILING DEMO - REMOVE ALL EXISTING DROPPED CEILING AND DROPPED CEILING SYSTEM STRUCTURE, LIGHTING, HVAC SUPPLY AND DIFFUSERS (BACK TO SOURCE) REMOVE ALL SUPPLEMENTAL FRAMING SUSPENSION SYSTEMS AND UTILITY SUPPORT. EXISTING FIRE RATED CEILING ABOVE DROPPED GWB CEILING TO REMAIN. PATCH AND REPAIR (E) 1 HR FRR GWB CEILING AS REQ TO MAINTAIN 1 HR FRR.
- REMOVE EXISTING NON BEARING PARTITION IN ITS ENTIRETY (TYPICAL OF ALL WALLS SHOWN DASHED).
- REMOVE EXISTING BASE BOARD HEATERS. REFER TO MECHANICAL DRAWINGS. PATCH OPENINGS IN WALLS AND FLOORS AS REQ.
- EXISTING MECHANICAL SHAFT TO REMAIN.
- EXISTING LIFT TO REMAIN.
- REMOVE STAIR DOOR AND FRAME IN ITS ENTIRETY. PREP OPENING TO RECEIVE NEW INFILL WALL. REFER TO CONSTRUCTION PLAN FOR MORE DETAILS.
- EXISTING FIREPLACE. DECOMMISSION AND REMOVE ALL GAS LINES/ACCESSORIES. PREPARE BRICK FOR NEW PAINT.
- DEMOLISH BULKHEAD BELOW EXISTING WOOD CEILING. THIS LOCATION. PATCH AND REPAIR UNDERSIDE OF BULKHEAD TO RECEIVE NEW PAINT.
- PATCH AND REPAIR (E) 1 HR FRR WALL TO MAINTAIN 1 HR FRR CONSTRUCTION.
- REMOVE UNUSED LIFT CONTROLS AND RELOCATE PER ADA STANDARDS. REMOVE COVER PLATES TO BE REPLACED.

PARTITION NOTES

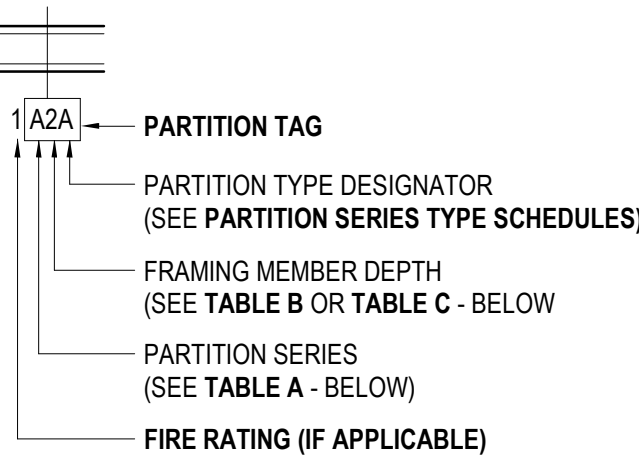


TABLE A- PARTITION SERIES CONSTRUCTION ASSEMBLY

SERIES	SHEATHING	FRAMING MEMBERS	SHEATHING
A	1-LAYER	METAL C-STUD	1-LAYER
B	2-LAYERS	METAL C-STUD	2-LAYERS
C	1-LAYER	METAL C-STUD	2-LAYERS
D	1-LAYER	METAL C-STUD	NONE
E	2-LAYERS	METAL C-STUD	NONE
F	1-LAYER	MTL HAT CHANNEL	NONE
G	1-LAYER	NONE	NONE
H	1-LAYER	METAL C-H STUD	NONE
J	2-LAYERS	METAL C-H STUD	LINER PNL
K	1-LAYER	(2) METAL C-STUDS	1-LAYER
L	2-LAYERS	(2) METAL C-STUDS	2-LAYERS
M	NONE	CMU	NONE
N-U	RESERVED FOR FUTURE EXPANSION		
V-Z	CUSTOM	N/A	N/A

TABLE B- FRAMING DEPTH SCHEDULE

TAG NUMBER	MTL STUD DESIGNATION	MTL C-H STUD DEPTH	WOOD STUD DEPTH
-	NO FRAMING		
0	7/8" FURRING CHANNEL	N/A	N/A
1	1 5/8"	N/A	N/A
2	2 1/2"	2 1/2"	N/A
3	3 5/8"	N/A	N/A
4	4"	4"	3 1/2"
6	6"	6"	5 1/2"
8	8"	N/A	7 1/4"
10	10"	N/A	9 1/4"

TABLE C- MASONRY WIDTH SCHEDULE

TAG NUMBER	CMU WIDTH
4	3 5/8"
6	5 5/8"
8	7 5/8"
10	9 5/8"
12	11 5/8"

STEEL SHEET THICKNESS FOR STUDS AND RUNNERS

GAUGE# MIN. STEEL BASE METAL THICKNESS (UNCOATED)

INCH	MILS	MM
12	0.0107	97
14	0.0713	68
16	0.0566	54
18	0.0451	43
20	0.0312	30
22	0.0270	27
25	0.0179	18


\*GAUGE 16, 18 USED FOR STRUCTURAL FRAMING; 20, 22, AND 25 USED FOR NON-STRUCTURAL FRAMING

\*USE OF DIMPLED STEEL STUDS ACCEPTABLE PROVIDED CONTRACTOR SUPPLIES DOCUMENTATION PROVING THE EQUIVALENT MINIMUM BASE METAL THICKNESS IS ACHIEVED

GENERAL NOTES

- GN-01. PARTITION TYPES ARE NOT SEQUENTIAL.
- GN-02. ALL PARTITION SHEATHING TO BE 5/8" GYPSUM BOARD UNLESS OTHERWISE NOTED.
- GN-03. REFER TO 109.02 SERIES FOR TOP OF PARTITION AND 109.02 SERIES FOR BOTTOM OF PARTITION CONDITIONS LISTED IN PARTITION SCHEDULE
- GN-04. ALL PARTITIONS SHALL BE COORDINATED WITH SCHEDULED FINISHES FOR PARTITION LAYOUT AND REQUIRED CLEARANCES.
- GN-05. PROVIDE BLOCKING IN PARTITIONS FOR ARTWORK HANGING AS INDICATED. SEE CONSTRUCTION PLANS(S) AND/ OR INTERIOR ELEVATIONS FOR LOCATIONS.
- GN-06. FOR INTERIOR FRAMING LIMITING HEIGHTS REFER TO SSMA TABLES FOR INTERIOR NON-STRUCTURAL NON-COMPOSITE PARTITIONS
- GN-07. CONTRACTOR TO RE-CONFIRM STUD SIZING AND SUBMIT SELECTION CRITERIA FOR REVIEW INCLUDING DELINEATION OF SLAB TO UNDERSIDE OF SLAB INFORMATION
- GN-08. ALL STUD CAVITIES TO HAVE ACOUSTICAL BATT INSULATION AS MINIMUM. WALLS NOT IDENTIFIED IN SCHEDULE AS HAVING INSULATION TO HAVE MINIMUM THICKNESS OF ACOUSTICAL INSULATION (1 5/8" STUD = 1" INSULATION, 3 5/8" STUD = 3 1/2" INSULATION, 6" STUD = 5 1/2" INSULATION). REFER TO SCHEDULE TO PROVIDE INSULATION CRITERIA EXCEEDING THIS MINIMUM.

KEY PLAN

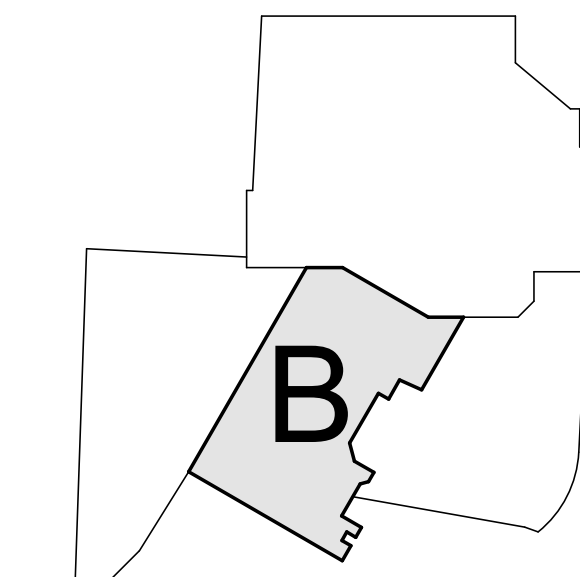

ALTRERA east west partners

2305 Mount Werner Circle  
Steamboat Springs, CO 80487

Gensler

1225 17th Street  
Suite 150  
Denver, CO 80202  
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United States  
Tel 303.421.6655



Seal / Signature

Date Description  
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Project Name

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003.7835.002

Description

DEMOLITION PLAN AND SCHEDULES

Scale

As indicated


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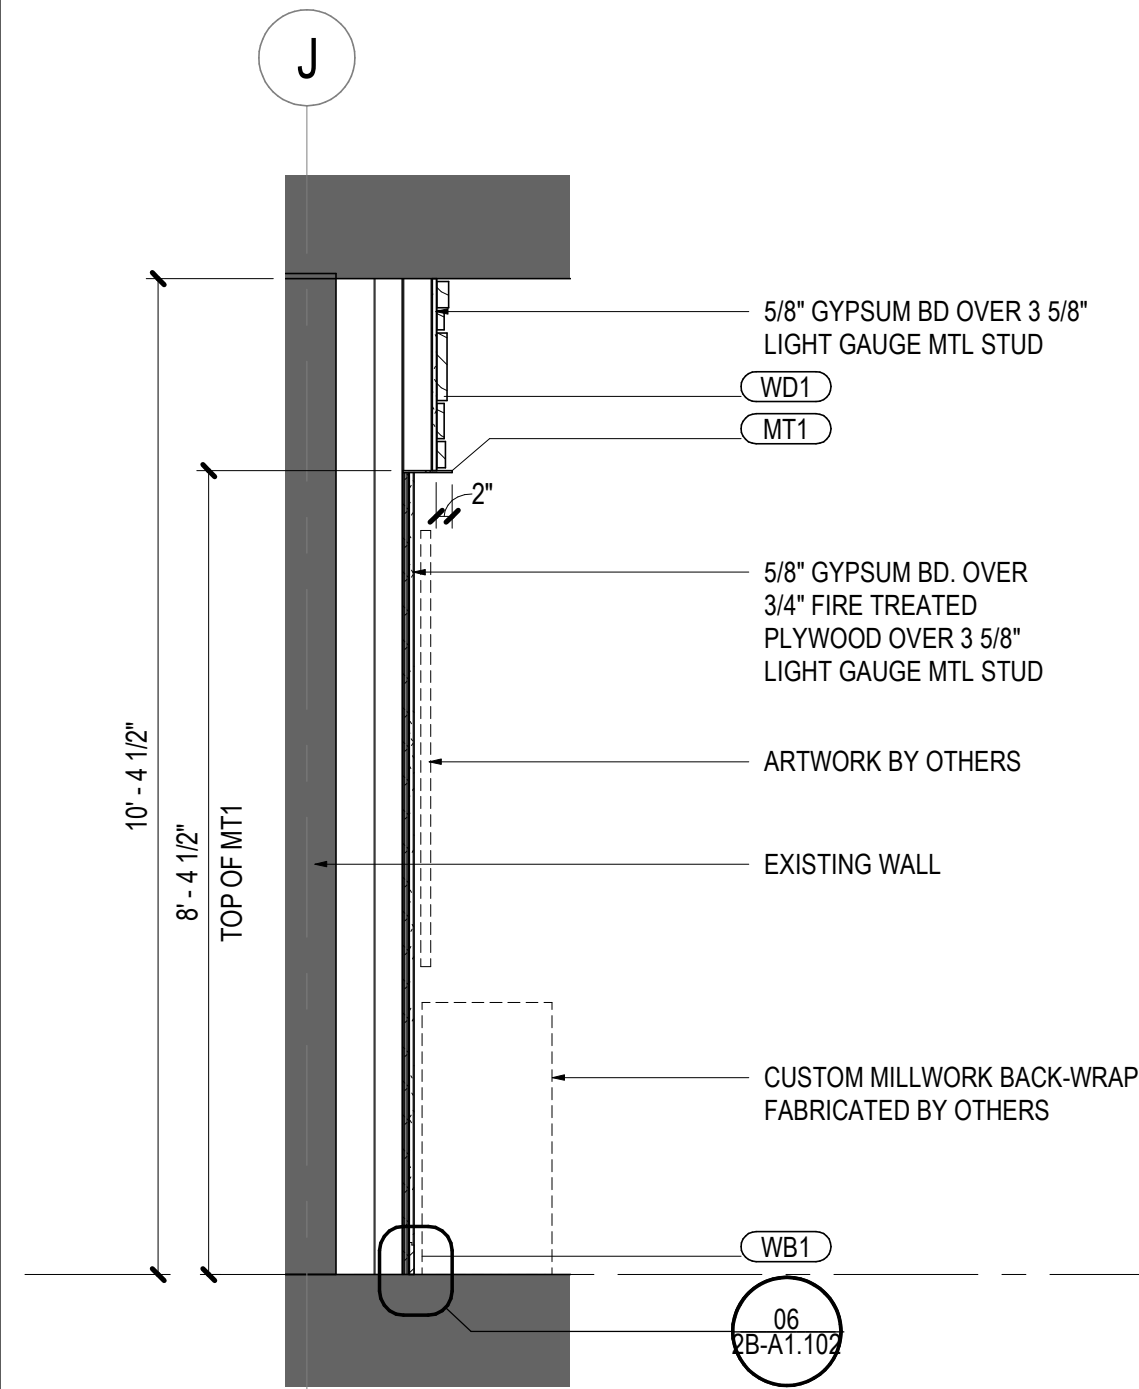










09 3 CABINET DOOR  
SCALE: 1 1/2" = 1'-0"

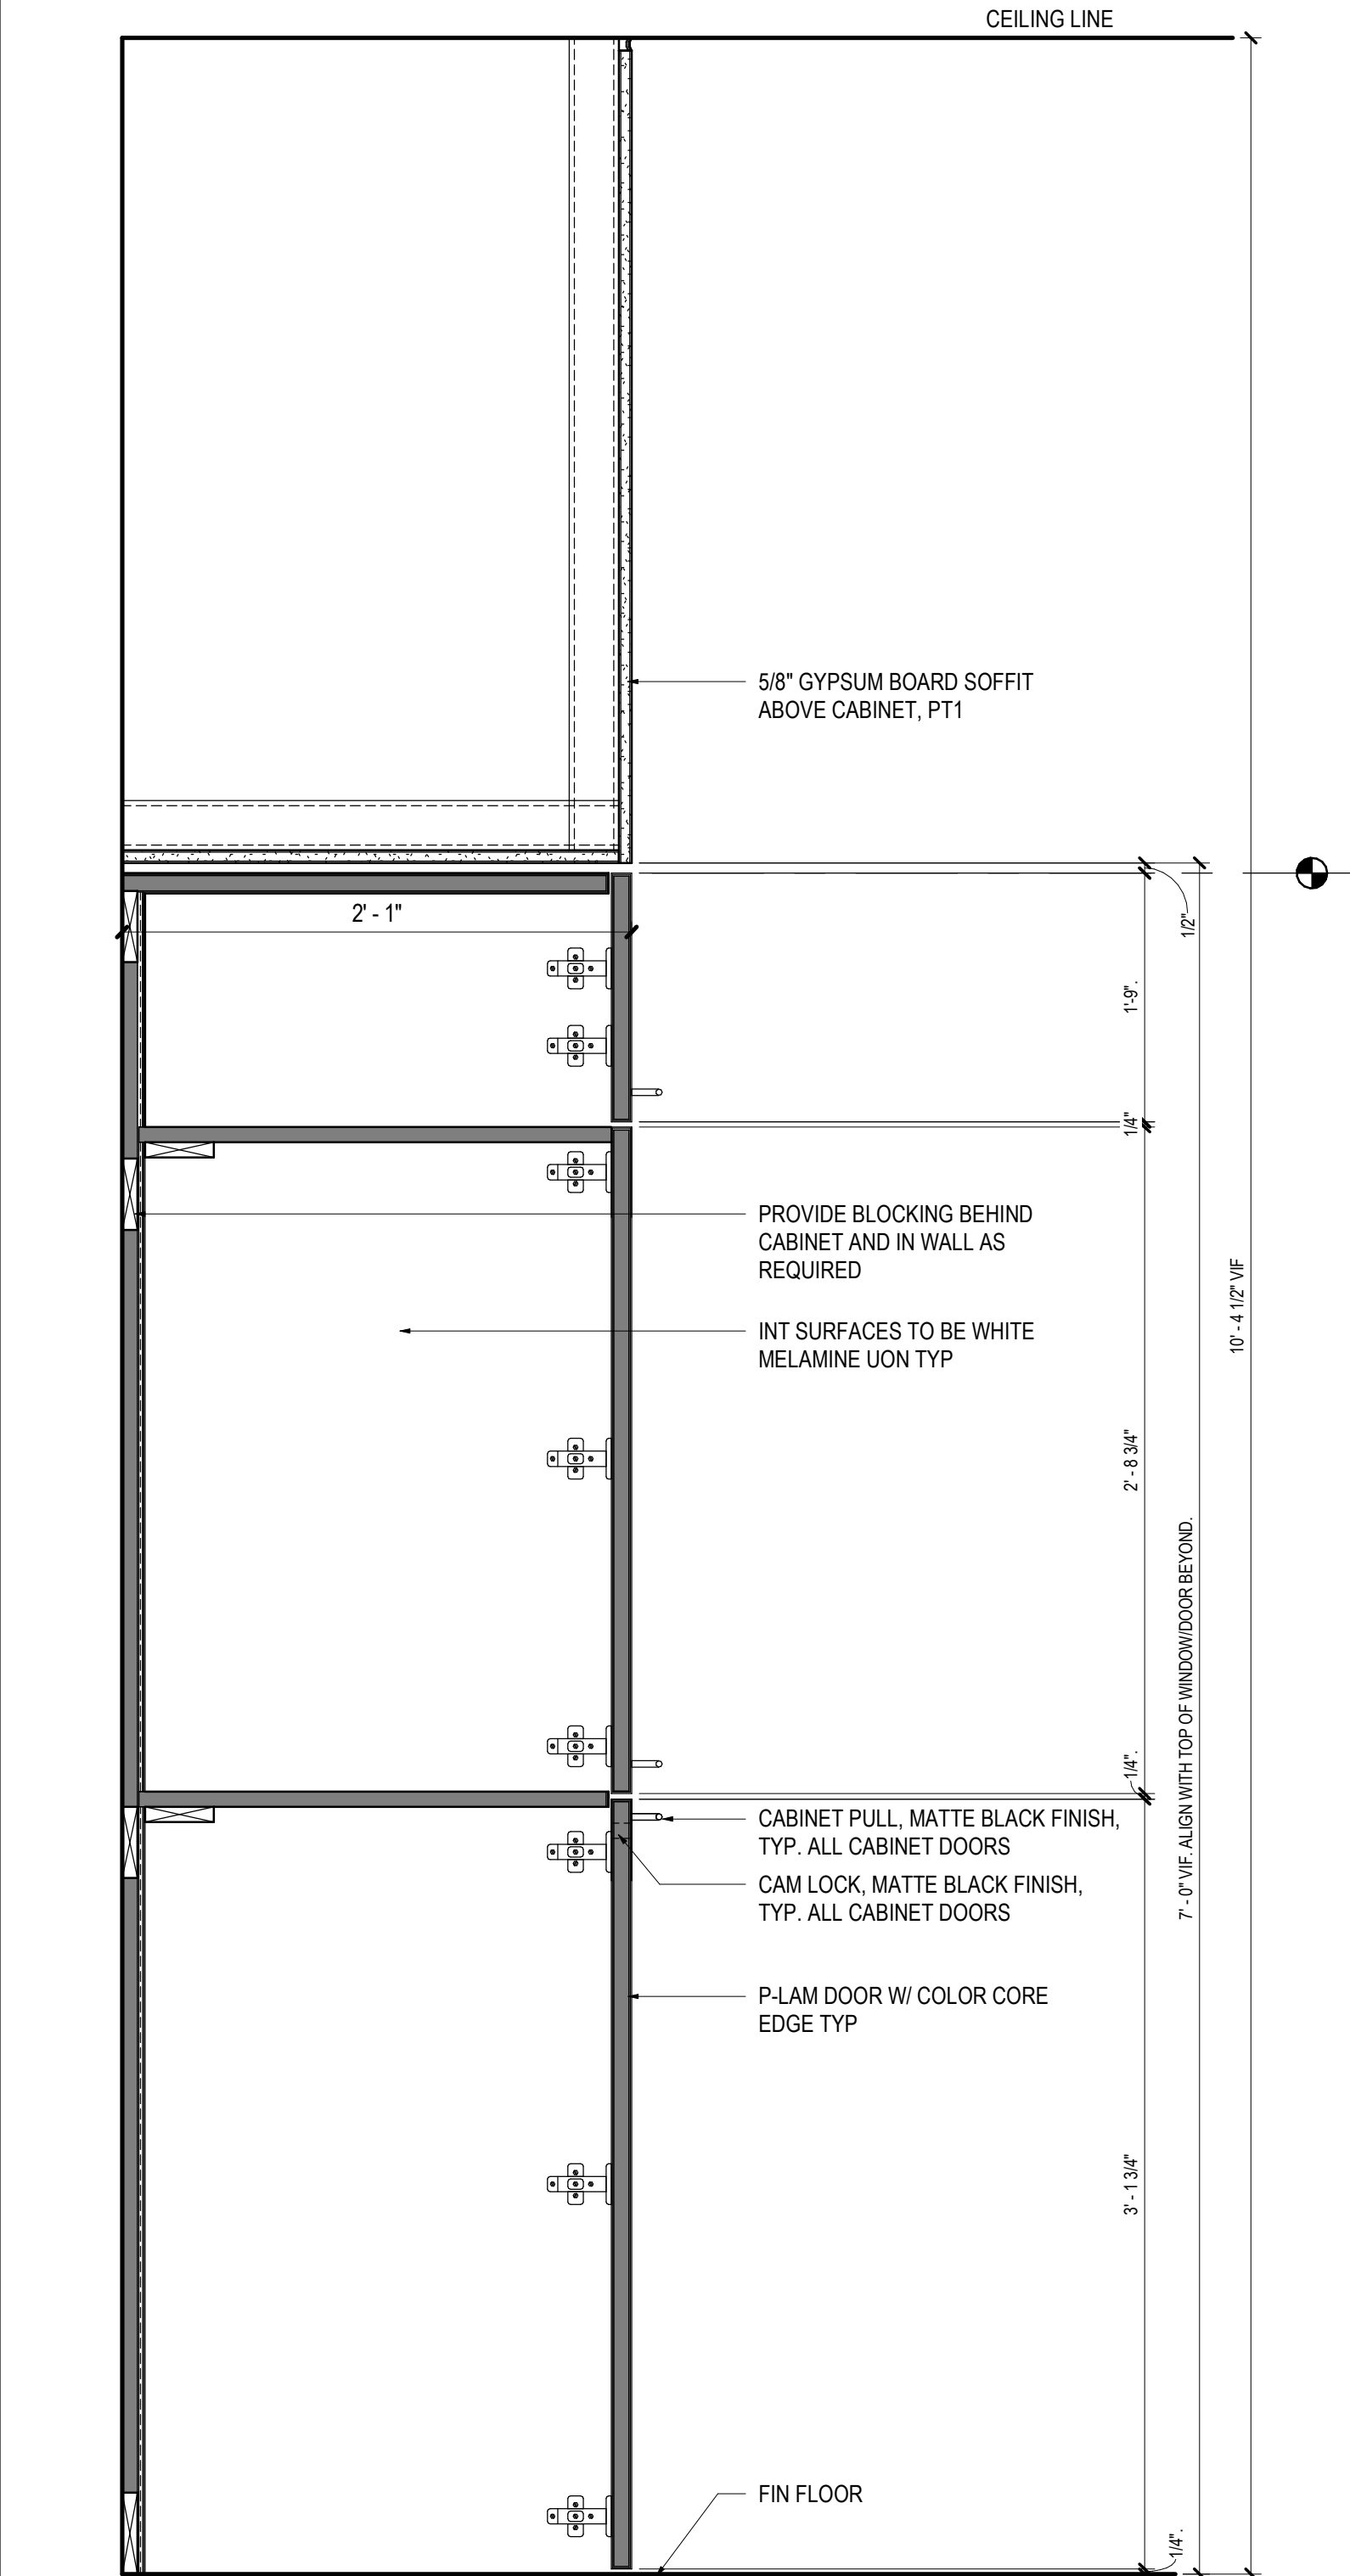


08 SECTION @ BACK-WRAP  
SCALE: 1/2" = 1'-0"

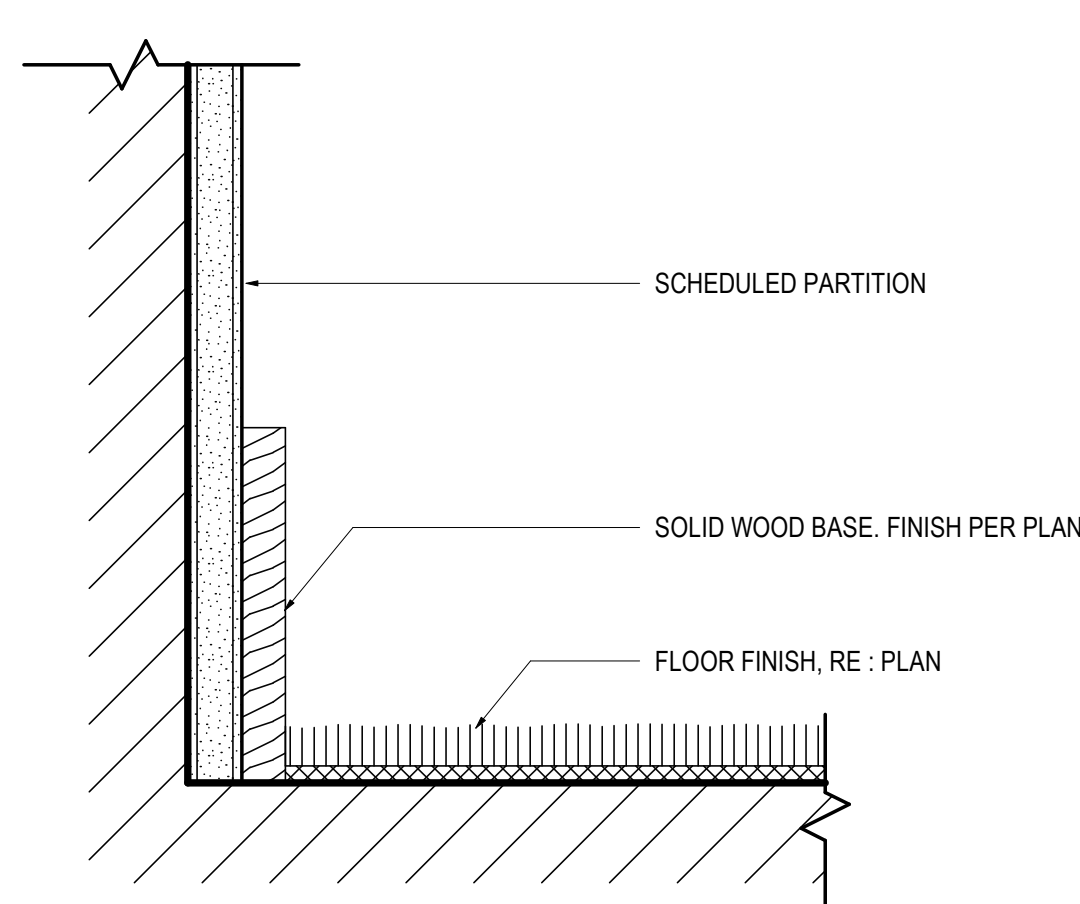


06 WOOD WALL BASE  
SCALE: 6" = 1'-0"

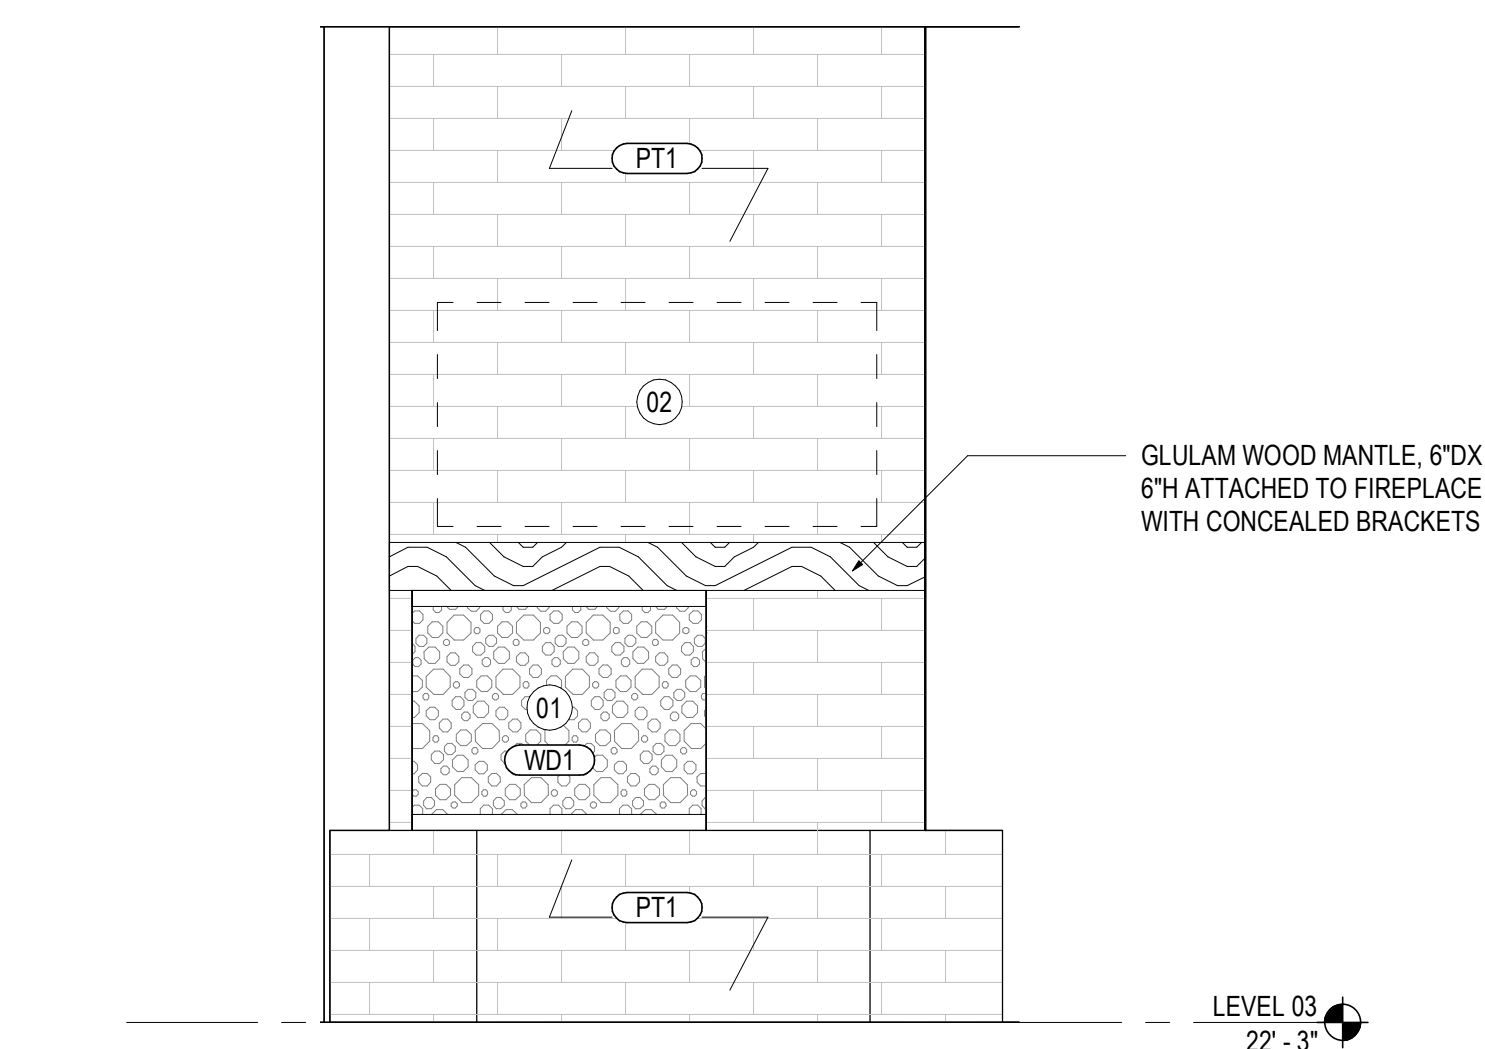


04 INTERIOR ELEVATION - FIRE PLACE  
SCALE: 1/2" = 1'-0"

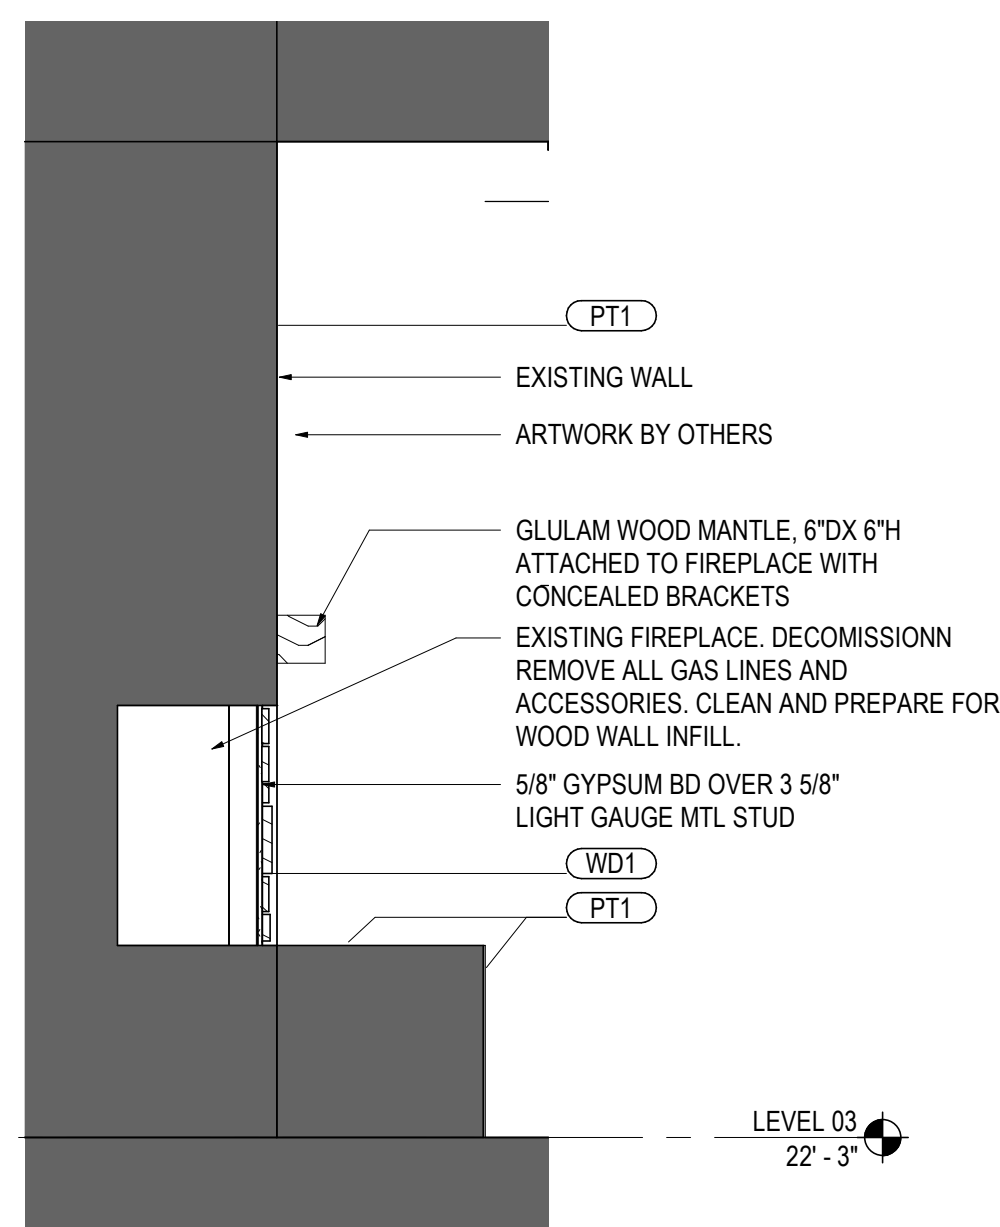


07 SECTION @ FIREPLACE  
SCALE: 1/2" = 1'-0"

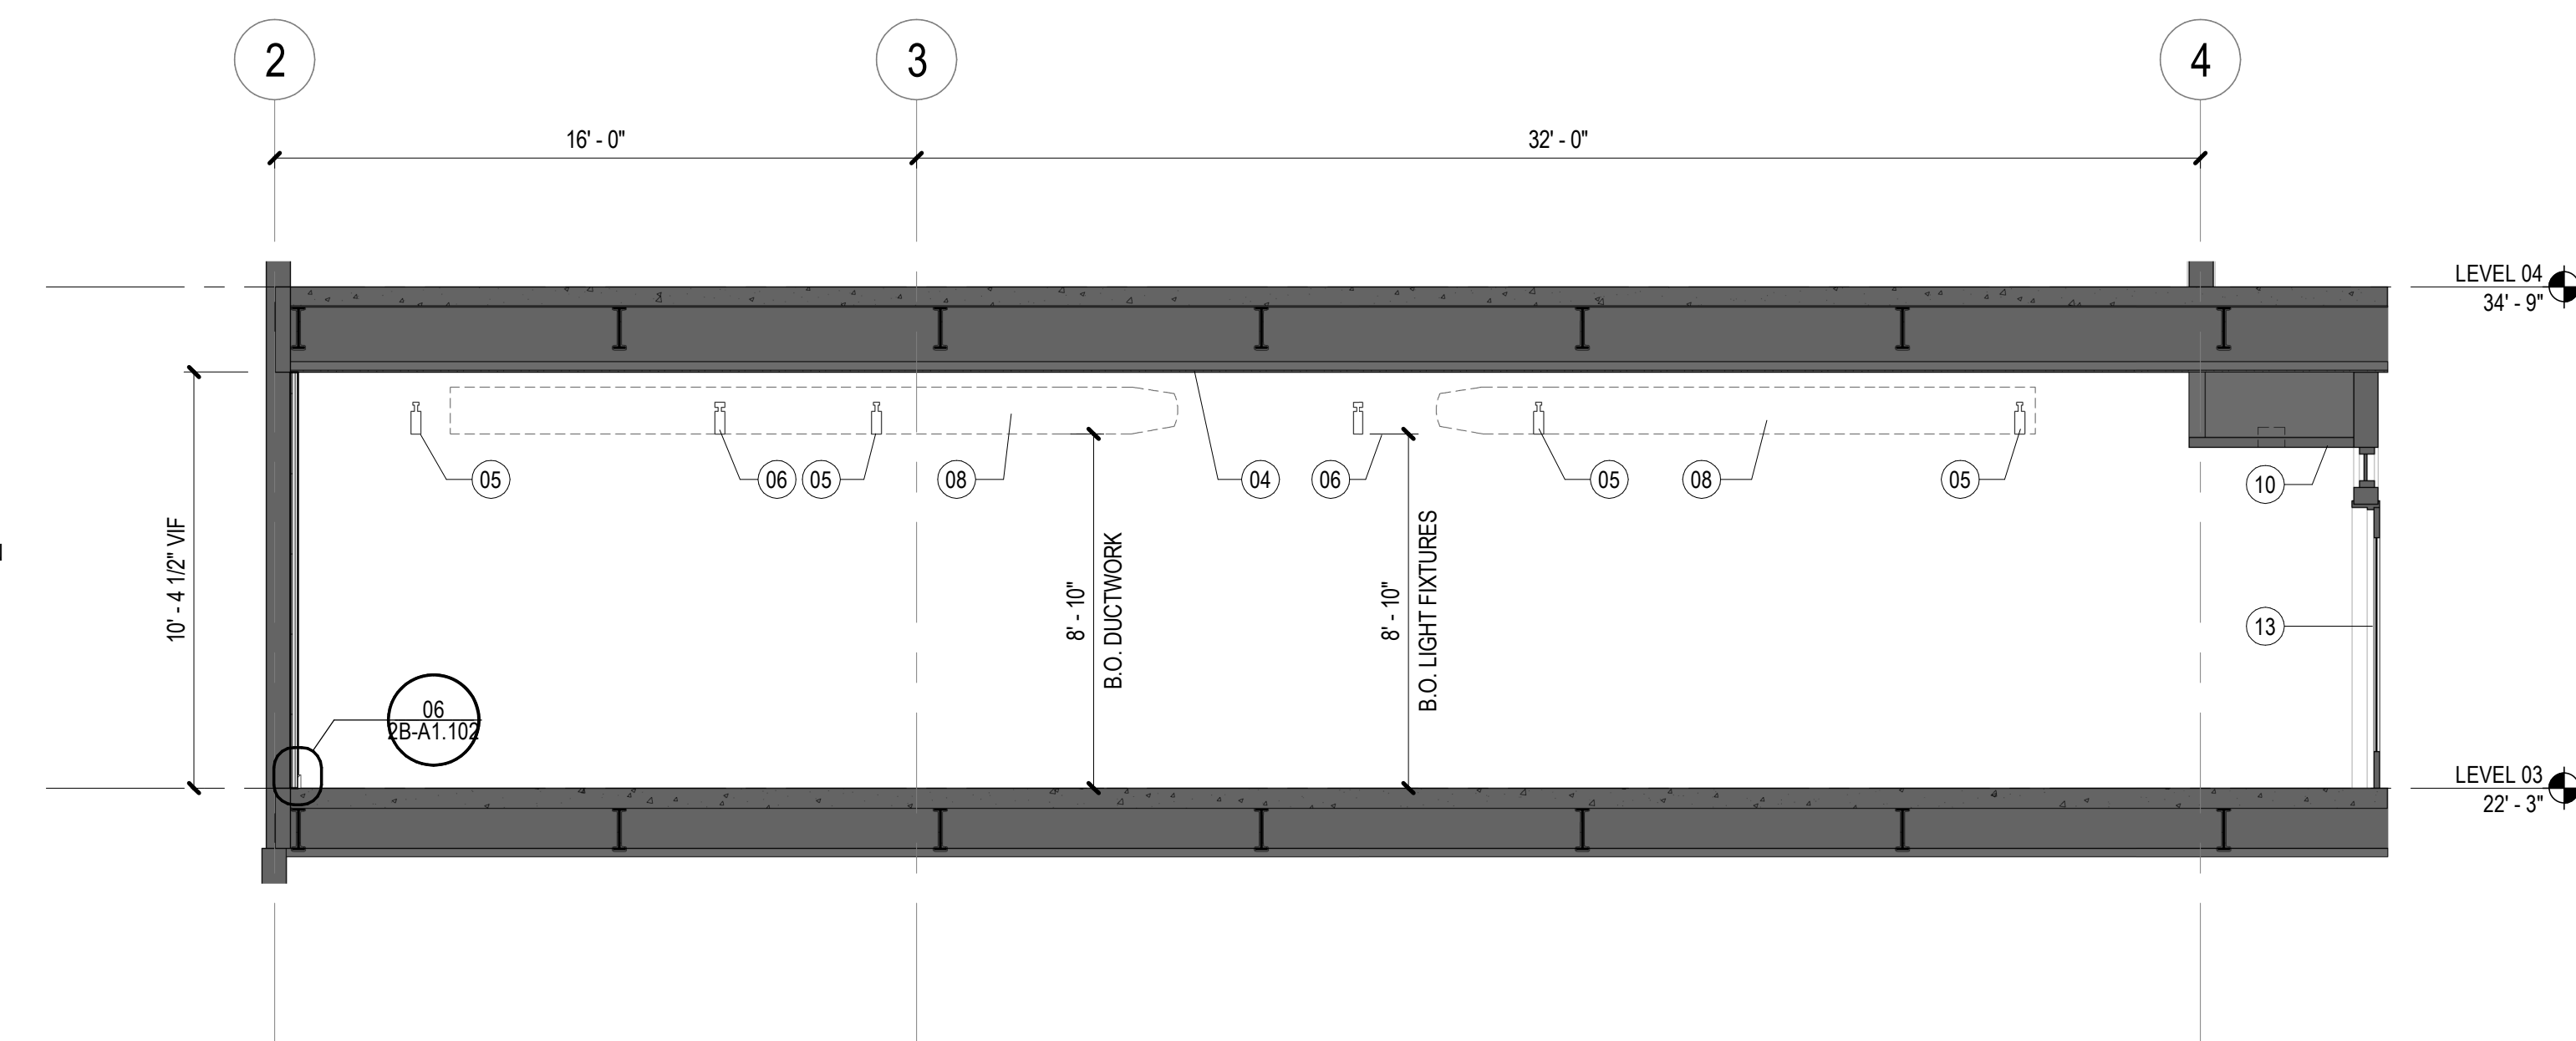


01 SECTION - RETAIL  
SCALE: 1/4" = 1'-0"

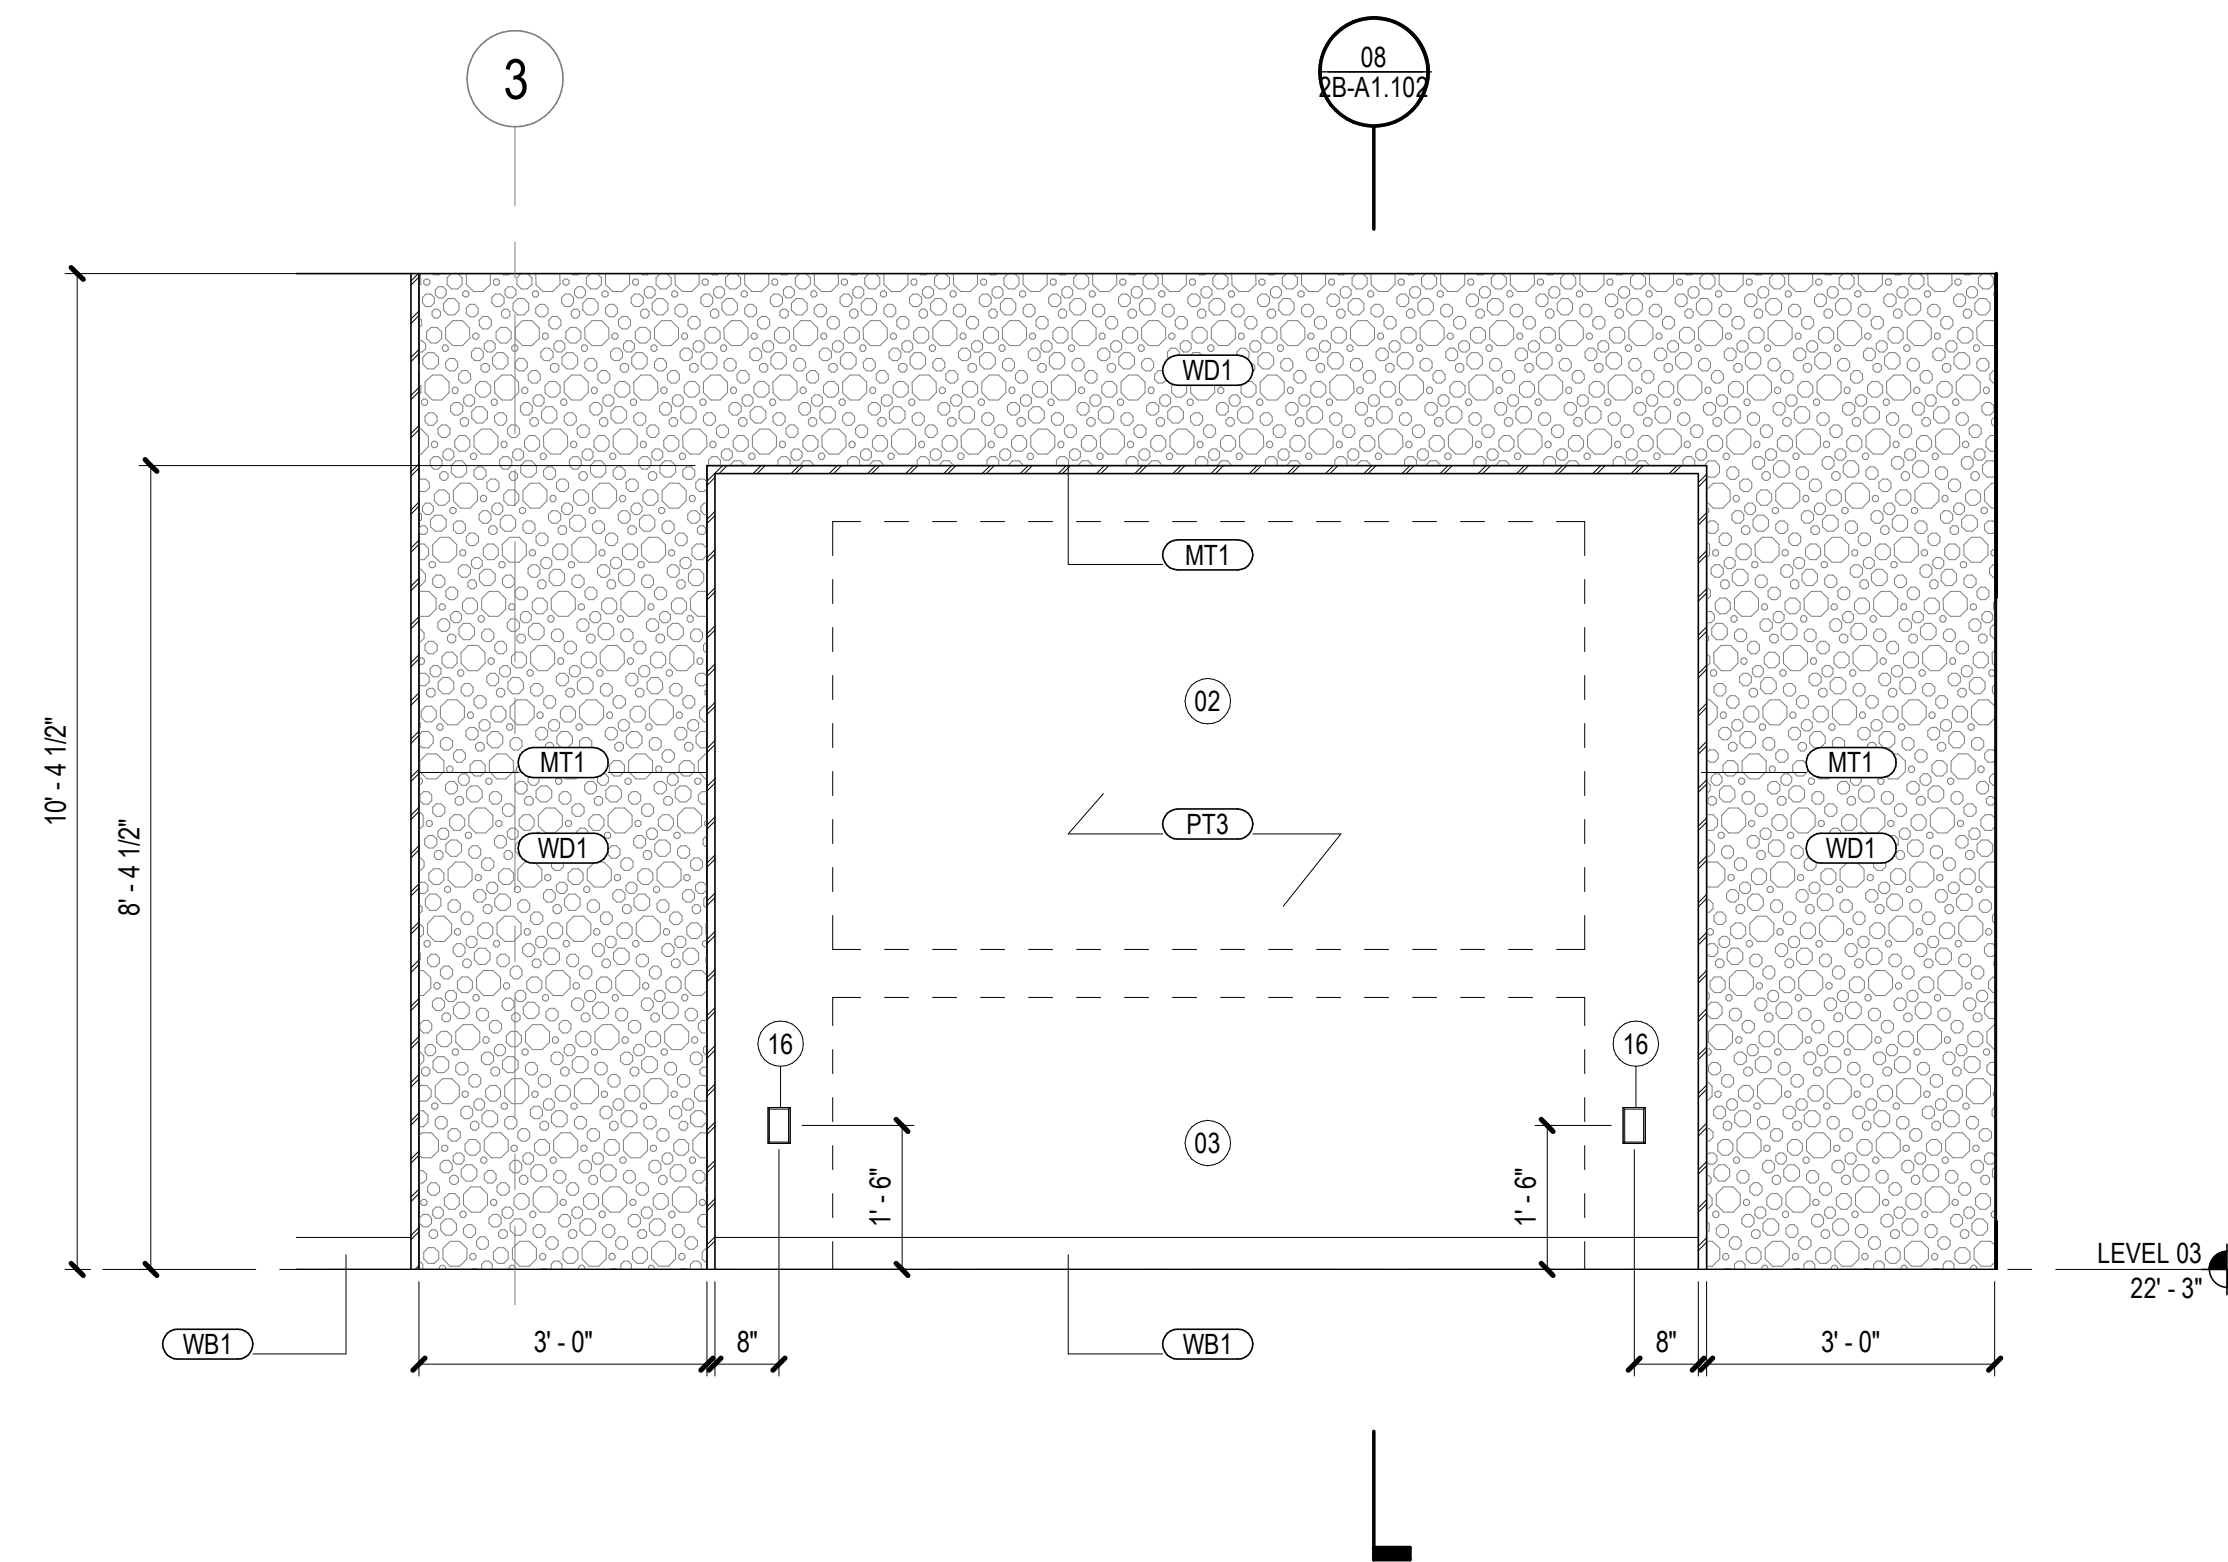

02 INTERIOR ELEVATION - BACK-WRAP WALL  
SCALE: 1/2" = 1'-0"

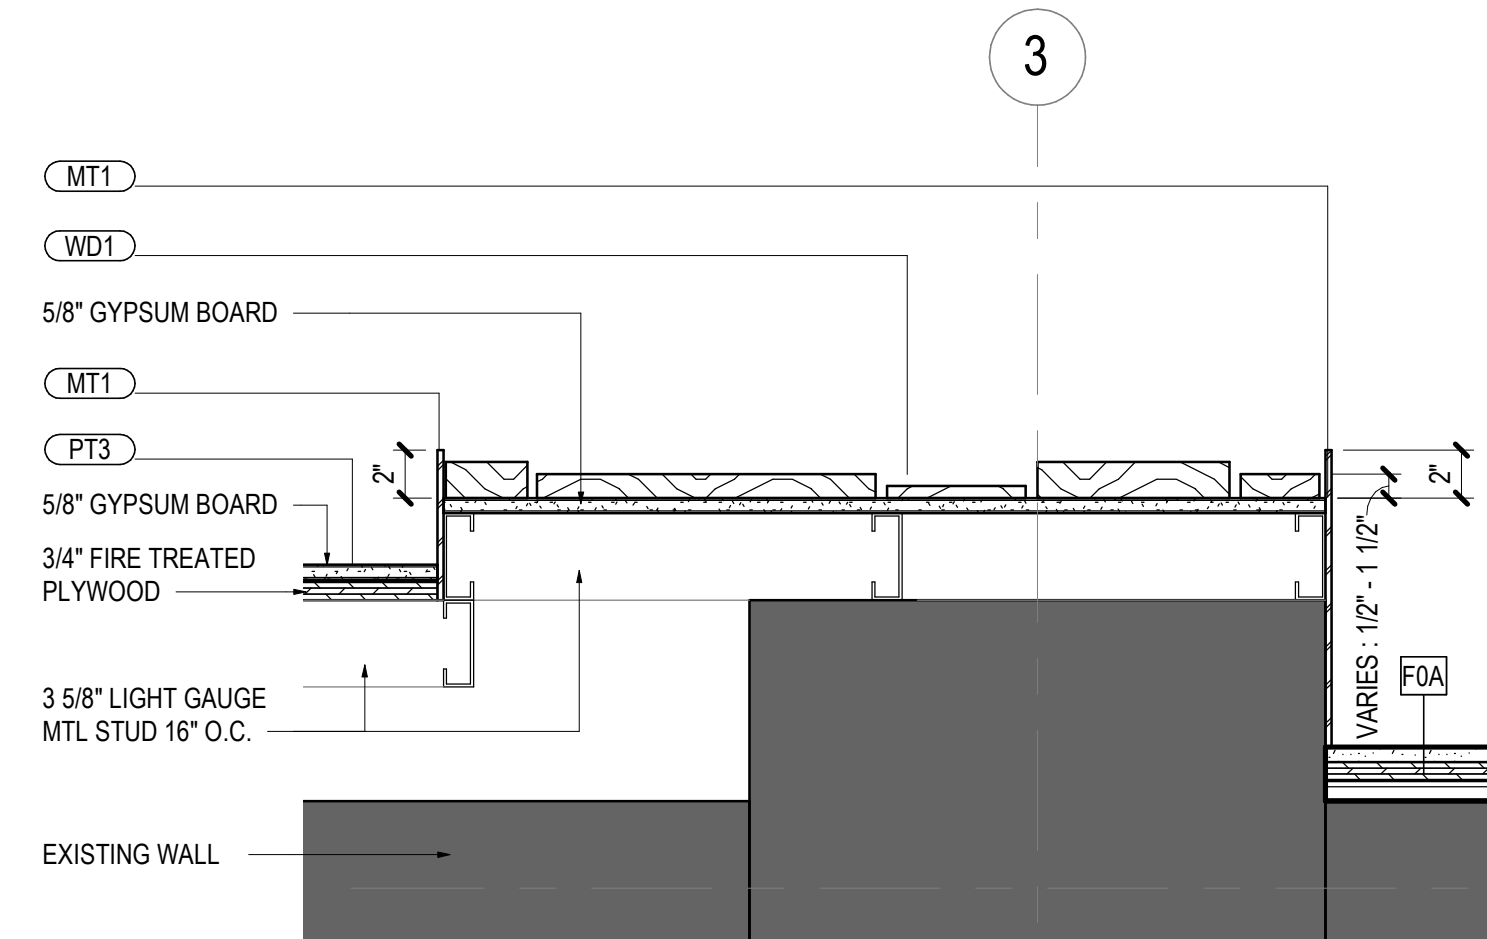

05 PLAN DETAIL - BACK-WRAP WALL  
SCALE: 1 1/2" = 1'-0"

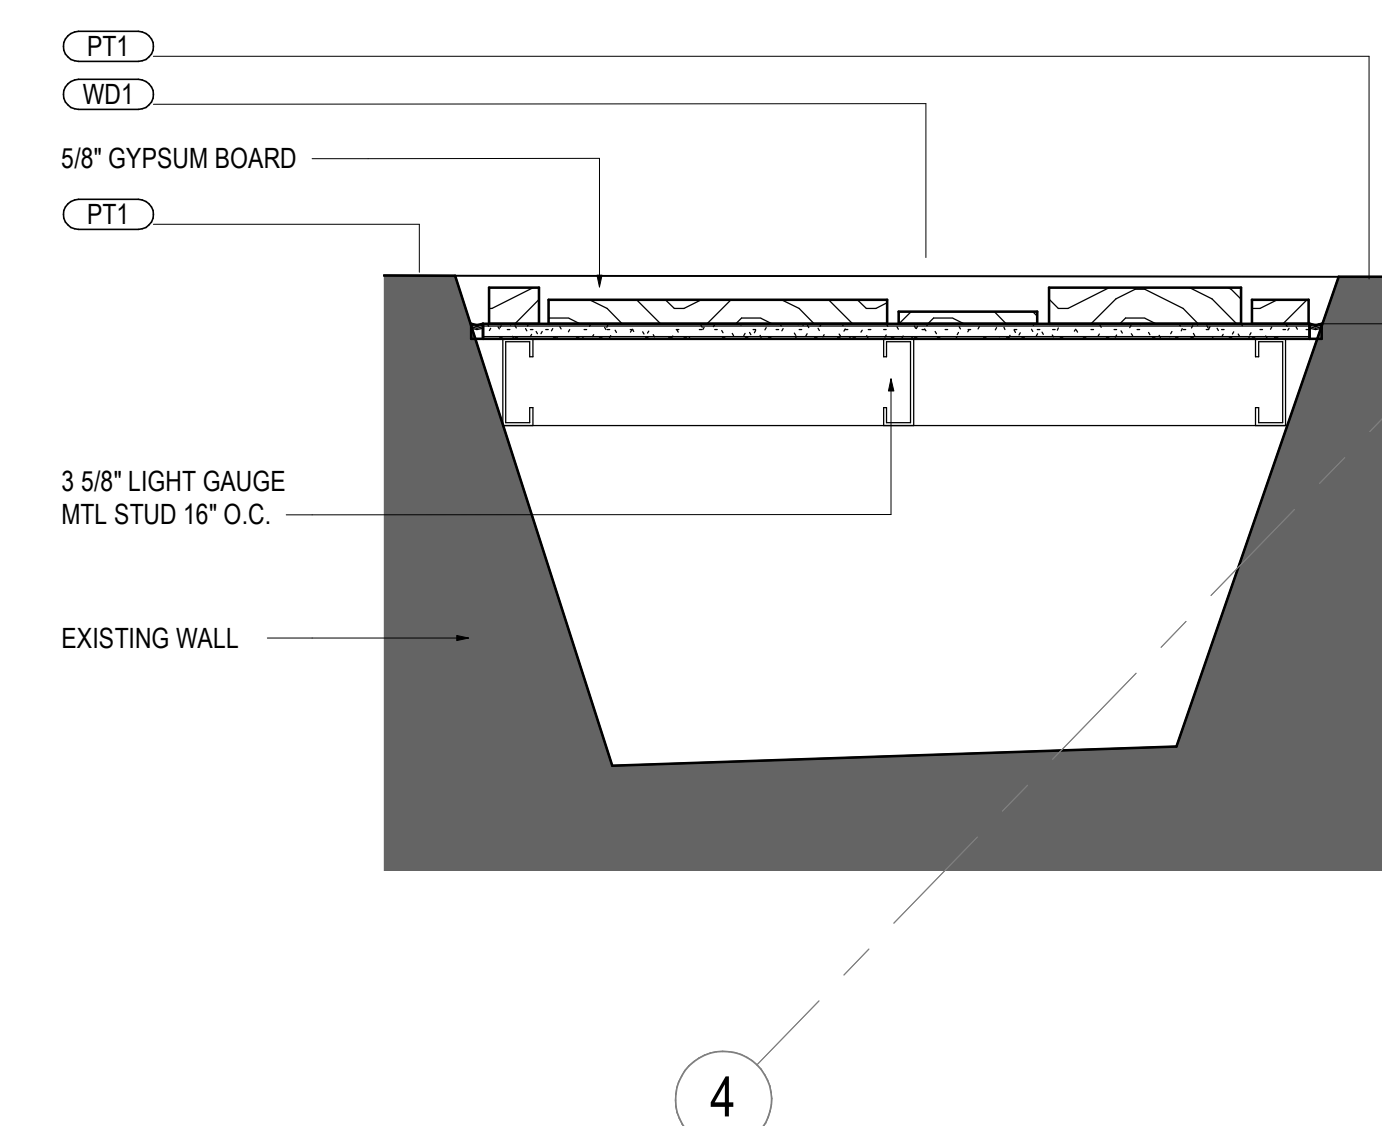

03 PLAN DETAIL - FIREPLACE  
SCALE: 1 1/2" = 1'-0"

## SHEET NOTES

- 01 EXISTING FIREPLACE. DECOMMISSION AND REMOVE ALL GAS LINES/ACCESSORIES. PAINT BRICK PTZ. INFILL OPENING WITH WD1.
- 02 ARTWORK BY OTHERS
- 03 CUSTOM MILLWORK BACK-WRAP. TO BE FABRICATED BY OTHERS.
- 04 EXISTING RATED CEILING TO REMAIN. PATCH AND REPAIR (E) 1 HR FRR GWB CEILING AS REQUIRED TO MAINTAIN 1 HR FRR. FINISH TO BE PT1
- 05 HANGING TRACK LIGHT. MOUNT LIGHT AS HIGH AS POSSIBLE UNDER MEP AND SPRINKLERS. GC TO VERIFY EXISTING CONDITIONS IN FIELD AND COORDINATE HEIGHT WITH ARCHITECT. RE: MEP
- 06 PENDANT LIGHT WITH SURFACE MOUNTED JUNCTION BOX. MOUNT LIGHT AS HIGH AS POSSIBLE UNDER MEP AND SPRINKLERS. GC TO VERIFY EXISTING CONDITIONS IN FIELD AND COORDINATE HEIGHT WITH ARCHITECT. RE: MEP
- 08 EXPOSED DUCTWORK. MOUNT TIGHT TO CEILING. RE: MEP
- 10 EXISTING WOOD CEILING TO REMAIN. PAINT PT1
- 13 EXISTING EXTERIOR DOORS AND WINDOWS. PAINT WOOD FRAME PT1
- 16 POWER OUTLET AND COVER PLATE. FINISH TO BE BLACK AT BACK-WRAP WALL ONLY

## GENERAL NOTES

**Steamboat**  
ALTRERRA east west partners  
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Seal / Signature

Date	Description
1 05/20/2022	ISSUE FOR CONSTRUCTION

## NOT FOR CONSTRUCTION

Project Name	SSRC   BASE AREA IMPROVEMENTS
Project Number	003.7835.002
Description	INTERIOR ELEVATIONS & DETAILS

Scale  
As indicated

2B-A1.102