

STEAMBOAT SKI & RESORT CORPORATION

SSRC | BASE AREA IMPROVEMENTS

2305 Mount Werner Circle
Steamboat Springs, CO 80487

Building A: Retail - ISSUE FOR CONSTRUCTION

2022.05.20

PROJECT INFORMATION

FOLLOWING ARE THE PLANS OUTLINING THE SCOPE OF WORK REQUIRED FOR THE NEW CONSTRUCTION AND RENOVATION OF THE STEAMBOAT BASE VILLAGE.

THE WORK OF PROJECT IS DEFINED BY THE CONTRACT DOCUMENTS. THE WORK IS TO INCLUDE THE INTERIOR RENOVATION OF THE EXISTING BUILDING A STORAGE SPACE TO CREATE A NEW MERCANTILE OCCUPANCY RETAIL SPACE.

THE WORK WILL INCLUDE NEW PARTITIONS, CEILINGS, FINISHES, MECHANICAL, AND ELECTRICAL. NO EXTERIOR RENOVATIONS ARE INCLUDED IN THIS PROJECT.

THE DRAWINGS, IN CONCERT WITH THE PROJECT MANUAL, COMPRISE THE CONTRACT DOCUMENTS OUTLINING THE DESIGN INTENT AND PROJECT SCOPE, AND MAY BE SUPPLEMENTED BY FURTHER INFORMATION ISSUED BY ARCHITECT.

THE DRAWINGS ARE ARRANGED IN GENERAL TO SPECIFIC ORDER, FOLLOWING A TOP TO BOTTOM, RIGHT TO LEFT FORMAT. CONTRACTORS ARE ADVISED TO READ AND FAMILIARIZE THEMSELVES WITH THE INFORMATION IN THE PROJECT MANUAL, AS WELL AS THE GENERAL LEGENDS CONTAINED IN THE G SERIES OF DRAWINGS. PRIOR TO REVIEW OF THE PLANS, ELEVATIONS AND DETAILS, ADVISE THE ARCHITECT WHERE INTENT IS NOT CLEARLY PERCEIVED, PRIOR TO PROCEEDING WITH WORK.

BUILDING ADDRESS: 2305 MOUNT WERNER CIRCLE
STEAMBOAT SPRINGS, CO 80487

BUILDING JURISDICTION: ROUTT COUNTY, STEAMBOAT SPRINGS, COLORADO

APPLICABLE CODES: 2018 INTERNATIONAL BUILDING CODE
2018 INTERNATIONAL MECHANICAL CODE
2018 INTERNATIONAL PLUMBING CODE
2018 INTERNATIONAL FUEL GAS CODE
2018 INTERNATIONAL FIRE CODE
2020 NATIONAL ELECTRIC CODE
2018 INTERNATIONAL ENERGY CONSERVATION CODE
ASHRAE 90.1 2016
2009 ICC A117.1, ACCESSIBILITY REQUIREMENTS
2010 ADA ACCESSIBILITY GUIDELINES
ANSI/ASME A17.1, SAFETY CODE FOR ELEVATORS 2013
USEABLE BUILDING & FACILITIES CODE
STEAMBOAT SPRINGS AND ROUTT COUNTY CODE AMENDMENTS

OCCUPANCY TYPE: M-MERCANTILE, S-2 STORAGE

SEPARATED USE: NON SEPARATED MIXED OCCUPANCY

CONSTRUCTION TYPE: TYPE IIA

FIRE SUPPRESSION: FIRE RESISTIVE, (100% SPRINKLERED)

FIRE ALARM SYSTEM: FIRE ALARM AND SMOKE DETECTION SYSTEM PER IBC 907.2 & NFPA 72

DEFERRED SUBMITTALS: • FIRE ALARM SYSTEM
• FIRE SPRINKLER SYSTEM
• ACCESS CONTROL HARDWARE

NUMBER OF STORIES IN BUILDING: 4 STORIES (ABOVE GRADE)
1 STORY (BELOW GRADE)

TOTAL FLOOR AREA: 32,340 SF

SCOPE OF WORK AREA: 1,406 SF

LEED CERTIFICATION: NONE


PROJECT TEAM

CLIENT / OWNER: ALTRERA MOUNTAIN COMPANY REAL ESTATE DEVELOPMENT
3501 WAZEE STREET
DENVER, CO 80216
(303) 749 - 8200


ARCHITECT: GENSLER
1225 17TH STREET, SUITE 150
DENVER, CO 80202
(303) 595 - 8585

MECHANICAL / ELECTRICAL
/ PLUMBING ENGINEER: ME ENGINEERS
14143 DENVER WEST PKWY, SUITE 300
GOLDEN, CO 80401
(303) 421-6655

LOCATION MAP

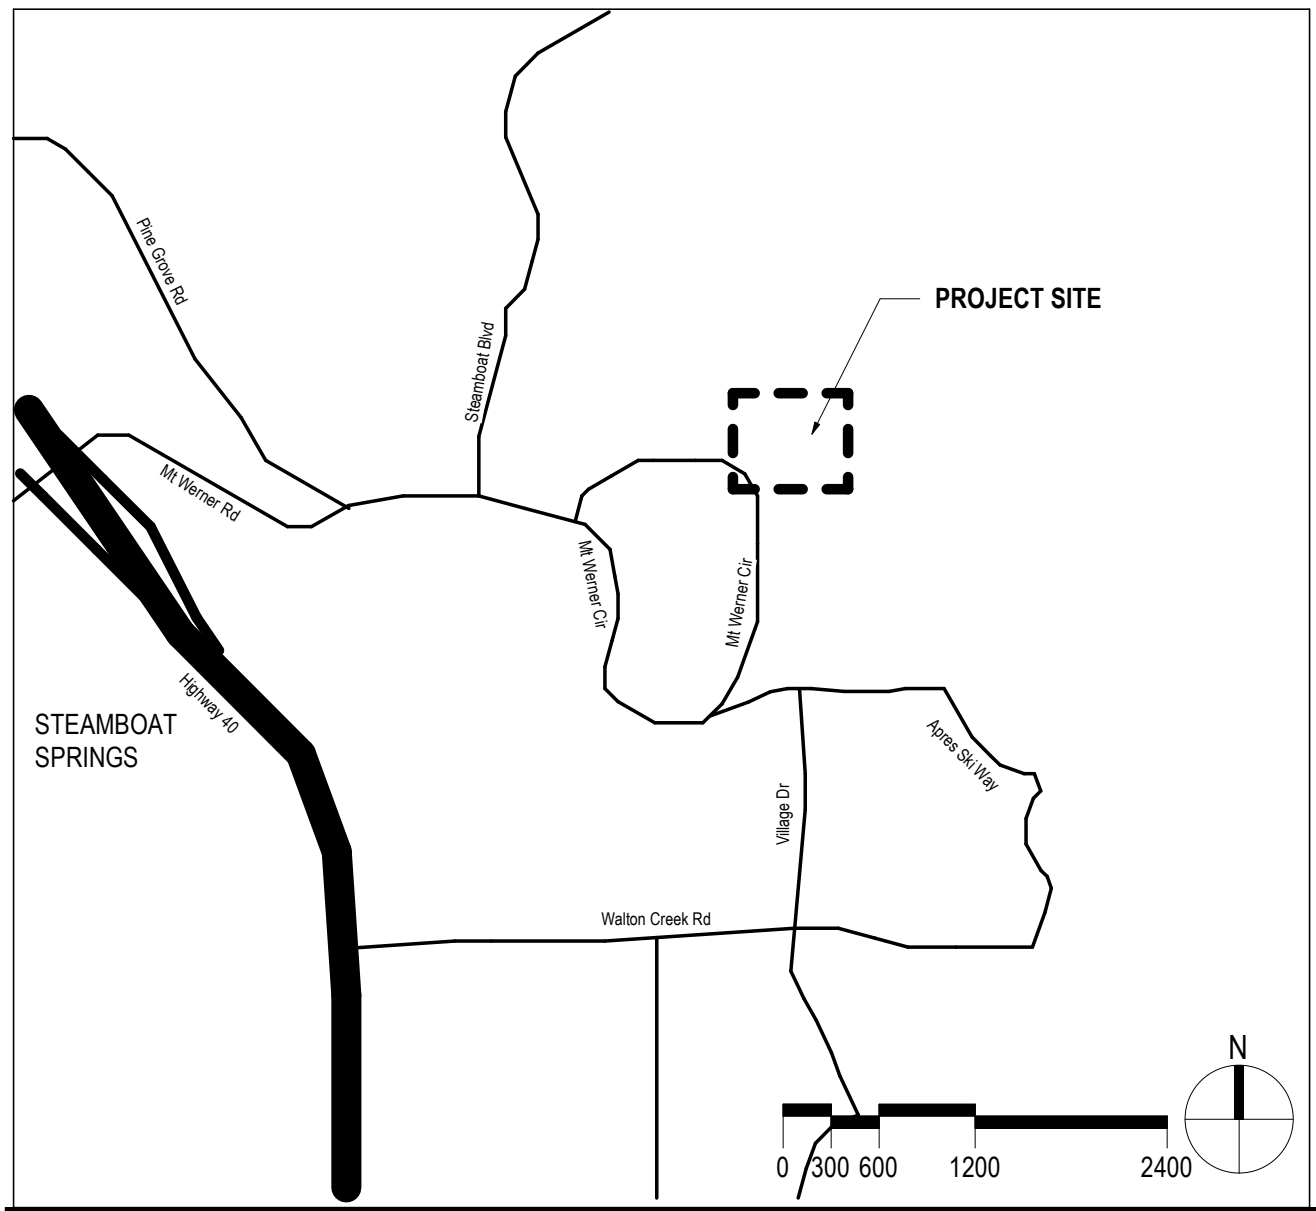

SITE PLAN

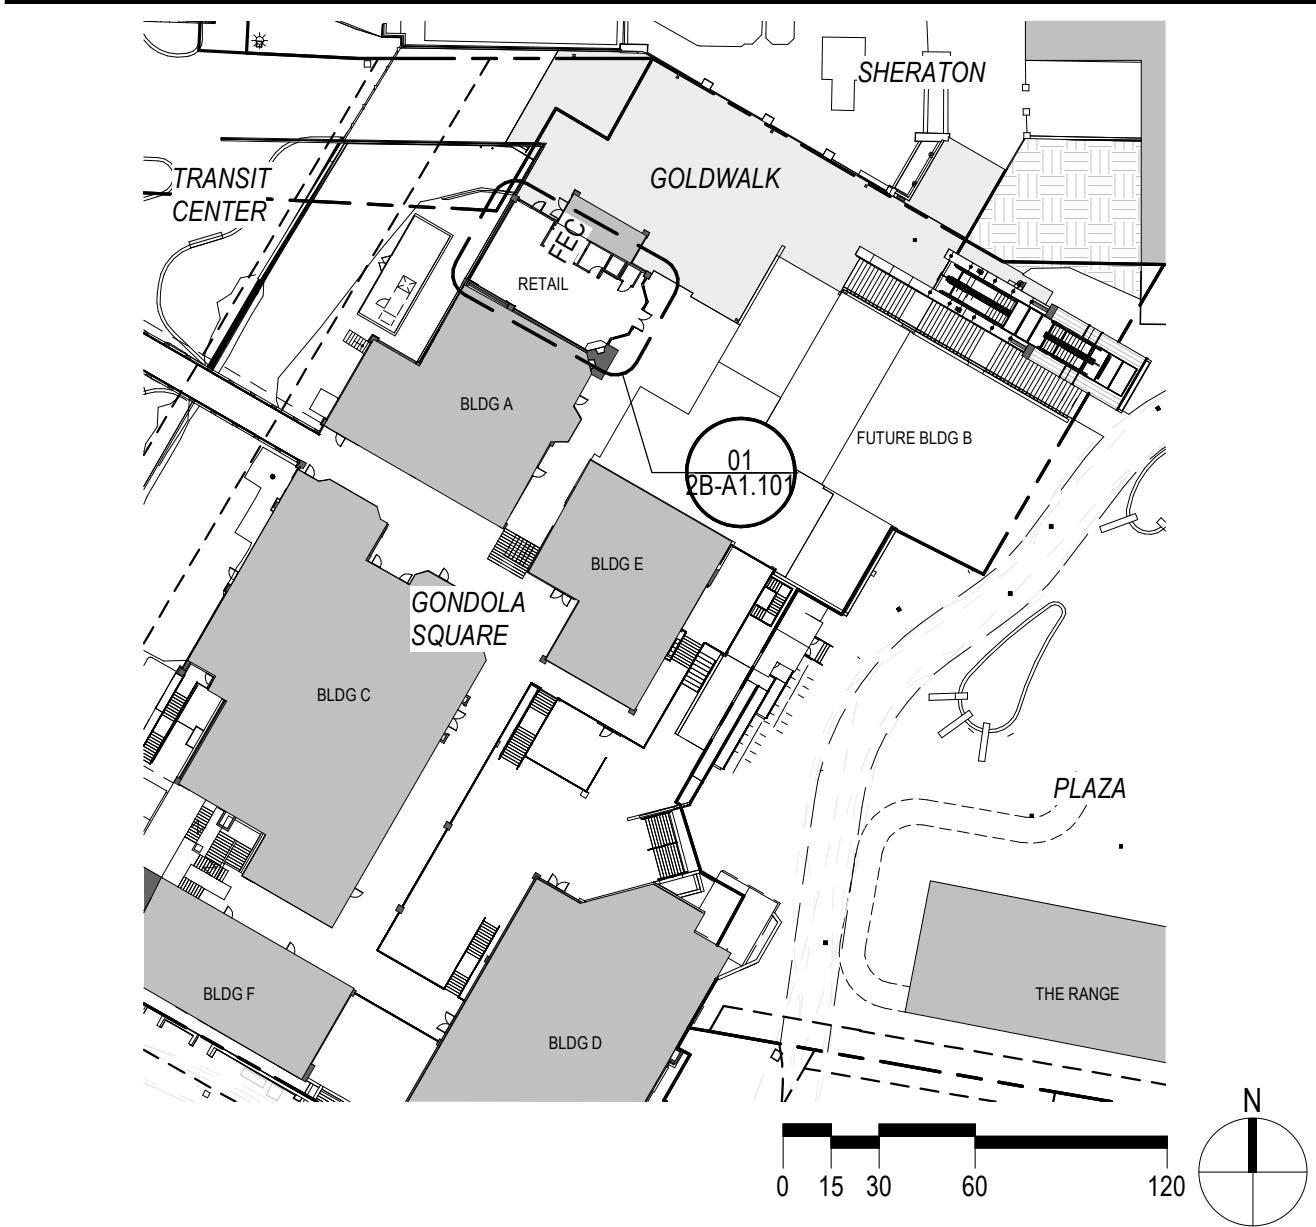


GRAPHIC SYMBOLS LEGEND	EGRESS REQUIREMENTS
EXIT ACCESS TRAVEL DISTANCE	TOTAL GROSS AREA OF TENANT - ENTIRE LEVEL: APPROX. 1,406 SF
COMMON PATH OF TRAVEL	TOTAL AREA IN SCOPE: APPROX. 1,406 SF
SECURITY LOCATIONS	TENANT OCCUPANT LOAD CALCULATIONS: MERCANTILE (60 GSF/PERSON): 22 OCCUPANTS STORAGE (300 GSF/PERSON): 1 OCCUPANTS
OCCUPANCY, FUNCTION OF SPACE	TOTAL: 23 OCCUPANTS
1HR FIRE BARRIER / 20MIN OPENINGS	EGRESS WIDTH REQUIREMENTS: OTHER EGRESS COMPONENTS: REQUIRED (1 IN/OCCUPANT): 3.45 INCHES PROVIDED AT EXIT DOORS: 108 INCHES
1HR FIRE BARRIER / 45MIN OPENINGS	EXIT STAIR WIDTH: REQUIRED (2 IN/OCCUPANT): NA PROVIDED AT EXIT STAIRS: NA
2HR FIRE BARRIER / 90MIN OPENINGS	MINIMUM WIDTH OF EGRESS CORRIDOR REQUIRED: 36 INCHES
3HR FIRE BARRIER	MINIMUM WIDTH OF EGRESS CORRIDOR PROVIDED: NA
FUNCTION LEGEND (OCCUPANT LOAD)	MINIMUM NUMBER OF EXITS REQUIRED: 1 EXITS
MERCANTILE	NUMBER OF EXITS PROVIDED: 2 EXITS
STORAGE	MAXIMUM LENGTH OF EGRESS TRAVEL: IBC TABLE 1017.2 FOOT/NOTE C 250 FEET (MERCANTILE)
GENERAL NOTES	MAXIMUM COMMON PATH OF TRAVEL: IBC 1006.2.1 FOOT/NOTE A 75 FEET (MERCANTILE)
SHEET NOTES	MAXIMUM DEAD END CORRIDOR: IBC 1020.4 EXCEPTION 2 50 FEET (MERCANTILE)
1. EGRESS ALLOWED IN DIRECTION OF EGRESS TRAVEL.	REMOVEDNESS OF EXITS: LONGEST DIAGONAL REMOVEDNESS OF EXITS: NA, SINGLE EXIT

PLUMBING FIXTURE REQUIREMENTS - LEVEL XX		
OCCUPANCY TOTALS	'M'	'S'
	22	1

FIXTURE QUANTITIES	REQUIRED 'M'	REQUIRED 'S'	TOTAL REQUIRED	PROVIDED
WATER CLOSETS				
MEN	11/500 = 0.022	.5/100 = 0.005	0.027	0"
WOMEN	11/500 = 0.022	.5/100 = 0.005	0.027	0"
LAVATORIES				
MEN	11/750 = 0.015	.5/100 = 0.005	0.020	0"
WOMEN	11/750 = 0.015	.5/100 = 0.005	0.020	0"
DRINKING FOUNTAINS	22/500 = 0.044	1/1000 = 0.001	0.045	0"

* PLUMBING FIXTURES REQUIRED ARE TO BE PROVIDED IN FUTURE BUILDING B WORK.

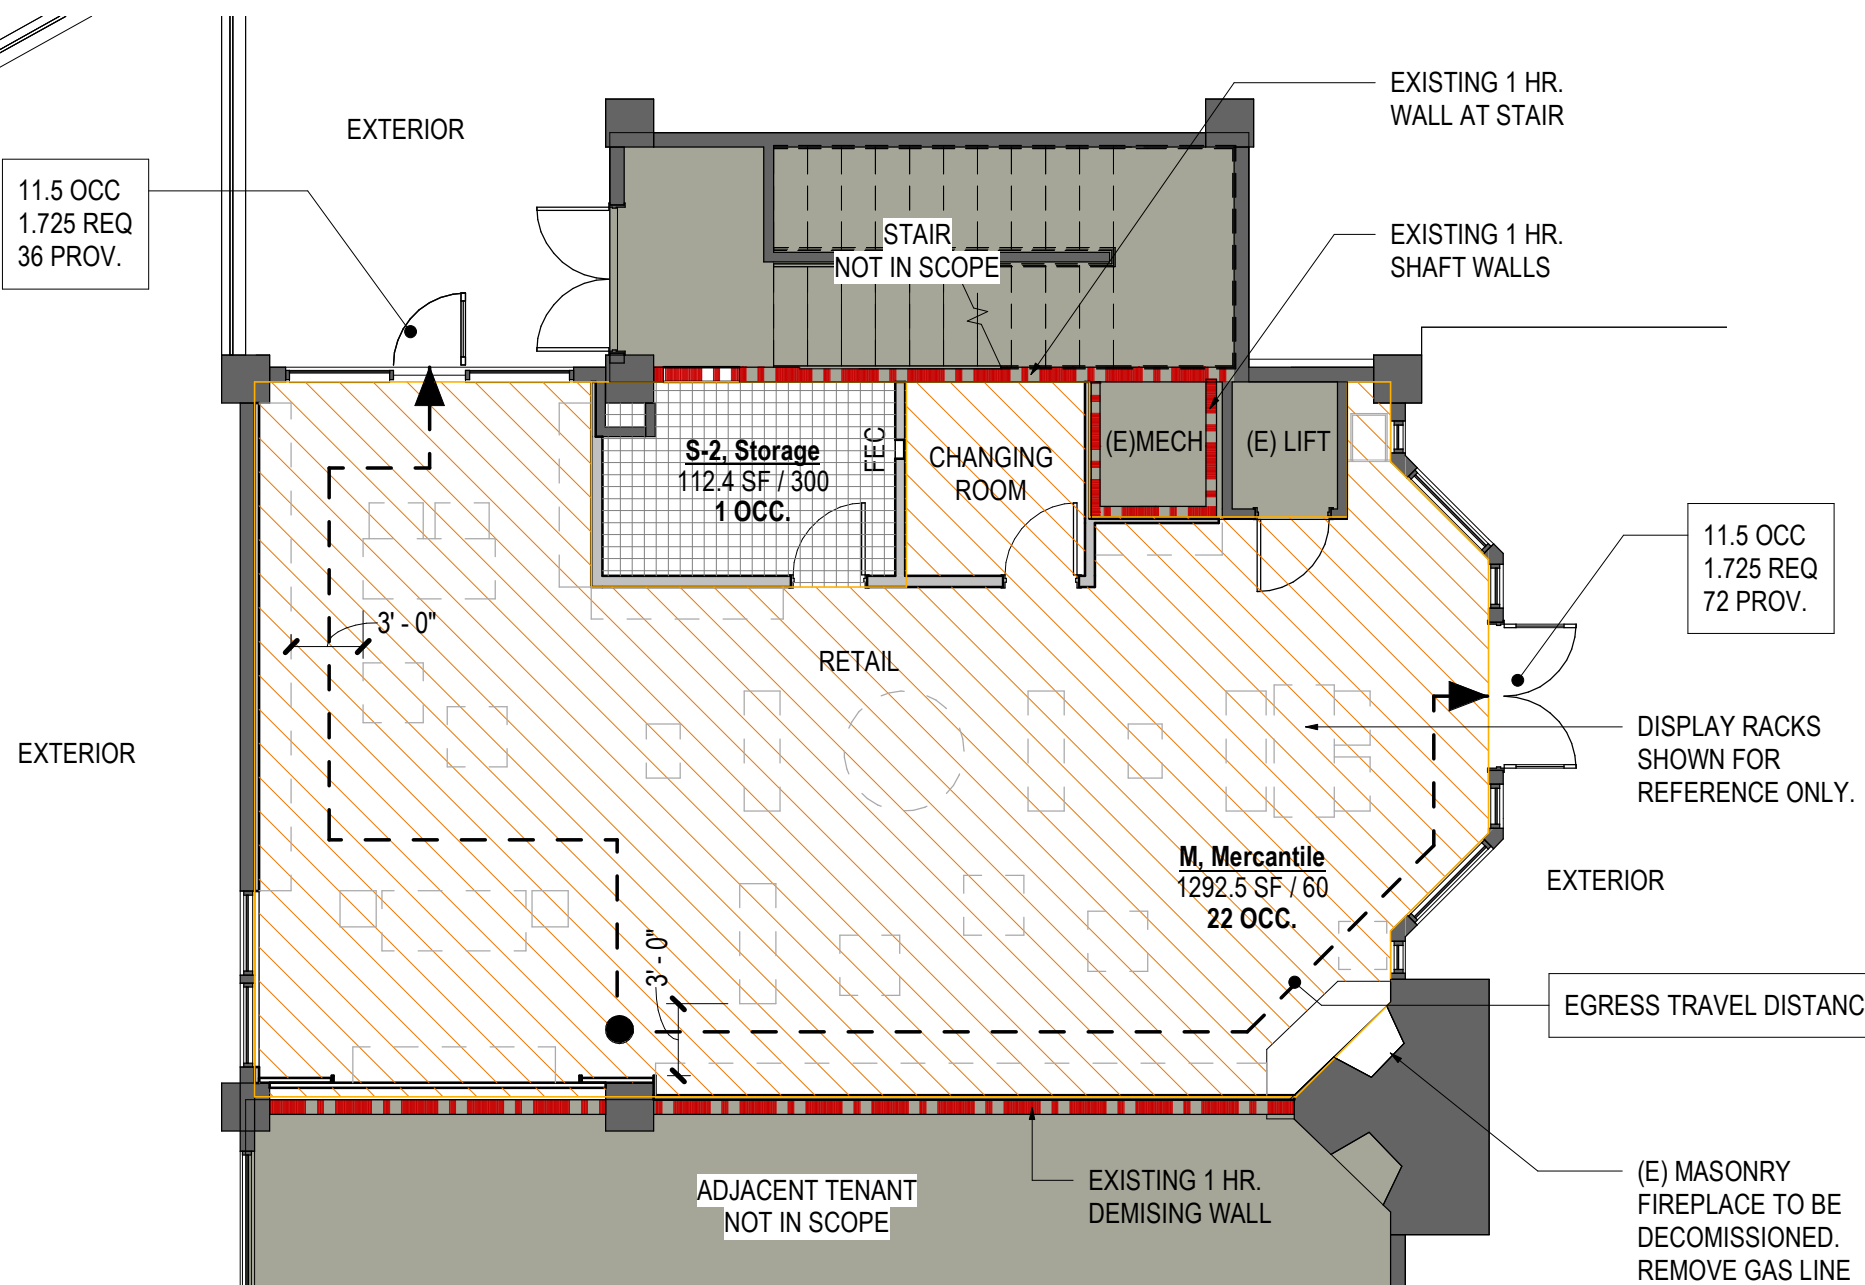

01 RETAIL EGRESS & OCCUPANCY PLAN

SCALE: 1/8" = 1'-0"

DRAWING INDEX

Sheet Number	Sheet Name	Current Revision to IFC (if applicable)
		Latest Description Date
01 - GENERAL		
2B-G0.000	COVER	1 ISSUE FOR CONSTRUCTION 05/20/2022
01 - GENERAL		
2B-G1.101	DEMOLITION PLAN AND SCHEDULES	1 ISSUE FOR CONSTRUCTION 05/20/2022
05 - ARCHITECTURE		
2B-A1.101	CONSTRUCTION PLAN, RCP, SECTION, & ELEVATIONS	1 ISSUE FOR CONSTRUCTION 05/20/2022
2B-A1.102	INTERIOR ELEVATIONS & DETAILS	1 ISSUE FOR CONSTRUCTION 05/20/2022
06 - MECHANICAL		
2B-M0.001	MECHANICAL GENERAL NOTES	1 ISSUE FOR CONSTRUCTION 05/20/2022
2B-M0.002	MECHANICAL CONTROLS	1 ISSUE FOR CONSTRUCTION 05/20/2022
2B-M0.201	MECHANICAL PLAN - LEVEL 02	1 ISSUE FOR CONSTRUCTION 05/20/2022
2B-M0.301	MECHANICAL PIPING PLAN - LEVEL 02	1 ISSUE FOR CONSTRUCTION 05/20/2022
2B-M0.000	MECHANICAL LEGEND	1 ISSUE FOR CONSTRUCTION 05/20/2022
2B-M8.000	MECHANICAL DETAILS	1 ISSUE FOR CONSTRUCTION 05/20/2022
2B-MEP0.000	MECHANICAL SCHEDULES	1 ISSUE FOR CONSTRUCTION 05/20/2022
10 - ELECTRICAL		
2B-EO.000	ELECTRICAL LEGEND	1 ISSUE FOR CONSTRUCTION 05/20/2022
2B-EO.001	ELECTRICAL ONE-LINE	1 ISSUE FOR CONSTRUCTION 05/20/2022
2B-EO.002	ELECTRICAL SCHEDULES	1 ISSUE FOR CONSTRUCTION 05/20/2022
2B-E1.201	ELECTRICAL PLAN - LEVEL 03	1 ISSUE FOR CONSTRUCTION 05/20/2022
2B-E1.301	LIGHTING PLAN - LEVEL 03	1 ISSUE FOR CONSTRUCTION 05/20/2022
2B-E8.000	ELECTRICAL DETAILS	1 ISSUE FOR CONSTRUCTION 05/20/2022
15 - TECHNOLOGY		
2B-TO.000	TECHNOLOGY LEGEND	1 ISSUE FOR CONSTRUCTION 05/20/2022
2B-TO.001	TECHNOLOGY GENERAL NOTES & ABBREVIATIONS	1 ISSUE FOR CONSTRUCTION 05/20/2022
2B-T1.201	TECHNOLOGY PLAN - LEVEL 03	1 ISSUE FOR CONSTRUCTION 05/20/2022
2B-T8.000	TECHNOLOGY DETAILS	1 ISSUE FOR CONSTRUCTION 05/20/2022
2B-T8.001	TECHNOLOGY DETAILS	1 ISSUE FOR CONSTRUCTION 05/20/2022

Steamboat
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me
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Seal / Signature

05.20.2022

Date	Description
1 05/20/2022	ISSUE FOR CONSTRUCTION

Project Name
SSRC | BASE AREA IMPROVEMENTS

Project Number
003.7835.002

Description
COVER

Scale
NOT TO SCALE

2B-G0.000

FINISH MATERIAL SCHEDULE

CEILINGS

CL1
09 51 00 ACOUSTICAL CEILINGS
NAME: ULTIMA
GRID SIZE: SUPRAPINE 9/16"
GRID COLOR: WHITE
GRID STYLE: BEVELED REGULAR
TILE MANUFACTURER: ARMSTRONG WORLD INDUSTRIES INC.
TILE SIZE: 12" X 24"
TILE COLOR: WHITE

CARPET

CP1
09 68 16 SHEET CARPETING
MANUFACTURER: INTERFACE
NUMBER: 105596
COLOR: CHARCOAL STITCH
PATTERN NAME: STITCH IN TIME

DECORATIVE METALS

MT1
05 50 00 METAL FABRICATIONS
DESCRIPTION: BLACKENED STEEL PANEL
SIZE: 1/4" THICK

PAINT

PT1
09 91 13 INTERIOR PAINTING
MANUFACTURER: BENJAMIN MOORE
NUMBER: OC-85
COLOR: CHANTILLY LACE
FINISH: WALLS TO BE EGGSHELL, CEILINGS TO BE FLAT, RESTROOMS TO BE SATIN, RUDDING BASE AND TRIM TO BE SEMI-GLOSS, DOORS AND FRAMES TO BE SEMI-GLOSS
STYLE: ULTRA SPEC 500

PT2
09 91 13 INTERIOR PAINTING
MANUFACTURER: BENJAMIN MOORE
NUMBER: 2108-40
COLOR: STARBUCKS
FINISH: WALLS TO BE EGGSHELL, CEILINGS TO BE FLAT, RESTROOMS TO BE SATIN, RUDDING BASE AND TRIM TO BE SEMI-GLOSS, DOORS AND FRAMES TO BE SEMI-GLOSS
STYLE: ULTRA SPEC 500

PT3
09 91 13 INTERIOR PAINTING
MANUFACTURER: BENJAMIN MOORE
NUMBER: 2120-10
COLOR: JET BLACK
FINISH: WALLS TO BE EGGSHELL, CEILINGS TO BE FLAT, RESTROOMS TO BE SATIN, RUDDING BASE AND TRIM TO BE SEMI-GLOSS, DOORS AND FRAMES TO BE SEMI-GLOSS
STYLE: ULTRA SPEC 500

WOOD BASE, INTERIOR

WB1
06 40 23 WOOD BASE
SIZE: 4" TALL
COLOR: TO MATCH ADJACENT WALL
FINISH: TO MATCH ADJACENT WALL

WOOD WALL

WD1
INTERIOR ARCHITECTURAL WOODWORK
DESCRIPTION: CUSTOM FEATURE WALL, END CUT ASPEN TREE. PAINT SUBSTRATE WALL PT3
SIZE: ROUNDS TO VARY BETWEEN 4" AND 16" DIA., BETWEEN 1/2" AND 1 1/2" THICK
NOTE: CLASS C FIRE RATED FINISH

GRAPHIC SYMBOLS (CONT.)

REFLECTED CEILING

ACOUSTICAL CEILING AND GRID

CEILING HEIGHT CHANGE SYMBOL

FINISH CEILING HEIGHT SYMBOL

GRID STARTPOINT SYMBOL

CEILING FINISH TAG

MOTION SENSOR

CEILING MOUNTED SPEAKER

CEILING MOUNTED CAMERA

CEILING MOUNTED SPRINKLER HEAD

CEILING MOUNTED SMOKE DETECTOR

CEILING MOUNTED STROBE LIGHT

CEILING MOUNTED EXIT SIGNS

WALL MOUNTED EXIT SIGNS - PARALLEL

WALL MOUNTED EXIT SIGNS - PERPENDICULAR

Denotes EXISTING TO REMAIN

Denotes EXISTING TO BE RELOCATED

ACCESS DOOR

LIGHT FIXTURES

FLORESCENT LIGHT FIXTURE

FLORESCENT LIGHT FIXTURE / EMERGENCY CIRCUIT

EXISTING LIGHT FIXTURE TO BE REMOVED

UNDER CABINET FLORESCENT FIXTURE

FLORESCENT STRIP FIXTURE

FLORESCENT PENDANT FIXTURE

RECESSED DOWNLIGHT

RECESSED ADJUSTABLE DOWNLIGHT

RECESSED WALL WASHER

TRACK LIGHTING

SURFACE MOUNTED LIGHT FIXTURE

WALL SCONCE

LIGHT SWITCH

DIMMER SWITCH

MECHANICAL FIXTURES

RETURN AIR

SUPPLY AIR

CIRCULAR DIFFUSER

LINEAR DIFFUSER

EXHAUST FAN

CONSTRUCTION

COLUMN GRID REFERENCE NUMBER

COLUMN GRID LINES AND REFERENCE NUMBER

EXISTING CONSTRUCTION TO REMAIN

EXISTING CONSTRUCTION TO BE DEMOLISHED

NEW PARTITION

1 HR. RATED PARTITION

2 HR. RATED PARTITION

3 HR. RATED PARTITION

4 HR. RATED PARTITION

MILLWORK

MILLWORK ABOVE

DETAIL NUMBER

SHEET NUMBER

DESCRIPTION OF SIMILAR OR OPPOSITE

AREA TO BE DETAILED

LOCATION ON SHEET WHERE ELEVATION IS SHOWN

DIRECTION OF ELEVATION

SHEET NUMBER WHERE ELEVATION IS SHOWN

INTERIOR AND EXTERIOR ELEVATION MARKER

REVISION REFERENCE NUMBER

REVISION CLOUD DEPICTING AREA REVISED

NAME	ROOM NAME	ROOM NUMBER
1234		

SHEETNOTE REFERENCE

WALL TYPE REFERENCE

FIRE RATING

DOOR REFERENCE NUMBER (REFER TO DOOR SCHEDULE)

DOOR NUMBER

DOOR TYPE

DOOR NUMBER

DOOR TYPE / HARDWARE TYPE

WINDOW REFERENCE NUMBER (REFER TO WINDOW SCHEDULE)

MILLWORK REFERENCE NUMBER (REFER TO MILLWORK SCHEDULE)

ELEVATION DATUM REFERENCE

FLOOR ELEVATION TRANSITION

MATCH LINE SEE XXXX

MATCH LINE SYMBOL

ALIGN WITH ESTABLISHED / ADJACENT SURFACES

WALL MOUNTED LIFE SAFETY EQUIPMENT AND DEVICES

FIRE WARDEN STATION SYMBOL

WALL MOUNTED FIRE ALARM STROBE SYMBOL

FIRE ALARM PULL SYMBOL

WALL MOUNTED, FIRE EXTINGUISHER CABINET

WALL MOUNTED FIRE EXTINGUISHER

WALL MOUNTED FIRE HOSE CABINET

WALL MOUNTED FIRE VALVE

WALL MOUNTED FIRE VALVE CABINET

FINISH

WALL FINISH TAG

BASE FINISH TAG

EXTENT OF FINISH TYP.

WALL FINISH TAG

SPECIAL FINISH TAG


FLOOR FINISH TAG

CEILING FINISH TAG

CHANGE IN FLOOR FINISH

01 CONSTRUCTION PLAN

SCALE: 1/4" = 1'-0"

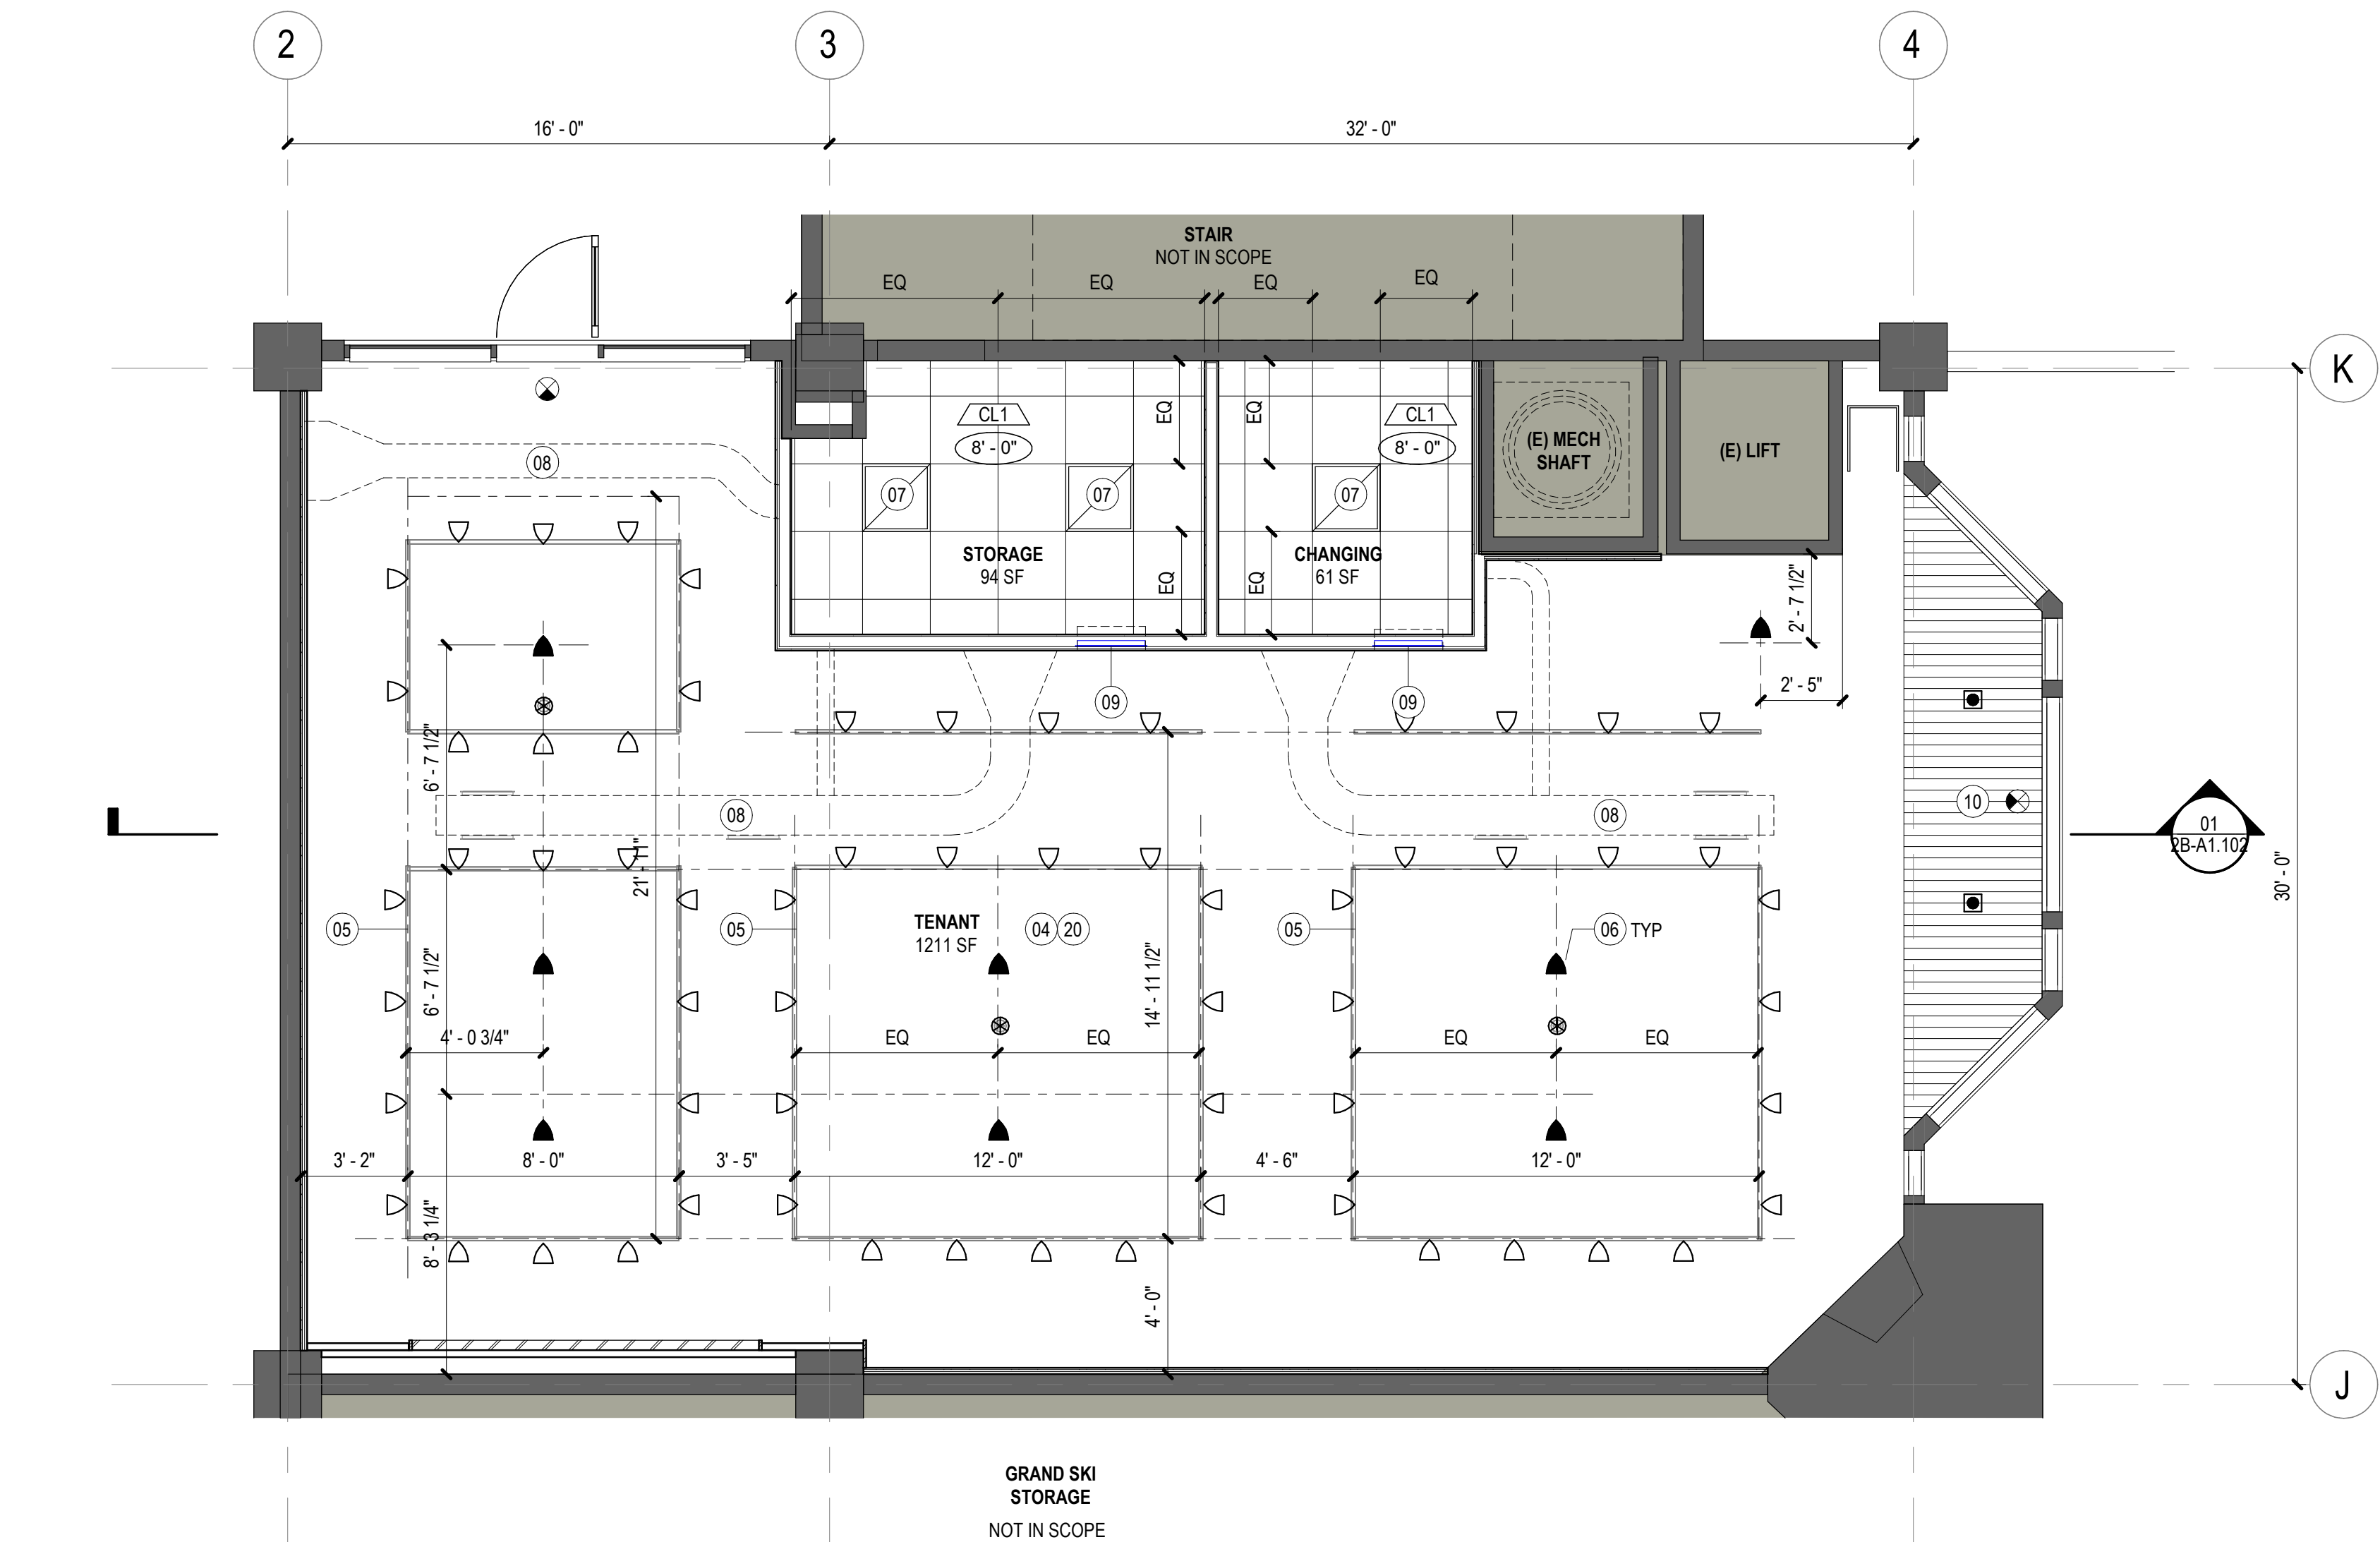

02 REFLECTED CEILING PLAN

SCALE: 1/4" = 1'-0"

SHEET NOTES

- EXISTING FIREPLACE. DECOMMISSION AND REMOVE ALL GAS LINES/ACCESSORIES. PAINT BRICK PT2. INFILL OPENING WITH WD1.
- EXISTING RATED CEILING TO REMAIN. PATCH AND REPAIR (E) 1 HR FRR GWB CEILING AS REQUIRED TO MAINTAIN 1 HR FRR. FINISH TO BE PT1
- HANGING TRACK LIGHT. MOUNT LIGHT AS HIGH AS POSSIBLE UNDER MEP AND SPRINKLERS. GC TO VERIFY EXISTING CONDITIONS IN FIELD AND COORDINATE HEIGHT WITH ARCHITECT. RE: MEP
- PENDANT LIGHT WITH SURFACE MOUNTED JUNCTION BOX. MOUNT LIGHT AS HIGH AS POSSIBLE UNDER MEP AND SPRINKLERS. GC TO VERIFY EXISTING CONDITIONS IN FIELD AND COORDINATE HEIGHT WITH ARCHITECT. RE: MEP
- RECESSED 2' X 2' LIGHT FIXTURE. RE: MEP
- EXPOSED DUCTWORK. MOUNT TIGHT TO CEILING. RE: MEP
- WALL LOUVER TO UNITS OVER RESTROOM/STORAGE CEILING. CENTER OVER DOORS. RE: MEP
- EXISTING WOOD CEILING TO REMAIN. PAINT PT1
- BASEBOARD HEATER. REFER TO MECHANICAL DRAWINGS
- EXISTING EGRESS DOOR.
- EXISTING EXTERIOR DOORS AND WINDOWS. PAINT WOOD FRAME PT1
- INFILL WALL. MATCH EXISTING FINISHES. WALL SHALL BE 1 HR FRR ASSEMBLY.
- DUPLEX POWER OUTLET. REFER TO ELECTRICAL DRAWINGS FOR ADDITIONAL ELECTRICAL AND TECHNOLOGY INFORMATION
- FLOOR FOURPLEX RECEPTACLE. REFER TO ELECTRICAL DRAWINGS FOR MORE INFORMATION
- SLOPE FLOOR UP TO LIFT ELEVATION UNDER CARPET, 1:20 MAX.
- ADD BLACKOUT FILM ON INTERIOR FACE OF EXISTING GLASS
- ALL ABANDONED MEP DUCTWORK, PIPES, CONDUIT, ETC TO BE CAPPED AND REMOVED.
- EXISTING LIFT DOOR TO REMAIN. PAINT PT1. REMOVE ALL UN-USED CONTROLS, REPLACE SWITCHPLATES WITH NEW.
- RETURN GYP BACK TO EXISTING WALL AT EDGE OF FOA PARTITION
- MEP EQUIPMENT. RE: MEP
- STORAGE SHELVING AND CLOTHING RACKS ON CASTERS TO BE PROVIDED BY OTHERS
- ADA BENCH TO BE PROVIDED BY OTHERS
- WOOD FRAMED FULL LENGTH MIRROR TO BE PROVIDED BY OTHERS. BOO: WEST ELM, ANTON FLOOR MIRROR, BURNT WAX, 30" X 72". MOUNT AT ADA HEIGHT. SECURE TO WALL.
- COAT HOOK. BRADLEY, 9643 BRADLEY, STAINLESS STEEL, 2" PROJECTION, TO BE MOUNTED CENTERED BETWEEN DOOR AND WALL AT ADA HEIGHT

GENERAL NOTES

- A. REF. GENERAL SHEETS FOR GRAPHIC SYMBOLS, GENERAL NOTES AND ABBREVIATIONS, ACCESSIBILITY REQUIREMENTS, CLEARANCES AND MOUNTING HEIGHTS.
- B. ALL PARTITIONS TO BE TYPE "A" U.O.N.
- C. PROVIDE LVL. 4 FINISH AT ALL GYP.BD SURFACES, U.O.N.
- D. ALL EXISTING PARTITIONS, INCLUDING AT PERIMETER TO BE MODIFIED / EXTENDED AS REQ'D TO BE FULLY FINISHED (GYP. BOARD, TAPED, MUDDDED AND PAINTED) TO 12" BELOW DECK ABOVE TO COVER EXPOSED WALL STRUCTURE. COORD. SPECIFIC REQUIREMENTS & LOCATIONS W/ RCP SHEETS.
- E. ALL POWER OUTLETS AT WALLS TO BE MOUNTED AT 18" AFF U.O.N. REFER TO GENERAL MOUNTING LOCATIONS.
- F. PARTITIONS AT BUILDING PERIMETER SHALL BE CENTERED ON CENTERLINE OF WINDOW MULLION U.O.N.
- G. INSTALL METAL CORNER BEADS AT ALL EXPOSED WALLBOARD EDGES. INSTALL CASING BEADS WHEREVER WALLBOARD, PLASTER, ETC. ABUTS A DISSIMILAR FINISH MATERIAL & PROVIDE SEALANT AS REQ'D.
- H. PROVIDE MIN. 20 GA. BACKING STUDS AND/OR 18 GA. BY 6" WIDE BACKS PLATES WHEN REQUIRED FOR SUPPORT U.O.N.
- J. NOTIFY ARCHITECT IN WRITINGS OF CONFLICTS, DIMENSIONAL OR OTHER DISCREPANCIES PRIOR TO PROCEEDING WITH WORK OR AREAS AFFECTED.
- K. ALL GLASS TO BE TEMPERED. ALL EXPOSED EDGES SHALL BE POLISHED.
- L. PREP SLAB AS REQUIRED FOR SPECIFIED FINISH.
- M. DOOR JAMB LOCATIONS SHALL BE TYP. 4" FROM ADJ. WALL.
- N. PATCH AND REPAIR SURFACES DAMAGED AS A RESULT OF WORK PERFORMED ON THIS PROJECT. PATCH & REPAIR EXIST SURFACES SURFACES AS REQ'D TO RECEIVE NEW FINISH.
- P. PROVIDE PAINTED LAYOUT FOR REVIEW BY ARCHITECT PRIOR TO INSTALLATION OF TRACK AND STUDS. LAYOUT TO INCLUDE PARTITIONS, MILLWORK, SOFFITS, LIGHTS AND ALL SIGNIFICANT ARCHITECTURAL FEATURES.
- Q. ALL PARTITIONS TO BE PAINTED PT1 WITH WB1 U.O.N. ALL CEILINGS TO BE PAINTED PT1 U.O.N.

KEY PLAN

REVIEWED FOR CODE COMPLIANCE

06/17/2022

B

Steamboat

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STATE OF COLORADO
J. C. Gensler
202617
05.20.2022
Seal / Signature

Date Description
1 05/20/2022 ISSUE FOR CONSTRUCTION

Project Name
SSRC | BASE AREA IMPROVEMENTS

Project Number
003.7835.002

Description
CONSTRUCTION PLAN, RCP, SECTION, & ELEVATIONS

Scale
As indicated

2B-A1.101

