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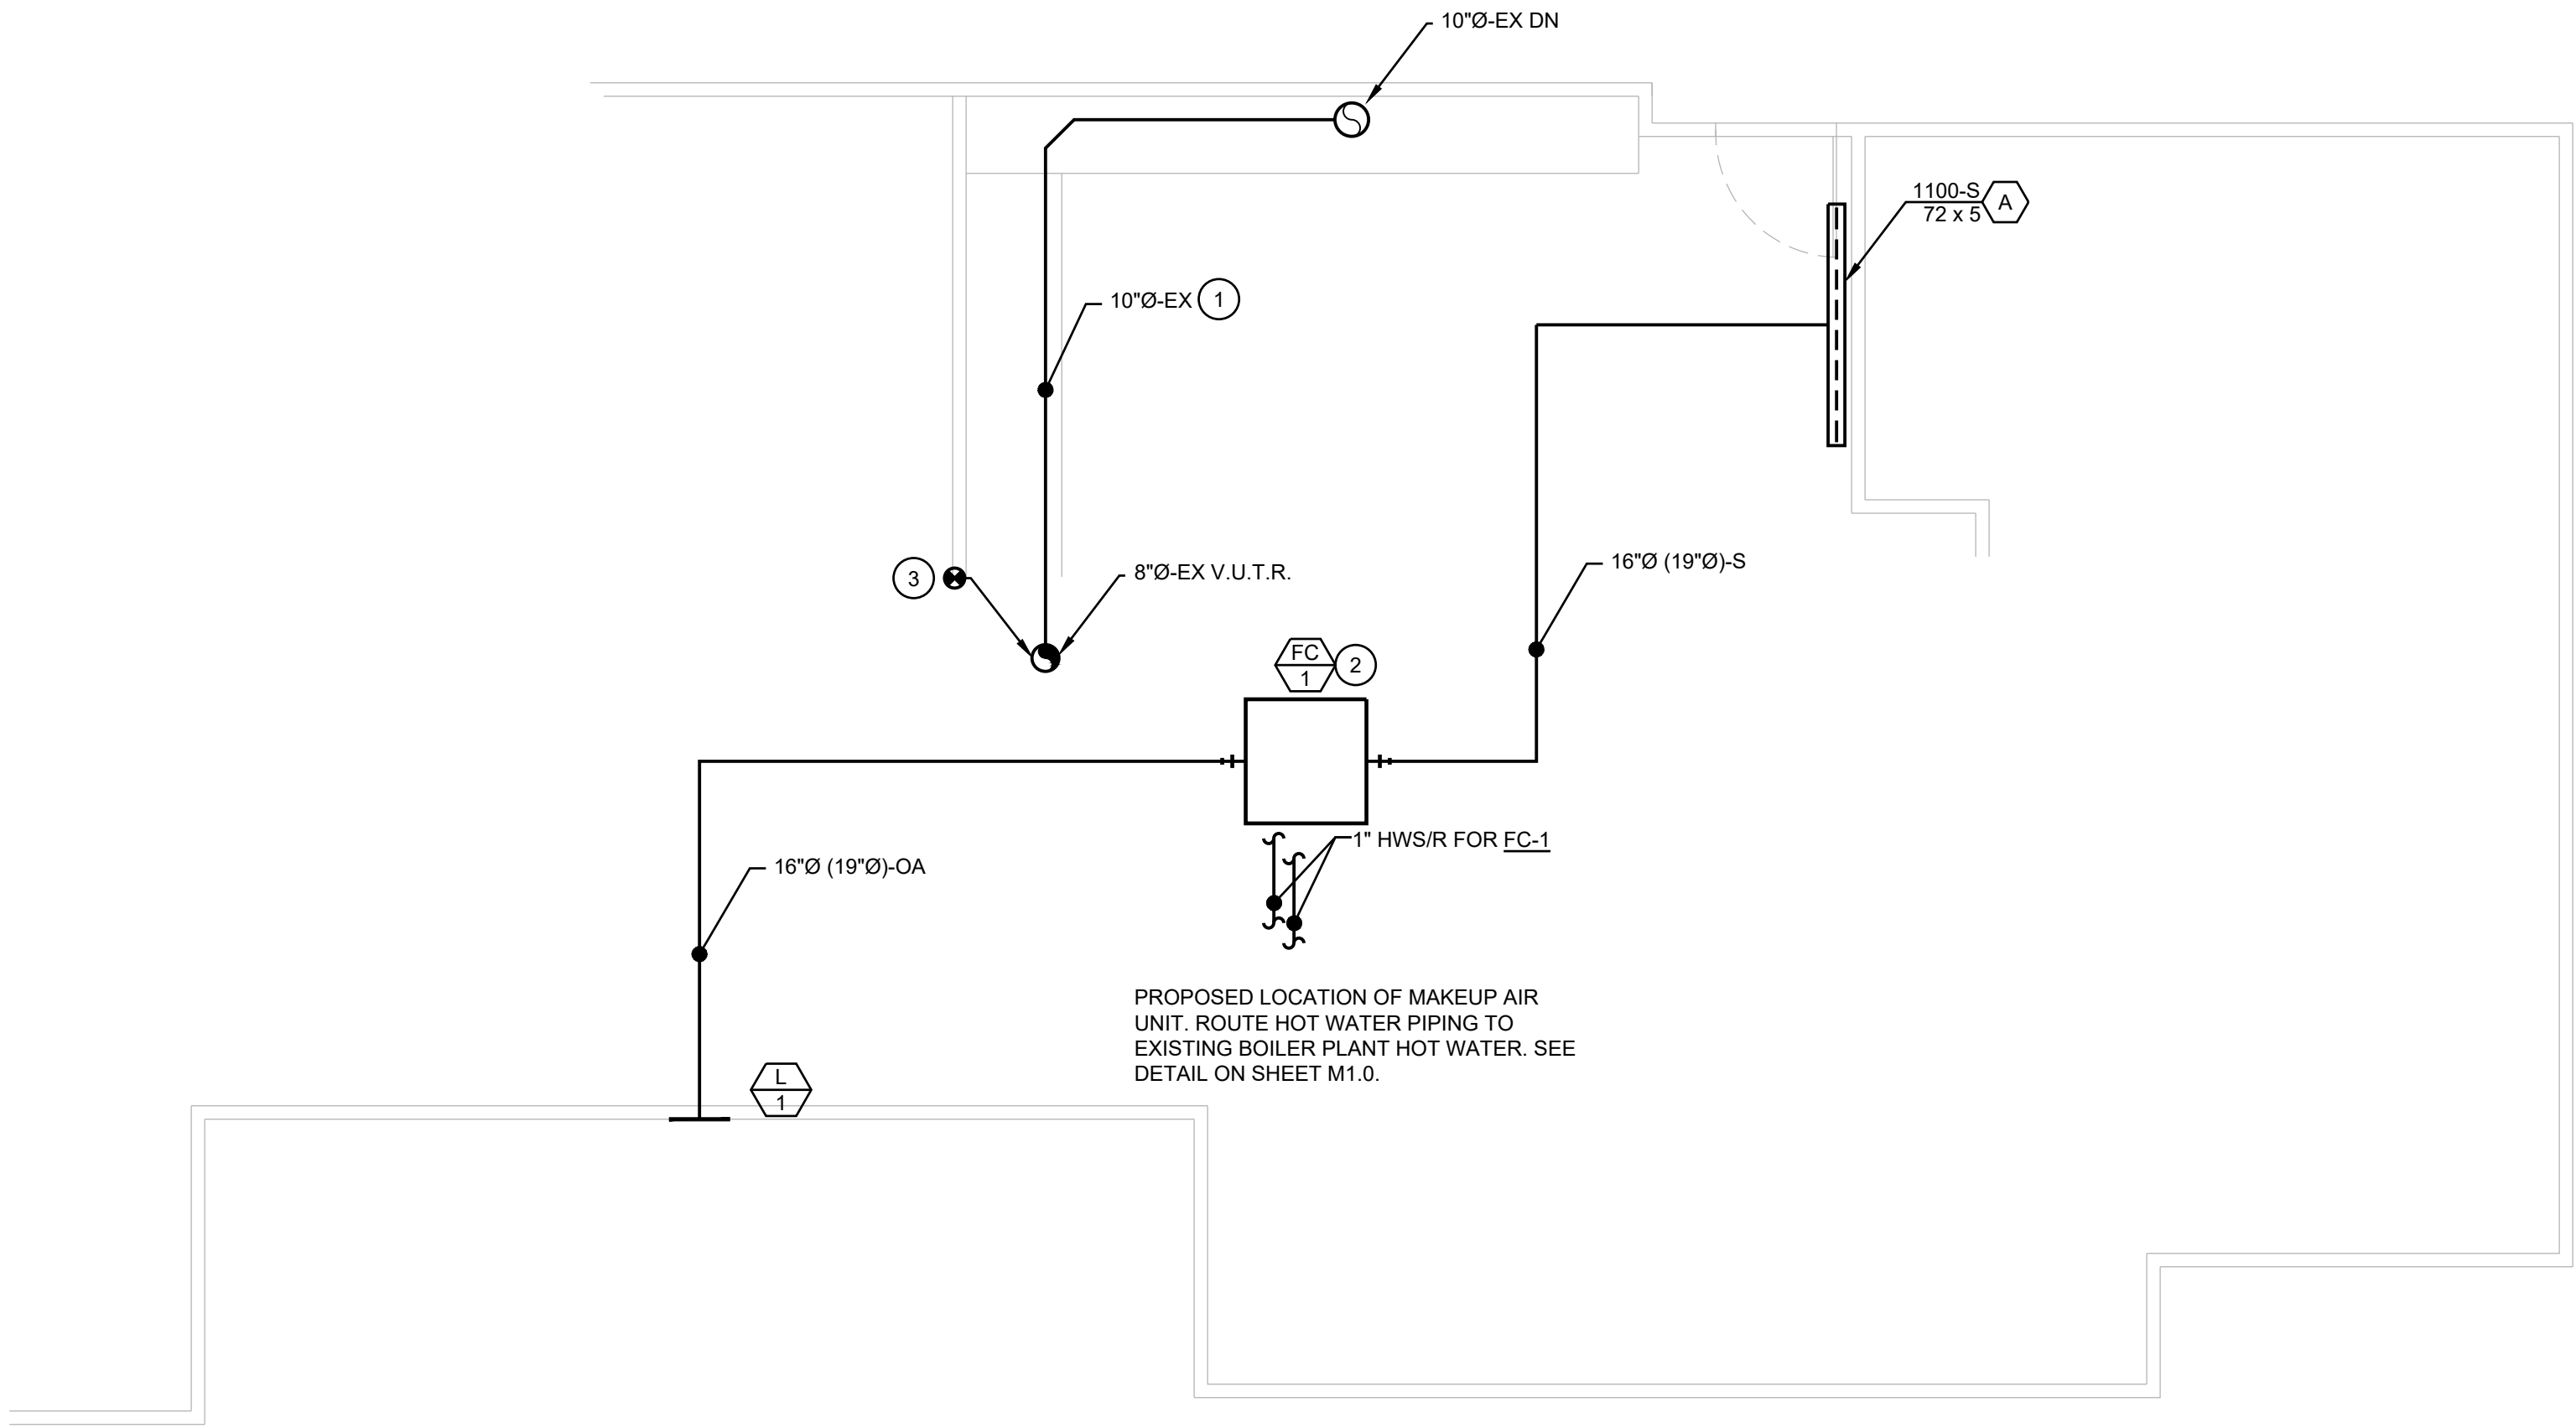
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GENERAL NOTES:

1. ALL DUCTWORK DIMENSIONS ARE SHOWN INSIDE TO INSIDE.
2. ALL INTERIOR SUPPLY AND RETURN DUCTWORK SHALL INCLUDE 1" LINER UNLESS OTHERWISE NOTED. ALL OUTSIDE AIR INTAKE AND ROUND DUCTWORK SHALL BE WRAPPED WITH 1.5" THICK INSULATION UNLESS OTHERWISE NOTED.
3. ALL FINAL DUCTWORK CONNECTIONS TO SUPPLY GRILLES (OR PLENUMS) SHALL BE COMPLETED WITH ACOUSTICAL FLEXIBLE DUCT UNLESS OTHERWISE NOTED AND A MAXIMUM LENGTH OF FIVE FEET.
4. ALL ROUND DUCT CONNECTIONS TO ROUND DUCTWORK SHALL BE CONICAL TEES.
5. ALL DUCTWORK SHALL BE RUN TIGHT TO UNDERSIDE OF STRUCTURE WHERE IT EXISTS UNLESS OTHERWISE NOTED.
6. ALL DUCTWORK PASSING THROUGH FIRE-RATED ASSEMBLIES SHALL INCLUDE FIRE DAMPERS RATED TO MATCH THAT OF THE ASSEMBLY, EVEN WHERE NOT EXPLICITLY NOTED ON THIS PLAN.
7. ALL FIRE DAMPERS ARE INTENDED TO BE SPRING OPERATED CURTAIN DAMPERS. ALL FIRE SMOKE DAMPERS ARE INTENDED TO BE EQUIPPED WITH 120V ACTUATORS.
8. ALL SUPPLY GRILLES SHALL INCLUDE A BALANCING DAMPER(S), EVEN IF NOT SPECIFICALLY SHOWN, UNLESS OTHERWISE NOTED. IF THE DAMPER IS LOCATED IN AN INACCESSIBLE LOCATION, CABLE-STYLE DAMPERS (ROTOTWIST OR EQUIVALENT) SHALL BE INSTALLED AND SHALL BE ADJUSTABLE FROM THE GRILLE FACE.
9. COORDINATE ALL ACCESS PANEL LOCATIONS WITH THE ARCHITECT.
10. ALL DUCTWORK SHALL BE SUPPORTED IN ACCORDANCE WITH THE 2015 IMC 603.10 AND SMACNA HVAC DUCT CONSTRUCTION STANDARDS.


SHEET DETAIL NOTES:

- 1 DEMOLISH EXISTING 8"Ø-EX. REPLACE WITH 15"Ø-EX.
- 2 MAINTAIN ALL SERVICE CLEARANCES PER MANUFACTURER'S RECOMMENDATIONS. LOCATE SUCH THAT UNIT CAN BE ACCESSED FROM EXISTING CATWALK IF POSSIBLE.
- 3 APPROXIMATE LOCATION OF EXISTING KITCHEN EXHAUST. FIELD VERIFY. CONNECT NEW 10"Ø-EX TO EXISTING 8"Ø ROOF PENETRATION.



MECHANICAL ATTIC SPACE
HVAC PLAN

SCALE: 1/4" = 1'0"

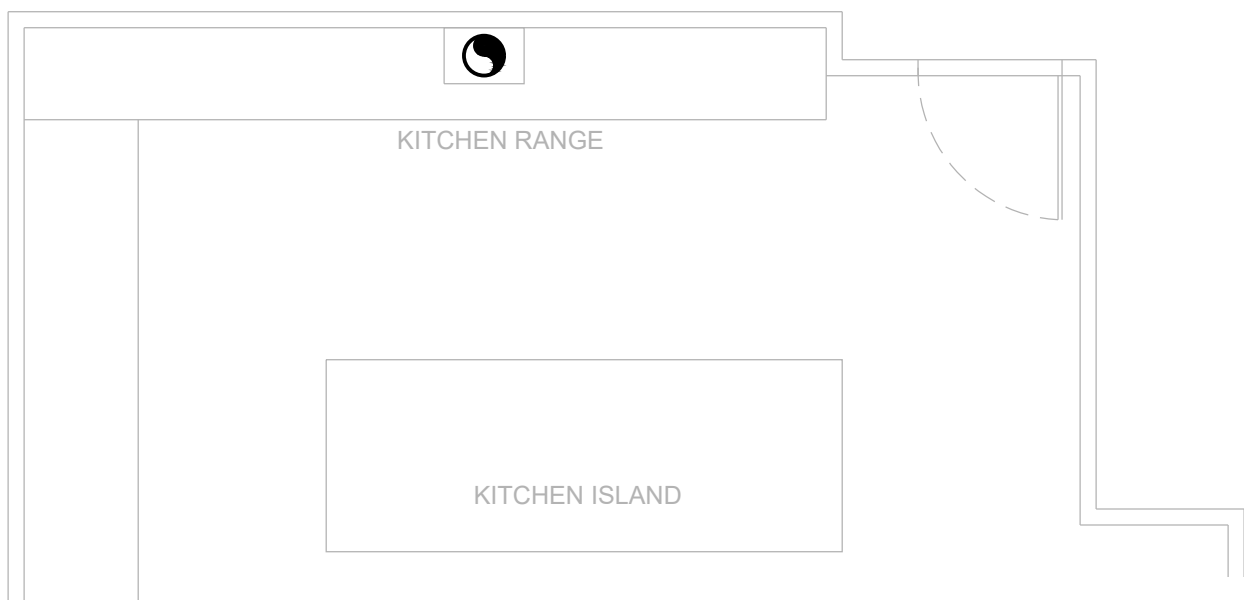


KITCHEN LEVEL HVAC PLAN

SCALE: 1/4" = 1'0"



PROGRESS DRAWINGS - NOT FOR CONSTRUCTION

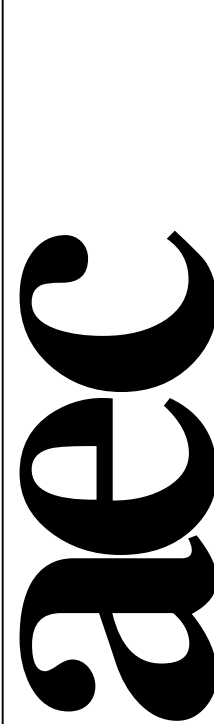

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AEC PROJECT #: 19095	
DATE:	ISSUE:
01-15-20	PROGRESS/PRICING

Drawn By:	Checked By:
NR	TOC

HVAC
PLAN

SCALE 1/4" = 1'-0"

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