







21102.00.000

05.26.2023

STEAMBOAT GRAND - PIPING SYSTEM REPLACEMENT

2300 MT WERNER CIR, STEAMBOAT SPRINGS, CO 80487

Original Issuance:

FOR PERMIT

5/24/2023 1:50:52 PM

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ENLARGED REFLECTED CEILING PLAN - LEVEL 5 - AREAS A & B

FINISH LEGEND, NOTES, & INTERIOR DETAILS

GARAGE DETAILS

EXISTING FIRE RESISTIVE REQUIREMENTS TO BE MAINTAINED: (RESTRAINED / UNRESTRAINED)

STANDARD ABBREVIATIONS LEGEND 1. IF DISCREPANCIES OCCUR BETWEEN DRAWINGS OR BETWEEN THE DRAWINGS 2. DO NOT SCALE THE DRAWINGS. SUBMIT AN RFI IF CRITICAL DIMENSIONS DO NOT 3. THE BUILDING EXTERIOR IS DEFINED BASED ON A SYSTEMS METHODOLOGY. REFER TO A-700 DRAWING SERIES FOR COMPONENTS THAT COMPRISE EACH 4. PROVIDE ISOLATION BETWEEN ALL DISSIMILAR METALS WHERE THEY OCCUR TO APPROX 5. VERIFY EQUIPMENT ROUGH-IN DIMENSIONS WITH MANUFACTURER FOR ARCH AUX BLDG TO ACCURATELY LOCATE FACE BASED ON ADJACENT ITEMS OR THE CONDITION MAY NOT VARY TO A DIMENSION GREATER THAN THAT THE CONDITION MAY NOT VARY TO A DIMENSION SMALLER THAN THAT THE CONDITION APPLIES TO SAME CONDITIONS THROUGHOUT UNLESS DWG EMER EQUIP EXIST GALV HB HORIZ MEZZ

GENERAL NOTES

SYSTEM.

DEFINITIONS

APPEAR ON THE DRAWINGS.

AND SPECIFICATIONS, SUBMIT AN RFI FOR RESOLUTION.

PREVENT ELECTROLYTIC REACTION AND CORROSION.

CONSTRUCTION

NOTED OTHERWISE

EQUIPMENT THAT IS EXISTING, REUSED, OR FURNISHED BY OWNER.

SHOWN WITHOUT THE APPROVAL OF THE ARCHITECT

SHOWN WITHOUT THE APPROVAL OF THE ARCHITECT

ADDENDUM REFERENCE ABOVE FINISHED FLOOR ALUMINUM ALTERNATE ALUMINUM WALL SECTION ANODIZED REFERENCE APPROXIMATE(LY) ARCHITECT or ARCHITECTURAL ARCHITECT'S SUPPLEMENTAL INSTRUCTIONS # AUXILIARY DETAIL ELEVATION X-### BUILDING REFERENCE BASEMENT BETWEEN CONSTRUCTION DOCUMENTS or CONTRACT DOCUMENTS INTERIOR ELEVATION CONSTRUCTION JOINT or CONTROL JOINT REFERENCE CEILING CLEAR CONCRETE MASONRY UNIT CONCRETE EXTERIOR ELEVATION CORRIDOR REFERENCE DOUBLE DEMOLISH or DEMOLITION DRINKING FOUNTAIN DIAMETER DIMENSION or DIMENSIONAL DETAIL CALLOUT DISHWASHER DRAWING EACH **EXPANSION JOINT** DIMENSION STRING ELECTRIC(AL) ELEVATOR EMERGENCY EDGE OF SLAB CENTERLINE EQUAL EQUIPMENT # ----ELECTRIC WATER COOLER **GRID LABEL - NEW** EXISTING FLOOR DRAIN # -----GRID LABEL - EXISTING FIRE DEPARTMENT CONNECTION FIRE EXTINGUISHER LEVEL 1_100' - 0" FIRE EXTINGUISHER CABINET **ELEVATION LABEL** FURNITURE, FIXTURES AND EQUIPMENT FIRE HOSE CABINET GAUGE EXTERIOR SYSTEM TAG PWS_MET_2.1 GALVANIZED HOSE BIBB INTERIOR PARTITION TYPE TAG Fn2PX—— HORIZONTAL WINDOW TAG HEATING, VENTILATION and AIR CONDITIONING INTERNATIONAL BUILDING CODE [C#] CURTAIN WALL TAG JANITOR JOINT STOREFRONT TAG ANGLE MAXIMUM EL = 100'-0" SPOT ELEVATION MECHANICAL MECHANICAL, ELECTRICAL and PLUMBING MEZZANINE DOOR TAG (####X) MINIMUM MISCELLANEOUS **ROOM NAME ROOM TAG** MASONRY OPENING NOT APPLICABLE AREA NAME 150 SF NOT IN CONTRACT AREA TAG NUMBER FOR ADDITIONAL ABBREVATIONS; REFER TO SPECIFICATION 01 4200 FOR 10'-10" CEILING HEIGHT TAG COMPLETE INDUSTRY STANDARD ABBREVIATION LIST NOISE REDUCTION COEFFICIENT FINISH TAG NOT TO SCALE XX# ON-CENTER OPENING VIEW REFERENCE 1 / A-101 OPPOSITE PERIMETER KEYNOTE AND LEADER-PAIR or PROPOSAL REQUEST POUNDS PER SQUARE FOOT POUNDS PER SQUARE INCH PAINT(ED), POST-TENSIONED SLAB or PRESSURE TREATED KEYNOTE AND LEADER-07 2700 - SHEET -WATERPROOFING RADIUS, RISER or THERMAL RESISTANCE REFLECTED CEILING PLAN REVISION CLOUD ROAD or ROOF DRAIN AND TAG REFER TO or REFERENCE REVISE, REVISED or REVISION ROUGH OPENING RIGHT-OF-WAY NORTH ARROW ROOFTOP UNIT SANITARY SQUARE FOOT (FEET) SHEET GRAPHIC SCALE SIMILAR SPECIFICATION(S) 0' 4' 8' SOUND TRANSMISSION CLASS STEEL DETAIL NUMBERING STORAGE BATTLESHIP GRID ORDER TOP OF TOP OF CONCRETE TOP OF PARAPET TOP OF STEEL TOP OF WALL TYPICAL UNLESS NOTED OTHERWISE VERIFY IN FIELD WITH -SHADED DETAIL LOCATION WITHOUT WOULD BE NUMBERED "A2" ON WOOD THE DETAIL SHEET WORKING POINT WEIGHT

STEAMBOAT GRAND HOTEL 2300 MT. WERMER CIR. STEAMBOAT SPRINGS, CO 8047 Walton Creek Rd

MECHANICAL

303.936.1633

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JOE LEAR

MEP ENGINEERING


CENTENNIAL, CO 80111

6402 S. TROY CIRCLE, STE 100

Location Map

ARCHITECTS 2901 Blake Street, Suite 100 Denver, CO 80205 303.861.8555

Consultant(s)

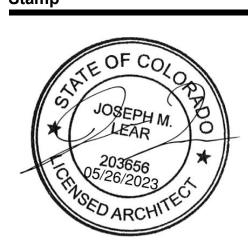

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Revisions

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DAVIS PARTNERSHIP ARCHITECTS

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COMPLIANCE

03/21/2024

Project Information

SRAND PLACE MT WERN AT SPRIN

Sheet Information

Sheet Title: PROJECT DATA

Sheet Number:

· · · · · · · · · · · · · · · · · · ·	NOVATIONS EAMBOAT SPRINGS, CO 80487 AL BUILDING DEPARTMENT		
WITH A GROSS ARE SAFETY DRAWINGS DESIGNED UNDER	EA OF 444,698 SF. THE BUILDING IS S FOR THIS BUILDING AND THEREF	FULLY SPRINKLERED. THE MAIN TYPE OF	DOMINIUMS. THE EXISTING BUILDING IS 10 STORIES ABOVE GRADE, OCCUPANCY IS R-2 OCCUPANCY. THERE ARE NO EXISTING LIFE ED FOLLOWING ASSUMPTION THAT THE EXISTING BUILDING WAS R CONSTRUCTION.
CURRENT BUILDING CODES: INTERNATIONAL BUILDING CODE - 2018 EDITI INTERNATIONAL EXISTING BUILDING CODE - 2018 EDITI INTERNATIONAL ENERGY CONSERVATION COUNTERNATIONAL MECHANICAL CODE - 2018 EDIT INTERNATIONAL FUEL GAS CODE - 2018 EDIT INTERNATIONAL PLUMBING CODE - 2018 EDIT NATIONAL ELECTRICAL CODE (NFPA 70) - 202 INTERNATIONAL CODE COUNCIL ELECTRICAL ICC/ANSI A117.1 ACCESSIBILITY STANDARD -	2018 EDITION DDE - 2018 EDITION DITION ION FION 10 EDITION L CODE, ADMINISTRATIVE PROVISIO	DNS - 2018 EDITION	
CONSTRUCTION TYPE: OCCUPANCY CLASSIFICATION:	I-FR (TYPE I-A IBC) NON-SEPARATED USE:		
OCCUPANCY CLASSIFICATION.	R-2 - RESIDENTIAL OCCUPANO A-3 - ASSEMBLY (CONFERENCI A-2 - ASSEMBLY (DINING, KITCI	E ROOMS, LOUNGES, EXERCISE ROOMS) HEN, GRAND BALLROOM) E AND SALES OFFICES, SPA, LAUNDRY)	
LIFE SAFETY SYSTEMS:	FULLY SPRINKLERED	·	
BUILDING AREA: TOTAL 444,698 GSF	GRADE LEVEL: 9,504 GSF ASSEMBLY 2,823 GSF BUSINESS 3,632 GSF MERCANTILE 3,137 GSF PARKING LEVEL: 93,724 GSF STORAGE 86,867 GSF BUSINESS 411 GSF MERCANTILE 4,673 GSF RESIDENTIAL 1,774 GSF LEVEL 1: 72,995 GSF ASSEMBLY 39,434 GSF BUSINESS 31,149 GSF MERCANTILE 1,807 GSF STORAGE 609 GSF LEVEL 2: 50,092 GSF ASSEMBLY 7,121 GSF RESIDENTIAL 42,971 GSF	LEVEL 3: 45,102 GSF RESIDENTIAL 45,102 GSF LEVEL 4: 46,226 GSF RESIDENTIAL 46,226 GSF LEVEL 5: 46,375 GSF RESIDENTIAL 46,375 GSF LEVEL 6: 41,805 GSF RESIDENTIAL 39,683 GSF STORAGE 2,167 GSF LEVEL 7: 27,650 GSF RESIDENTIAL 23,492 GSF STORAGE 4,158 GSF LEVEL 8 (LOFT): 11,225 GSF RESIDENTIAL 3,309 GSF STORAGE 7,916 GSF	
BUILDING HEIGHT: STRUCTURAL FRAME:	10 STORIES 3-HR RATED		
FLOORS AND FLOOR-CEILINGS: SHAFT AND VERTICAL EXIT ENCLOSURES: BEARING WALLS - EXTERIOR:	2-HR RATED 2-HR RATED 4-HR RATED		
BEARING WALLS - INTERIOR:	3-HR RATED		
PARTITIONS - PERMANENT:	1-HR RATED		
ROOFS AND ROOF-CEILINGS:	2-HR RATED		

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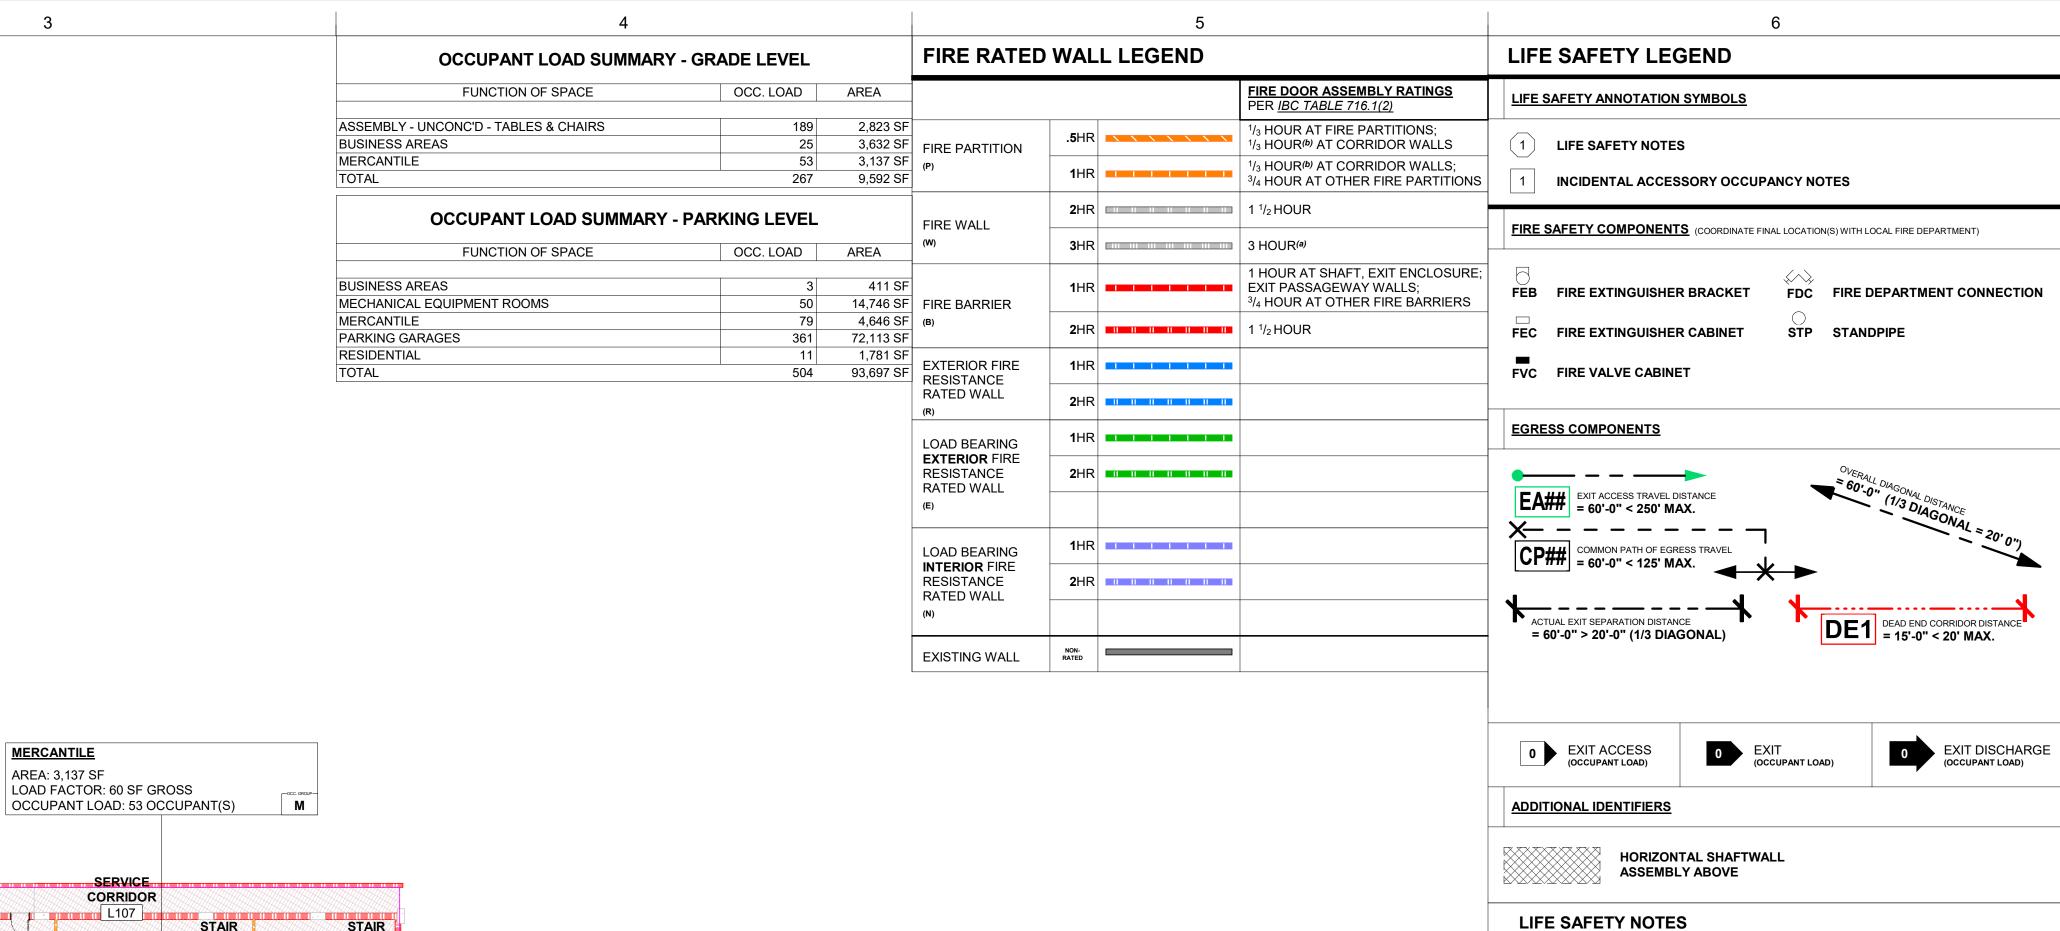
05/26/2023

ACOUSTICAL CEILING TILE **BUILDING SECTION** Project Team STEAMBOAT GRAND CONDOMINIUM ASSOCIATION 2300 MOUNT WERNER CIRCLE STEAMBOAT SPRINGS, CO 80487 970.871.5510 **PAUL BERRY** pbarry@steamboat.com CONTRACTOR HASELDEN CONSTRUCTION 823 GRAND AVENUE GLENWOOD SPRINGS, CO 81601 970.200.2522 **DAVID MARSH** STRUCTURAL KL&A 1717 WASHINGTON AVE. SUITE 100 GOLDEN, CO 80401 **HEITH C. STEIN** hstein@klaa.com SCALE: 1/8" = 1'-0" STOR

1 2 3 4 5 6

ARCHITECTURAL SYMBOLS LEGEND

AND CODE **ANALYSIS**





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Consultant(s)

(1) 2-HR RATED PT CONCRETE SLAB - TYP.

2 3-HR RATED CONCRETE FRAME (COLUMNS, BEAMS, GIRDERS) - TYP.

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Project Information

Sheet Information

Sheet Title: LIFE SAFETY PLAN - PARKING AREA A AND

GRADE LEVELS

Sheet Number:

LS-100.A

DPA Project: 21102.00.000

OCCUPANT LOAD: 189 OCCUPANT(S) SERVICE ELEV. MECH STAIR STAIR ROOM L110 REAL ESTATE CORRIDOR SALES L103 RETAIL 2 L108 VEST. VESTIBULE

AREA: 2,823 SF

LOAD FACTOR: 15 SF NET

ASSEMBLY - UNCONC'D - TABLES & CHAIRS

MERCANTILE

AREA: 3,137 SF

LOAD FACTOR: 60 SF GROSS


D1 LIFE SAFETY PLAN - GRADE LEVEL

BUSINESS AREAS

LOAD FACTOR: 150 SF GROSS


OCCUPANT LOAD: 25 OCCUPANT(S)

AREA: 3,632 SF

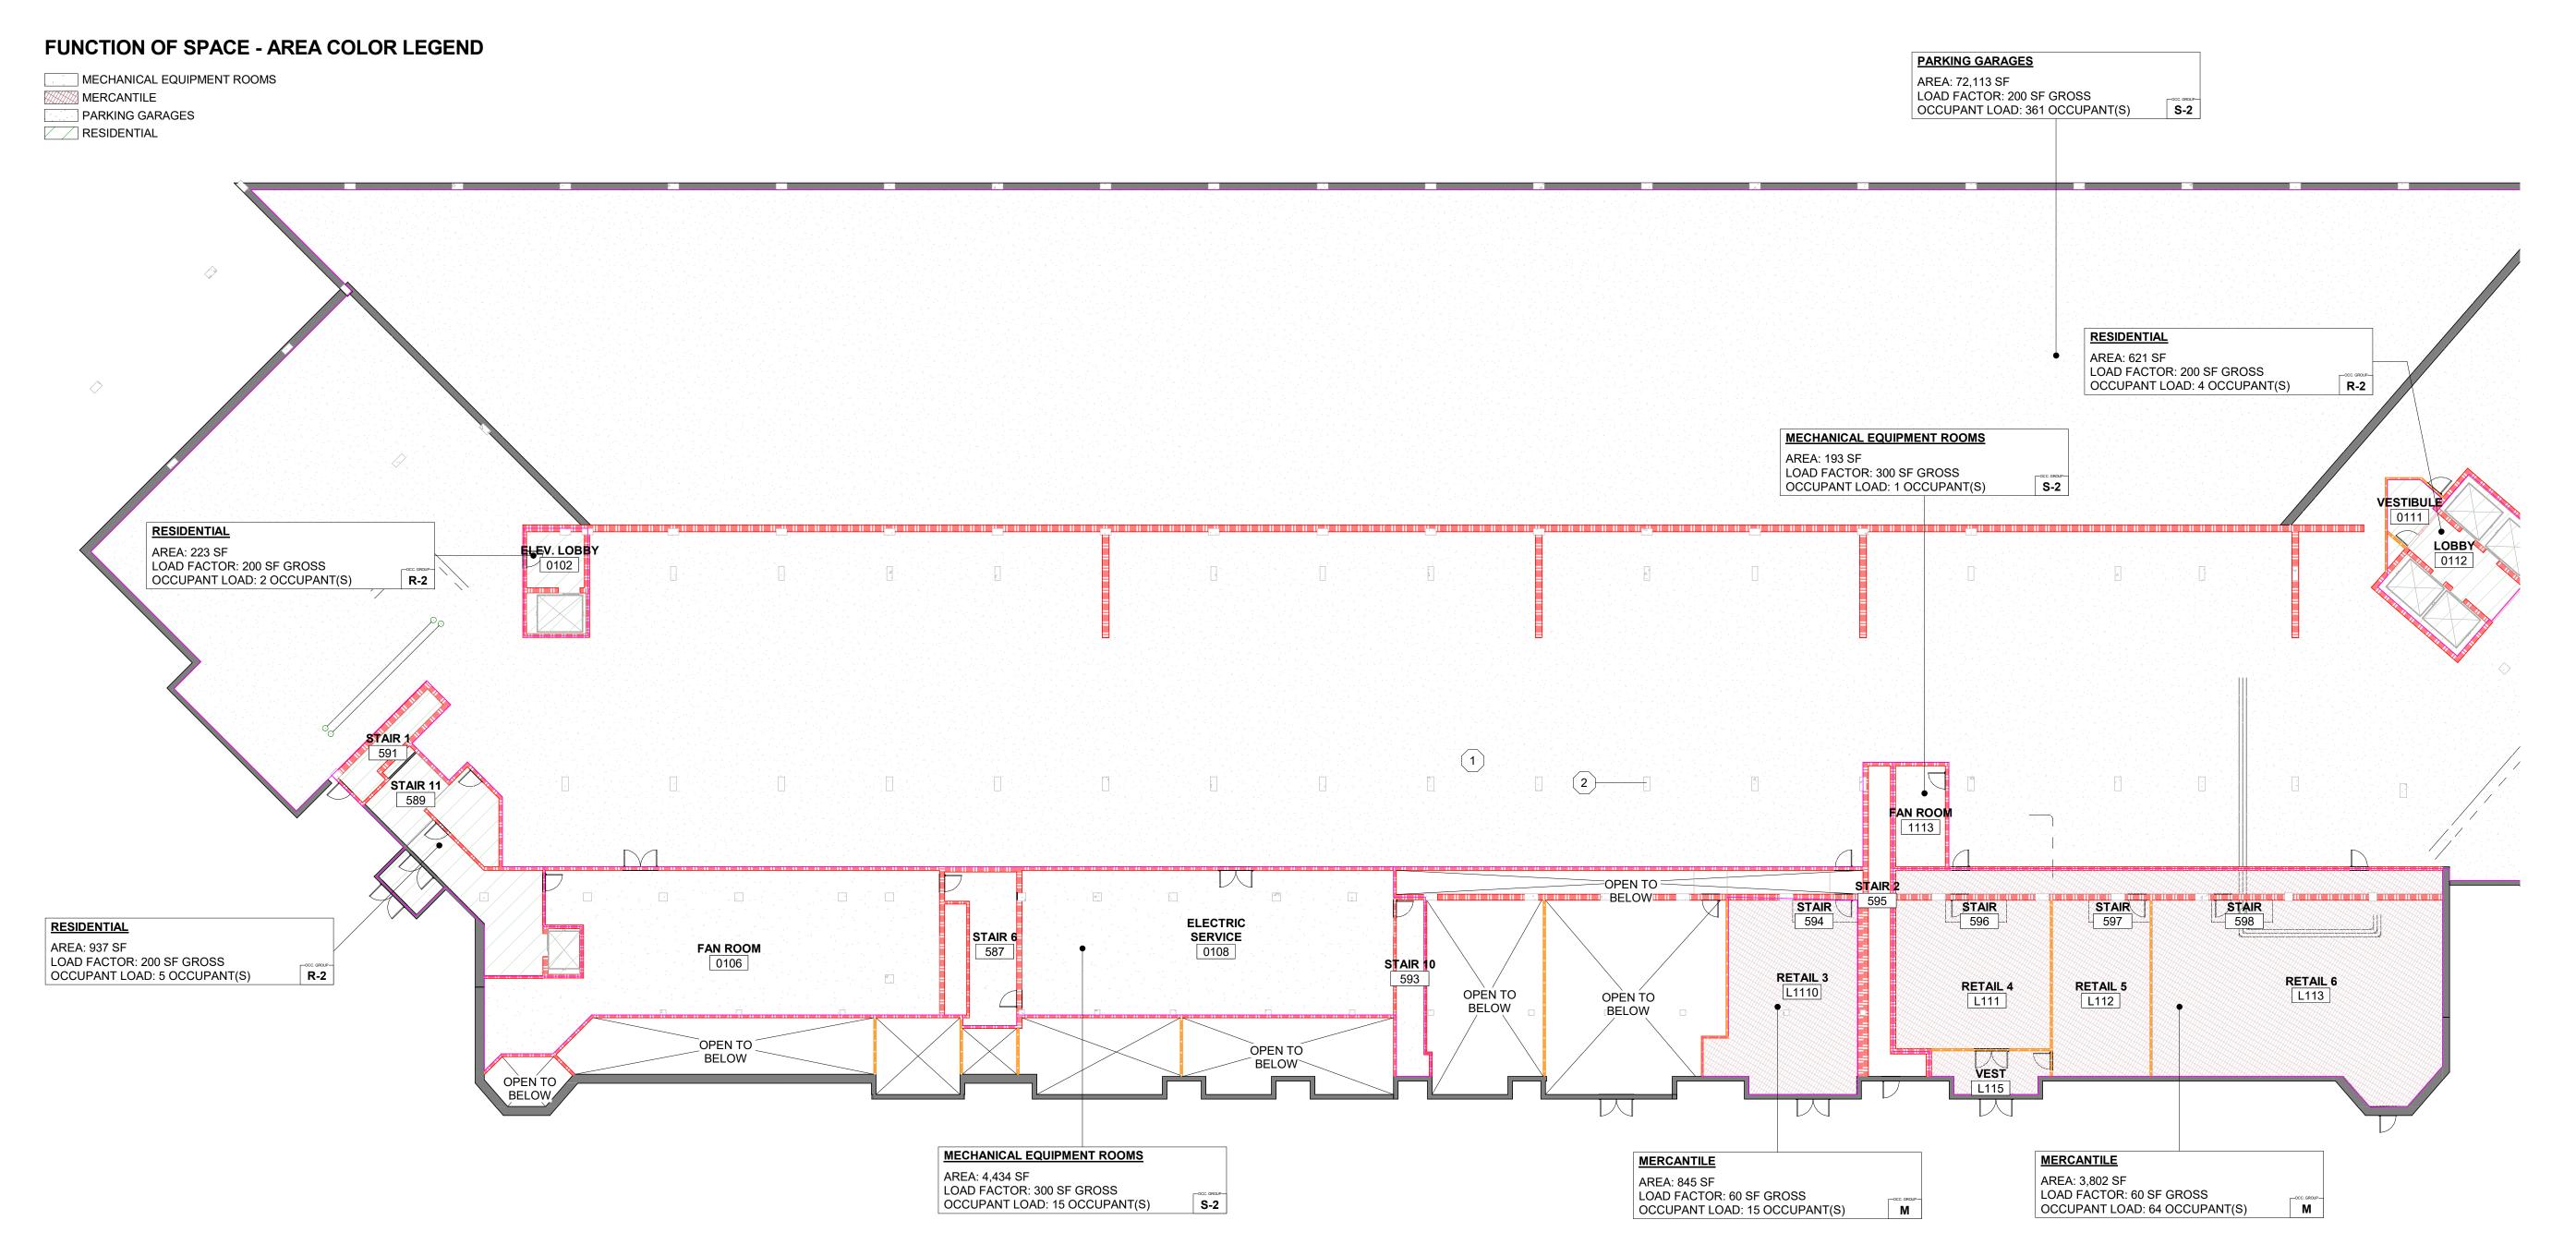

BOILER 0122 MECHANICAL EQUIPMENT ROOMS AREA: 10,119 SF LOAD FACTOR: 300 SF GROSS OCCUPANT LOAD: 34 OCCUPANT(S) ELECTRICAL 0118A STORAGE AREA: 411 SF LOAD FACTOR: 150 SF GROSS OCCUPANT LOAD: 3 OCCUPANT(S) **FUNCTION OF SPACE - AREA COLOR LEGEND** BUSINESS AREAS MECHANICAL EQUIPMENT ROOMS RESIDENTIAL MERCANTILE AREA: 621 SF LOAD FACTOR: 200 SF GROSS OCCUPANT LOAD: 4 OCCUPANT(S) PARKING GARAGES R-2 RESIDENTIAL

FIRE RATED WALL LEGEND LIFE SAFETY LEGEND FIRE DOOR ASSEMBLY RATINGS PER IBC TABLE 716.1(2) LIFE SAFETY ANNOTATION SYMBOLS ¹/₃ HOUR AT FIRE PARTITIONS; (1) LIFE SAFETY NOTES 1/3 HOUR(b) AT CORRIDOR WALLS FIRE PARTITION 1/3 HOUR(b) AT CORRIDOR WALLS; 3/4 HOUR AT OTHER FIRE PARTITIONS INCIDENTAL ACCESSORY OCCUPANCY NOTES **2**HR 1 1/₂ HOUR FIRE WALL FIRE SAFETY COMPONENTS (COORDINATE FINAL LOCATION(S) WITH LOCAL FIRE DEPARTMENT) 3 HOUR^(a) 1 HOUR AT SHAFT, EXIT ENCLOSURE; EXIT PASSAGEWAY WALLS; 3/4 HOUR AT OTHER FIRE BARRIERS FEB FIRE EXTINGUISHER BRACKET FDC FIRE DEPARTMENT CONNECTION FIRE BARRIER FEC FIRE EXTINGUISHER CABINET STP STANDPIPE FVC FIRE VALVE CABINET **EXTERIOR FIRE** RESISTANCE RATED WALL 2HR | | | | | | | | | | | | | | EGRESS COMPONENTS LOAD BEARING **EXTERIOR** FIRE RESISTANCE 2HR | | | | | | | | | | | | | | | RATED WALL EA## EXIT ACCESS TRAVEL DISTANCE = 60'-0" < 250' MAX. CP## = 60'-0" < 125' MAX. LOAD BEARING **INTERIOR** FIRE RESISTANCE **2**HR RATED WALL ACTUAL EXIT SEPARATION DISTANCE
= 60'-0" > 20'-0" (1/3 DIAGONAL) DE1 DEAD END CORRIDOR DISTANCE = 15'-0" < 20' MAX. NON-RATED EXISTING WALL 0 EXIT DISCHARGE (OCCUPANT LOAD) 0 EXIT ACCESS (OCCUPANT LOAD) ADDITIONAL IDENTIFIERS HORIZONTAL SHAFTWALL ASSEMBLY ABOVE LIFE SAFETY NOTES (1) 2-HR RATED PT CONCRETE SLAB - TYP. 2 3-HR RATED CONCRETE FRAME (COLUMNS, BEAMS, GIRDERS) - TYP.

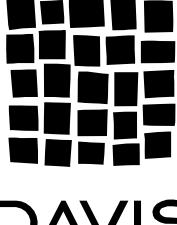

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Consultant(s)



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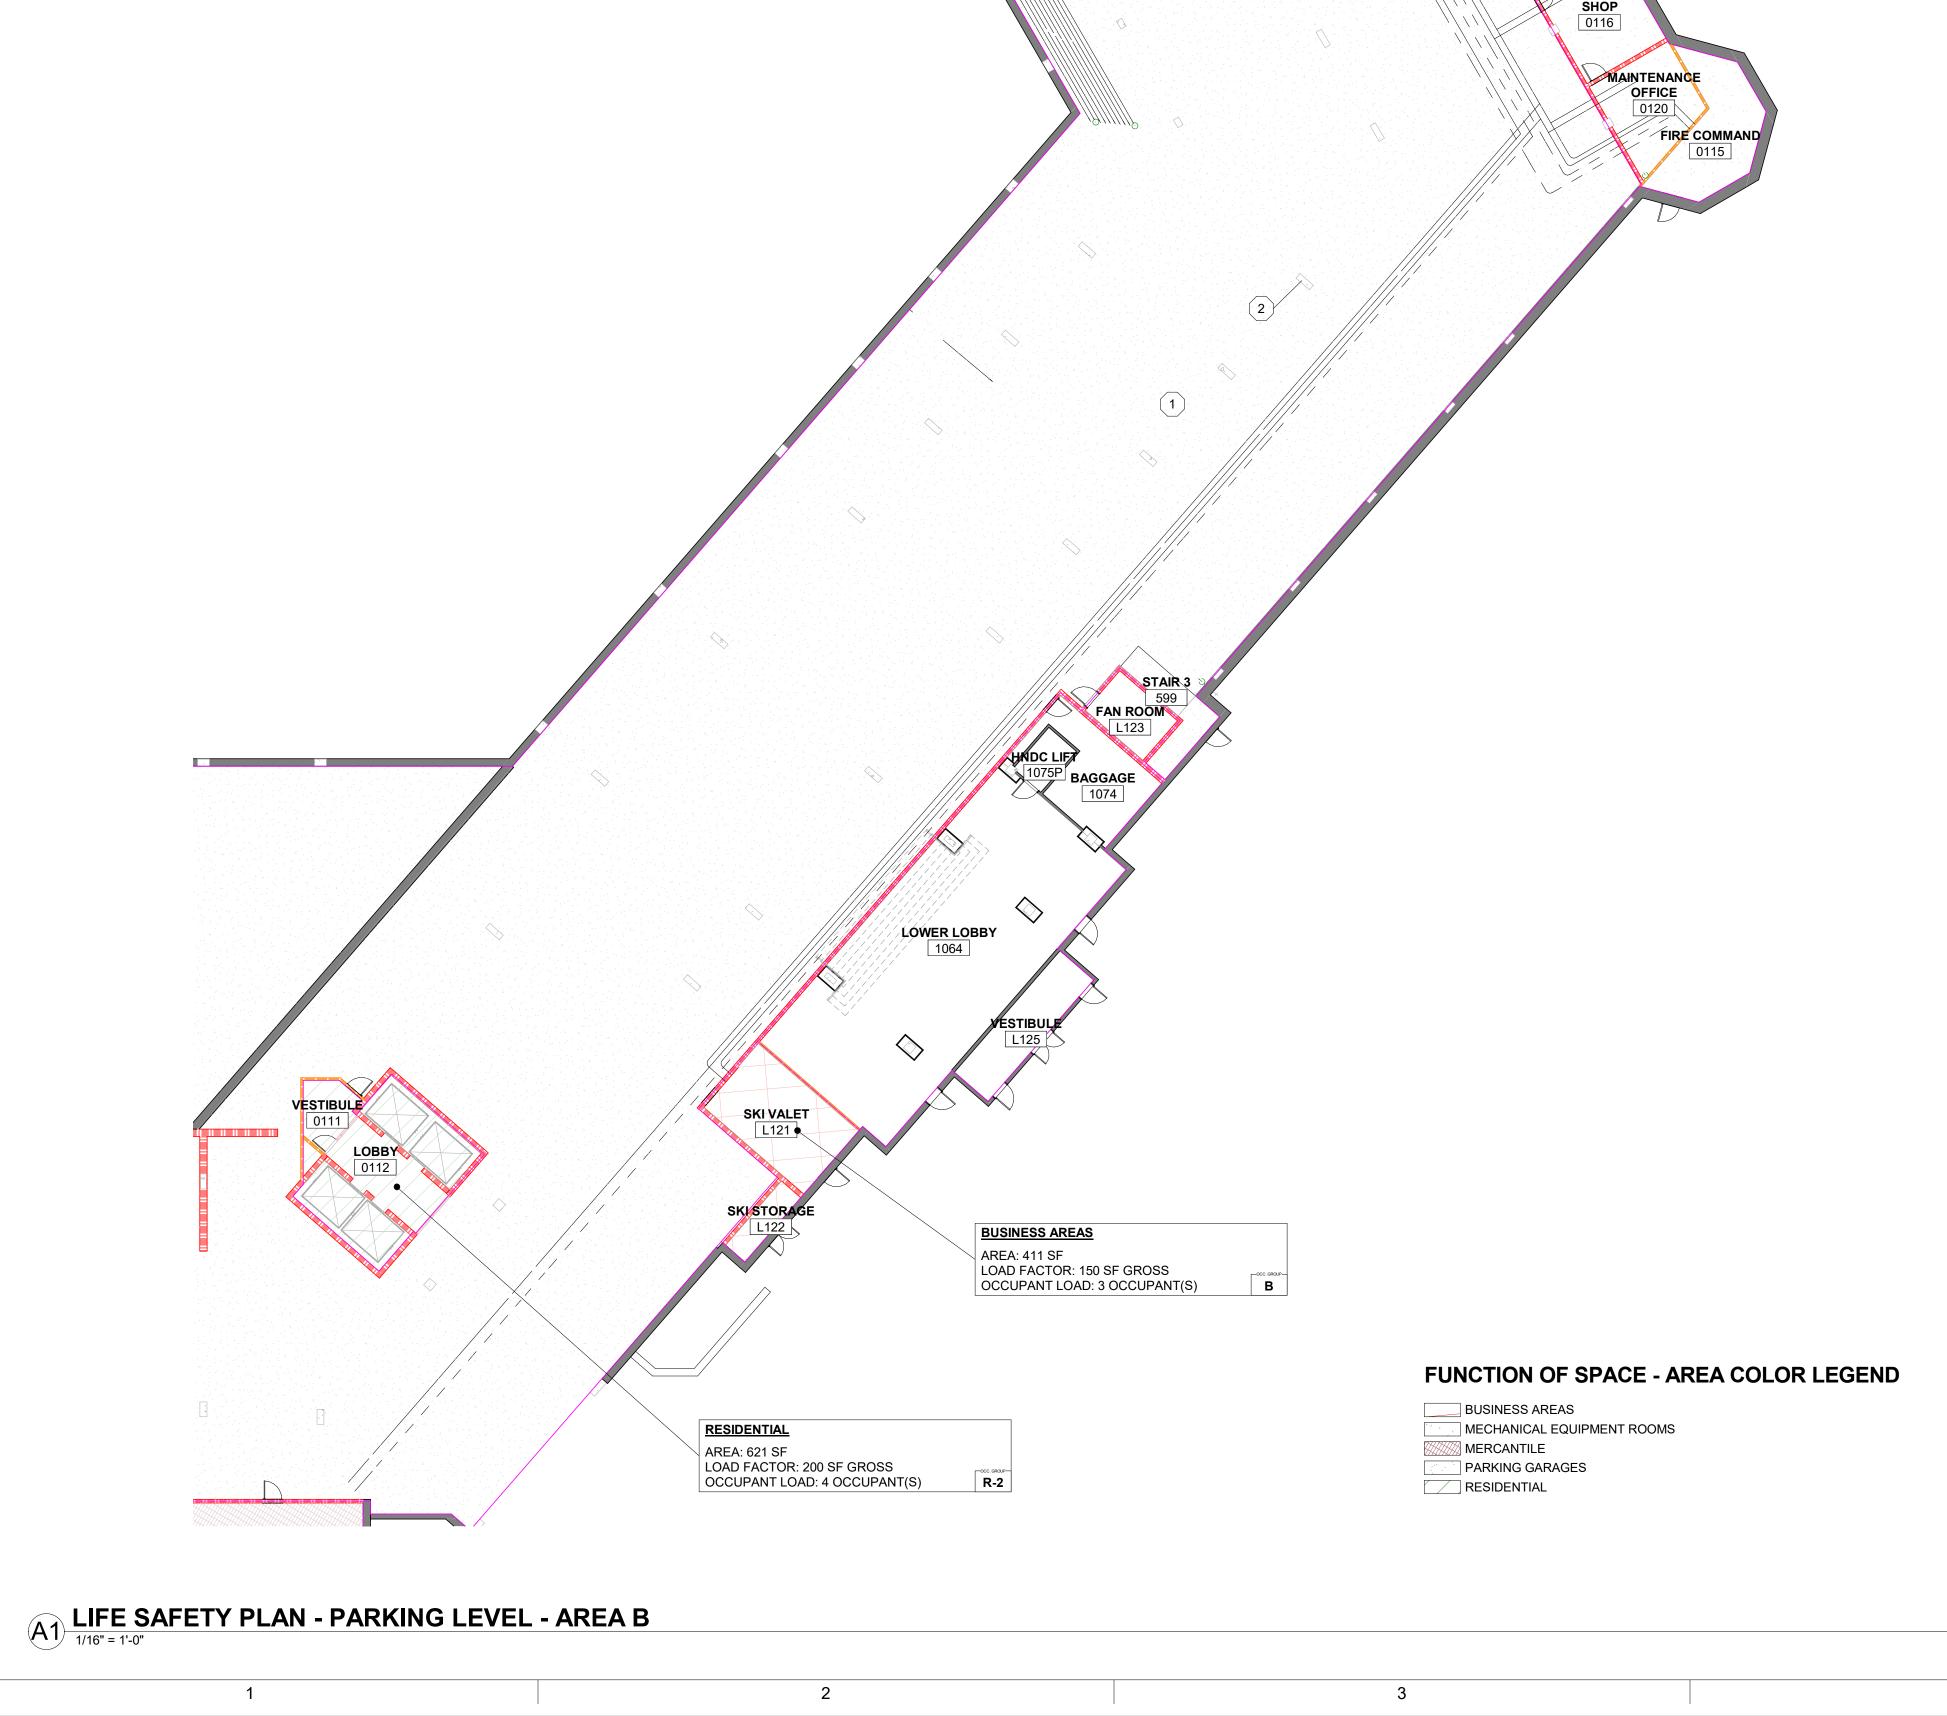
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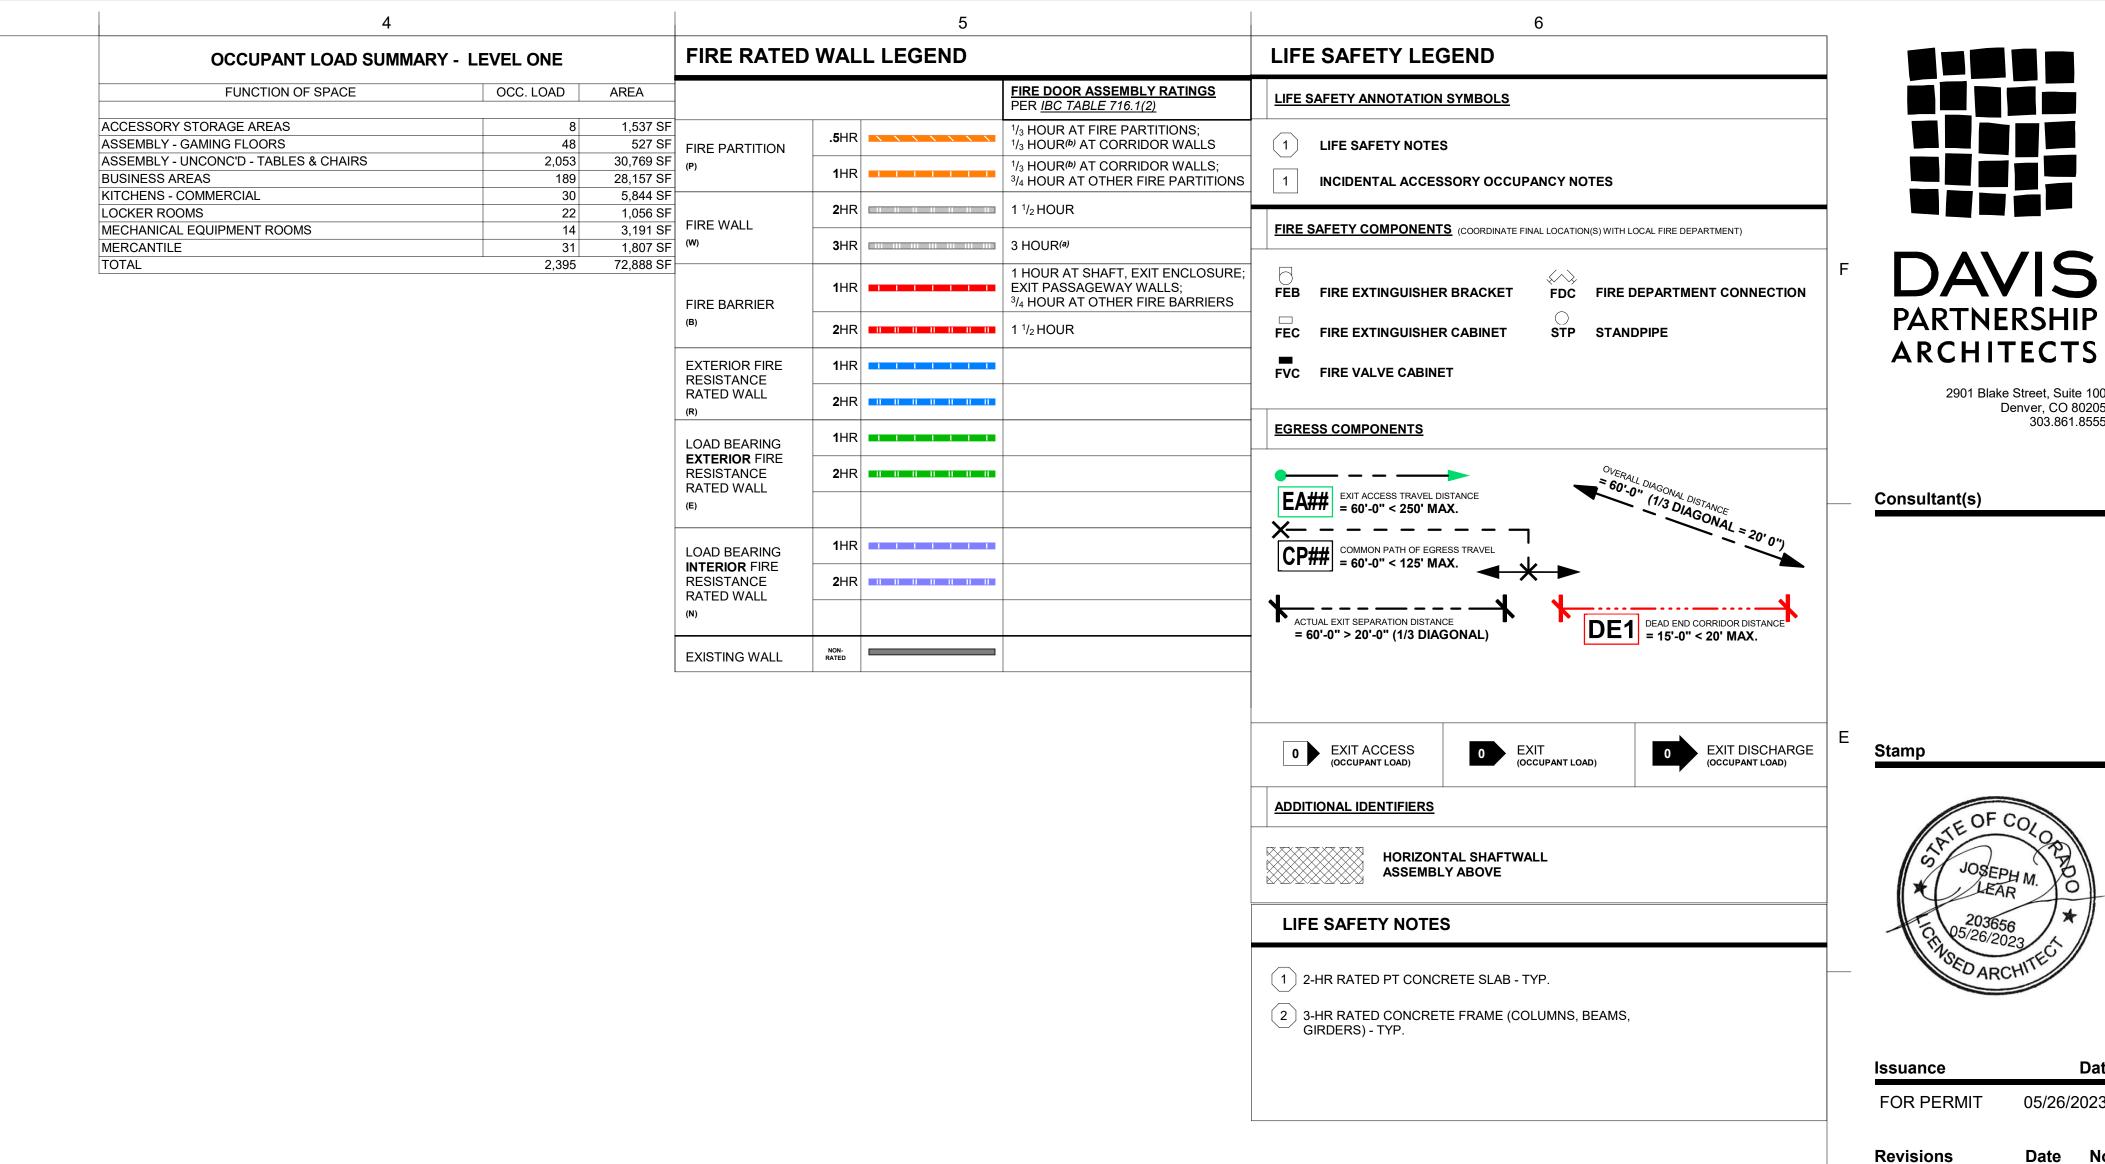
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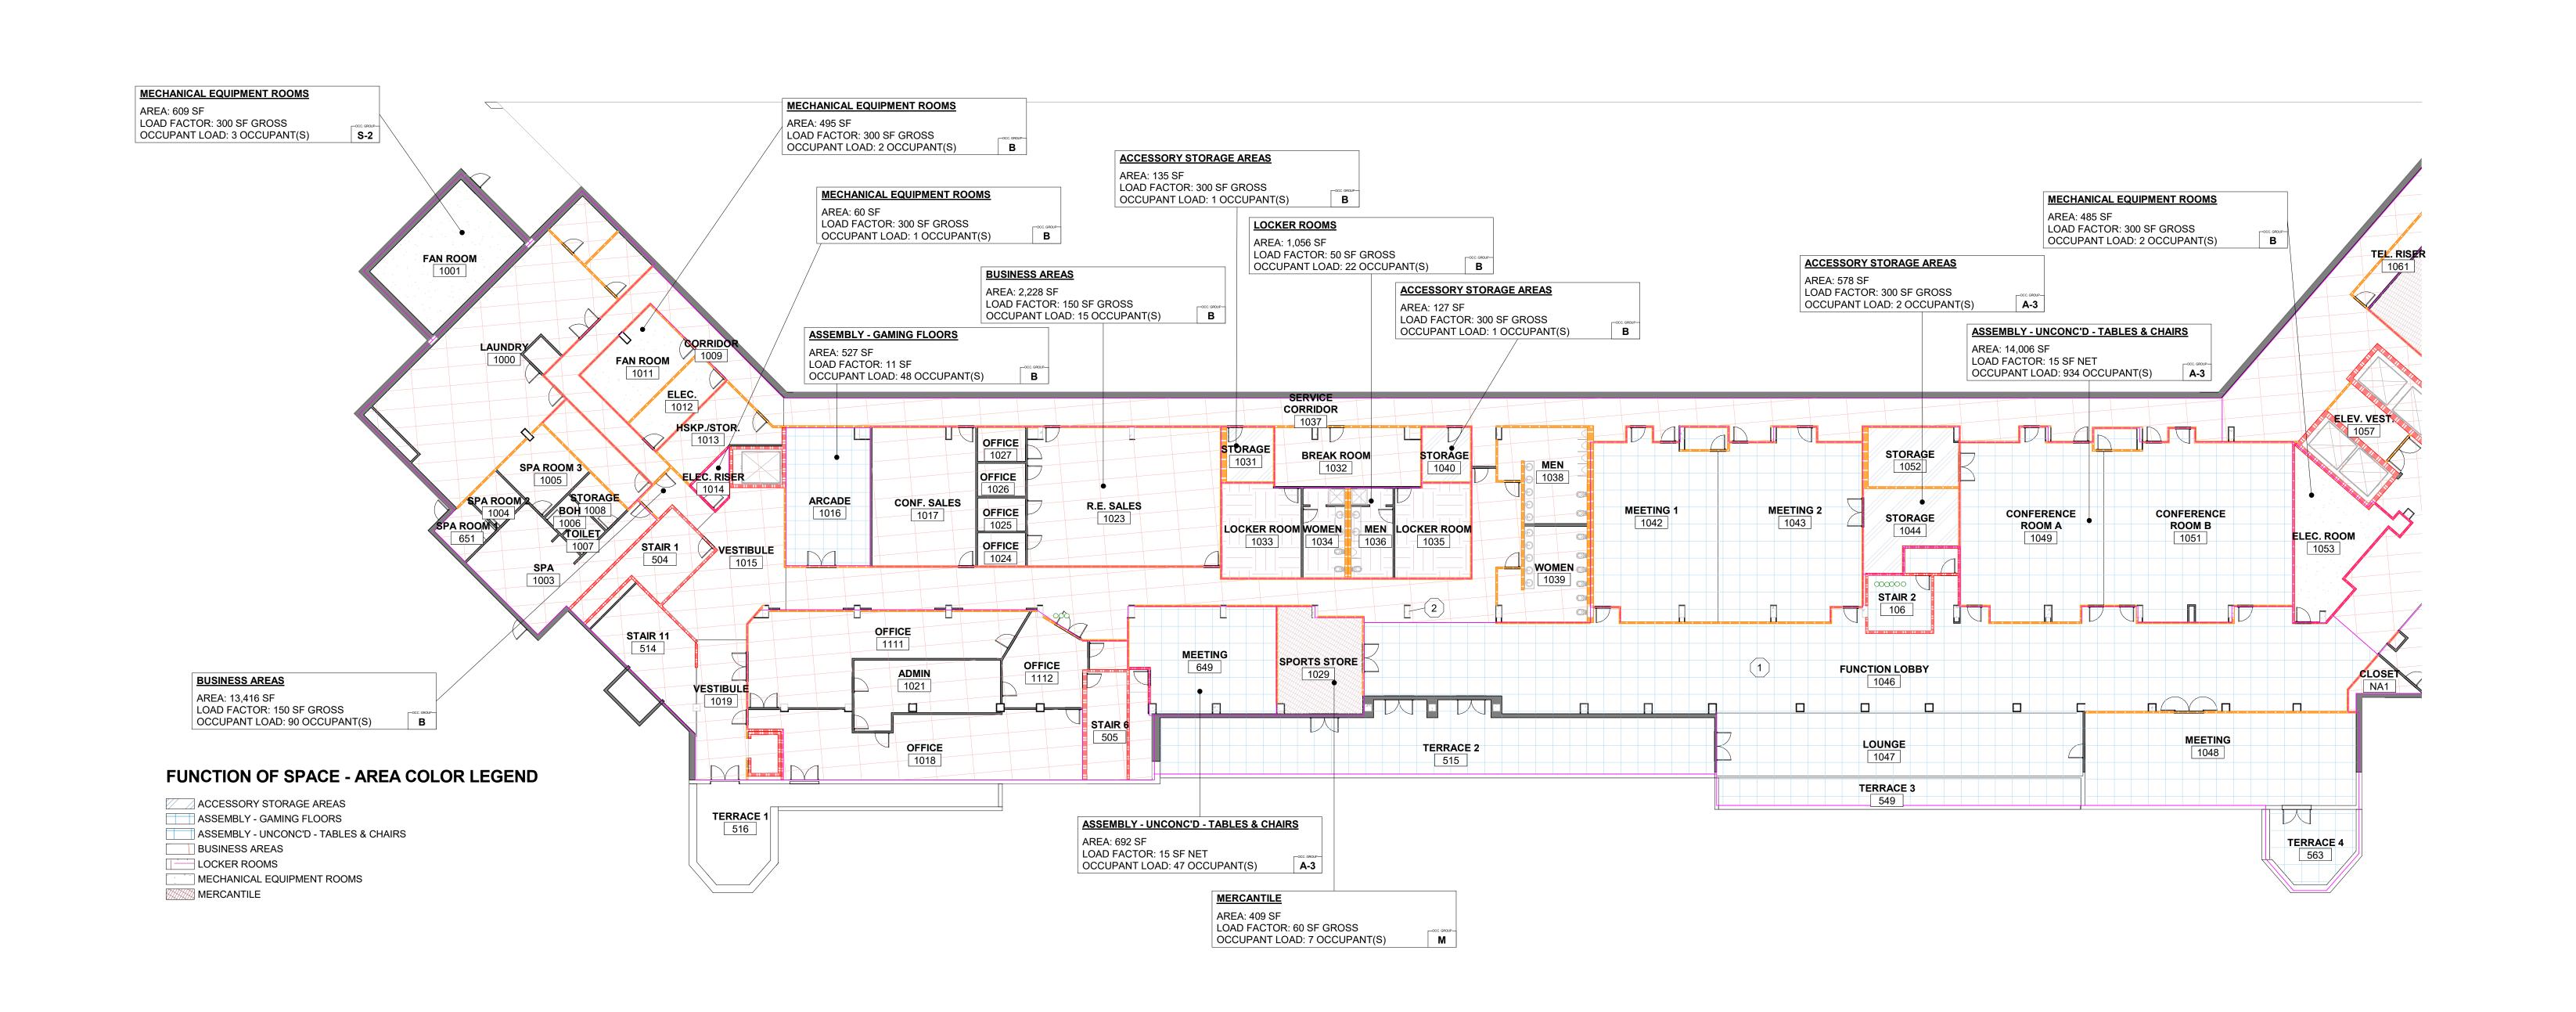
LIFE SAFETY PLAN - PARKING LEVEL AREA B

Sheet Number:

LS-100.B







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05/26/2023

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Sheet Information Sheet Title:


LIFE SAFETY PLAN - LEVEL 1 -AREA A

Sheet Number:

LS-101.A

DPA Project: 21102.00.000

A1 LIFE SAFETY PLAN - LEVEL 1 - AREA A

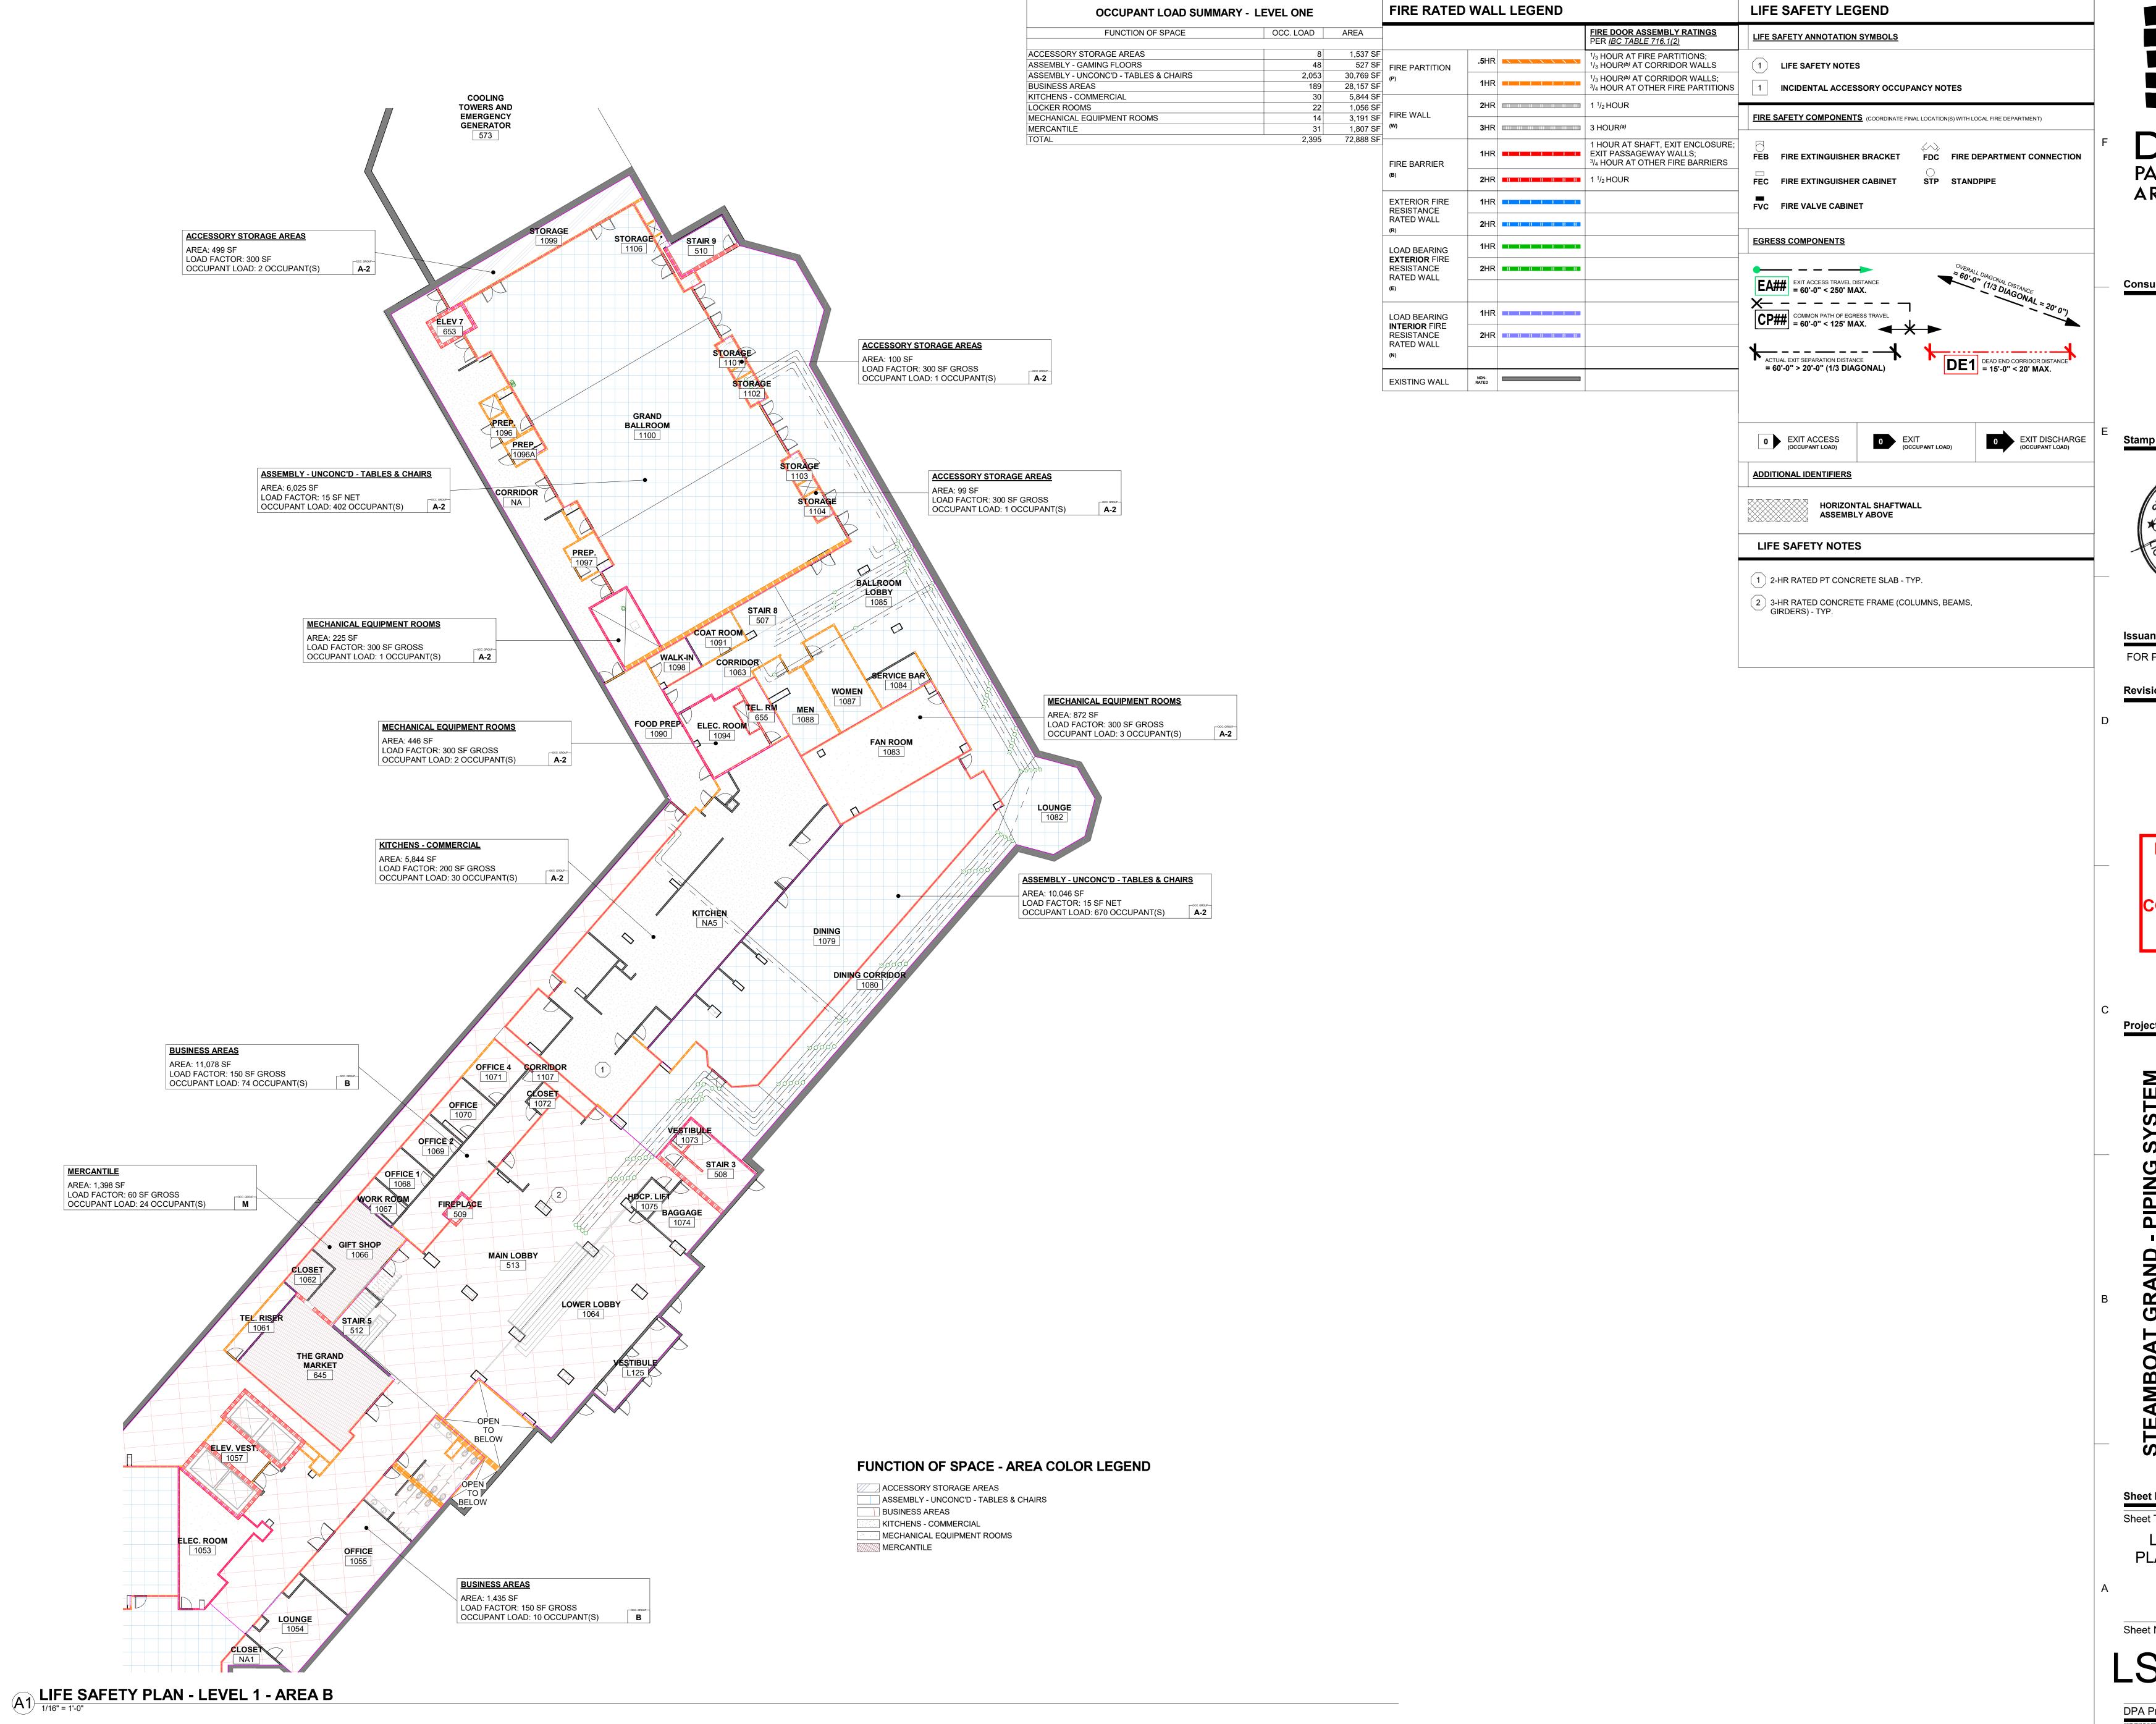

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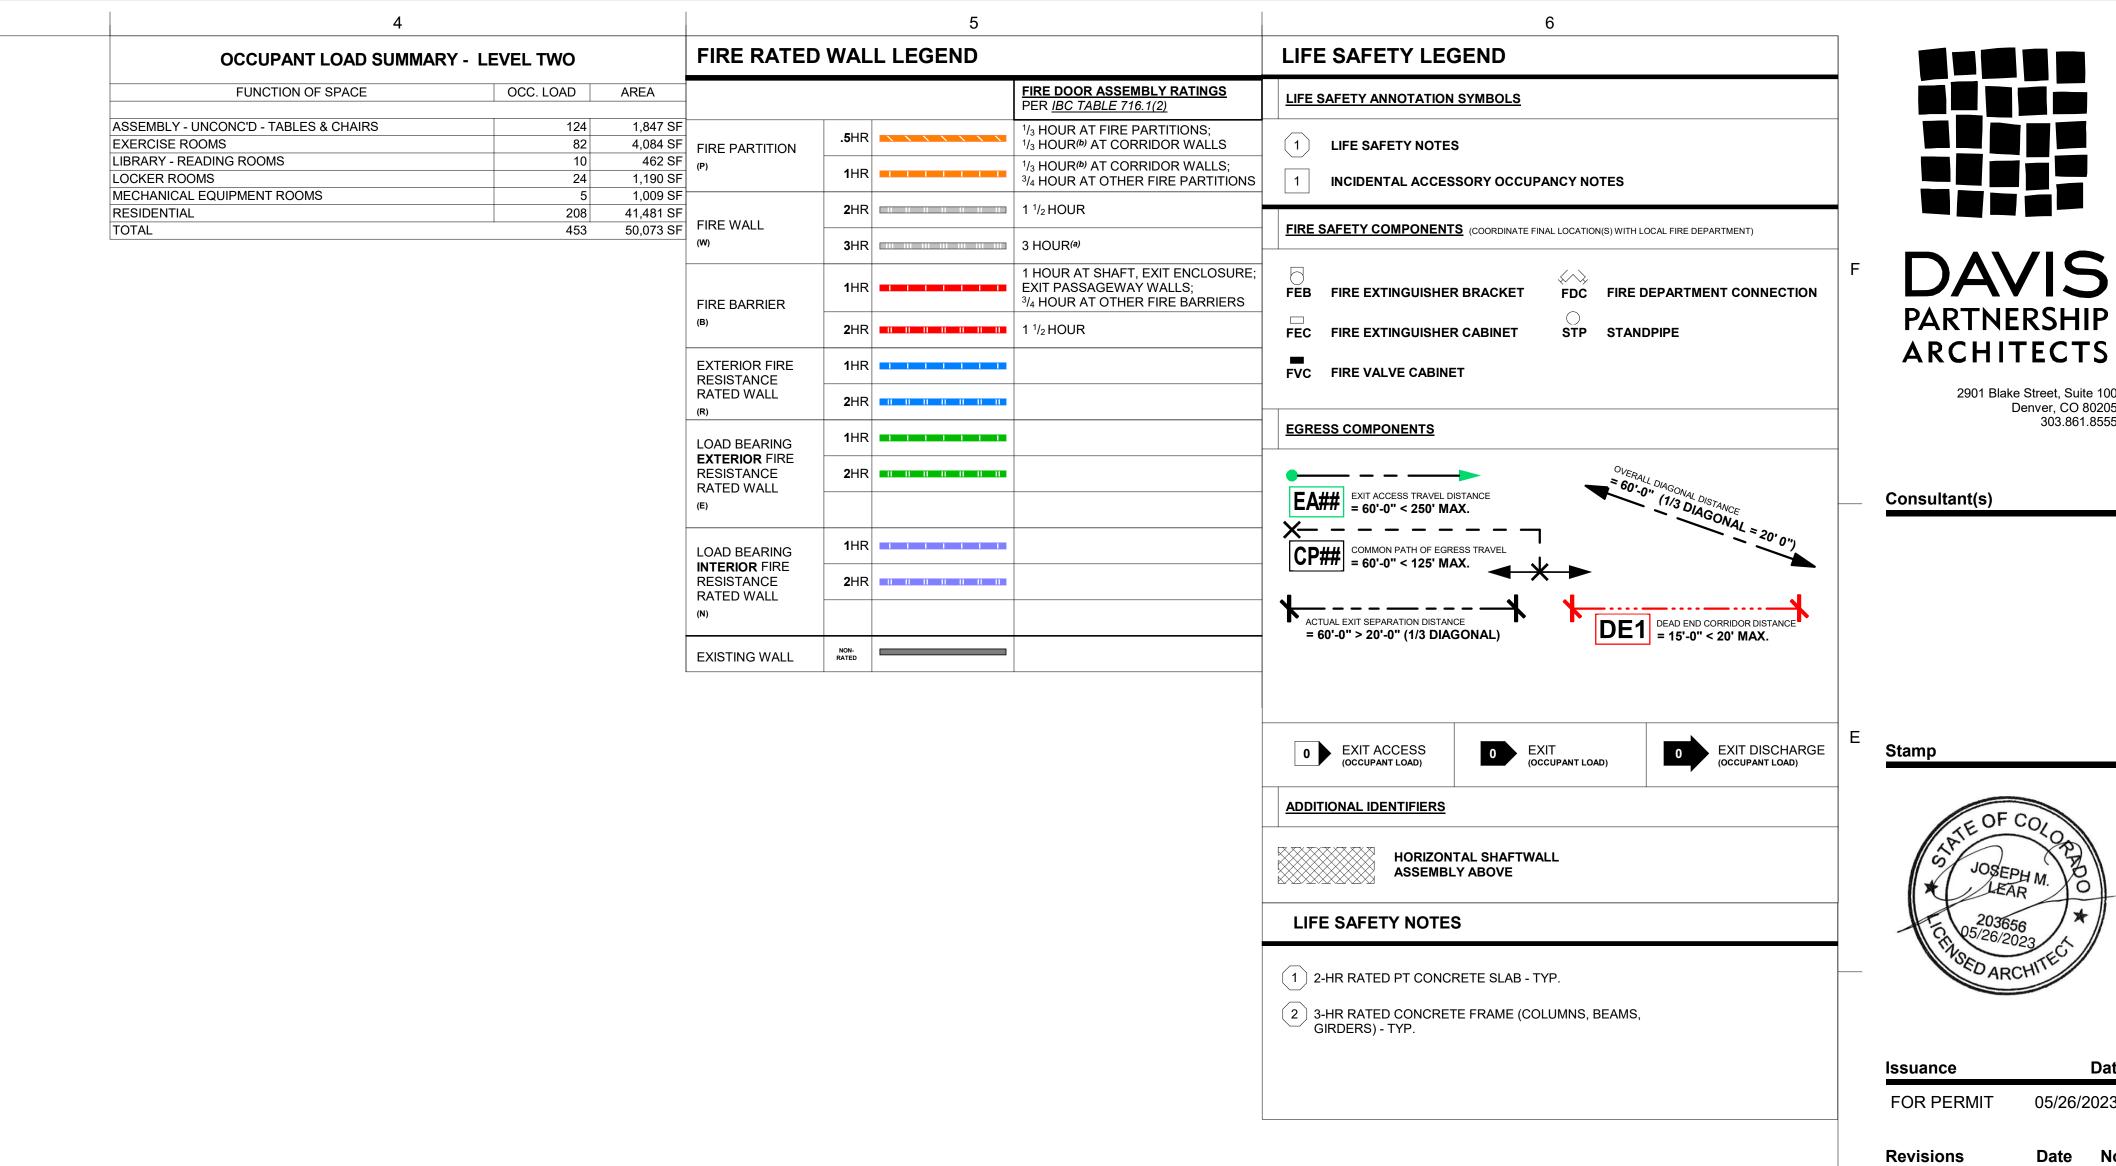
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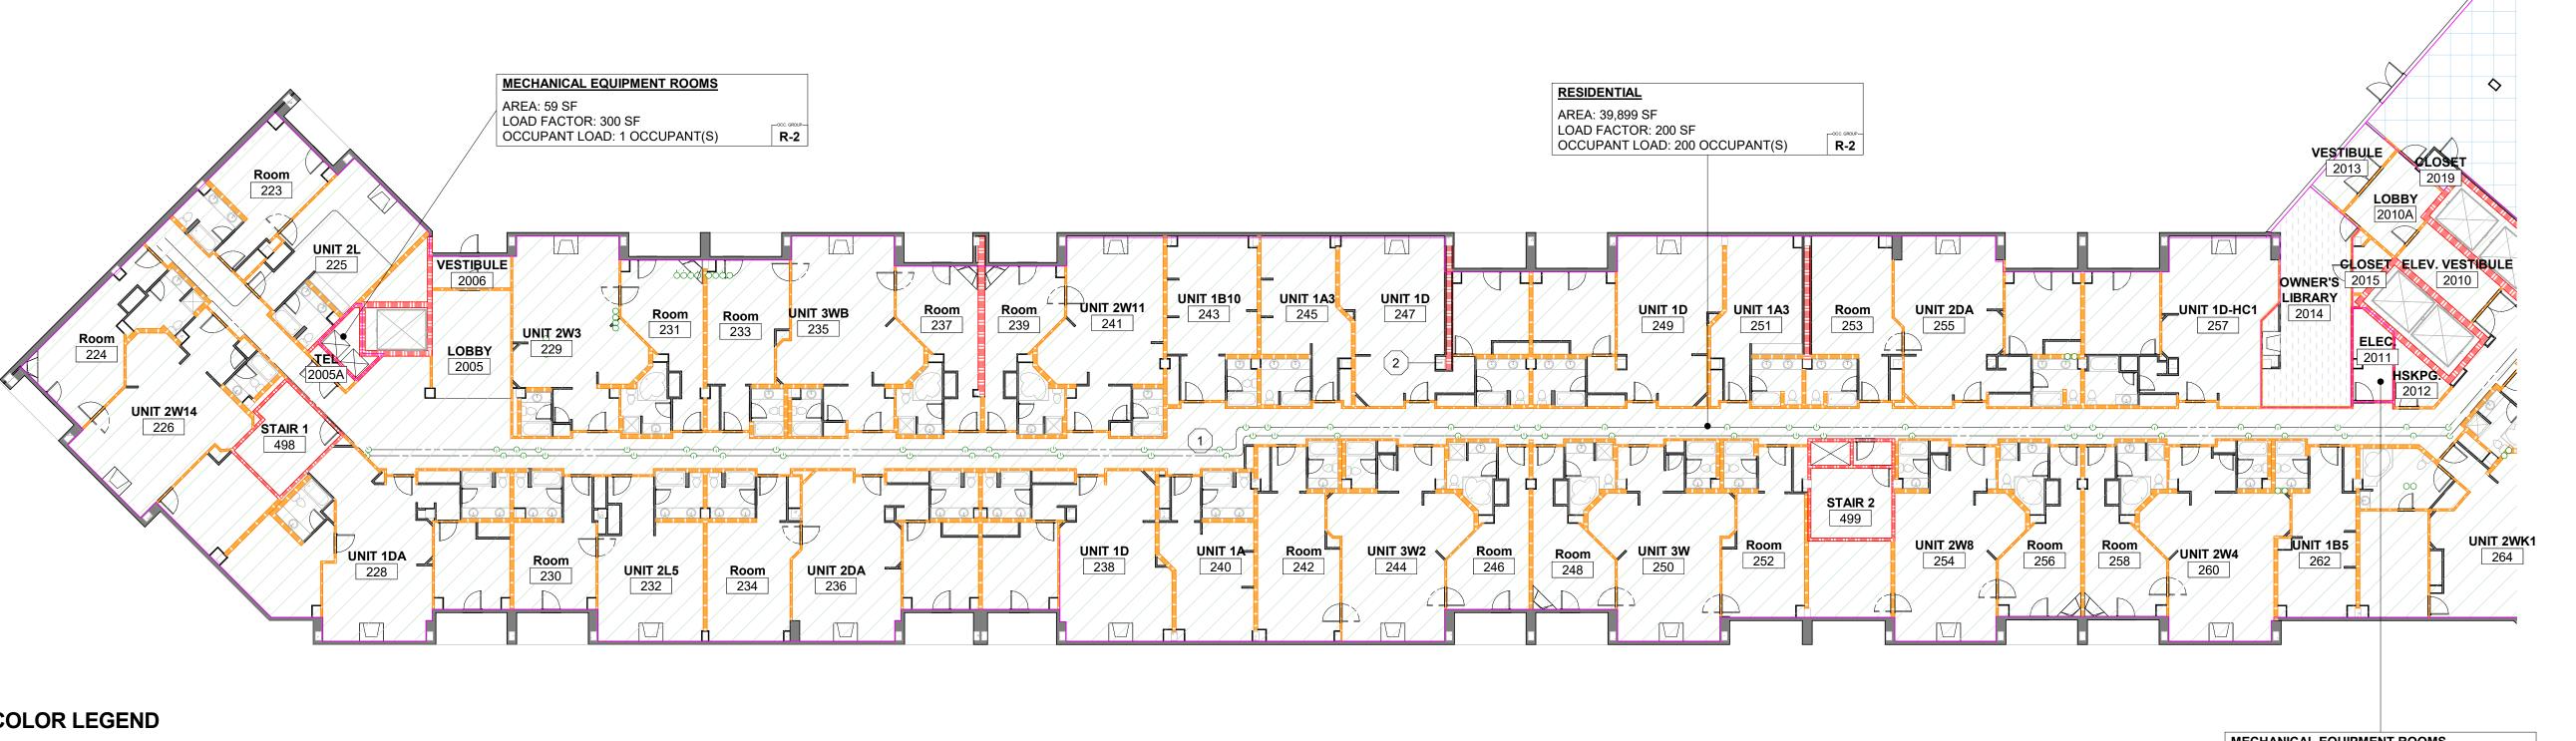
Sheet Title:

LIFE SAFETY PLAN - LEVEL 1 -AREA B

Sheet Number:

LS-101.B





FUNCTION OF SPACE - AREA COLOR LEGEND

ASSEMBLY - UNCONC'D - TABLES & CHAIRS LIBRARY - READING ROOMS MECHANICAL EQUIPMENT ROOMS

RESIDENTIAL

MECHANICAL EQUIPMENT ROOMS AREA: 101 SF LOAD FACTOR: 300 SF OCCUPANT LOAD: 1 OCCUPANT(S)

Sheet Information Sheet Title:

LIFE SAFETY PLAN - LEVEL 2 -AREA A

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Date No.

REVIEWED

CODE

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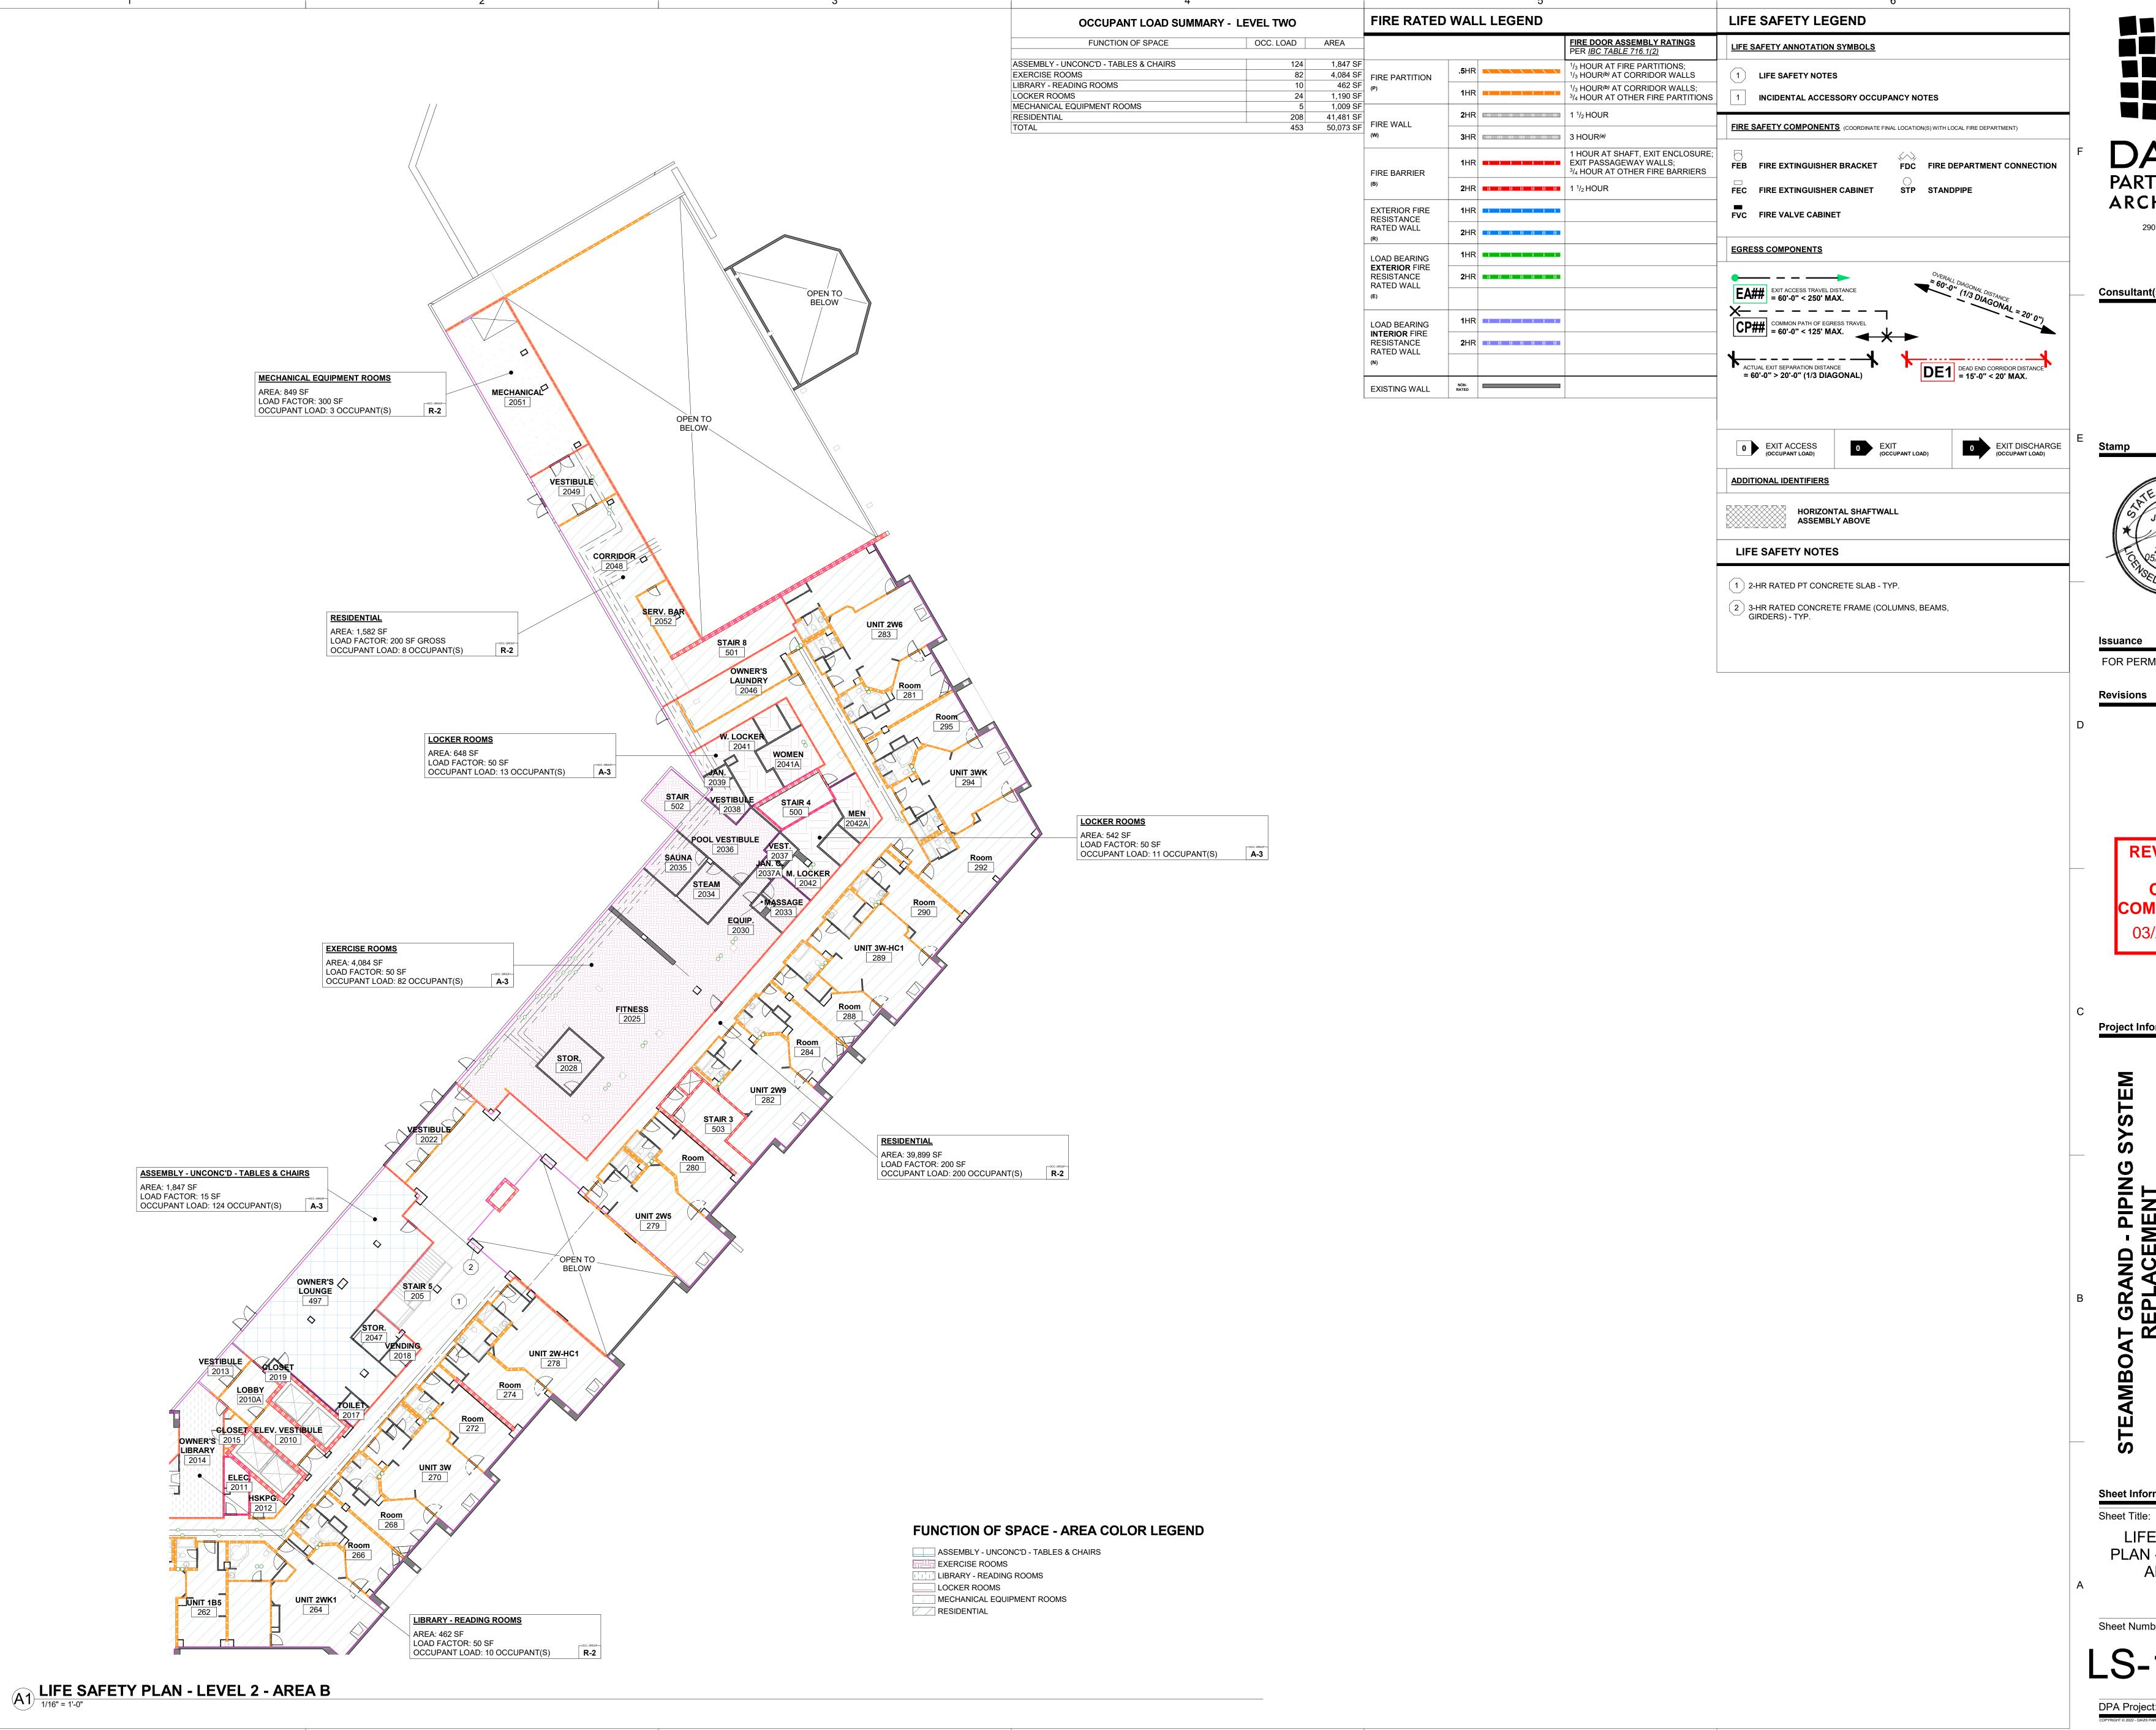
03/21/2024

Project Information

Sheet Number:

LS-102.A

A1 LIFE SAFETY PLAN - LEVEL 2 - AREA A



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Project Information

Sheet Information

LIFE SAFETY PLAN - LEVEL 2 -AREA B

Sheet Number:

LS-102.B

FIRE RATED WALL LEGEND LIFE SAFETY LEGEND OCCUPANT LOAD SUMMARY - LEVEL THREE FIRE DOOR ASSEMBLY RATINGS PER IBC TABLE 716.1(2) FUNCTION OF SPACE OCC. LOAD AREA LIFE SAFETY ANNOTATION SYMBOLS MECHANICAL EQUIPMENT ROOMS ¹/₃ HOUR AT FIRE PARTITIONS; 44,849 SF FIRE PARTITION RESIDENTIAL 225 228 1/3 HOUR(b) AT CORRIDOR WALLS (1) LIFE SAFETY NOTES 45,102 SF 1/3 HOUR(b) AT CORRIDOR WALLS; 3/4 HOUR AT OTHER FIRE PARTITIONS INCIDENTAL ACCESSORY OCCUPANCY NOTES **2**HR 1 1/₂ HOUR FIRE WALL FIRE SAFETY COMPONENTS (COORDINATE FINAL LOCATION(S) WITH LOCAL FIRE DEPARTMENT) 3 HOUR^(a) 1 HOUR AT SHAFT, EXIT ENCLOSURE; EXIT PASSAGEWAY WALLS; FEB FIRE EXTINGUISHER BRACKET FDC FIRE DEPARTMENT CONNECTION 3/4 HOUR AT OTHER FIRE BARRIERS FIRE BARRIER FEC FIRE EXTINGUISHER CABINET STP STANDPIPE FVC FIRE VALVE CABINET **EXTERIOR FIRE** RESISTANCE RATED WALL 2HR | | | | | | | | | | | | | | EGRESS COMPONENTS LOAD BEARING **EXTERIOR** FIRE RESISTANCE RATED WALL EA## EXIT ACCESS TRAVEL DISTANCE = 60'-0" < 250' MAX. CP## = 60'-0" < 125' MAX. 1HR LOAD BEARING **INTERIOR** FIRE RESISTANCE RATED WALL ACTUAL EXIT SEPARATION DISTANCE = 60'-0" > 20'-0" (1/3 DIAGONAL)

DE1 DEAD END CORRIDOR DISTANCE = 15'-0" < 20' MAX. NON-RATED EXISTING WALL 0 EXIT ACCESS (OCCUPANT LOAD) 0 EXIT (OCCUPANT LOAD) ADDITIONAL IDENTIFIERS

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0 EXIT DISCHARGE (OCCUPANT LOAD)

HORIZONTAL SHAFTWALL **ASSEMBLY ABOVE**

LIFE SAFETY NOTES

(1) 2-HR RATED PT CONCRETE SLAB - TYP.

2 3-HR RATED CONCRETE FRAME (COLUMNS, BEAMS, GIRDERS) - TYP.

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Project Information

Sheet Information Sheet Title:

> LIFE SAFETY PLAN - LEVEL 3 -AREA A

Sheet Number:

LS-103.A

DPA Project: 21102.00.000

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MECHANICAL EQUIPMENT ROOMS AREA: 59 SF LOAD FACTOR: 300 SF OCCUPANT LOAD: 1 OCCUPANT(S) RESIDENTIAL AREA: 44,849 SF LOAD FACTOR: 200 SF
OCCUPANT LOAD: 225 OCCUPANT(S)

R-2 UNIT 1A

FUNCTION OF SPACE - AREA COLOR LEGEND

MECHANICAL EQUIPMENT ROOMS RESIDENTIAL

LIFE SAFETY PLAN - LEVEL 3 - AREA A


FIRE		VEL THREE	OCCUPANT LOAD SUMMARY - LE
	AREA	OCC. LOAD	FUNCTION OF SPACE
	253 SF	3	MECHANICAL EQUIPMENT ROOMS
FIRE PA	44,849 SF	225	RESIDENTIAL
(P)	45,102 SF	228	TOTAL
1 ` ′			<u> </u>

	FIRE RATED	WAL	L LEGEND		LIFE SAFETY LEGEND
				FIRE DOOR ASSEMBLY RATINGS PER IBC TABLE 716.1(2)	LIFE SAFETY ANNOTATION SYMBOLS
SF SF	FIRE PARTITION	.5 HR		1/3 HOUR AT FIRE PARTITIONS; 1/3 HOUR(*) AT CORRIDOR WALLS	1 LIFE SAFETY NOTES
SF	(P)	1HR		1/3 HOUR(b) AT CORRIDOR WALLS; 3/4 HOUR AT OTHER FIRE PARTITIONS	1 INCIDENTAL ACCESSORY OCCUPANCY NOTES
	FIRE WALL	2 HR		1 ¹ / ₂ HOUR	FIDE OAFETY COMPONENTO
	(W)	3 HR		3 HOUR ^(a)	FIRE SAFETY COMPONENTS (COORDINATE FINAL LOCATION(S) WITH LOCAL FIRE DEPARTMENT)
	FIRE BARRIER	1HR		1 HOUR AT SHAFT, EXIT ENCLOSURE; EXIT PASSAGEWAY WALLS; ³ / ₄ HOUR AT OTHER FIRE BARRIERS	FEB FIRE EXTINGUISHER BRACKET FDC FIRE DEPARTMENT CONNEC
	(B)	2 HR	11 11 11 11 11 11	1 ¹ / ₂ HOUR	FEC FIRE EXTINGUISHER CABINET STP STANDPIPE
	EXTERIOR FIRE RESISTANCE	1HR			FVC FIRE VALVE CABINET
	RATED WALL	2HR	11 11 11 11 11 11		
	LOAD BEARING	1HR			EGRESS COMPONENTS
	EXTERIOR FIRE RESISTANCE RATED WALL	2 HR	11 11 11 11 11 11		OVERALL DIACO
	(E)				EA## EXIT ACCESS TRAVEL DISTANCE = 60'-0" < 250' MAX.
	LOAD BEARING	1HR			EA## EXIT ACCESS TRAVEL DISTANCE = 60'-0" < 250' MAX. CP## = 60'-0" < 125' MAX.
	INTERIOR FIRE RESISTANCE RATED WALL	2 HR	11 11 11 11 11 11		- 1 - 00 - 0
	(N)				ACTUAL EXIT SEPARATION DISTANCE = 60'-0" > 20'-0" (1/3 DIAGONAL) DE1 DEAD END CORRIDOR DISTANCE = 15'-0" < 20' MAX.
	EXISTING WALL	NON- RATED			- 50-0 7 20-0 (110 DIAGONAL) - 15-0 < 20 MAX.

LIFE SAFETY NOTES

1 2-HR RATED PT CONCRETE SLAB - TYP.

2 3-HR RATED CONCRETE FRAME (COLUMNS, BEAMS, GIRDERS) - TYP.

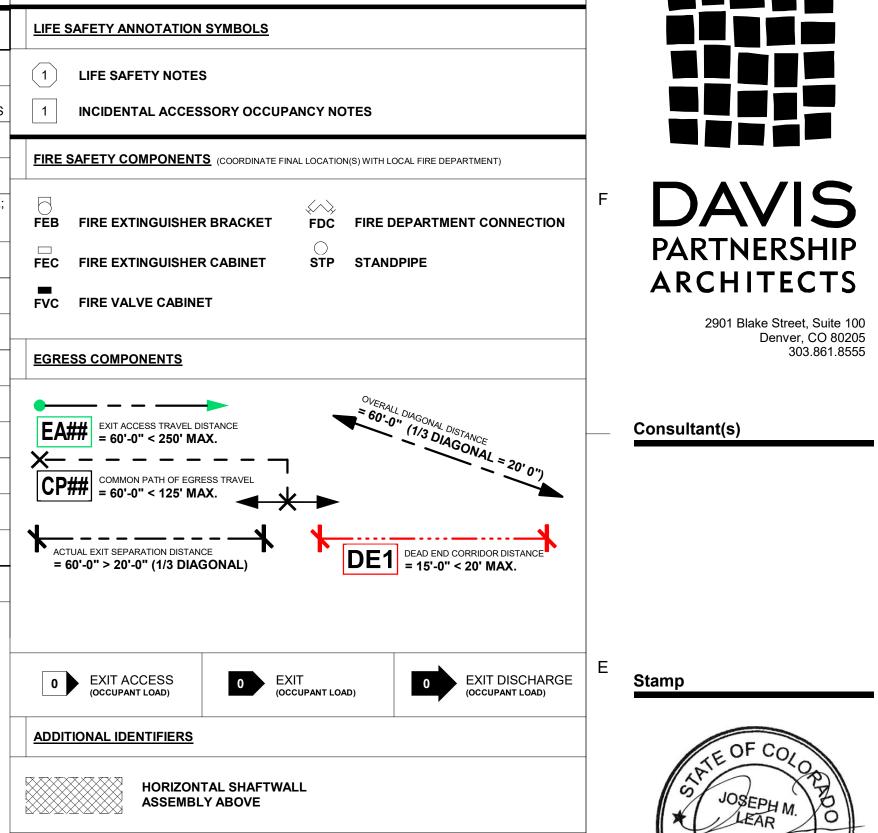



FOR PERMIT 05/26/2023

Revisions Date No.

Revisions Date No

REVIEWED FOR CODE COMPLIANCE 03/21/2024

Project Information

MBOAI GRAND - PIPING SYSTEM
REPLACEMENT
2300 MT WERNER CIR,
STEAMBOAT SPRINGS, CO 80487

Sheet Information
Sheet Title:

LIFE SAFETY PLAN - LEVEL 3 -AREA B

Sheet Number:

LS-103.B



OCCUPANT LOAD SUMMARY - LEVEL FOUR FUNCTION OF SPACE OCC. LOAD AREA MECHANICAL EQUIPMENT ROOMS RESIDENTIAL 46,226 SF

FIRE RATED WALL LEGEND LIFE SAFETY LEGEND FIRE DOOR ASSEMBLY RATINGS PER IBC TABLE 716.1(2) LIFE SAFETY ANNOTATION SYMBOLS ¹/₃ HOUR AT FIRE PARTITIONS; 45,985 SF FIRE PARTITION 1/3 HOUR(b) AT CORRIDOR WALLS (1) LIFE SAFETY NOTES 1/3 HOUR(b) AT CORRIDOR WALLS; 3/4 HOUR AT OTHER FIRE PARTITIONS INCIDENTAL ACCESSORY OCCUPANCY NOTES **2**HR 1 1/₂ HOUR FIRE WALL FIRE SAFETY COMPONENTS (COORDINATE FINAL LOCATION(S) WITH LOCAL FIRE DEPARTMENT) 3 HOUR^(a) 1 HOUR AT SHAFT, EXIT ENCLOSURE; EXIT PASSAGEWAY WALLS; FEB FIRE EXTINGUISHER BRACKET FDC FIRE DEPARTMENT CONNECTION 3/4 HOUR AT OTHER FIRE BARRIERS FIRE BARRIER FEC FIRE EXTINGUISHER CABINET STP STANDPIPE FVC FIRE VALVE CABINET **EXTERIOR FIRE** RESISTANCE RATED WALL **2**HR EGRESS COMPONENTS LOAD BEARING **EXTERIOR** FIRE RESISTANCE RATED WALL EA## EXIT ACCESS TRAVEL DISTANCE = 60'-0" < 250' MAX. CP## = 60'-0" < 125' MAX. 1HR LOAD BEARING **INTERIOR** FIRE RESISTANCE RATED WALL ACTUAL EXIT SEPARATION DISTANCE = 60'-0" > 20'-0" (1/3 DIAGONAL)

DE1 DEAD END CORRIDOR DISTANCE = 15'-0" < 20' MAX. NON-RATED EXISTING WALL 0 EXIT DISCHARGE (OCCUPANT LOAD) 0 EXIT ACCESS (OCCUPANT LOAD) 0 EXIT (OCCUPANT LOAD) ADDITIONAL IDENTIFIERS

DAVIS PARTNERSHIP ARCHITECTS 2901 Blake Street, Suite 100 Denver, CO 80205 303.861.8555

Consultant(s)

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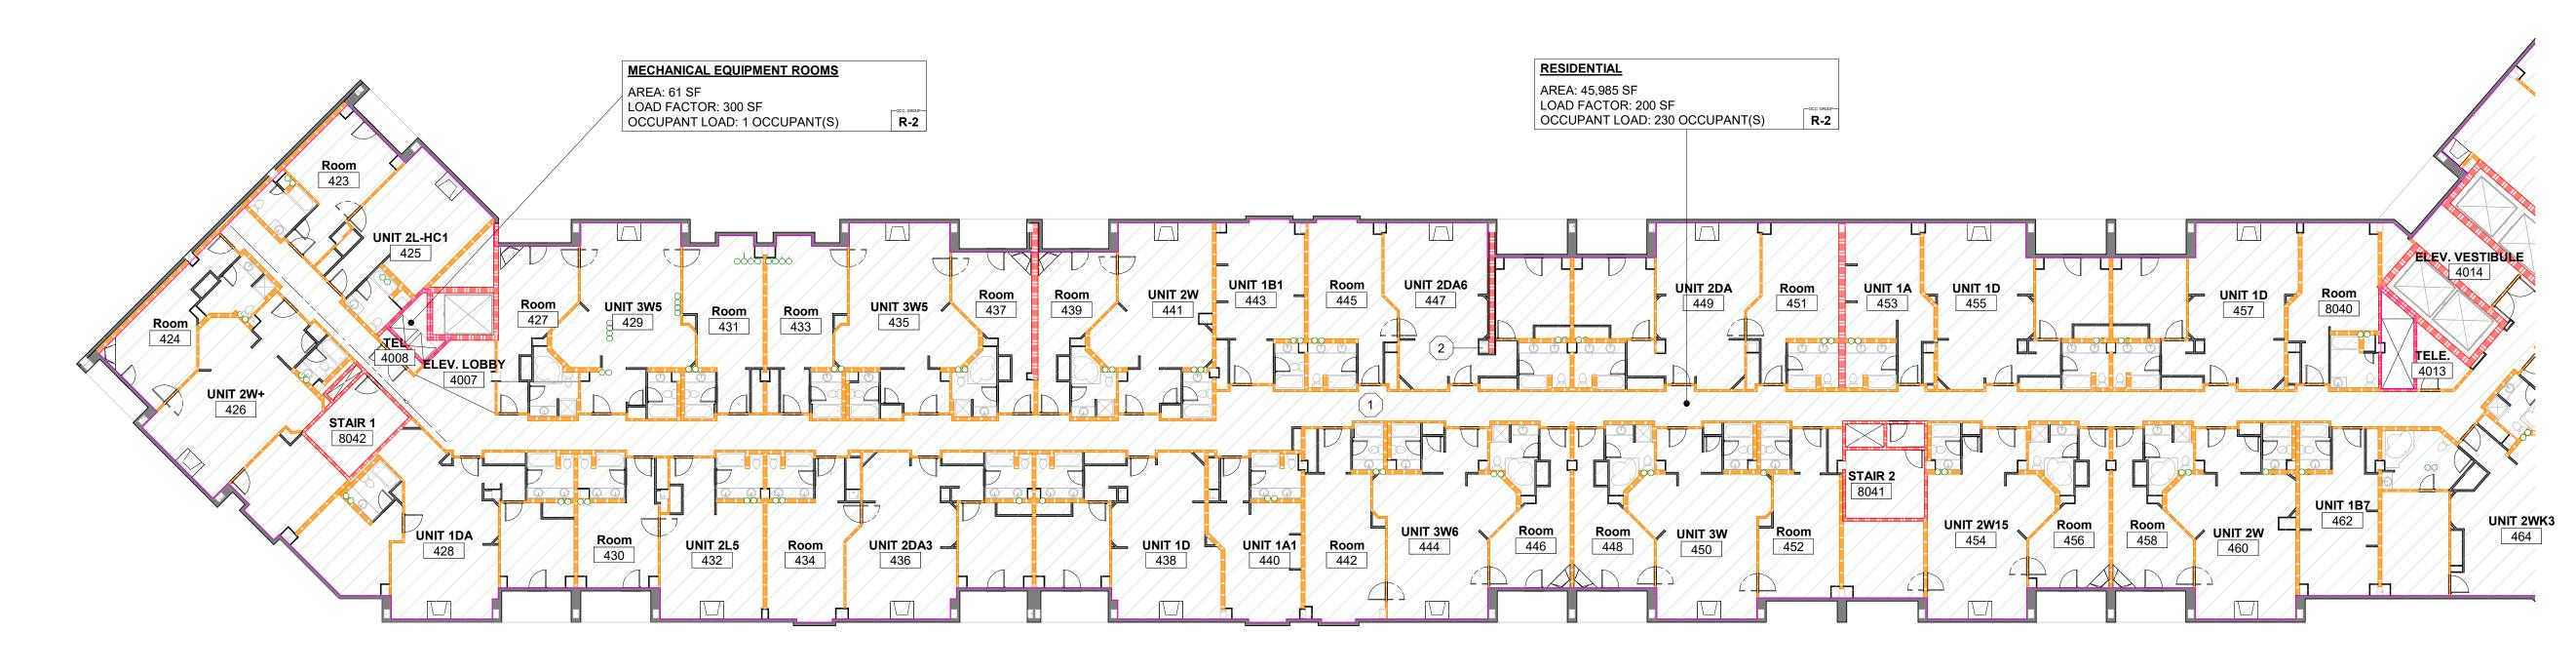
Date No. Revisions

> CODE 03/21/2024

Project Information

Sheet Title: LIFE SAFETY PLAN - LEVEL 4 -

Sheet Number:



FUNCTION OF SPACE - AREA COLOR LEGEND

MECHANICAL EQUIPMENT ROOMS RESIDENTIAL

A1 LIFE SAFETY PLAN - LEVEL 4 - AREA A

HORIZONTAL SHAFTWALL **ASSEMBLY ABOVE**

LIFE SAFETY NOTES

(1) 2-HR RATED PT CONCRETE SLAB - TYP. 2 3-HR RATED CONCRETE FRAME (COLUMNS, BEAMS, GIRDERS) - TYP.


> **REVIEWED** COMPLIANCE

Sheet Information

AREA A


OCCUPANT LOAD SUMMARY - LEV	/EL FOUR		FI
FUNCTION OF SPACE	OCC. LOAD	AREA	
MECHANICAL EQUIPMENT ROOMS	3	241 SF	
RESIDENTIAL	230	45,985 SF	FIR
TOTAL	233	46,226 SF	(P)

	FIRE RATED	WALL	LEGEND		LIFE SAFETY LEGEND
١				FIRE DOOR ASSEMBLY RATINGS PER IBC TABLE 716.1(2)	LIFE SAFETY ANNOTATION SYMBOLS
41 SF 85 SF	FIRE PARTITION	. 5 HR =		1/3 HOUR AT FIRE PARTITIONS; 1/3 HOUR ^(b) AT CORRIDOR WALLS	1 LIFE SAFETY NOTES
26 SF	(P)	1HR		1/3 HOUR ^(b) AT CORRIDOR WALLS; 3/4 HOUR AT OTHER FIRE PARTITIONS	1 INCIDENTAL ACCESSORY OCCUPANCY NOTES
	FIRE WALL	2HR =		1 ¹ / ₂ HOUR	FIRE SAFETY COMPONENTS (COORDINATE FINAL LOCATION(S) WITH LOCAL FIRE DEPARTMENT)
	(W)	3 HR ■		3 HOUR ^(a)	COOKBINATE TIME EGOATION(O) WITH EGOAL TIME BELL ANTIMENTY
	FIRE BARRIER	1HR		1 HOUR AT SHAFT, EXIT ENCLOSURE EXIT PASSAGEWAY WALLS; ³ / ₄ HOUR AT OTHER FIRE BARRIERS	FEB FIRE EXTINGUISHER BRACKET FDC FIRE DEPARTMENT CONNECTION
	(B)	2 HR	11 11 11 11 11 11	1 ¹ / ₂ HOUR	FEC FIRE EXTINGUISHER CABINET STP STANDPIPE
	EXTERIOR FIRE RESISTANCE	1HR			FVC FIRE VALVE CABINET
	RATED WALL (R)	2 HR	11 11 11 11 11		
	LOAD BEARING	1HR			EGRESS COMPONENTS
	EXTERIOR FIRE RESISTANCE RATED WALL	2HR	11 11 11 11 11 11		EA## EXIT ACCESS TRAVEL DISTANCE = 60'-0" < 250' MAX. CD## COMMON PATH OF EGRESS TRAVEL
	(E)				EA## EXIT ACCESS TRAVEL DISTANCE = 60'-0" < 250' MAX.
	LOAD BEARING	1HR			CP## = 60'-0" < 125' MAX.
	INTERIOR FIRE RESISTANCE RATED WALL	2 HR	11 11 11 11 11 11		CF## = 60'-0" < 125' MAX.
	(N)				ACTUAL EXIT SEPARATION DISTANCE - 60' 0" > 20' 0" (1/2 PIAGONAL)
	EXISTING WALL	NON- RATED			= 60'-0" > 20'-0" (1/3 DIAGONAL) = 15'-0" < 20' MAX.

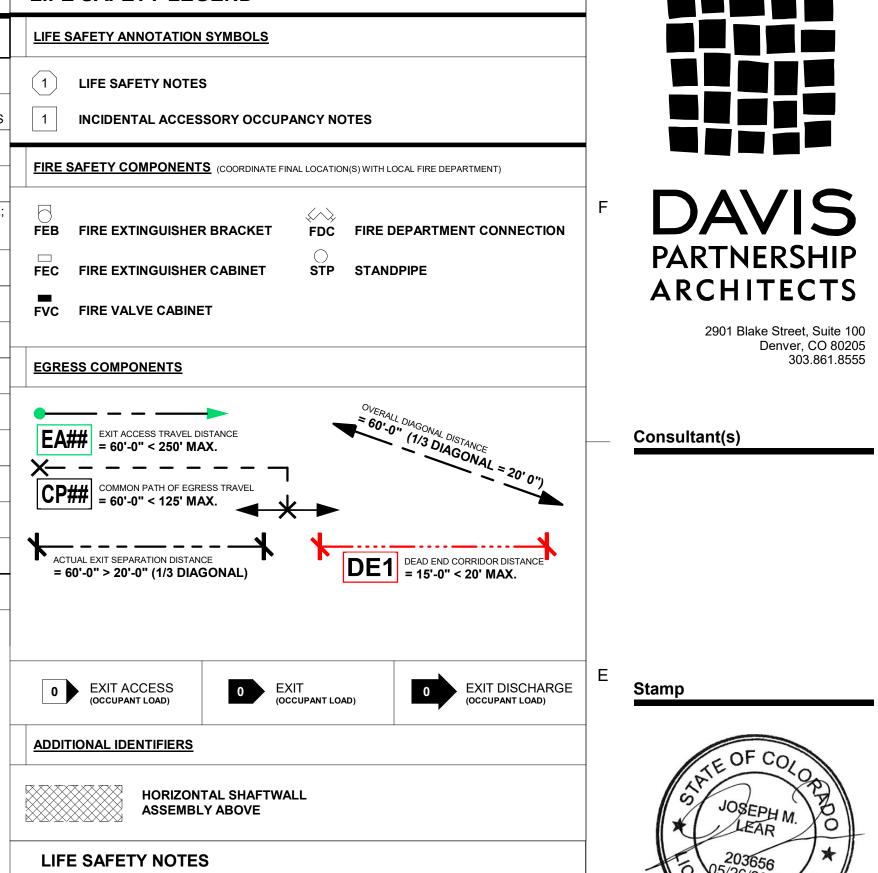

1 2-HR RATED PT CONCRETE SLAB - TYP.

2 3-HR RATED CONCRETE FRAME (COLUMNS, BEAMS, GIRDERS) - TYP.

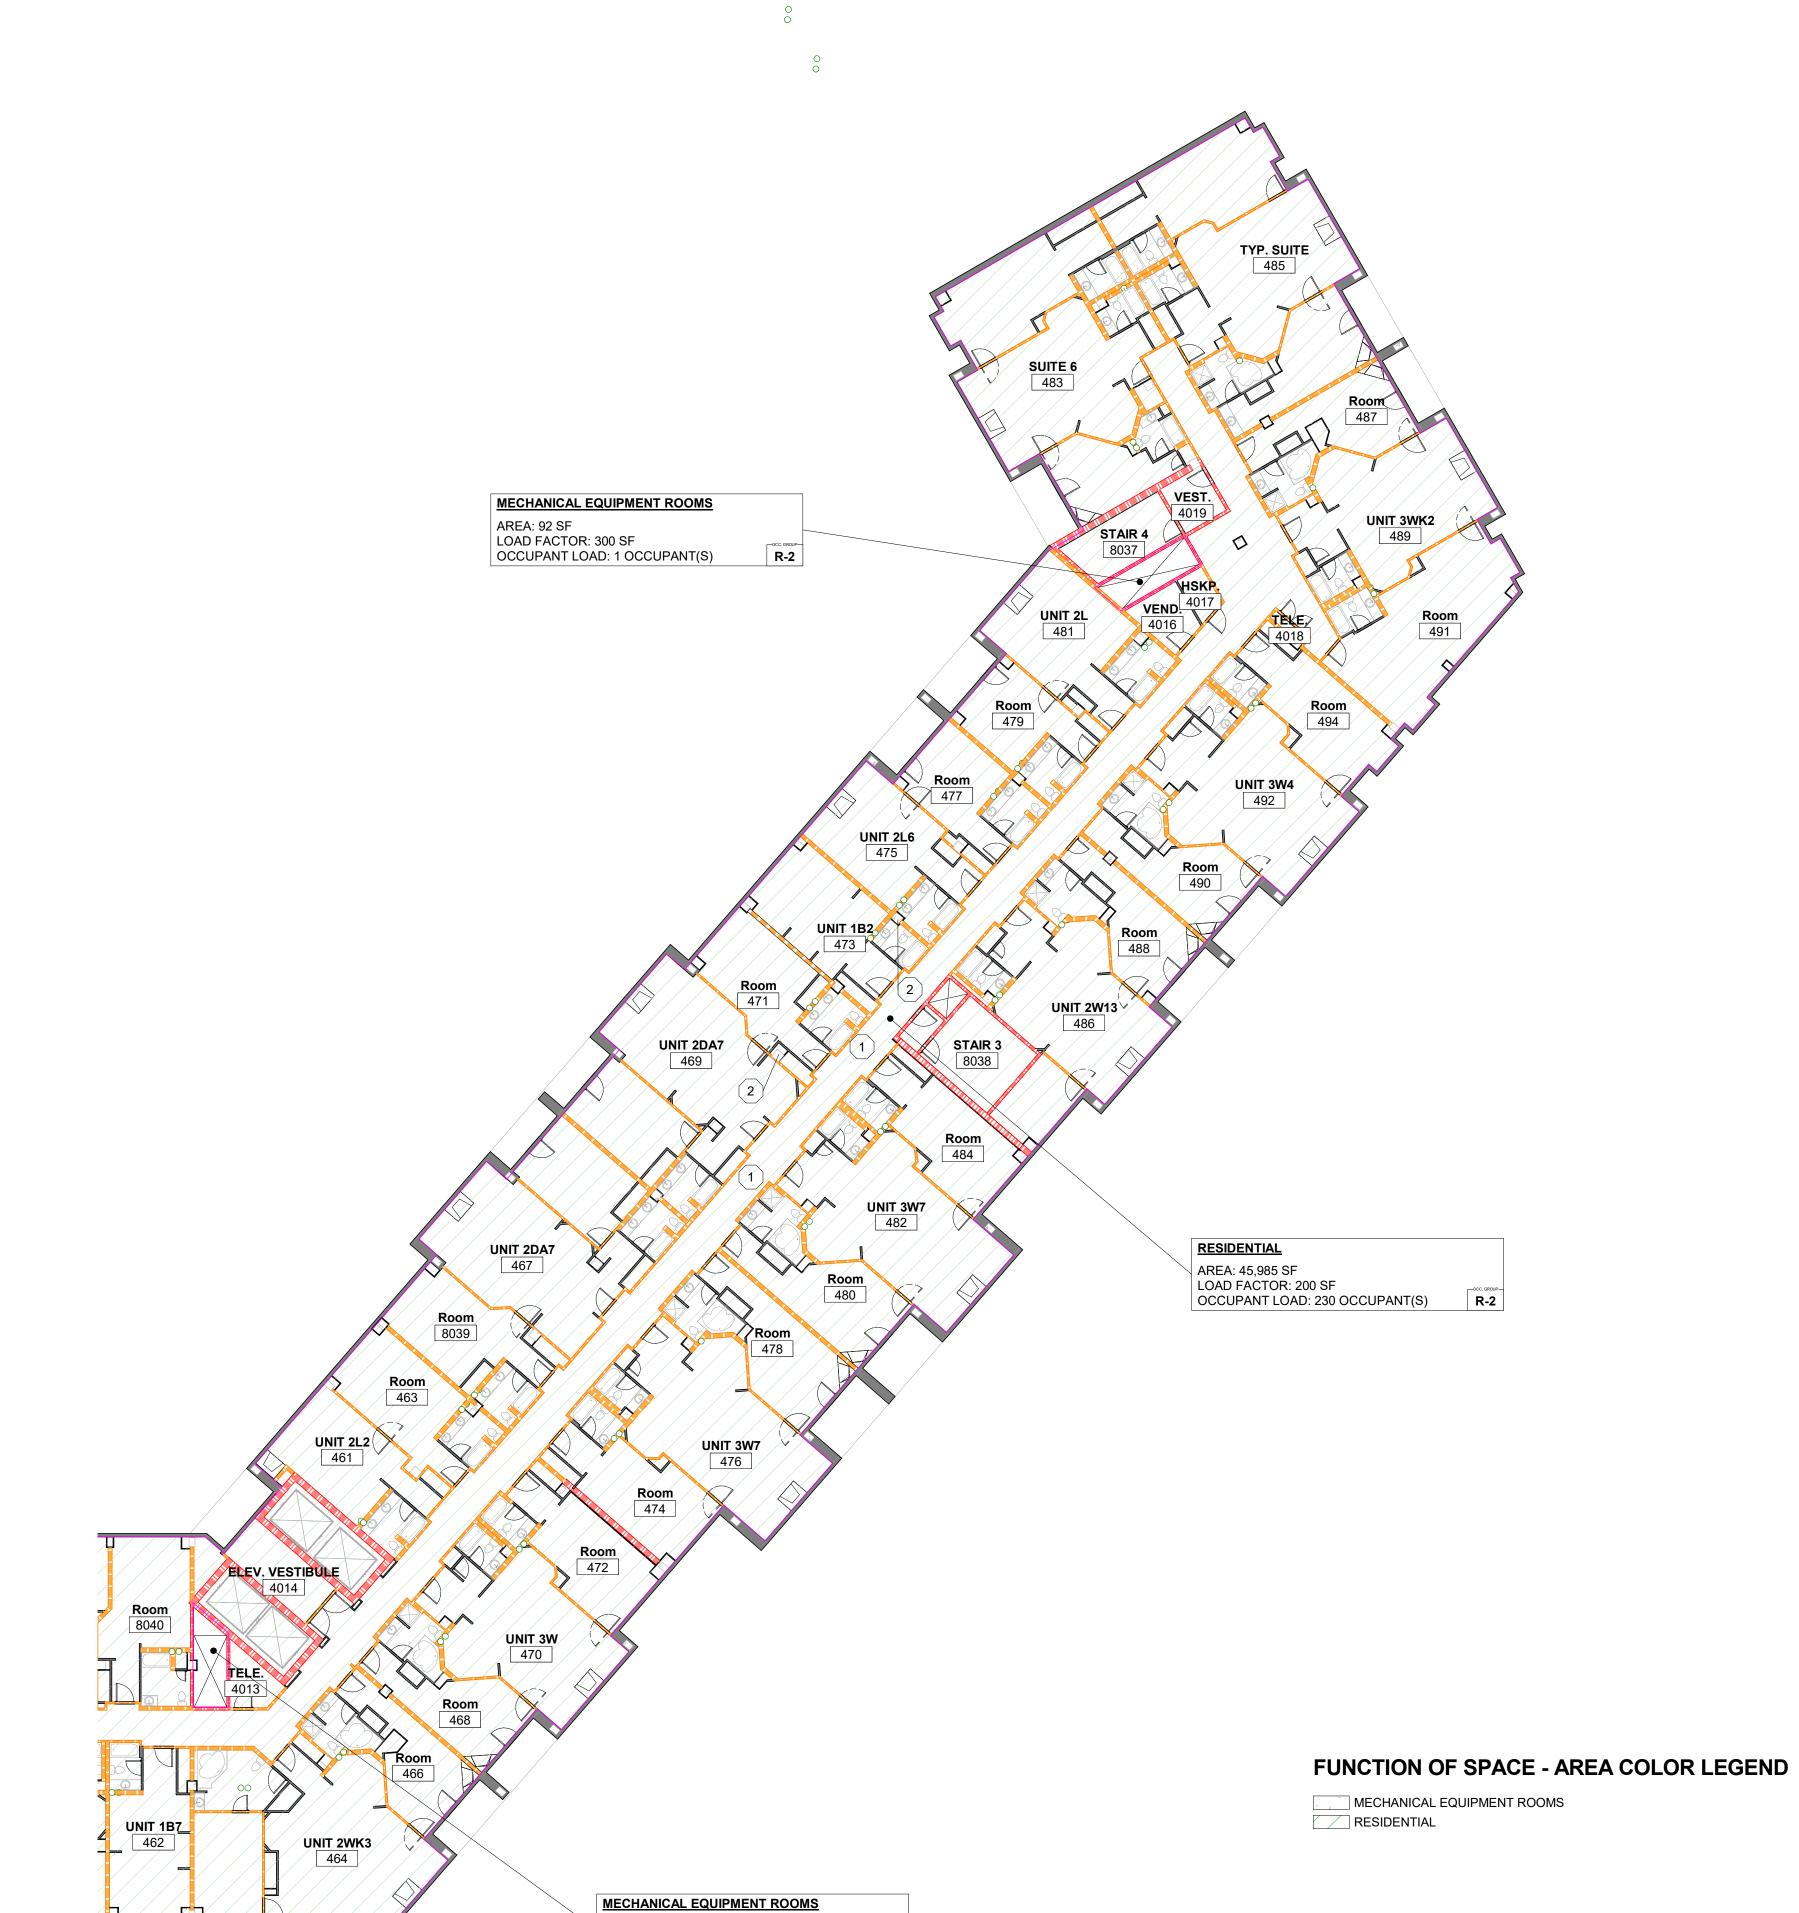

AREA: 88 SF LOAD FACTOR: 300 SF OCCUPANT LOAD: 1 OCCUPANT(S)

A1 LIFE SAFTEY PLAN - LEVEL 4 - AREA B

CODE COMPLIANCE

Project Information

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Sheet Information

Sheet Title: LIFE SAFETY PLAN - LEVEL 4 -


AREA B

Sheet Number:

LS-104.B

FIF		LEVEL FIVE	OCCUPANT LOAD SUMMARY - L
	AREA	OCC. LOAD	FUNCTION OF SPACE
_	247 SF	3	CHANICAL EQUIPMENT ROOMS
-	46,128 SF	231	SIDENTIAL
	46,375 SF	234	TAL

	FIRE RATED	WAL	L LEGEND		LIFE SAFETY LEGEND
				FIRE DOOR ASSEMBLY RATINGS PER IBC TABLE 716.1(2)	LIFE SAFETY ANNOTATION SYMBOLS
7 SF 8 SF	FIRE PARTITION	. 5 HR		1/ ₃ HOUR AT FIRE PARTITIONS; 1/ ₃ HOUR ^(b) AT CORRIDOR WALLS	1 LIFE SAFETY NOTES
5 SF	(P)	1HR		1/3 HOUR(b) AT CORRIDOR WALLS; 3/4 HOUR AT OTHER FIRE PARTITIONS	1 INCIDENTAL ACCESSORY OCCUPANCY NOTES
	FIRE WALL	2 HR		1 ¹ / ₂ HOUR	FIRE SAFETY COMPONENTS (COORDINATE FINAL LOCATION(S) WITH LOCAL FIRE DEPARTMENT)
	(W)	3HR		3 HOUR ^(a)	(COORDINATE FINAL LOCATION(S) WITH LOCAL FIRE DEPARTMENT)
	FIRE BARRIER	1HR		1 HOUR AT SHAFT, EXIT ENCLOSURE; EXIT PASSAGEWAY WALLS; 3/4 HOUR AT OTHER FIRE BARRIERS	FEB FIRE EXTINGUISHER BRACKET FDC FIRE DEPARTMENT CONNECT
	(B)	2HR		1 ¹ / ₂ HOUR	FEC FIRE EXTINGUISHER CABINET STP STANDPIPE
	EXTERIOR FIRE RESISTANCE	1HR			FVC FIRE VALVE CABINET
	RATED WALL	2HR	11 11 11 11 11 11		
	LOAD BEARING	1HR			EGRESS COMPONENTS
	EXTERIOR FIRE RESISTANCE RATED WALL	2 HR	11 11 11 11 11 11		OVERALL DIAGO
	(E)				EA## EXIT ACCESS TRAVEL DISTANCE = 60'-0" < 250' MAX. (1/3 DIAGONA)
	LOAD BEARING	1HR			EA## EXIT ACCESS TRAVEL DISTANCE = 60'-0" < 250' MAX. CP## = 60'-0" < 125' MAX.
	INTERIOR FIRE RESISTANCE RATED WALL	2HR	11 11 11 11 11 11		= 60 -0 < 125 IVIAA.
	(N)				ACTUAL EXIT SEPARATION DISTANCE = 60'-0" > 20'-0" (1/3 DIAGONAL) DE1 DE2 DE3 DE3 DE3 DE3 DE3 DE3 DE3
	EXISTING WALL	NON- RATED			= 60'-0" > 20'-0" (1/3 DIAGONAL)

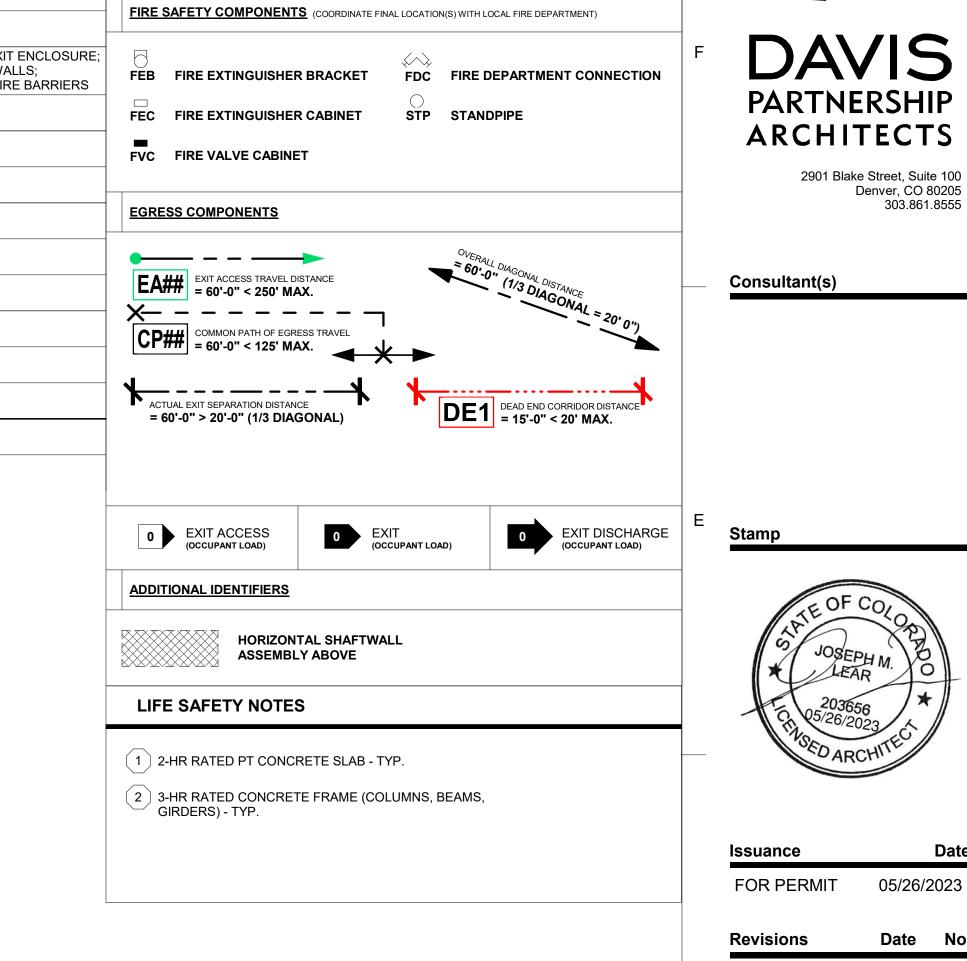

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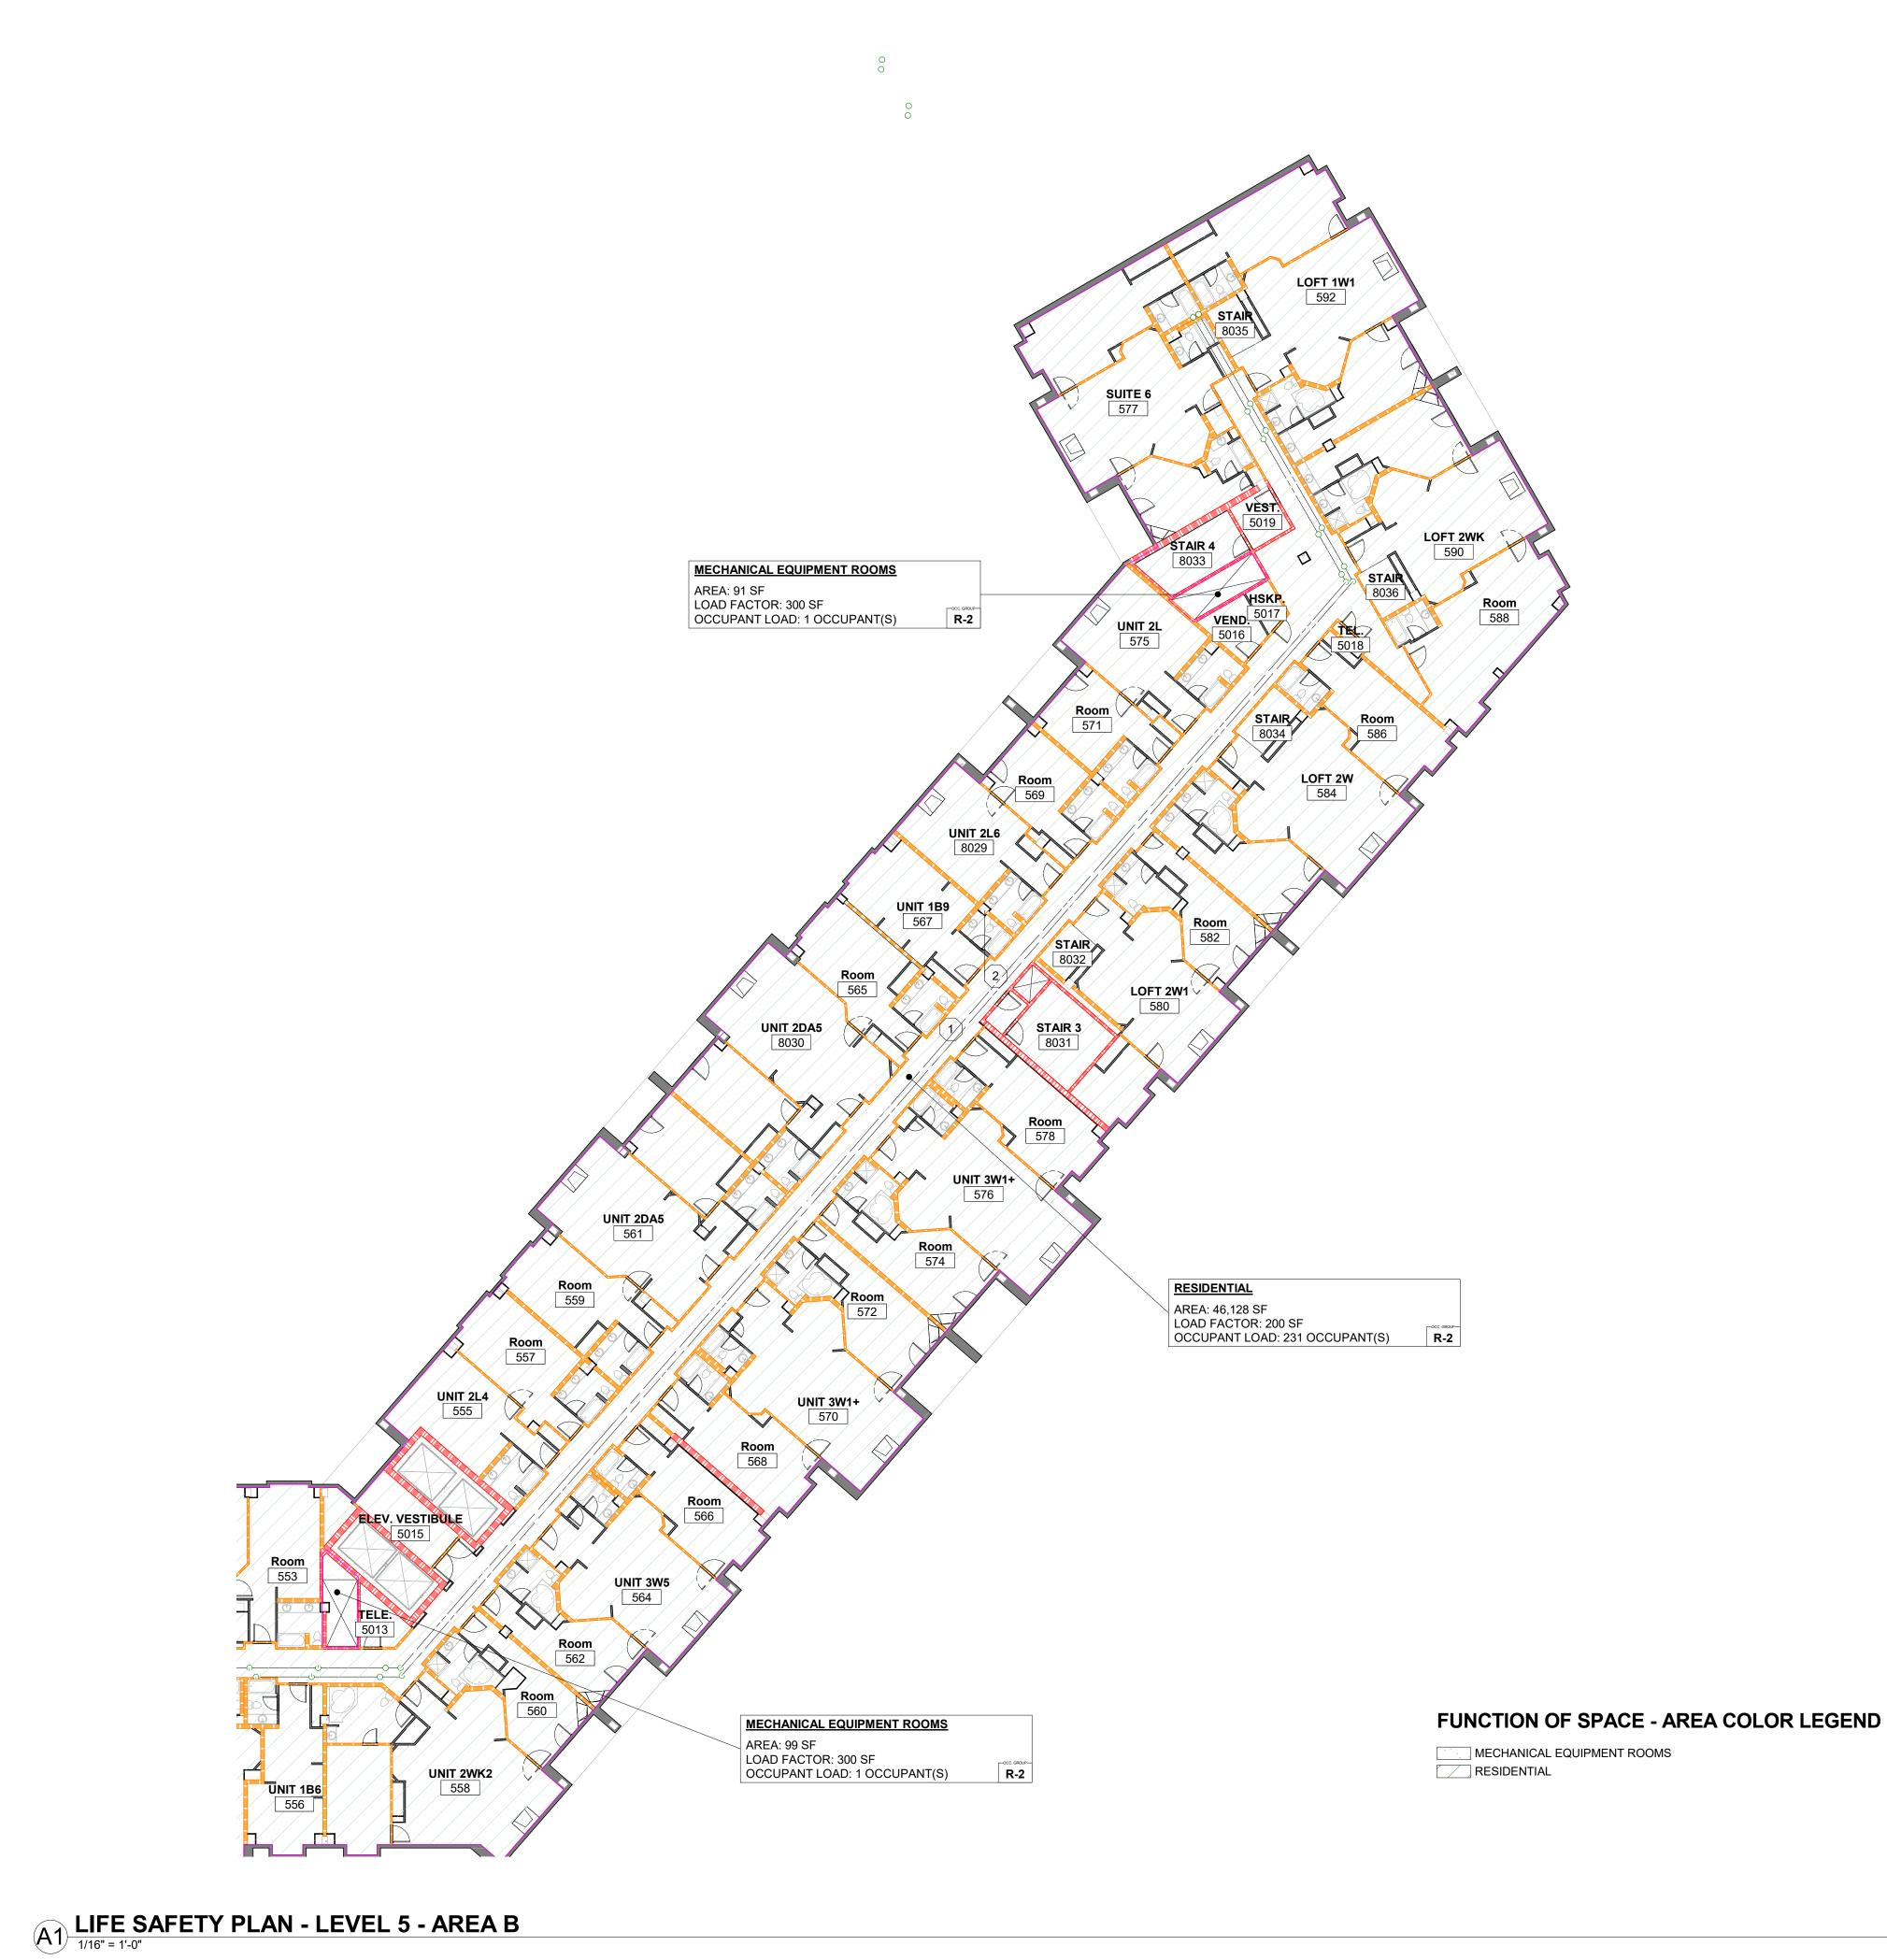
Project Information

Sheet Information

Sheet Title: LIFE SAFETY PLAN - LEVEL 5 -AREA B

Sheet Number:

LS-105.B



FIRE RATED WALL LEGEND LIFE SAFETY LEGEND OCCUPANT LOAD SUMMARY - LEVEL SIX FIRE DOOR ASSEMBLY RATINGS PER IBC TABLE 716.1(2) OCC. LOAD AREA FUNCTION OF SPACE LIFE SAFETY ANNOTATION SYMBOLS MECHANICAL EQUIPMENT ROOMS ¹/₃ HOUR AT FIRE PARTITIONS; 199 39,493 SF 209 41,805 SF (P) RESIDENTIAL 1/3 HOUR(b) AT CORRIDOR WALLS (1) LIFE SAFETY NOTES 1/3 HOUR(b) AT CORRIDOR WALLS; 3/4 HOUR AT OTHER FIRE PARTITIONS INCIDENTAL ACCESSORY OCCUPANCY NOTES **2**HR 1 1/₂ HOUR FIRE WALL FIRE SAFETY COMPONENTS (COORDINATE FINAL LOCATION(S) WITH LOCAL FIRE DEPARTMENT) 3 HOUR^(a) 1 HOUR AT SHAFT, EXIT ENCLOSURE; EXIT PASSAGEWAY WALLS; FEB FIRE EXTINGUISHER BRACKET FDC FIRE DEPARTMENT CONNECTION 3/4 HOUR AT OTHER FIRE BARRIERS FIRE BARRIER FEC FIRE EXTINGUISHER CABINET STP STANDPIPE FVC FIRE VALVE CABINET **EXTERIOR FIRE** RESISTANCE RATED WALL 2HR | | | | | | | | | | | | | | EGRESS COMPONENTS LOAD BEARING **EXTERIOR** FIRE RESISTANCE RATED WALL EA## EXIT ACCESS TRAVEL DISTANCE = 60'-0" < 250' MAX. CP## = 60'-0" < 125' MAX. 1HR LOAD BEARING **INTERIOR** FIRE RESISTANCE RATED WALL ACTUAL EXIT SEPARATION DISTANCE = 60'-0" > 20'-0" (1/3 DIAGONAL)

DE1 DEAD END CORRIDOR DISTANCE = 15'-0" < 20' MAX. NON-RATED EXISTING WALL 0 EXIT DISCHARGE (OCCUPANT LOAD) 0 EXIT ACCESS (OCCUPANT LOAD) 0 EXIT (OCCUPANT LOAD) ADDITIONAL IDENTIFIERS HORIZONTAL SHAFTWALL **ASSEMBLY ABOVE** LIFE SAFETY NOTES

> **REVIEWED** COMPLIANCE 03/21/2024

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ARCHITECTS

Consultant(s)

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Date No.

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Project Information

Sheet Information

Sheet Title:

LIFE SAFETY PLAN - LEVEL 6 -AREA A

Sheet Number:

A1 LIFE SAFETY PLAN - LEVEL 6 - AREA A

AREA: 58 SF LOAD FACTOR: 300 SF GROSS OCCUPANT LOAD: 1 OCCUPANT(S) LOAD FACTOR: 300 SF OCCUPANT LOAD: 1 OCCUPANT(S)

RESIDENTIAL

FUNCTION OF SPACE - AREA COLOR LEGEND

MECHANICAL EQUIPMENT ROOMS

RESIDENTIAL

MECHANICAL EQUIPMENT ROOMS

(1) 2-HR RATED PT CONCRETE SLAB - TYP.

2 3-HR RATED CONCRETE FRAME (COLUMNS, BEAMS, GIRDERS) - TYP.

MECHANICAL EQUIPMENT ROOMS


AREA: 86 SF

AREA: 38,065 SF
LOAD FACTOR: 200 SF GROSS
OCCUPANT LOAD: 191 OCCUPANT(S)

R-2

OCCUPANT LOAD SUMMARY - L	EVEL SIX		FIF
FUNCTION OF SPACE	OCC. LOAD	AREA	
CHANICAL EQUIPMENT ROOMS	10	2,312 SF	
SIDENTIAL	199	39,493 SF	FIRE
TAL	209	41,805 SF	(P)
			` '

	FIRE RATED	WAL	L LEGEND		LIFE SAFETY LEGEND
				FIRE DOOR ASSEMBLY RATINGS PER IBC TABLE 716.1(2)	LIFE SAFETY ANNOTATION SYMBOLS
SF SF	FIRE PARTITION	. 5 HR		1/ ₃ HOUR AT FIRE PARTITIONS; 1/ ₃ HOUR ^(b) AT CORRIDOR WALLS	1 LIFE SAFETY NOTES
SF	(P)	1HR		1/3 HOUR(b) AT CORRIDOR WALLS; 3/4 HOUR AT OTHER FIRE PARTITIONS	1 INCIDENTAL ACCESSORY OCCUPANCY NOTES
	FIRE WALL	2 HR		1 ¹ / ₂ HOUR	FIDE CAFETY COMPONENTS
	(W)	3 HR		3 HOUR ^(a)	FIRE SAFETY COMPONENTS (COORDINATE FINAL LOCATION(S) WITH LOCAL FIRE DEPARTMENT)
	FIRE BARRIER	1HR		1 HOUR AT SHAFT, EXIT ENCLOSURE; EXIT PASSAGEWAY WALLS; ³ / ₄ HOUR AT OTHER FIRE BARRIERS	FEB FIRE EXTINGUISHER BRACKET FDC FIRE DEPARTMENT CONNECT
	(B)	2 HR		1 ¹ / ₂ HOUR	FEC FIRE EXTINGUISHER CABINET STP STANDPIPE
	EXTERIOR FIRE RESISTANCE	1HR			FVC FIRE VALVE CABINET
	RATED WALL	2 HR	11 11 11 11 11 11		
	LOAD BEARING	1HR			EGRESS COMPONENTS
	EXTERIOR FIRE RESISTANCE RATED WALL	2 HR	11 11 11 11 11 11		EA## EXIT ACCESS TRAVEL DISTANCE = 60'-0" < 250' MAX. CD## COMMON PATH OF EGRESS TRAVEL
	(E)				EA## EXIT ACCESS TRAVEL DISTANCE = 60'-0" < 250' MAX. (1/3 DIAGONA)
	LOAD BEARING	1HR			CP## = 60'-0" < 125' MAX.
	INTERIOR FIRE RESISTANCE RATED WALL	2 HR	11 11 11 11 11 11 11		
	(N)				ACTUAL EXIT SEPARATION DISTANCE = 60'-0" > 20'-0" (1/3 DIAGONAL) = 15'-0" < 20' MAX
	EXISTING WALL	NON- RATED			= 60'-0" > 20'-0" (1/3 DIAGONAL)

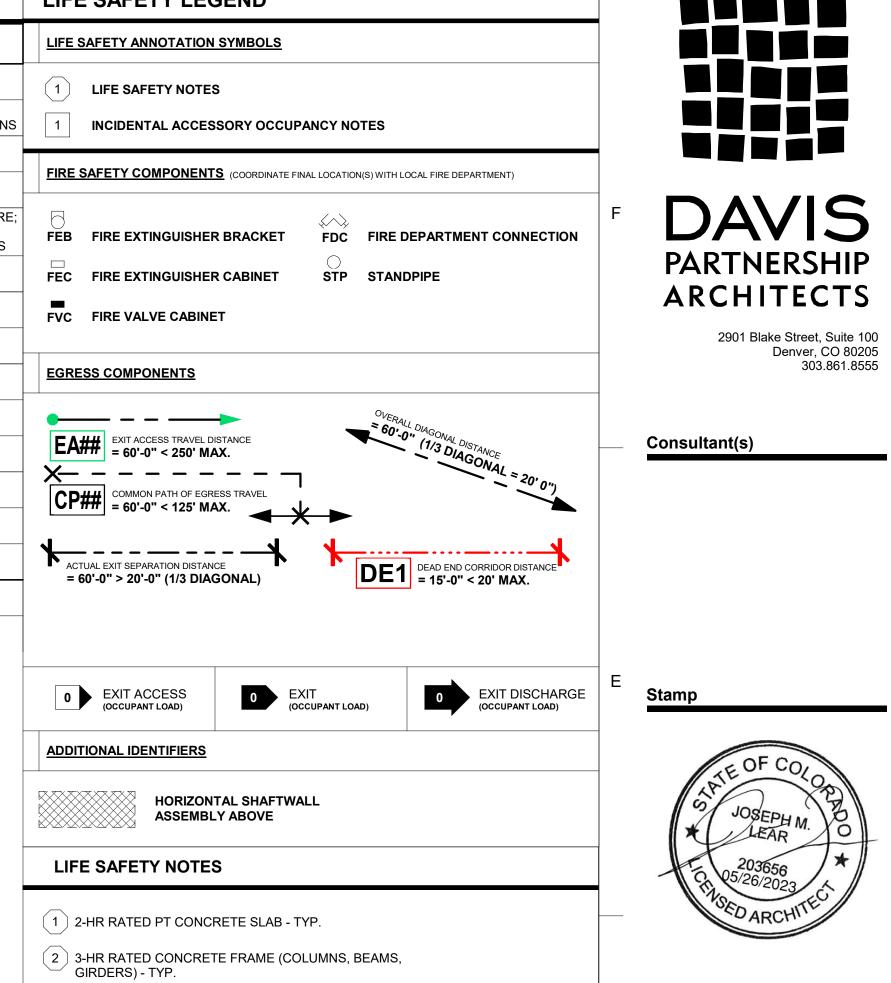

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05/26/2023

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Project Information

TEAMBOAT GRAND - PIPING SYSTEM
REPLACEMENT
2300 MT WERNER CIR,
STEAMBOAT SPRINGS, CO 80487

Sheet Information

Sheet Title:


LIFE SAFETY

PLAN - LEVEL 6
AREA B

Sheet Number:

LS-106.B



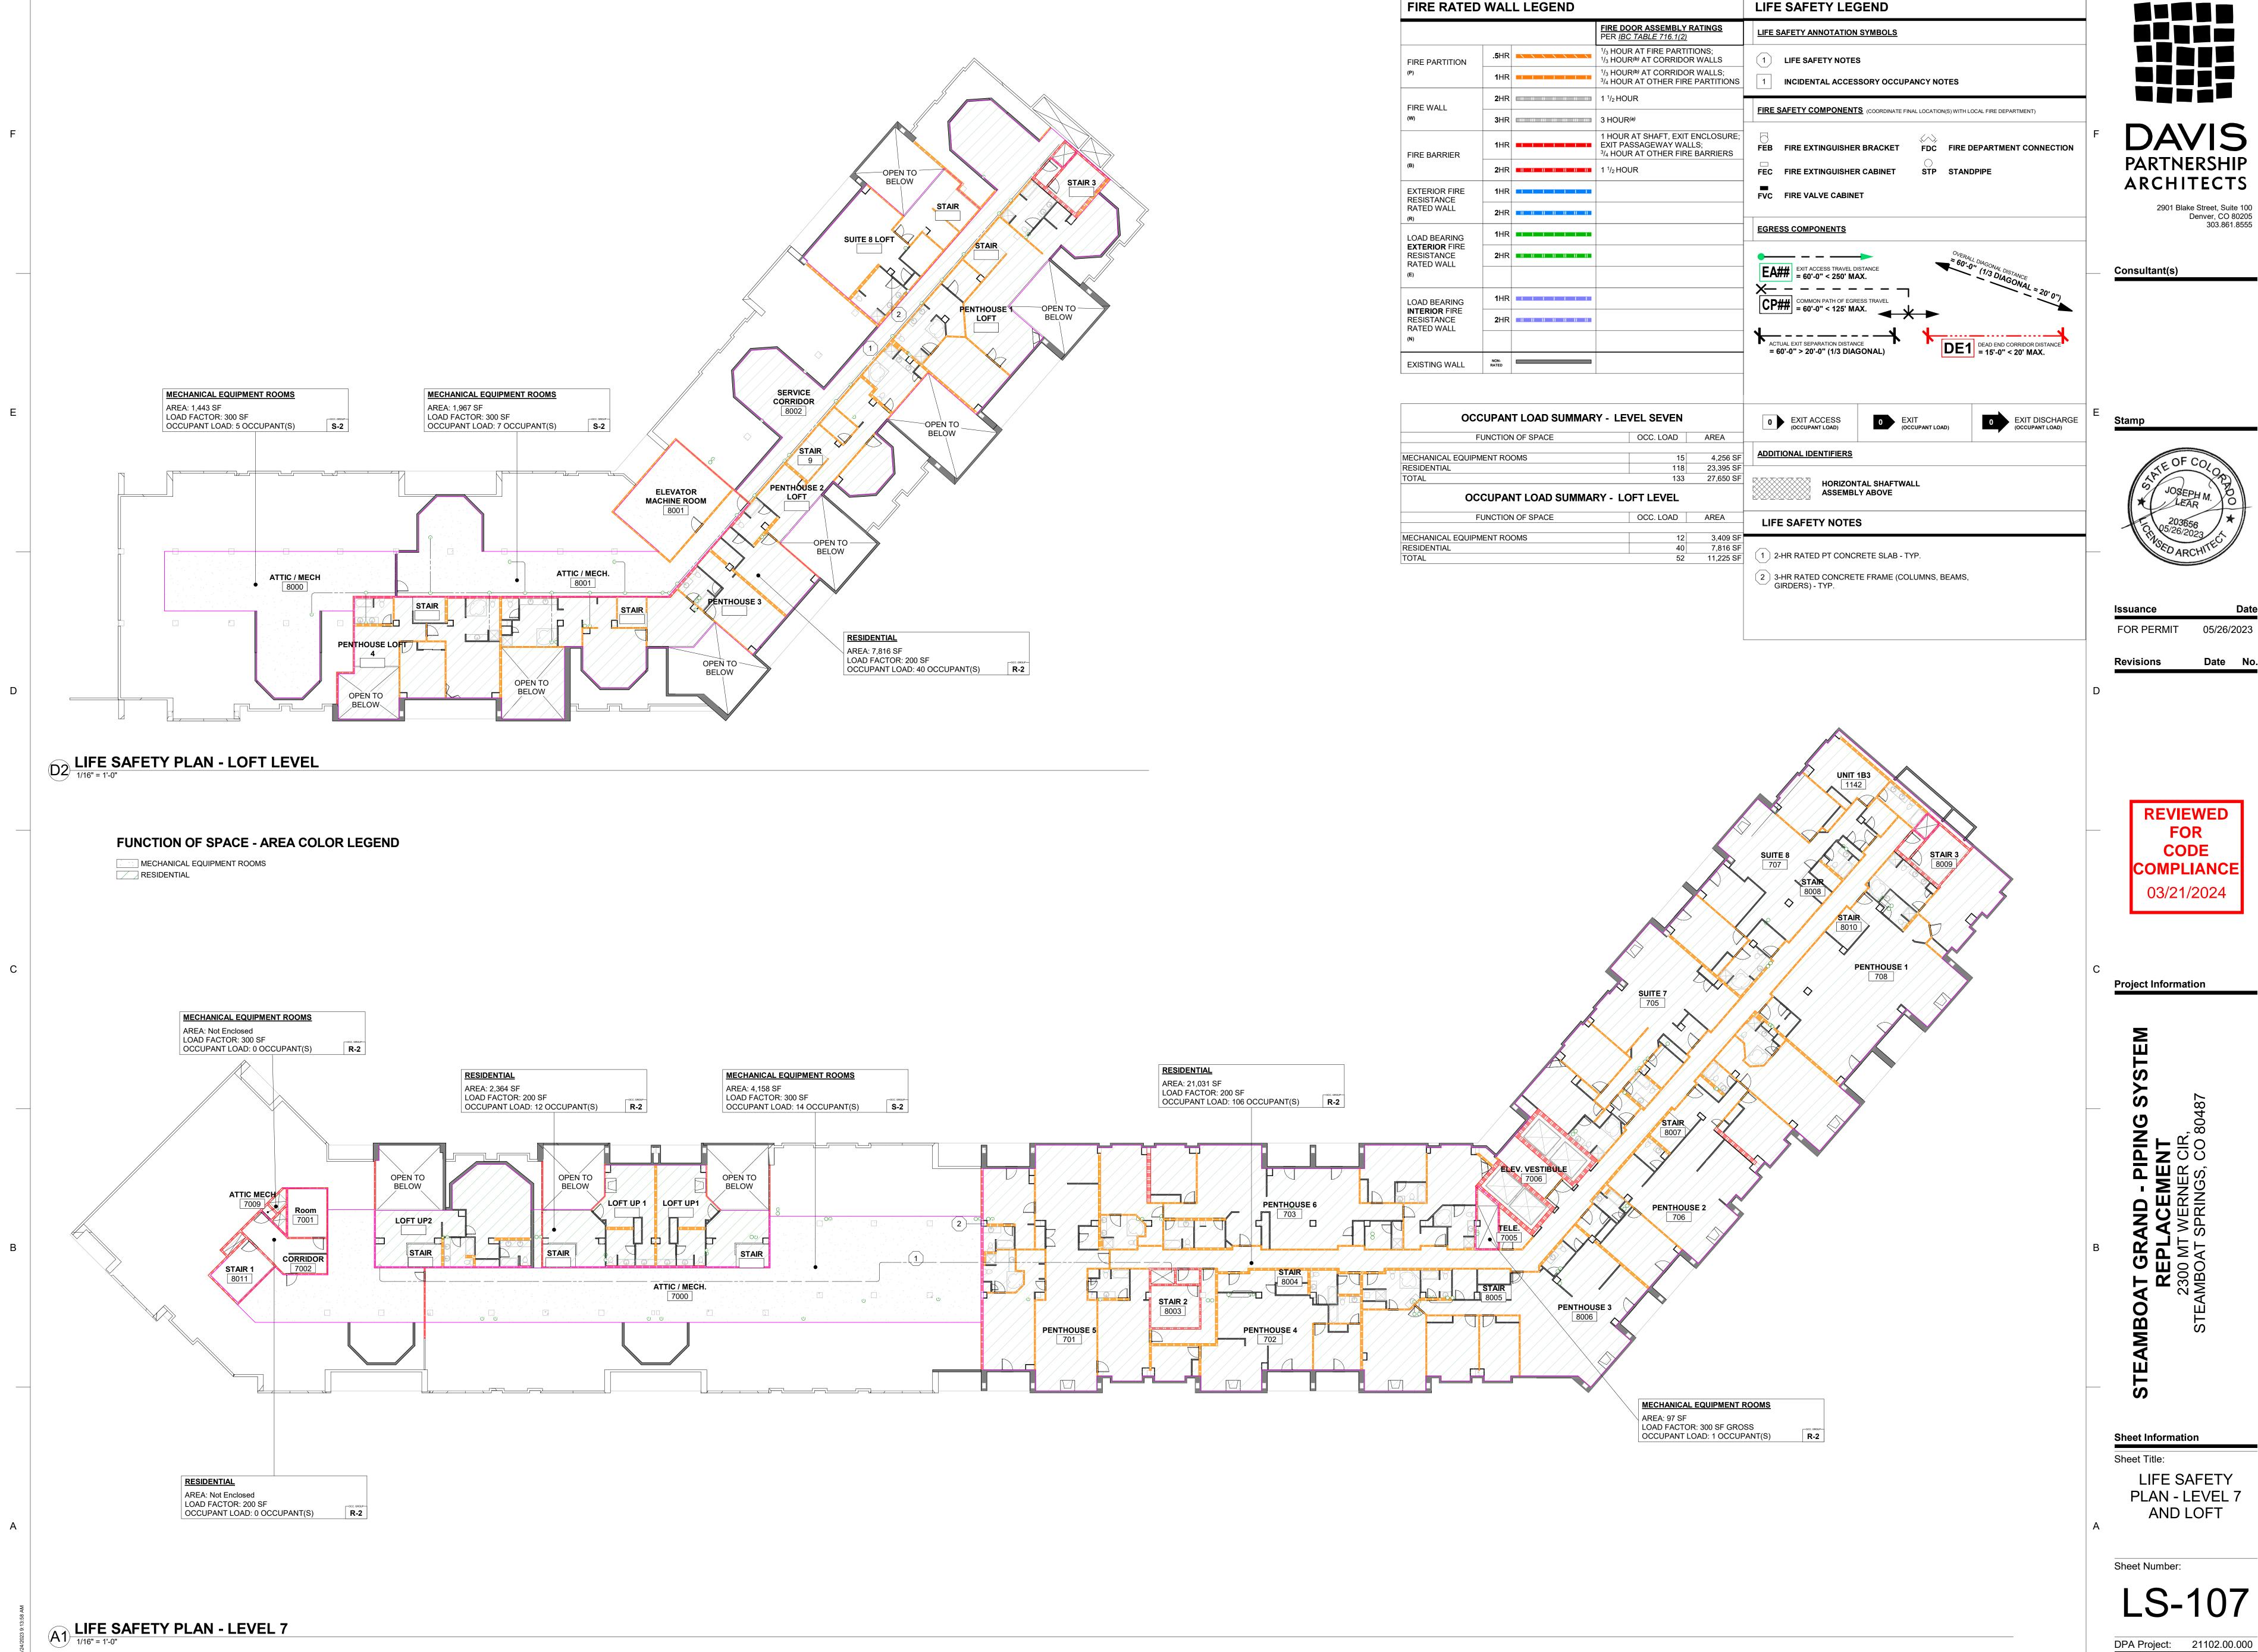

PARTNERSHIP ARCHITECTS




05/26/2023

COMPLIANCE

LIFE SAFETY PLAN - LEVEL 7

LS-107

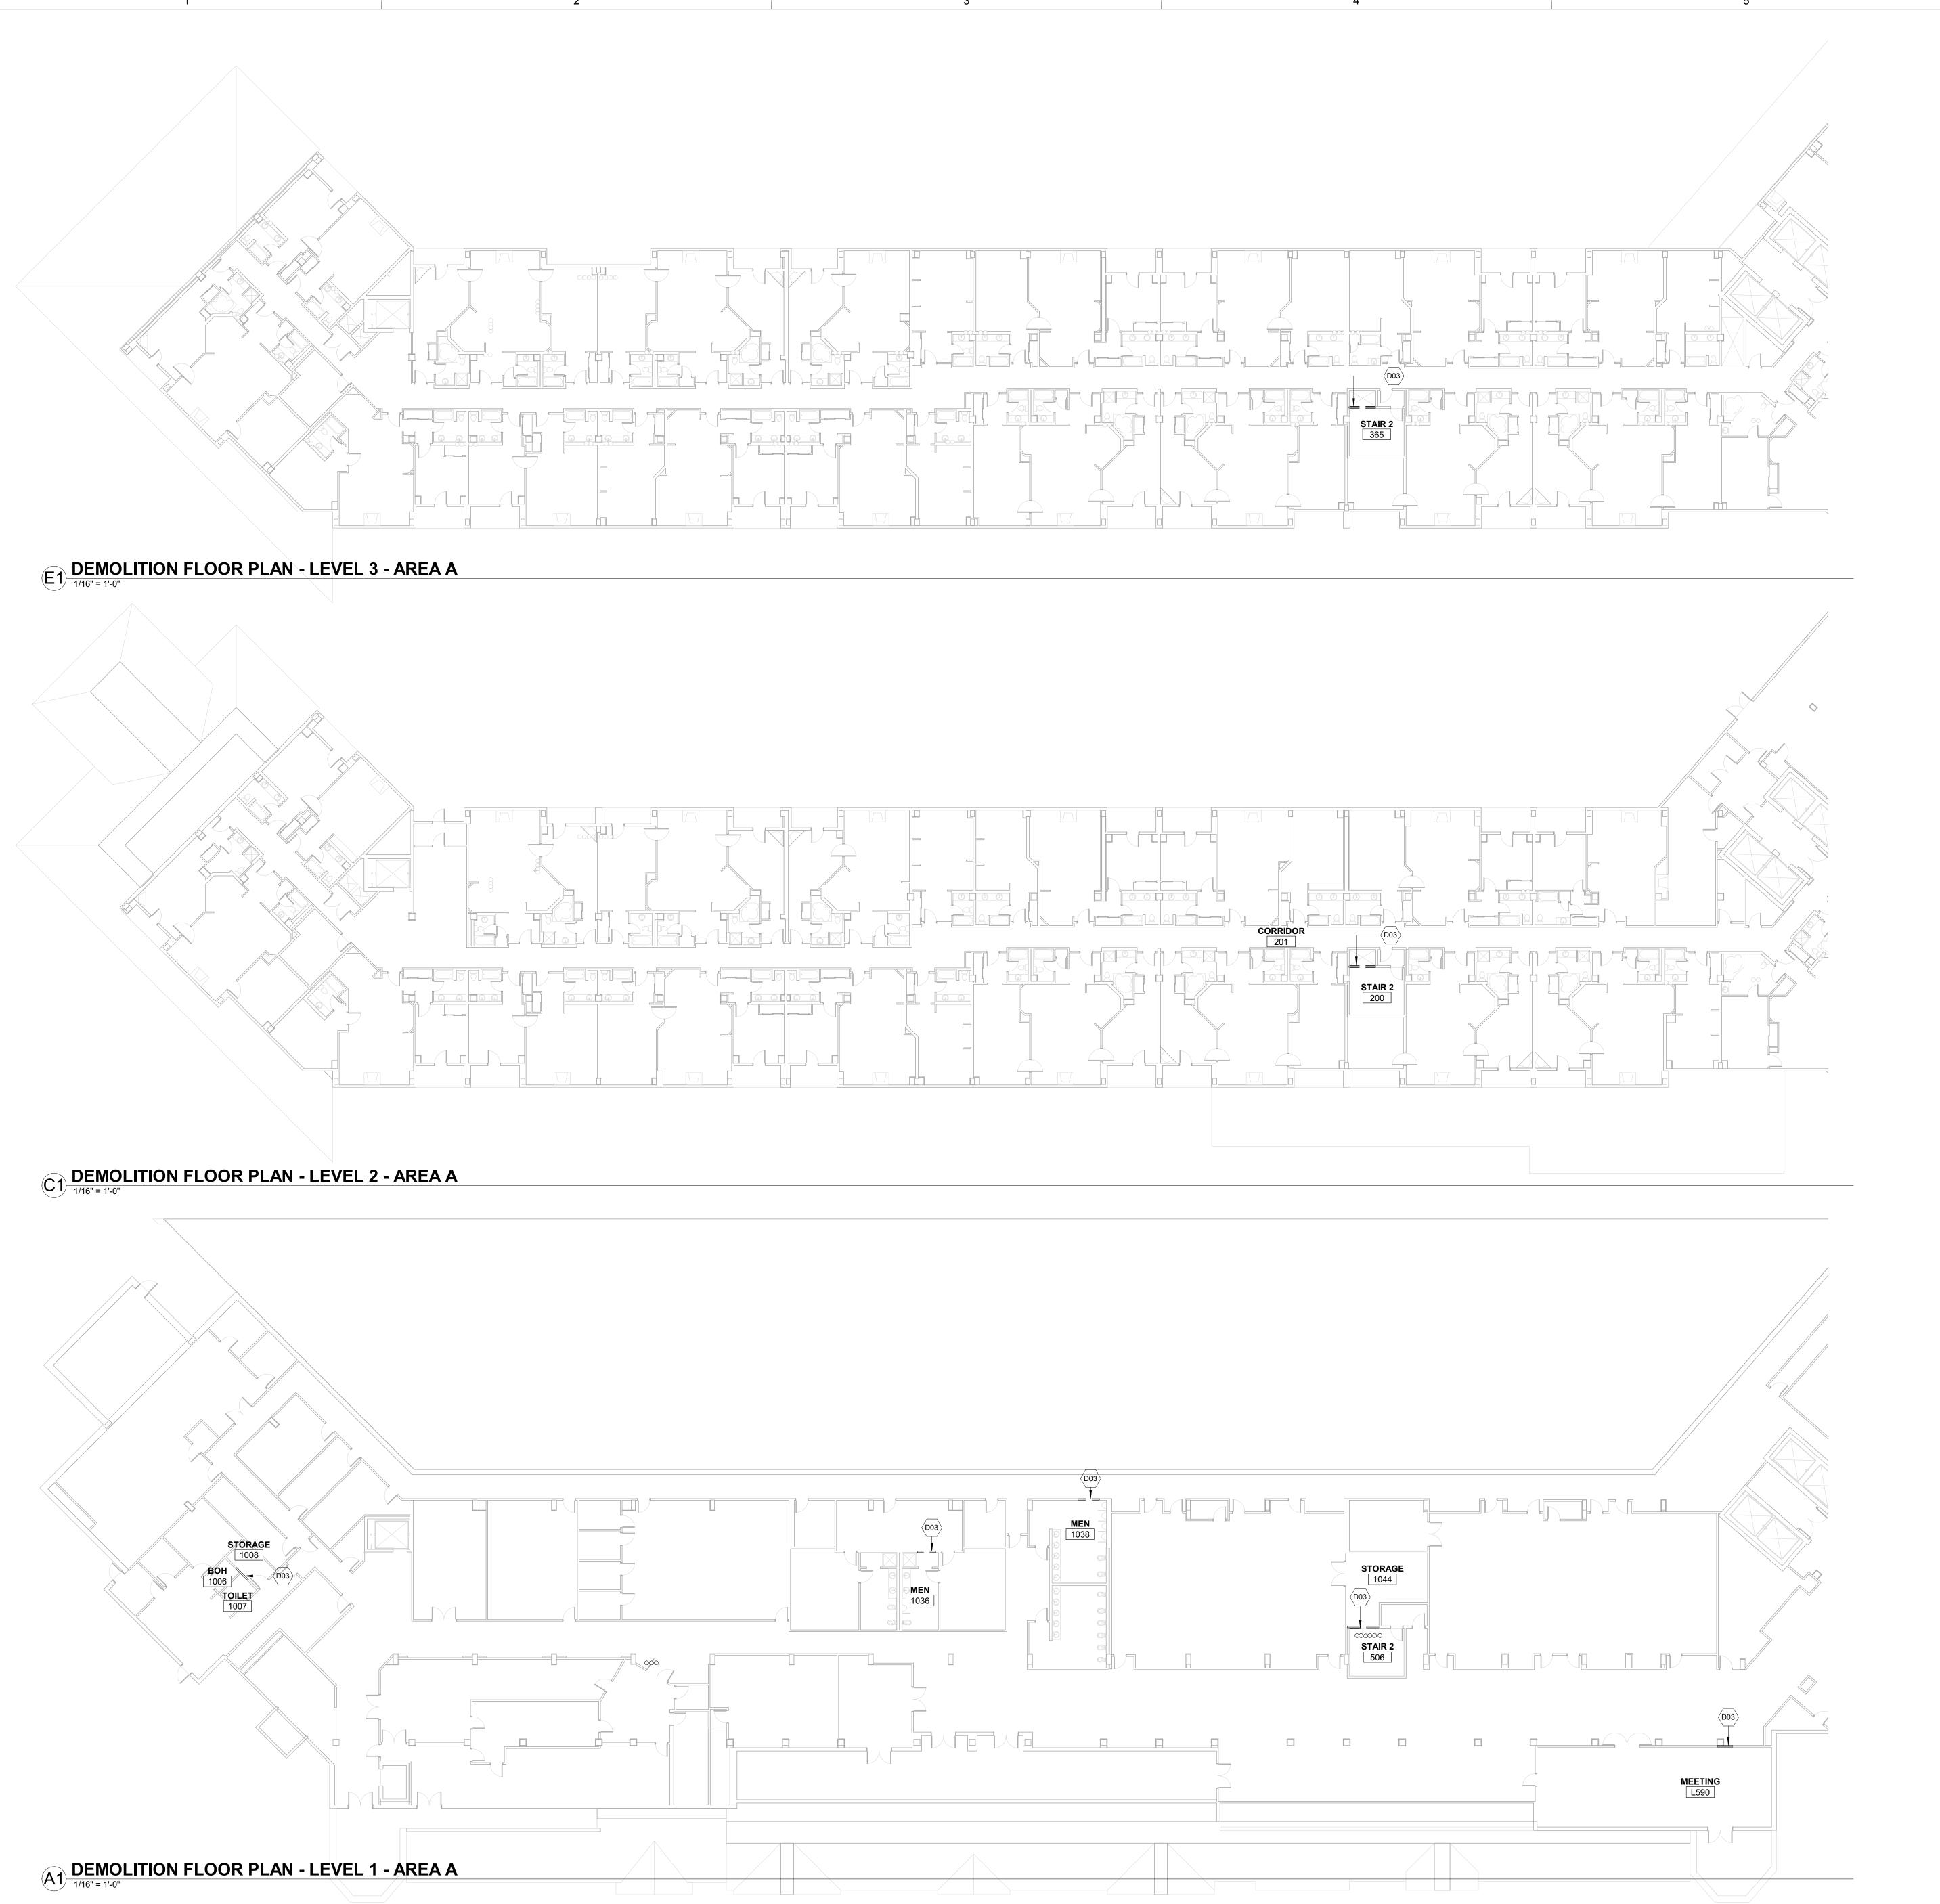

- CONTRACTOR TO INFORM ARCHITECT OF ANY DISCREPANCIES BETWEEN FIELD CONDITIONS AND ARCHITECTURAL DRAWINGS. EXISTING BUILDING CONDITIONS ARE SHOWN IN HALFTONE.
 ALL DIMENSIONS ARE TO FINISHED FACE OF PARTITION OR SOFFIT, U.N.O.
 CONTRACTOR TO COORDINATE THE DEMOLITION OF MECHANICAL,
- ELECTRICAL, PLUMBING, AND SPECIAL SYSTEMS. CONTRACTOR TO MAINTAIN EXISTING STRUCTURAL INTEGRITY AND
- FIREPROOFING INTEGRITY DURING DEMOLITION. REMOVE AND STORE CEILING FIXTURES AS REQUIRED DURING DEMOLITION
- PATCH AND REPAIR FLOOR AND CEILING TO MATCH ADJACENT CONSTRUCTION AS REQUIRED DURING DEMOLITION.

Demo Legend

EXISTING TO REMAIN

EXISTING TO BE REMOVED

EXISTING WALL/ PARTITION TO BE REMOVED

 $_{1}--+--+$ --+--+

DEMOLISH CEILINGS

DEMOLITION KEYNOTES

DEMO EXISTING WALL FROM FLOOR TO CEILING FOR ACCESS TO PIPING; PATCH AND REPAIR AS NEEDED.

PARTNERSHIP ARCHITECTS

Consultant(s)

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Revisions

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Project Information

Sheet Information

Sheet Title: DEMOLITION PLANS - LEVELS

1, 2, 3 - AREA A

Sheet Number:

AD-101



- CONTRACTOR TO INFORM ARCHITECT OF ANY DISCREPANCIES BETWEEN FIELD CONDITIONS AND ARCHITECTURAL DRAWINGS.
- FIELD CONDITIONS AND ARCHITECTURAL DRAWINGS.
 EXISTING BUILDING CONDITIONS ARE SHOWN IN HALFTONE.
 ALL DIMENSIONS ARE TO FINISHED FACE OF PARTITION OR SOFFIT, U.N.O.
 CONTRACTOR TO COORDINATE THE DEMOLITION OF MECHANICAL,
 ELECTRICAL, PLUMBING, AND SPECIAL SYSTEMS.
 CONTRACTOR TO MAINTAIN EXISTING STRUCTURAL INTEGRITY AND
- FIREPROOFING INTEGRITY DURING DEMOLITION.
 REMOVE AND STORE CEILING FIXTURES AS REQUIRED DURING DEMOLITION

PATCH AND REPAIR FLOOR AND CEILING TO MATCH ADJACENT CONSTRUCTION AS REQUIRED DURING DEMOLITION.

Demo Legend

EXISTING TO REMAIN — — — EXISTING TO BE REMOVED

EXISTING WALL/ PARTITION TO BE REMOVED

--+--++

DEMOLISH CEILINGS

DEMOLITION KEYNOTES

DEMO EXISTING WALL FROM FLOOR TO CEILING FOR ACCESS TO PIPING; PATCH AND REPAIR AS NEEDED.

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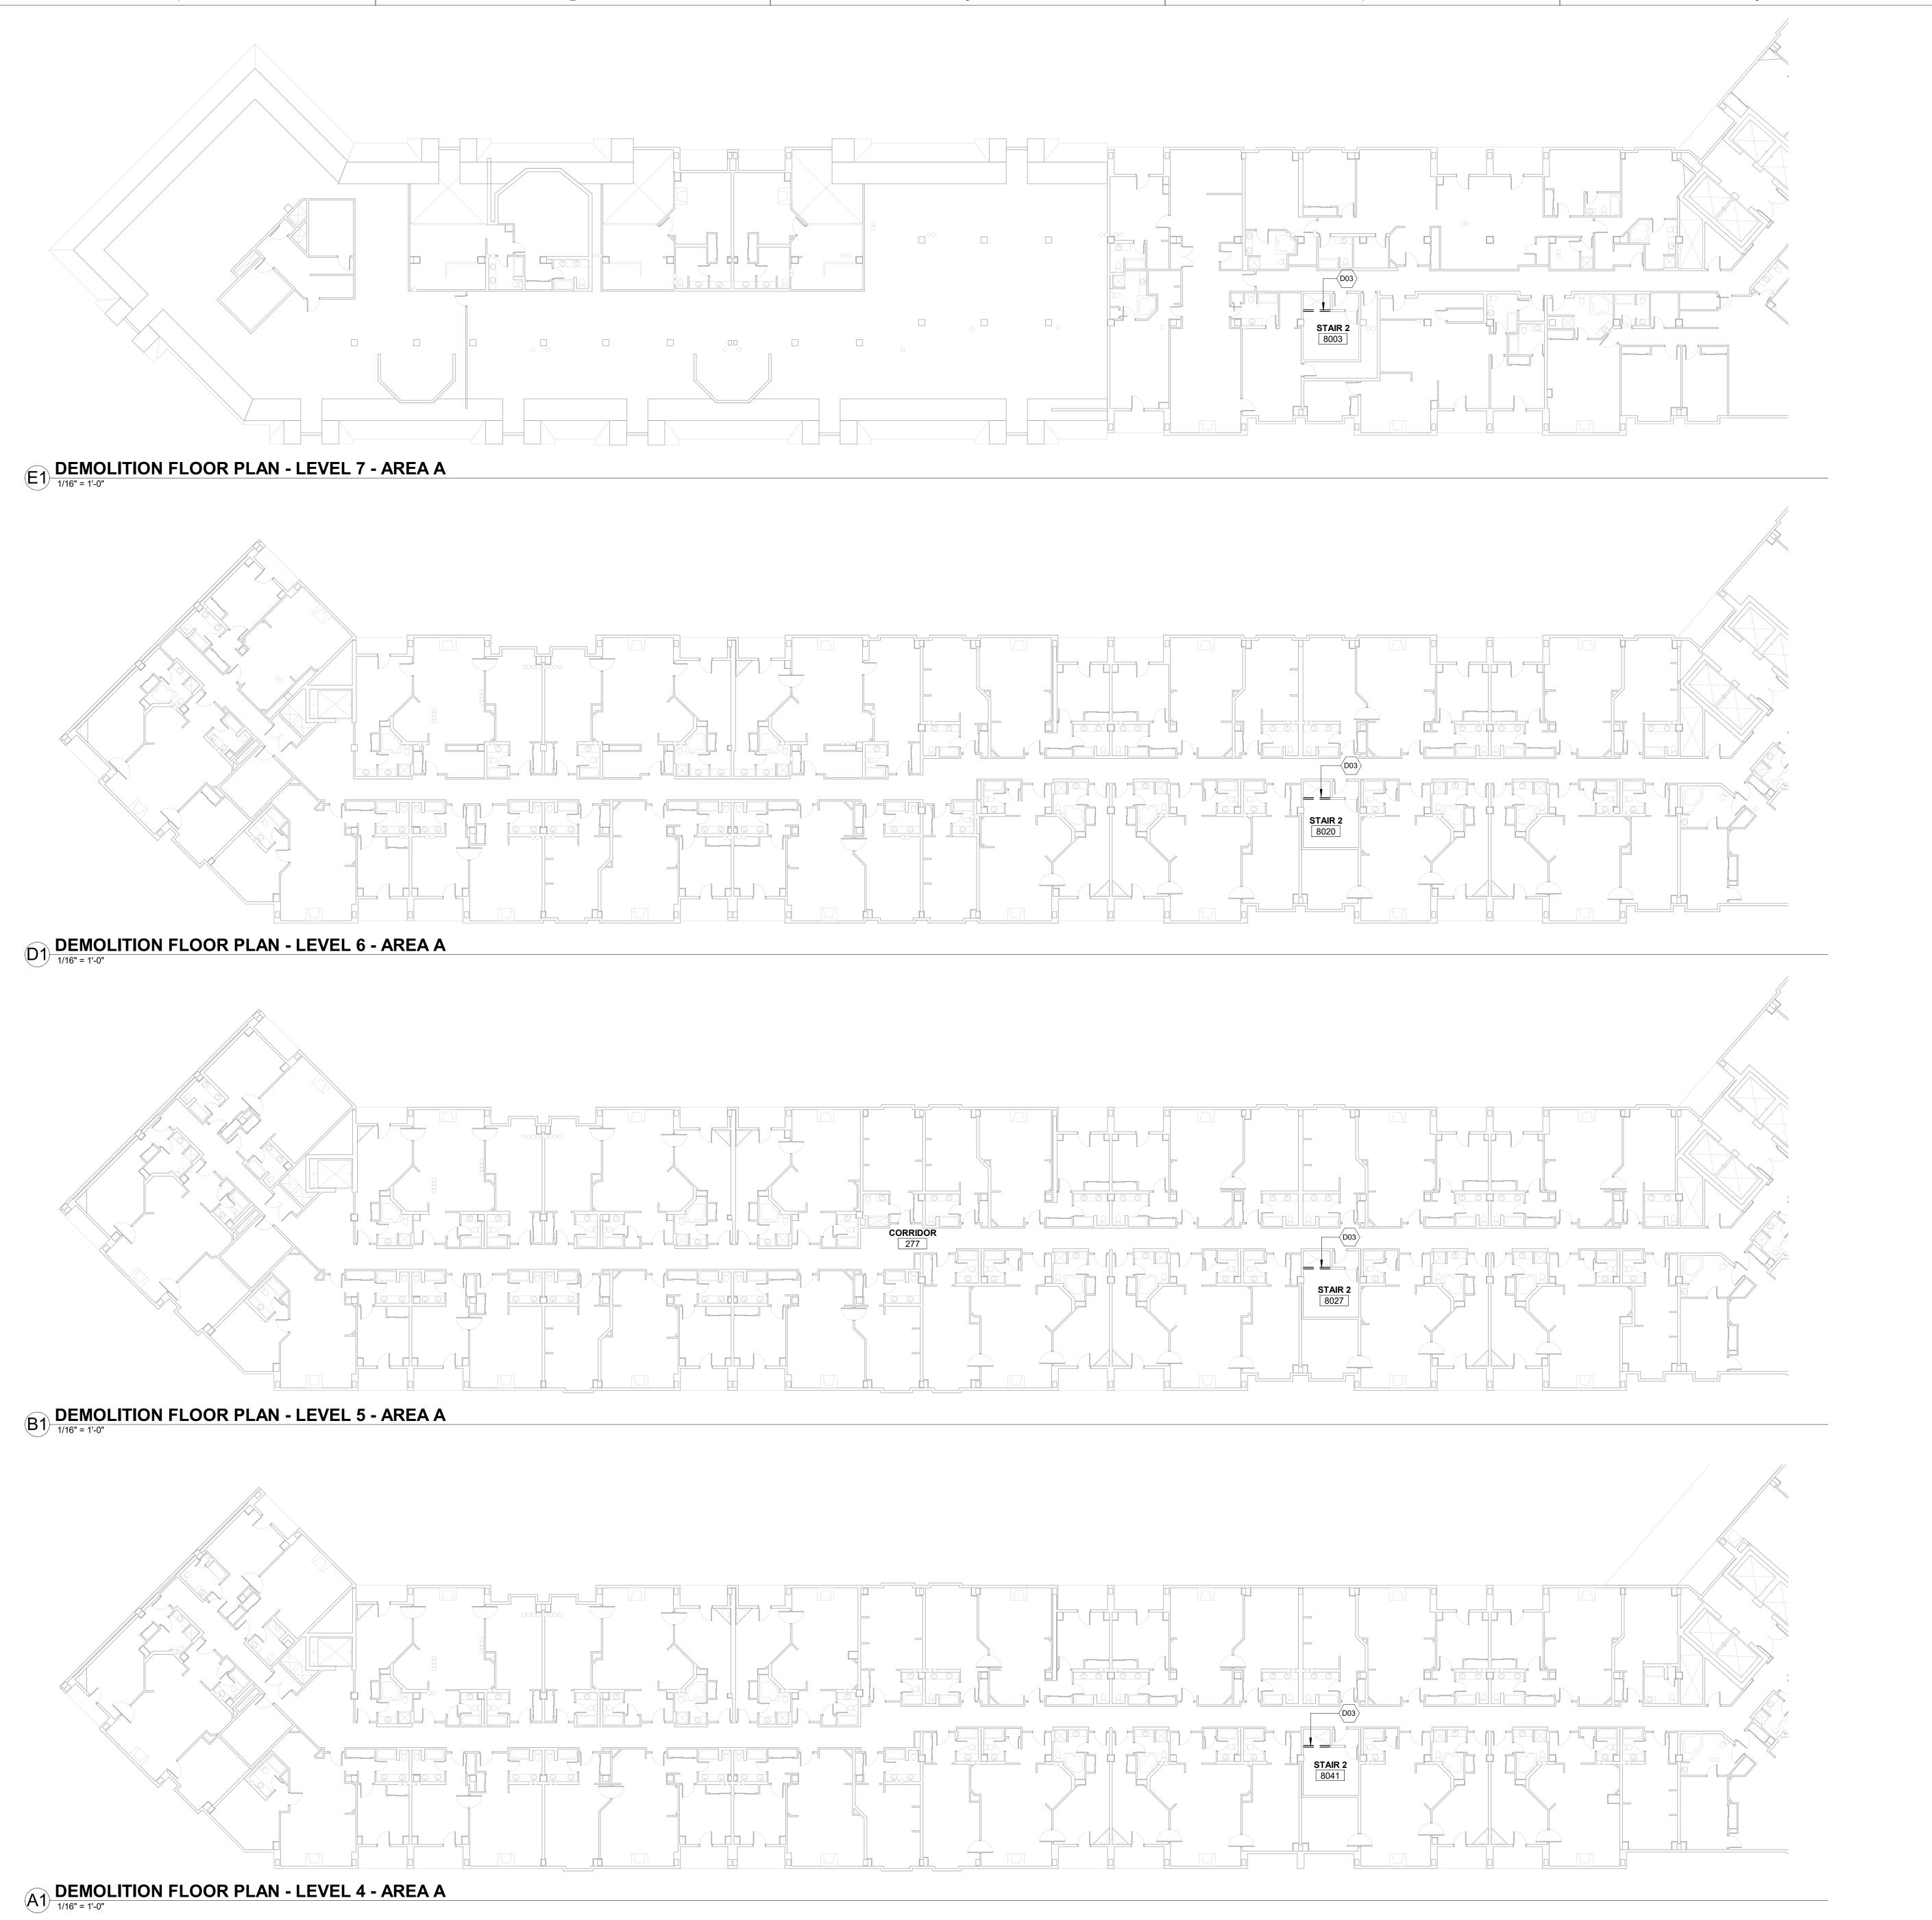
Sheet Information

Sheet Title:

DEMOLITION PLAN - LEVEL 1 -AREA B

Sheet Number:

AD-101.B



- CONTRACTOR TO INFORM ARCHITECT OF ANY DISCREPANCIES BETWEEN FIELD CONDITIONS AND ARCHITECTURAL DRAWINGS.
- EXISTING BUILDING CONDITIONS ARE SHOWN IN HALFTONE.
 ALL DIMENSIONS ARE TO FINISHED FACE OF PARTITION OR SOFFIT, U.N.O.
 CONTRACTOR TO COORDINATE THE DEMOLITION OF MECHANICAL,
- ELECTRICAL, PLUMBING, AND SPECIAL SYSTEMS.
 CONTRACTOR TO MAINTAIN EXISTING STRUCTURAL INTEGRITY AND
- FIREPROOFING INTEGRITY DURING DEMOLITION.
 REMOVE AND STORE CEILING FIXTURES AS REQUIRED DURING DEMOLITION PATCH AND REPAIR FLOOR AND CEILING TO MATCH ADJACENT CONSTRUCTION AS REQUIRED DURING DEMOLITION.

Demo Legend

EXISTING TO REMAIN — — — EXISTING TO BE

EXISTING WALL/ PARTITION TO BE REMOVED

|--+---+--+--+

DEMOLISH CEILINGS

DEMOLITION KEYNOTES

DEMO EXISTING WALL FROM FLOOR TO CEILING FOR ACCESS TO PIPING; PATCH AND REPAIR AS NEEDED.

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Project Information

Sheet Information

Sheet Title: DEMOLITION

PLANS - LEVELS 4, 5, 6, 7 - AREA A

Sheet Number:

- CONTRACTOR TO INFORM ARCHITECT OF ANY DISCREPANCIES BETWEEN FIELD CONDITIONS AND ARCHITECTURAL DRAWINGS. EXISTING BUILDING CONDITIONS ARE SHOWN IN HALFTONE.
- ALL DIMENSIONS ARE TO FINISHED FACE OF PARTITION OR SOFFIT, U.N.O. CONTRACTOR TO COORDINATE THE DEMOLITION OF MECHANICAL,
- ELECTRICAL, PLUMBING, AND SPECIAL SYSTEMS. CONTRACTOR TO MAINTAIN EXISTING STRUCTURAL INTEGRITY AND
- FIREPROOFING INTEGRITY DURING DEMOLITION. REMOVE AND STORE CEILING FIXTURES AS REQUIRED DURING DEMOLITION
- OF CEILING. PATCH AND REPAIR FLOOR AND CEILING TO MATCH ADJACENT CONSTRUCTION AS REQUIRED DURING DEMOLITION.

Demo Legend

EXISTING TO REMAIN

— — — EXISTING TO BE

EXISTING WALL/ PARTITION TO BE REMOVED

|--+--+ **DEMOLISH CEILINGS** |--+--+

DEMOLITION KEYNOTES

DEMO EXISTING CEILING GRID/TILES. REMOVE EXISTING FIXTURES; STORAGE FOR INSTALL IN NEW CEILING.



ARCHITECTS

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Consultant(s)



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Sheet Information

Sheet Title:

DEMOLITION REFLECTED **CEILING PLAN -**PARKING LEVEL AREA A

Sheet Number:

DPA Project: 21102.00.000

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DEMOLITION RCP - PARKING LEVEL - AREA A

1/16" = 1'-0"

DEMOLITION RCP - PARKING LEVEL - AREA B

Demolition General Notes

- CONTRACTOR TO INFORM ARCHITECT OF ANY DISCREPANCIES BETWEEN FIELD CONDITIONS AND ARCHITECTURAL DRAWINGS.

 EXISTING BUILDING CONDITIONS ARE SHOWN IN HALFTONE.
- EXISTING BUILDING CONDITIONS ARE SHOWN IN HALFTONE.
 ALL DIMENSIONS ARE TO FINISHED FACE OF PARTITION OR SOFFIT, U.N.O.
 CONTRACTOR TO COORDINATE THE DEMOLITION OF MECHANICAL,
- ALL DIMENSIONS ARE TO FINISHED FACE OF FARTHON OR SOFFIT, 0
 CONTRACTOR TO COORDINATE THE DEMOLITION OF MECHANICAL, ELECTRICAL, PLUMBING, AND SPECIAL SYSTEMS.
 CONTRACTOR TO MAINTAIN EXISTING STRUCTURAL INTEGRITY AND
- FIREPROOFING INTEGRITY DURING DEMOLITION.

 6. REMOVE AND STORE CEILING FIXTURES AS REQUIRED DURING DEMOLITION
- OF CEILING.
 PATCH AND REPAIR FLOOR AND CEILING TO MATCH ADJACENT CONSTRUCTION AS REQUIRED DURING DEMOLITION.

Demo Legend

EXISTING TO REMAIN

— — — EXISTING TO BE REMOVED

EXISTING WALL/ PARTITION TO BE REMOVED

DEMO EXISTING CEILING GRID/TILES. REMOVE EXISTING FIXTURES; STORAGE FOR INSTALL IN NEW CEILING.

DEMOLITION KEYNOTES

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Consultant(s)

Ctomp



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Project Information

REPLACEMENT
2300 MT WERNER CIR,
STEAMBOAT SPRINGS, CO 80487

Sheet Information
Sheet Title:

DEMOLITION REFLECTED CEILING PLAN -PARKING LEVEL AREA B

Sheet Number:

AD-150.B

CONTRACTOR TO INFORM ARCHITECT OF ANY DISCREPANCIES BETWEEN FIELD CONDITIONS AND ARCHITECTURAL DRAWINGS.

EXISTING BUILDING CONDITIONS ARE SHOWN IN HALFTONE.
ALL DIMENSIONS ARE TO FINISHED FACE OF PARTITION OR SOFFIT, U.N.O.
CONTRACTOR TO COORDINATE THE DEMOLITION OF MECHANICAL, ELECTRICAL, PLUMBING, AND SPECIAL SYSTEMS.

CONTRACTOR TO MAINTAIN EXISTING STRUCTURAL INTEGRITY AND FIREPROOFING INTEGRITY DURING DEMOLITION. REMOVE AND STORE CEILING FIXTURES AS REQUIRED DURING DEMOLITION

OF CEILING. PATCH AND REPAIR FLOOR AND CEILING TO MATCH ADJACENT CONSTRUCTION AS REQUIRED DURING DEMOLITION.

Demo Legend

EXISTING TO REMAIN — — — EXISTING TO BE

EXISTING WALL/ PARTITION TO BE REMOVED

|--+--+|

DEMOLISH CEILINGS

DEMOLITION KEYNOTES

STORAGE FOR INSTALL IN NEW CEILING.

DEMO EXISTING CEILING GRID/TILES. REMOVE EXISTING FIXTURES;

REMOVE EXISTING GYP CEILING; REPAIR AND PATCH SURROUNDING AREAS AS NEEDED.



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Consultant(s)

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Project Information

Sheet Information

Sheet Title: DEMOLITION REFLECTED

CEILING PLAN -LEVEL 2 - AREA A

Sheet Number:

AD-152.A

DEMOLITION RCP - LEVEL 2 - AREA A

DEMOLITION RCP - LEVEL 2 - AREA B

Demolition General Notes

CONTRACTOR TO INFORM ARCHITECT OF ANY DISCREPANCIES BETWEEN FIELD CONDITIONS AND ARCHITECTURAL DRAWINGS.

EXISTING BUILDING CONDITIONS ARE SHOWN IN HALFTONE.
ALL DIMENSIONS ARE TO FINISHED FACE OF PARTITION OR SOFFIT, U.N.O.
CONTRACTOR TO COORDINATE THE DEMOLITION OF MECHANICAL,
ELECTRICAL, PLUMBING, AND SPECIAL SYSTEMS.
CONTRACTOR TO MAINTAIN EXISTING STRUCTURAL INTEGRITY AND

FIREPROOFING INTEGRITY DURING DEMOLITION.
REMOVE AND STORE CEILING FIXTURES AS REQUIRED DURING DEMOLITION

OF CEILING.
PATCH AND REPAIR FLOOR AND CEILING TO MATCH ADJACENT CONSTRUCTION AS REQUIRED DURING DEMOLITION.

Demo Legend

EXISTING TO REMAIN

— — — EXISTING TO BE REMOVED

EXISTING WALL/ PARTITION TO BE REMOVED

|--+--+ |--+--+|

DEMOLISH CEILINGS

DEMOLITION KEYNOTES

DEMO EXISTING CEILING GRID/TILES. REMOVE EXISTING FIXTURES; STORAGE FOR INSTALL IN NEW CEILING. REMOVE EXISTING GYP CEILING; REPAIR AND PATCH SURROUNDING AREAS AS NEEDED.

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Project Information

Sheet Information

Sheet Title:

DEMOLITION REFLECTED CEILING PLAN -LEVEL 2 - AREA B

Sheet Number:

AD-152.B

- CONTRACTOR TO INFORM ARCHITECT OF ANY DISCREPANCIES BETWEEN FIELD CONDITIONS AND ARCHITECTURAL DRAWINGS. EXISTING BUILDING CONDITIONS ARE SHOWN IN HALFTONE.
 ALL DIMENSIONS ARE TO FINISHED FACE OF PARTITION OR SOFFIT, U.N.O.
- CONTRACTOR TO COORDINATE THE DEMOLITION OF MECHANICAL, ELECTRICAL, PLUMBING, AND SPECIAL SYSTEMS.
- CONTRACTOR TO MAINTAIN EXISTING STRUCTURAL INTEGRITY AND FIREPROOFING INTEGRITY DURING DEMOLITION. REMOVE AND STORE CEILING FIXTURES AS REQUIRED DURING DEMOLITION
 - OF CEILING.

PATCH AND REPAIR FLOOR AND CEILING TO MATCH ADJACENT CONSTRUCTION AS REQUIRED DURING DEMOLITION.

Demo Legend

EXISTING TO REMAIN

— — — EXISTING TO BE

EXISTING WALL/ PARTITION TO BE REMOVED

|--+--+||--+--+|

DEMOLISH CEILINGS

DEMOLITION KEYNOTES

DEMO EXISTING CEILING GRID/TILES. REMOVE EXISTING FIXTURES; STORAGE FOR INSTALL IN NEW CEILING. REMOVE EXISTING GYP CEILING; REPAIR AND PATCH SURROUNDING AREAS AS NEEDED.

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Sheet Information Sheet Title:

DEMOLITION REFLECTED CEILING PLAN -LEVEL 5 - AREA A

Sheet Number:

AD-155.A

DPA Project: 21102.00.000

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DEMOLITION RCP - LEVEL 5 - AREA A

1/16" = 1'-0"

CONTRACTOR TO INFORM ARCHITECT OF ANY DISCREPANCIES BETWEEN FIELD CONDITIONS AND ARCHITECTURAL DRAWINGS.

EXISTING BUILDING CONDITIONS ARE SHOWN IN HALFTONE.
ALL DIMENSIONS ARE TO FINISHED FACE OF PARTITION OR SOFFIT, U.N.O.
CONTRACTOR TO COORDINATE THE DEMOLITION OF MECHANICAL, ELECTRICAL, PLUMBING, AND SPECIAL SYSTEMS.
CONTRACTOR TO MAINTAIN EXISTING STRUCTURAL INTEGRITY AND

FIREPROOFING INTEGRITY DURING DEMOLITION. REMOVE AND STORE CEILING FIXTURES AS REQUIRED DURING DEMOLITION

PATCH AND REPAIR FLOOR AND CEILING TO MATCH ADJACENT CONSTRUCTION AS REQUIRED DURING DEMOLITION.

Demo Legend

EXISTING TO REMAIN — — — EXISTING TO BE

EXISTING WALL/ PARTITION TO BE REMOVED

|--+--+||--+--+|

DEMOLISH CEILINGS

DEMOLITION KEYNOTES

DEMO EXISTING CEILING GRID/TILES. REMOVE EXISTING FIXTURES; STORAGE FOR INSTALL IN NEW CEILING. REMOVE EXISTING GYP CEILING; REPAIR AND PATCH SURROUNDING AREAS AS NEEDED.

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Sheet Information

Sheet Title:

DEMOLITION REFLECTED CEILING PLAN -LEVEL 5 - AREA B


Sheet Number:

AD-155.B

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DEMOLITION RCP - LEVEL 5 - AREA B


1/16" = 1'-0"

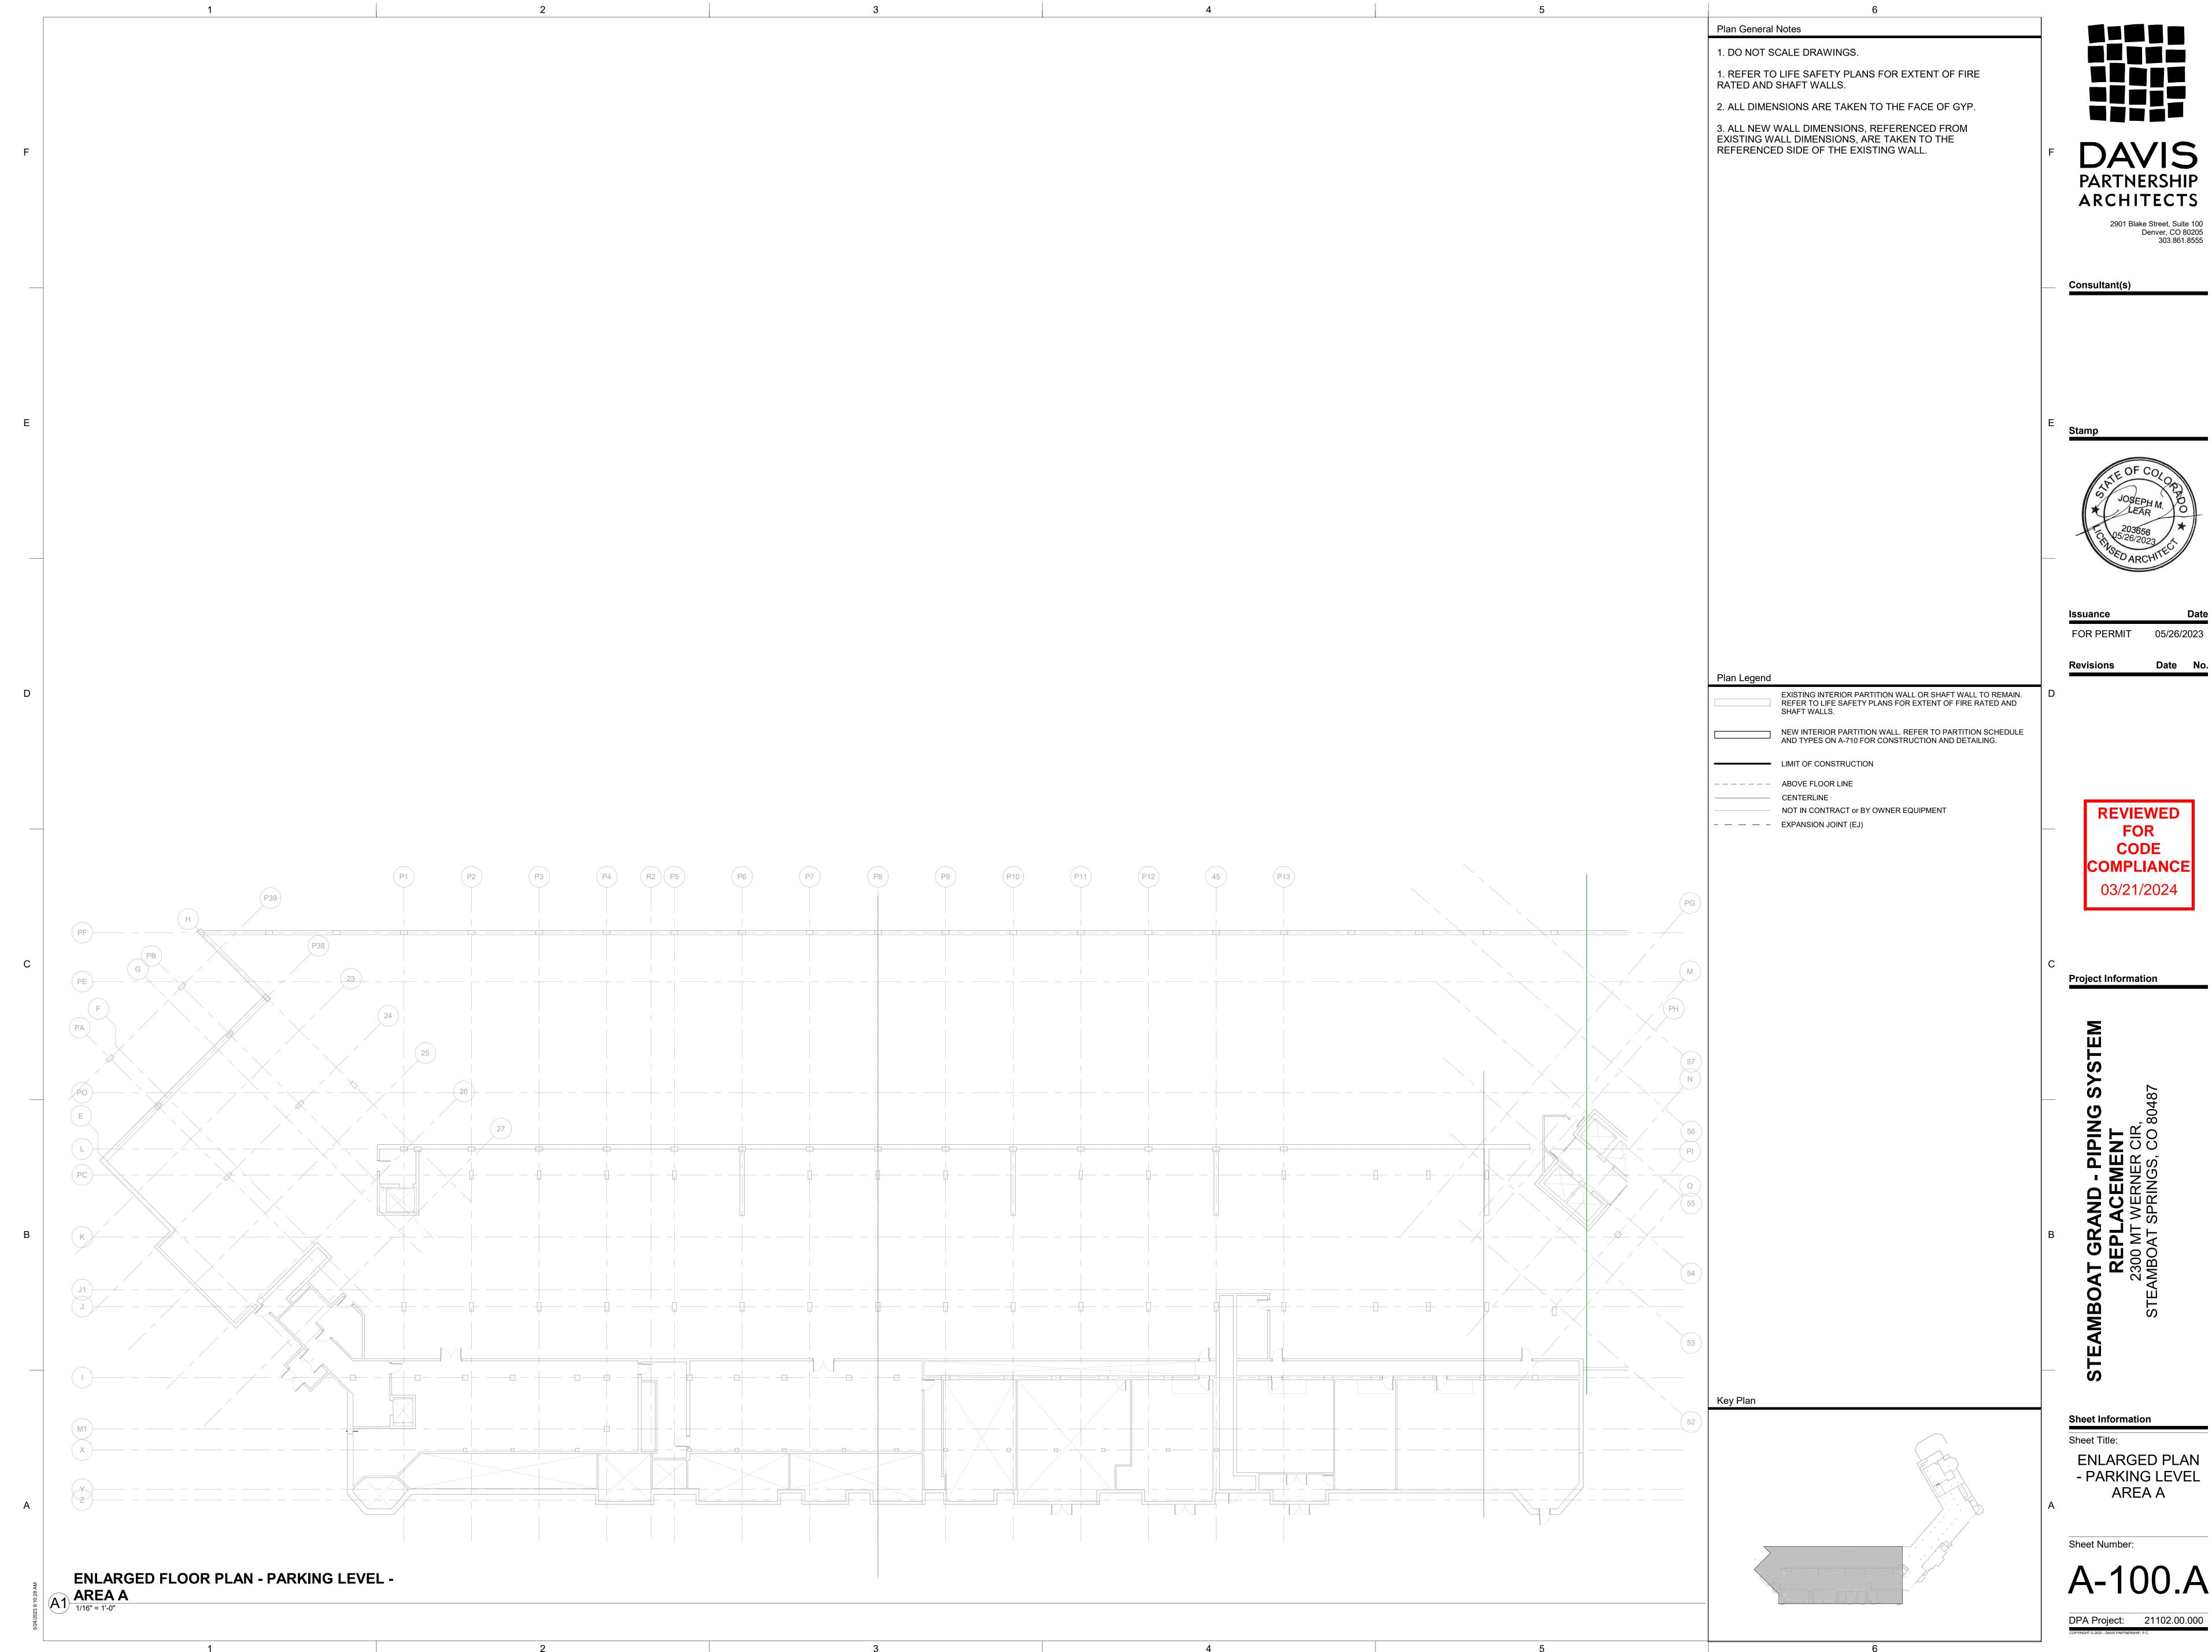

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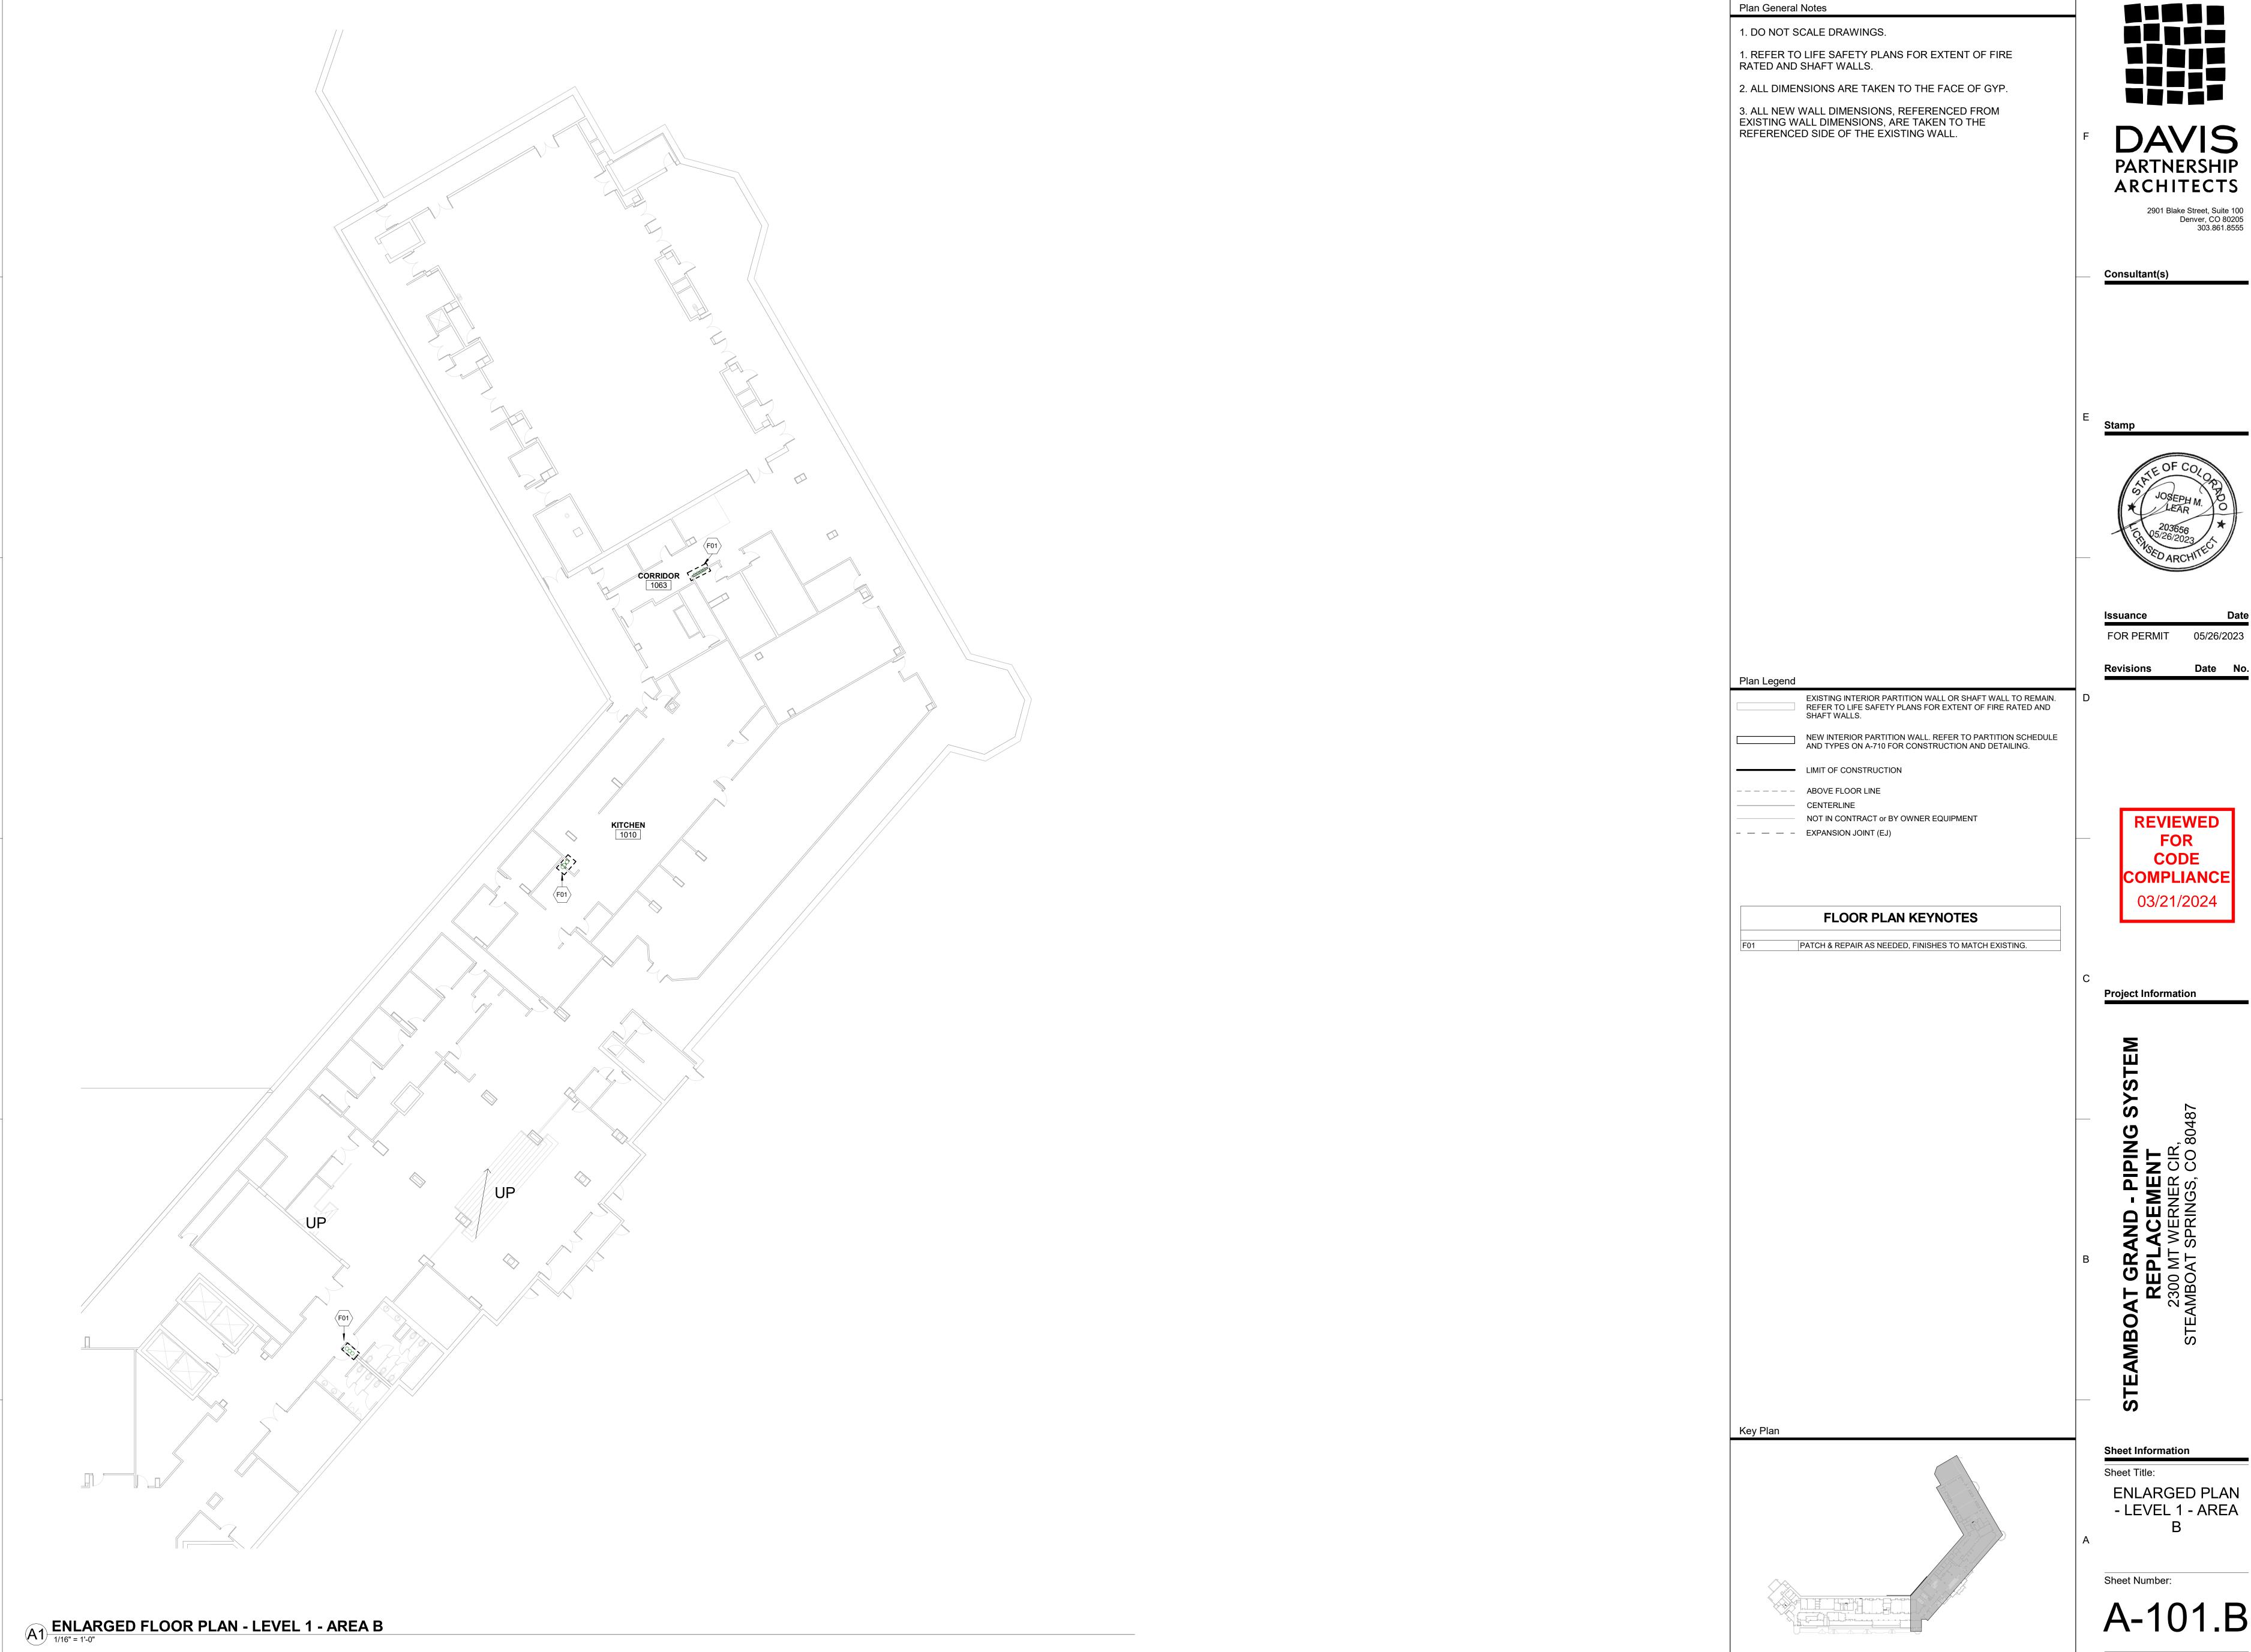


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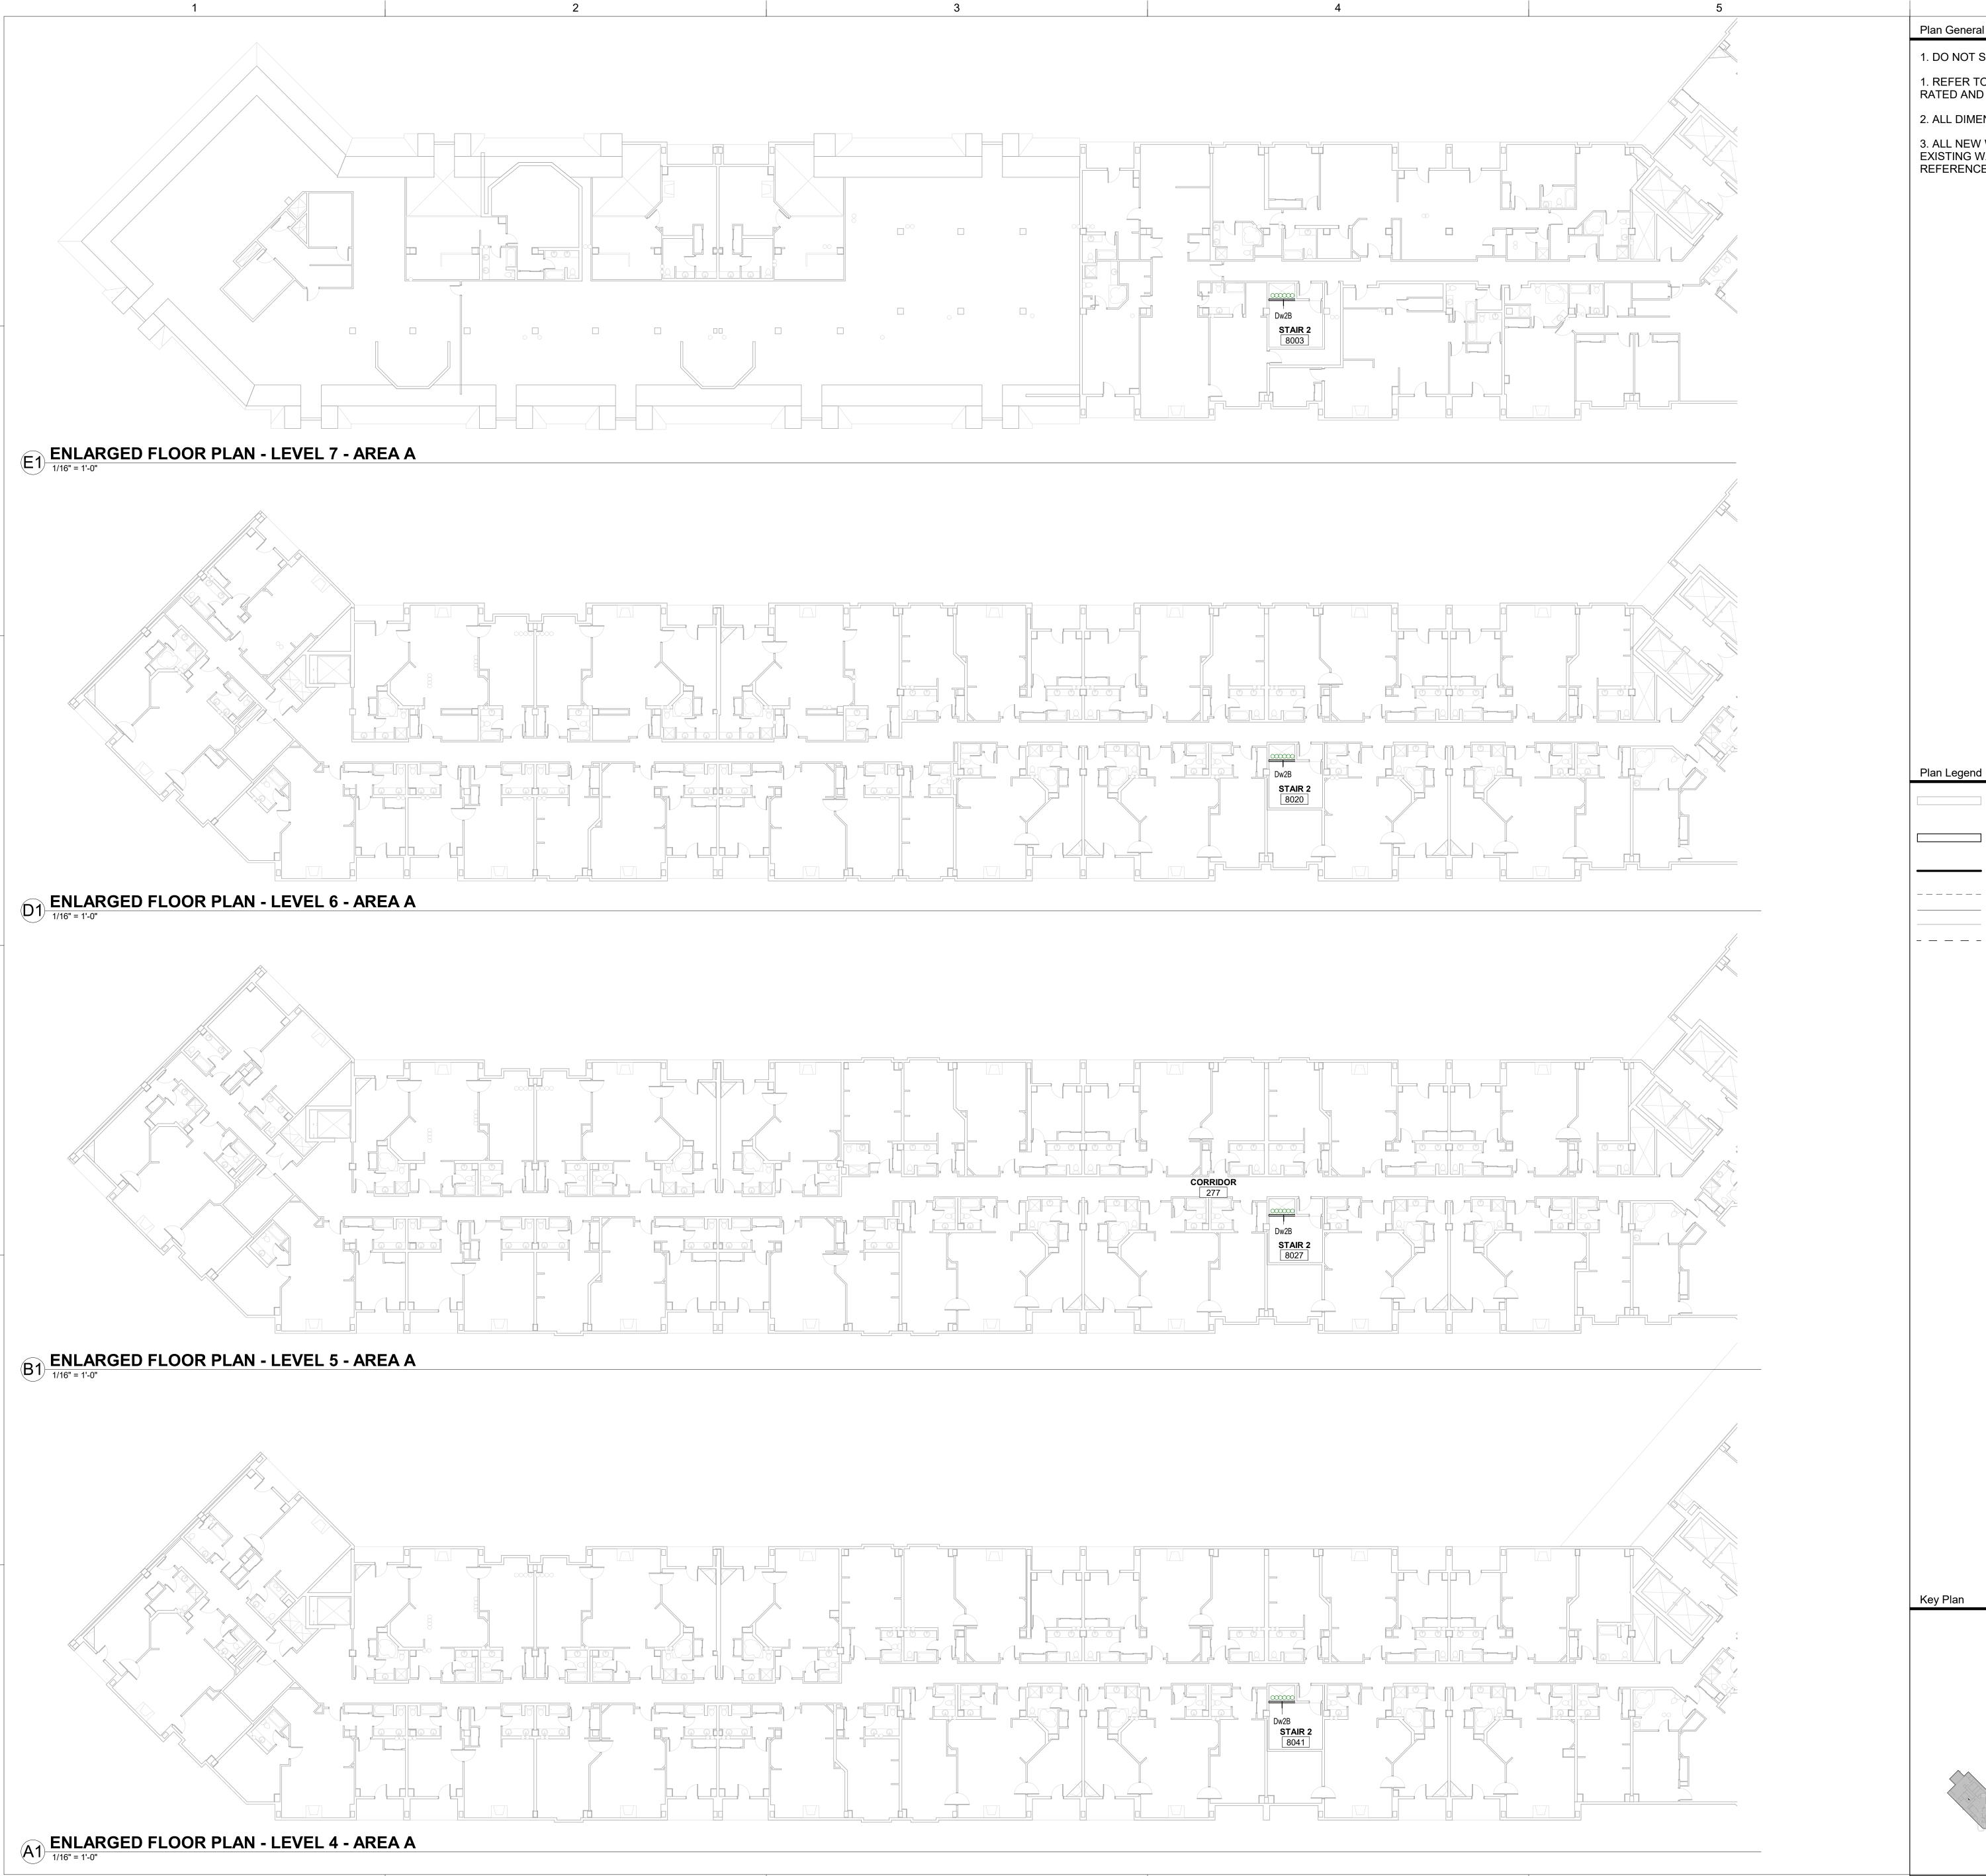
A-101.A

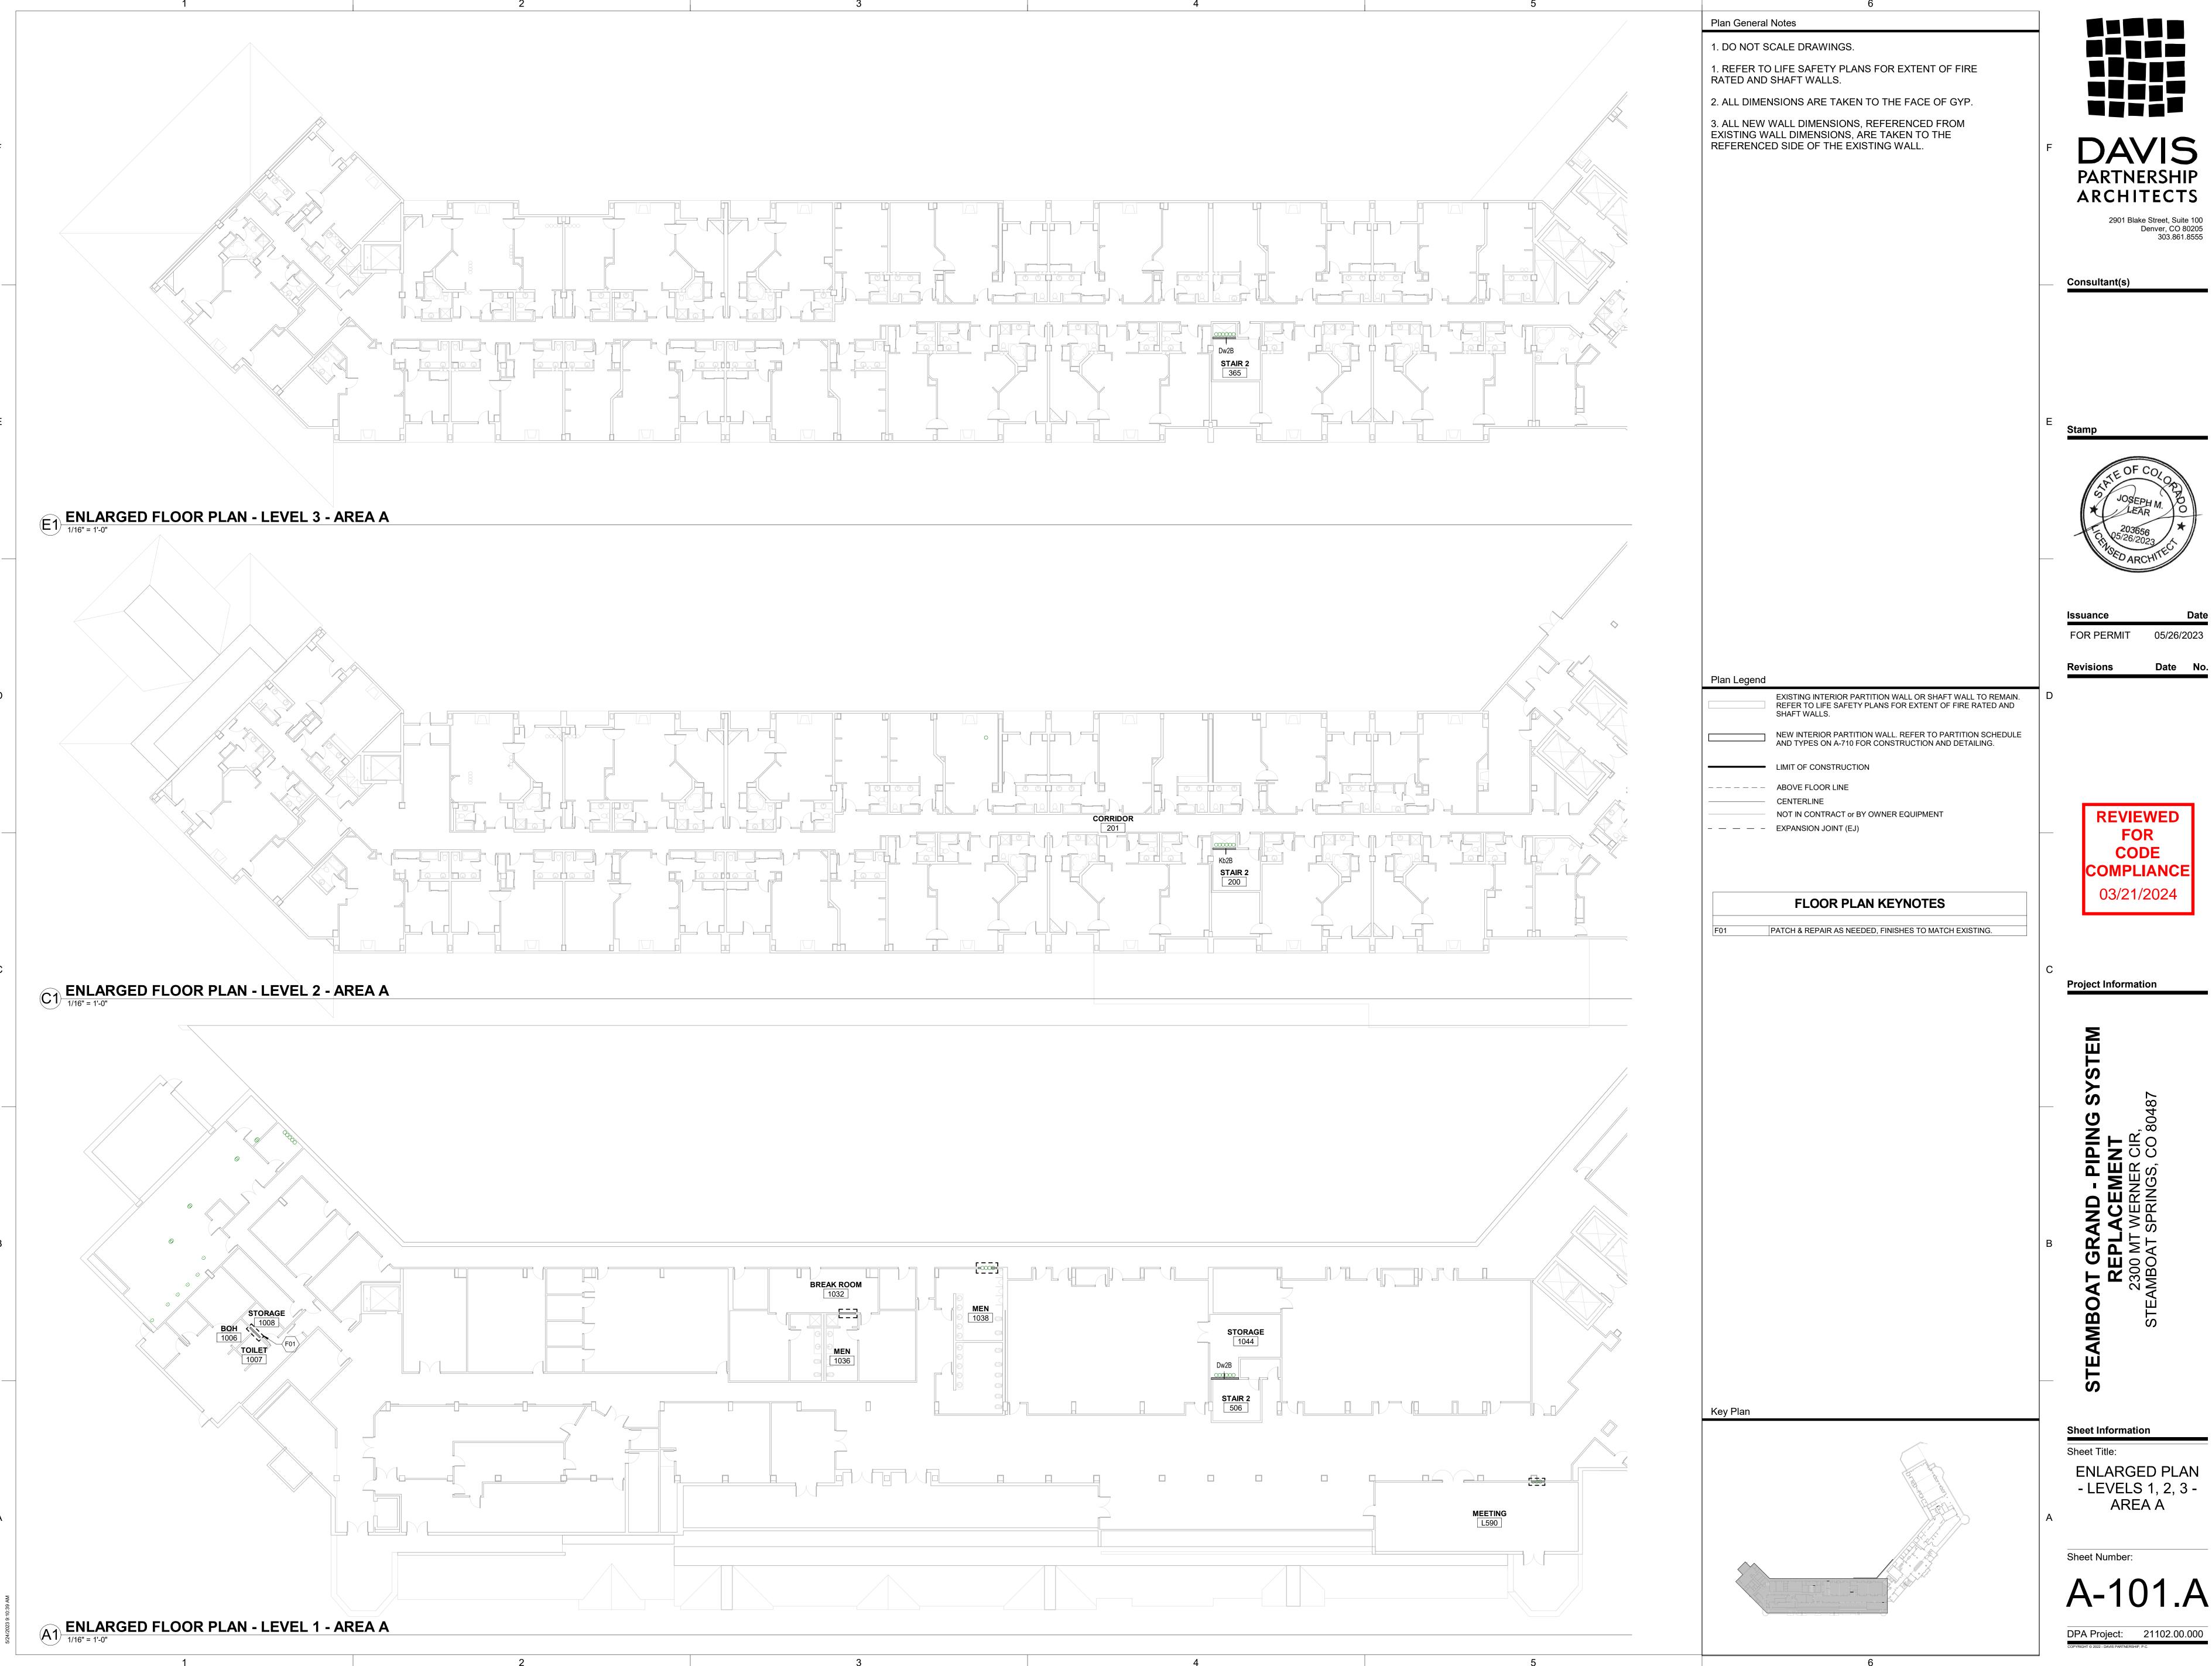

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05/26/2023



Plan General Notes 1. DO NOT SCALE DRAWINGS.

1. REFER TO LIFE SAFETY PLANS FOR EXTENT OF FIRE RATED AND SHAFT WALLS.

2. ALL DIMENSIONS ARE TAKEN TO THE FACE OF GYP.

3. ALL NEW WALL DIMENSIONS, REFERENCED FROM EXISTING WALL DIMENSIONS, ARE TAKEN TO THE REFERENCED SIDE OF THE EXISTING WALL.



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FOR PERMIT 05/26/2023

Revisions

REFER TO LIFE SAFETY PLANS FOR EXTENT OF FIRE RATED AND

LIMIT OF CONSTRUCTION


ABOVE FLOOR LINE CENTERLINE

NOT IN CONTRACT or BY OWNER EQUIPMENT - - - EXPANSION JOINT (EJ)

CODE COMPLIANCE 03/21/2024

Project Information

Key Plan

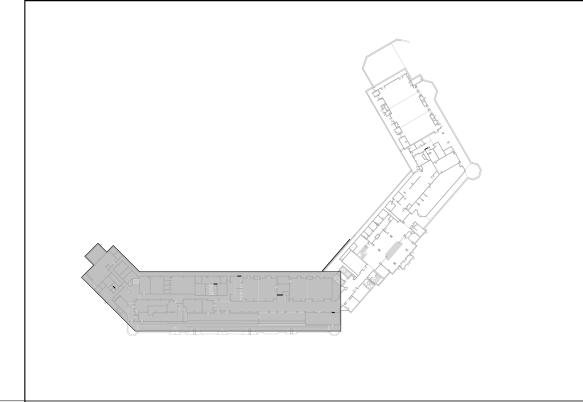


Sheet Information

Sheet Title:

ENLARGED PLAN - LEVELS 4, 5, 6, 7 - AREA A

Sheet Number:

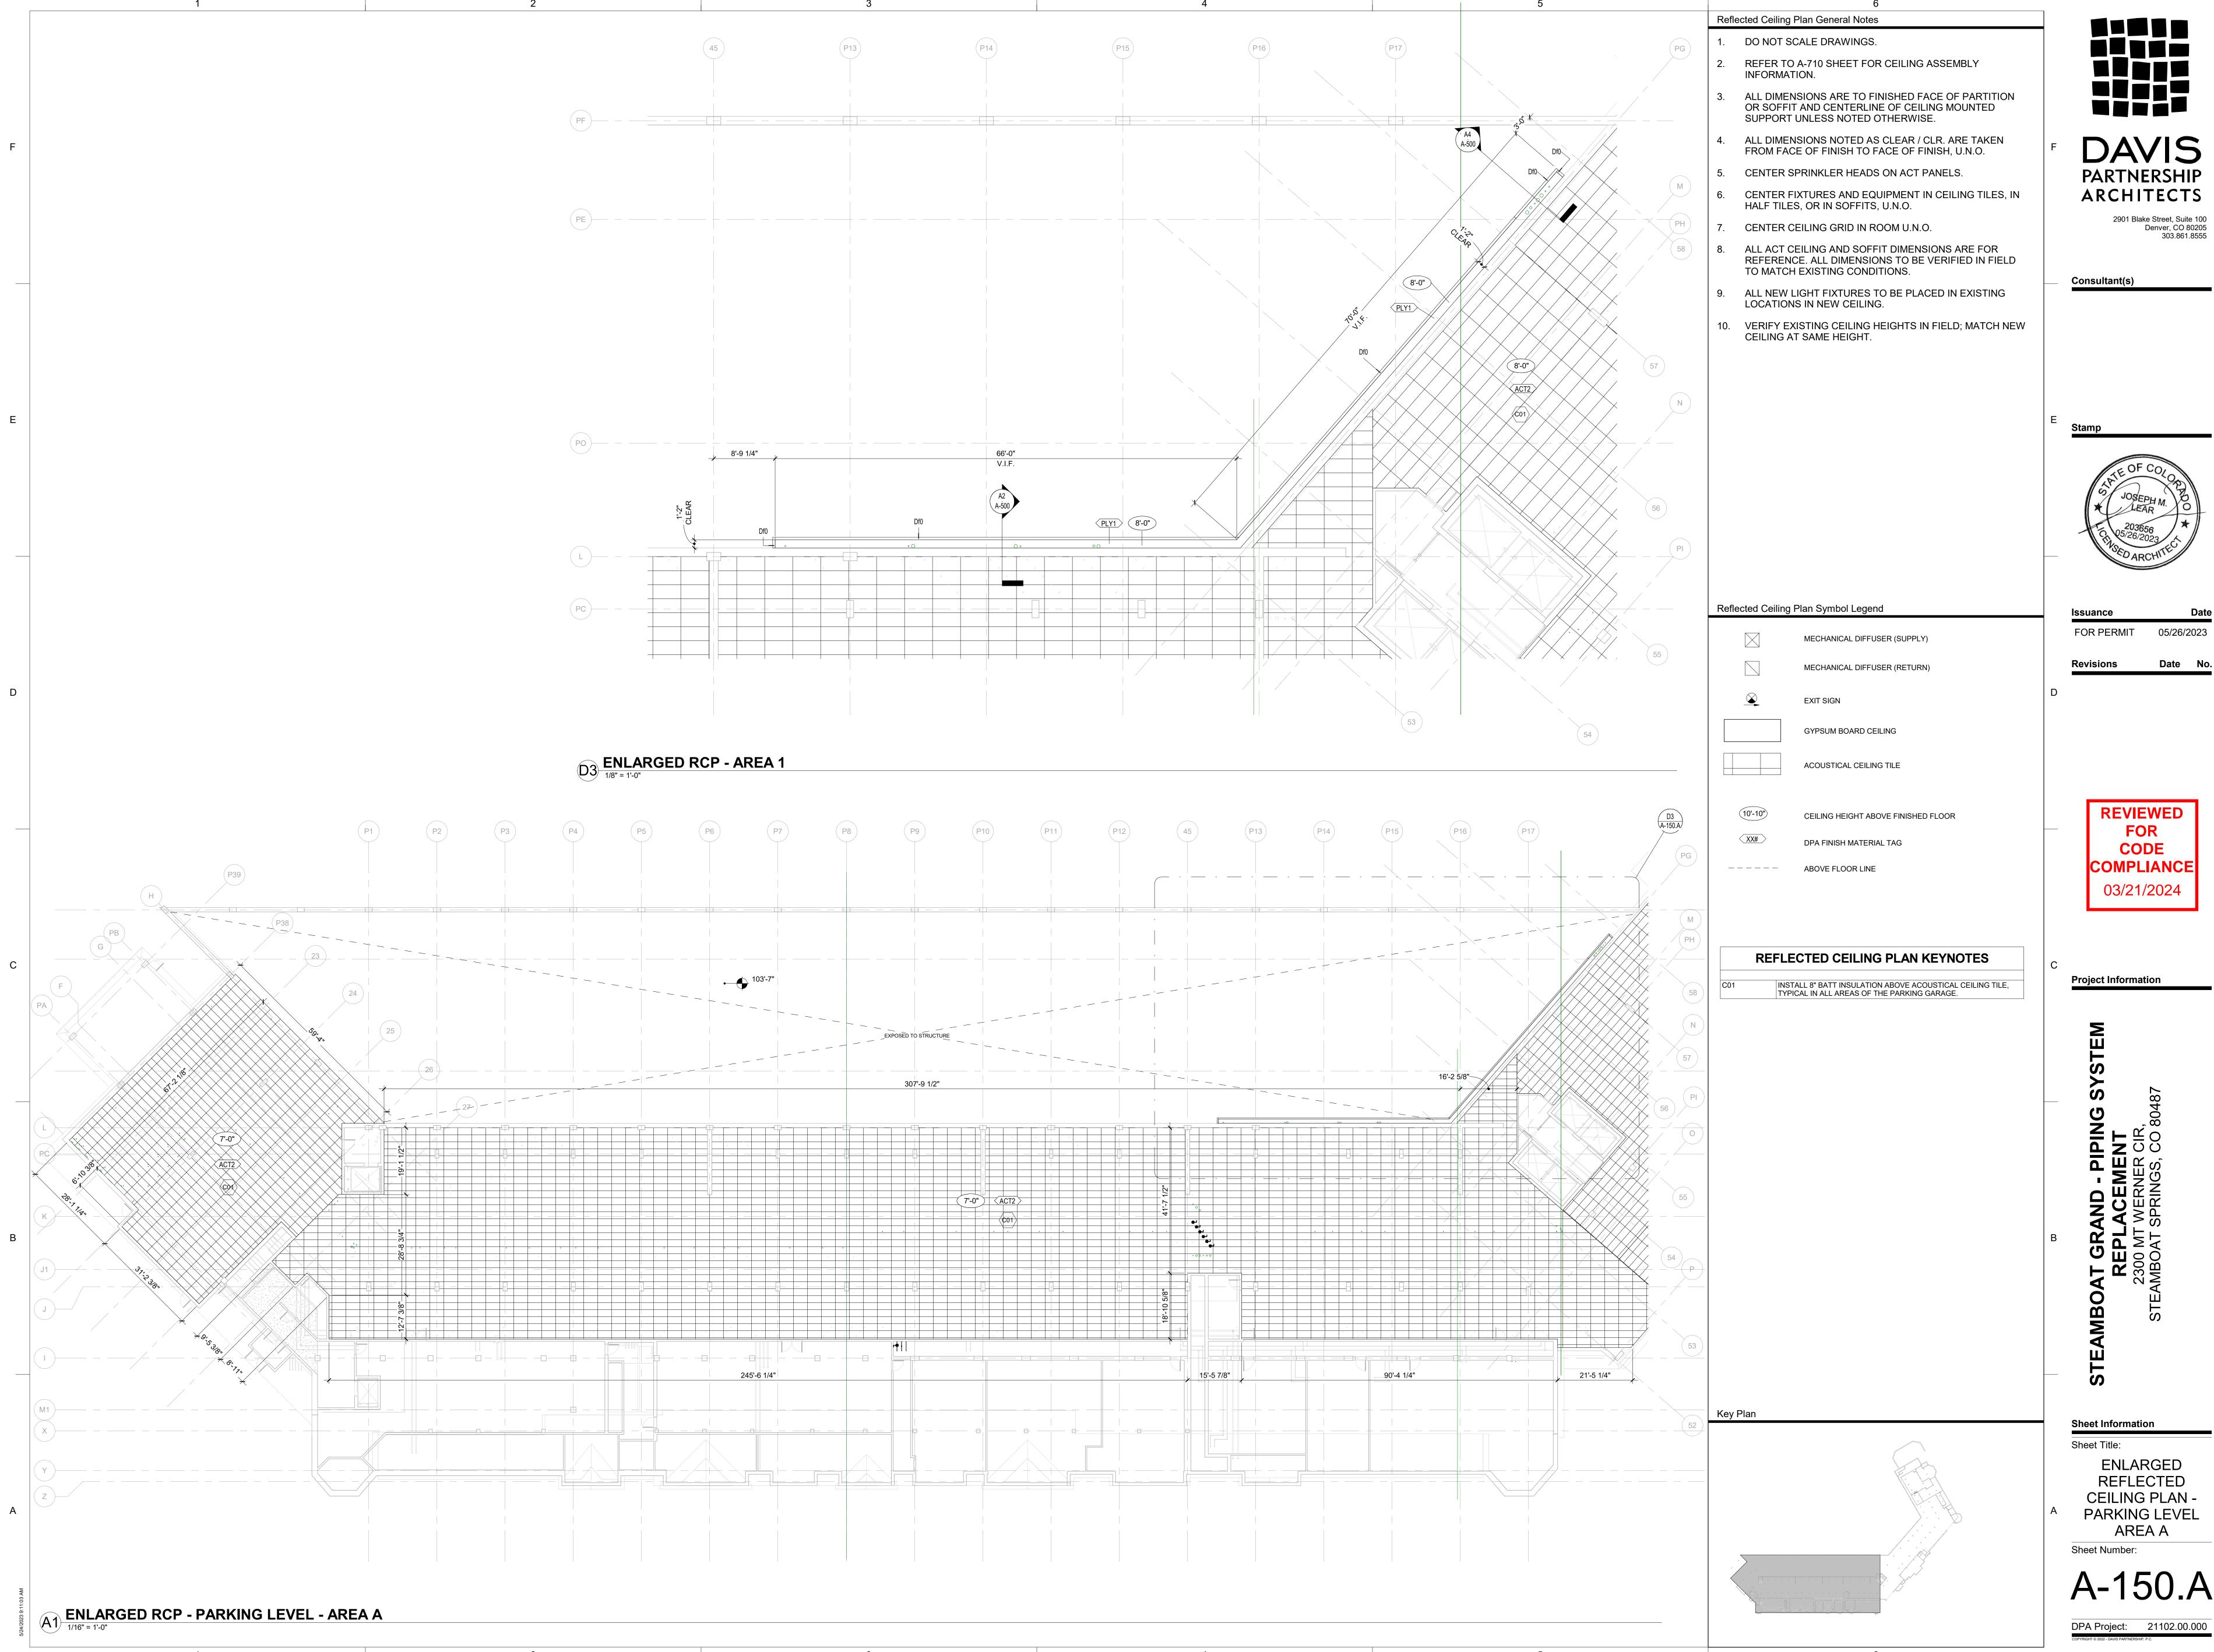


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05/26/2023

A-150.A



Reflected Ceiling Plan General Notes

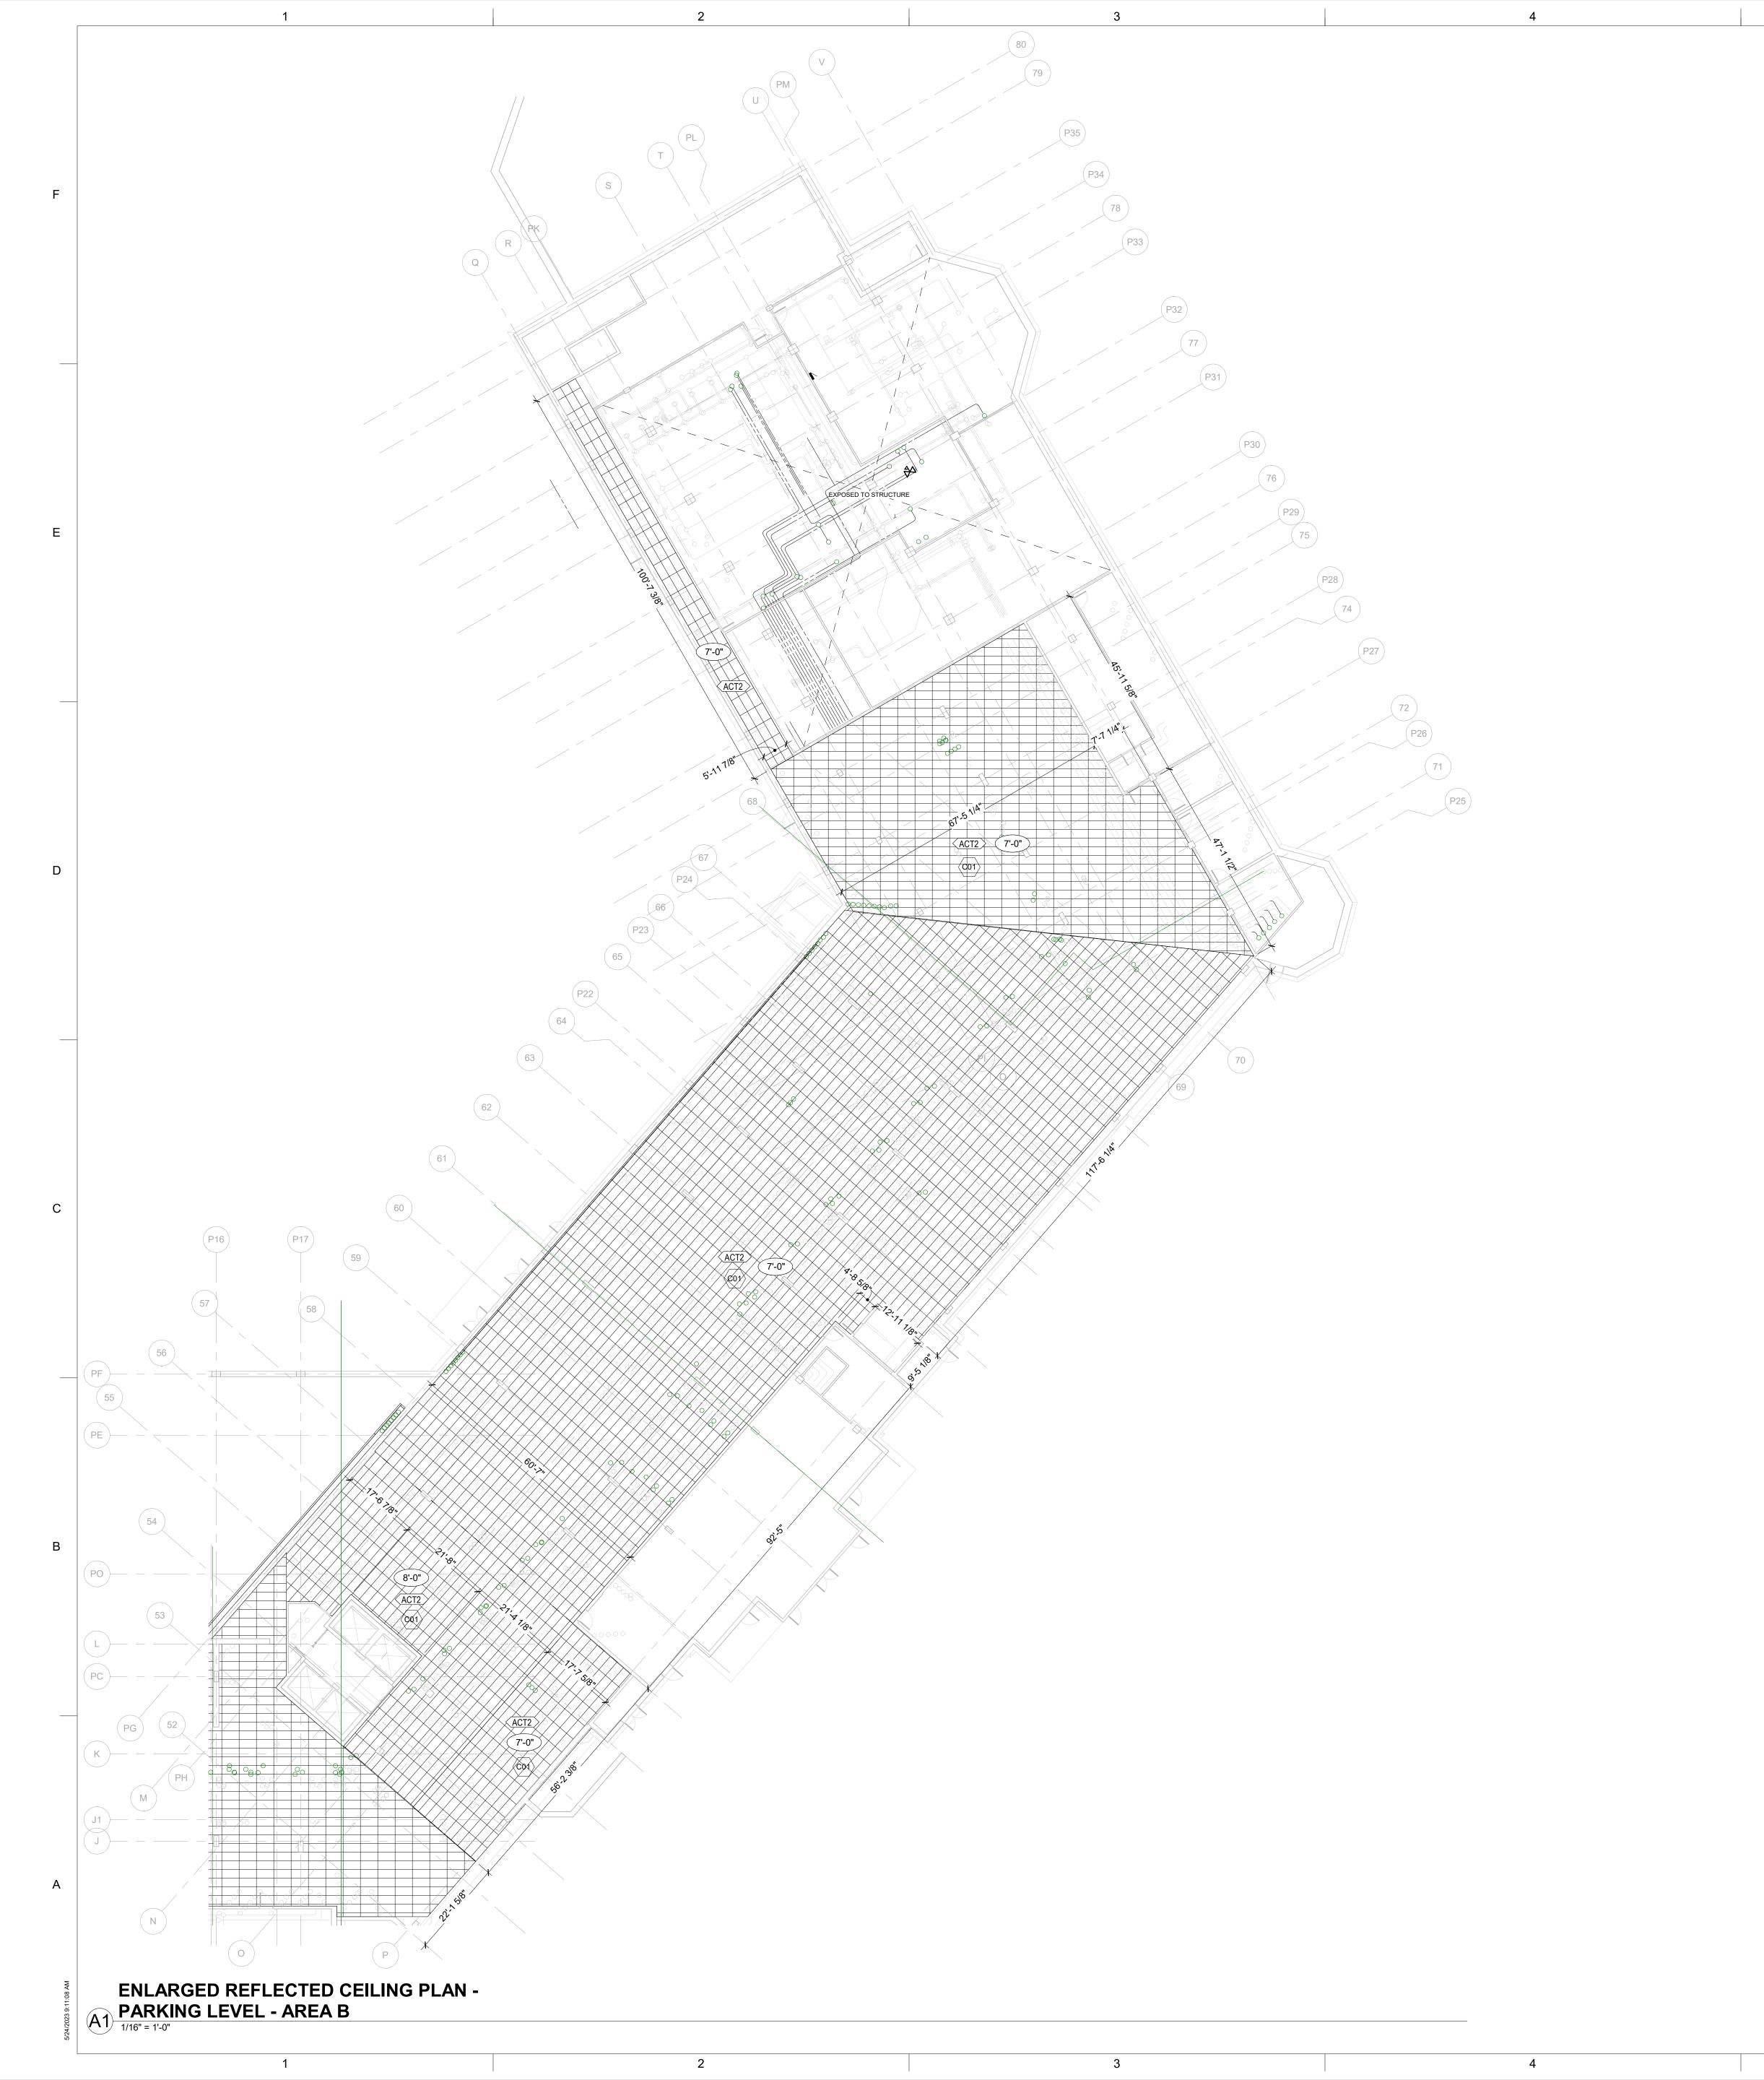DO NOT SCALE DRAWINGS.

REFER TO A-710 SHEET FOR CEILING ASSEMBLY

INFORMATION. ALL DIMENSIONS ARE TO FINISHED FACE OF PARTITION

OR SOFFIT AND CENTERLINE OF CEILING MOUNTED SUPPORT UNLESS NOTED OTHERWISE.

ALL DIMENSIONS NOTED AS CLEAR / CLR. ARE TAKEN FROM FACE OF FINISH TO FACE OF FINISH, U.N.O.

CENTER SPRINKLER HEADS ON ACT PANELS.

CENTER FIXTURES AND EQUIPMENT IN CEILING TILES, IN HALF TILES, OR IN SOFFITS, U.N.O.

CENTER CEILING GRID IN ROOM U.N.O.

ALL ACT CEILING AND SOFFIT DIMENSIONS ARE FOR REFERENCE. ALL DIMENSIONS TO BE VERIFIED IN FIELD TO MATCH EXISTING CONDITIONS.

ALL NEW LIGHT FIXTURES TO BE PLACED IN EXISTING LOCATIONS IN NEW CEILING.

10. VERIFY EXISTING CEILING HEIGHTS IN FIELD; MATCH NEW CEILING AT SAME HEIGHT.

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05/26/2023

Reflected Ceiling Plan Symbol Legend Issuance

MECHANICAL DIFFUSER (SUPPLY)

MECHANICAL DIFFUSER (RETURN)

CEILING HEIGHT ABOVE FINISHED FLOOR

GYPSUM BOARD CEILING

ACOUSTICAL CEILING TILE

DPA FINISH MATERIAL TAG ABOVE FLOOR LINE _____


REFLECTED CEILING PLAN KEYNOTES

INSTALL 8" BATT INSULATION ABOVE ACOUSTICAL CEILING TILE, TYPICAL IN ALL AREAS OF THE PARKING GARAGE.

COMPLIANCE

03/21/2024

Project Information

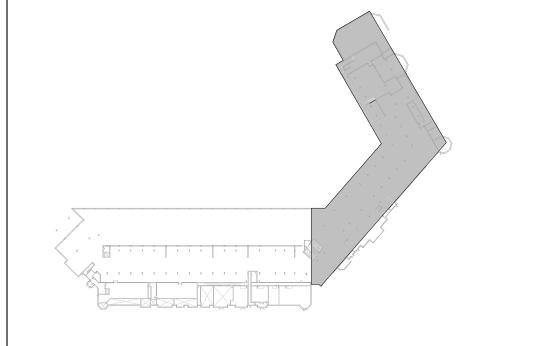

Key Plan


Sheet Information


Sheet Title:

ENLARGED REFLECTED **CEILING PLAN -**PARKING LEVEL AREA B

Sheet Number:

A-150.B

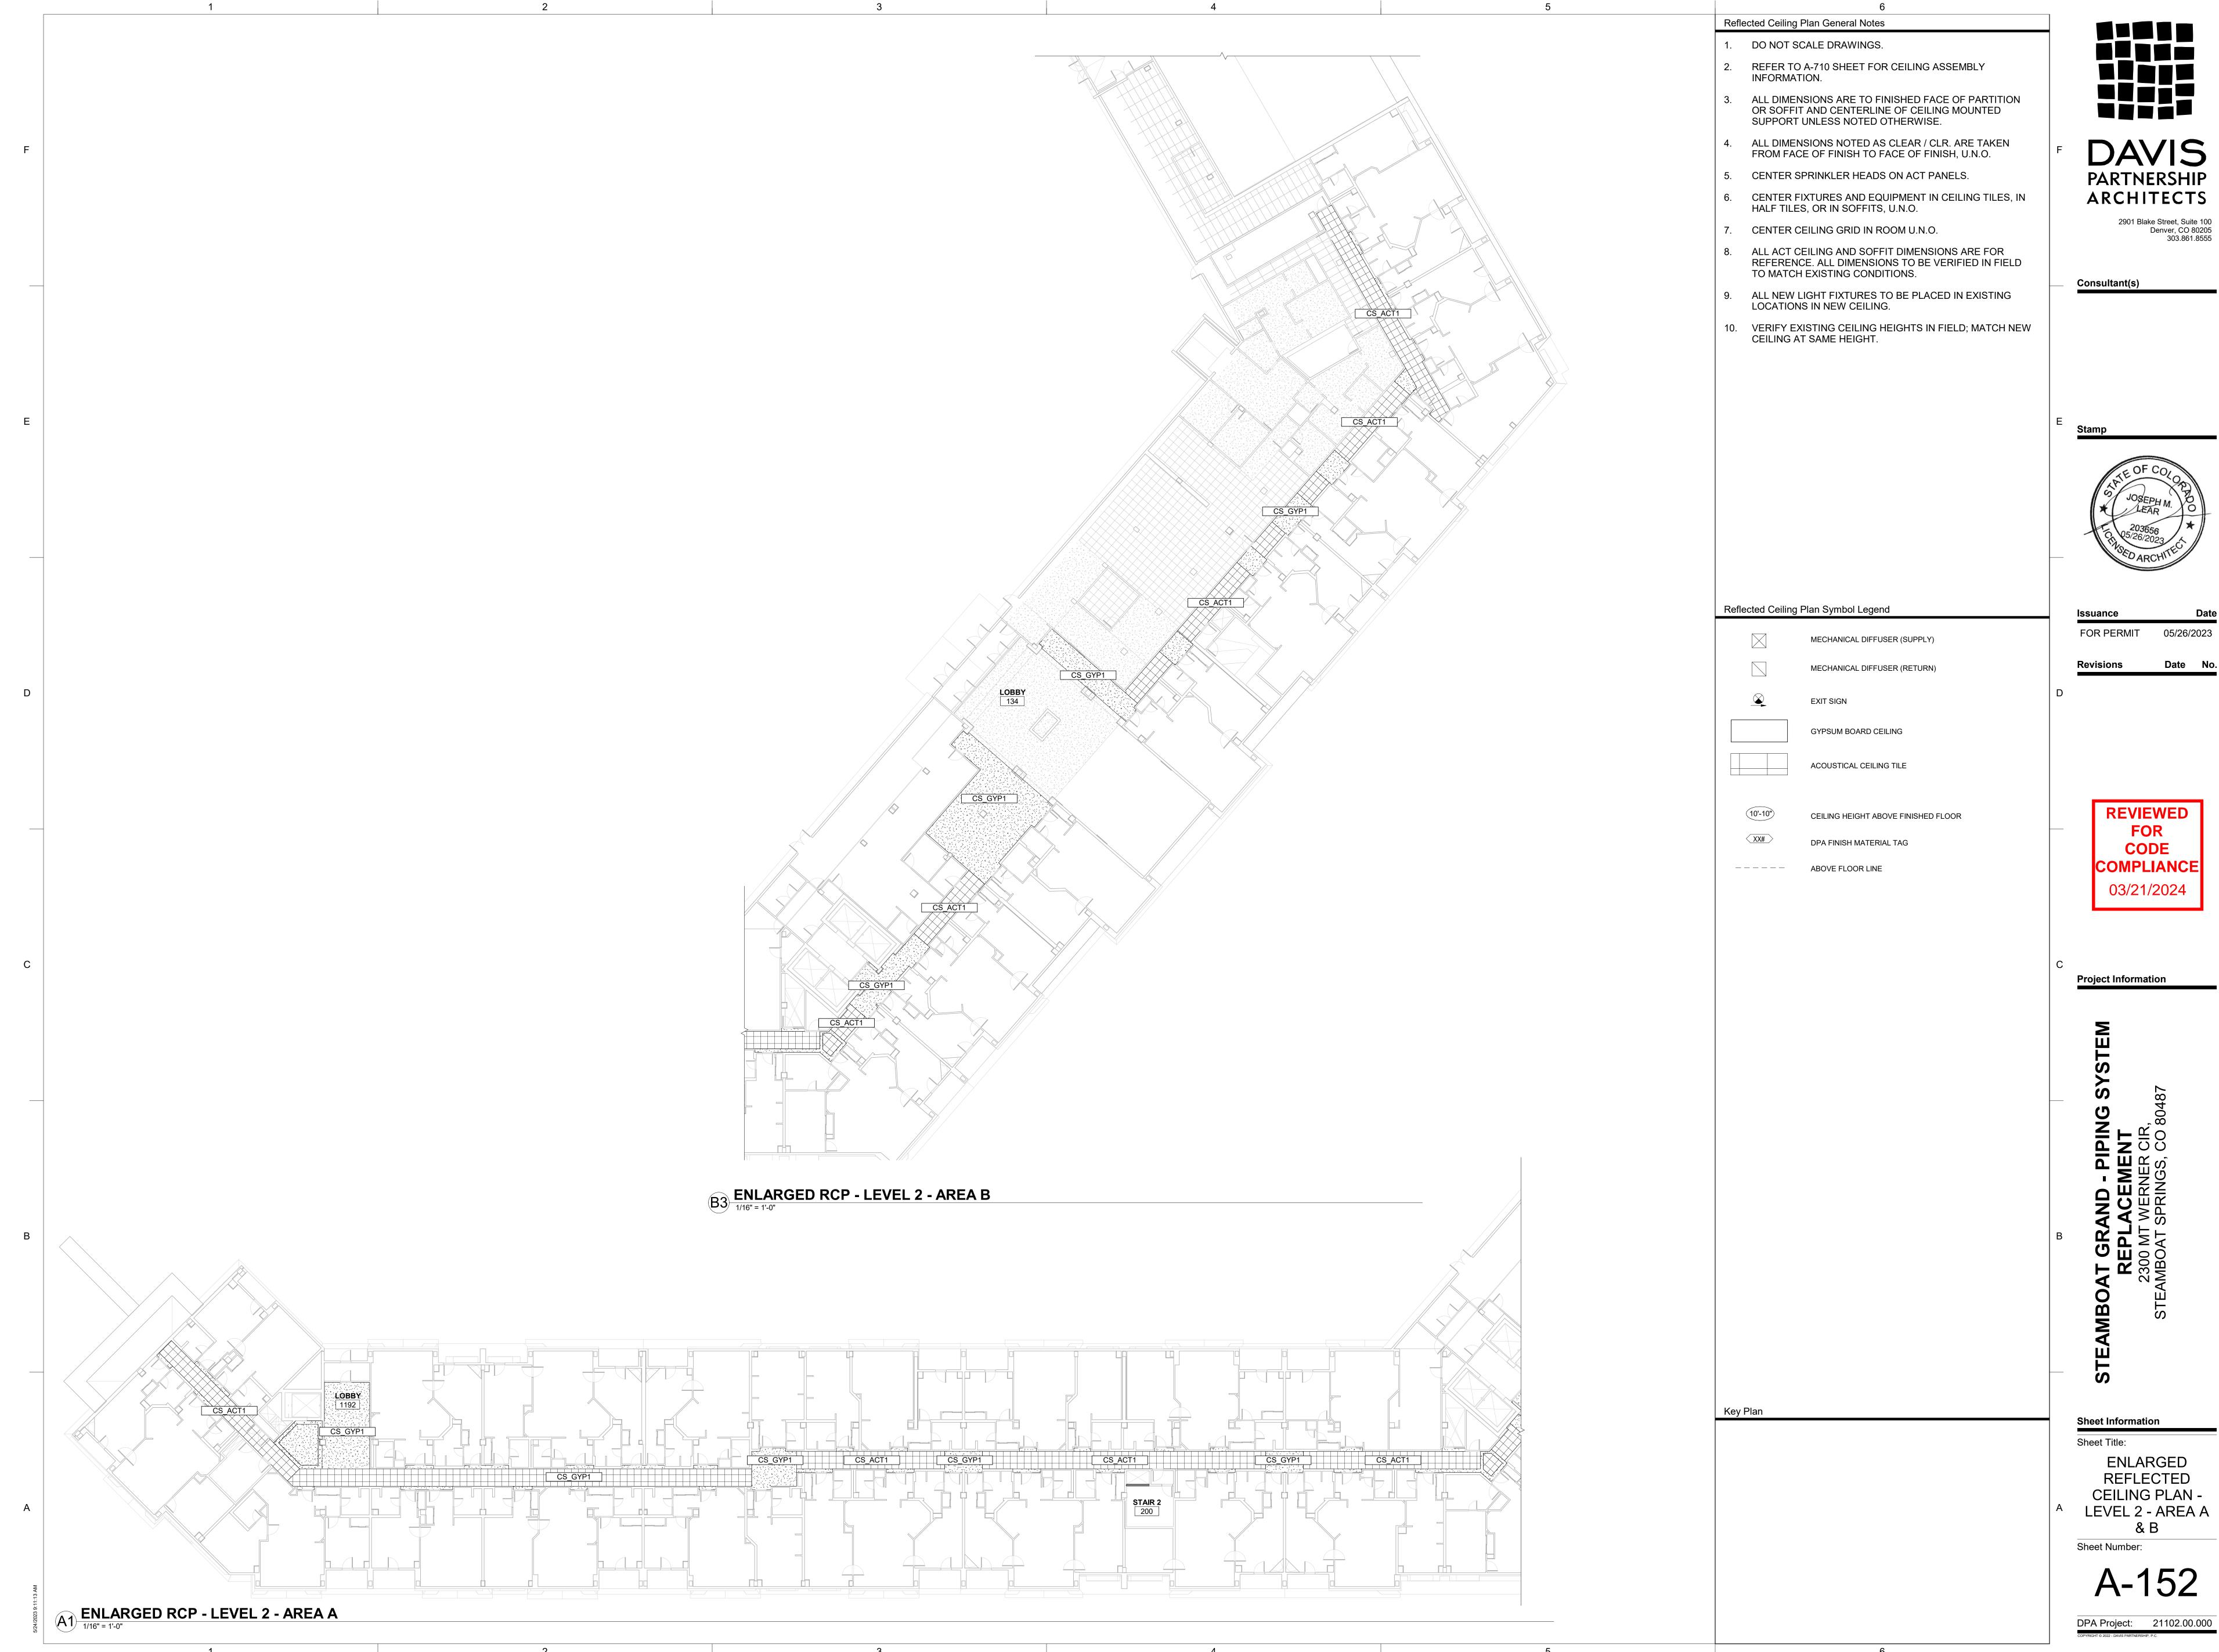

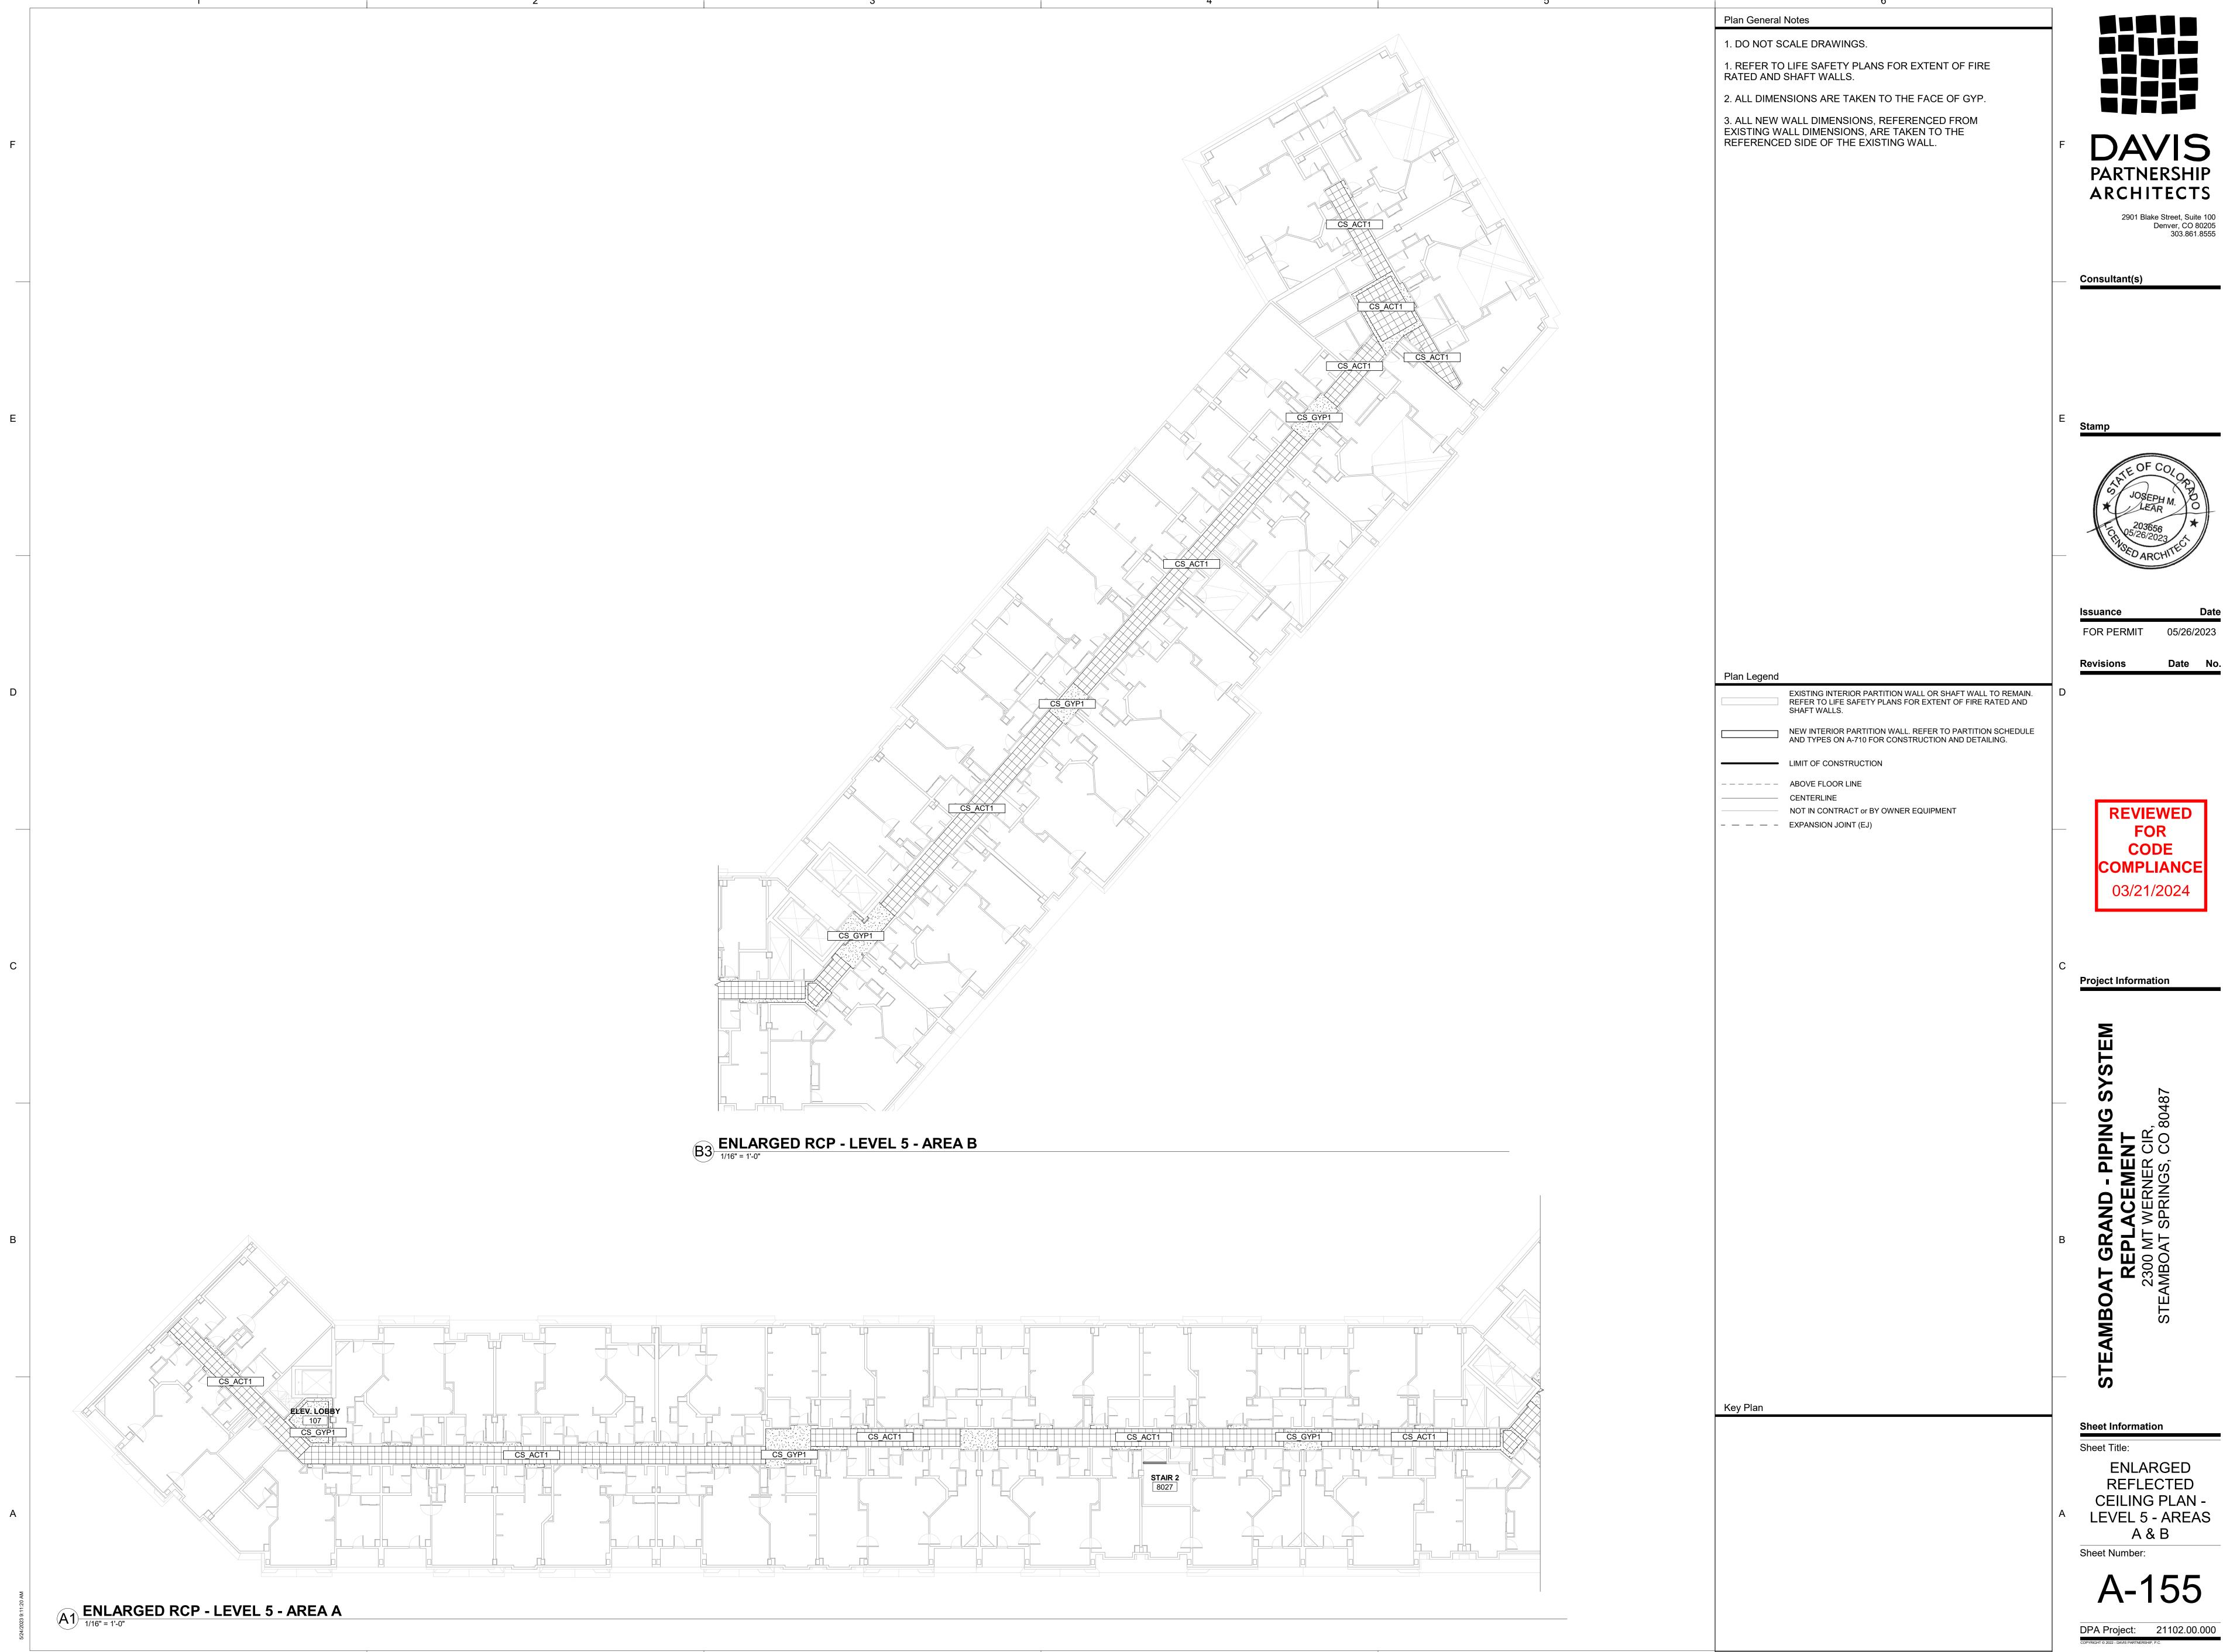

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05/26/2023

03/21/2024

ENLARGED REFLECTED CEILING PLAN -LEVEL 5 - AREAS

DPA Project: 21102.00.000

6


 EXISTING CONCRETE SLAB — 07 9200 - JOINT SEALANT 1' - 2" 06 1600 - FIRE-RETARDANT TREATED PLYWOOD; PAINTED 09 2216 - NON-STRUCTURAL METAL FRAMING LEVEL 1 6950 100'-0" EXISTING WALL -----09 2900 - CORNER BEAD 09 2216 - NON-STRUCTURAL METAL FRAMING - 06 1600 - FIRE-RETARDANT TREATED PLYWOOD; PAINTED — 07 9200 - JOINT SEALANT

A2 SOFFIT DETAIL 2

09 5113 - METAL SUSPENSION—— SYSTEM 09 5113 - ACOUSTICAL PANEL-09 5113 - METAL EDGE_ TRIM 09 5113 - METAL SUSPENSION SYSTEM

E5 DETAIL - ACT TO ACT

A4 SOFFIT DETAIL 1

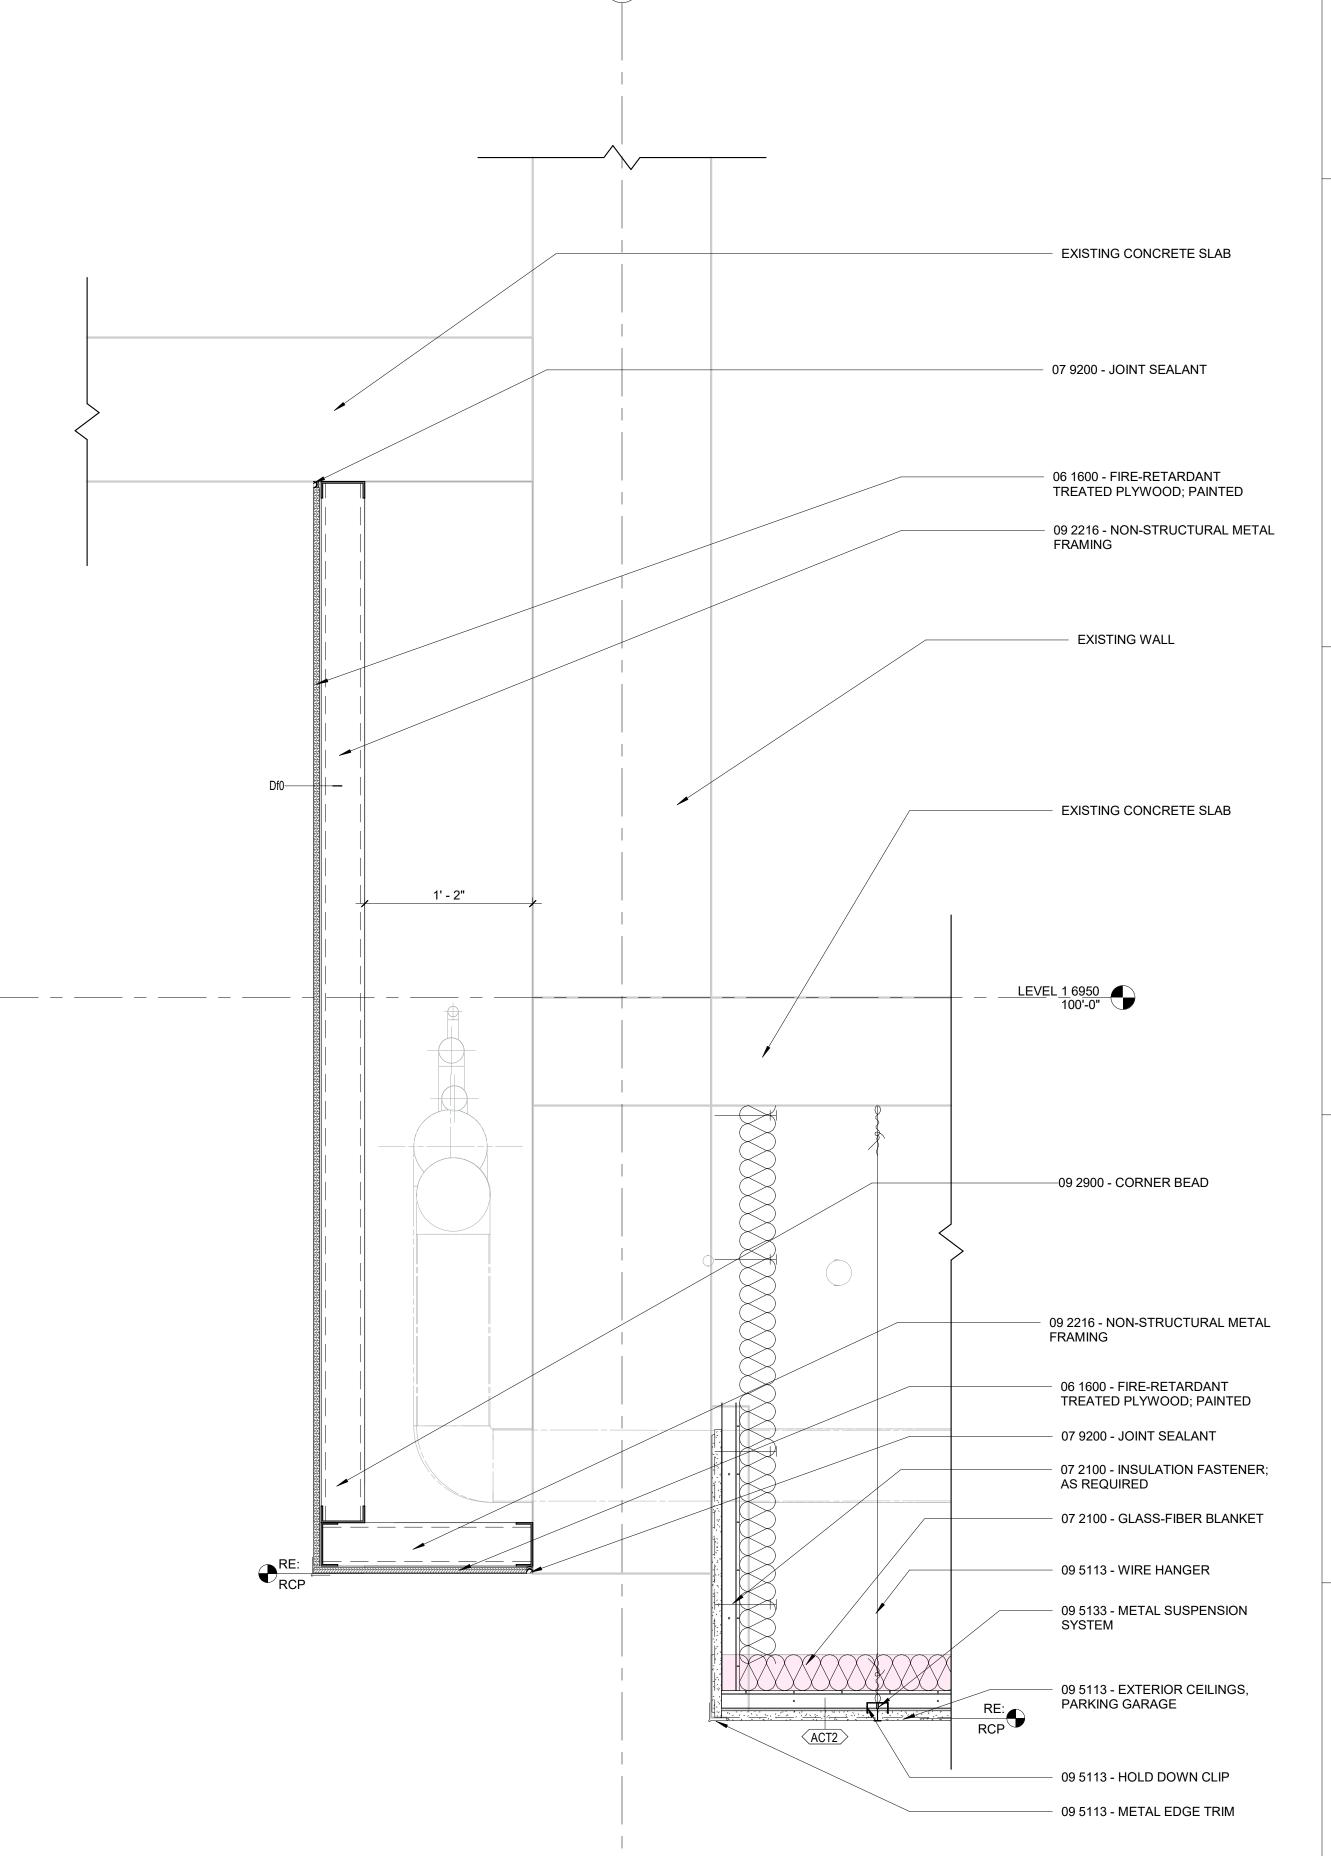

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Project Information

Sheet Information

Sheet Title: GARAGE DETAILS

Sheet Number:

	FINISH	ABBREVIATIONS
ABBREVIA	TION	DESCRIPTION
CEILING FINIS	HES	
ACT	ACOU	STICAL CEILING TILE
EXP	EXPO	SED
GYP	GYPS	UM CEILING
		•

			FINISH SCHEDULE			
FINISH CODE	DESCRIPTION	MANUFACTURER	SERIES/PATTERN	COLOR	SIZE	COMMENTS
	·			·		
CEILING FINISHES						
ACT GRID	ACOUSTICAL CEILING TILE GRID	ARMSTRONG	SUPRAFINE XL/EXPOSED TEE SUSPENSION SYSTEM	WHITE (WH)	9/16"	
CS_ACT1	ACOUSTICAL CEILING TILE	ARMSTRONG	OPTIMA WITH PLANT BASED BINDER/TEGULAR/FINE TEXTURE	WHITE	24" X 24"	
CS_ACT2	ACOUSTICAL CEILING TILE	USG CEILING SOLUTIONS	CLIMAPLUS PERFORMANCE	WHITE	24" X 48"	PARKING GARAGE ONLY
CS_GYP	CEILING GYPSUM BOARD	BY CONTRACTOR		PAINTED PT1		
				·		
WALL FINISHES						
PT1	PAINT	SHERWIN WILLIAMS	SW 7007	BRIGHT WHITE		FLAT FINISH



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CODE COMPLIANCE 03/21/2024


Project Information

Sheet Information Sheet Title:


FINISH LEGEND, NOTES, & INTERIOR **DETAILS**


Sheet Number:



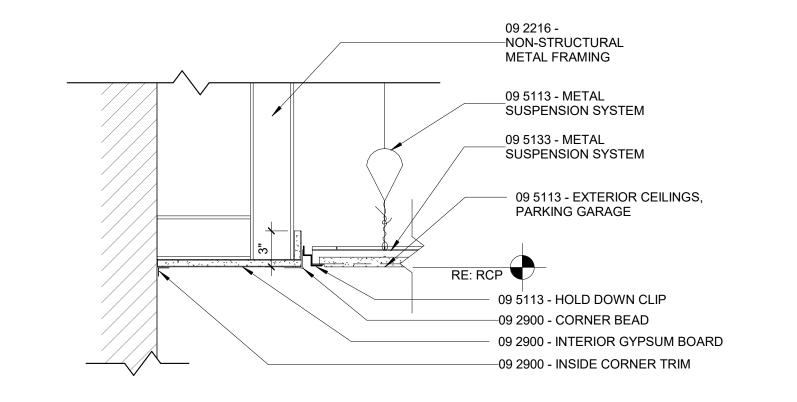


A1 DETAIL - FLUSH SOFFIT

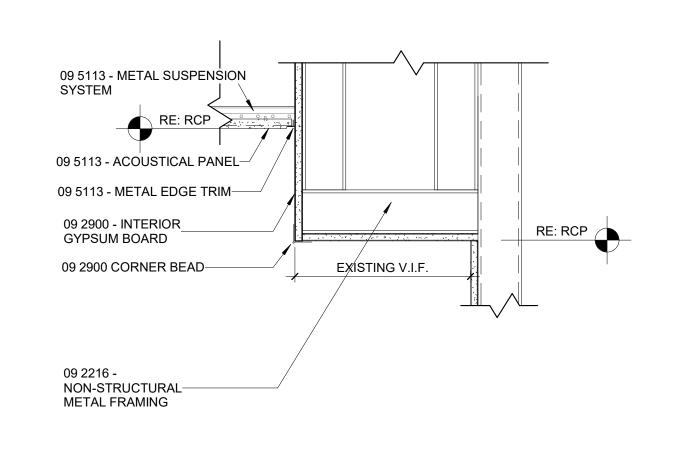


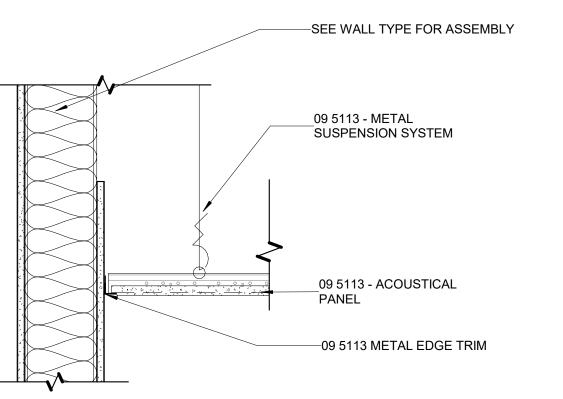


PARTITION TYPES SCHEDULE					
PARTITION TYPE	USE DESCRIPTION	PARTITION WIDTH	STRUCTURE	CONSTRUCTION DESCRIPTION	STC RATING
0					
Db0	PARTITION TO STRUCTURE	0'-4 7/8"	3-5/8" STEEL STUD	(1) LAYER 5/8" GYPSUM BOARD EACH SIDE	
Df0	FURRING WALL	0'-4 1/4"	3-5/8" STEEL STUD	(1) LAYER OF FRT PLYWOOD ON ONE SIDE	
Ff0	FURRING WALL	0'-6 5/8"	6" STEEL STUD	(1) LAYER OF FRT PLYWOOD ON ONE SIDE	
1					
Db1P	FIRE PARTITION TO STRUCTURE	0'-4 7/8"	3-5/8" STEEL STUD	(1) LAYER 5/8" TYPE "X" GYPSUM BOARD EACH SIDE	
2					
Dw2B	FIRE BARRIER TO STRUCTURE	0'-6 1/8"	3-5/8" STEEL STUD	(2) LAYERS 5/8" GYPSUM BOARD EACH SIDE, 3" BATT	
Kb2B	FIRE BARRIER TO STRUCTURE / SHAFT WALL	0'-5 1/4"	4" C-H STEEL STUD	(2) LAYERS 5/8" TYPE "X" GYPSUM BOARD ROOM SIDE WITH 1" SHAFTLINER BOARD SHAFT SIDE	

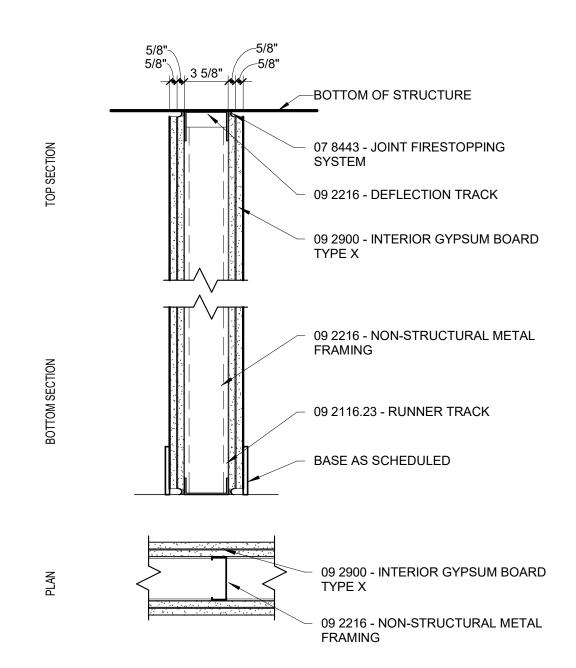


Dw2B - 2 HOUR RATED FIRE BARRIER
1 1/2" = 1'-0"

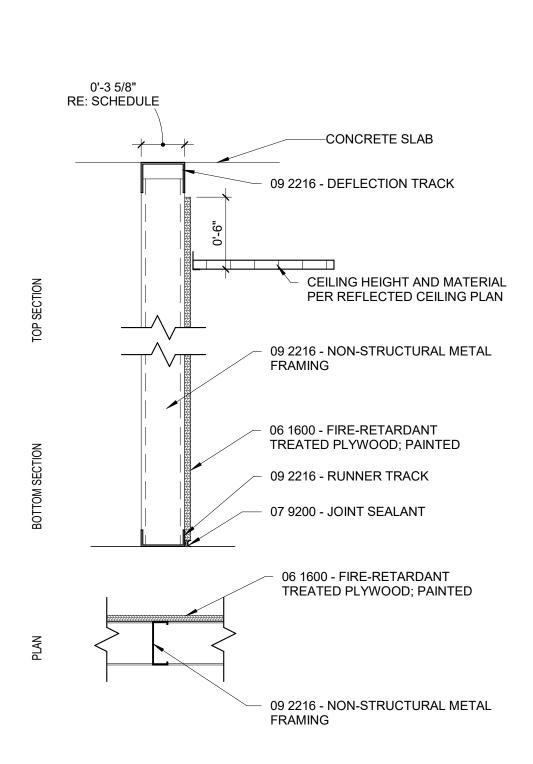

Df0/Ff0 - UNRATED FURRING WALL
1 1/2" = 1'-0"

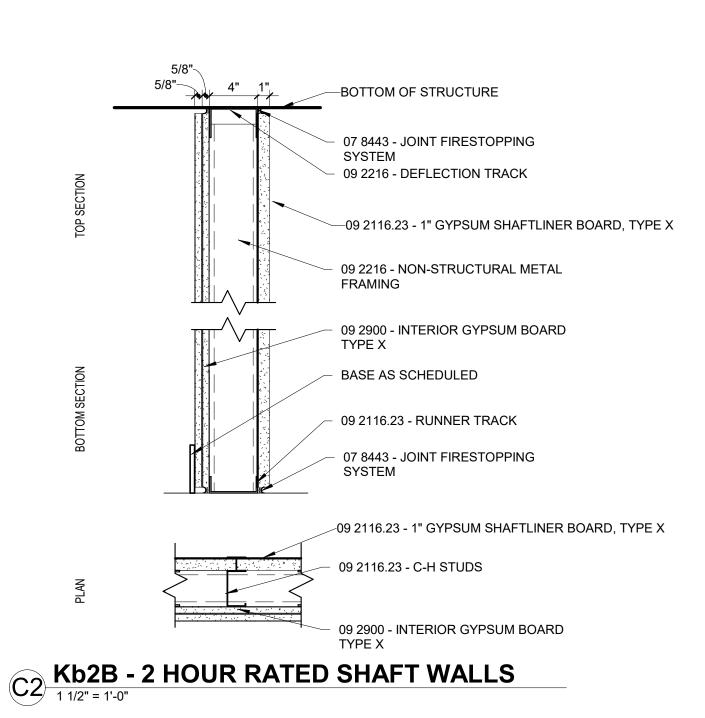

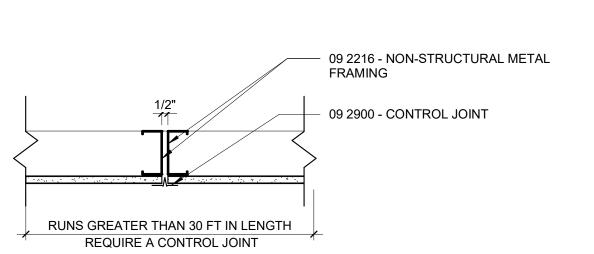

A2 TYP. CONTROL JOINT

INTERIOR PARTITION TYPES **NAMING CONVENTION WALL TAG ANATOMY** STRUCTURE SUB-TYPE FIRE RESISTANCE RATING STRUCTURE SUB-TYPE — FIRE RESISTANCE RATING 6" ABOVE CEILING NON-RATED A 7/8" HAT CHANNEL FIRE RATING TYPE B 1 5/8" STEEL STUD UNDERSIDE OF STRUCTURE 1/2 HOUR SMOKE RATING MODIFIER 2 1/2" STEEL STUD UNDERSIDE OF CEILING 1 HOUR 2 HOUR 3 5/8" STEEL STUD FURRING 4" STEEL STUD PARTIAL HEIGHT 3 HOUR F = 6" METAL STUD 6" STEEL STUD MRI SHIELDING 4 HOUR n = LEAD-LINED SOUND PARTITION 3 5/8" DOUBLE STEEL STUD LEAD-LINED = 2 HOUR FIRE RESISTANCE RATING LEAD-LINED SOUND PARTITION 2 1/2" C-H STEEL STUD FIRE / SMOKE RATING MODIFIERS = FIRE PARTITION BALLISTIC RESISTANT FIBERGLASS 4" C-H STEEL STUD X = SMOKE BARRIER 6" C-H STEEL STUD SOUND PARTITION B FIRE BARRIER 2x4 WOOD STUD THERMAL INSULATION FIRE PARTITION 2x6 WOOD STUD SOUND PARTITION WITH (2) LAYERS W FIRE WALL GYPSUM BOARD ONE SIDE 4" CMU N INTERIOR LOAD BEARING 6" CMU (1) LAYER OTHER SIDE FIRE RESISTANCE RATED WALL 8" CMU w SOUND PARTITION WITH (2) LAYERS 12" CMU GYPSUM BOARD EACH SIDE V SMOKE PARTITION 8" CAST-IN-PLACE CONCRETE z TILE BACKER BOARD SMOKE BARRIER V 12" CAST-IN-PLACE CONCRETE

Y 18" CAST-IN-PLACE CONCRETE Z 1 1/2" Z-FURRING CHANNEL

GENERAL CONSTRUCTION AND LAYOUT NOTES

1. THE INTERIOR FRAMING SUBCONTRACTOR SHALL PROVIDE A DELEGATED ENGINEERED STUD DESIGN FOR ALL NON-STRUCTURAL METAL FRAMING FOR WALLS AND CEILINGS. SUBMIT FRAMING SHOP DRAWINGS WITH DETAILS, PRODUCT SELECTIONS, AND ENGINEERING CALCULATIONS STAMPED BY A LICENSED ENGINEER IN THE PROJECT JURISDICTION. ENGINEERING SHALL INCLUDE PROVISIONS FOR ELEMENTS ATTACHED TO/SUPPORTED BY THE FRAMING. FASTENER DESIGN AND SELECTION IS ALSO REQUIRED. SUBMIT ICC ES EVALUATION REPORTS FOR EACH FASTENER. USE OF DIMPLED OR PERFORMANCE ENCHANCED SHAPED STUDS IS ACCEPTABLE. UNLESS OTHERWISE INDICATED DESIGN FOR A MAXIMUM DEFLECTION OF L/240 AT 5 PSF. AT PARTITIONS TO RECEIVE CERAMIC TILE DESIGN FOR A MAXIMUM DEFLECTION

Y WALL RESISTING THE PASSAGE OF SMOKE

2. ALL INTERIOR PARTITIONS ARE DIMENSIONED TO FINISHED FACE OF GYPSUM BOARD UNLESS NOTED OTHERWISE. 3. ALL STUDS SHALL BE FULL HEIGHT TO UNDERSIDE OF STRUCTURE UNLESS INDICATED OTHERWISE BY PARTITION TYPE.

4. BOTTOM OF GYPSUM BOARD SHALL BE 1/4" TO 3/8" ABOVE FINISH FLOOR UNLESS OTHERWISE INDICATED. 5. OFFSET STUDS AS NECESSARY TO ALIGN OUTSIDE FACES OF GYPSUM BOARD AT ADJACENT WALL TYPES WITH VARYING LAYERS OF GYPSUM BOARD.

MOVEMENT AND 1" OF DOWNWARD DYNAMIC MOVEMENT CAPABILITIES. 7. AT SLAB-ON-GRADE CONDITIONS PROVIDE DYNAMIC MOVEMENT REQUIREMENTS CALLED FOR IN THE GEOTECHNICAL INVESTIGATION (SOILS REPORT). IF NO

GEOTECHNICAL INVESTIGATION EXISTS CONTACT THE ARCHITECT FOR DEFLECTION CRITERIA. 8. ALL PARTITION TYPES MARKED BY A "t" SUFFIX (IE. D0t) SHALL BE INSTALLED WITH FULL HEIGHT AND WIDTH CONTINUOUS THERMAL INSULATION AND, IF INDICATED, CONTINUOUS VAPOR RETARDER.

6. PROVIDE DEEP LEG TRACKS (3" FLANGE) AT HEAD OF PARTITIONS AT ALL NON-LOAD BEARING PARTITIONS FOR EACH CONDITION THAT ALLOW FOR 1" OF UPWARD

9. PROVIDE GYPSUM BOARD CONTROL JOINTS PER ASTM C 840 UNLESS OTHERWISE INDICATED ON DRAWINGS. 10. PROVIDE FIRE BLOCKING AND DRAFT STOPS PER CODE.

OF L/360 AT 5 PSF.

. FIRE RATED ASSEMBLY CRITERIA TAKE PRECEDENT OVER ANY OTHER CONSTRUCTION CRITERIA. 2. REFERENCE LIFE SAFETY DRAWINGS FOR LOCATIONS OF FIREWALLS, FIRE BARRIERS, FIRE PARTITIONS, SMOKE PARTITIONS, SMOKE BARRIERS, AND WALLS RESISTING THE PASSAGE OF SMOKE. COMPLY WITH IBC AND ANY OTHER APPLICABLE CODES FOR CONSTRUCTION REQUIREMENTS FOR EACH RATED PARTITION TYPE. E. REFERENCE SPECIFICATION SECTION 07 8413 – 'PENETRATION FIRESTOPPING' FOR TREATMENT OF ANY PENETRATIONS THROUGH A FIRE RATED PARTITION. 4. REFERENCE SPECIFICATION SECTION 07 8443 - 'JOINT FIRESTOPPING' FOR TREATMENT OF TOP AND BOTTOM OF WALL JOINTS AND JOINTS TO ABUTTING CONSTRUCTION. 5. PROVIDE AND SUBMIT FOR APPROVAL U.L. RATED HEAD OF WALL ASSEMBLIES FOR EACH RATED PARTITION CONDITION THAT ALLOWS FOR THE DYNAMIC MOVEMENT INDICATED. IF ACCEPTABLE TO THE AUTHORITY HAVING JURISDICTION (AHJ), OBTAIN ENGINEERING JUDGEMENTS FOR JOB SPECIFIC CONDITIONS NOT ADDRESSED BY TESTED ASSEMBLIES.


6. PROVIDE FIRE-RATED ACCESS DOORS AND FRAMES TO REACH DAMPERS OR CONTROL VALVES IN RATED PARTITIONS OR CEILING AS REQUIRED TO MAINTAIN RATING. PROVIDE NONRATED ACCESS DOORS AT NON RATED CONSTRUCTION. . WHERE DEVICES ARE RECESSED IN A FIRE RATED PARTITION PROVIDE: A.) DEVICE RATED FOR INSTALLATION IN RATED PARTITIONS, OR B.) CONSTRUCTION SUCH THAT FIRE RATING IS MAINTAINED BEHIND RECESSED DEVICE.


8. WHERE STRUCTURAL ITEMS SUCH AS HANGERS FOR STAIRS ARE EMBEDDED IN A RATED PARTITON CONSTRUCTION SHALL BE SUCH THAT FIRE RATING IS MAINTAINED BEHIND EMBEDDED ITEM. MARKING AND IDENTIFICATION: FIRE WALLS, FIRE BARRIERS, FIRE PARTITIONS, SMOKE BARRIERS AND SMOKE PARTITIONS OR ANY OTHER WALL REQUIRED TO HAVE PROTECTED OPENINGS OR PENETRATIONS SHALL BE LABELED PER CODE.


10. PROVIDE SMOKE PARTITIONS TO LIMIT THE TRANSFER OF SMOKE. FILL JOINTS AND THE SPACE AROUND PENETRATING ITEMS SUCH AS DUCTS, PIPES, CONDUITS, AND SIMILAR BUILDING SERVICE EQUIPMENT WITH AN APPROVED MATERIAL TO LIMIT THE PASSAGE OF SMOKE.


ALL PARTITION TYPES WITH A SUB-TYPE DESIGNATING A "SOUND PARTITION" SHALL BE INSTALLED TO INCLUDE FULL HEIGHT AND WIDTH SOUND ATTENUATION BLANKETS (SAB) AND ACOUSTICAL JOINT SEALANT AT TOPS AND BOTTOMS OF ALL WALLS AND PENETRATIONS

PROVIDE ELECTRICAL OUTLET BARRIER PADS IN SOUND PARTITIONS. 3. STAGGER DEVICES THAT PENETRATE OPPOSING WALL SURFACES IN ADJACENT STUD CAVITIES.

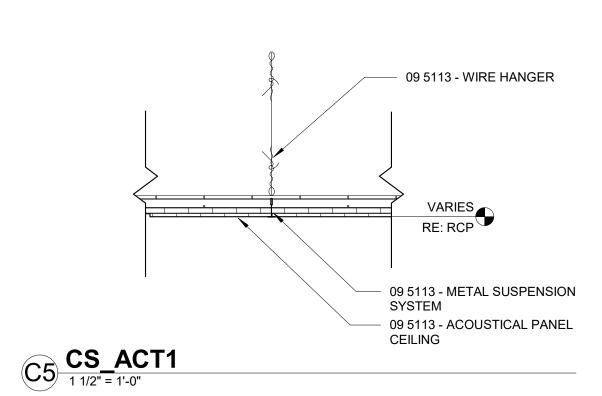

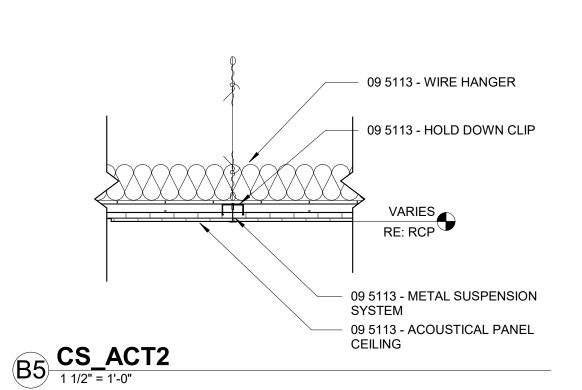

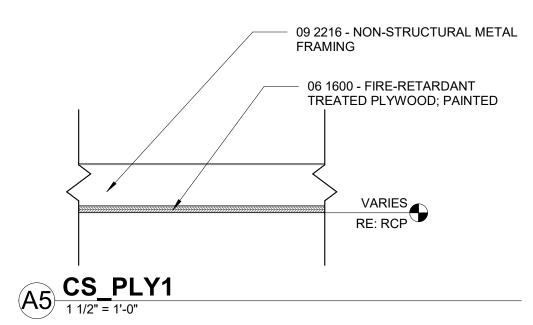

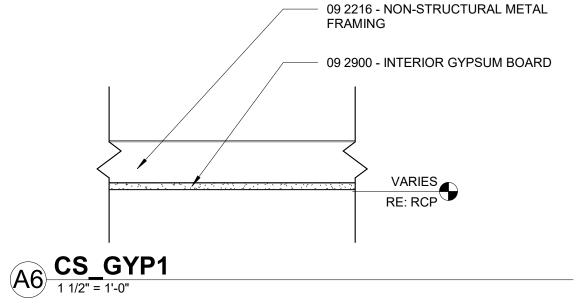



Denver, CO 80205

303.861.8555

Consultant(s)



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Project Information

Sheet Information

Sheet Title: INTERIOR PARTITON AND **CEILING TYPES**

Sheet Number: