ELECTRICAL EQUIPMENT LEGEND	CC	MMUNICATION LEGEND
BRANCH CIRCUIT PANELBOARD		
TELEPHONE TERMINAL BOARD	PLAIN DATA C	UTLET
	$\bigtriangledown$ 80" PLAIN DATA C	UTLET WITH MOUNTING HEIGHT
F FUSED SAFETY SWITCH / DISCONNECT COMBINATION		DATA/TELEPHONE
	FLOOR MOUN	TED COMBINATION DATA/TELEPHONE
	CEILING MOU	TED COMBINATION DATA/TELEPHONE
	V	UTLET
_		
		PEAKER WALL MOUNTED
CONDUIT OR WIRE UNDERFLOOR/UNDERGND. (DASHED LINE TYPE)		IG MOUNTED SPEAKER
		KER
		SH TO CALL SWITCH
ELECTRICAL DEVICE LEGEND		CESS POINT ABOVE THE CEILING
(J) CEILING JUNCTION BOX - SURFACE/FLUSH	PROJECTOR	CONNECTION ABOVE THE CEILING
	L R	
	HDMI WALL MOUNT	ED HDMI
	FIRE A	LARM EQUIPMENT LEGEND
	FACP FIRE ALARM	CONTROL PANEL
	FAAP FIRE ALARM	NNUNCIATION PANEL
		OLE STATION
+ USB		IORN
	FIRE ALARMS	TROBE
H CW	FIRE ALARM I	IORN STROBE
	^	TOR
$\checkmark$		CTOR - PHOTOELECTRIC
	SMOKE DETE	CTOR - IONIZATION
		SMOKE / CARBON MONOXIDE DETECTOR
		OR - 135° ALARM
		P
		1
	TS TAMPER SWI	СН
	DH DOOR HOLD	MAGNETIC HOLD
(M) ELECTRICAL METER SHOWN IN ONE LINE		
o d 100A = AMP RATING	SE	CURITY SYSTEM LEGEND
100  A  2P CLASS T = FUSE CLASS		
		MERA
	HC ADA DOOR C	PERATOR PUSH BUTTON
PP1= PANEL NAME		OR STRIKE
120/208V = PANEL VOLTAGE		R FOR DOOR OPERATOR
3PH, 4 WIRE = PANEL PHASE, DISTRIBUTION TYPE		
PP1 PP1 225A MLO 225A MCB		
120/208V 120/208V		
3PH, 4W 3PH, 4W		
	PRANCH CIRCUIT PANELBOARD         TELEPHONE TERMINAL BOARD         ELECTRIC MOTOR         F       FUSED SAFETY SWITCH / DISCONNECT COMBINATION         CONTACTOR         CONTACTOR         CONTACTOR         CONTACTOR         CONDUIT OR WIRE CONCEALED IN WALL/CLG. (SOLID LINE TYPE)         CONDUIT OR WIRE CONCEALED IN WALL/CLG. (SOLID LINE TYPE)         CONDUIT OR WIRE CONCEALED IN WALL/CLG. (SOLID LINE TYPE)         CONDUIT OR WIRE CONCEALED IN WALL/CLG. (SOLID LINE TYPE)         CONDUIT OR WIRE CONCEALED IN WALL/CLG. (SOLID LINE TYPE)         CONDUIT OR WIRE CONCEALED IN WALL/CLG. (SOLID LINE TYPE)         CONDUIT OR WIRE CONCEALED IN WALL/CLG. (SOLID LINE TYPE)         CONDUIT OR WIRE CONCEALED IN WALL/CLG. (SOLID LINE TYPE)         CONDUIT OR WIRE CONCEALED ON WALL DUNCTION BOX - SURFACE/FLUSH         UPLEX RECEPTACLE         SPLIT WREED DUPLEX RECEPTACLE         EVENT WREE RECEPTACLE         CONTRUE RECEPTACLE         CONDUCTED FOURPLEX RECEPTACLE         POURPLEX RECEPTACLE         CONTRUE RECEPTACLE         CONTRUE RECEPTACLE         CONTRUE RECEPTACLE         CONTRUE RECEPTACLE         CONTRUE RECEPTACLE         CONTACTOR         RECEPTACLE MOUNTED ATALST CIRCUIT INTERRUPTER         CHOR MOUNTED ATALST	■ BRANCH CIRCUIT PANELBOARD         ■ TELEPTION DISCONNECT COMBINATION         ● ELECTION MOTOR         ● FUSID SARTY SWITCH DISCONNECT COMBINATION         ● COMPLICATION BOX         ● CONTRACTOR         ● CONTRACTOR BACKTOR         ● CONTRACTOR BACKTORALE         ● CONTRACTORALE AN

- 1. ALL WIRING IS SHOWN DIAGRAMMATICALLY ON DRAWING, FIELD VERIFY ALL CONDITIONS PRIOR TO ROUGH-IN. 2. ALL CONDUITS AND CONVEYANCES SHALL BE CONCEALED. IN THE EVENT THAT A NEW DEVICE IS BEING INSTALLED IN AN EXISTING DRYWALL PARTITION, PROVIDE A CUT IN TYPE BOX AND FISH
- FLEXIBLE CONDUIT DOWN INSIDE THE WALL FROM ABOVE THE CEILING AND REPAIR THE DRYWALL AROUND THE CONDUIT. TRANSITION TO EMT ONCE ABOVE THE CEILING. 3. SIZES OF WIRE AND CABLES ARE BASED UPON COPPER CONDUCTORS, UNLESS OTHERWISE INDICATED. ALL CIRCUITS SHALL CONTAIN (2) #12 AWG WITH (1) #12 GND IN 1/2" CONDUIT UNLESS NOTED OTHERWISE.
- 4. ALL BRANCH CIRCUITS WITH HOME RUNS OVER 50 FEET, WILL BE SIZED ONE SIZE LARGER. 5. ALL PENETRATIONS IN OR THROUGH FIRE RATED PARTITIONS SHALL BE FIRE STOPPED IN SUCH A
- WAY THAT THE PENETRATION MATCHES THE FIRE RATING OF THE WALL. 6. THE ELECTRICAL CONTRACTOR IS RESPONSIBLE FOR ALL COORDINATION BETWEEN THE
- APPROPRIATE DISCIPLINES AND CONTRACTORS. 7. COORDINATE ALL DEVICE, FIXTURE AND HARDWARE COLOR SELECTIONS WITH THE ARCHITECT PRIOR TO MAKING SHOP DRAWING SUBMITTALS.
- 8. COORDINATE THE MOUNTING HEIGHTS OF ALL RECEPTACLES MOUNTED ABOVE COUNTERS, CASEWORK AND APPLIANCE RECEPTACLES WITH ARCHITECTURAL ELEVATIONS.
- 9. BRANCH CIRCUIT AND SPECIAL SYSTEMS WIRING FOR DEVICES ON WALLS IN FINISHED AREAS WHICH CANNOT BE CONCEALED SHALL BE INSTALLED IN SURFACE MOUNTED RACEWAY.
- 10. ALL EXPOSED CONDUITS, BOXES, ETC. IN ROOMS TO BE PAINTED SHALL BE PAINTED TO MATCH THE SURROUNDING SURFACE. EXPOSED CONDUITS, BOXES, ETC. IN ROOMS WHICH ARE NOT PAINTED MAY BE LEFT UN-PAINTED. EXPOSED CONDUIT, BOXES, ETC. ON THE EXTERIOR OF BUILDINGS SHALL BE PAINTED TO MATCH THE SURROUNDING SURFACE AS CLOSELY AS POSSIBLE. 11. THE CONTRACTOR IS RESPONSIBLE FOR PATCHING, PAINTING, REPAIRING OR REPLACEMENT OF
- ALL WALLS, CEILING OR OTHER BUILDING ELEMENTS WHICH ARE DISTURBED AS PART OF THE DEMOLITION AND/OR INSTALLATION OF ELECTRICAL WORK. 12. PROVIDE ELECTRICAL CONNECTION TO ALL FIRE, SMOKE, AND FIRE / SMOKE DAMPERS INCLUDING POWER AND FIRE ALARM. VERIFY EXACT SIZE AND FINAL LOCATION OF ALL DAMPERS WITH THE MECHANICAL CONTRACTOR. ALL ROOFTOP UNITS RATED AT MORE THAN 2000 CFM WILL BE
- OUTFITTED WITH A DUCT DETECTOR IN THE RETURN DUCT. ALL ROOFTOP UNITS RATED AT MORE THAN 15000 CFM WILL BE OUTFITTED WITH A DUCT DETECTOR IN BOTH THE SUPPLY AND RETURN DUCT AT ROOFTOP LEVEL AND IN THE RETURN DUCT AT EVERY LEVEL THAT IS SERVED. ELECTRICAL CONTRACTOR WILL PROVIDE A REMOTE TEST STATION AND ALL WIRING NECESSARY TO COMPLETE INSTALLATION.
- 13. REFER TO THE MECHANICAL EQUIPMENT SCHEDULE FOR ADDITIONAL REQUIREMENTS ASSOCIATED WITH PLUMBING AND HVAC EQUIPMENT AND OWNER/GENERAL CONTRACTOR FURNISHED EQUIPMENT.

6. THE LIGHTING PACKAGE SHALL BE APPROVED BY BOTH THE ARCHITECT AND ENGINEER AS APPROVED EQUAL BEFORE BID. NO LIGHT FIXTURE SHALL BE ORDERED UNTIL THE LIGHT FIXTURE SUBMITTAL PACKAGE HAS BEEN APPROVED IN WRITING BY THE ARCHITECT, GENERAL CONTRACTOR AND ELECTRICAL ENGINEER. 7. COORDINATE LUMINAIRE MOUNTING REQUIREMENTS PRIOR TO PLACING ORDER.

MOUNTED FIXTURES PRIOR TO ORDERING.

PROVIDED.

### **RESPONSIBLE DIVISION:**

IN PLACE AND WIRED AS FOLLOWS:

UNLESS OTHERWISE INDICATED ALL HEATING, VENTILATING, AIR CONDITIONING, PLUMBING, AND OTHER MECHANICAL EQUIPMENT, MOTORS, AND CONTROLS SHALL BE FURNISHED, SET

ITEM	FURNISHED	SET	POWER WIRED	CONTROL WIRED
EQUIPMENT	23	23	26	
COMBINATION MAGNETIC MOTOR STARTERS, MAGNETIC MOTOR STARTERS, VFD'S AND CONTACTORS	23(1)	26	26(2)	23
FUSED AND UNFUSED DISCONNECT SWITCHES, THERMAL OVERLOAD SWITCHES AND HEATERS, MANUAL MOTOR STARTERS	26	26	26	
MANUAL-OPERATING AND MULTI-SPEED SWITCHES	23	26	26	26
CONTROLS, RELAYS, TRANSFORMERS	23	23	26	23
THERMOSTATS (LOW VOLTAGE) AND TIME SWITCHES	23	23	26	23
THERMOSTATS (LINE VOLTAGE)	23	23	26	26
TEMPERATURE CONTROL PANELS	23	23	26	23
MOTOR AND SOLENOID VALVES, DAMPER MOTORS, PE & EP SWITCHES	23	23(2)		23(2)
PUSH-BUTTON STATIONS AND PILOT LIGHTS	23	23(2)		23(2)
HEATING, COOLING, VENTILATION AND AIR CONDITIONING CONTROLS	23	23	26	23
EXHAUST FAN SWITCHES	23	26	26	23(2)

ROL TRANSFORMER, HOA SWITCH, (1) NO AND (1)NC "OFF" PILOT LIGHTS.

N PLACE AND CONNECT UNDER DIVISION 26. WHERE

OR ATTACHED TO PIPING OR DUCTS AND USING LINE DIVISION 23, CONNECT UNDER DIVISION 26.

EXHAU	JST FAN SWITCHES
1. MO	CRIPT FOOTNOTES: OTOR STARTER TO INCLUDE CONTR JXILIARY CONTACT, AND "ON" AND "O
FA	ITEM IS FOR LINE VOLTAGE, SET IN ACTORY MOUNTED ON EQUIPMENT O DLTAGE FURNISH AND SET UNDER D
ABB	REVIATIONS:
	MOUNTING HEIGHT ABOVE ED FLOOR TO CENTER OF DEVICE
A A D	AMPS ACCESS DOOR
AAV	AIR ADMITTANCE VALVE
ABV	ABOVE
AC	AIR CONDITIONING UNIT
AC	ABOVE COUNTER
	AREA DRAIN (SEE SYMBOLS)
	ABOVE FINISHED CEILING ABOVE FINISHED GRADE
AIC	AMPERE INTERRUPTING
CAPAC	CITY
	ABOVE FINISHED FLOOR
	AIR HANDLING UNIT ALUMINUM
AP	ACCESS PANEL OR DOOR
ATS	AUTOMATIC TRANSFER SWITCH
AV	AUDIO / VIDEO
AVG	AVERAGE
	AMERICAN WIRE GAGE
BAS	BUILDING AUTOMATION SYSTEM
BB BD	BASEBOARD BACK DRAFT DAMPER
BFP	BACK FLOW PREVENTOR
BL	BOILER
BLDG	BUILDING
BLW	BELOW
BOB	BOTTOM OF BEAM
BOD BOP	BOTTOM OF DUCT BOTTOM OF PIPE
BSMT	BASEMENT
BTU	BRITISH THERMAL UNIT
С	CHILLER
CAP	CAPACITY
СВ	CIRCUIT BREAKER
CBV CCT	CIRCUIT BALANCING VALVE CORRELATED COLOR
	ERATURE
СКТ	CIRCUIT
CFH	CUBIC FEET PER HOUR
CFM	
	CHILLED WATER RETURN CHILLED WATER SUPPLY
CI	CAST IRON
CL	CENTER LINE
CLG	CEILING
CMU	CONCRETE MASONRY UNIT
CO COL	
	COLUMN COMPRESSOR
	CONCRETE
COND	CONDENSATE
CONN	CONNECTION
	CONTINUATION
CONTE	R CONTRACTOR
CT	COOLING TOWER
СТ	CURRENT TRANSFORMER
CU	CONDENSING UNIT
CU	COPPER
	CABINET UNIT HEATER
CVB CWR	CONSTANT VOLUME BOX
	CONDENSER WATER RETURN CONDENSER WATER SUPPLY
DB	DRY BULB
DEPT	DEPARTMENT
	DRINKING FOUNTAIN
	DIAMETER
DIAG	DIAGRAM

,	
DIFF	DIFFERENTIAL
	DISCHARGE
	DIVISION
DN DS	DOWN DUCT SILENCER
	DRAWING
X	DIRECT EXPANSION
,	
	EXHAUST AIR GRILLE/REGISTER ENTERING AIR TEMPERATURE
	ELECTRICAL CONTRACTOR
CC	ECCENTRIC
	EXHAUST FAN
EFF	EFFICIENCY ELEVATION
ELEC	ELECTRIC
	ELEVATOR
	EMERGENCY FUNCTION
	ENTERING ELECTRIC METALLIC TUBE
	EQUAL
EQUIP	EQUIPMENT
	EQUIVALENT
	END SWITCH EXTERNAL STATIC PRESSURE
ET	EXPANSION TANK
EWC	ELECTRIC WATER COOLER
	ENTERING WATER RATURE
	EXHAUST
EXPAN	EXPANSION
	EXTERNAL
	DEGREES FAHRENHEIT
	FREE AREA FAN COIL UNIT
	FOOTCANDLE
CV	FLOW CONTROL VALVE
-	
-	FLOOR DRAIN FINISHED
	FULL LOAD AMPS
LEX	FLEXIBLE
	FLOOR
	FLAT ON BOTTOM FLAT ON TOP
	FIRE PROTECTION
P	FIRE PUMP
	FEET PER MINUTE
	FEET PER SECOND FLOW SWITCH
	FIRE/SMOKE DAMPER
т	FEET
	FLEXIBLE CONNECTION
GND GA	GROUND GAUGE
	GALLON
GALV	GALVANIZED
	GROUND ELECTRODE
	GFI GROUND FAULT CIRCUIT
	GENERAL CONTRACTOR GALLONS PER HOUR
	GALLONS PER MINUTE
GRS/LE	GRAINS PER POUND
	WATER
	HOSE BIBB HEAD (SEE SCHEDULES)
	HEAD (SEE SCHEDULES) HEAT PUMP
-D	

HP HORSEPOWER

SUBS	ΤΙΤ	UTI	ONS:

REQUIREMENTS.

HR HOUR

A. SUBSTITUTIONS: SUBSTITUTION OF SPECIFIED EQUIPMENT WILL BE ALLOWED THROUGH A PRIOR APPROVAL PROCESS INITIATED BY THE CONTRACTOR. CONTRACTOR SHALL SUBMIT INTENDED SUBSTITUTION AT LEAST FIVE DAYS PRIOR TO BID FOR APPROVAL FROM ENGINEER. SUBMITTAL SHALL INCLUDE CAPACITIES, DIMENSIONS AND OPERATING INSTRUCTIONS FOR EACH PIECE OF EQUIPMENT. SUBSTITUTION SHALL OCCUR AT NO COST TO THE OWNER. CONTRACTOR IS RESPONSIBLE FOR COORDINATION OF APPROVED SUBSTITUTION AND SHALL INCUR ALL COSTS ASSOCIATED WITH THE SUBSTITUTION INCLUDING STRUCTURAL MODIFICATIONS, SPACE LAYOUT AND REDESIGN COSTS. SEE ALSO DIVISION I GENERAL REQUIREMENTS.

EXAMINATION OF SITE, DRAWINGS, SPECIFICATIONS:

A. EXAMINE CAREFULLY THE SITE AND CONDITIONS OF THE SITE. PROVIDE ALL NECESSARY EQUIPMENT AND LABOR TO INSTALL A COMPLETE WORKING SYSTEM WITHIN THE SITE CONDITIONS.

B. EXAMINE THE DRAWINGS AND SPECIFICATIONS AND 5 DAYS PRIOR TO BIDDING REPORT ANY ERRORS, OMISSIONS, INCONSISTENCIES, AND CONFLICTS TO THE ENGINEER TO BE REMEDIED IN AN ADDENDUM TO THE PROJECT PRIOR TO BID TIME.

C. DRAWINGS ARE DIAGRAMMATIC AND CATALOG NUMBERS GIVEN ARE FOR REFERENCE ONLY. THE CONTRACTOR SHALL BE RESPONSIBLE FOR VERIFYING THE CAPACITY OF THE EQUIPMENT MEETS THE DRAWING REQUIREMENTS AND SHALL NOT DIMENSION FROM THE MECHANICAL, PLUMBING, OR PIPING DRAWINGS.

D. THE LATEST ADOPTED VERSIONS OF THE INTERNATIONAL BUILDING CODES SHALL BE USED AS REQUIRED. THIS WILL ALSO INCLUDE THE LATEST ADOPTED VERSIONS OF THE MECHANICAL, PLUMBING AND ENERGY CONSERVATION CODES. ALL METHODS AND MATERIALS REQUIRED BY THESE CODES SHALL BE REQUIRED BY THESE SPECIFICATIONS UNLESS INDICATED OTHERWISE. OTHER APPLICABLE LOCAL CODES AND ORDINANCES SHALL BE AS REQUIRED AND IT SHALL BE THE CONTRACTOR'S RESPONSIBILITY TO BE KNOWLEDGEABLE OF THESE

E. WHERE INSTALLATION PROCEDURES OR ANY PART THEREOF ARE REQUIRED TO BE IN ACCORDANCE WITH THE RECOMMENDATIONS OF THE MANUFACTURER OF THE MATERIAL BEING INSTALLED, PRINTED COPIES OF THESE RECOMMENDATIONS SHALL BE FURNISHED TO THE ENGINEER PRIOR TO INSTALLATION. INSTALLATION OF THE ITEM WILL NOT BE ALLOWED TO PROCEED UNTIL THE RECOMMENDATIONS ARE RECEIVED. FAILURE TO FURNISH THESE RECOMMENDATIONS CAN BE CAUSE FOR REJECTION OF THE MATERIAL.

PT PRESSURE TRANSMITTER

HR	HOUR
HT	HEIGHT
HTR	HEATER
HWR	HEATING WATER RETURN
HWS	HEATING WATER SUPPLY
нх	HEAT EXCHANGER
HZ	HERTZ
ID	INSIDE DIAMETER
	ISOLATED GROUND
IG	
IN	INCHES
INV	INVERT
JBOX	JUNCTION BOX
К	KELVIN
KW	KILOWATT
KVA	KILO VOLT - AMPS
L	LENGTH
LAT	LEAVING AIR TEMPERATURE
LV	LAVATORY
LB	POUND
LD	LINEAR DIFFUSER
LF	LINEAR FEET
LIN	LINEAR
LIQ	LIQUID
LM	LUMEN
LRA	LOCKED ROTOR AMPS
LV	LOUVER
LVG	LEAVING
LWT	LEAVING WATER TEMPERATURE
MBH	THOUSANDS OF BTU PER HOUR
MC	MECHANICAL CONTRACTOR
MCA	MINIMUM CIRCUIT AMPACITY
MCB	MAIN CIRCUIT BREAKER
MD	MOTORIZED DAMPER
MDP	MAIN DISTRIBUTION PANEL
MED	MEDIUM
MFR	MANUFACTURER
MFR	
MIN	MINIMUM
MIN MISC	MINIMUM MISCELLANEOUS
MIN MISC MLO	MINIMUM MISCELLANEOUS MAIN LUG ONLY
MIN MISC MLO MOCF	MINIMUM MISCELLANEOUS
MIN MISC MLO MOCF PROT	MINIMUM MISCELLANEOUS MAIN LUG ONLY MAXIMUM OVERCURRENT
MIN MISC MLO MOCF PROT	MINIMUM MISCELLANEOUS MAIN LUG ONLY MAXIMUM OVERCURRENT ECTION MOUNTED
MIN MISC MLO MOCF PROT MTD	MINIMUM MISCELLANEOUS MAIN LUG ONLY MAXIMUM OVERCURRENT ECTION MOUNTED MAKE-UP AIR UNIT
MIN MISC MLO MOCF PROT MTD MUA N	MINIMUM MISCELLANEOUS MAIN LUG ONLY MAXIMUM OVERCURRENT ECTION MOUNTED MAKE-UP AIR UNIT NEUTRAL
MIN MISC MLO MOCF PROT MTD MUA N NC	MINIMUM MISCELLANEOUS MAIN LUG ONLY MAXIMUM OVERCURRENT ECTION MOUNTED MAKE-UP AIR UNIT NEUTRAL NORMALLY CLOSED
MIN MISC MLO MOCF PROT MTD MUA N NC NEG	MINIMUM MISCELLANEOUS MAIN LUG ONLY MAXIMUM OVERCURRENT ECTION MOUNTED MAKE-UP AIR UNIT NEUTRAL NORMALLY CLOSED NEGATIVE
MIN MISC MLO MOCF PROT MTD MUA N NC NEG NIC	MINIMUM MISCELLANEOUS MAIN LUG ONLY MAXIMUM OVERCURRENT ECTION MOUNTED MAKE-UP AIR UNIT NEUTRAL NORMALLY CLOSED NEGATIVE NOT IN CONTRACT
MIN MISC MLO MOCF PROT MTD MUA N NC NEG NIC NL	MINIMUM MISCELLANEOUS MAIN LUG ONLY MAXIMUM OVERCURRENT ECTION MOUNTED MAKE-UP AIR UNIT NEUTRAL NORMALLY CLOSED NEGATIVE
MIN MISC MLO MOCF PROT MTD MUA N NC NEG NIC NL NOT S	MINIMUM MISCELLANEOUS MAIN LUG ONLY MAXIMUM OVERCURRENT ECTION MOUNTED MAKE-UP AIR UNIT NEUTRAL NORMALLY CLOSED NEGATIVE NOT IN CONTRACT NIGHT / SECURITY LIGHT - DO
MIN MISC MLO MOCF PROT MTD MUA NC NC NEG NIC NIC NO	MINIMUM MISCELLANEOUS MAIN LUG ONLY MAXIMUM OVERCURRENT ECTION MOUNTED MAKE-UP AIR UNIT NEUTRAL NORMALLY CLOSED NEGATIVE NOT IN CONTRACT NIGHT / SECURITY LIGHT - DO SWITCH NORMALLY OPEN
MIN MISC MLO MOCF PROT MTD MUA N NC NEG NIC NIC NO NOM	MINIMUM MISCELLANEOUS MAIN LUG ONLY MAXIMUM OVERCURRENT ECTION MOUNTED MAKE-UP AIR UNIT NEUTRAL NORMALLY CLOSED NEGATIVE NOT IN CONTRACT NIGHT / SECURITY LIGHT - DO SWITCH NORMALLY OPEN NORMALLY OPEN
MIN MISC MLO MOCF PROT MTD MUA N NC NEG NIC NOT S NO NOM NTS	MINIMUM MISCELLANEOUS MAIN LUG ONLY MAXIMUM OVERCURRENT ECTION MOUNTED MAKE-UP AIR UNIT NEUTRAL NORMALLY CLOSED NEGATIVE NOT IN CONTRACT NIGHT / SECURITY LIGHT - DO WITCH NORMALLY OPEN NOMINAL NOT TO SCALE
Min Misc Mlo Mocf Prot Mtd Mua N N N N N N N N N N N N N N O A	MINIMUM MISCELLANEOUS MAIN LUG ONLY MAXIMUM OVERCURRENT ECTION MOUNTED MAKE-UP AIR UNIT NEUTRAL NORMALLY CLOSED NEGATIVE NOT IN CONTRACT NIGHT / SECURITY LIGHT - DO WITCH NORMALLY OPEN NOMINAL NOT TO SCALE OUTSIDE AIR
MIN MISC MLO MOCF PROT MTD MUA N NC NEG NIC NL NOT S NO NOM NTS OA OBD	MINIMUM MISCELLANEOUS MAIN LUG ONLY MAXIMUM OVERCURRENT ECTION MOUNTED MAKE-UP AIR UNIT NEUTRAL NORMALLY CLOSED NEGATIVE NOT IN CONTRACT NIGHT / SECURITY LIGHT - DO WITCH NORMALLY OPEN NOMINAL NOT TO SCALE OUTSIDE AIR OPPOSED BLADE DAMPER
MIN MISC MLO MOCF PROT MUA N NC NEG NIC NIC NO NOT S NO NOM NTS OA OBD OC	MINIMUM MISCELLANEOUS MAIN LUG ONLY MAXIMUM OVERCURRENT ECTION MOUNTED MOUNTED MAKE-UP AIR UNIT NEUTRAL NORMALLY CLOSED NEGATIVE NOT IN CONTRACT NIGHT / SECURITY LIGHT - DO WITCH NORMALLY OPEN NOMINAL NOT TO SCALE OUTSIDE AIR OPPOSED BLADE DAMPER ON CENTER
MIN MISC MLO MOCF PROT MUA N NC NEG NIC NIC NO NOT S NO NOM NTS OA OBD OC	MINIMUM MISCELLANEOUS MAIN LUG ONLY MAXIMUM OVERCURRENT ECTION MOUNTED MAKE-UP AIR UNIT NEUTRAL NORMALLY CLOSED NEGATIVE NOT IN CONTRACT NIGHT / SECURITY LIGHT - DO WITCH NORMALLY OPEN NOMINAL NOT TO SCALE OUTSIDE AIR OPPOSED BLADE DAMPER
MIN MISC MLO MOCF PROT MUA N NC NEG NIC NIC NO NOT S NO NOM NTS OA OBD OC	MINIMUM MISCELLANEOUS MAIN LUG ONLY MAXIMUM OVERCURRENT ECTION MOUNTED MOUNTED MAKE-UP AIR UNIT NEUTRAL NORMALLY CLOSED NEGATIVE NOT IN CONTRACT NIGHT / SECURITY LIGHT - DO WITCH NORMALLY OPEN NOMINAL NOT TO SCALE OUTSIDE AIR OPPOSED BLADE DAMPER ON CENTER
MIN MISC MLO MOCF PROT MTD MUA N NC NEG NIC NIC NO NO NO NO NO NO NO NO OA OBD OC OCC	MINIMUM MISCELLANEOUS MAIN LUG ONLY MAXIMUM OVERCURRENT ECTION MOUNTED MAKE-UP AIR UNIT NEUTRAL NORMALLY CLOSED NEGATIVE NOT IN CONTRACT NIGHT / SECURITY LIGHT - DO WITCH NORMALLY OPEN NOMINAL NOT TO SCALE OUTSIDE AIR OPPOSED BLADE DAMPER ON CENTER OCCUPIED
MIN MISC MLO MOCF PROT MTD MUA N NC NEG NIC NOT S NO NOT S NO NOT S OA OBD OC OCC OCP	MINIMUM MISCELLANEOUS MAIN LUG ONLY MAXIMUM OVERCURRENT ECTION MOUNTED MAKE-UP AIR UNIT NEUTRAL NORMALLY CLOSED NEGATIVE NOT IN CONTRACT NIGHT / SECURITY LIGHT - DO WITCH NORMALLY OPEN NOMINAL NOT TO SCALE OUTSIDE AIR OPPOSED BLADE DAMPER ON CENTER OCCUPIED OVER CURRENT PROTECTION
MIN MISC MLO MOCF PROT MUA N NC NEG NIC NIC NIC NIC NO NOM NTS OA OBD OC OCC OCP	MINIMUM MISCELLANEOUS MAIN LUG ONLY MAXIMUM OVERCURRENT ECTION MOUNTED MOUNTED MAKE-UP AIR UNIT NEUTRAL NORMALLY CLOSED NEGATIVE NOT IN CONTRACT NIGHT / SECURITY LIGHT - DO WITCH NORMALLY OPEN NOMINAL NOT TO SCALE OUTSIDE AIR OPPOSED BLADE DAMPER ON CENTER OCCUPIED OVER CURRENT PROTECTION OUTSIDE DIAMETER
MIN MISC MLO MOCF PROT MUA N NC NEG NIC NIC NIC NO NOM NTS OA OBD OC OCC OCC OCC OCP OD	MINIMUM MISCELLANEOUS MAIN LUG ONLY MAXIMUM OVERCURRENT ECTION MOUNTED MAKE-UP AIR UNIT NEUTRAL NORMALLY CLOSED NEGATIVE NOT IN CONTRACT NIGHT / SECURITY LIGHT - DO WITCH NORMALLY OPEN NOMINAL NOT TO SCALE OUTSIDE AIR OPPOSED BLADE DAMPER ON CENTER OCCUPIED OVER CURRENT PROTECTION OUTSIDE DIAMETER OVERLOAD
MIN MISC MLO MOCF PROT MUA N NC NEG NIC NC NC NC NC NC NC NC NC NC OC OC OC OC OC OC OC OC OC OC OC OC OC	MINIMUM MISCELLANEOUS MAIN LUG ONLY MAXIMUM OVERCURRENT ECTION MOUNTED MAKE-UP AIR UNIT NEUTRAL NORMALLY CLOSED NEGATIVE NOT IN CONTRACT NIGHT / SECURITY LIGHT - DO WITCH NORMALLY OPEN NOMINAL NOT TO SCALE OUTSIDE AIR OPPOSED BLADE DAMPER ON CENTER OCCUPIED OVER CURRENT PROTECTION OUTSIDE DIAMETER OVERLOAD OVERFLOW ROOF DRAIN
MIN MISC MLO MOCF PROT MUA N NC NEG NIC NIC NIC NO NOM NTS OA OBD OC OCC OCC OCC OCC OCC OCC OCC OCC OCC	MINIMUM MISCELLANEOUS MAIN LUG ONLY MAXIMUM OVERCURRENT ECTION MOUNTED MAKE-UP AIR UNIT NEUTRAL NORMALLY CLOSED NEGATIVE NOT IN CONTRACT NIGHT / SECURITY LIGHT - DO WITCH NORMALLY OPEN NOMINAL NOT TO SCALE OUTSIDE AIR OPPOSED BLADE DAMPER ON CENTER OCCUPIED OVER CURRENT PROTECTION OUTSIDE DIAMETER OVERLOAD OVERFLOW ROOF DRAIN OUNCE
MIN MISC MLO MOCF PROT MTD MUA N NC NEG NIC NIC NIC NIC NO NOM NTS OA OBD OC OCC OCC OCC OCC OCC OCC OCC OCC OCC	MINIMUM MISCELLANEOUS MAIN LUG ONLY MAXIMUM OVERCURRENT ECTION MOUNTED MAKE-UP AIR UNIT NEUTRAL NORMALLY CLOSED NEGATIVE NOT IN CONTRACT NIGHT / SECURITY LIGHT - DO WITCH NORMALLY OPEN NOMINAL NOT TO SCALE OUTSIDE AIR OPPOSED BLADE DAMPER ON CENTER OCCUPIED OVER CURRENT PROTECTION OUTSIDE DIAMETER OVERLOAD OVERFLOW ROOF DRAIN OUNCE PARALLEL BLADE DAMPER
MIN MISC MLO MOCF PROT MUA N NC NEG NIC NIC NIC NO NOM NTS OA OBD OC OCC OCC OCC OCC OCC OCC OCC OCC OCC	MINIMUM MISCELLANEOUS MAIN LUG ONLY MAXIMUM OVERCURRENT ECTION MOUNTED MAKE-UP AIR UNIT NEUTRAL NORMALLY CLOSED NEGATIVE NOT IN CONTRACT NIGHT / SECURITY LIGHT - DO WITCH NORMALLY OPEN NOMINAL NOT TO SCALE OUTSIDE AIR OPPOSED BLADE DAMPER ON CENTER OCCUPIED OVER CURRENT PROTECTION OUTSIDE DIAMETER OVERLOAD OVERFLOW ROOF DRAIN OUNCE PARALLEL BLADE DAMPER PRESSURE DROP
MIN MISC MLO MOCF PROT MUA N NC NEG NIC NIC NO NO NO NO NO NO NO NO NO NO NO OC OC OC OC OC OC OC OC OC OC OC OC OC	MINIMUM MISCELLANEOUS MAIN LUG ONLY MAXIMUM OVERCURRENT ECTION MOUNTED MAKE-UP AIR UNIT NEUTRAL NORMALLY CLOSED NEGATIVE NOT IN CONTRACT NIGHT / SECURITY LIGHT - DO WITCH NORMALLY OPEN NOMINAL NOT TO SCALE OUTSIDE AIR OPPOSED BLADE DAMPER ON CENTER OCCUPIED OVER CURRENT PROTECTION OUTSIDE DIAMETER OVERLOAD OVERFLOW ROOF DRAIN OUNCE PARALLEL BLADE DAMPER PRESSURE DROP PHASE
MIN MISC MLO MOCF PROT MUA N NC NEG NIC NIC NIC NO NOM NTS OA OBD OC OCC OCC OCC OCC OCC OCC OCC OCC OCC	MINIMUM MISCELLANEOUS MAIN LUG ONLY MAXIMUM OVERCURRENT ECTION MOUNTED MAKE-UP AIR UNIT NEUTRAL NORMALLY CLOSED NEGATIVE NOT IN CONTRACT NIGHT / SECURITY LIGHT - DO WITCH NORMALLY OPEN NOMINAL NOT TO SCALE OUTSIDE AIR OPPOSED BLADE DAMPER ON CENTER OCCUPIED OVER CURRENT PROTECTION OUTSIDE DIAMETER OVERLOAD OVERFLOW ROOF DRAIN OUNCE PARALLEL BLADE DAMPER PRESSURE DROP PHASE POSITIVE PRESSURE POSITIVE PRESSURE
MIN MISC MLO MOCF PROT MUA N NC NEG NIC NIC NO NOM NTS OA OBD OC OCC OCC OCC OCC OCC OCC OCC OCC OCC	MINIMUM MISCELLANEOUS MAIN LUG ONLY MAXIMUM OVERCURRENT ECTION MOUNTED MAKE-UP AIR UNIT NEUTRAL NORMALLY CLOSED NEGATIVE NORMALLY CLOSED NEGATIVE NORMALLY OPEN NOMINAL NOT TO SCALE OUTSIDE AIR OPPOSED BLADE DAMPER ON CENTER OCCUPIED OVER CURRENT PROTECTION OUTSIDE DIAMETER OVERLOAD OVERFLOW ROOF DRAIN OUNCE PARALLEL BLADE DAMPER PRESSURE DROP PHASE POSITIVE PRESSURE POINT OF SALES PRESSURE REDUCING VALVE
MIN MISC MLO MOCF PROT MUA N NC NC NC NC NC NC NC NC NO NOM NTS OA OBD OC OCC OCC OCC OCC OCC OCC OCC OCC OCC	MINIMUM MISCELLANEOUS MAIN LUG ONLY MAXIMUM OVERCURRENT ECTION MOUNTED MAKE-UP AIR UNIT NEUTRAL NORMALLY CLOSED NEGATIVE NOT IN CONTRACT NIGHT / SECURITY LIGHT - DO WITCH NORMALLY OPEN NOMINAL NOT TO SCALE OUTSIDE AIR OPPOSED BLADE DAMPER ON CENTER OCCUPIED OVER CURRENT PROTECTION OUTSIDE DIAMETER OVERLOAD OVERFLOW ROOF DRAIN OUNCE PARALLEL BLADE DAMPER PRESSURE DROP PHASE POSITIVE PRESSURE POSITIVE PRESSURE


	PRESSURE TRANSMITTER
	PACKAGED TERMINAL AIR
CONDI	TIONER
PV	PLUG VALVE
PVC	POLYVINYL CHLORIDE
QTY	QUANTITY
RA	RETURN AIR GRILLE / REGISTER
RCP	REFLECTED CEILING PLAN
	ROOF DRAIN
	RELIEF
REQD	REQUIRED
RF	RETURN FAN
RH	RELATIVE HUMIDITY
RHC	REHEAT COIL
RLA	RATED LOAD AMPS
RM	ROOM
RPM	REVOLUTIONS PER MINUTE
SA	SUPPLY AIR GRILLE / REGISTER
•	
SC	SHORT CIRCUIT
SCA	SHORT CIRCUIT AVAILABLE
SCCR	
RATIN	
SCH	SCHEDULE
SD	SMOKE DAMPER
SEF	SMOKE EXHAUST FAN
SF	SUPPLY FAN
SH	SENSIBLE HEAT
SH	SHOWER
SP	STATIC PRESSURE
SPD	SURGE PROTECTION DEVICE
SPEC	SPECIFICATION
SQ	SQUARE
SS	STAINLESS STEEL
SS	SAFETY SHOWER
STD	STANDARD
STL	STEEL
SYS	SYSTEM
TEMP	TEMPERATURE
TR	TRANSFER GRILLE / REGISTER
TR	TAMPER RESISTANT
TT	
	TELECOMMUNICATIONS NAL BACKBOARD
TYP	TYPICAL
ТΧ	TRANSFORMER
UC	UNDERCUT DOOR
UH	UNIT HEATER
UNO	UNLESS NOTED OTHERWISE
UNOCO	C UNOCCUPIED
UR	URINAL
V	VOLTS
V VA	VOLTS VOLT AMPERE
-	
VA VA	VOLT AMPERE VALVE
VA VA VAV	VOLT AMPERE VALVE VARIABLE AIR VOLUME UNIT
VA VA VAV VFD	VOLT AMPERE VALVE VARIABLE AIR VOLUME UNIT VARIABLE FREQUENCY DRIVE
VA VA VAV	VOLT AMPERE VALVE VARIABLE AIR VOLUME UNIT
VA VA VAV VFD VRF	VOLT AMPERE VALVE VARIABLE AIR VOLUME UNIT VARIABLE FREQUENCY DRIVE
VA VA VAV VFD VRF	VOLT AMPERE VALVE VARIABLE AIR VOLUME UNIT VARIABLE FREQUENCY DRIVE VARIABLE REFRIGERANT FLOW
VA VA VAV VFD VRF VOLT	VOLT AMPERE VALVE VARIABLE AIR VOLUME UNIT VARIABLE FREQUENCY DRIVE VARIABLE REFRIGERANT FLOW VOLTAGE
VA VA VAV VFD VRF VOLT VTR	VOLT AMPERE VALVE VARIABLE AIR VOLUME UNIT VARIABLE FREQUENCY DRIVE VARIABLE REFRIGERANT FLOW VOLTAGE VENT THROUGH ROOF
VA VA VAV VFD VRF VOLT VOLT VTR W	VOLT AMPERE VALVE VARIABLE AIR VOLUME UNIT VARIABLE FREQUENCY DRIVE VARIABLE REFRIGERANT FLOW VOLTAGE VENT THROUGH ROOF WIDTH
VA VA VAV VFD VRF VOLT VTR W W W	VOLT AMPERE VALVE VARIABLE AIR VOLUME UNIT VARIABLE FREQUENCY DRIVE VARIABLE REFRIGERANT FLOW VOLTAGE VENT THROUGH ROOF WIDTH WATTS
VA VA VAV VFD VRF VOLT VTR W W W W/ W/O	VOLT AMPERE VALVE VARIABLE AIR VOLUME UNIT VARIABLE FREQUENCY DRIVE VARIABLE REFRIGERANT FLOW VOLTAGE VENT THROUGH ROOF WIDTH WATTS WITH WITHOUT
VA VAV VFD VRF VOLT VTR W W W W/ W/ W/O WB	VOLT AMPERE VALVE VARIABLE AIR VOLUME UNIT VARIABLE FREQUENCY DRIVE VARIABLE REFRIGERANT FLOW VOLTAGE VENT THROUGH ROOF WIDTH WATTS WITH WITHOUT WET BULB
VA VAV VFD VRF VOLT VTR W W W W W/O W/O WB	VOLT AMPERE VALVE VARIABLE AIR VOLUME UNIT VARIABLE FREQUENCY DRIVE VARIABLE REFRIGERANT FLOW VOLTAGE VENT THROUGH ROOF WIDTH WATTS WITH WITHOUT WET BULB WATER COLUMN
VA VAV VFD VRF VOLT VTR W W W W/O W/O WB WC	VOLT AMPERE VALVE VARIABLE AIR VOLUME UNIT VARIABLE FREQUENCY DRIVE VARIABLE REFRIGERANT FLOW VOLTAGE VENT THROUGH ROOF WIDTH WATTS WITH WITHOUT WET BULB WATER COLUMN WATER CLOSET
VA VA VAV VFD VRF VOLT VTR W W W W/ W/O W/O W/O W/O W/O W/O W/O W/	VOLT AMPERE VALVE VARIABLE AIR VOLUME UNIT VARIABLE FREQUENCY DRIVE VARIABLE REFRIGERANT FLOW VOLTAGE VENT THROUGH ROOF WIDTH WATTS WITH WITHOUT WET BULB WATER COLUMN WATER CLOSET WATER GAUGE
VA VAV VFD VRF VOLT VTR W W W W/ W/O W/O W/O WB WC WC WC WC WC WC WC	VOLT AMPERE VALVE VARIABLE AIR VOLUME UNIT VARIABLE FREQUENCY DRIVE VARIABLE REFRIGERANT FLOW VOLTAGE VENT THROUGH ROOF WIDTH WATTS WITH WITHOUT WET BULB WATER COLUMN WATER CLOSET WATER GAUGE WEATHERPROOF
VA VAV VFD VRF VOLT VTR W W W W/ W/O W/O W/O WB WC WC WC WC WC WC WC	VOLT AMPERE VALVE VARIABLE AIR VOLUME UNIT VARIABLE FREQUENCY DRIVE VARIABLE REFRIGERANT FLOW VOLTAGE VENT THROUGH ROOF WIDTH WATTS WITH WITHOUT WET BULB WATER COLUMN WATER CLOSET WATER GAUGE
VA VA VAV VFD VRF VOLT VTR W W W W/ W/O W/O W/O W/O W/O W/O W/O W/	VOLT AMPERE VALVE VARIABLE AIR VOLUME UNIT VARIABLE FREQUENCY DRIVE VARIABLE REFRIGERANT FLOW VOLTAGE VENT THROUGH ROOF WIDTH WATTS WITH WITHOUT WET BULB WATER COLUMN WATER CLOSET WATER GAUGE WEATHERPROOF

XFMR TRANSFORMER


NOT LIMITED TO THE HANICAL DRAWINGS ECTED CEILING PLANS ID SHALL NOT BE D WILL BE REFLECTED CEILING 4. VERIFY LUMINAIRE MOUNTING REQUIREMENTS AND OVERALL HEIGHT OF ALL PENDANT

5. ALL LIGHT FIXTURES NEED TO BE COMPATIBLE WITH THE SWITCHES AND CONTROLS BEING

DO NOT REPRODUCE THESE DRAWINGS AND SPECIFICATIONS WITHOUT THE EXPRESSED WRITTEN PERMISSION OF THE DESIGNER. THE DRAWINGS AND SPECIFICATIONS ARE INSTRUMENTS OF THE SERVICE AND SHALL REMAIN THE PROPERTY OF THE DESIGNER WHETHER THE PROJECT FOR WHICH THEY ARE MADE IS EXECUTED OR NOT. THESE DRAWINGS AND SPECIFICATIONS SHALL NOT BE USED BY ANYONE ON ANY OTHER PROJECTS FOR ADDITIONS TO THIS PROJECT BY OTHERS EXCEPT BY THE EXPRESSED WRITTEN PERMISSION OF THE DESIGNER. C on, CO 81 241-8709 sulting Engine & Electrical Engine Jun (97 n b e 386 Grar Phor S S  $\bigcirc$ R ()Ŷ  $\bigcirc$ Ζ  $\mathsf{O}$ () 11 S ŝ 0  $\infty$ REVIEWED FOR CODE COMPLIANCE 12/07/2022 DATE: ISSUED FOR: 06/17/2022 PERMIT 09/07/2022 PERMIT CORRECTIONS 60539 06/17/2022 DATE: JOB NO: 21-276 DRAWN BY: BCE BCE CHECKED BY: SCALE: AS SHOWN SHEET NUMBER: E0-1 September 08, 2022 - 9:40:26am

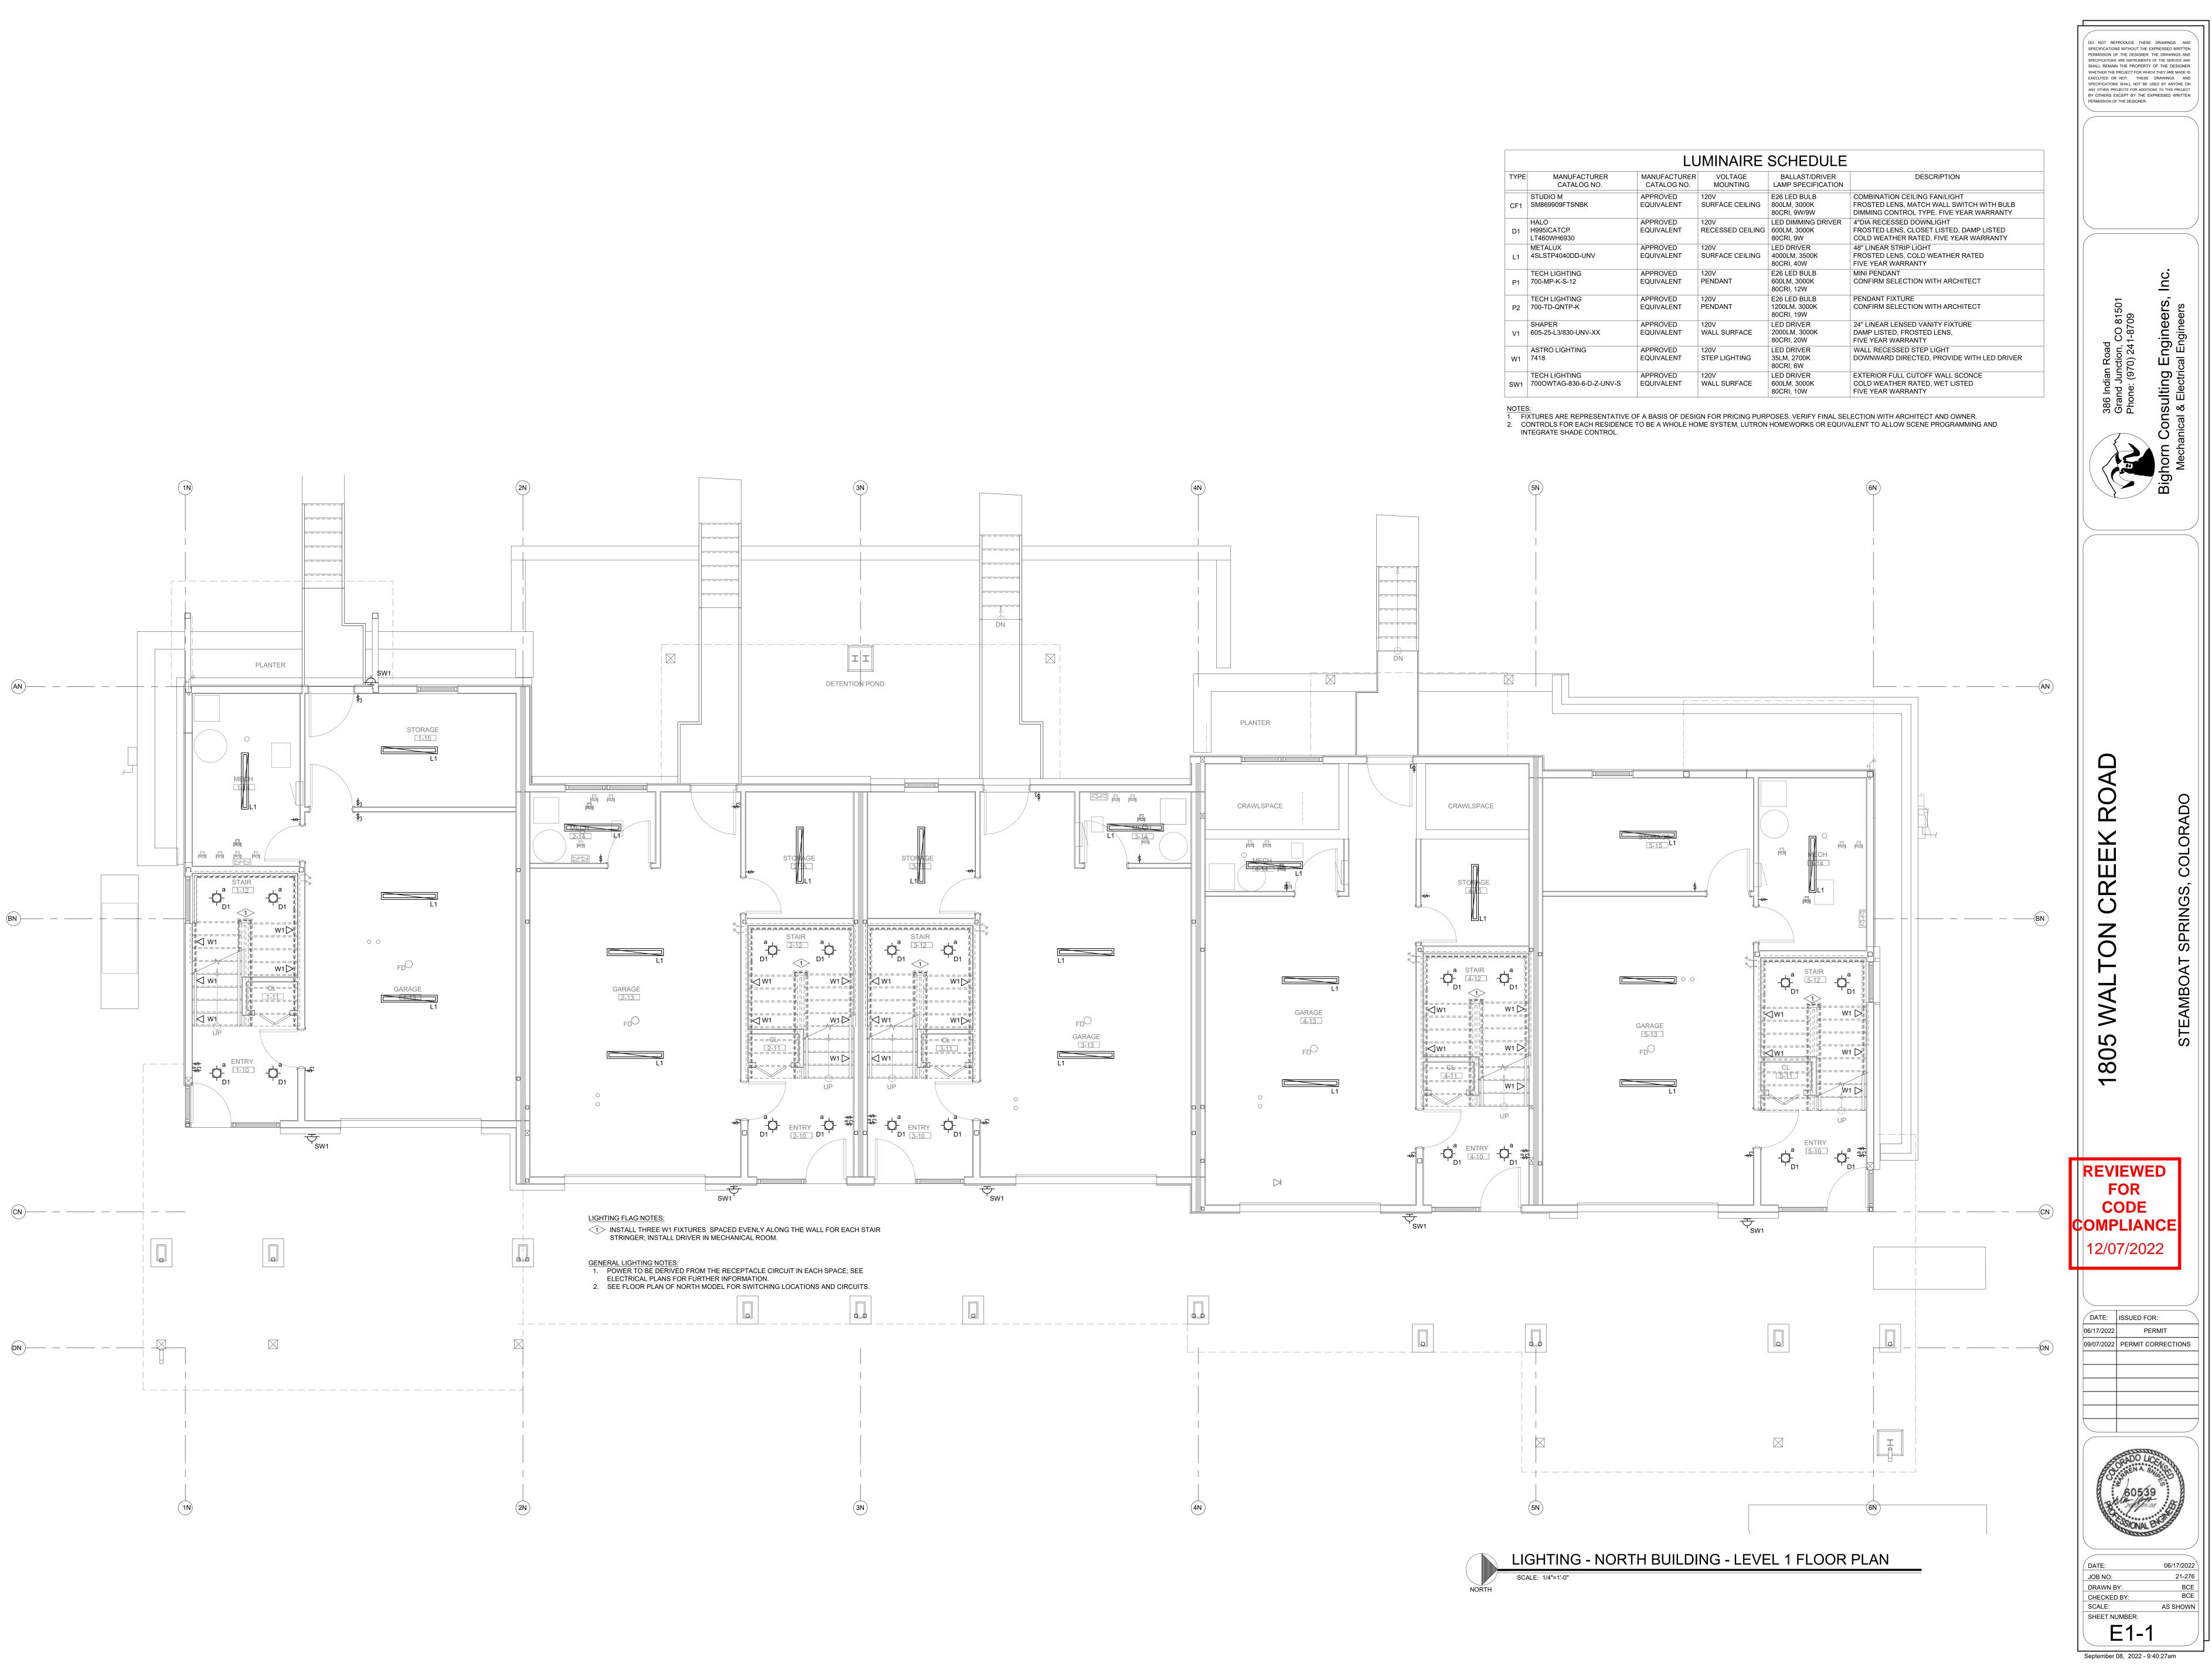

	LUMINAIRE SCHEDULE									
TYPE	MANUFACTURER CATALOG NO.	MANUFACTURER CATALOG NO.	VOLTAGE MOUNTING	BALLAST/DRIVER LAMP SPECIFICATION	DESCRIPTION					
CF1	STUDIO M SM869909FTSNBK	APPROVED EQUIVALENT	120V SURFACE CEILING	E26 LED BULB 800LM, 3000K 80CRI, 9W/9W	COMBINATION CEILING FAN/LIGHT FROSTED LENS, MATCH WALL SWITCH WI DIMMING CONTROL TYPE. FIVE YEAR WAR					
D1	HALO H995ICATCP LT460WH6930	APPROVED EQUIVALENT	120V RECESSED CEILING	LED DIMMING DRIVER 600LM, 3000K 80CRI, 9W	4"DIA RECESSED DOWNLIGHT FROSTED LENS, CLOSET LISTED, DAMP LIS COLD WEATHER RATED, FIVE YEAR WARR					
L1	METALUX 4SLSTP4040DD-UNV	APPROVED EQUIVALENT	120V SURFACE CEILING	LED DRIVER 4000LM, 3500K 80CRI, 40W	48" LINEAR STRIP LIGHT FROSTED LENS, COLD WEATHER RATED FIVE YEAR WARRANTY					
P1	TECH LIGHTING 700-MP-K-S-12	APPROVED EQUIVALENT	120V PENDANT	E26 LED BULB 600LM, 3000K 80CRI, 12W	MINI PENDANT CONFIRM SELECTION WITH ARCHITECT					
P2	TECH LIGHTING 700-TD-QNTP-K	APPROVED EQUIVALENT	120V PENDANT	E26 LED BULB 1200LM, 3000K 80CRI, 19W	PENDANT FIXTURE CONFIRM SELECTION WITH ARCHITECT					
V1	SHAPER 605-25-L3/830-UNV-XX	APPROVED EQUIVALENT	120V WALL SURFACE	LED DRIVER 2000LM, 3000K 80CRI, 20W	24" LINEAR LENSED VANITY FIXTURE DAMP LISTED, FROSTED LENS, FIVE YEAR WARRANTY					
W1	ASTRO LIGHTING 7418	APPROVED EQUIVALENT	120V STEP LIGHTING	LED DRIVER 35LM, 2700K 80CRI, 6W	WALL RECESSED STEP LIGHT DOWNWARD DIRECTED, PROVIDE WITH LE					
SW1	TECH LIGHTING 7000WTAG-830-6-D-Z-UNV-S	APPROVED EQUIVALENT	120V WALL SURFACE	LED DRIVER 600LM, 3000K 80CRI, 10W	EXTERIOR FULL CUTOFF WALL SCONCE COLD WEATHER RATED, WET LISTED FIVE YEAR WARRANTY					

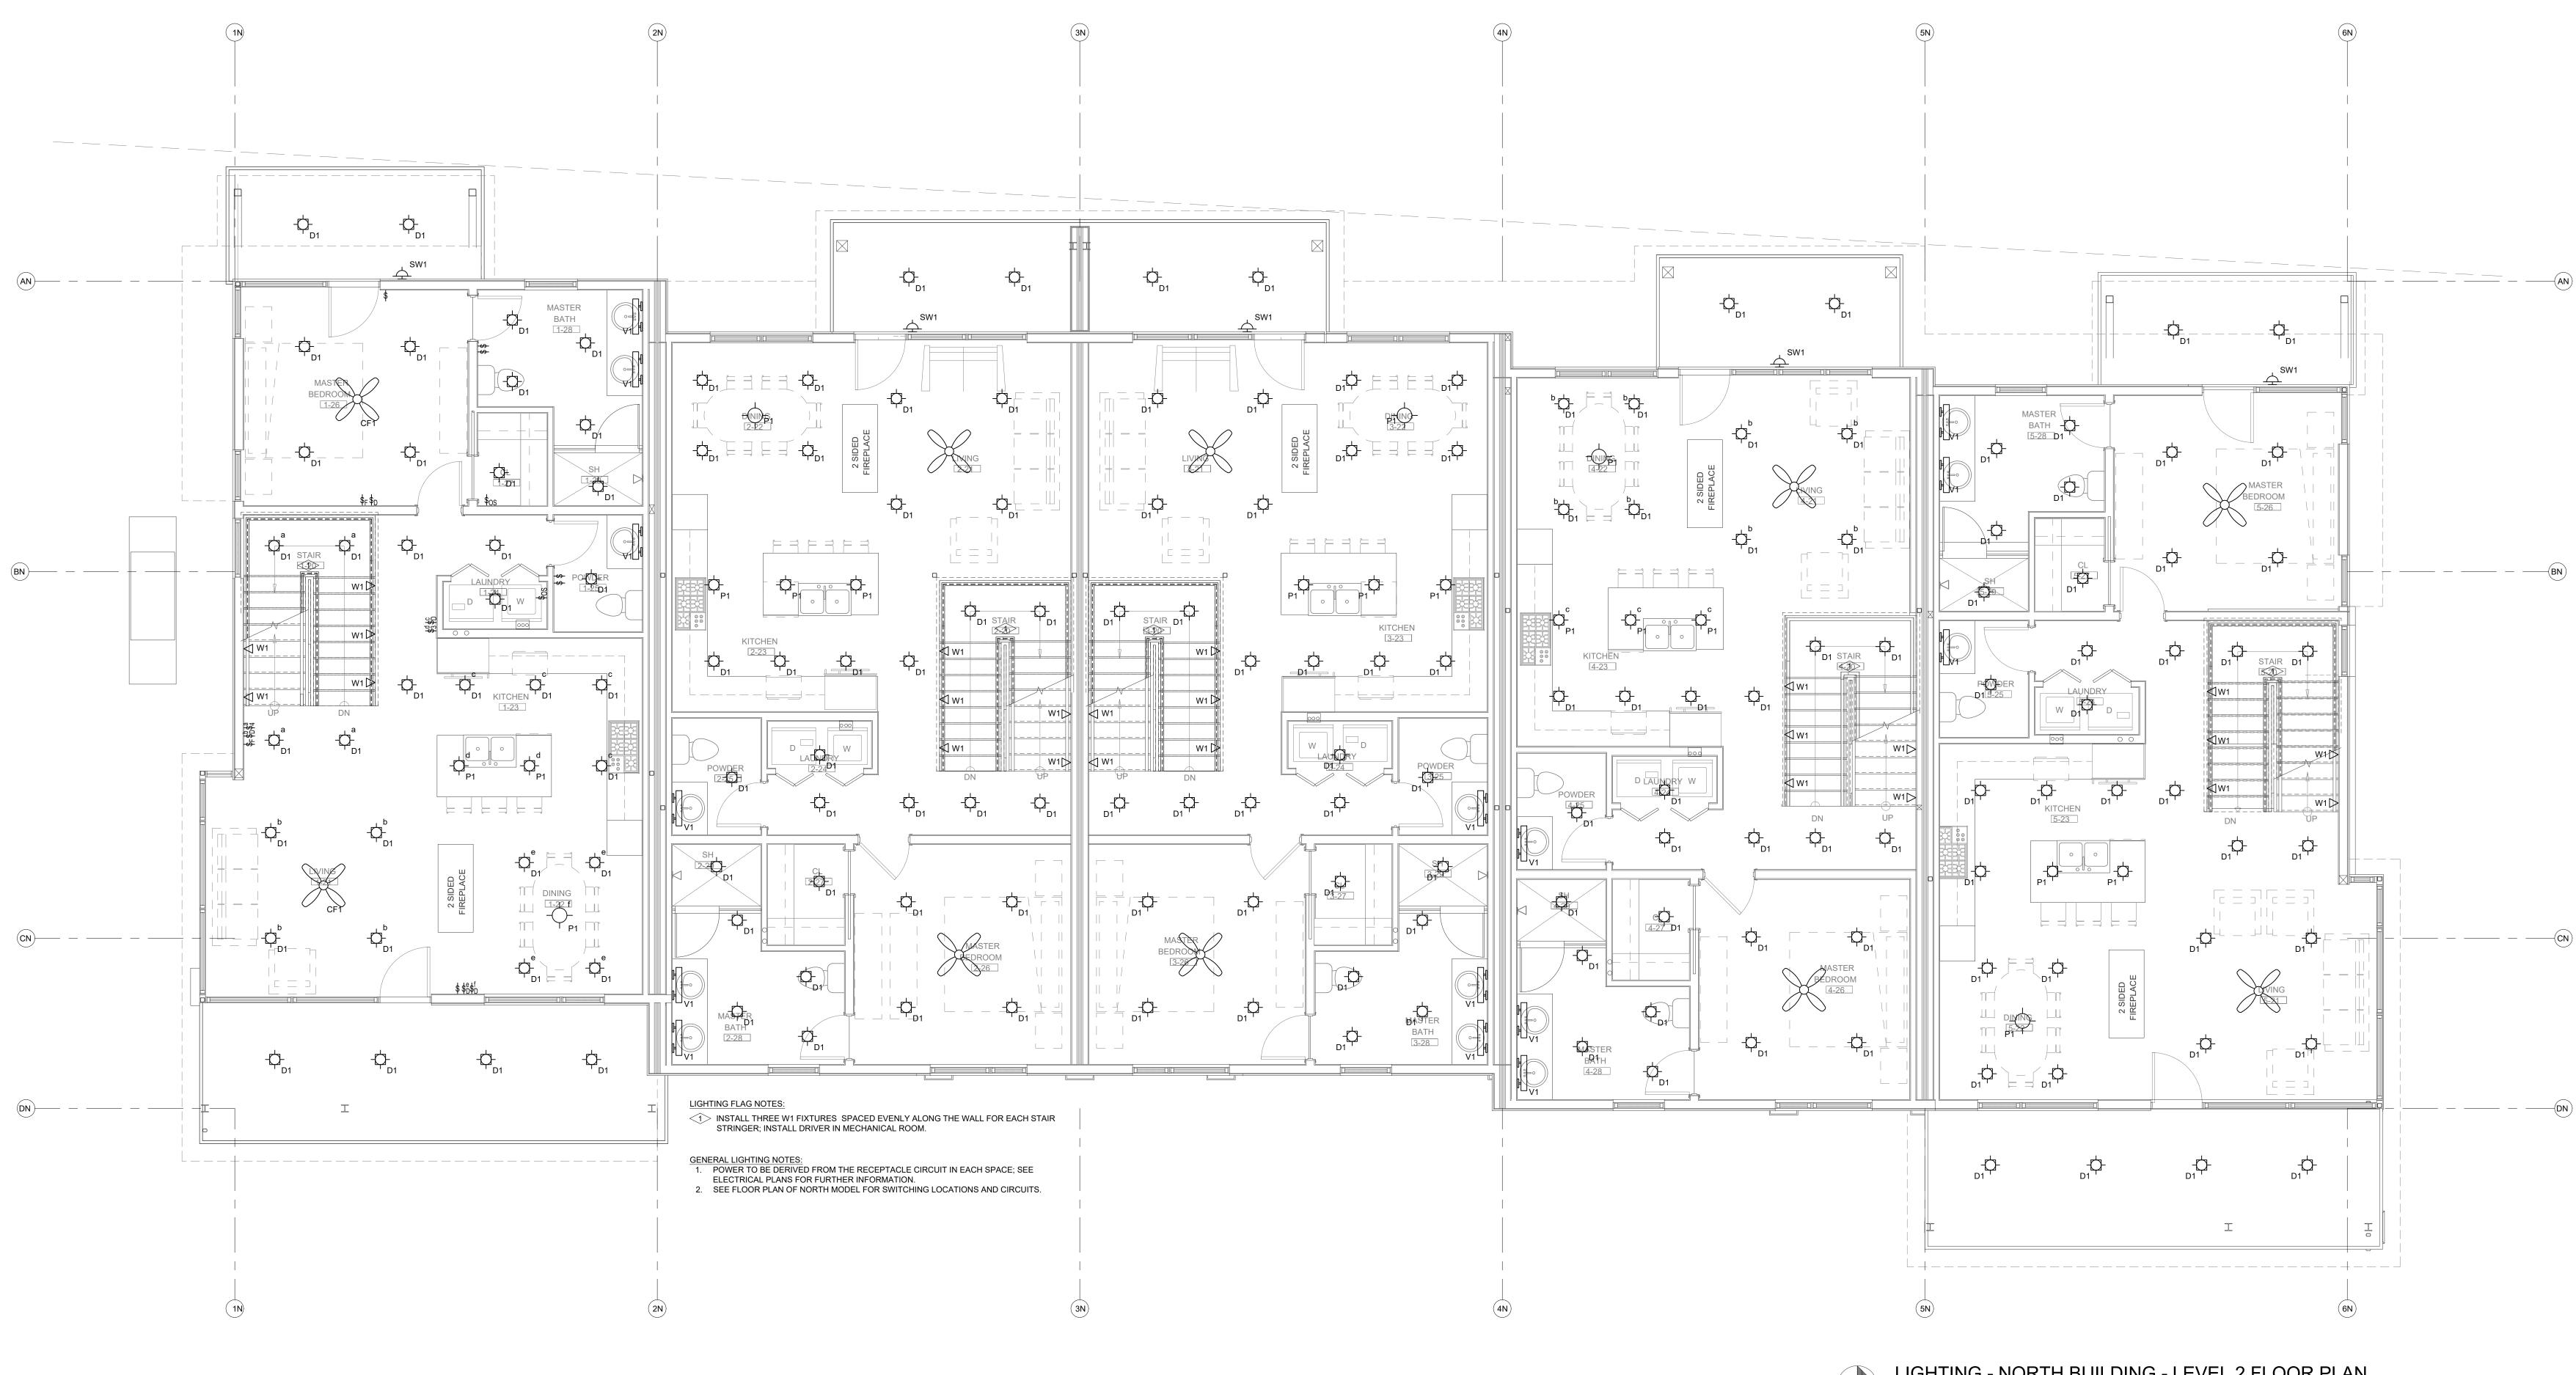


## LIGHTING - NORTH BUILDING - LEVEL 2 FLOOR PLAN SCALE: 1/4"=1'-0"

DO NOT REPRODUCE THESE DRAWINGS AND DO NOT REPRODUCE THESE DRAWINGS AND SPECIFICATIONS WITHOUT THE EXPRESSED WRITTEN PERMISSION OF THE DESIGNER. THE DRAWINGS AND SPECIFICATIONS ARE INSTRUMENTS OF THE SERVICE AND SHALL REMAIN THE PROPERTY OF THE DESIGNER WHETHER THE PROJECT FOR WHICH THEY ARE MADE IS EXECUTED OR NOT. THESE DRAWINGS AND SPECIFICATIONS SHALL NOT BE USED BY ANYONE ON ANY OTHER PROJECTS FOR ADDITIONS TO THIS PROJECT BY OTHERS EXCEPT BY THE EXPRESSED WRITTEN PERMISSION OF THE DESIGNER. 81 -20 -20 -24, 24 Ш ing. 386 Gral Pho AD RO CREEK ()-BN TON S WAL ш ST 1805 REVIEWED FOR CODE —(CN) COMPLIANCE 12/07/2022 DATE: ISSUED FOR: 06/17/2022 PERMIT PERMIT 09/07/2022 PERMIT CORRECTIONS 06/17/2022 DATE JOB NO: 21-276 DRAWN BY: BCE BCE CHECKED BY: SCALE: AS SHOWN SHEET NUMBER: E1-2 September 08, 2022 - 9:40:28am



DO NOT REPRODUCE THESE DRAWINGS AND SPECIFICATIONS WITHOUT THE EXPRESSED WRITTEN PERMISSION OF THE DESIGNER. THE DRAWINGS AND SPECIFICATIONS ARE INSTRUMENTS OF THE SERVICE AND SHALL REMAIN THE PROPERTY OF THE DESIGNER WHETHER THE PROJECT FOR WHICH THEY ARE MADE IS EXECUTED OR NOT. THESE DRAWINGS AND SPECIFICATIONS SHALL NOT BE USED BY ANYONE ON ANY OTHER PROJECTS FOR ADDITIONS TO THIS PROJECT BY OTHERS EXCEPT BY THE EXPRESSED WRITTEN PERMISSION OF THE DESIGNER.  $-\mathbf{C}$ ו Road nction, CO 815 70) 241-8709 ulting Engi & Electrical Eng June (97 386 Ind Grand , Phone: S ∞ Ś AD RO CREEK -BN \_\_\_\_\_ NO ഗ  $\vdash$ WAL 1805 . N REVIEWED FOR CODE \_\_\_\_\_CN COMPLIANCE 12/07/2022 DATE: ISSUED FOR: 06/17/2022 PERMIT PERMIT 09/07/2022 PERMIT CORRECTIONS 06/17/2022 DATE: JOB NO: 21-276 DRAWN BY: BCE BCE CHECKED BY: SCALE: AS SHOWN SHEET NUMBER: E1-3 September 08, 2022 - 9:40:29am

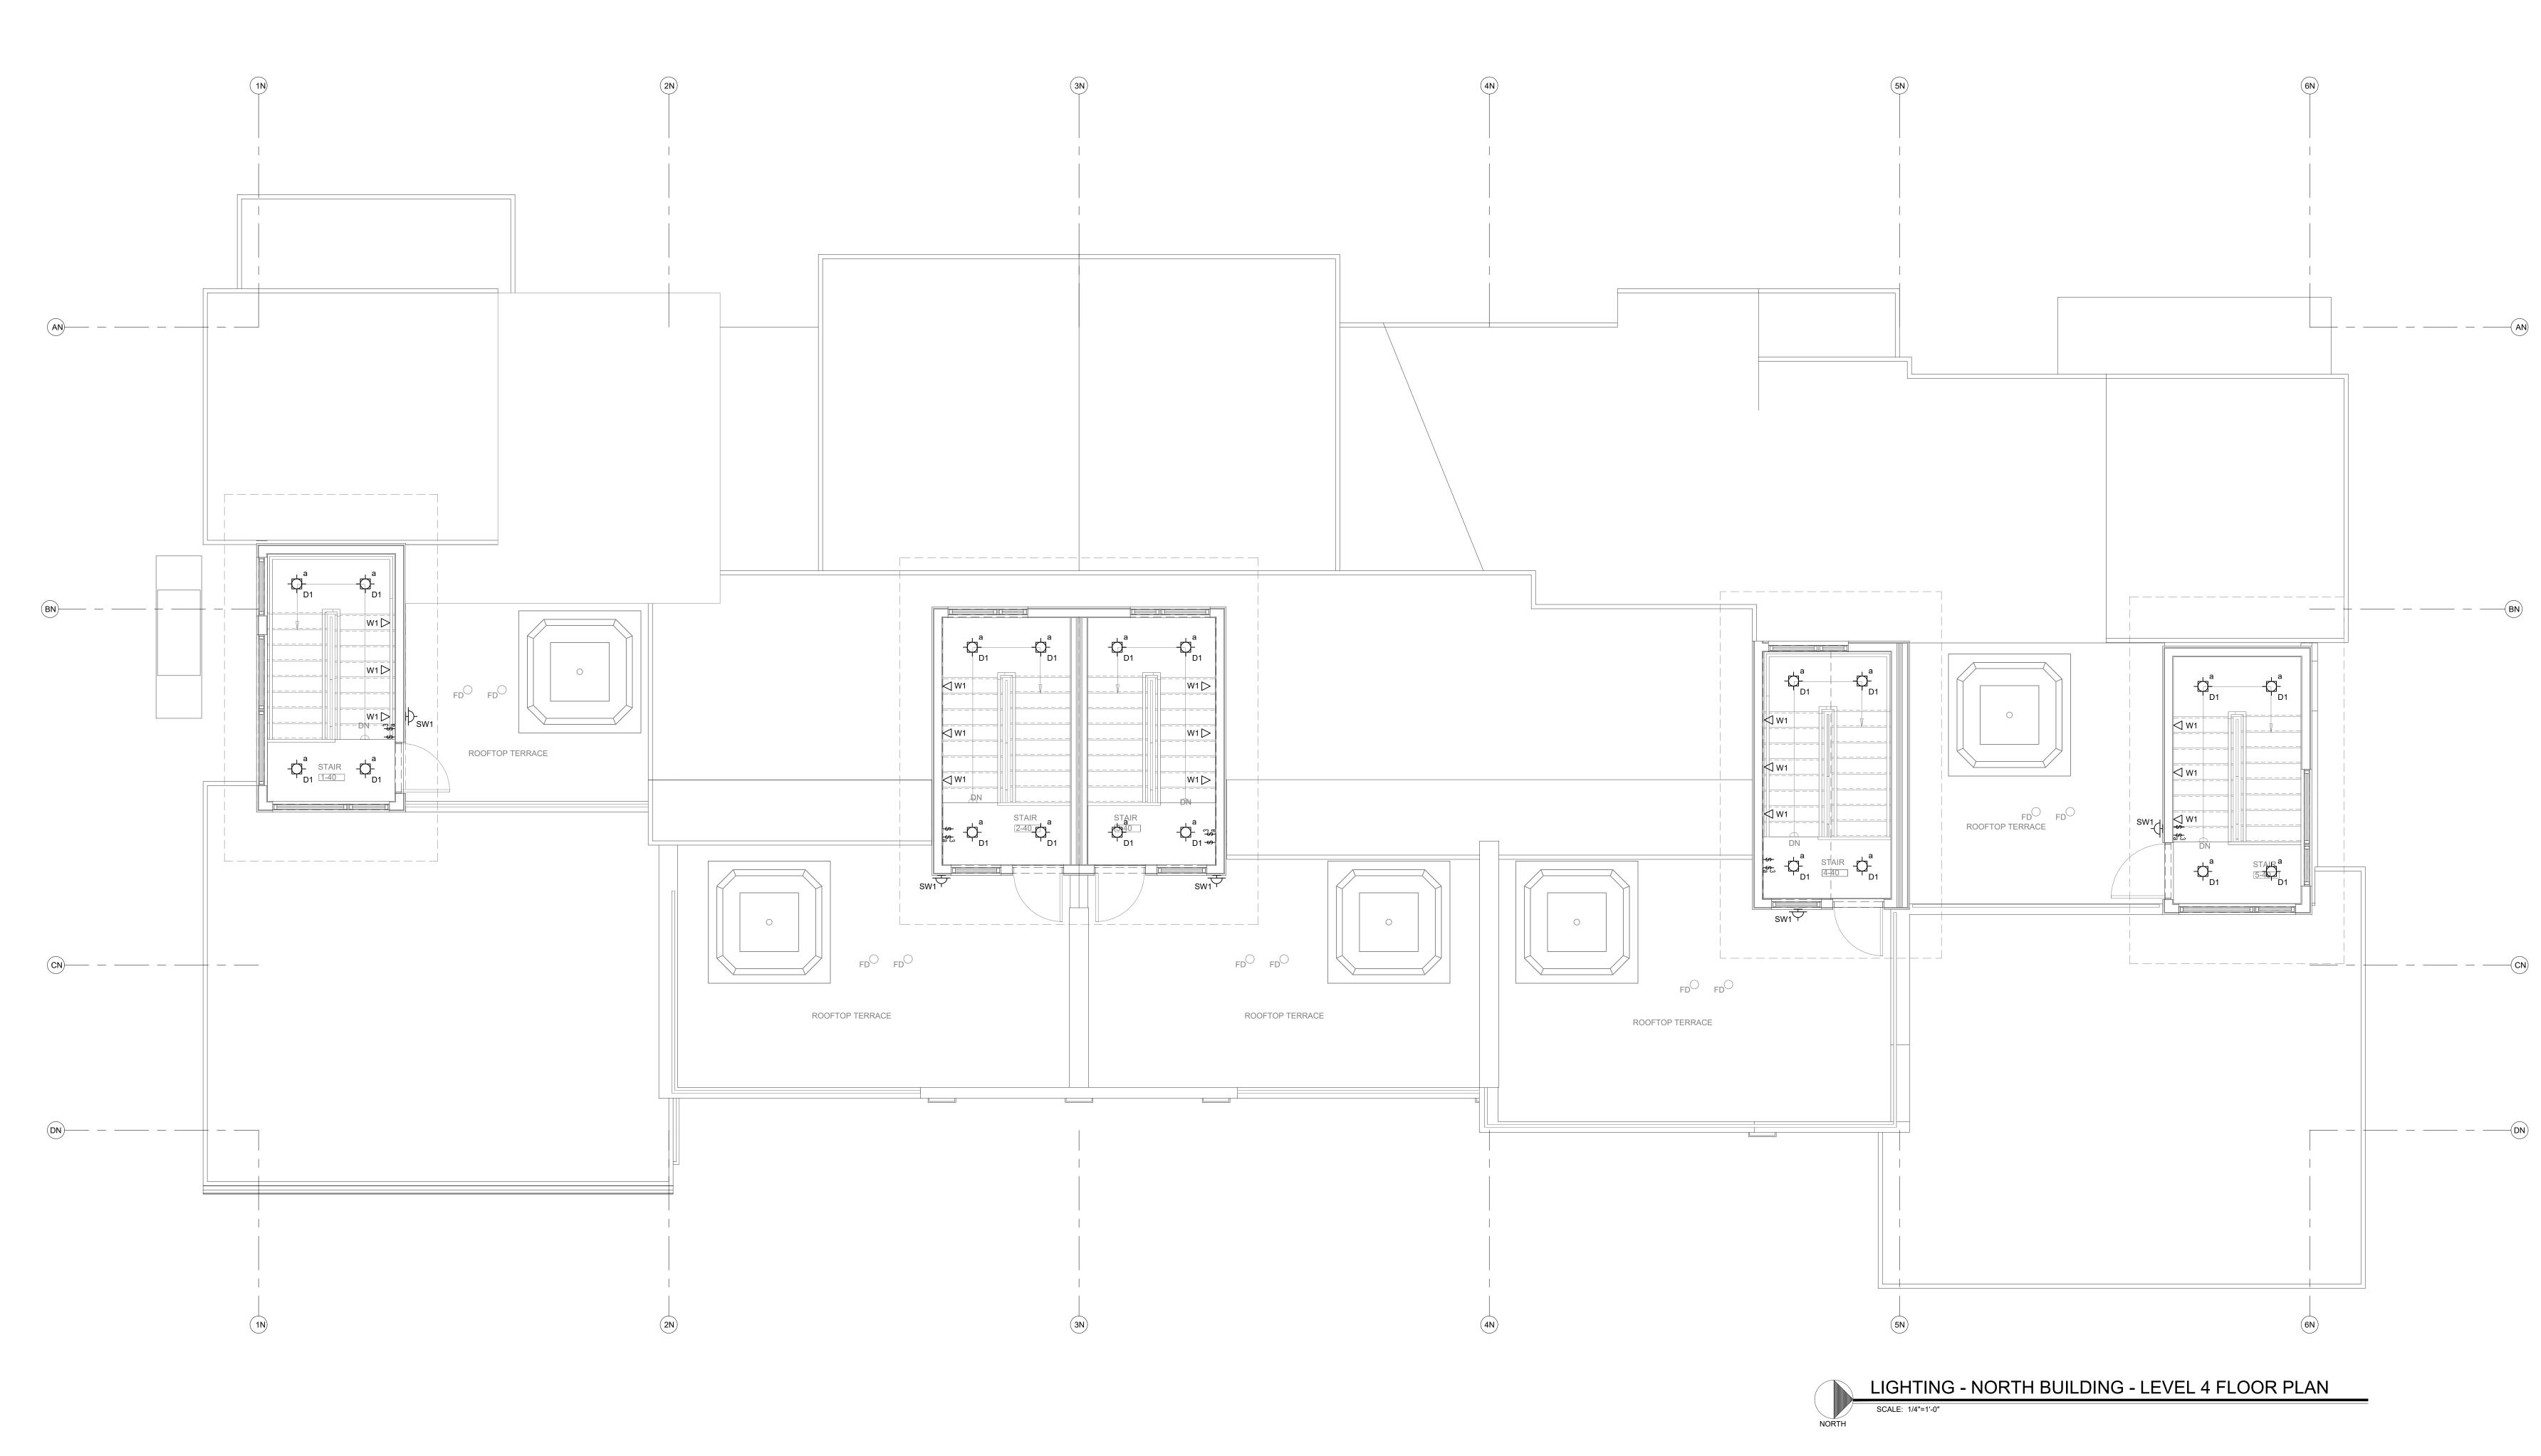

DO NOT REPRODUCE THESE DRAWINGS AND SPECIFICATIONS WITHOUT THE EXPRESSED WRITTEN PERMISSION OF THE DESIGNER. THE DRAWINGS AND SPECIFICATIONS ARE INSTRUMENTS OF THE SERVICE AND SHALL REMAIN THE PROPERTY OF THE DESIGNER WHETHER THE PROJECT FOR WHICH THEY ARE MADE IS EXECUTED OR NOT. THESE DRAWINGS AND SPECIFICATIONS SHALL NOT BE USED BY ANYONE ON ANY OTHER PROJECTS FOR ADDITIONS TO THIS PROJECT BY OTHERS EXCEPT BY THE EXPRESSED WRITTEN PERMISSION OF THE DESIGNER. C dian Road ا Junction, CO 815 »: (970) 241-8709 ISULTING Engine & Electrical Engine 386 Ind Grand , Phone:  $\odot$ R Ē AD RO CREEK ()TON ഗ WAL 1805 ່ທ REVIEWED FOR CODE COMPLIANCE \_\_\_\_\_CN 12/07/2022 DATE: ISSUED FOR: 06/17/2022 PERMIT 09/07/2022 PERMIT CORRECTIONS \_\_\_\_\_DN 60539 DATE: 06/17/2022 JOB NO: 21-276 DRAWN BY: BCE BCE CHECKED BY: SCALE: AS SHOWN SHEET NUMBER: E1-4 September 08, 2022 - 9:40:29am




(в) — –

	LUMINAIRE SCHEDULE								
TYPE	MANUFACTURER CATALOG NO.	MANUFACTURER CATALOG NO.	VOLTAGE MOUNTING	BALLAST/DRIVER LAMP SPECIFICATION	DESCRIPTION				
CF1	STUDIO M SM869909FTSNBK	APPROVED EQUIVALENT	120V SURFACE CEILING	E26 LED BULB 800LM, 3000K 80CRI, 9W/9W	COMBINATION CEILING FAN/LIGHT FROSTED LENS, MATCH WALL SWITCH WI DIMMING CONTROL TYPE. FIVE YEAR WAF				
D1	HALO H995ICATCP LT460WH6930	APPROVED EQUIVALENT	120V RECESSED CEILING	LED DIMMING DRIVER 600LM, 3000K 80CRI, 9W	4"DIA RECESSED DOWNLIGHT FROSTED LENS, CLOSET LISTED, DAMP LI COLD WEATHER RATED, FIVE YEAR WARF				
L1	METALUX 4SLSTP4040DD-UNV	APPROVED EQUIVALENT	120V SURFACE CEILING	LED DRIVER 4000LM, 3500K 80CRI, 40W	48" LINEAR STRIP LIGHT FROSTED LENS, COLD WEATHER RATED FIVE YEAR WARRANTY				
P1	TECH LIGHTING 700-MP-K-S-12	APPROVED EQUIVALENT	120V PENDANT	E26 LED BULB 600LM, 3000K 80CRI, 12W	MINI PENDANT CONFIRM SELECTION WITH ARCHITECT				
P2	TECH LIGHTING 700-TD-QNTP-K	APPROVED EQUIVALENT	120V PENDANT	E26 LED BULB 1200LM, 3000K 80CRI, 19W	PENDANT FIXTURE CONFIRM SELECTION WITH ARCHITECT				
V1	SHAPER 605-25-L3/830-UNV-XX	APPROVED EQUIVALENT	120V WALL SURFACE	LED DRIVER 2000LM, 3000K 80CRI, 20W	24" LINEAR LENSED VANITY FIXTURE DAMP LISTED, FROSTED LENS, FIVE YEAR WARRANTY				
W1	ASTRO LIGHTING 7418	APPROVED EQUIVALENT	120V STEP LIGHTING	LED DRIVER 35LM, 2700K 80CRI, 6W	WALL RECESSED STEP LIGHT DOWNWARD DIRECTED, PROVIDE WITH LI				
SW1	TECH LIGHTING 700OWTAG-830-6-D-Z-UNV-S	APPROVED EQUIVALENT	120V WALL SURFACE	LED DRIVER 600LM, 3000K 80CRI, 10W	EXTERIOR FULL CUTOFF WALL SCONCE COLD WEATHER RATED, WET LISTED FIVE YEAR WARRANTY				

<u>NOTES:</u>
 FIXTURES ARE REPRESENTATIVE OF A BASIS OF DESIGN FOR PRICING PURPOSES. VERIFY FINAL SELECTION WITH ARCHITECT AND OWNER.
 CONTROLS FOR EACH RESIDENCE TO BE A WHOLE HOME SYSTEM, LUTRON HOMEWORKS OR EQUIVALENT TO ALLOW SCENE PROGRAMMING AND INTEGRATE SHADE CONTROL.

SCALE: 1/4"=1'-0"

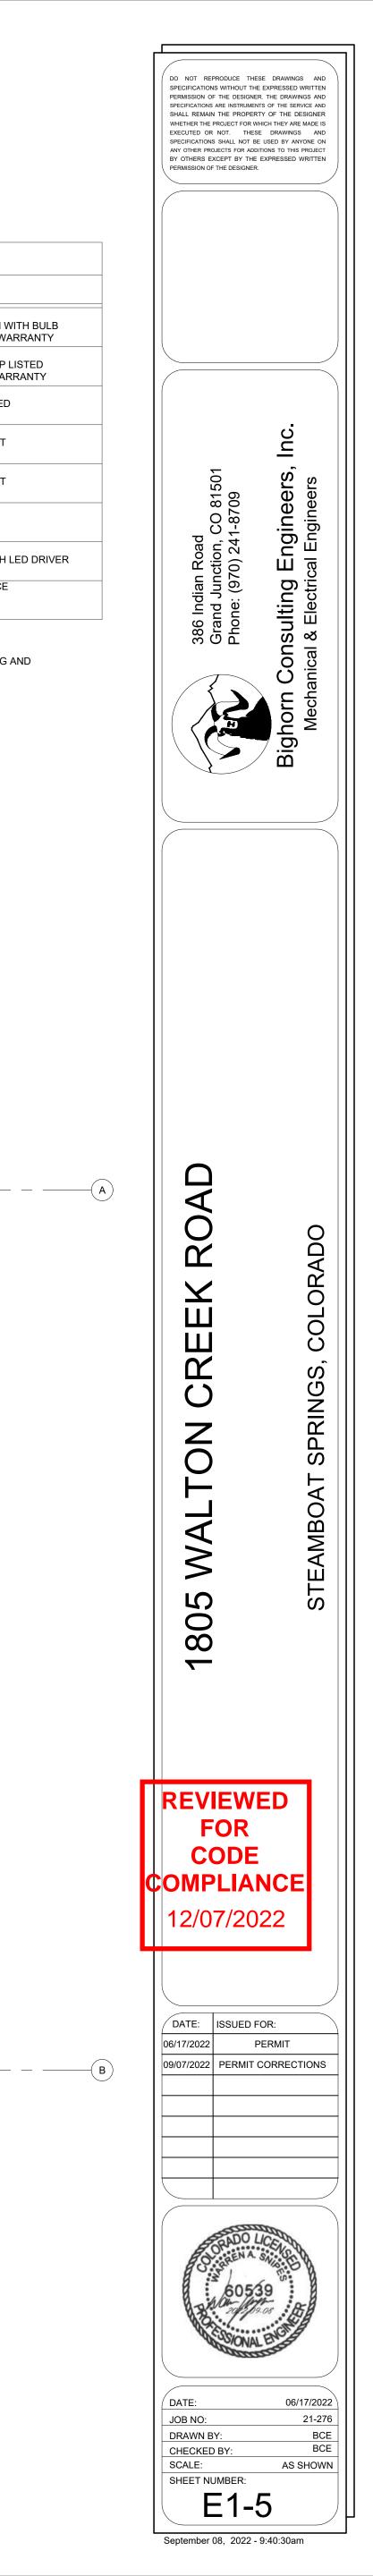





LIGHTING - SOUTH BUILDING - LEVEL 2 FLOOR PLAN SCALE: 1/4"=1'-0"

DO NOT REPRODUCE THESE DRAWINGS AND SPECIFICATIONS WITHOUT THE EXPRESSED WRITTEN PERMISSION OF THE DESIGNER. THE DRAWINGS AND SPECIFICATIONS ARE INSTRUMENTS OF THE SERVICE AND SHALL REMAIN THE PROPERTY OF THE SERVICE AND SHALL REMAIN THE PROPERTY OF THE DESIGNER WHETHER THE PROJECT FOR WHICH THEY ARE MADE IS EXECUTED OR NOT. THESE DRAWINGS AND SPECIFICATIONS SHALL NOT BE USED BY ANYONE ON ANY OTHER PROJECTS FOR ADDITIONS TO THIS PROJECT BY OTHERS EXCEPT BY THE EXPRESSED WRITTEN PERMISSION OF THE DESIGNER. Inc S 386 Indian Road Grand Junction, CO 815 Phone: (970) 241-8709 sulting Engine & Electrical Engine 0 Ŭ  $\overline{}$ Real Provide American Street horn Big ROAD CREEK ()WALTON ഗ Ш 1805 ST REVIEWED FOR CODE COMPLIANCE 12/07/2022 DATE: ISSUED FOR: 06/17/2022 PERMIT 09/07/2022 PERMIT CORRECTIONS DATE: 06/17/2022 JOB NO: 21-276 DRAWN BY: BCE BCE CHECKED BY: SCALE: AS SHOWN SHEET NUMBER: E1-6 September 08, 2022 - 9:40:31am



 $\left(1\right)$ B \_\_\_\_\_

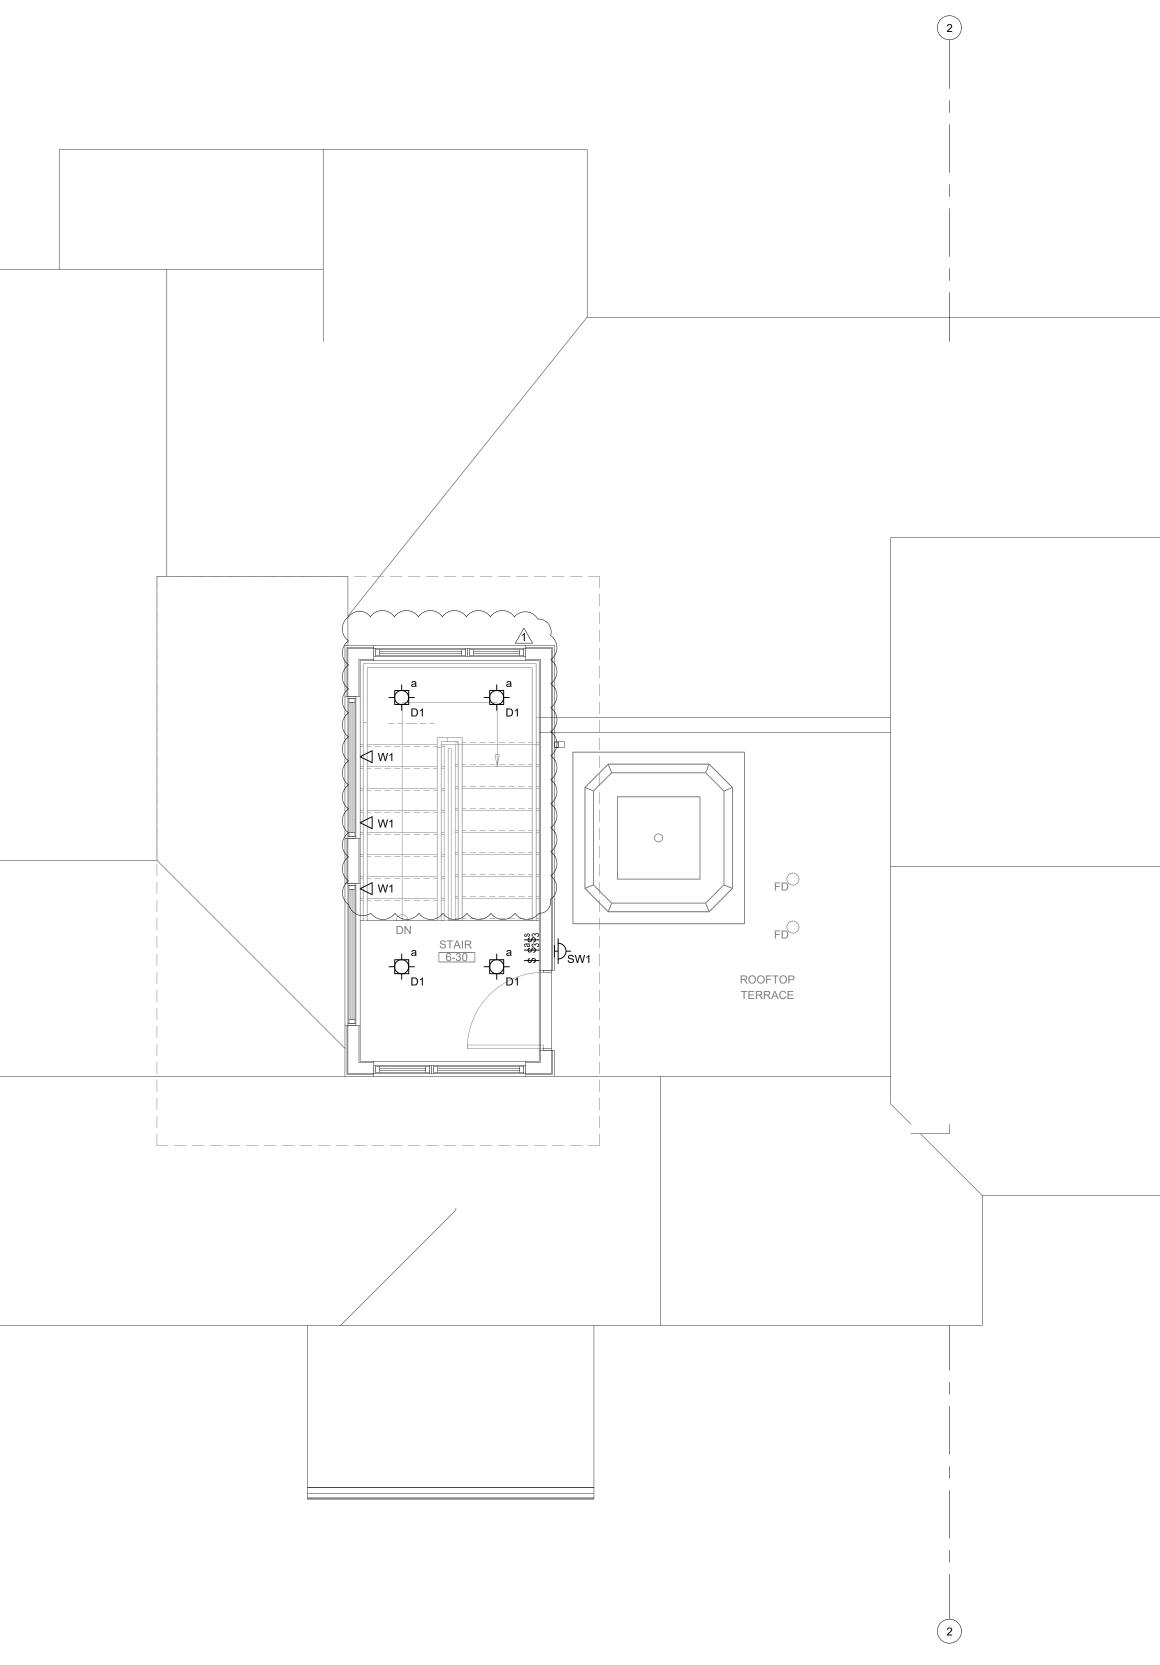


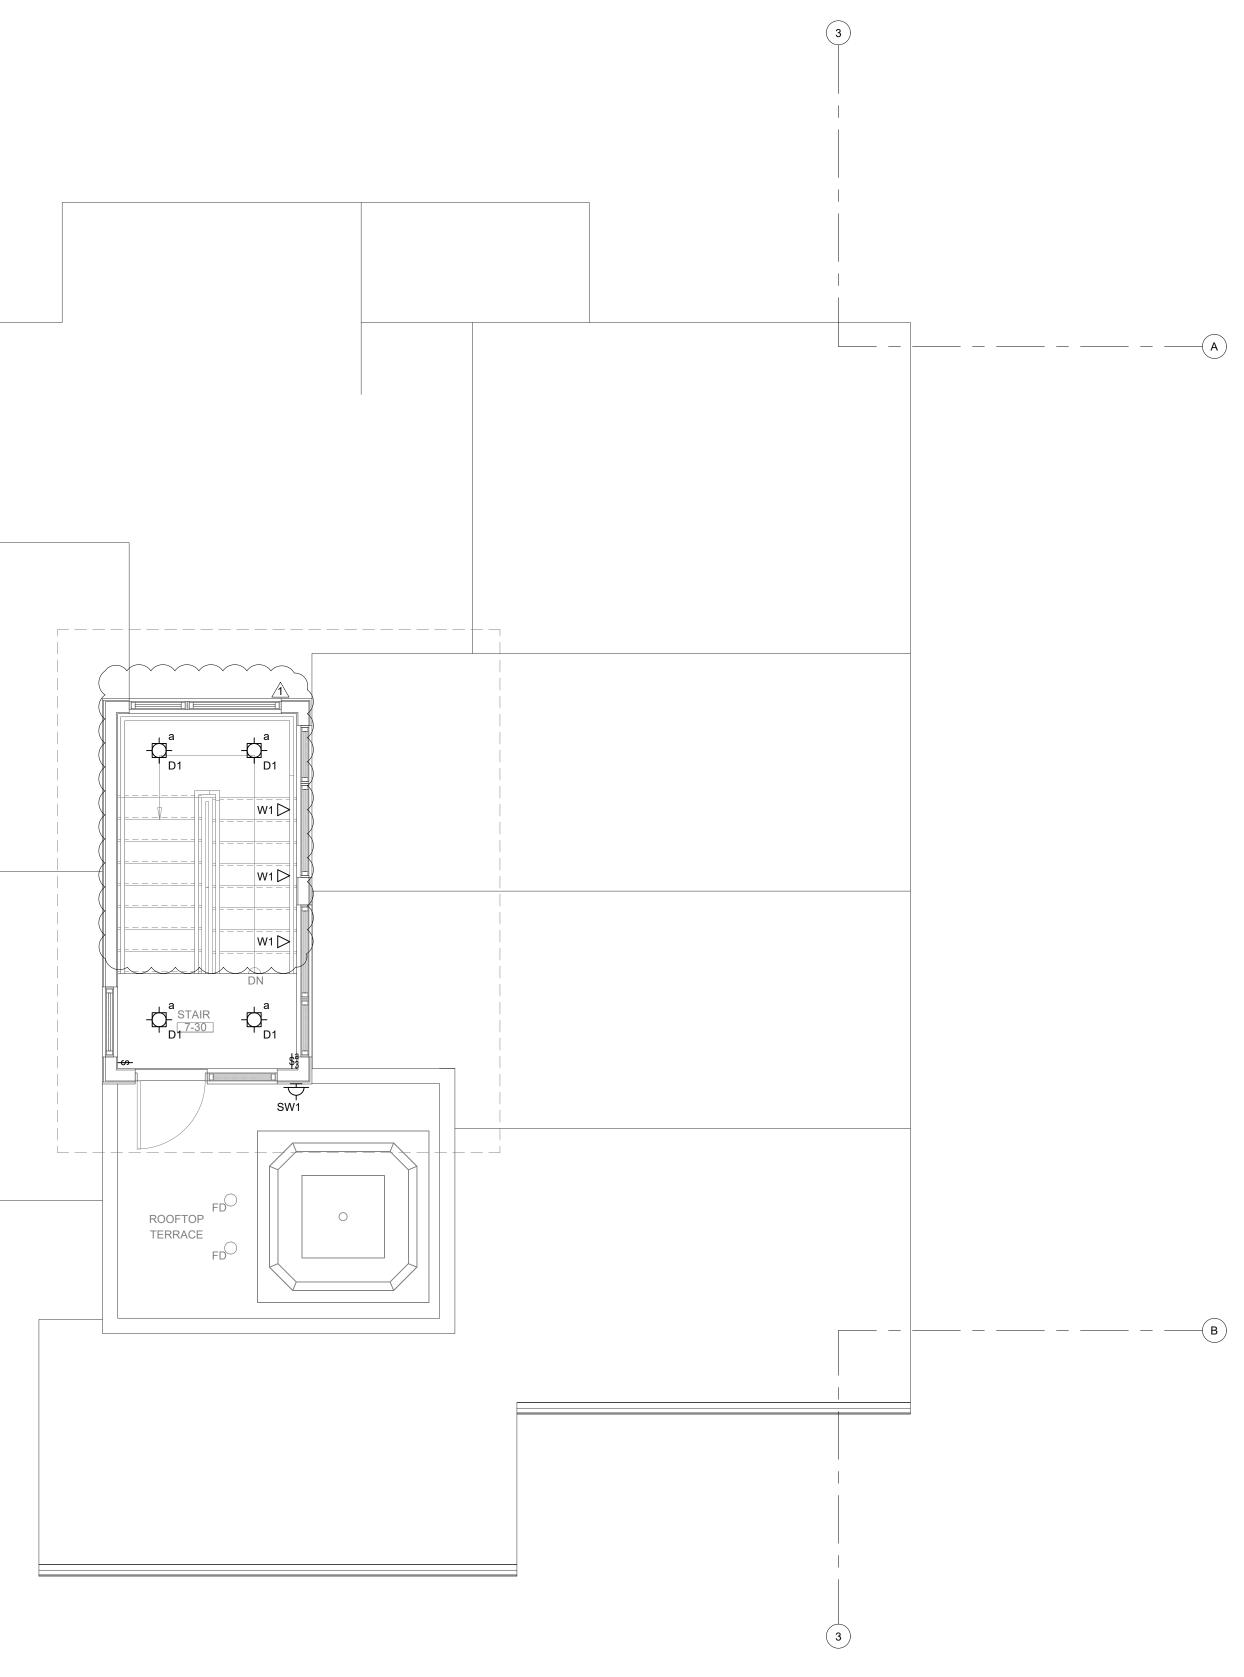


LIGHTING - SOUTH BUILDING - LEVEL 3 FLOOR PLAN SCALE: 1/4"=1'-0"

DO NOT REPRODUCE THESE DRAWINGS AND SPECIFICATIONS WITHOUT THE EXPRESSED WRITTEN PERMISSION OF THE DESIGNER. THE DRAWINGS AND SPECIFICATIONS ARE INSTRUMENTS OF THE SERVICE AND SHALL REMAIN THE PROPERTY OF THE SERVICE AND SHALL REMAIN THE PROPERTY OF THE DESIGNER WHETHER THE PROJECT FOR WHICH THEY ARE MADE IS EXECUTED OR NOT. THESE DRAWINGS AND SPECIFICATIONS SHALL NOT BE USED BY ANYONE ON ANY OTHER PROJECTS FOR ADDITIONS TO THIS PROJECT BY OTHERS EXCEPT BY THE EXPRESSED WRITTEN PERMISSION OF THE DESIGNER. Inc S 386 Indian Road Grand Junction, CO 815 Phone: (970) 241-8709 sulting Enginee & Electrical Enginee 0 Ŭ horn Mert Big ROAD CREEK ()TON S WAL ш 1805 ST REVIEWED FOR CODE COMPLIANCE 12/07/2022 DATE: ISSUED FOR: 06/17/2022 PERMIT 09/07/2022 PERMIT CORRECTIONS DATE: 06/17/2022 21-276 JOB NO: DRAWN BY: BCE BCE CHECKED BY: SCALE: AS SHOWN SHEET NUMBER: E1-7 September 08, 2022 - 9:40:32am



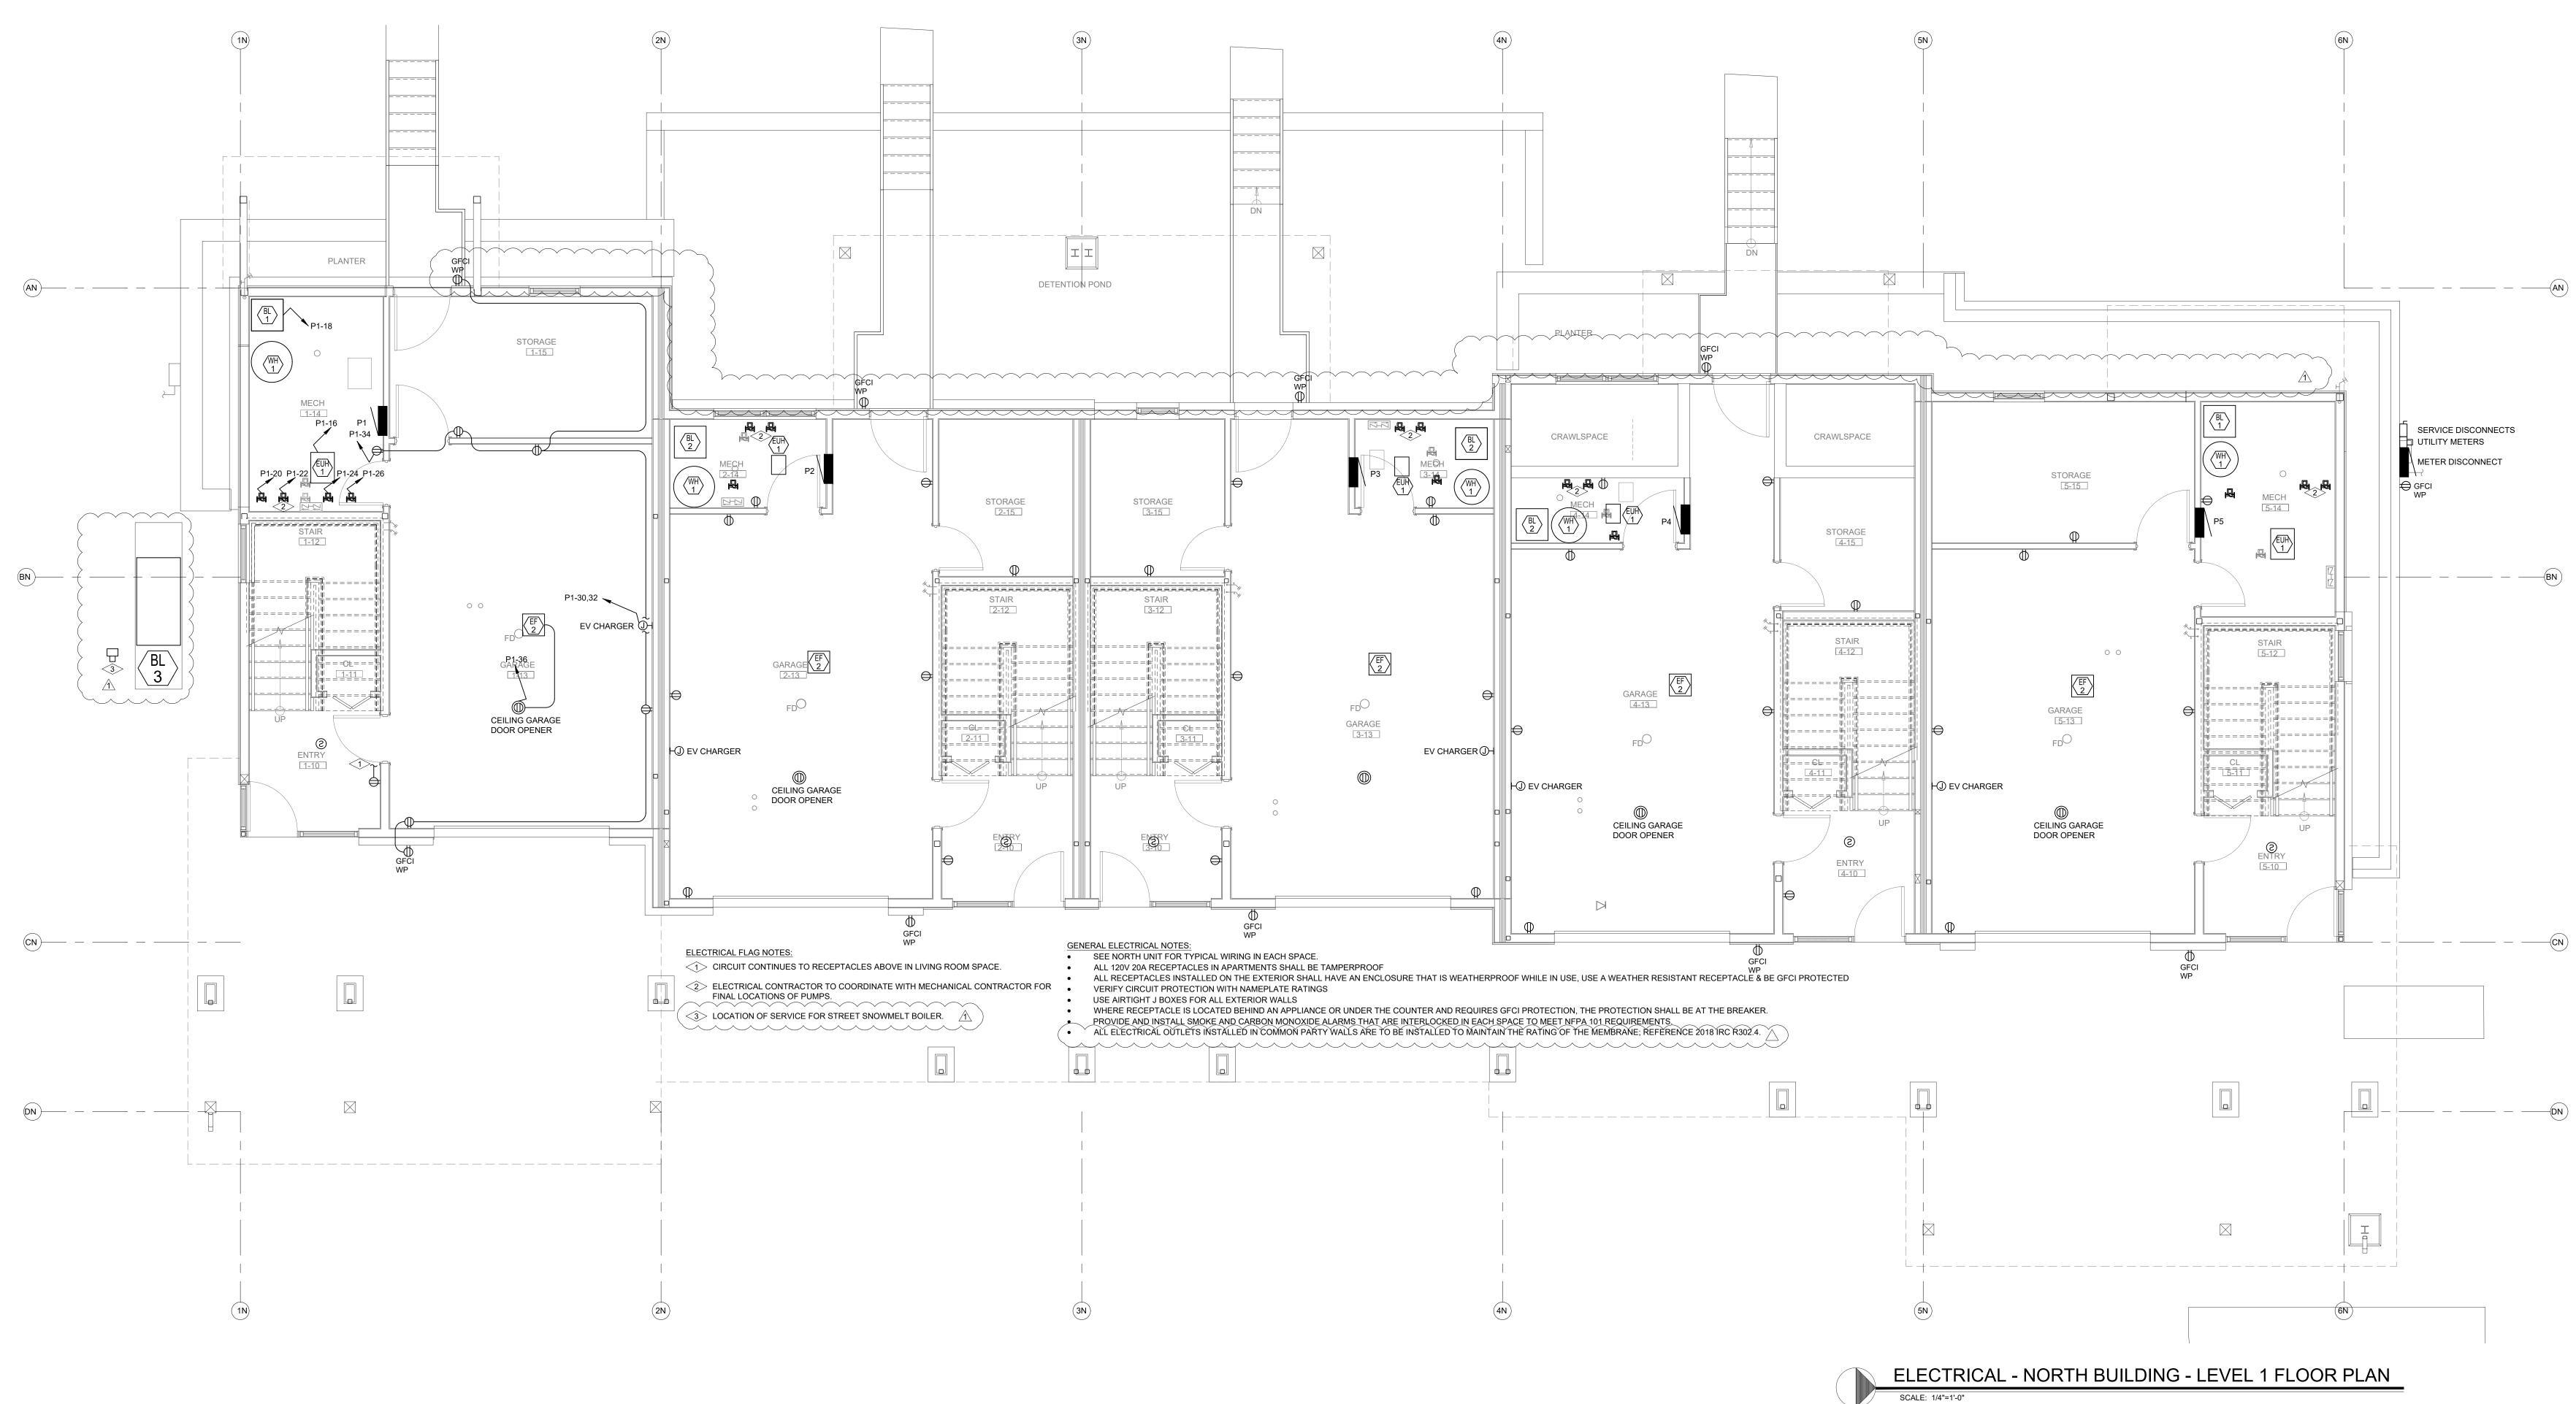


DO NOT REPRODUCE THESE DRAWINGS AND DO NOT REPRODUCE THESE DRAWINGS AND SPECIFICATIONS WITHOUT THE EXPRESSED WRITTEN PERMISSION OF THE DESIGNER. THE DRAWINGS AND SPECIFICATIONS ARE INSTRUMENTS OF THE SERVICE AND SHALL REMAIN THE PROPERTY OF THE DESIGNER WHETHER THE PROJECT FOR WHICH THEY ARE MADE IS EXECUTED OR NOT. THESE DRAWINGS AND SPECIFICATIONS SHALL NOT BE USED BY ANYONE ON ANY OTHER PROJECTS FOR ADDITIONS TO THIS PROJECT BY OTHERS EXCEPT BY THE EXPRESSED WRITTEN PERMISSION OF THE DESIGNER.  $-\mathbf{C}$ 81<u>(</u> 709 ı Road ıction, CO { 70) 241-87( ulting Engi , Electrical Enc. Jd Pc 386 | Gran Phor S & **E** > $\square$ 4 Ο  $\mathbf{C}$  $\mathbf{X}$ REE  $\mathbf{O}$ -(BN ) Ζ C S 80 ~ REVIEWED FOR CODE —(CN ) COMPLIANCE 12/07/2022 DATE: ISSUED FOR: 06/17/2022 PERMIT 09/07/2022 PERMIT CORRECTIONS —(DN ) 06/17/2022 DATE JOB NO: 21-276 DRAWN BY: BCE BCE CHECKED BY: SCALE: AS SHOWN SHEET NUMBER: E2-1 September 08, 2022 - 9:40:36am

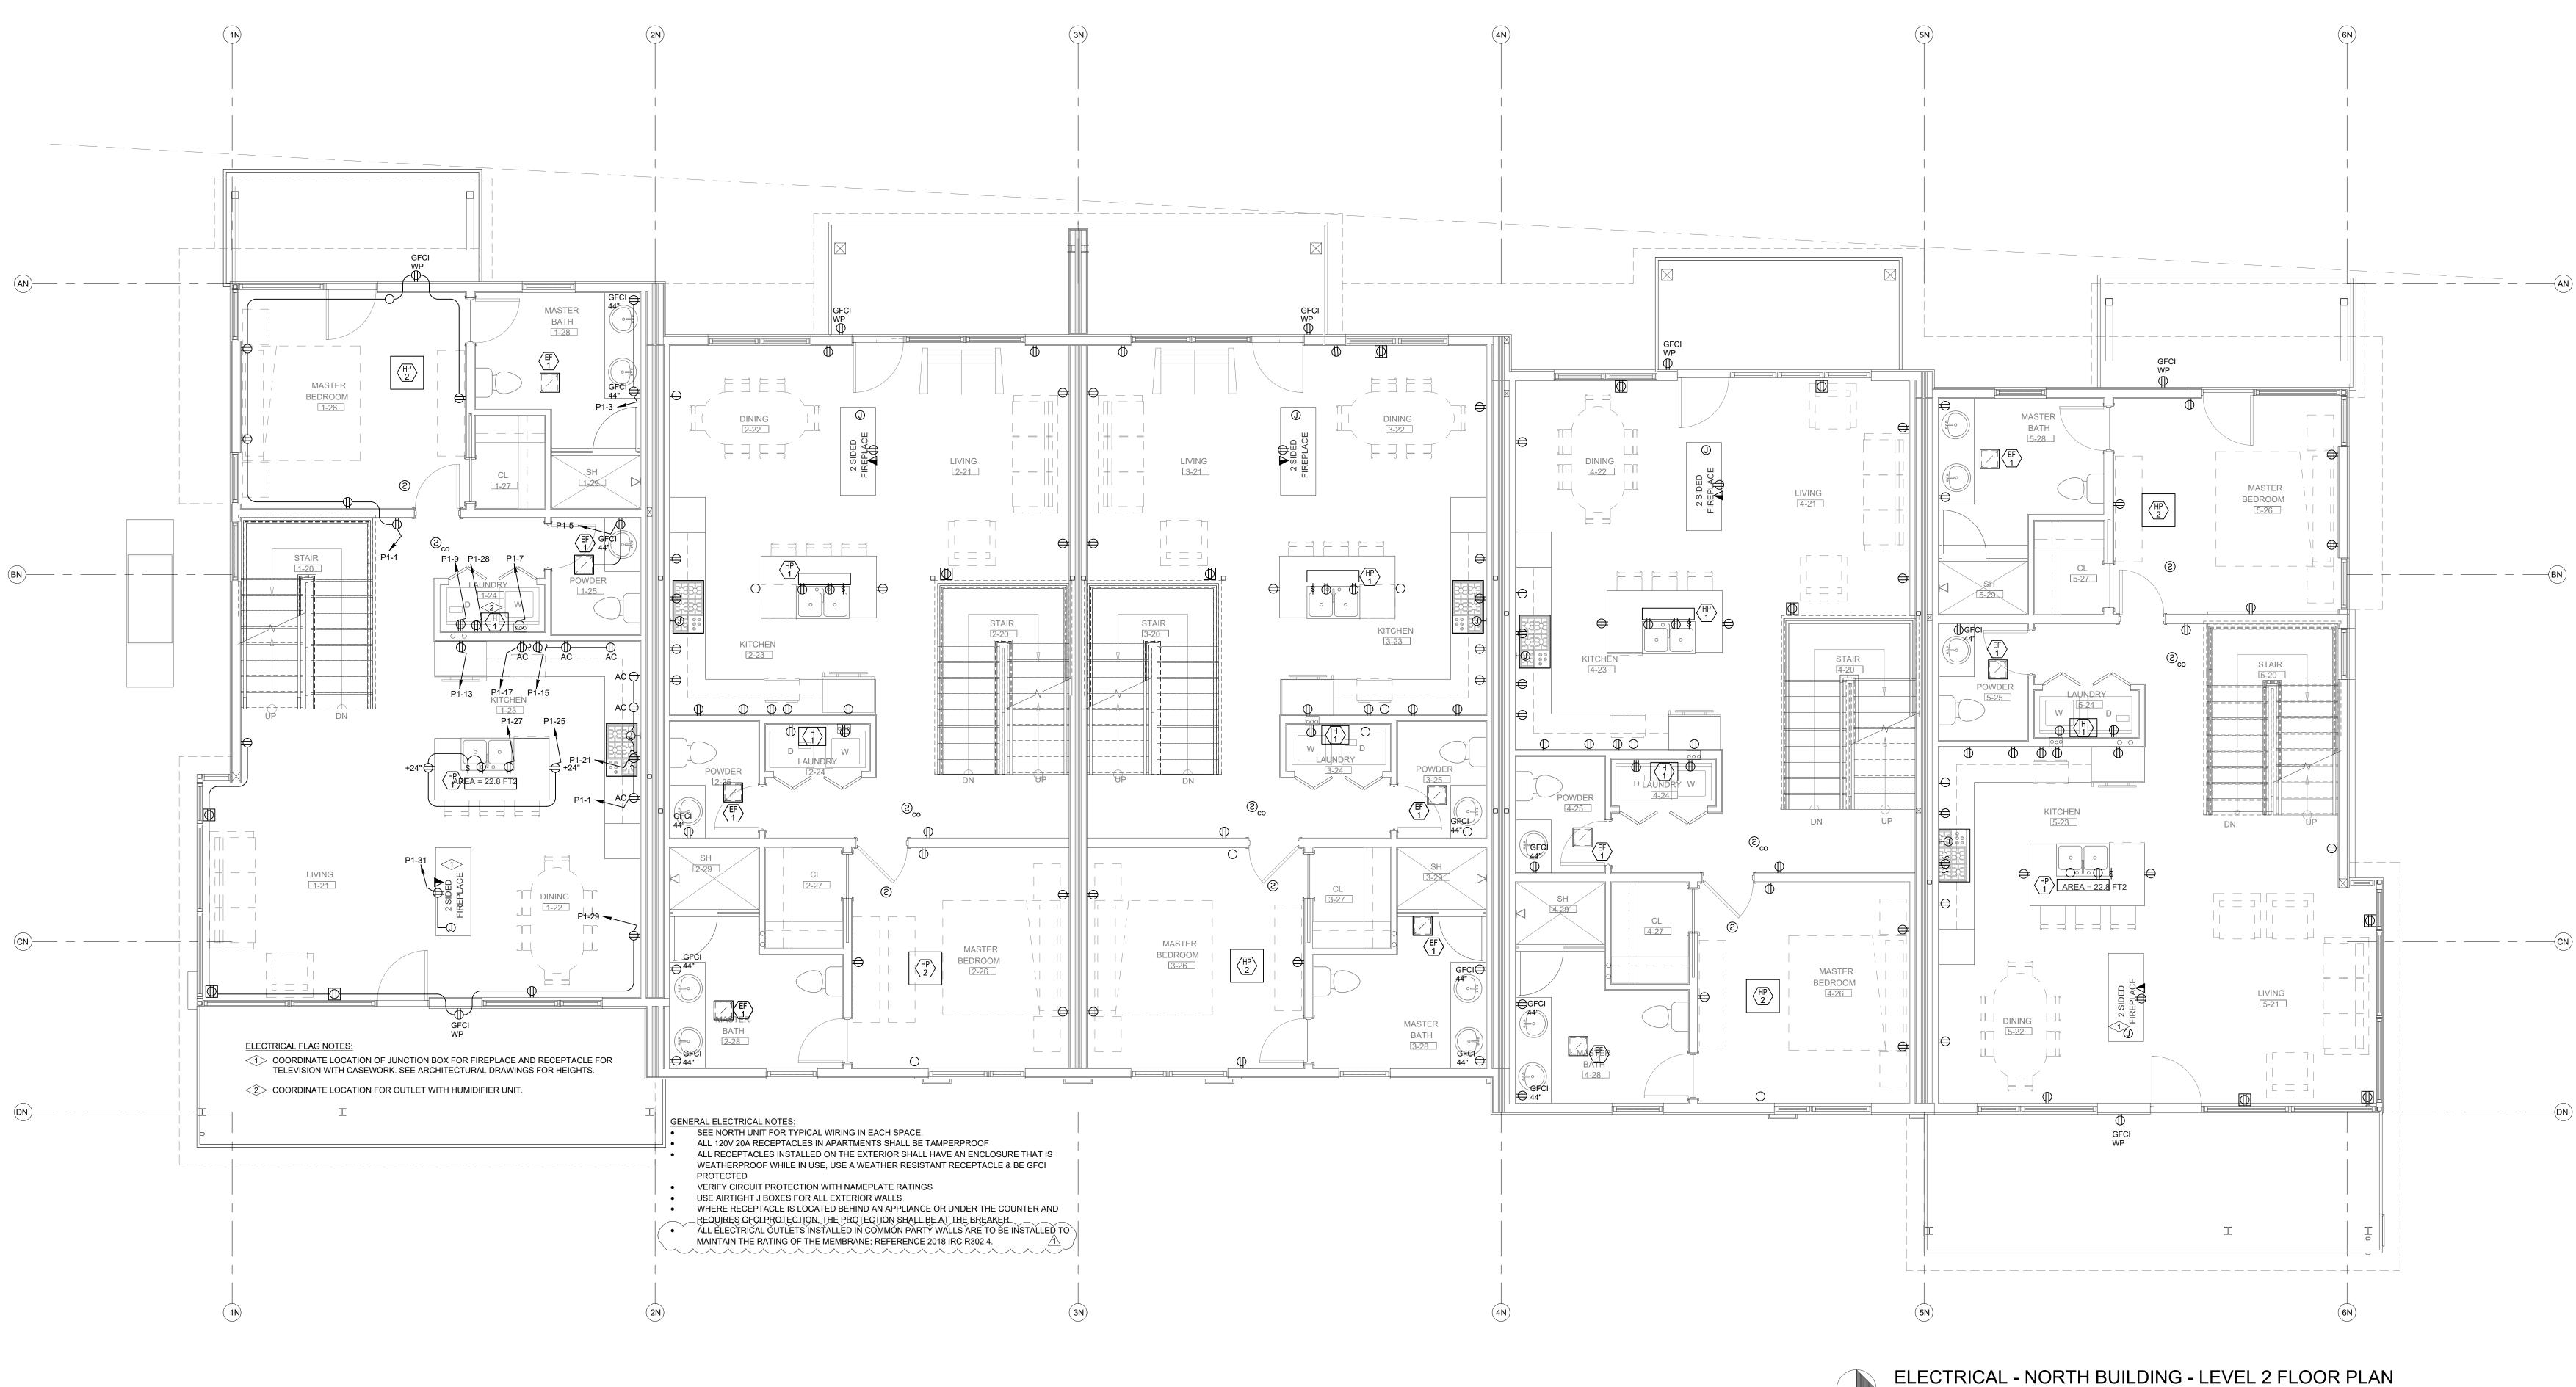


SCALE: 1/4"=1'-0"


DO NOT REPRODUCE THESE DRAWINGS AN DO NOT REPRODUCE THESE DRAWINGS AND SPECIFICATIONS WITHOUT THE EXPRESSED WRITTEN PERMISSION OF THE DESIGNER. THE DRAWINGS AND SPECIFICATIONS ARE INSTRUMENTS OF THE SERVICE AND SHALL REMAIN THE PROPERTY OF THE DESIGNER WHETHER THE PROJECT FOR WHICH THEY ARE MADE IS EXECUTED OR NOT. THESE DRAWINGS AND SPECIFICATIONS SHALL NOT BE USED BY ANYONE ON ANY OTHER PROJECTS FOR ADDITIONS TO THIS PROJECT BY OTHERS EXCEPT BY THE EXPRESSED WRITTEN PERMISSION OF THE DESIGNER. 0.4 5<sup>4</sup> 27 Ш D. 386 Gral Pho  $\square$  $\triangleleft$ O Ŷ CREEK -(BN) NO S WAL 1805 ίΩ REVIEWED FOR CODE —(CN) COMPLIANCE 12/07/2022 DATE: ISSUED FOR: 06/17/2022 PERMIT 09/07/2022 PERMIT CORRECTIONS 06/17/2022 DATE JOB NO: 21-276 DRAWN BY: BCE BCE CHECKED BY: SCALE: AS SHOWN SHEET NUMBER: E2-2 September 08, 2022 - 9:40:38am

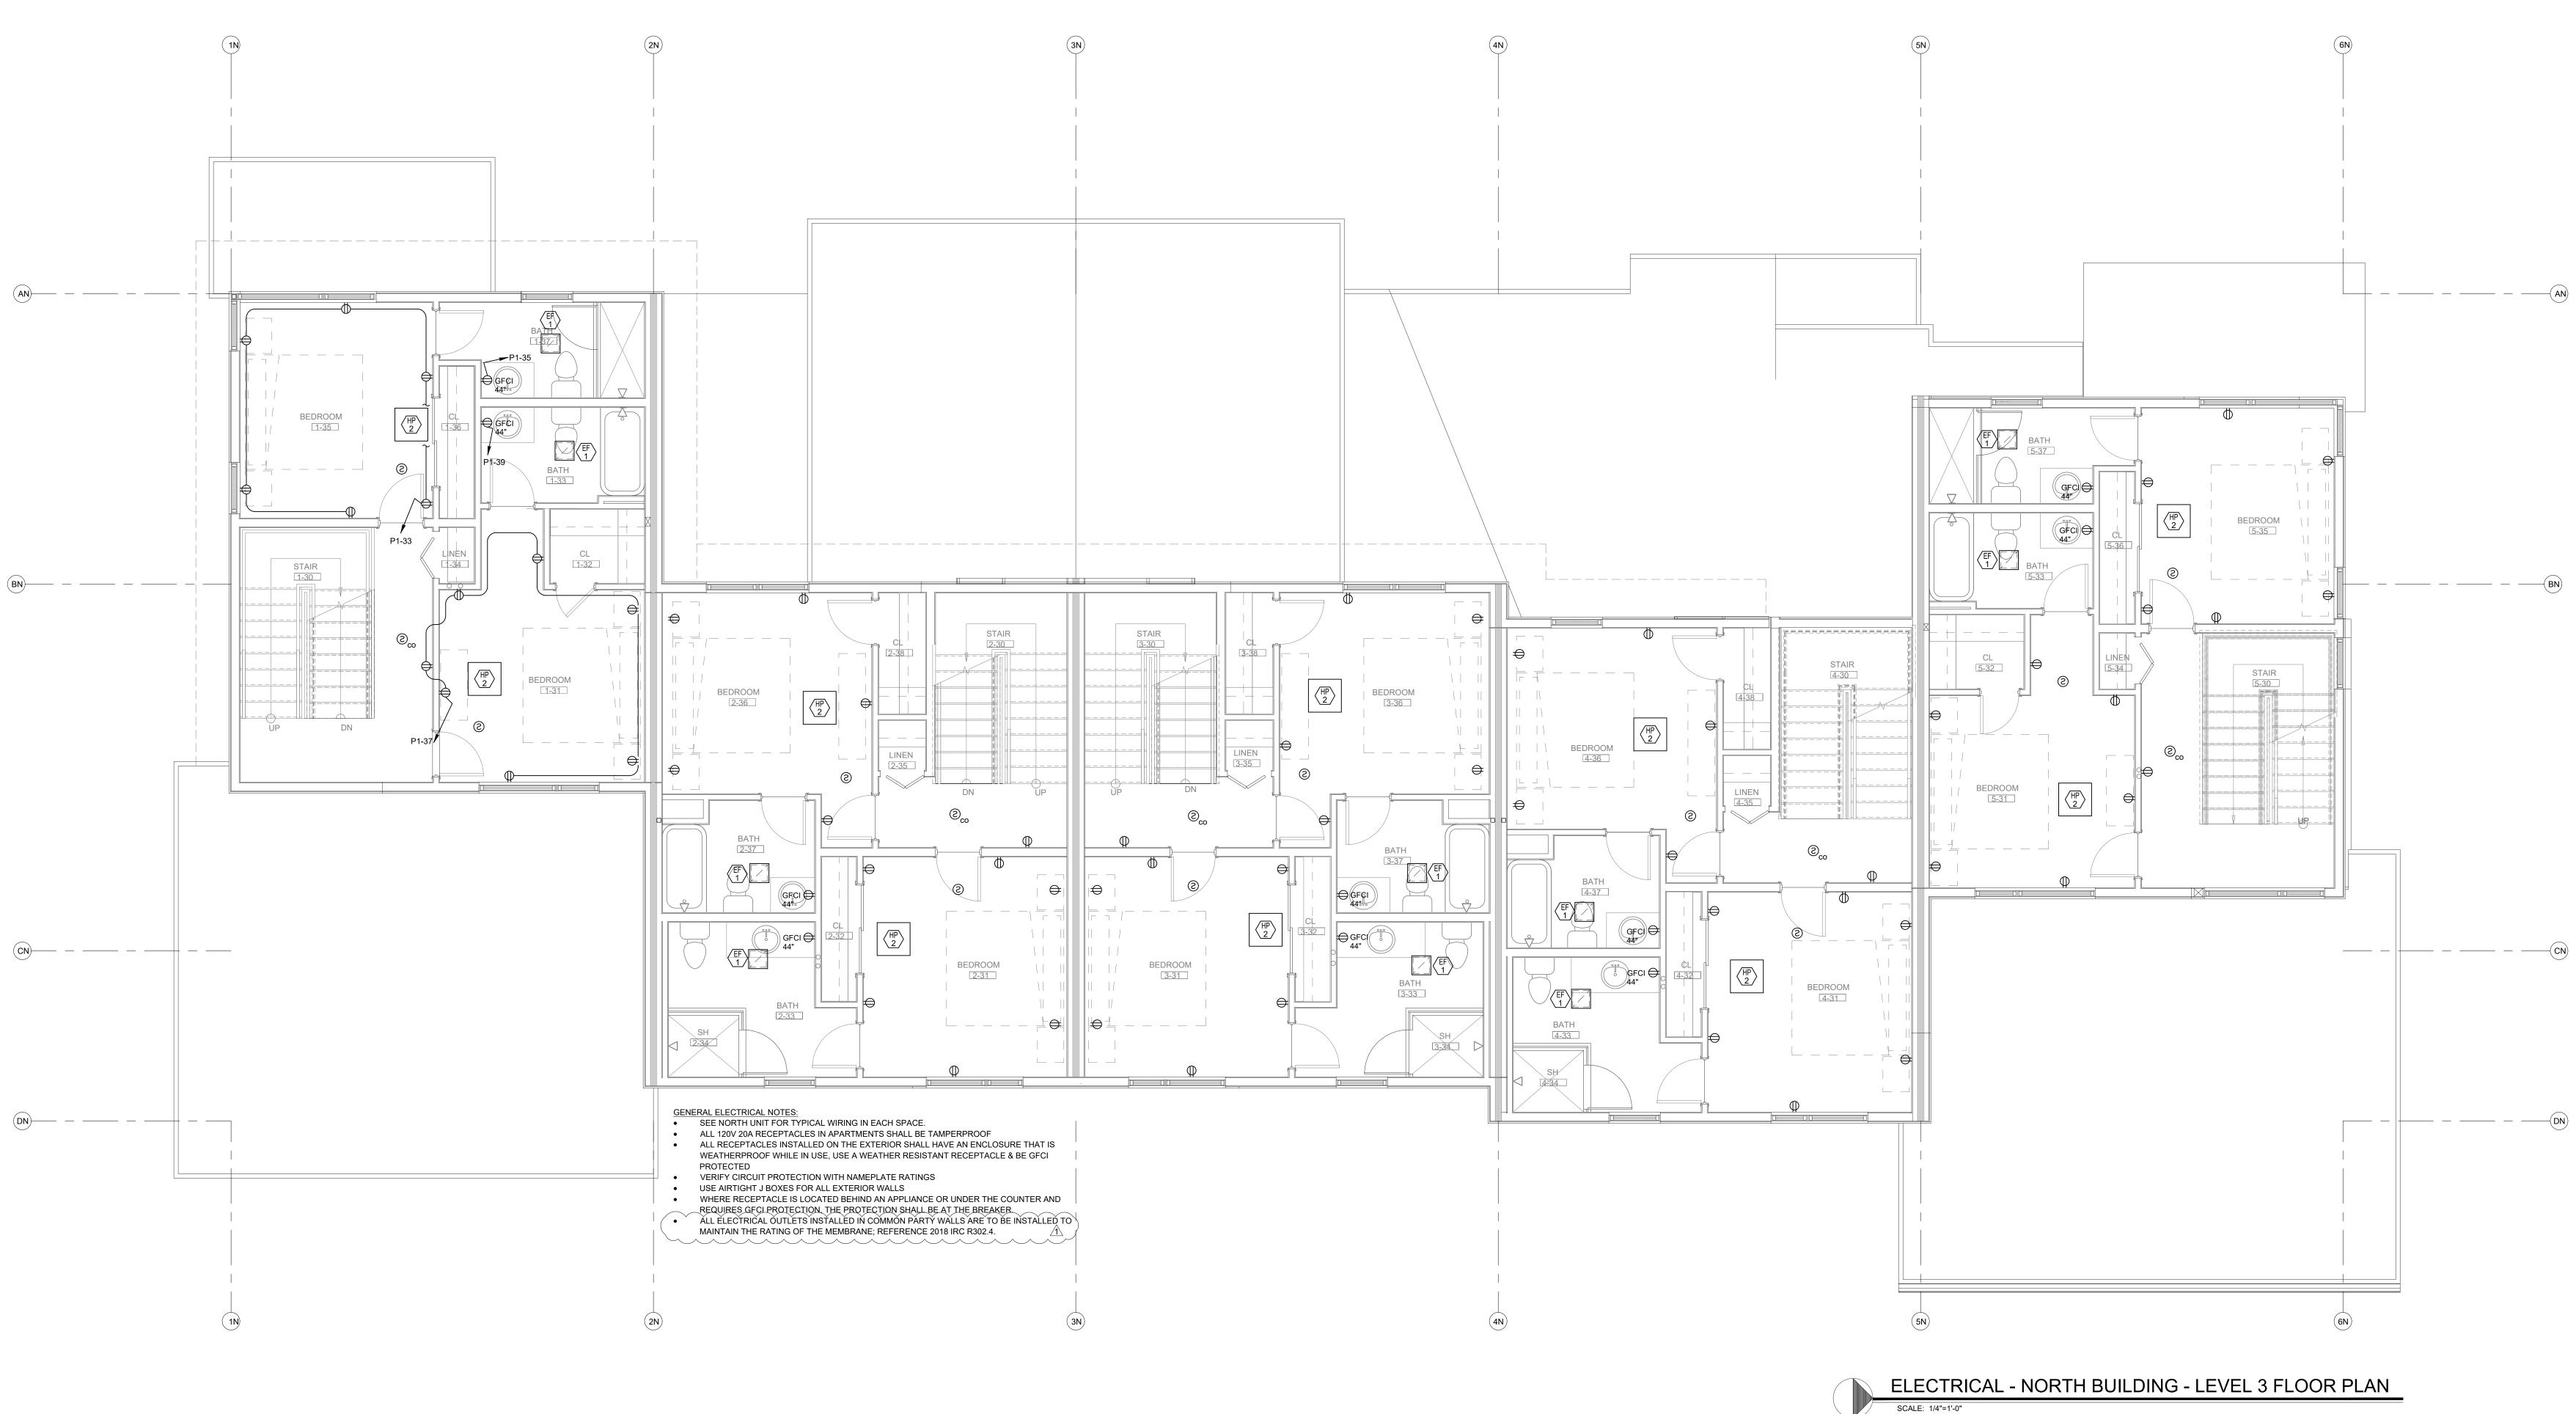


DO NOT REPRODUCE THESE DRAWINGS AND SPECIFICATIONS WITHOUT THE EXPRESSED WRITTEN PERMISSION OF THE DESIGNER. THE DRAWINGS AND SPECIFICATIONS ARE INSTRUMENTS OF THE SERVICE AND SHALL REMAIN THE PROPERTY OF THE DESIGNER WHETHER THE PROJECT FOR WHICH THEY ARE MADE IS EXECUTED OR NOT. THESE DRAWINGS AND SPECIFICATIONS SHALL NOT BE USED BY ANYONE ON ANY OTHER PROJECTS FOR ADDITIONS TO THIS PROJECT BY OTHERS EXCEPT BY THE EXPRESSED WRITTEN PERMISSION OF THE DESIGNER. 81 09 Road ction, CO { 70) 241-87( ulting Engi , Electrical Enc J d d d 386 Grar Phor S & Ś  $\square$  $\triangleleft$ RO CREEK NO AL  $\geq$ 1805 . N REVIEWED FOR CODE \_\_\_\_\_CN COMPLIANCE 12/07/2022 DATE: ISSUED FOR: 06/17/2022 PERMIT PERMIT 09/07/2022 PERMIT CORRECTIONS 06/17/2022 DATE: JOB NO: 21-276 DRAWN BY: BCE BCE CHECKED BY: SCALE: AS SHOWN SHEET NUMBER: E2-3 September 08, 2022 - 9:40:38am

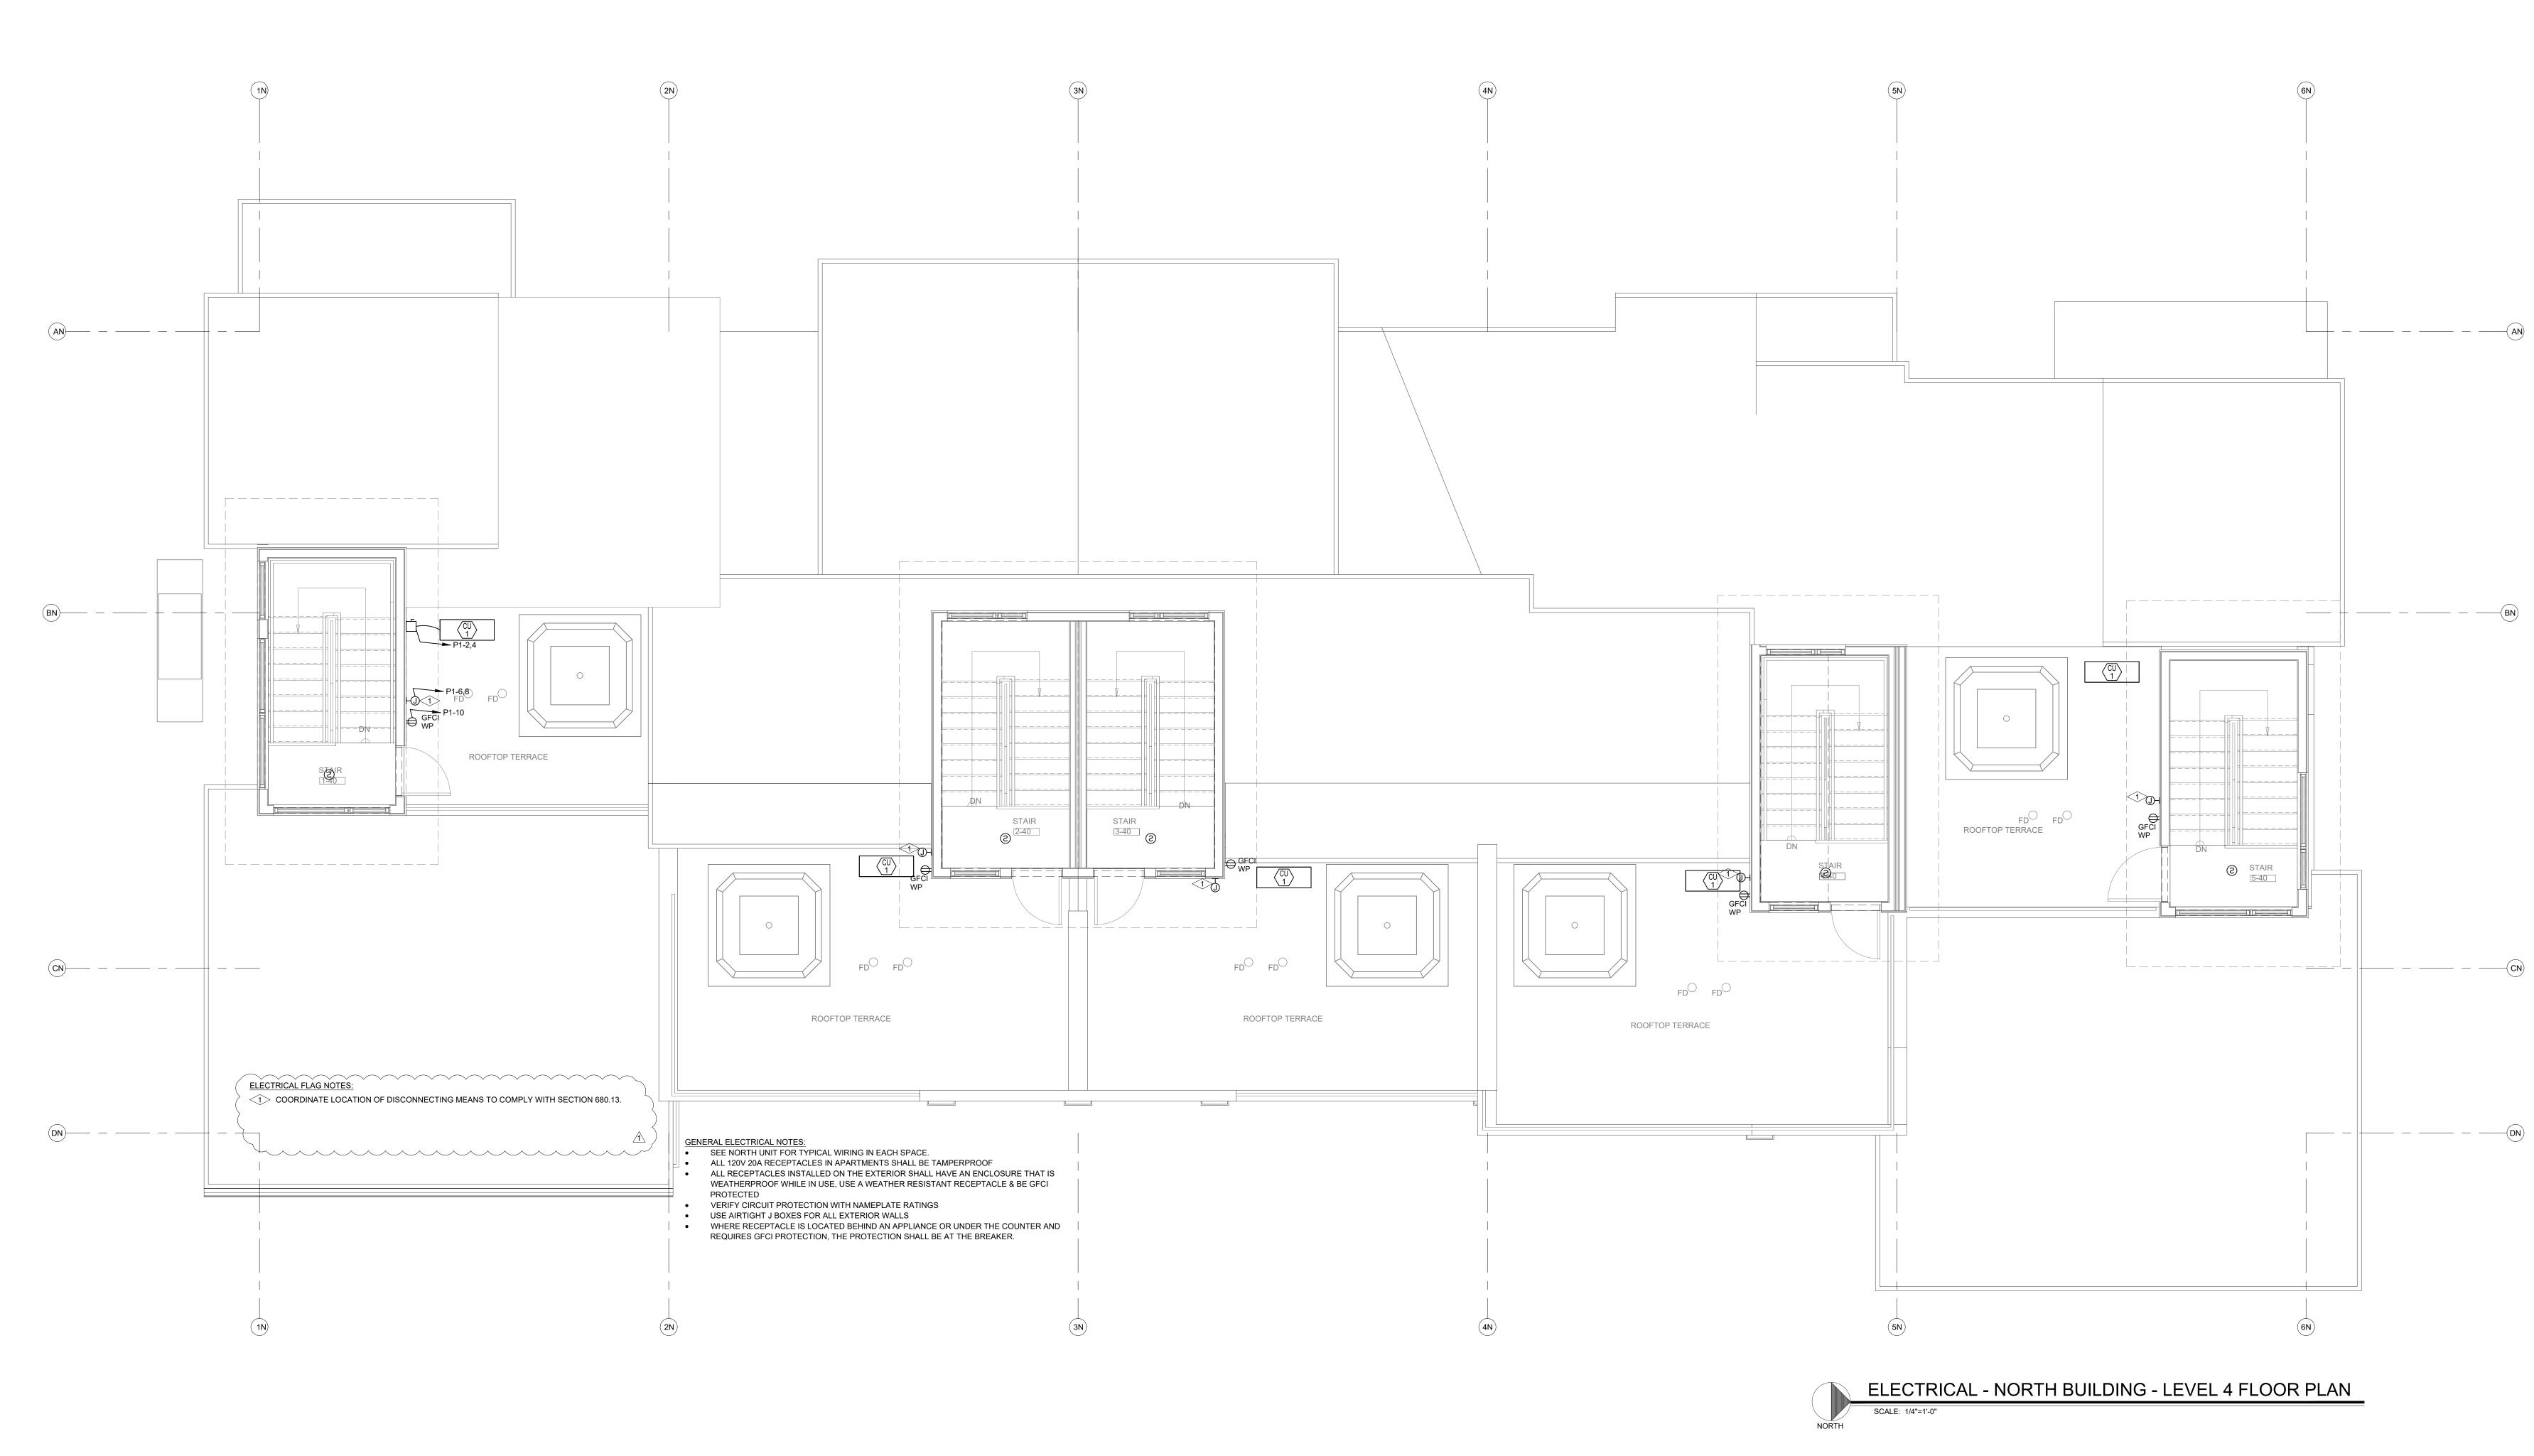

DO NOT REPRODUCE THESE DRAWINGS AND SPECIFICATIONS WITHOUT THE EXPRESSED WRITTEN PERMISSION OF THE DESIGNER. THE DRAWINGS AND SPECIFICATIONS ARE INSTRUMENTS OF THE SERVICE AND SHALL REMAIN THE PROPERTY OF THE DESIGNER WHETHER THE PROJECT FOR WHICH THEY ARE MADE IS EXECUTED OR NOT. THESE DRAWINGS AND SPECIFICATIONS SHALL NOT BE USED BY ANYONE ON ANY OTHER PROJECTS FOR ADDITIONS TO THIS PROJECT BY OTHERS EXCEPT BY THE EXPRESSED WRITTEN PERMISSION OF THE DESIGNER. 0 dian Road Junction, CO 815 :: (970) 241-8709 <mark>าsulting Engin</mark>€ I & Electrical Endin 386 Ind Grand , Phone:  $\odot$ **E** >Ο  $\mathbf{\mathcal{L}}$ REEK  $\mathbf{O}$ NO A  $\geq$ 805 ()  $\overline{}$ REVIEWED FOR CODE COMPLIANCE 12/07/2022 DATE: ISSUED FOR: 06/17/2022 PERMIT \_\_\_\_\_DN 09/07/2022 PERMIT CORRECTIONS 06/17/2022 DATE: JOB NO: 21-276 DRAWN BY: BCE BCE CHECKED BY: SCALE: AS SHOWN SHEET NUMBER: E2-4 September 08, 2022 - 9:40:39am

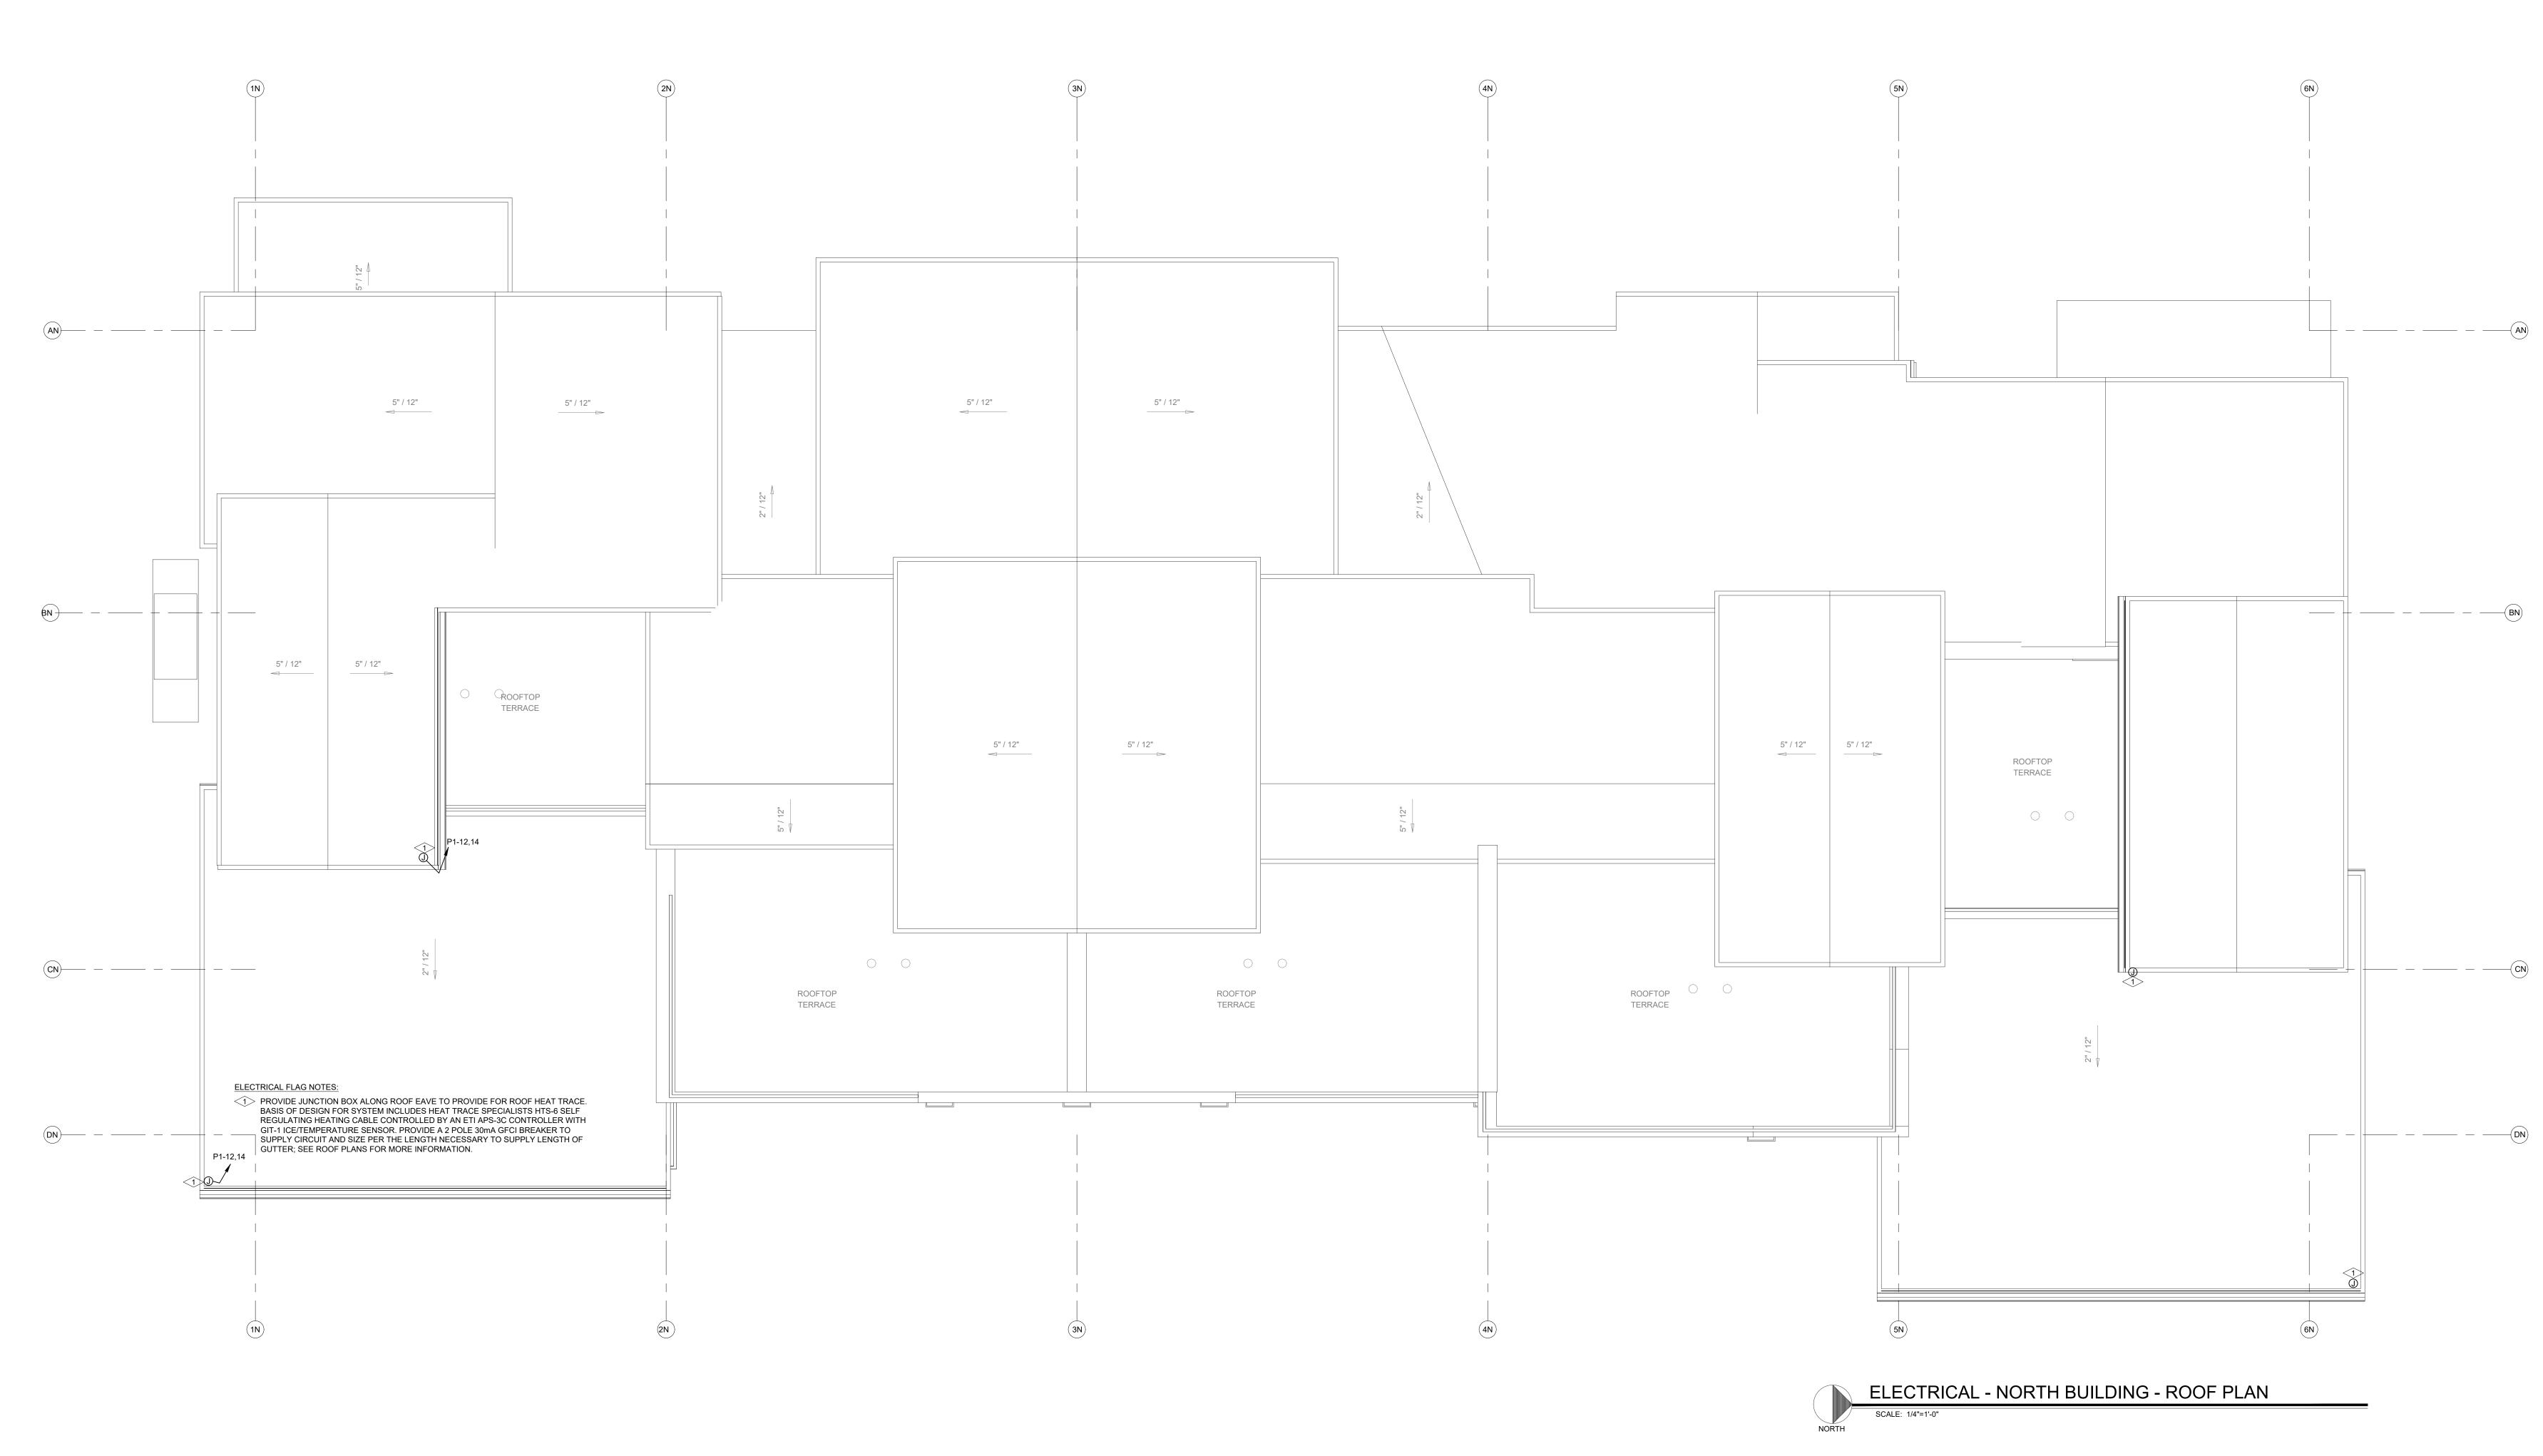

DO NOT REPRODUCE THESE DRAWINGS AND SPECIFICATIONS WITHOUT THE EXPRESSED WRITTEN PERMISSION OF THE DESIGNER. THE DRAWINGS AND SPECIFICATIONS ARE INSTRUMENTS OF THE SERVICE AND SHALL REMAIN THE PROPERTY OF THE DESIGNER WHETHER THE PROJECT FOR WHICH THEY ARE MADE IS EXECUTED OR NOT. THESE DRAWINGS AND SPECIFICATIONS SHALL NOT BE USED BY ANYONE ON ANY OTHER PROJECTS FOR ADDITIONS TO THIS PROJECT BY OTHERS EXCEPT BY THE EXPRESSED WRITTEN PERMISSION OF THE DESIGNER. U U dian Road Junction, CO 815 :: (970) 241-8709 sulting Engine & I & Electrical Endin 386 Ind Grand , Phone:  $\odot$ R Ē  $\square$ 4 O Ŷ CREEK ()NO S WAL 1805 Ω. REVIEWED FOR CODE \_\_\_\_\_CN COMPLIANCE 12/07/2022 DATE: ISSUED FOR: 06/17/2022 PERMIT 09/07/2022 PERMIT CORRECTIONS 06/17/2022 DATE: JOB NO: 21-276 DRAWN BY: BCE BCE CHECKED BY: SCALE: AS SHOWN SHEET NUMBER: E2-5 September 08, 2022 - 9:40:40am

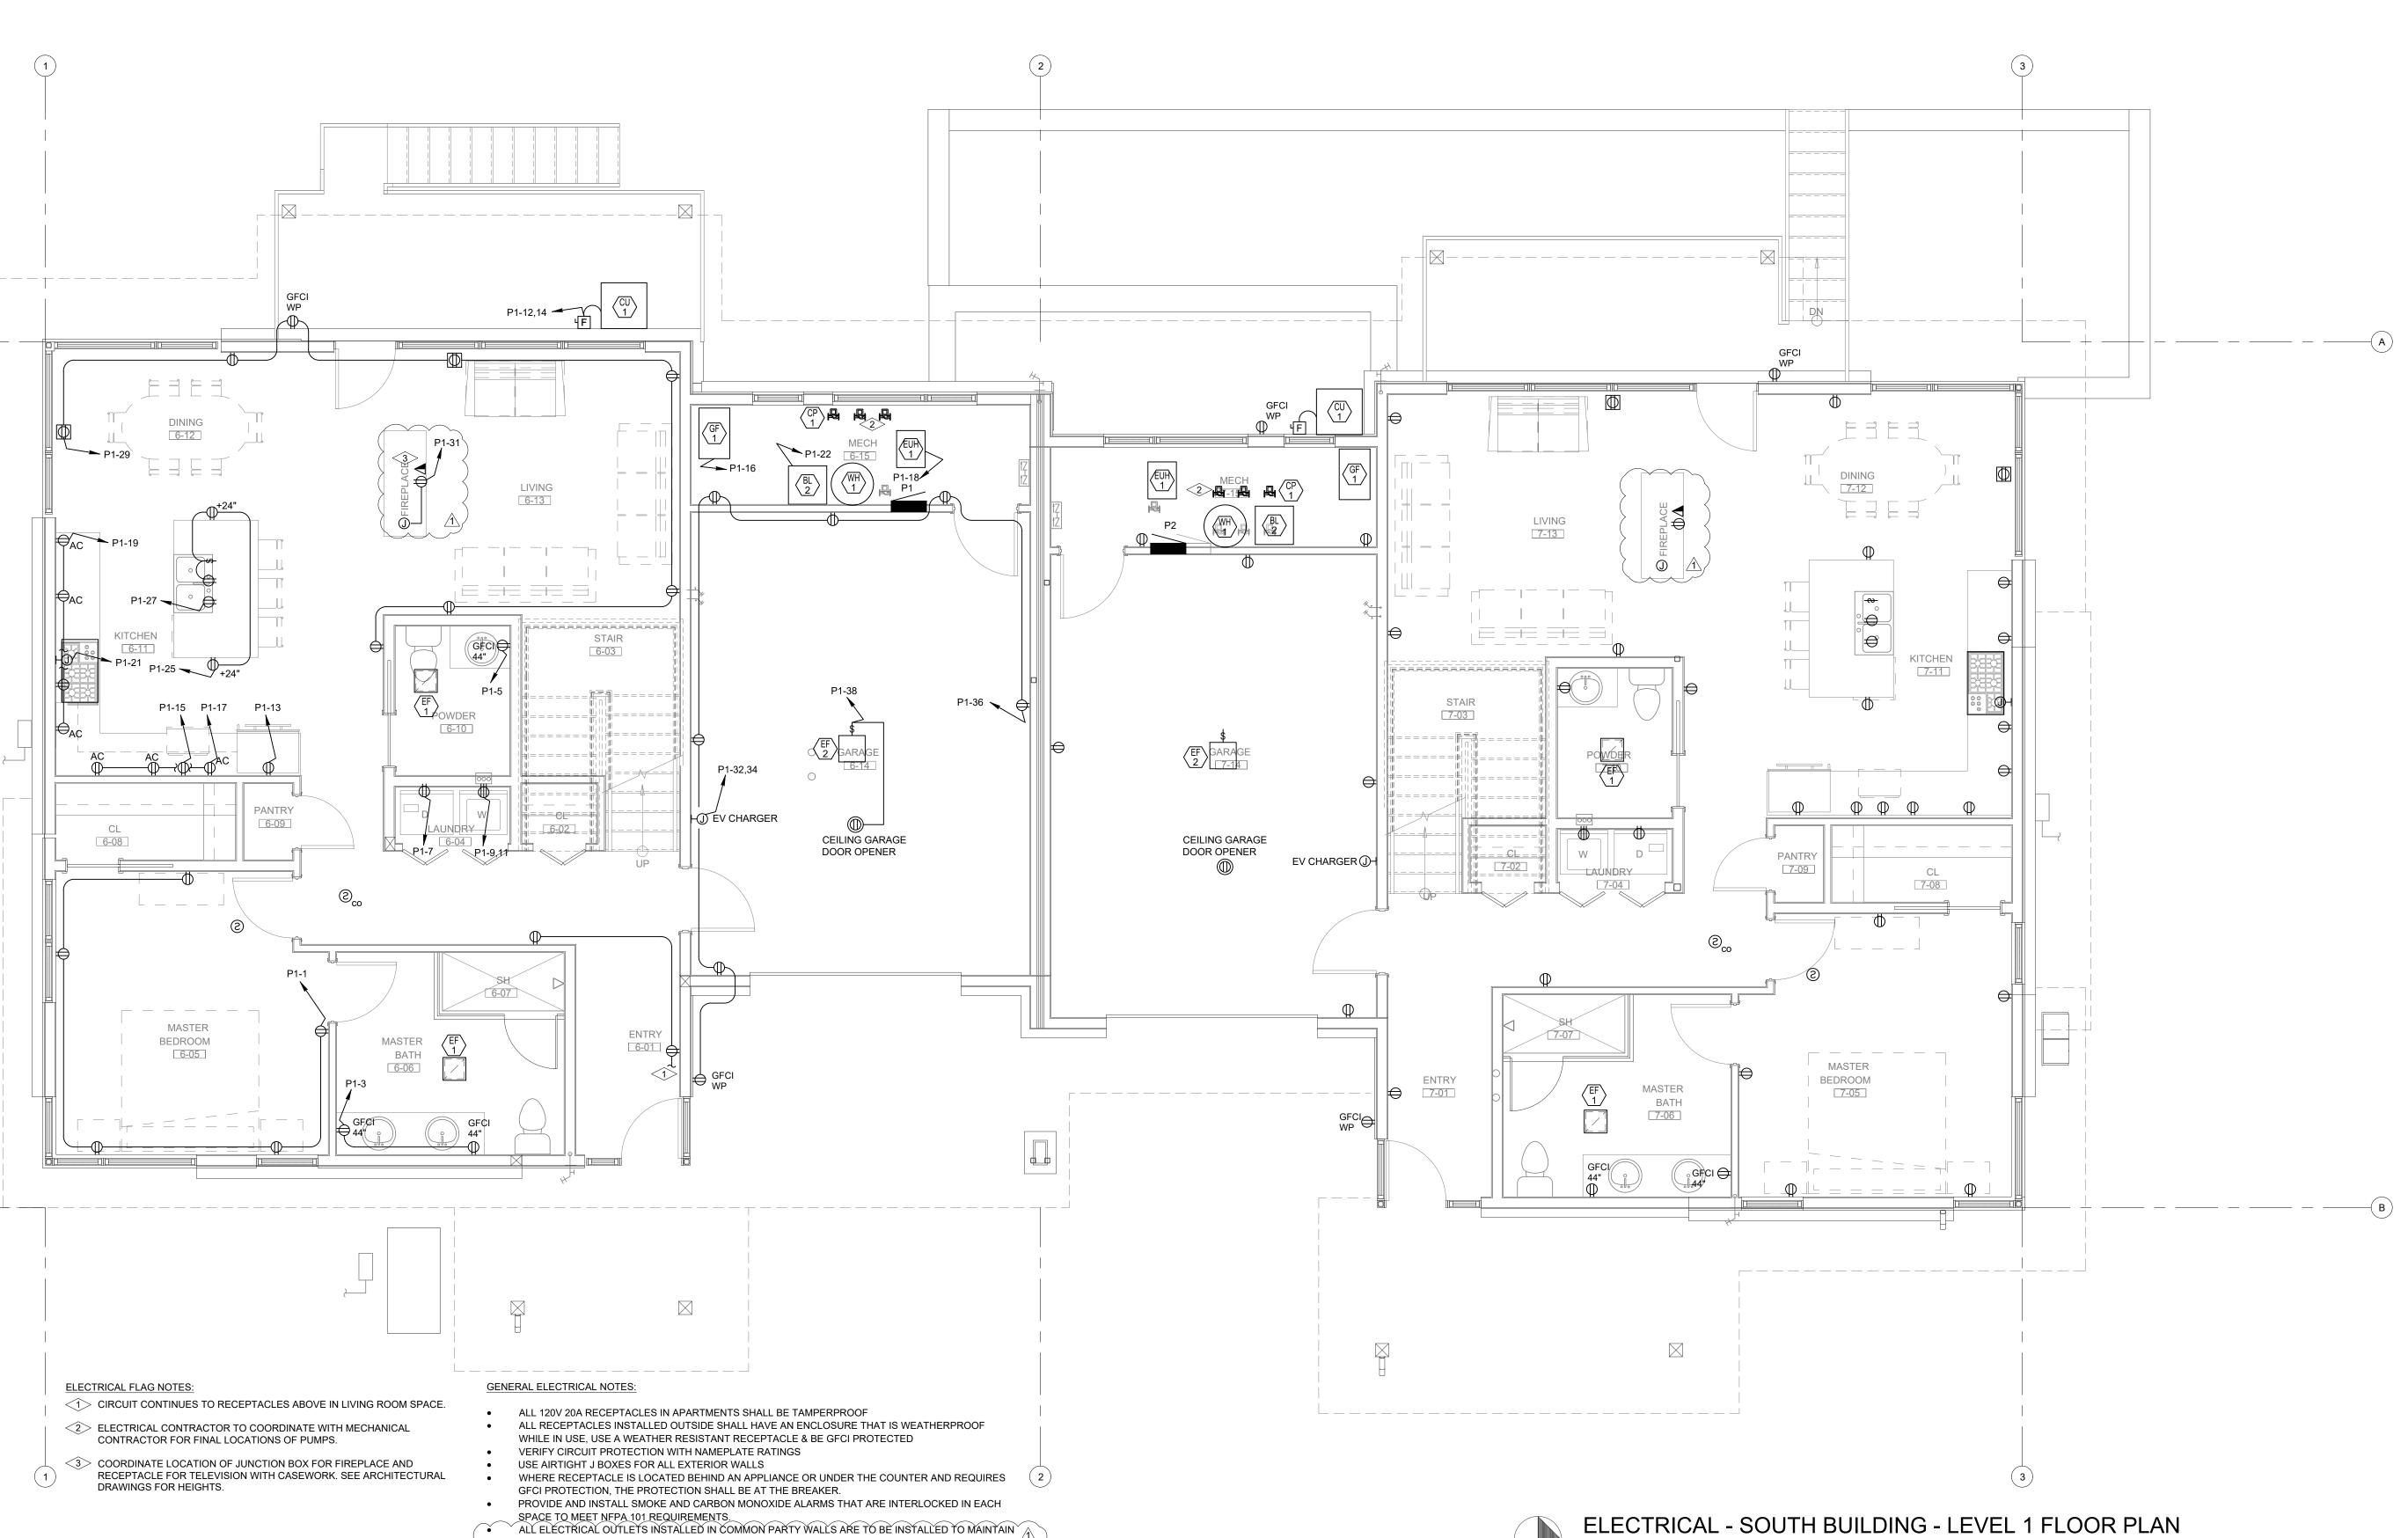

SCALE: 1/4"=1'-0"


NORTH

(B)-----

DO NOT REPRODUCE THESE DRAWINGS AND DO NOT REPRODUCE THESE DRAWINGS AND SPECIFICATIONS WITHOUT THE EXPRESSED WRITTEN PERMISSION OF THE DESIGNER. THE DRAWINGS AND SPECIFICATIONS ARE INSTRUMENTS OF THE SERVICE AND SHALL REMAIN THE PROPERTY OF THE DESIGNER WHETHER THE PROJECT FOR WHICH THEY ARE MADE IS EXECUTED OR NOT. THESE DRAWINGS AND SPECIFICATIONS SHALL NOT BE USED BY ANYONE ON ANY OTHER PROJECTS FOR ADDITIONS TO THIS PROJECT BY OTHERS EXCEPT BY THE EXPRESSED WRITTEN PERMISSION OF THE DESIGNER. 0 dian Road Junction, CO 815 :: (970) 241-8709 sulting Engine & I & Electrical בחמיי 386 Ind Grand , Phone: S. AD RO CREEK TON **WAL** 1805 ່ທ REVIEWED FOR CODE COMPLIANCE 12/07/2022 DATE: ISSUED FOR: 06/17/2022 PERMI PERMIT 09/07/2022 PERMIT CORRECTIONS 06/17/2022 DATE: JOB NO: 21-276 DRAWN BY: BCE BCE CHECKED BY: SCALE: AS SHOWN SHEET NUMBER: E2-6 September 08, 2022 - 9:40:40am

—(в)


<sup>•</sup> ALL ELECTRICAL OUTLETS INSTALLED IN COMMON PARTY WALLS ARE TO BE INSTALLED TO MAINTAIN THE RATING OF THE MEMBRANE; REFERENCE 2018 IRC R302.4.

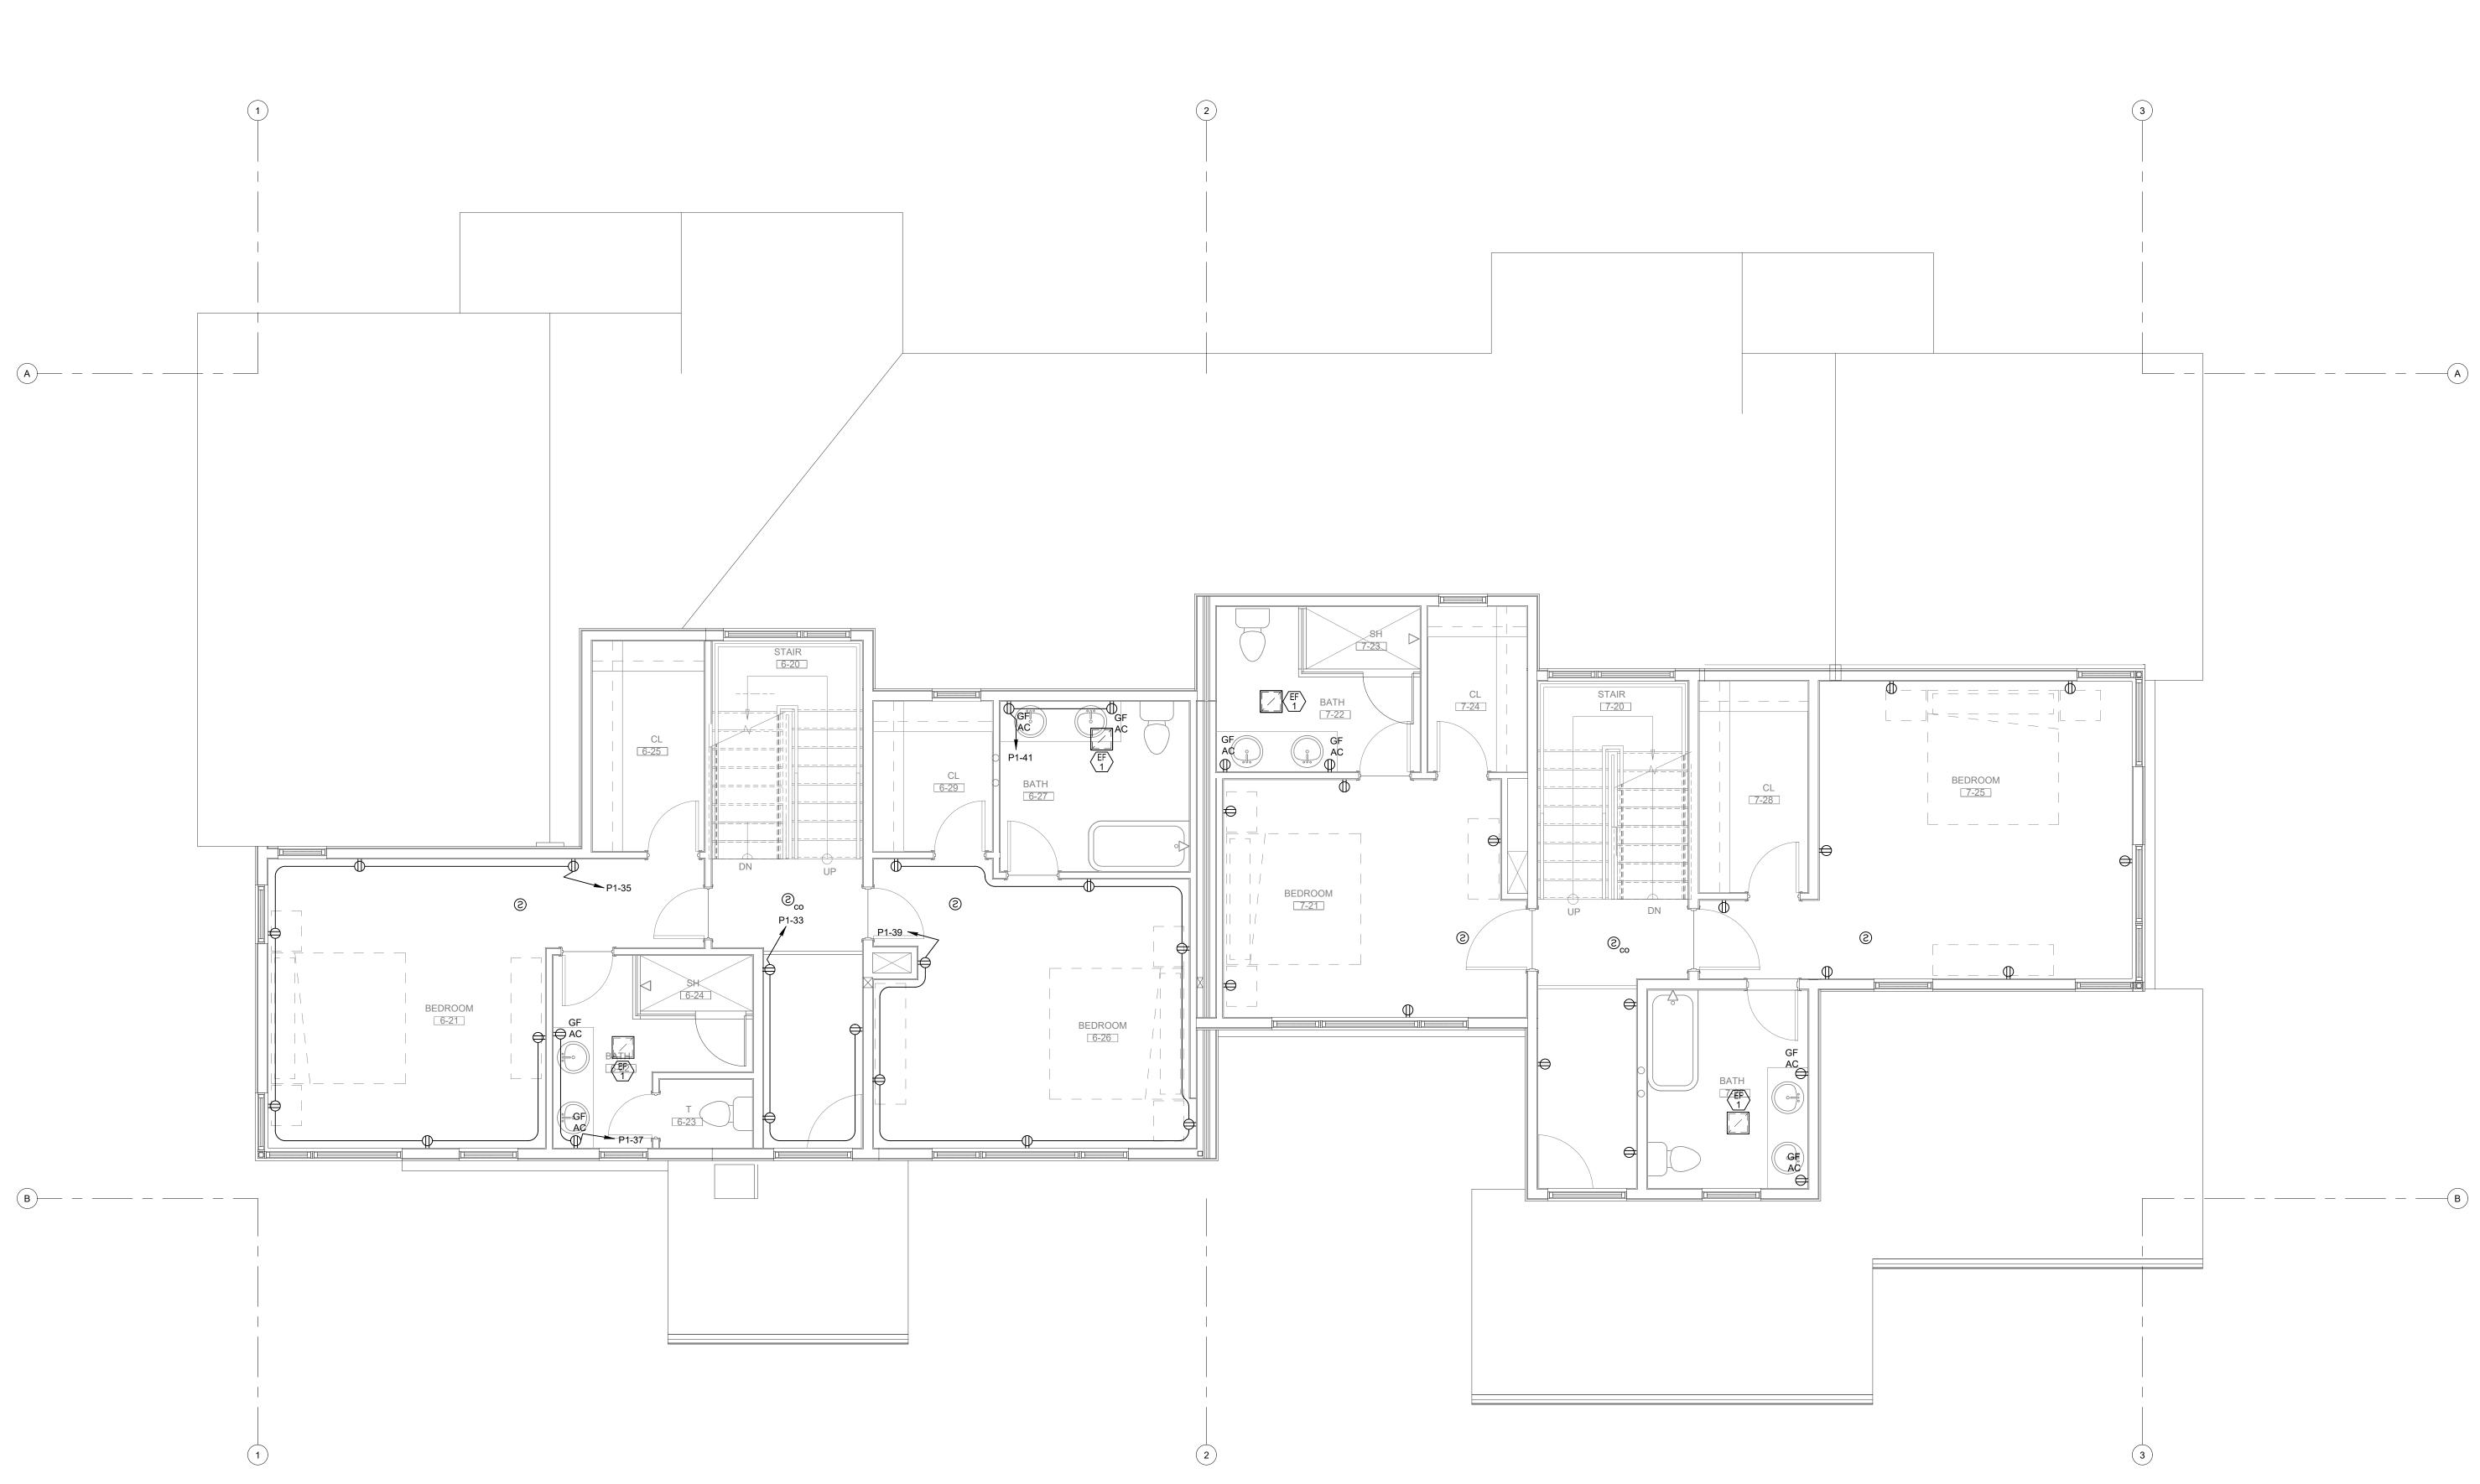


ELECTRICAL - SOUTH BUILDING - LEVEL 2 FLOOR PLAN SCALE: 1/4"=1'-0"

DO NOT REPRODUCE THESE DRAWINGS AND SPECIFICATIONS WITHOUT THE EXPRESSED WRITTEN PERMISSION OF THE DESIGNER. THE DRAWINGS AND SPECIFICATIONS ARE INSTRUMENTS OF THE SERVICE AND SHALL REMAIN THE PROPERTY OF THE DESIGNER WHETHER THE PROJECT FOR WHICH THEY ARE MADE IS EXECUTED OR NOT. THESE DRAWINGS AND SPECIFICATIONS SHALL NOT BE USED BY ANYONE ON ANY OTHER PROJECTS FOR ADDITIONS TO THIS PROJECT BY OTHERS EXCEPT BY THE EXPRESSED WRITTEN PERMISSION OF THE DESIGNER. Inc S 386 Indian Road Grand Junction, CO 815 Phone: (970) 241-8709 sulting Engine & Electrical Engine 0 Ŏ  $\overline{}$ Real Provide American Street horn Big ROAD CREEK ()WALTON ഗ ш 1805 ST REVIEWED FOR CODE COMPLIANCE 12/07/2022 DATE: ISSUED FOR: 06/17/2022 PERMIT 09/07/2022 PERMIT CORRECTIONS 06/17/2022 DATE: JOB NO: 21-276 DRAWN BY: BCE BCE CHECKED BY: SCALE: AS SHOWN SHEET NUMBER: E2-7 September 08, 2022 - 9:40:41am



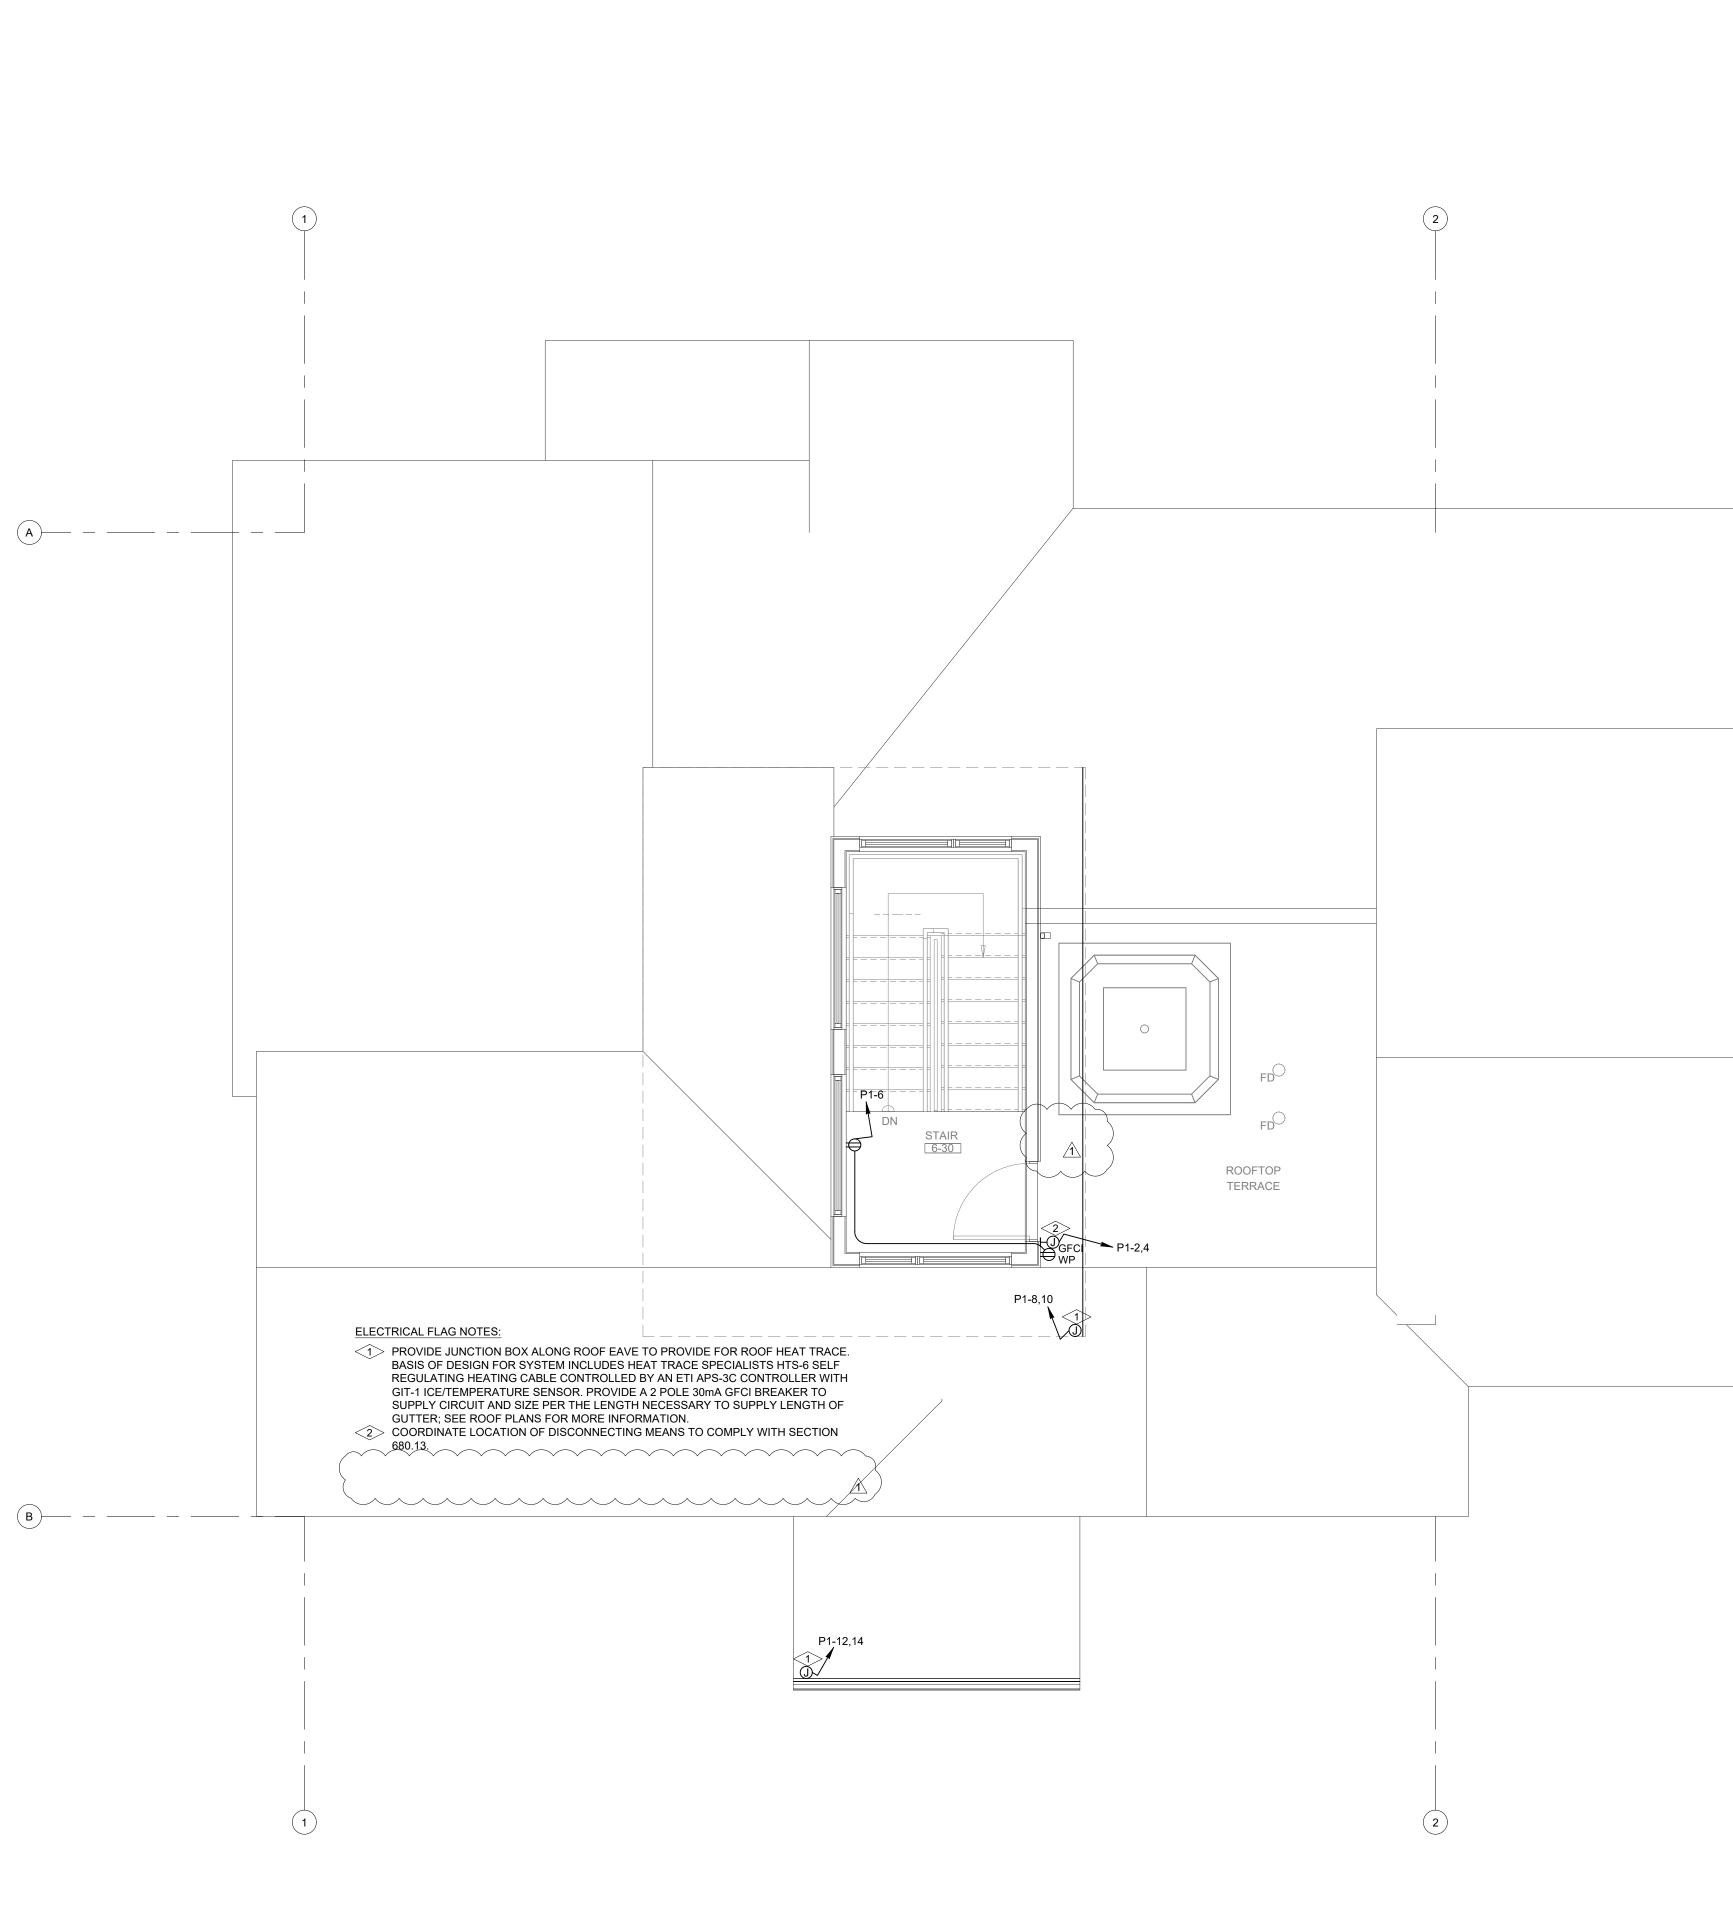

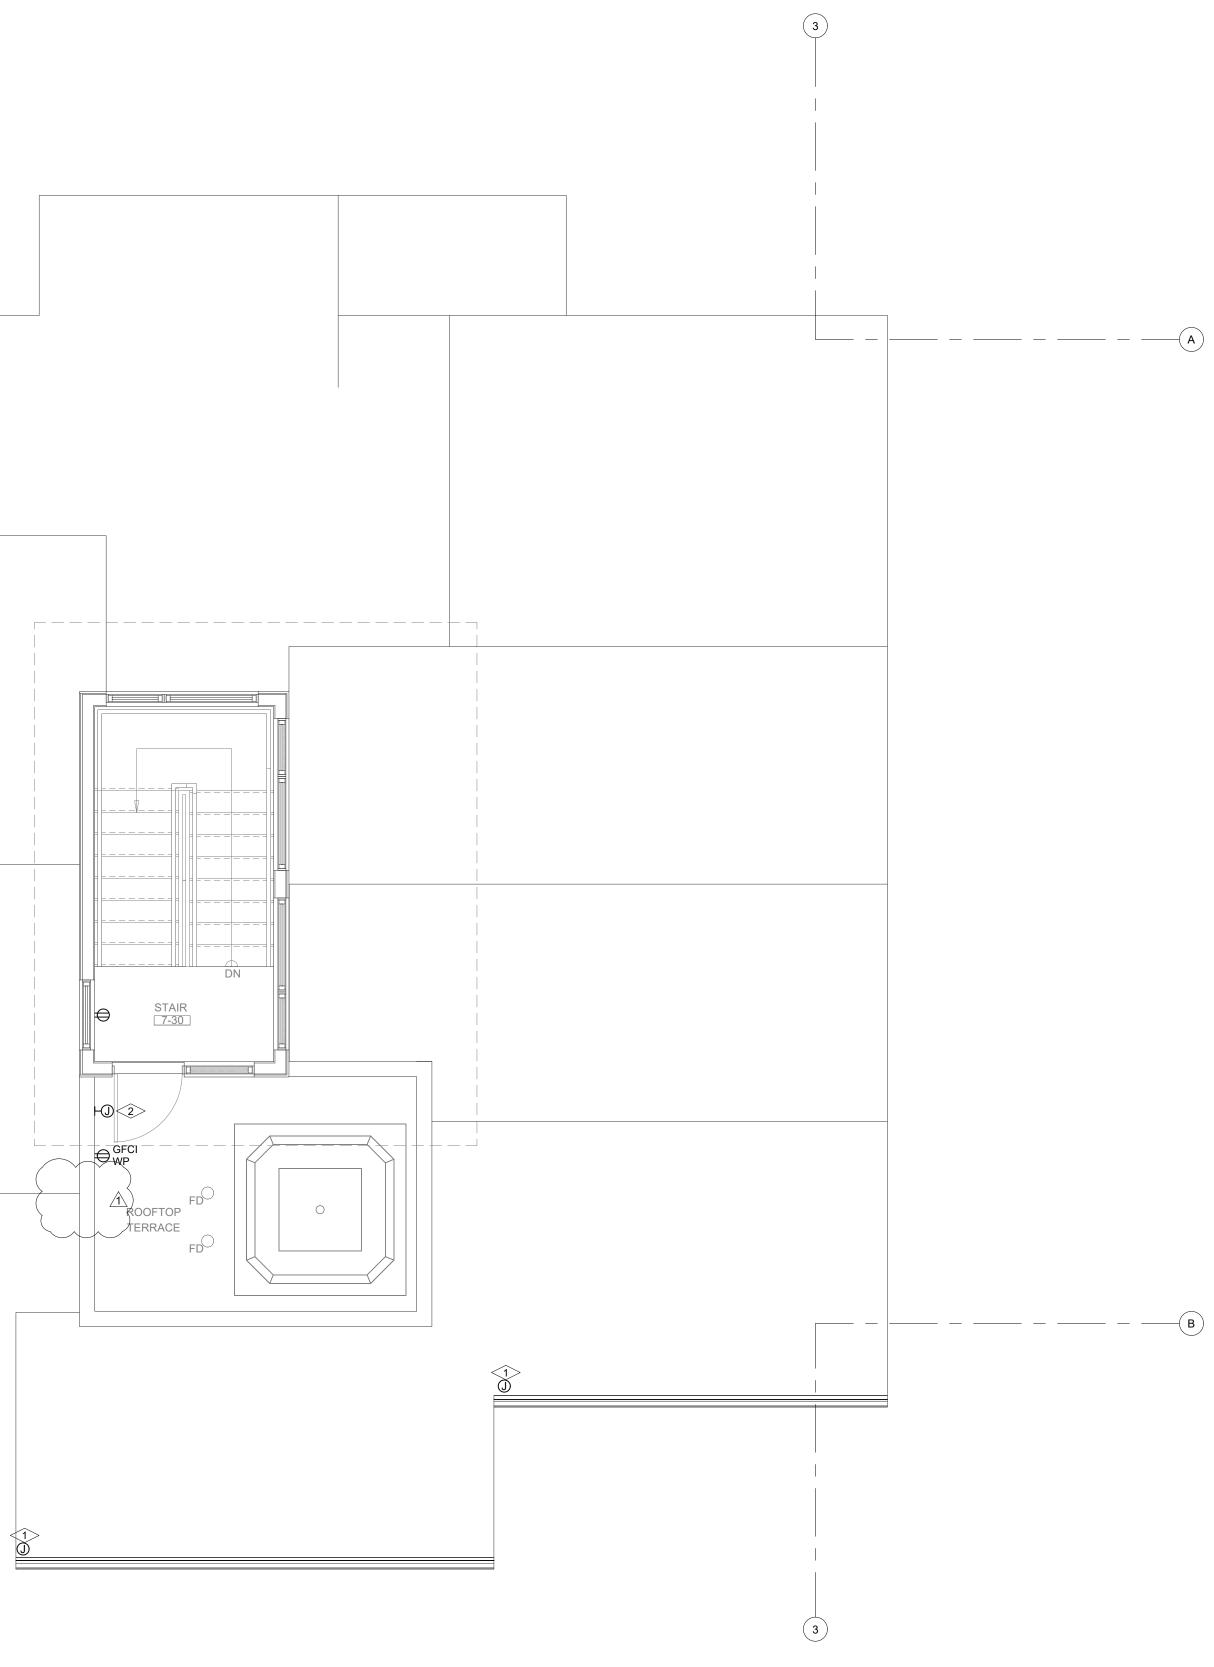

NORTH

ELECTRICAL - SOUTH BUILDING - LEVEL 3 FLOOR PLAN SCALE: 1/4"=1'-0"


DO NOT REPRODUCE THESE DRAWINGS AND SPECIFICATIONS WITHOUT THE EXPRESSED WRITTEN PERMISSION OF THE DESIGNER. THE DRAWINGS AND SPECIFICATIONS ARE INSTRUMENTS OF THE SERVICE AND SHALL REMAIN THE PROPERTY OF THE SERVICE AND SHALL REMAIN THE PROPERTY OF THE DESIGNER WHETHER THE PROJECT FOR WHICH THEY ARE MADE IS EXECUTED OR NOT. THESE DRAWINGS AND SPECIFICATIONS SHALL NOT BE USED BY ANYONE ON ANY OTHER PROJECTS FOR ADDITIONS TO THIS PROJECT BY OTHERS EXCEPT BY THE EXPRESSED WRITTEN PERMISSION OF THE DESIGNER. Inc S 386 Indian Road Grand Junction, CO 815( Phone: (970) 241-8709 sulting Engine & Electrical Engine 0 Ŭ  $\overline{}$ R C Ē  $\square$  $\triangleleft$ O Ŷ CREEK ()NO S AL  $\leq$ 805 . S **~** REVIEWED FOR CODE COMPLIANCE 12/07/2022 DATE: ISSUED FOR: 06/17/2022 PERMIT \_\_\_\_ 09/07/2022 PERMIT CORRECTIONS 06/17/2022 ( DATE: JOB NO: 21-276 DRAWN BY: BCE BCE CHECKED BY: SCALE: AS SHOWN SHEET NUMBER: E2-8 September 08, 2022 - 9:40:42am


	PANEL SCHEDULE	- P1 TYPE: VOLTAGE: ENCLOSURE:	LOADCENTER 120/240 NEMA1	BUS S MAIN MOUN	BRKR:	225 NONE FLUSH		PHASES: 1 WIRES: 3 SC RATING: 10000	NEUTRAL BUS: YES GROUND BUS: YES		
Residential Calculation - Village Drive North	LOAD TYPE	LOAD DESCRIPTION	AMPS POLES	CKT# LOAD	۵	CKT# LOAD	AMPS POLES	LOAD TYPE	LOAD DESCRIPTION		
2020 NFPA 70 ART. 220 PART III 2020 NEC 220.14(J), 220.42 & 220.52	RECEPTACLE	RCPT - MAST. BED	20A 1P	1	A	2	30A	MECH YEAR ROUND	CU-1 - HEAT PUMP		
371 SQFT Garage Level 1014 SQFT Main Level	RECEPTACLE	CAFCI RCPT - MAST. BATH	20A	1440 3	В	2880 4	2P 	MECH YEAR ROUND	HACR		
686 SQFT Upper Level 136 SQFT Upper Stairwell	RECEPTACLE	 RCPT - POWDER ROOM	1P 20A	500 5	A	2880 6	 50A	MISCELLANEOUS	SPA - ROOF		
2207 SQFT General Lighting Load     6621 VA       2 CCT Small Appliance     3000 VA	MISCELLANEOUS	 WASHER	1P 20A	300 7	В	4800 8	2P	MISCELLANEOUS			
1 CCT Laundry Circuit         1500 VA           Total General Load:         11121 VA	MISCELLANEOUS	CAFCI/GFCI 5mA DRYER	1P 20A	1500 9	A	4800 10	 20A	RECEPTACLE	 RCPT - ROOF		
3000 VA @ 100% 3000 VA 8121 VA @ 35% 2842.35 VA	SPACE	CAFCI/GFCI 5mA	1P	1200 11	В	180 12	1P 20A	MECH HEATING	GUTTER HEAT TRACE		
General Lighting Load: 5842 VA				0		1000	2P		GFCI 30mA		
2020 NEC 220.51 and 220.60       Cooling Loads	APPLIANCE	FRIDGE CAFCI	15A 1P	13 600	A	14 1000		MECH HEATING			
Equipment PowerEquipmentPowerCU Heat P5760 VACU Heat Pump5760 VA	APPLIANCE	MICROWAVE DRAWER CAFCI	20A 1P	15 1500	В	16 20	1A 1P	MECH HEATING	EUH-1 - UNIT HEATER 		
Gutter Heat trace       1200 VA * See unit plans         EUH - Garage Unit Heat       1500 VA         10860 VA Heating Loads	RECEPTACLE	RCPT - KITCHEN COUNTER CAFCI/GFCI 5mA	20A 1P	17 1500	A	18 20	1A 1P	MECH YEAR ROUND	BL-1 BOILER 		
Radiant Pumps         2400 VA         5760 VA Cooling Loads           Connected: 10860 VA Greater of Noncoincidental Loads: 10860 VA	RECEPTACLE	RCPT - KITCHEN COUNTER CAFCI/GFCI 5mA	20A 1P	19 1500	В	20 1500	20A 1P	MOTOR	CP1/3-BOILER/LOOP PUMP 		
2020 NEC 220.53	APPLIANCE	GAS RANGE/HOOD CAFCI	20A 1P	21 1500	A	22 1500	20A 1P	MOTOR	CP2/7- WATER HEATER/DOMESTIC		
Appliance Loads Load Each 1 Refrigerator 600 VA 1 Dishwasher 1200 VA	SPACE			23 0	В	24 1500	20A 1P	MOTOR	CP4/6 - SNOWMELT / LOOP		
1 Disposal 1 Microwave 1 200 VA 1 Microwave 1 200 VA	RECEPTACLE	RCPT - ISLAND COUNTER CAFCI/GFCI 5mA	20A 1P	25 1500	A	26 1500	20A 1P	MOTOR	CP6/7-RADIANT/LOOP		
1 Gas Range/ Hood     1000 VA       4900 VA @ 75%     Appliance Load: 3675 VA	APPLIANCE	DISHWASHER CAFCI/GFCI 5mA	20A 1P	27 1200	В	28 1200	20A 1P	MISCELLANEOUS	HUMIDIFIER CAFCI/GFCI 5mA		
2020 NEC 220.14(A)	RECEPTACLE	RCPT - LIVING/DINING	20A	29	A	30	40A	MISCELLANEOUS	EVC - GARAGE		
QTY Description Load Each	RECEPTACLE	CAFCI RCPT - FIREPLACE/TV	1P 20A	1260 31	В	3500 32	2P 	MISCELLANEOUS			
1 Boiler 1440 VA 2 Circ Pumps 720 VA	RECEPTACLE	CAFCI RCPT - BEDROOM E	1P 20A	1200 33	A	3500 34	 20A	RECEPTACLE	 RCPT - GARAGE		
1 Gas Dryer     1200 VA       1 Hot Tub     9600 VA	RECEPTACLE	CAFCI RCPT - 3RD BATH E	1P 20A	1080 35	В	1500 36	1P 20A	RECEPTACLE	GFCI 5mA RCPT - GARAGE		
1 EVC Level II     7200 VA     125% LARGEST MOTOR: 480 VA       22080 VA     Total Other Load: 22560 VA	RECEPTACLE	 RCPT - BEDROOM W	1P 20A	500 37	A	1500 38	1P	SPACE	GFCI 5mA		
240 V Connected: 49441 VA Demand: 42937 VA	RECEPTACLE	CAFCI RCPT - 3RD BATH W	1P	1080		0		SPACE			
1 Ø 206.0 A 178.9 A			20A 1P	39 500	В	40 0		SPACE			
	PANEL SCHEDULE		LOADCENTER	BUS S		400		PHASES: 1	NEUTRAL BUS: YES		
		VOLTAGE: ENCLOSURE:	120/240 NEMA1	MAIN MOUN	BRKR:	NONE FLUSH		WIRES: 3 SC RATING: 10000	GROUND BUS: YES		
	PANEL SCHEDULE	VOLTAGE:	120/240	MAIN MOUN	BRKR:	NONE	AMPS POLES	WIRES: 3	GROUND BUS: YES		
Residential Calculation - Village Drive South		VOLTAGE: ENCLOSURE:	120/240 NEMA1 AMPS	MAIN MOUN CKT#	BRKR: ITING:	NONE FLUSH CKT#	AMPS	WIRES: 3 SC RATING: 10000	GROUND BUS: YES		
2020 NFPA 70 ART. 220 PART III	LOAD TYPE	VOLTAGE: ENCLOSURE: LOAD DESCRIPTION RCPT - MAST. BED	120/240 NEMA1 AMPS POLES 20A	MAIN MOUN CKT# LOAD	BRKR: ITING: D	NONE FLUSH CKT# LOAD 2	AMPS POLES 50A	WIRES: 3 SC RATING: 10000 LOAD TYPE	GROUND BUS: YES		
2020 NFPA 70 ART. 220 PART III 2020 NEC 220.14(J), 220.42 & 220.52 1286 SQFT Garage Level	LOAD TYPE RECEPTACLE	VOLTAGE: ENCLOSURE: LOAD DESCRIPTION RCPT - MAST. BED CAFCI	120/240 NEMA1 AMPS POLES 20A 1P 20A	MAIN MOUN CKT# LOAD 1 1440 3	BRKR: ITING: D A	NONE FLUSH CKT# LOAD 2 4800 4	AMPS POLES 50A 2P	WIRES: 3 SC RATING: 10000 LOAD TYPE MISCELLANEOUS	GROUND BUS: YES LOAD DESCRIPTION SPA - ROOF		
2020 NFPA 70 ART. 220 PART III 2020 NEC 220.14(J), 220.42 & 220.52 1286 SQFT Garage Level 1018 SQFT Upper Level 136 SQFT Upper Stairwell	LOAD TYPE RECEPTACLE RECEPTACLE	VOLTAGE: ENCLOSURE: LOAD DESCRIPTION RCPT - MAST. BED CAFCI RCPT - MAST. BATH  RCPT - POWDER ROOM  WASHER	120/240 NEMA1AMPS POLES20A 1P20A 1P20A 20A 1P20A 20A	MAIN MOUN CKT# LOAD 1 1440 3 500 5 300 7	BRKR: ITING: D A B	NONE FLUSH CKT# LOAD 2 4800 4 4800 6 180 8	AMPS POLES 50A 2P   20A 1P 20A	WIRES: 3 SC RATING: 10000 LOAD TYPE MISCELLANEOUS MISCELLANEOUS	GROUND BUS: YES LOAD DESCRIPTION SPA - ROOF   RCPT - ROOF  GUTTER HEAT TRACE		
2020 NFPA 70 ART. 220 PART III 2020 NEC 220.14(J), 220.42 & 220.52 1286 SQFT Garage Level 1018 SQFT Upper Level 136 SQFT Upper Stairwell 2440 SQFT General Lighting Load 2 CCT Small Appliance 3000 VA	LOAD TYPE RECEPTACLE RECEPTACLE RECEPTACLE	VOLTAGE: ENCLOSURE: LOAD DESCRIPTION RCPT - MAST. BED CAFCI RCPT - MAST. BATH  RCPT - POWDER ROOM  WASHER CAFCI/GFCI 5mA DRYER	120/240       NEMA1       AMPS       POLES       20A       1P       20A       20A       20A       20A       20A       20A       20A       20A	MAIN MOUN CKT# LOAD 1 1440 3 500 5 300 7 1500 9	BRKR: ITING: A B A	NONE FLUSH CKT# LOAD 2 4800 4 4800 6 180 8 1000 10	AMPS POLES 50A 2P  20A 1P 20A 2P 	WIRES: 3 SC RATING: 10000 LOAD TYPE MISCELLANEOUS MISCELLANEOUS RECEPTACLE	GROUND BUS: YES LOAD DESCRIPTION SPA - ROOF   RCPT - ROOF 		
2020 NFPA 70 ART. 220 PART III 2020 NEC 220.14(J), 220.42 & 220.52 1286 SQFT Garage Level 1018 SQFT Upper Level 136 SQFT Upper Stairwell 2440 SQFT General Lighting Load 7320 VA 2 CCT Small Appliance 3000 VA 1 CCT Laundry Circuit 1500 VA Total General Load: 11820 VA	LOAD TYPE RECEPTACLE RECEPTACLE RECEPTACLE MISCELLANEOUS	VOLTAGE: ENCLOSURE: LOAD DESCRIPTION RCPT - MAST. BED CAFCI RCPT - MAST. BATH  RCPT - POWDER ROOM  WASHER CAFCI/GFCI 5mA DRYER CAFCI/GFCI 5mA 	120/240         NEMA1         AMPS         POLES         20A         1P           20A          20A          20A	MAIN MOUN CKT# LOAD 1 1440 3 500 5 300 5 300 7 1500 9 1200 11	BRKR: ITING: A B A B B B	NONE FLUSH           CKT# LOAD           2           4800           4           4800           6           180           8           1000           10           1000           12	AMPS POLES 50A 2P  20A 1P 20A 2P  20A 2P  30A	WIRES: 3 SC RATING: 10000 LOAD TYPE MISCELLANEOUS MISCELLANEOUS RECEPTACLE MECH HEATING	GROUND BUS: YES LOAD DESCRIPTION SPA - ROOF   RCPT - ROOF  GUTTER HEAT TRACE GFCI 30mA  CU-1 - CONDENSING UNIT		
2020 NFPA 70 ART. 220 PART III 2020 NEC 220.14(J), 220.42 & 220.52 1286 SQFT Garage Level 1018 SQFT Upper Level 136 SQFT Upper Stairwell 2440 SQFT General Lighting Load 7320 VA 2 CCT Small Appliance 3000 VA 1 CCT Laundry Circuit 1500 VA	LOAD TYPE RECEPTACLE RECEPTACLE RECEPTACLE MISCELLANEOUS MISCELLANEOUS	VOLTAGE: ENCLOSURE: LOAD DESCRIPTION RCPT - MAST. BED CAFCI RCPT - MAST. BATH  RCPT - POWDER ROOM  WASHER CAFCI/GFCI 5mA DRYER CAFCI/GFCI 5mA  FRIDGE	120/240         NEMA1         AMPS         POLES         20A         1P         1P         1A	MAIN MOUN CKT# LOAD 1 1440 3 500 5 300 7 1500 9 1200 11 0 13	BRKR: ITING: A A B A B A A	NONE FLUSH CKT# LOAD 2 4800 4 4800 6 180 8 1000 10 1000 10 1000 12 2496 14	AMPS POLES 50A 2P  20A 1P 20A 2P  30A 2P  30A 2P 	WIRES: 3 SC RATING: 10000 LOAD TYPE MISCELLANEOUS MISCELLANEOUS RECEPTACLE MECH HEATING MECH HEATING	GROUND BUS: YES LOAD DESCRIPTION SPA - ROOF   RCPT - ROOF  GUTTER HEAT TRACE GFCI 30mA   CU-1 - CONDENSING UNIT 		
2020 NFPA 70 ART. 220 PART III 2020 NEC 220.14(J), 220.42 & 220.52 1286 SQFT Garage Level 1018 SQFT Upper Level 136 SQFT Upper Stairwell 2440 SQFT General Lighting Load 2 CCT Small Appliance 3000 VA 1 CCT Laundry Circuit Total General Load: 11820 VA 3000 VA @ 100% 3000 VA	LOAD TYPE RECEPTACLE RECEPTACLE RECEPTACLE MISCELLANEOUS MISCELLANEOUS SPACE	VOLTAGE: ENCLOSURE: LOAD DESCRIPTION RCPT - MAST. BED CAFCI RCPT - MAST. BATH  RCPT - POWDER ROOM  WASHER CAFCI/GFCI 5mA DRYER CAFCI/GFCI 5mA DRYER CAFCI/GFCI 5mA  FRIDGE CAFCI FRIDGE CAFCI	120/240         NEMA1         AMPS         POLES         20A         1P         20A         20A         20A	MAIN MOUN CKT# LOAD 1 1440 3 500 5 300 5 300 7 1500 9 1200 11 0 13 600 15	BRKR: ITING: A A B A B A B B B B	NONE FLUSH           CKT# LOAD           2           4800           4           4800           6           180           8           1000           12           2496           14           2496           16	AMPS POLES 50A 2P  20A 1P 20A 2P  30A 2P  30A 2P  20A	WIRES:3 10000LOAD TYPEMISCELLANEOUSMISCELLANEOUSRECEPTACLEMECH HEATINGMECH COOLING	GROUND BUS: YES LOAD DESCRIPTION SPA - ROOF   RCPT - ROOF  GUTTER HEAT TRACE GFCI 30mA   CU-1 - CONDENSING UNIT		
2020 NFPA 70 ART. 220 PART III 2020 NEC 220.14(J), 220.42 & 220.52 1286 SQFT Garage Level 1018 SQFT Upper Level 136 SQFT Upper Stairwell 2440 SQFT General Lighting Load 7320 VA 2 CCT Small Appliance 3000 VA 1 CCT Laundry Circuit 1500 VA Total General Load: 11820 VA 3000 VA @ 100% 3000 VA 8820 VA @ 35% 3087 VA General Lighting Load: 6087 VA 2020 NEC 220.51 and 220.60 Cooling Loads Heating Loads	LOAD TYPE RECEPTACLE RECEPTACLE RECEPTACLE MISCELLANEOUS MISCELLANEOUS SPACE APPLIANCE	VOLTAGE: ENCLOSURE: LOAD DESCRIPTION RCPT - MAST. BED CAFCI RCPT - MAST. BATH  RCPT - POWDER ROOM  WASHER CAFCI/GFCI 5mA DRYER CAFCI/GFCI 5mA  FRIDGE CAFCI	120/240         NEMA1         AMPS         POLES         20A         1P         2D         1P	MAIN MOUN CKT# LOAD 1 1440 3 500 5 300 7 1500 9 1200 11 0 13 600	BRKR: ITING: A A B A B A B A A A	NONE FLUSH           CKT# LOAD           2           4800           4           4800           6           180           8           1000           12           2496           14           2496	AMPS POLES 50A 2P  20A 1P 20A 2P  30A 2P  30A 2P	WIRES: 3 SC RATING: 10000 LOAD TYPE MISCELLANEOUS MISCELLANEOUS RECEPTACLE MECH HEATING MECH HEATING MECH COOLING MECH COOLING	GROUND BUS: YES LOAD DESCRIPTION SPA - ROOF   RCPT - ROOF  GUTTER HEAT TRACE GFCI 30mA   CU-1 - CONDENSING UNIT  		
2020 NFPA 70 ART. 220 PART III 2020 NEC 220.14(J), 220.42 & 220.52 1286 SQFT Garage Level 1018 SQFT Upper Level 136 SQFT Upper Stairwell 2440 SQFT General Lighting Load 7320 VA 2 CCT Small Appliance 3000 VA 1 CCT Laundry Circuit 1500 VA Total General Load: 11820 VA 3000 VA @ 100% 3000 VA 8820 VA @ 35% 3087 VA General Lighting Load: 6087 VA Cooling Loads Heating Loads Equipment Power Equipment Power GF-1 Air 1032 VA GF-1 Gas Furnace 1032 VA	LOAD TYPE RECEPTACLE RECEPTACLE RECEPTACLE MISCELLANEOUS MISCELLANEOUS SPACE APPLIANCE APPLIANCE RECEPTACLE	VOLTAGE: ENCLOSURE: ENCLOSURE: LOAD DESCRIPTION RCPT - MAST. BED CAFCI RCPT - MAST. BATH  RCPT - POWDER ROOM  WASHER CAFCI/GFCI 5mA DRYER CAFCI/GFCI 5mA DRYER CAFCI/GFCI 5mA FRIDGE CAFCI MICROWAVE DRAWER CAFCI RCPT - KITCHEN COUNTER CAFCI/GFCI 5mA	120/240         NEMA1         AMPS         POLES         20A         1P	MAIN MOUN CKT# LOAD 1 1440 3 500 5 300 5 300 7 1500 9 1200 11 0 13 600 15 1500 15 1500 17 1500	BRKR: ITING: A A B A B A B A B A B A A A	NONE FLUSH           CKT# LOAD           2           4800           4           4800           6           180           14           2496           16           1500           18           0	AMPS POLES 50A 2P  20A 1P 20A 2P  30A 2P  30A 2P  20A 1P   20A	WIRES: 3 SC RATING: 10000 LOAD TYPE MISCELLANEOUS MISCELLANEOUS RECEPTACLE MECH HEATING MECH HEATING MECH COOLING MECH COOLING MECH YEAR ROUND SPACE	GROUND BUS: YES LOAD DESCRIPTION SPA - ROOF   RCPT - ROOF  GUTTER HEAT TRACE GFCI 30mA   CU-1 - CONDENSING UNIT   GF1 - GAS FIRED FURNACE 		
2020 NFPA 70 ART. 220 PART III 2020 NEC 220.14(J), 220.42 & 220.52 1286 SQFT Garage Level 1018 SQFT Upper Level 136 SQFT Upper Stairwell 2440 SQFT General Lighting Load 7320 VA 2 CCT Small Appliance 3000 VA 1 CCT Laundry Circuit 1500 VA Total General Load: 11820 VA 3000 VA @ 100% 3000 VA 8820 VA @ 35% 3087 VA General Lighting Load: 6087 VA 2020 NEC 220.51 and 220.60 Cooling Loads Heating Loads Equipment Power Equipment Power	LOAD TYPE RECEPTACLE RECEPTACLE RECEPTACLE MISCELLANEOUS MISCELLANEOUS SPACE APPLIANCE APPLIANCE RECEPTACLE RECEPTACLE	VOLTAGE: ENCLOSURE: ENCLOSURE: LOAD DESCRIPTION RCPT - MAST. BED CAFCI RCPT - MAST. BATH  RCPT - POWDER ROOM  WASHER CAFCI/GFCI 5mA DRYER CAFCI/GFCI 5mA  FRIDGE CAFCI MICROWAVE DRAWER CAFCI MICROWAVE DRAWER CAFCI RCPT - KITCHEN COUNTER CAFCI/GFCI 5mA RCPT - KITCHEN COUNTER CAFCI/GFCI 5mA	120/240         NEMA1         AMPS         POLES         20A         1P	MAIN MOUN CKT# LOAD 1 1440 3 500 5 300 7 1500 9 1200 11 0 13 600 15 1500 15 1500 17 1500 19 1500	BRKR: ITING: A A B A B A B A B A B A B A B A B B A B B A B	NONE FLUSH           CKT# LOAD           2           4800           4           4800           6           180           8           1000           12           2496           14           2496           16           1500           18           0           20           20	AMPS POLES 50A 2P  20A 1P 20A 2P   30A 2P  20A 1P   20A 1P  1A 1P	WIRES: 3 SC RATING: 10000 LOAD TYPE MISCELLANEOUS MISCELLANEOUS RECEPTACLE MECH HEATING MECH HEATING MECH COOLING MECH COOLING MECH YEAR ROUND SPACE MECH HEATING	GROUND BUS: YES LOAD DESCRIPTION SPA - ROOF    RCPT - ROOF  GUTTER HEAT TRACE GFCI 30mA   CU-1 - CONDENSING UNIT   GF1 - GAS FIRED FURNACE   EUH-1 - UNIT HEATER 		
2020 NFPA 70 ART. 220 PART III 2020 NEC 220.14(J), 220.42 & 220.52 1286 SQFT Garage Level 1018 SQFT Upper Level 136 SQFT Upper Stairwell 2440 SQFT General Lighting Load 7320 VA 2 CCT Small Appliance 3000 VA 1 CCT Laundry Circuit 1500 VA Total General Load: 11820 VA 3000 VA @ 100% 3000 VA 8820 VA @ 35% 3087 VA CU AC 220.51 and 220.60 Cooling Loads Heating Loads Equipment Power GF-1 Air 1032 VA CU AC 4800 VA EUH - Garage Unit Heat 1500 VA Gutter Heat Trace 1500 VA CU AC 4800 VA EUH - Garage Unit Heat 1500 VA CU AC 4800 VA EUH - Garage Unit Heat 1500 VA	LOAD TYPE RECEPTACLE RECEPTACLE RECEPTACLE MISCELLANEOUS MISCELLANEOUS SPACE APPLIANCE RECEPTACLE RECEPTACLE RECEPTACLE APPLIANCE	VOLTAGE: ENCLOSURE: ENCLOSURE: LOAD DESCRIPTION RCPT - MAST. BED CAFCI RCPT - MAST. BATH  RCPT - POWDER ROOM  WASHER CAFCI/GFCI 5mA DRYER CAFCI/GFCI 5mA DRYER CAFCI/GFCI 5mA FRIDGE CAFCI MICROWAVE DRAWER CAFCI MICROWAVE DRAWER CAFCI RCPT - KITCHEN COUNTER CAFCI/GFCI 5mA RCPT - KITCHEN COUNTER CAFCI/GFCI 5mA RANGE/HOOD CAFCI	120/240         NEMA1         AMPS         POLES         20A         1P         20A         1P <td>MAIN MOUN CKT# LOAD 1 1440 3 500 5 300 7 1500 9 1200 11 0 13 600 15 1500 15 1500 17 1500 17 1500 19 1500 21 1500</td> <td>BRKR: JTING: A A B A B A B A B A B A B A B A A B A A A A</td> <td>NONE FLUSH           CKT# LOAD           2           4800           4           4800           6           180           220           20           20           20           20           20           20           20           20           20           20           20           20</td> <td>AMPS POLES 50A 2P  20A 1P 20A 2P  30A 2P  20A 1P  20A 1P  1A 1P 1A 1P</td> <td>WIRES: 3 SC RATING: 10000 LOAD TYPE MISCELLANEOUS MISCELLANEOUS RECEPTACLE MECH HEATING MECH HEATING MECH COOLING MECH COOLING MECH YEAR ROUND SPACE MECH HEATING MECH HEATING</td> <td>GROUND BUS: YES LOAD DESCRIPTION SPA - ROOF   RCPT - ROOF  GUTTER HEAT TRACE GFCI 30mA   CU-1 - CONDENSING UNIT  CU-1 - CONDENSING UNIT   GF1 - GAS FIRED FURNACE   BL-1 BOILER </td>	MAIN MOUN CKT# LOAD 1 1440 3 500 5 300 7 1500 9 1200 11 0 13 600 15 1500 15 1500 17 1500 17 1500 19 1500 21 1500	BRKR: JTING: A A B A B A B A B A B A B A B A A B A A A A	NONE FLUSH           CKT# LOAD           2           4800           4           4800           6           180           220           20           20           20           20           20           20           20           20           20           20           20           20	AMPS POLES 50A 2P  20A 1P 20A 2P  30A 2P  20A 1P  20A 1P  1A 1P 1A 1P	WIRES: 3 SC RATING: 10000 LOAD TYPE MISCELLANEOUS MISCELLANEOUS RECEPTACLE MECH HEATING MECH HEATING MECH COOLING MECH COOLING MECH YEAR ROUND SPACE MECH HEATING MECH HEATING	GROUND BUS: YES LOAD DESCRIPTION SPA - ROOF   RCPT - ROOF  GUTTER HEAT TRACE GFCI 30mA   CU-1 - CONDENSING UNIT  CU-1 - CONDENSING UNIT   GF1 - GAS FIRED FURNACE   BL-1 BOILER 		
2020 NFPA 70 ART. 220 PART III 2020 NEC 220.14(J), 220.42 & 220.52 1286 SQFT Garage Level 1018 SQFT Upper Level 136 SQFT Upper Stairwell 2440 SQFT General Lighting Load 2 CCT Small Appliance 3000 VA 1 CCT Laundry Circuit 1500 VA Total General Load: 11820 VA 3000 VA @ 100% 3000 VA 8820 VA @ 35% 3087 VA COOLING Loads Equipment Power GF-1 Air 1032 VA CU AC 4800 VA GF-1 Gas Furnace GF-1 Gas Furnace 1032 VA CU AC 4800 VA CU AC 4800 VA CU AC 2020 NEC 220.53 Agpliance Loads Load Each	LOAD TYPE RECEPTACLE RECEPTACLE RECEPTACLE MISCELLANEOUS MISCELLANEOUS SPACE APPLIANCE RECEPTACLE RECEPTACLE RECEPTACLE APPLIANCE SPACE	VOLTAGE: ENCLOSURE: ENCLOSURE: LOAD DESCRIPTION RCPT - MAST. BED CAFCI RCPT - MAST. BATH  RCPT - POWDER ROOM  WASHER CAFCI/GFCI 5mA DRYER CAFCI/GFCI 5mA DRYER CAFCI/GFCI 5mA  FRIDGE CAFCI MICROWAVE DRAWER CAFCI MICROWAVE DRAWER CAFCI RCPT - KITCHEN COUNTER CAFCI/GFCI 5mA RCPT - KITCHEN COUNTER CAFCI/GFCI 5mA RANGE/HOOD CAFCI	120/240         NEMA1         AMPS         POLES         20A         1P         20A         1P <td>MAIN MOUN CKT# LOAD 1 1440 3 500 5 300 7 1500 9 1200 11 0 13 600 15 1500 15 1500 15 1500 15 1500 15 1500 21 1500 23 0</td> <td>BRKR: TING: A A B A B A B A B A B A B A B A B A B</td> <td>NONE FLUSH           CKT# LOAD           2           4800           4           4800           6           180           8           1000           12           2496           14           2496           16           1500           22           20           22           20           22           20           22           20           24           1500</td> <td>AMPS POLES 50A 2P  20A 1P 20A 2P  30A 2P  30A 2P  20A 1P  1A 1P 1A 1P 1A 1P 1A 1P 20A 1P</td> <td>WIRES: 3 SC RATING: 10000 LOAD TYPE MISCELLANEOUS MISCELLANEOUS RECEPTACLE MECH HEATING MECH HEATING MECH COOLING MECH COOLING MECH YEAR ROUND SPACE MECH HEATING MECH HEATING MECH YEAR ROUND</td> <td>GROUND BUS: YES LOAD DESCRIPTION SPA - ROOF    RCPT - ROOF  GUTTER HEAT TRACE GFCI 30mA   CU-1 - CONDENSING UNIT   GF1 - GAS FIRED FURNACE   BL-1 BOILER  DU-1 - UNIT HEATER   CU-1 - UNIT HEATER  </td>	MAIN MOUN CKT# LOAD 1 1440 3 500 5 300 7 1500 9 1200 11 0 13 600 15 1500 15 1500 15 1500 15 1500 15 1500 21 1500 23 0	BRKR: TING: A A B A B A B A B A B A B A B A B A B	NONE FLUSH           CKT# LOAD           2           4800           4           4800           6           180           8           1000           12           2496           14           2496           16           1500           22           20           22           20           22           20           22           20           24           1500	AMPS POLES 50A 2P  20A 1P 20A 2P  30A 2P  30A 2P  20A 1P  1A 1P 1A 1P 1A 1P 1A 1P 20A 1P	WIRES: 3 SC RATING: 10000 LOAD TYPE MISCELLANEOUS MISCELLANEOUS RECEPTACLE MECH HEATING MECH HEATING MECH COOLING MECH COOLING MECH YEAR ROUND SPACE MECH HEATING MECH HEATING MECH YEAR ROUND	GROUND BUS: YES LOAD DESCRIPTION SPA - ROOF    RCPT - ROOF  GUTTER HEAT TRACE GFCI 30mA   CU-1 - CONDENSING UNIT   GF1 - GAS FIRED FURNACE   BL-1 BOILER  DU-1 - UNIT HEATER   CU-1 - UNIT HEATER  		
2020 NFPA 70 ART. 220 PART III 2020 NEC 220.14(J), 220.42 & 220.52 1286 SQFT Garage Level 1018 SQFT Upper Level 136 SQFT Upper Stainwell 2440 SQFT General Lighting Load 2 CCT Small Appliance 3000 VA 1 CCT Laundry Circuit 1500 VA 1 CCT Laundry Circuit 1500 VA Total General Load: 11820 VA 3000 VA @ 100% 3000 VA 8820 VA @ 35% 3087 VA General Lighting Load: 6087 VA 2020 NEC 220.51 and 220.60 Cooling Loads Equipment Power GF-1 Air 1032 VA CU AC 4800 VA Gutter Heat Trace 1032 VA Gutter Heat Trace 1032 VA CU AC 2020 NEC 220.53 Appliance Loads Load Each 1 Refrigerator 1 Dishwasher 1 200 VA	LOAD TYPE RECEPTACLE RECEPTACLE RECEPTACLE MISCELLANEOUS MISCELLANEOUS SPACE APPLIANCE APPLIANCE RECEPTACLE RECEPTACLE SPACE SPACE RECEPTACLE	VOLTAGE: ENCLOSURE: ENCLOSURE: LOAD DESCRIPTION RCPT - MAST. BED CAFCI RCPT - MAST. BATH  RCPT - POWDER ROOM  WASHER CAFCI/GFCI 5mA DRYER CAFCI/GFCI 5mA DRYER CAFCI/GFCI 5mA FRIDGE CAFCI MICROWAVE DRAWER CAFCI MICROWAVE DRAWER CAFCI RCPT - KITCHEN COUNTER CAFCI/GFCI 5mA RANGE/HOOD CAFCI   RCPT - ISLAND COUNTER CAFCI/GFCI 5mA	120/240         NEMA1         AMPS         20A         1P         20A	MAIN MOUN CKT# LOAD 1 1440 3 500 5 300 7 1500 9 1200 11 0 13 600 15 1500 15 1500 15 1500 17 1500 15 1500 21 1500 21 1500 23 0 25 1500	BRKR: JTING: A A B A B A B A B A B A B A B A B A B	NONE         CKT#         LOAD         2         4800         4         4800         6         180         22         20         20         20         20         24         1500         24         1500	AMPS POLES 50A 2P  20A 1P 20A 2P  30A 2P  20A 1P  20A 1P  1A 1P 1A 1P 1A 1P 20A 1P 20A 1P	WIRES: 3 SC RATING: 10000 LOAD TYPE MISCELLANEOUS MISCELLANEOUS RECEPTACLE MECH HEATING MECH HEATING MECH COOLING MECH COOLING MECH YEAR ROUND SPACE MECH HEATING MECH HEATING MECH YEAR ROUND SPACE MECH YEAR ROUND	GROUND BUS: YES LOAD DESCRIPTION SPA - ROOF   RCPT - ROOF  GUTTER HEAT TRACE GFCI 30mA  CU-1 - CONDENSING UNIT  CU-1 - CONDENSING UNIT  GF1 - GAS FIRED FURNACE  BL-1 BOILER  CP1/3-BOILER/LOOP PUMP  CP2/7- WATER HEATER/DOMESTIC 		
2020 NFPA 70 ART. 220 PART III 2020 NEC 220.14(J), 220.42 & 220.52 1286 SQFT Garage Level 1018 SQFT Upper Stairwell 2440 SQFT General Lighting Load 7320 VA 2 CCT Small Appliance 3000 VA 1 CCT Laundry Circuit 1500 VA Total General Load: 11820 VA 3000 VA @ 100% 3000 VA 8820 VA @ 35% 3087 VA Cooling Loads Heating Loads Equipment Power Equipment Power Equipment Power Equipment Power GF-1 Air 1032 VA CU AC 4800 VA EUH - Garage Unit Heat 1500 VA Gutter Heat Trace 1500 VA Connected: 11232 VA Greater of Noncoincidental Loads Connected: 11232 VA Greater of Noncoincidental Loads: 6432 VA 2020 NEC 220.53 Appliance Loads Load Each 1 Refrigerator 600 VA 1 Dishwasher 1200 VA	LOAD TYPE RECEPTACLE RECEPTACLE RECEPTACLE MISCELLANEOUS MISCELLANEOUS SPACE APPLIANCE RECEPTACLE RECEPTACLE RECEPTACLE APPLIANCE SPACE RECEPTACLE APPLIANCE	VOLTAGE: ENCLOSURE: ENCLOSURE: LOAD DESCRIPTION RCPT - MAST. BED CAFCI RCPT - MAST. BATH  RCPT - POWDER ROOM  WASHER CAFCI/GFCI 5mA DRYER CAFCI/GFCI 5mA DRYER CAFCI/GFCI 5mA FRIDGE CAFCI MICROWAVE DRAWER CAFCI MICROWAVE DRAWER CAFCI RCPT - KITCHEN COUNTER CAFCI/GFCI 5mA RCPT - KITCHEN COUNTER CAFCI/GFCI 5mA RANGE/HOOD CAFCI   RCPT - ISLAND COUNTER CAFCI/GFCI 5mA	120/240         NEMA1         AMPS         POLES         20A         1P         20A         1P <td>MAIN MOUN CKT# LOAD 1 1440 3 500 5 300 7 1500 9 1200 11 0 13 600 15 1500 15 1500 15 1500 15 1500 17 1500 15 1500 21 1500 23 0 25 1500 27 1200</td> <td>BRKR: TING: A A B A B A B A B A B A B A B A B A B</td> <td>NONE         CKT#         LOAD         2         4800         4         6         180         10         1000         12         2496         14         2496         16         1500         22         20         22         20         22         20         24         1500         28         1500</td> <td>AMPS POLES 50A 2P  20A 1P 20A 2P  30A 2P  30A 2P  20A 1P  1A 1P 1A 1P 1A 1P 20A 1P 20A 1P 20A 1P</td> <td>WIRES: 3 SC RATING: 10000 LOAD TYPE MISCELLANEOUS MISCELLANEOUS RECEPTACLE MECH HEATING MECH HEATING MECH COOLING MECH COOLING MECH YEAR ROUND SPACE MECH HEATING MECH HEATING MECH YEAR ROUND MOTOR MOTOR</td> <td>GROUND BUS: YES LOAD DESCRIPTION SPA - ROOF   RCPT - ROOF  GUTTER HEAT TRACE GFCI 30mA   CU-1 - CONDENSING UNIT   GF1 - GAS FIRED FURNACE   BL-1 BOILER  BL-1 BOILER  CP1/3-BOILER/LOOP PUMP  CP2/7- WATER HEATER/DOMESTIC  CP4/6 - SNOWMELT / LOOP</td>	MAIN MOUN CKT# LOAD 1 1440 3 500 5 300 7 1500 9 1200 11 0 13 600 15 1500 15 1500 15 1500 15 1500 17 1500 15 1500 21 1500 23 0 25 1500 27 1200	BRKR: TING: A A B A B A B A B A B A B A B A B A B	NONE         CKT#         LOAD         2         4800         4         6         180         10         1000         12         2496         14         2496         16         1500         22         20         22         20         22         20         24         1500         28         1500	AMPS POLES 50A 2P  20A 1P 20A 2P  30A 2P  30A 2P  20A 1P  1A 1P 1A 1P 1A 1P 20A 1P 20A 1P 20A 1P	WIRES: 3 SC RATING: 10000 LOAD TYPE MISCELLANEOUS MISCELLANEOUS RECEPTACLE MECH HEATING MECH HEATING MECH COOLING MECH COOLING MECH YEAR ROUND SPACE MECH HEATING MECH HEATING MECH YEAR ROUND MOTOR MOTOR	GROUND BUS: YES LOAD DESCRIPTION SPA - ROOF   RCPT - ROOF  GUTTER HEAT TRACE GFCI 30mA   CU-1 - CONDENSING UNIT   GF1 - GAS FIRED FURNACE   BL-1 BOILER  BL-1 BOILER  CP1/3-BOILER/LOOP PUMP  CP2/7- WATER HEATER/DOMESTIC  CP4/6 - SNOWMELT / LOOP		
2020 NFPA 70 ART. 220 PART III 2020 NEC 220.14(J), 220.42 & 220.52 1286 SQFT Garage Level 1018 SQFT Upper Stairwell 2440 SQFT General Lighting Load 7320 VA 2 CCT Small Appliance 3000 VA 1 CCT Laundry Circuit 1500 VA Total General Load: 11820 VA 3000 VA @ 100% 3000 VA 8820 VA @ 35% 3087 VA Cooling Loads Heating Loads Equipment Power Equipment Power GF-1 Air 1032 VA CU AC 4800 VA GF-1 Gas Furnace 1032 VA Gutter Heat Trace 1500 VA CONNEC 220.51 and 220.60 Connected: 11232 VA Greater of Noncoincidental Loads: 6432 VA Cooling Loads Loads Load Each 1 Refrigerator 600 VA 1 Dishwasher 1200 VA	LOAD TYPE RECEPTACLE RECEPTACLE RECEPTACLE MISCELLANEOUS MISCELLANEOUS SPACE APPLIANCE APPLIANCE RECEPTACLE RECEPTACLE SPACE SPACE RECEPTACLE	VOLTAGE: ENCLOSURE: ENCLOSURE: LOAD DESCRIPTION RCPT - MAST. BED CAFCI RCPT - MAST. BATH  RCPT - POWDER ROOM  WASHER CAFCI/GFCI 5mA DRYER CAFCI/GFCI 5mA DRYER CAFCI FRIDGE CAFCI KCPT - KITCHEN COUNTER CAFCI RCPT - KITCHEN COUNTER CAFCI/GFCI 5mA RANGE/HOOD CAFCI CAFCI 5mA RANGE/HOOD CAFCI CAFCI 5mA RANGE/HOOD CAFCI CAFCI 5mA	120/240         NEMA1         AMPS         20A         1P         20A	MAIN MOUN CKT# LOAD 1 1440 3 500 5 300 7 1500 9 1200 11 0 13 600 15 1500 15 1500 15 1500 17 1500 17 1500 17 1500 21 1500 21 1500 21 1500 23 0 25 1500 27	BRKR: JTING: A A B A B A B A B A B A B A B A B A B	NONE         CKT#         LOAD         2         4800         4         4800         6         180         22496         16         15000         20         20         20         20         20         24         1500         24         1500         24         250         24         200         22         20         20         20         20         20         20         23         24         250         24         2500         28	AMPS POLES 50A 2P  20A 1P 20A 2P  30A 2P  20A 1P  20A 1P  1A 1P 1A 1P 1A 1P 20A 1P 20A 1P	WIRES: 3 SC RATING: 10000 LOAD TYPE MISCELLANEOUS MISCELLANEOUS RECEPTACLE MECH HEATING MECH HEATING MECH COOLING MECH COOLING MECH YEAR ROUND SPACE MECH HEATING MECH HEATING MECH YEAR ROUND SPACE MECH YEAR ROUND	GROUND BUS: YES LOAD DESCRIPTION SPA - ROOF   RCPT - ROOF  GUTTER HEAT TRACE GFCI 30mA  CU-1 - CONDENSING UNIT  CU-1 - CONDENSING UNIT  GF1 - GAS FIRED FURNACE  BL-1 BOILER  CP1/3-BOILER/LOOP PUMP  CP2/7- WATER HEATER/DOMESTIC 		
2020 NFPA 70 ART. 220 PART III 2020 NEC 220.14(J), 220.42 & 220.52 1286 SQFT Garage Level 136 SQFT Upper Stairwell 2440 SQFT General Lighting Load 7320 VA 2440 SQFT General Lighting Load 7300 VA 1 CCT Laundry Circuit 1500 VA Total General Load: 11820 VA 3000 VA @ 100% 3000 VA 8820 VA @ 35% 3087 VA General Lighting L <u>oad: 6087 VA</u> 2020 NEC 220.51 and 220.60 Cooling Loads Heating Loads Equipment Power Equipment Power GF-1 Air 1032 VA CU AC 4800 VA GUH - Garage Unit Heat 1500 VA See unit plans G432 VA Heating Loads S322 VA Cooling Loads Connected: 11232 VA Greater of Noncoincidental Loads: 64 <u>32</u> VA 2020 NEC 220.53 Appliance Loads Load Each 1 Refrigerator 1 Dishwasher 1200 VA 1 Disposal 900 VA 4900 VA @ 75% Appliance Load: 3675 VA	LOAD TYPE RECEPTACLE RECEPTACLE RECEPTACLE MISCELLANEOUS MISCELLANEOUS SPACE APPLIANCE RECEPTACLE RECEPTACLE RECEPTACLE APPLIANCE SPACE RECEPTACLE APPLIANCE	VOLTAGE: ENCLOSURE: ENCLOSURE: LOAD DESCRIPTION RCPT - MAST. BED CAFCI RCPT - MAST. BATH  RCPT - POWDER ROOM  WASHER CAFCI/GFCI 5mA DRYER CAFCI/GFCI 5mA DRYER CAFCI/GFCI 5mA FRIDGE CAFCI MICROWAVE DRAWER CAFCI RCPT - KITCHEN COUNTER CAFCI/GFCI 5mA RCPT - KITCHEN COUNTER CAFCI/GFCI 5mA RANGE/HOOD CAFCI   RCPT - ISLAND COUNTER CAFCI/GFCI 5mA RANGE/HOOD CAFCI DISHWASHER CAFCI/GFCI 5mA RCPT - LIVING/DINING	120/240         NEMA1         AMPS         POLES         20A         1P         20A         1P <td>MAIN MOUN CKT# LOAD 1 1440 3 500 5 300 7 1500 9 1200 11 0 13 600 11 15 1500 15 1500 15 1500 15 1500 17 1500 15 1500 21 1500 21 1500 23 0 25 1500 27 1200 29</td> <td>BRKR: ITING: A A B A B A B A B A B A B A B A B A B</td> <td>NONE         CKT#         LOAD         2         4800         4         400         6         180         12         2496         14         2496         16         1500         22         20         22         20         22         20         21         20         20         20         20         21         20         20         20         21         220         230         24         1500         28         1500         30</td> <td>AMPS POLES 50A 2P  20A 1P 20A 2P  30A 2P  30A 2P  20A 1P  1A 1P 1A 1P 1A 1P 20A 1P 20A 1P 20A 1P</td> <td>WIRES: 3 SC RATING: 10000 LOAD TYPE MISCELLANEOUS MISCELLANEOUS RECEPTACLE MECH HEATING MECH HEATING MECH COOLING MECH COOLING MECH YEAR ROUND SPACE MECH HEATING MECH HEATING MECH YEAR ROUND MOTOR MOTOR</td> <td>GROUND BUS: YES LOAD DESCRIPTION SPA - ROOF   RCPT - ROOF  GUTTER HEAT TRACE GFCI 30mA   CU-1 - CONDENSING UNIT   GF1 - GAS FIRED FURNACE   BL-1 BOILER  BL-1 BOILER  CP1/3-BOILER/LOOP PUMP  CP2/7- WATER HEATER/DOMESTIC  CP4/6 - SNOWMELT / LOOP</td>	MAIN MOUN CKT# LOAD 1 1440 3 500 5 300 7 1500 9 1200 11 0 13 600 11 15 1500 15 1500 15 1500 15 1500 17 1500 15 1500 21 1500 21 1500 23 0 25 1500 27 1200 29	BRKR: ITING: A A B A B A B A B A B A B A B A B A B	NONE         CKT#         LOAD         2         4800         4         400         6         180         12         2496         14         2496         16         1500         22         20         22         20         22         20         21         20         20         20         20         21         20         20         20         21         220         230         24         1500         28         1500         30	AMPS POLES 50A 2P  20A 1P 20A 2P  30A 2P  30A 2P  20A 1P  1A 1P 1A 1P 1A 1P 20A 1P 20A 1P 20A 1P	WIRES: 3 SC RATING: 10000 LOAD TYPE MISCELLANEOUS MISCELLANEOUS RECEPTACLE MECH HEATING MECH HEATING MECH COOLING MECH COOLING MECH YEAR ROUND SPACE MECH HEATING MECH HEATING MECH YEAR ROUND MOTOR MOTOR	GROUND BUS: YES LOAD DESCRIPTION SPA - ROOF   RCPT - ROOF  GUTTER HEAT TRACE GFCI 30mA   CU-1 - CONDENSING UNIT   GF1 - GAS FIRED FURNACE   BL-1 BOILER  BL-1 BOILER  CP1/3-BOILER/LOOP PUMP  CP2/7- WATER HEATER/DOMESTIC  CP4/6 - SNOWMELT / LOOP		
2020 NFPA 70 ART. 220 PART III 2020 NEC 220.14(J), 220.42 & 220.52 1286 SQFT Garage Level 138 SQFT Upper Stainwell 2440 SQFT General Lighting Load 2 CCT Small Appliance 3000 VA 1 CCT Laundry Circuit 1500 VA Total General Load: 11820 VA 3000 VA @ 100% 3000 VA 8820 VA @ 35% 3087 VA Coloing Loads Equipment Power GF-1 Air 1032 VA CU AC 4800 VA Gutter Heat Trace 1500 VA CU AC 4800 VA CU AC CONNEC 220.53 Appliance Loads CONNEC 220.53 CONNEC 220.53 Appliance Loads CONNEC 220.53 CONNEC 220.55 CONNEC 220.55 CONNEC 220.55 CONNEC 220.55 CONNEC	LOAD TYPE RECEPTACLE RECEPTACLE RECEPTACLE MISCELLANEOUS MISCELLANEOUS SPACE APPLIANCE APPLIANCE RECEPTACLE RECEPTACLE SPACE RECEPTACLE APPLIANCE RECEPTACLE RECEPTACLE APPLIANCE	VOLTAGE: ENCLOSURE: ENCLOSURE: LOAD DESCRIPTION RCPT - MAST. BED CAFCI RCPT - MAST. BATH  RCPT - POWDER ROOM  WASHER CAFCI/GFCI 5mA DRYER CAFCI/GFCI 5mA  FRIDGE CAFCI MICROWAVE DRAWER CAFCI MICROWAVE DRAWER CAFCI MICROWAVE DRAWER CAFCI RCPT - KITCHEN COUNTER CAFCI/GFCI 5mA RCPT - KITCHEN COUNTER CAFCI/GFCI 5mA RANGE/HOOD CAFCI   RCPT - ISLAND COUNTER CAFCI/GFCI 5mA DISHWASHER CAFCI/GFCI 5mA RCPT - LIVING/DINING CAFCI FIREPLACE OUTLETS	120/240         NEMA1         AMPS         20A         1P         20A	MAIN MOUN CKT# LOAD 1 1440 3 500 5 300 7 1500 9 1200 11 0 13 600 15 1500 15 1500 15 1500 15 1500 17 1500 17 1500 19 1500 21 1500 21 1500 21 1500 21 1500 21 1500 21 1500 21 1500 21 1500 21 1500 21 1500 21 1500 21 1500 21 1500 21 1500 21 1500 21 21 20 21 20 21 20 20 21 20 20 21 20 20 21 20 20 21 20 20 21 20 20 21 20 21 20 21 20 21 20 21 20 21 20 21 20 21 20 21 20 21 20 20 21 20 20 21 20 20 21 20 20 21 20 20 21 20 20 21 20 20 21 20 20 20 20 20 20 20 20 20 20 20 20 20	BRKR: ITING: A B A A B A B A A B A A B A A B A A B A A B A A B A A B A A B A A B A A B A A B A A A B A A A B A A A B A A A A B A A A A A A A A A A A A A	NONE         CKT#         LOAD         2         4800         4         6         180         8         1000         12         2496         14         2496         1500         22         20         22         20         21         20         20         20         20         21         200         21         20         23         2496         16         1500         28         1500         30         1500         32	AMPS POLES 50A 2P  20A 1P 20A 2P  30A 2P  30A 2P  20A 1P 20A 1P 1A 1P 1A 1P 1A 1P 20A 1P 20A 1P 20A 1P 20A 1P 20A 1P	WIRES: 3 SC RATING: 10000 LOAD TYPE MISCELLANEOUS MISCELLANEOUS RECEPTACLE MECH HEATING MECH HEATING MECH COOLING MECH COOLING MECH YEAR ROUND SPACE MECH HEATING MECH HEATING MECH YEAR ROUND MOTOR MOTOR MOTOR	GROUND BUS: YES LOAD DESCRIPTION SPA - ROOF   RCPT - ROOF  GUTTER HEAT TRACE GFCI 30mA  CU-1 - CONDENSING UNIT  CU-1 - CONDENSING UNIT  CU		
2020 NFPA 70 ART. 220 PART III 2020 NFC 220.14(1), 220.42 & 220.52 1286 SQFT Garage Level 138 SQFT Upper Level 138 SQFT Upper Level 138 SQFT General Lighting Load 2 CCT Small Appliance 2 440 SQFT General Load: 11820 VA 3000 VA @ 100% 3000 VA 8820 VA @ 35% 3087 VA Cooling Loads Cooling Loads Co	LOAD TYPE RECEPTACLE RECEPTACLE RECEPTACLE MISCELLANEOUS MISCELLANEOUS SPACE APPLIANCE APPLIANCE RECEPTACLE RECEPTACLE APPLIANCE SPACE RECEPTACLE RECEPTACLE RECEPTACLE RECEPTACLE RECEPTACLE	VOLTAGE: ENCLOSURE: ENCLOSURE: LOAD DESCRIPTION RCPT - MAST. BED CAFCI RCPT - MAST. BATH  RCPT - POWDER ROOM  WASHER CAFCI/GFCI 5mA DRYER CAFCI/GFCI 5mA  FRIDGE CAFCI KCPT - KITCHEN COUNTER CAFCI RCPT - KITCHEN COUNTER CAFCI/GFCI 5mA RCPT - KITCHEN COUNTER CAFCI/GFCI 5mA RANGE/HOOD CAFCI   RCPT - ISLAND COUNTER CAFCI/GFCI 5mA RANGE/HOOD CAFCI DISHWASHER CAFCI/GFCI 5mA RCPT - LIVING/DINING CAFCI FIREPLACE OUTLETS CAFCI FIREPLACE OUTLETS CAFCI RCPT - 2ND COMMON	120/240         NEMA1         AMPS         20A         1P         20A	MAIN MOUN CKT# LOAD 1 1440 3 500 5 300 7 1500 9 1200 11 0 13 600 15 1500 15 1500 15 1500 15 1500 17 1500 15 1500 21 1500 21 1500 23 0 25 1500 23 0 25 1500 23 0 25 1500 23 1200 23 31 700 33 720 35	BRKR: TING: A A B B A B B B A B B B B B B B B B B B B B	NONE         CKT#         LOAD         2         4800         4         6         180         10         1000         12         2496         14         2496         16         1500         22         20         21         20         20         20         20         20         20         21         200         21         200         22         20         230         24         1500         28         1500         32         3500         34         3500         36	AMPS POLES 50A 2P  20A 1P 20A 2P  30A 2P  30A 2P  20A 1P 20A 1P 20A 1P 20A 1P 20A 1P 20A 1P 20A 1P 20A 1P 20A 1P	WIRES: 3 SC RATING: 10000 LOAD TYPE MISCELLANEOUS MISCELLANEOUS RECEPTACLE MECH HEATING MECH HEATING MECH COOLING MECH COOLING MECH YEAR ROUND SPACE MECH HEATING MECH YEAR ROUND SPACE MECH YEAR ROUND MOTOR MOTOR MOTOR MOTOR	GROUND BUS: YES LOAD DESCRIPTION SPA - ROOF   RCPT - ROOF  GUTTER HEAT TRACE GFCI 30mA  CU-1 - CONDENSING UNIT  CU-1 - CONDENSING UNIT  CU-1 - CONDENSING UNIT  CU-1 - CONDENSING UNIT  BL-1 GAS FIRED FURNACE  CF1/3-BOILER  CP1/3-BOILER/LOOP PUMP  CP2/7- WATER HEATER/DOMESTIC  CP2/7- WATER HEATER/DOMESTIC  CP4/6 - SNOWMELT / LOOP  CP6/7-RADIANT/LOOP  EVC - GARAGE 		
2020 NFPA 70 ART. 220 PART III         2020 NEC 220.14(J), 220.42 & 220.52         1286 SQFT Garage Level         1386 SQFT Upper Stairwell         2440 SQFT General Lighting Load         7320 VA         2 CGT Small Appliance         2000 VA         1 1620 VA         2000 VA         1 1620 VA         Cooling Load:         1 1820 VA         3000 VA         Cooling Loads         Equipment Power         Equipment Power <td <="" colspan="2" td=""><td>LOAD TYPE RECEPTACLE RECEPTACLE RECEPTACLE MISCELLANEOUS MISCELLANEOUS SPACE APPLIANCE APPLIANCE RECEPTACLE RECEPTACLE SPACE RECEPTACLE RECEPTACLE RECEPTACLE RECEPTACLE RECEPTACLE RECEPTACLE RECEPTACLE</td><td>VOLTAGE: ENCLOSURE: ENCLOSURE: LOAD DESCRIPTION RCPT - MAST. BED CAFCI RCPT - POWDER ROOM  WASHER CAFCI/GFCI 5mA DRYER CAFCI/GFCI 5mA DRYER CAFCI/GFCI 5mA FRIDGE CAFCI MICROWAVE DRAWER CAFCI MICROWAVE DRAWER CAFCI RCPT - KITCHEN COUNTER CAFCI/GFCI 5mA RCPT - KITCHEN COUNTER CAFCI/GFCI 5mA RCPT - KITCHEN COUNTER CAFCI/GFCI 5mA RANGE/HOOD CAFCI   RCPT - ISLAND COUNTER CAFCI/GFCI 5mA DISHWASHER CAFCI/GFCI 5mA RCPT - LIVING/DINING CAFCI FIREPLACE OUTLETS CAFCI FIREPLACE OUTLETS CAFCI RCPT - 2ND COMMON CAFCI RCPT - 2ND COMMON CAFCI</td><td>120/240         NEMA1         AMPS         20A         1P         20A</td><td>MAIN MOUN CKT# LOAD 1 1440 3 500 5 300 7 1500 9 1200 11 0 13 600 15 1500 15 1500 15 1500 15 1500 17 1500 15 1500 17 1500 17 1500 13 600 15 1500 21 1500 21 1500 21 1500 21 1500 21 1500 21 1500 21 1500 23 0 25 1500 23 0 25 1500 23 0 25 1500 23 1500 23 1500 23 1500 23 0 25 1500 23 1500 25 1500 20 15 1500 21 1500 23 1500 23 1500 23 1500 23 1500 23 1500 23 1500 23 1500 23 1500 23 1500 25 1500 23 1500 23 1500 23 1500 23 1500 25 1500 20 25 1500 20 25 1500 20 25 1500 20 25 1500 20 25 1500 20 25 1500 20 25 1500 20 25 1500 20 25 1500 20 25 1500 20 20 20 20 20 20 20 20 20 20 20 20 2</td><td>BRKR: TING: A B A A B A B A A B A A B A A B A A B A A B A A B A A B A A B A A B A A B A A B A A B A A A B A A B A A A B A A A B A A A B A A A B A A A B A A A B A A A B A A A A B A A A A B A A A A B A A A A A B A A A A B A A A A A B A A A A A A A A A A B A A A A A A A A A A A A A</td><td>NONE         CKT#         LOAD         2         4800         4         6         180         20         20         20         20         20         20         20         20         20         20         20         20         20         20         20         20         20         20         30         1500         30         1500         32         3500         34         3500         36         1500         38    </td><td>AMPS POLES 50A 2P  20A 1P 20A 2P  30A 2P  30A 2P  20A 1P 20A 1P 20A 1P 20A 1P 20A 1P 20A 1P 20A 1P 20A 1P 20A 1P 20A 1P 20A 1P</td><td>WIRES: 3 SC RATING: 10000 LOAD TYPE MISCELLANEOUS MISCELLANEOUS RECEPTACLE MECH HEATING MECH HEATING MECH COOLING MECH COOLING MECH YEAR ROUND SPACE MECH HEATING MECH HEATING MECH YEAR ROUND SPACE MECH HEATING MOTOR MOTOR MOTOR MOTOR MOTOR MOTOR MISCELLANEOUS</td><td>GROUND BUS: YES LOAD DESCRIPTION SPA - ROOF   RCPT - ROOF  GUTTER HEAT TRACE GFCI 30mA   GUTTER HEAT TRACE GFCI 30mA   CU-1 - CONDENSING UNIT   CU-1 - CONDENSING UNIT   GF1 - GAS FIRED FURNACE   EUH-1 - UNIT HEATER  EUH-1 - UNIT HEATER  EUH-1 - UNIT HEATER  EUH-1 - UNIT HEATER  CP2/7- WATER HEATER/DOMESTIC  CP2/7- WATER HEATER/DOMESTIC  CP4/6 - SNOWMELT / LOOP  CP6/7-RADIANT/LOOP  EVC - GARAGE  EVC - GARAGE </td></td>	<td>LOAD TYPE RECEPTACLE RECEPTACLE RECEPTACLE MISCELLANEOUS MISCELLANEOUS SPACE APPLIANCE APPLIANCE RECEPTACLE RECEPTACLE SPACE RECEPTACLE RECEPTACLE RECEPTACLE RECEPTACLE RECEPTACLE RECEPTACLE RECEPTACLE</td> <td>VOLTAGE: ENCLOSURE: ENCLOSURE: LOAD DESCRIPTION RCPT - MAST. BED CAFCI RCPT - POWDER ROOM  WASHER CAFCI/GFCI 5mA DRYER CAFCI/GFCI 5mA DRYER CAFCI/GFCI 5mA FRIDGE CAFCI MICROWAVE DRAWER CAFCI MICROWAVE DRAWER CAFCI RCPT - KITCHEN COUNTER CAFCI/GFCI 5mA RCPT - KITCHEN COUNTER CAFCI/GFCI 5mA RCPT - KITCHEN COUNTER CAFCI/GFCI 5mA RANGE/HOOD CAFCI   RCPT - ISLAND COUNTER CAFCI/GFCI 5mA DISHWASHER CAFCI/GFCI 5mA RCPT - LIVING/DINING CAFCI FIREPLACE OUTLETS CAFCI FIREPLACE OUTLETS CAFCI RCPT - 2ND COMMON CAFCI RCPT - 2ND COMMON CAFCI</td> <td>120/240         NEMA1         AMPS         20A         1P         20A</td> <td>MAIN MOUN CKT# LOAD 1 1440 3 500 5 300 7 1500 9 1200 11 0 13 600 15 1500 15 1500 15 1500 15 1500 17 1500 15 1500 17 1500 17 1500 13 600 15 1500 21 1500 21 1500 21 1500 21 1500 21 1500 21 1500 21 1500 23 0 25 1500 23 0 25 1500 23 0 25 1500 23 1500 23 1500 23 1500 23 0 25 1500 23 1500 25 1500 20 15 1500 21 1500 23 1500 23 1500 23 1500 23 1500 23 1500 23 1500 23 1500 23 1500 23 1500 25 1500 23 1500 23 1500 23 1500 23 1500 25 1500 20 25 1500 20 25 1500 20 25 1500 20 25 1500 20 25 1500 20 25 1500 20 25 1500 20 25 1500 20 25 1500 20 25 1500 20 20 20 20 20 20 20 20 20 20 20 20 2</td> <td>BRKR: TING: A B A A B A B A A B A A B A A B A A B A A B A A B A A B A A B A A B A A B A A B A A B A A A B A A B A A A B A A A B A A A B A A A B A A A B A A A B A A A B A A A A B A A A A B A A A A B A A A A A B A A A A B A A A A A B A A A A A A A A A A B A A A A A A A A A A A A A</td> <td>NONE         CKT#         LOAD         2         4800         4         6         180         20         20         20         20         20         20         20         20         20         20         20         20         20         20         20         20         20         20         30         1500         30         1500         32         3500         34         3500         36         1500         38    </td> <td>AMPS POLES 50A 2P  20A 1P 20A 2P  30A 2P  30A 2P  20A 1P 20A 1P 20A 1P 20A 1P 20A 1P 20A 1P 20A 1P 20A 1P 20A 1P 20A 1P 20A 1P</td> <td>WIRES: 3 SC RATING: 10000 LOAD TYPE MISCELLANEOUS MISCELLANEOUS RECEPTACLE MECH HEATING MECH HEATING MECH COOLING MECH COOLING MECH YEAR ROUND SPACE MECH HEATING MECH HEATING MECH YEAR ROUND SPACE MECH HEATING MOTOR MOTOR MOTOR MOTOR MOTOR MOTOR MISCELLANEOUS</td> <td>GROUND BUS: YES LOAD DESCRIPTION SPA - ROOF   RCPT - ROOF  GUTTER HEAT TRACE GFCI 30mA   GUTTER HEAT TRACE GFCI 30mA   CU-1 - CONDENSING UNIT   CU-1 - CONDENSING UNIT   GF1 - GAS FIRED FURNACE   EUH-1 - UNIT HEATER  EUH-1 - UNIT HEATER  EUH-1 - UNIT HEATER  EUH-1 - UNIT HEATER  CP2/7- WATER HEATER/DOMESTIC  CP2/7- WATER HEATER/DOMESTIC  CP4/6 - SNOWMELT / LOOP  CP6/7-RADIANT/LOOP  EVC - GARAGE  EVC - GARAGE </td>		LOAD TYPE RECEPTACLE RECEPTACLE RECEPTACLE MISCELLANEOUS MISCELLANEOUS SPACE APPLIANCE APPLIANCE RECEPTACLE RECEPTACLE SPACE RECEPTACLE RECEPTACLE RECEPTACLE RECEPTACLE RECEPTACLE RECEPTACLE RECEPTACLE	VOLTAGE: ENCLOSURE: ENCLOSURE: LOAD DESCRIPTION RCPT - MAST. BED CAFCI RCPT - POWDER ROOM  WASHER CAFCI/GFCI 5mA DRYER CAFCI/GFCI 5mA DRYER CAFCI/GFCI 5mA FRIDGE CAFCI MICROWAVE DRAWER CAFCI MICROWAVE DRAWER CAFCI RCPT - KITCHEN COUNTER CAFCI/GFCI 5mA RCPT - KITCHEN COUNTER CAFCI/GFCI 5mA RCPT - KITCHEN COUNTER CAFCI/GFCI 5mA RANGE/HOOD CAFCI   RCPT - ISLAND COUNTER CAFCI/GFCI 5mA DISHWASHER CAFCI/GFCI 5mA RCPT - LIVING/DINING CAFCI FIREPLACE OUTLETS CAFCI FIREPLACE OUTLETS CAFCI RCPT - 2ND COMMON CAFCI RCPT - 2ND COMMON CAFCI	120/240         NEMA1         AMPS         20A         1P         20A	MAIN MOUN CKT# LOAD 1 1440 3 500 5 300 7 1500 9 1200 11 0 13 600 15 1500 15 1500 15 1500 15 1500 17 1500 15 1500 17 1500 17 1500 13 600 15 1500 21 1500 21 1500 21 1500 21 1500 21 1500 21 1500 21 1500 23 0 25 1500 23 0 25 1500 23 0 25 1500 23 1500 23 1500 23 1500 23 0 25 1500 23 1500 25 1500 20 15 1500 21 1500 23 1500 23 1500 23 1500 23 1500 23 1500 23 1500 23 1500 23 1500 23 1500 25 1500 23 1500 23 1500 23 1500 23 1500 25 1500 20 25 1500 20 25 1500 20 25 1500 20 25 1500 20 25 1500 20 25 1500 20 25 1500 20 25 1500 20 25 1500 20 25 1500 20 20 20 20 20 20 20 20 20 20 20 20 2	BRKR: TING: A B A A B A B A A B A A B A A B A A B A A B A A B A A B A A B A A B A A B A A B A A B A A A B A A B A A A B A A A B A A A B A A A B A A A B A A A B A A A B A A A A B A A A A B A A A A B A A A A A B A A A A B A A A A A B A A A A A A A A A A B A A A A A A A A A A A A A	NONE         CKT#         LOAD         2         4800         4         6         180         20         20         20         20         20         20         20         20         20         20         20         20         20         20         20         20         20         20         30         1500         30         1500         32         3500         34         3500         36         1500         38	AMPS POLES 50A 2P  20A 1P 20A 2P  30A 2P  30A 2P  20A 1P 20A 1P 20A 1P 20A 1P 20A 1P 20A 1P 20A 1P 20A 1P 20A 1P 20A 1P 20A 1P	WIRES: 3 SC RATING: 10000 LOAD TYPE MISCELLANEOUS MISCELLANEOUS RECEPTACLE MECH HEATING MECH HEATING MECH COOLING MECH COOLING MECH YEAR ROUND SPACE MECH HEATING MECH HEATING MECH YEAR ROUND SPACE MECH HEATING MOTOR MOTOR MOTOR MOTOR MOTOR MOTOR MISCELLANEOUS	GROUND BUS: YES LOAD DESCRIPTION SPA - ROOF   RCPT - ROOF  GUTTER HEAT TRACE GFCI 30mA   GUTTER HEAT TRACE GFCI 30mA   CU-1 - CONDENSING UNIT   CU-1 - CONDENSING UNIT   GF1 - GAS FIRED FURNACE   EUH-1 - UNIT HEATER  EUH-1 - UNIT HEATER  EUH-1 - UNIT HEATER  EUH-1 - UNIT HEATER  CP2/7- WATER HEATER/DOMESTIC  CP2/7- WATER HEATER/DOMESTIC  CP4/6 - SNOWMELT / LOOP  CP6/7-RADIANT/LOOP  EVC - GARAGE  EVC - GARAGE 
2020 NFPA 70 ART. 220 PART III 2020 NEC 220.14(J), 220.42 & 220.52 1286 SQFT Garage Level 136 SQFT Upper Stainwell 2440 SQFT General Lighting Load 7320 VA 2 CCT Small Appliance 3000 VA 1 CCT Laundry Circuit 1500 VA Total General Load: 11820 VA 3000 VA @ 100% 3000 VA 8820 VA @ 35% 3087 VA CO20 NEC 220.51 and 220.60 Cooling Loads Equipment Power Equipment Power GF-1 Air 1032 VA GF-1 Gas Furnace 1032 VA GF-1 Gas Furnace 1032 VA GF-1 Gas Furnace 1032 VA GF-1 Air 1032 VA GF-1 Gas Furnace 1032 VA GF-1 Gas ZU-14(A) CONNECted: 11222 VA GF-1 Cooling Loads: 1 Refrigerator 1 Connected: 1200 VA 4900 VA 1 Disposal 900 VA	LOAD TYPE RECEPTACLE RECEPTACLE RECEPTACLE MISCELLANEOUS MISCELLANEOUS SPACE APPLIANCE APPLIANCE RECEPTACLE RECEPTACLE SPACE RECEPTACLE RECEPTACLE RECEPTACLE RECEPTACLE RECEPTACLE RECEPTACLE RECEPTACLE RECEPTACLE RECEPTACLE	VOLTAGE: ENCLOSURE: ENCLOSURE: LOAD DESCRIPTION RCPT - MAST. BED CAFCI RCPT - MAST. BATH  RCPT - POWDER ROOM  WASHER CAFCI/GFCI 5mA DRYER CAFCI/GFCI 5mA DRYER CAFCI/GFCI 5mA FRIDGE CAFCI MICROWAVE DRAWER CAFCI MICROWAVE DRAWER CAFCI RCPT - KITCHEN COUNTER CAFCI/GFCI 5mA RCPT - KITCHEN COUNTER CAFCI/GFCI 5mA RANGE/HOOD CAFCI   RCPT - ISLAND COUNTER CAFCI/GFCI 5mA RANGE/HOOD CAFCI SIGHUASHER CAFCI/GFCI 5mA RCPT - LIVING/DINING CAFCI FIREPLACE OUTLETS CAFCI FIREPLACE OUTLETS CAFCI RCPT - 2ND COMMON CAFCI RCPT - BEDROOM N CAFCI RCPT - 2ND BATH N  RCPT - BEDROOM S	120/240         NEMA1         AMPS         20A         1P         20A	MAIN MOUN CKT# LOAD 1 1440 3 500 5 300 7 1500 9 1200 11 0 13 600 15 1500 15 1500 15 1500 15 1500 15 1500 17 1500 15 1500 21 1500 21 1500 23 0 25 1500 25 1500 23 0 25 1500 23 1500 23 1500 23 1500 23 25 1500 23 25 1500 25 1500 25 1500 25 1500 25 1500 25 1500 27 1200 20 25 1500 25 1500 27 1200 21 1500 23 0 25 1500 25 1500 27 1200 23 25 1500 25 1500 27 1200 23 25 1500 27 1200 23 25 1500 27 1200 23 25 1500 27 1200 23 25 1500 27 1200 23 25 1500 27 1200 23 25 1500 27 1200 23 3 7 700 23 3 7 700 33 7 20 35 1080 33 37 500 33 33 37 500 33 33 33 33 33 33 33 33 33 33 33 33 3	BRKR: ING: A A B B A B A B B A B B A B B A B B A B B A B B A B B A B B A B B A B B A B B A B B A B B A B B A B B A B B A B B A B B B A B B B B B B B B B B B B B	NONE         CKT#         LOAD         2         4800         4         6         180         10         100         12         2496         14         2496         16         1500         22         24         16         1500         22         20         21         20         20         20         21         20         230         34         3500         34         3500         38         1500         38         3500         34         3500         38         1500	AMPS POLES 50A 2P  20A 1P 20A 2P  30A 2P  20A 1P 20A 1P 20A 1P 20A 1P 20A 1P 20A 1P 20A 1P 20A 1P 20A 1P 20A 1P 20A 1P 20A 1P 20A 1P 20A 1P	WIRES: 3 SC RATING: 10000 LOAD TYPE MISCELLANEOUS MISCELLANEOUS RECEPTACLE MECH HEATING MECH HEATING MECH COOLING MECH COOLING MECH YEAR ROUND SPACE MECH HEATING MECH YEAR ROUND SPACE MECH YEAR ROUND MOTOR MOTOR MOTOR MOTOR MOTOR MISCELLANEOUS RECEPTACLE	GROUND BUS: YES LOAD DESCRIPTION SPA - ROOF   RCPT - ROOF  GUTTER HEAT TRACE GFCI 30mA  CU-1 - CONDENSING UNIT  CU-1 - CONDENSING UNIT  CU		
2020 NFPA 70 ART. 220 PART III         2020 NFC 220.14(J), 220.42 & 220.52         1286 SQFT Upper Level       138 SQFT Upper Stairwell         2440 SQFT General Lighting Load       7320 VA         2 CCT Small Appliance       3000 VA         2 CCT Small Appliance       3000 VA         3000 VA @ 100% 3000 VA       8820 VA @ 35% 3087 VA         General Lighting Load         Total General Lighting Loads         Equipment Power       1032 VA         General Lighting Loads       Equipment Power         GF-1 Air       1032 VA         Coling Loads       Heating Loads         Equipment Power       1030 VA         GE-1 Air       1032 VA         CU AC       4800 VA         GF-1 Gas Furnace       1032 VA         Connected: 11232 VA Greater of Noncolincidental Loads: 6432 VA         Colong Loads       Load Each         1       1         1       1         0       Noncolincidental Loads: 6432 VA         2020 NEC 220.53       Appliance Loads         Appliance Loads       Load Each         1       1         1       1         0       1         0       VA	LOAD TYPE RECEPTACLE RECEPTACLE RECEPTACLE MISCELLANEOUS MISCELLANEOUS SPACE APPLIANCE APPLIANCE RECEPTACLE RECEPTACLE SPACE RECEPTACLE	VOLTAGE: ENCLOSURE: ENCLOSURE: LOAD DESCRIPTION RCPT - MAST. BED CAFCI RCPT - MAST. BATH  RCPT - POWDER ROOM  WASHER CAFCI/GFCI 5mA DRYER CAFCI/GFCI 5mA DRYER CAFCI CAFCI MICROWAVE DRAWER CAFCI MICROWAVE DRAWER CAFCI RCPT - KITCHEN COUNTER CAFCI/GFCI 5mA RCPT - KITCHEN COUNTER CAFCI/GFCI 5mA RANGE/HOOD CAFCI   RCPT - ISLAND COUNTER CAFCI/GFCI 5mA RANGE/HOOD CAFCI SISHWASHER CAFCI/GFCI 5mA DISHWASHER CAFCI/GFCI 5mA RCPT - LIVING/DINING CAFCI FIREPLACE OUTLETS CAFCI FIREPLACE OUTLETS CAFCI RCPT - 2ND COMMON CAFCI RCPT - BEDROOM N CAFCI RCPT - 2ND BATH N 	120/240         NEMA1         AMPS         20A         1P         20A	MAIN MOUN CKT# LOAD 1 1440 3 500 5 300 7 1500 9 1200 11 0 13 600 15 1500 17 1500 15 1500 15 1500 17 1500 15 1500 21 1500 21 1500 21 1500 21 1500 21 1500 21 1500 21 1500 21 1500 23 0 25 1500 23 0 25 1500 23 0 25 1500 23 0 25 1500 23 0 25 1500 23 0 25 1500 23 0 25 1500 23 0 25 1500 23 0 25 1500 23 0 25 1500 23 0 25 1500 23 0 25 1500 23 0 25 1500 23 0 25 1500 23 0 25 1500 23 0 25 1500 23 0 25 1500 23 1500 23 1500 23 1500 23 1500 23 1500 23 1500 23 1500 23 1500 23 1500 23 1500 23 1500 23 1500 25 1500 23 1500 25 1500 25 1500 25 1500 25 1500 25 1500 20 21 1500 21 1500 21 1500 23 0 25 1500 27 1200 25 1500 25 1500 25 1500 27 1200 25 1500 25 100 25 100 25 100 25 100 25 100 25 100 25 100 25 100 25 100 25 100 25 100 25 100 25 100 25 100 25 100 25 100 25 100 25 100 20 25 100 20 20 20 20 20 20 20 20 20 20 20 20 2	BRKR:         D         A         B	NONE         CKT#         LOAD         2         4800         4         6         180         10         1000         12         2496         14         2496         16         1500         22         24         16         1500         22         20         21         20         20         20         21         20         230         243         300         1500         32         3500         34         3500         38         1500	AMPS POLES 50A 2P  20A 1P 20A 2P  30A 2P  30A 2P  20A 1P 20A 1P 20A 1P 20A 1P 20A 1P 20A 1P 20A 1P 20A 1P 20A 1P 20A 1P 20A 1P	WIRES: 3 SC RATING: 10000 LOAD TYPE MISCELLANEOUS MISCELLANEOUS RECEPTACLE MECH HEATING MECH HEATING MECH COOLING MECH COOLING MECH YEAR ROUND SPACE MECH HEATING MECH HEATING MECH YEAR ROUND SPACE MECH HEATING MOTOR MOTOR MOTOR MOTOR MOTOR MOTOR MOTOR MOTOR MISCELLANEOUS RECEPTACLE	GROUND BUS: YES LOAD DESCRIPTION SPA - ROOF  GUTTER HEAT TRACE GFCI 30mA  GUTTER HEAT TRACE GFCI 30mA  CU-1 - CONDENSING UNIT  CU-1 - CONDENSING UNIT  GF1 - GAS FIRED FURNACE  GF1 - GAS FIRED FURNACE  CP1/3-BOILER/LOOP PUMP  CP2/7- WATER HEATER/DOMESTIC  CP2/7- WATER HEATER/DOMESTIC  CP6/7-RADIANT/LOOP  CP6/7-RADIANT/LOOP  CP6/7-RADIANT/LOOP  CP6/7-RADIANT/LOOP  CP6/7-RADIANT/LOOP  CP6/7-RADIANT/LOOP  CP6/7-RADIANT/LOOP  CP6/7-RADIANT/LOOP  CP6/7-RADIANT/LOOP  CP6/7-RADIANT/LOOP  CP6/7-RADIANT/LOOP  CP6/7-RADIANT/LOOP  CP6/7-RADIANT/LOOP  CP6/7-RADIANT/LOOP  CP6/7-RADIANT/LOOP  CP6/7-RADIANT/LOOP		

PANEL SCHEDULE -	PH	TYPE: VOLTAGE: ENCLOSURE:	LOADCE 120/240 NEMA3R		BUS SIZ MAIN BF MOUNT	RKR:	60 60 SURF	ACE	PHASES: WIRES: SC RATING:	1 3 10000	NEUTRAL BUS: YES GROUND BUS: YES		
LOAD TYPE	LOAD DESCRIPTION			AMPS POLES	CKT# 1 LOAD	Ø	CKT# LOAD	AMPS POLES	LOAD TYPE		LOAD DESCRIPTION		
MECH YEAR ROUND	BOILER 			20A 1P	1 / 1440	A	2 200	20A 1P	SPARE		SPARE 		
MOTOR	CP-1 - BOILER PUMP			20A 1P	3 E 720	В	4 200	20A 1P	SPARE		SPARE 		
MOTOR	CP-2 - CIRC PUMP			20A 1P	5 / 720	A	6 200	20A 1P	SPARE		SPARE 		
MOTOR	CP-3 - CIRC PUMP			20A 1P	7 E 720	В	8 200	20A 1P	SPARE		SPARE 		
MOTOR	CP-4 - LOOP PUMP			20A 1P	9 / 720 /	A	10 0		SPACE				
SPACE					11 E 0	В	12 0		SPACE				
SPACE					13 / 0	A	14 0		SPACE				
SPACE					15 E 0	В	16 0		SPACE				
SPACE					17 / 0	A	18 0		SPACE				
SPACE					19 E 0	В	20 0		SPACE				
LOADS BY TYPE:					LOADS BY P	PHASE	:		•		·		
LOAD TYPE	CONNECTED LOAD (VA)	DEMAND FACTOR	DEMAND LOAD (VA)		PHASE			CONNECTED LOAD (VA)	CONN LOAD (AM	ECTED //PS)	BALANCE (PERCENT)		
LIGHTING KITCHEN PROCESS RECEPTACLES	0.00 0.00 0.00 0.00	1.25 0.00 1.00 1.00	0.00 0.00 0.00 0.00		A B C			3280.00 1840.00 		7.33 5.33	A-B: 56.1 B-A: 56.1		
MECH HEATING MECH COOLING MECH YEAR ROUND	0.00 0.00 1440.00	1.00 1.00 1.00	0.00 0.00 1440.00		TOTAL/AVERAGE 5120.00 NOTES:				21.33 56.1				
APPLIANCE MISCELLANEOUS MOTOR SPARE LARGEST MOTOR <sup>1</sup>	0.00 0.00 2880.00 800.00 ABOVE	1.00 1.00 1.00 1.00 0.25	0.00 0.00 4320.00 800.00 360.00		1. THE LARGEST CONNECTED MOTOR LOAD IS INCLUDED IN MECHANICAL, PROCESS, OR MOTOR LOAD								
TOTAL	5120.00		5480.00										


	PANEL SCHEDULE	- P1	TYPE: VOLTAGE: ENCLOSURE:	LOADCENTER 120/240 NEMA1		SIZE: I BRKR: NTING:	225 NONE FLUSH		PHASES: 1 WIRES: 3 SC RATING: 1000	NEUTRAL BUS: YES GROUND BUS: YES
esidential Calculation - Village Drive North 20 NFPA 70 ART. 220 PART III	LOAD TYPE	LOAD DESCRIPTION		AMPS POLES	CKT# LOAD	۵	CKT# LOAD	AMPS POLES	LOAD TYPE	LOAD DESCRIPTION
2020 NEC 220.14(J), 220.42 & 220.52 371 SQFT Garage Level	RECEPTACLE	RCPT - MAST. BED CAFCI		20A 1P	1 1440	A	2 2880	30A 2P	MECH YEAR ROUND	CU-1 - HEAT PUMP HACR
1014 SQFT Main Level 686 SQFT Upper Level	RECEPTACLE	RCPT - MAST. BATH		20A 1P	3 500	В	4 2880		MECH YEAR ROUND	
136 SQFT Upper Stairwell       2207 SQFT General Lighting Load       6621 VA	RECEPTACLE	RCPT - POWDER ROO	ОМ	20A 1P	5 300	A	6 4800	50A 2P	MISCELLANEOUS	SPA - ROOF
2 CCT Small Appliance 3000 VA 1 CCT Laundry Circuit 1500 VA	MISCELLANEOUS	WASHER CAFCI/GFCI 5mA		20A 1P	7 1500	В	8 4800		MISCELLANEOUS	
Total General Load: 11121 VA 3000 VA @ 100% 3000 VA	MISCELLANEOUS	DRYER CAFCI/GFCI 5mA		20A 1P	9 1200	A	10 180	20A 1P	RECEPTACLE	RCPT - ROOF
8121 VA @ 35% 2842.35 VA	SPACE				11 0	В	12 1000	20A 2P	MECH HEATING	GUTTER HEAT TRACE GFCI 30mA
2020 NEC 220.51 and 220.60	ighting Load: 5842 VA APPLIANCE	FRIDGE CAFCI		15A 1P	13 600	A	14 1000		MECH HEATING	
Cooling LoadsHeating Loadsquipment PowerEquipmentJ Heat P5760 VACU Heat Pump5760 VA	APPLIANCE	MICROWAVE DRAWE	R	20A 1P	15 1500	В	16 20	1A 1P	MECH HEATING	EUH-1 - UNIT HEATER
Gutter Heat trace 1200 VA * See unit plans	/A Heating Loads	RCPT - KITCHEN COL CAFCI/GFCI 5mA	JNTER	20A 1P	17 1500	A	18 20	1A 1P	MECH YEAR ROUND	BL-1 BOILER
	/A Cooling Loads RECEPTACLE	RCPT - KITCHEN CO CAFCI/GFCI 5mA	UNTER	20A 1P	19 1500	В	20 1500	20A 1P	MOTOR	CP1/3-BOILER/LOOP PUMP
2020 NEC 220.53	APPLIANCE	GAS RANGE/HOOD CAFCI		20A 1P	21 1500	A	22 1500	20A 1P	MOTOR	CP2/7- WATER HEATER/DOMESTIC
Appliance Loads Load Each 1 Refrigerator 600 VA	SPACE				23	В	24 1500	20A 1P	MOTOR	CP4/6 - SNOWMELT / LOOP
1 Dishwasher1200 VA1 Disposal900 VA1 Microwave1200 VA	RECEPTACLE	RCPT - ISLAND COUN CAFCI/GFCI 5mA	ITER	20A 1P	25 1500	A	26 1500	20A 1P	MOTOR	CP6/7-RADIANT/LOOP
1 Gas Range/ Hood 1000 VA	pliance Load: 3675 VA	DISHWASHER CAFCI/GFCI 5mA		20A 1P	27 1200	В	28 1200	20A 1P	MISCELLANEOUS	HUMIDIFIER CAFCI/GFCI 5mA
2020 NEC 220.14(A)	RECEPTACLE	RCPT - LIVING/DINING	3	20A 1P	29 1260	A	30 3500	40A 2P	MISCELLANEOUS	EVC - GARAGE
QTY DescriptionLoad Each1 Humidifier1200 VA	RECEPTACLE	RCPT - FIREPLACE/TY CAFCI	V	20A 1P	31 1200	В	32 3500		MISCELLANEOUS	
1 Boiler1440 VA2 Circ Pumps720 VA1 Cos Prior1200 VA	RECEPTACLE	RCPT - BEDROOM E CAFCI		20A 1P	33 1080	A	34 1500	20A 1P	RECEPTACLE	RCPT - GARAGE GFCI 5mA
1 Gas Dryer       1200 VA         1 Hot Tub       9600 VA         1 EVC Level II       7200 VA	EST MOTOR: 480 VA	RCPT - 3RD BATH E		20A 1P	35 500	В	36 1500	20A 1P	RECEPTACLE	RCPT - GARAGE GFCI 5mA
	I Other Load: 22560 VA RECEPTACLE	RCPT - BEDROOM W CAFCI		20A 1P	37 1080	A	38 0		SPACE	
240 V Connected: 49441 VA 1 Ø 206.0 A	Demand: 42937 VA 178.9 A	RCPT - 3RD BATH W		20A 1P	39 500	В	40 0		SPACE	

P1	TYPE: VOLTAGE: ENCLOSURE:	LOADCE 120/240 NEMA1	NTER	BUS S MAIN E MOUN	BRKR:	400 NONE FLUSH		PHASES: 1 WIRES: 3 SC RATING: 10000	NEUTRAL BUS: YES GROUND BUS: YES
LOAD DESCRIPTION			AMPS POLES	CKT# LOAD	۵	CKT# LOAD	AMPS POLES	LOAD TYPE	LOAD DESCRIPTION
RCPT - MAST. BED CAFCI			20A 1P	1 1440	А	2 4800	50A 2P	MISCELLANEOUS	SPA - ROOF 
RCPT - MAST. BATH			20A 1P	3 500	В	4 4800		MISCELLANEOUS	
RCPT - POWDER ROC	DM		20A 1P	5 300	A	6 180	20A 1P	RECEPTACLE	RCPT - ROOF
WASHER CAFCI/GFCI 5mA			20A 1P	7 1500	В	8 1000	20A 2P	MECH HEATING	GUTTER HEAT TRACE GFCI 30mA
DRYER CAFCI/GFCI 5mA			20A 1P	9 1200	А	10 1000		MECH HEATING	
				11 0	В	12 2496	30A 2P	MECH COOLING	CU-1 - CONDENSING UNIT
FRIDGE CAFCI			15A 1P	13 600	A	14 2496		MECH COOLING	
MICROWAVE DRAWE	R		20A 1P	15 1500	В	16 1500	20A 1P	MECH YEAR ROUND	GF1 - GAS FIRED FURNACE
RCPT - KITCHEN COU CAFCI/GFCI 5mA	NTER		20A 1P	17 1500	А	18 0		SPACE	
RCPT - KITCHEN COU CAFCI/GFCI 5mA	JNTER		20A 1P	19 1500	В	20 20	1A 1P	MECH HEATING	EUH-1 - UNIT HEATER 
RANGE/HOOD CAFCI			20A 1P	21 1500	A	22 20	1A 1P	MECH YEAR ROUND	BL-1 BOILER 
				23 0	В	24 1500	20A 1P	MOTOR	CP1/3-BOILER/LOOP PUMP
RCPT - ISLAND COUN CAFCI/GFCI 5mA	TER		20A 1P	25 1500	A	26 1500	20A 1P	MOTOR	CP2/7- WATER HEATER/DOMESTIC
DISHWASHER CAFCI/GFCI 5mA			20A 1P	27 1200	В	28 1500	20A 1P	MOTOR	CP4/6 - SNOWMELT / LOOP
RCPT - LIVING/DINING	3		20A 1P	29 1260	A	30 1500	20A 1P	MOTOR	CP6/7-RADIANT/LOOP
FIREPLACE OUTLETS			20A 1P	31 700	В	32 3500	40A 2P	MISCELLANEOUS	EVC - GARAGE
RCPT - 2ND COMMON CAFCI	l		20A 1P	33 720	A	34 3500		MISCELLANEOUS	
RCPT - BEDROOM N CAFCI			20A 1P	35 1080	В	36 1500	20A 1P	RECEPTACLE	RCPT - GARAGE GFCI 5mA
RCPT - 2ND BATH N			20A 1P	37 500	A	38 1500	20A 1P	RECEPTACLE	RCPT - GARAGE GFCI 5mA
RCPT - BEDROOM S CAFCI			20A 1P	39 1080	В	40 0		SPACE	 
RCPT - 2ND BATH S			20A 1P	41 500	А	42 0		SPACE	

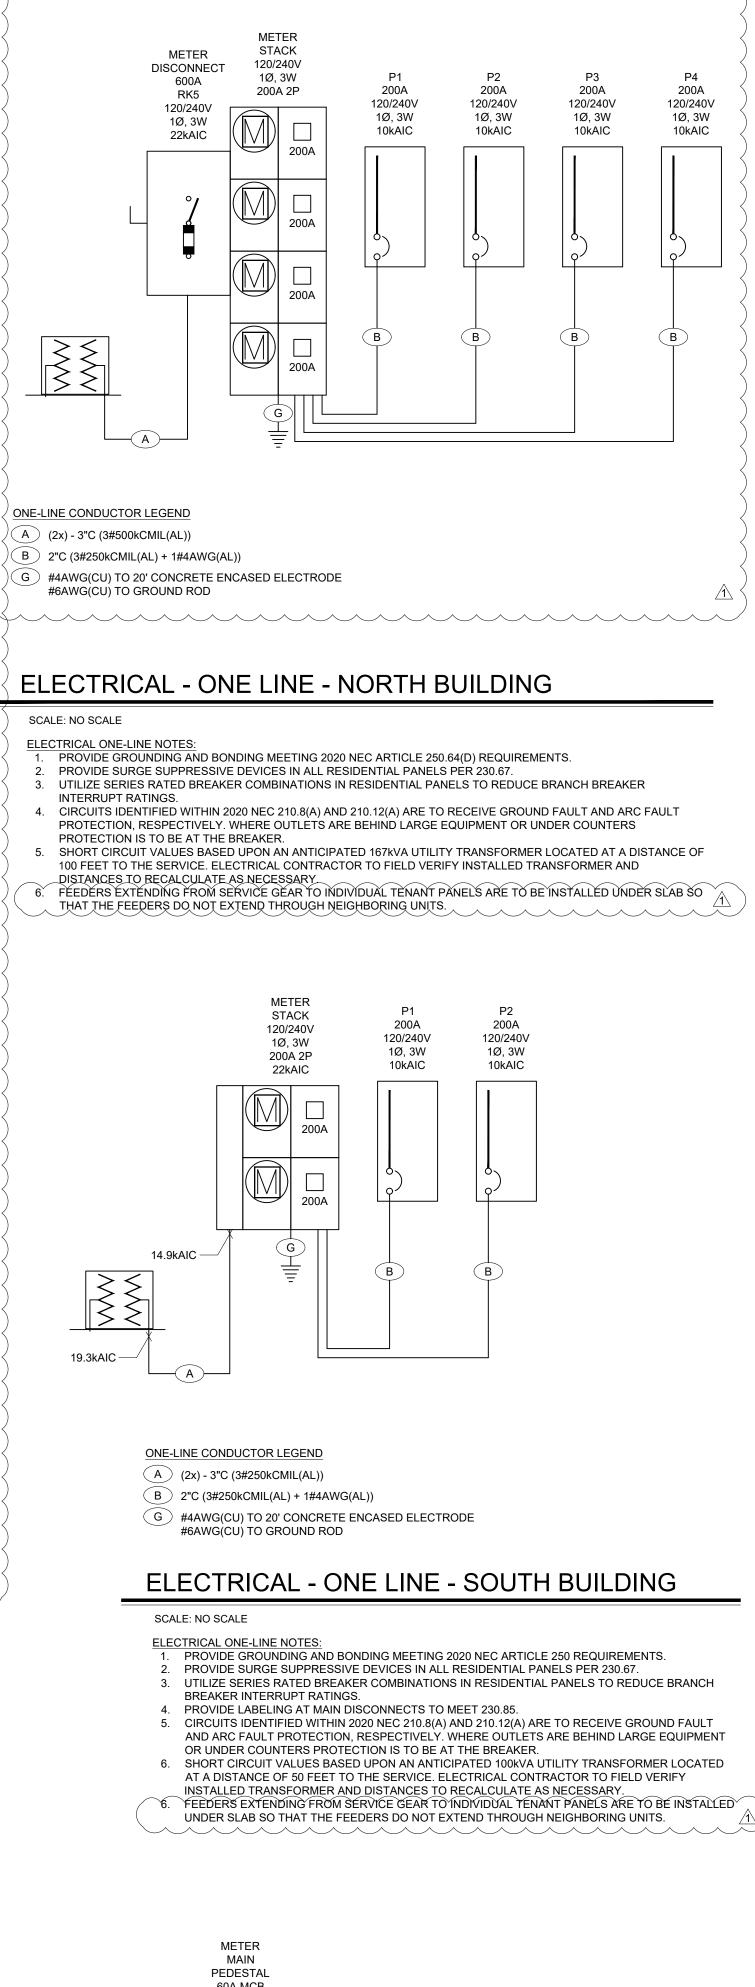

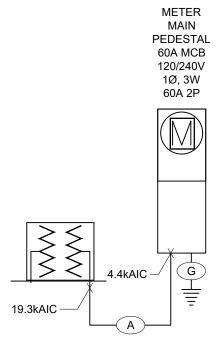

SCALE: NO SCALE

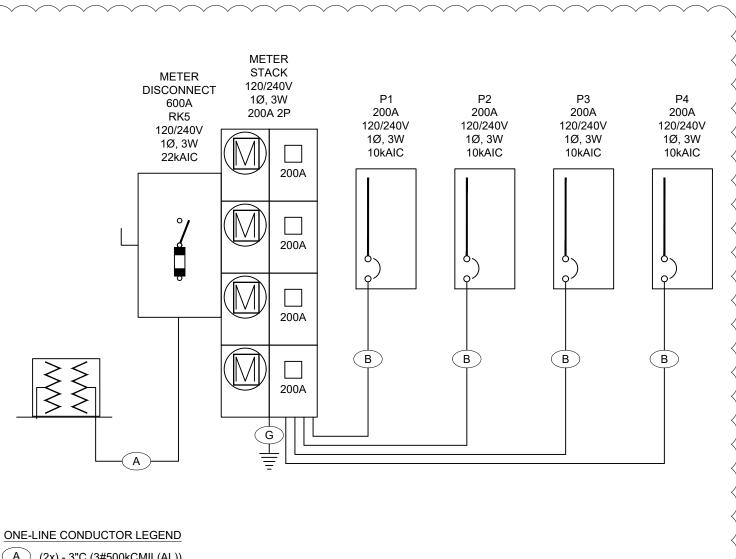

ľ	MECHANICAL EQU	JIPM	ΞΝΤ	SC	CHE	DULE	- N	OR	TΗ	BUIL	.DIN	G
	COMBINATION MOTOR STARTER MAGNETIC MOTOR STARTER				NE REQU JG-IN UN		MAN:	MANU	TRACTO JAL MO LIED WI	OR FOR STAR TH UNIT:	TER	
	FUNCTION (NOTES)	LOAD	VOLTS	Ø	MIN CIRC AMP	BRANG CONDUIT SIZE	CH CIRC NO.	WIRE	GRND WIRE SIZE	BRKR SIZE	START	DISC FUSE
	HEAT PUMP CONDENSING UNIT	4TON	240V	1	29.0A	1/2"	2	10	10	30A	W/U	30A 30A
HP 1	HEAT PUMP INTERIOR CASSETTE TYPICAL OF HP-2,3&4		240V	1	0.4A	1/2"	2	14	14	**	W/U	**
EF	EXHAUST FAN - BATH	10W	120V	1	0.1A	1/2"	2	12	12	15A	W/U	\$
EF 2	EXHAUST FAN - GARAGE	64W	120V	1	0.5A	1/2"	2	12	12	15A	W/U	\$
	ELECTRIC UNIT HEATER	1.5kW	120V	1	12A	1/2"	2	12	12	20A	W/U	\$
BL	GAS FIRED BOILER	1440W	120V	1	12A	1/2"	2	12	12	20A	W/U	\$
CP	CIRCULATION PUMP	270W	120V	1	5A	1/2"	2	12	12	15A	W/U	\$
2P	CIRCULATION PUMP TYPICAL OF CP-3,4&7	270W	120V	1	5A	1/2"	2	12	12	15A	W/U	\$
CP	CIRCULATION PUMP	1/8HP	120V	1	2A	1/2"	2	12	12	15A	W/U	\$
CP	CIRCULATION PUMP	370W	120V	1	3A	1/2"	2	12	12	15A	W/U	\$

MECHANICAL EQUIPMENT SCHEDULE NOTES: 1. FIELD VERIFY FINAL LOCATIONS OF CIRCULATION PUMPS WITH MECHANICAL CONTRACTOR. 2. HEAT PUMP CASSETTES ARE SUPPLIED FROM EXTERIOR UNIT; SEE MANUFACTURER'S INSTALLATION REQUIREMENTS FOR

MORE INFORMATION.

Comb: Mag:	COMBINATION MOTOR STARTER MAGNETIC MOTOR STARTER				NE REQU IG-IN UNI		MAN:	MANU	TRACTO JAL MO LIED WI	OR TOR STAR TH UNIT:	TER	
UNIT NO	FUNCTION (NOTES)	LOAD	VOLTS	Ø	MIN CIRC AMP	BRAN CONDUIT SIZE	CH CIRC NO.	CUIT WIRE SIZE	GRND WIRE SIZE	BRKR SIZE	START	DISC FUSE
	AC CONDENSING UNIT	2TON	240V	1	17.6A	1/2"	2	10	10	30A	W/U	30A 30A
$\left< \begin{array}{c} GF \\ 1 \end{array} \right>$	GAS FURNACE		120V	1	8.6A	1/2"	2	12	12	20A	W/U	\$
$\left< \begin{array}{c} EF \\ 1 \end{array} \right>$	EXHAUST FAN - BATH	10W	120V	1	0.1A	1/2"	2	12	12	15A	W/U	\$
$\left< \begin{array}{c} EF \\ 2 \end{array} \right>$	EXHAUST FAN - GARAGE	64W	120V	1	0.5A	1/2"	2	12	12	15A	W/U	\$
	ELECTRIC UNIT HEATER	1.5kW	120V	1	12A	1/2"	2	12	12	20A	W/U	\$
$\begin{pmatrix} BL \\ 1 \end{pmatrix}$	GAS FIRED BOILER	1440W	120V	1	12A	1/2"	2	12	12	20A	W/U	\$
	CIRCULATION PUMP	270W	120V	1	5A	1/2"	2	12	12	15A	W/U	\$
	CIRCULATION PUMP TYPICAL OF CP-3,4&7	270W	120V	1	5A	1/2"	2	12	12	15A	W/U	\$
CP 5	CIRCULATION PUMP	1/8HP	120V	1	2A	1/2"	2	12	12	15A	W/U	\$
	CIRCULATION PUMP	370W	120V	1	3A	1/2"	2	12	12	15A	W/U	\$

ELECTRICAL ONE-LINE NOTES: 1. PROVIDE GROUNDING AND BONDING MEETING 2020 NEC ARTICLE 250 REQUIREMENTS. 2. PROVIDE SURGE SUPPRESSIVE DEVICES IN ALL RESIDENTIAL PANELS PER 230.67.

AND ARC FAULT PROTECTION, RESPECTIVELY. WHERE OUTLETS ARE BEHIND LARGE EQUIPMENT

AT A DISTANCE OF 50 FEET TO THE SERVICE. ELECTRICAL CONTRACTOR TO FIELD VERIFY

UNDER SLAB SO THAT THE FEEDERS DO NOT EXTEND THROUGH NEIGHBORING UNITS.

ſ	MECHANICAL EQU	IIPME	ENT	SC	CHE	DULE	- S	OU	TH	BUII
	COMBINATION MOTOR STARTER MAGNETIC MOTOR STARTER				NE REQU IG-IN UNI		MAN:	MANU		OR TOR STAF TH UNIT:
UNIT	FUNCTION	LOAD	VOLTS	ø	MIN	BRAN	CH CIRC	CUIT	GRND	BRKR
NO	(NOTES)	LOAD	VOLIS	Ø	CIRC AMP	CONDUIT SIZE	NO. CONDUCTOR	WIRE SIZE	WIRE SIZE	SIZE
$\begin{pmatrix} BL \\ 1 \end{pmatrix}$	GAS FIRED BOILER	1440W	120V	1	12A	1/2"	2	12	12	20A
(CP) 1	CIRCULATION PUMP	270W	120V	1	5A	1/2"	2	12	12	15A
CP 2	CIRCULATION PUMP TYPICAL OF CP-3,4&7	270W	120V	1	5A	1/2"	2	12	12	15A
CP 5	CIRCULATION PUMP	1/8HP	120V	1	2A	1/2"	2	12	12	15A
	CIRCULATION PUMP	370W	120V	1	3A	1/2"	2	12	12	15A

ONE-LINE CONDUCTOR LEGEND A 2"C (3#4AWG(AL)) G #6AWG(CU) TO GROUND ROD

**ELECTRICAL - ONE LINE - SITE SNOWMELT** 

ELECTRICAL ONE-LINE NOTES: 1. PROVIDE GROUNDING AND BONDING MEETING 2020 NEC ARTICLE 250 REQUIREMENTS. 2. REFERENCE SITE PLAN FOR LOCATION ON PROPERTY. 3. SHORT CIRCUIT VALUES BASED UPON AN ANTICIPATED 100kVA UTILITY TRANSFORMER LOCATED

AT A DISTANCE OF 50 FEET TO THE SERVICE. ELECTRICAL CONTRACTOR TO FIELD VERIFY INSTALLED TRANSFORMER AND DISTANCES TO RECALCULATE AS NECESSARY.

# MECHANICAL EQUIPMENT SCHEDULE - SOUTH BUILDING

ILDING									
TARTER T:									
R	START	DISC FUSE							
	W/U	\$							
	W/U	\$							
	W/U	\$							
	W/U	\$							
	W/U	\$							

